

COMPLIANCE CODE



### **AMERICAN TOWER®**

ATC SITE NAME: FIVE POINTS ATC SITE NUMBER: 2543

T-MOBILE SITE NAME: FIVE POINTS I10 T-MOBILE SITE NUMBER: 9JK0230A

SITE ADDRESS: HWY 441 & I-10

LAKE CITY, FL 32055

SITE CLASS: GUYED

PROJECT SUMMARY





**LOCATION MAP** 

SHEET INDEX

## T-MOBILE ANCHOR AMENDMENT PLAN 67E5D998E 6160 (GSM ON 6630) CONFIGURATION

PROJECT DESCRIPTION

ALL WORK SHALL BE PERFORMED AND MATERIALS			THE PROPOSED PROJECT INCLUDES MODIFYING GROUND BASED AND TOWER MOUNTED EQUIPMENT AS INDICATED PER BELOW:	SHEET NO:	DESCRIPTION:	REV:	DATE:	BY:
OF THE FOLLOWING CODES AS ADOPTED BY THE LOCAL GOVERNMENT AUTHORITIES. NOTHING IN THESE PLANS IS	## AND TOWER MOUNTED EQUIPMENT AS INDICATED PER BELOW:    MONTHUED TO PERMIT WORK NOT CONFORMING TO PERMIT WORK NOT COMPONENTIAL DIA PROPERTY OF THE LOCAL MENT AUTHORITIES. NOTHING IN THESE PLANS IS COUNTY. COLUMBIA EMOVE (1) OWN ANTENNA(1) AND (1) STANDOFF MOUNT(6) @ 207 CO. G. GENERAL NOTES	01/06/25	JLR					
TO BE CONSTRUED TO PERMIT WORK NOT CONFORMING TO THESE CODES.			RAD	G-002	GENERAL NOTES	0	01/06/25	JLR
2021 IBC			RAD	C-101	DETAILED SITE PLAN	0	01/06/25	JLR
NATIONAL ELECTRICAL CODE (NFPA 70, NEC 2020) 2023 FLORIDA BUILDING CODE, MECHANICAL, 8TH EDITION	30° 14' 17	7.572" N	EXISTING (3) ANTENNA(S), (6) RRU(S), AND (2) 1.99" HYBRID TRUNK	C-201	TOWER ELEVATION	0	01/06/25	JLR
(IMC 2021 W/ AMND) 2023 FLORIDA BUILDING CODE, PLUMBING, 8TH EDITION (IPC	82° 38' 12	2.605" W	6/24 4 AWG CABLE(S) TO REMAIN @ 295'	C-401	ANTENNA INFORMATION & SCHEDULE	0	01/06/25	JLR
2021 W/ AMND) 2023 FLORIDA BUILDING CODE, ENERGY CONSERVATION, 8TH	GROUND ELEVA	TION: 148' AMSL	INSTALL (1) RP 6651	C-501	CONSTRUCTION DETAILS	0	01/06/25	JLR
EDITION (IECC 2021 W/ AMND) 2023 FLORIDA FIRE PREVENTION CODE, 8TH EDITION (NFPA 1.				E-501	GROUNDING DETAILS	0	01/06/25	JLR
2021 W/AMND) 2023 FLORIDA BUILDING CODE, EXISTING BUILDING, 8TH					SUPPLEMENTAL SHEETS (3 PAGES)			
EDITION (IEBC 2021 W/ AMND) 8TH ED (2023) FLORIDA BUILDING CODE			PROJECT NOTES					
2023 FLÒRIDÁ BUILDING CODE, RESIDENTIAL, 8TH EDITION	PROJEC	T TEAM						
(IRC 2021 W/ AMND) 2023 FLORIDA BUILDING CODE, FUEL GAS, 8TH EDITION (IFGC 2018 W/ AMND)  TOWER OWNEL  AMERICAN TOW	TOWER OWNER:	APPLICANT:	3. THE PROJECT WILL NOT RESULT IN ANY SIGNIFICANT LAND					
	ENGINEER:	TAMPA, FL 33634	ELIGIBLE FACILITIES REQUEST ENTITLED TO EXPEDITED					
	ATC TOWER SERVICES, LLC							
UTILITY COMPANIES	, , , , , , , , , , , , , , , , , , , ,		TRANSMISSION EQUIPMENT THAT IS NOT A SUBSTANTIAL					
POWER COMPANY: FLORIDA POWER & LIGHT COMPANY	PROPERTY OWNER:							
			PROJECT LOCATION DIRECTIONS					
Know where below. Call before you dig.								

# **AMERICAN TOWER®**

ATC TOWER SERVICES, LLC

1 FENTON MAIN SUITE 300 CARY, NC 27511 PHONE: (919) 468-0112

THE USE AND PUBLICATION OF THESE DRAWINGS SHALL BE RESTRICTED TO THE ORIGINAL SITE FOR WHICH THEY ARE PREPARED. ANY USE OR DISCLOSURE OTHER THAN THAT WHICH RELATES TO AMERICAN TOWER OR THE SPECIFIED CARRIER IS STRICTLY PROHIBITED. NEITHER THE ARCHITECT NOR THE ENGINEER WILL BE PROVIDING ON-SITE CONSTRUCTION REVIEW OF THIS PROJECT. CONTRACTOR(S) MUST VERIFY ALL DIMENSIONS AND ADVISE AMERICAN TOWER OR THE SPECIFIED CARRIER OF ANY DISCREPANCIES. ANY PRIOR ISSUANCE OF THIS DRAWING IS SUPERSEDED BY THE LATEST VERSION.

REV.	DESCRIPTION	BY	DATE
△_	FOR CONSTRUCTION	JLR	01/06/25
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$\square$			
	ATC SITE NUMBER:		
	2543		

ATC SITE NAME:

FIVE POINTS

T-MOBILE SITE NAME:

#### **FIVE POINTS I10**

SITE ADDRESS: HWY 441 & I-10 LAKE CITY, FL 32055

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Fletcher Date: 2025.01.06
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	ATC PROJ. #:	14910189_G0
4	CUST. ID:	FIVE POINTS I10
	CUST. #:	9JK0230A

TITLE SHEET

SHEET NUMBER:

G-001

0

REVISION:

#### **GENERAL CONSTRUCTION NOTES:**

- OWNER FURNISHED MATERIALS, T-MOBILE "THE COMPANY" WILL PROVIDE AND THE CONTRACTOR WILL INSTALL
- A. BTS EQUIPMENT FRAME (PLATFORM) AND ICEBRIDGE SHELTER (GROUND BUILD/CO-LOCATE ONLY)
- B. AC/TELCO INTERFACE BOX (PPC)
- C. ICE BRIDGE (CABLE TRAY WITH COVER) (GROUND BUILD/CO-LOCATE ONLY, GC TO FURNISH AND INSTALL FOR ROOFTOP INSTALLATION)
- D. TOWERS, MONOPOLES
- E. TOWER LIGHTING
- F. GENERATORS & LIQUID PROPANE TANK
- G. ANTENNA STANDARD BRACKETS, FRAMES AND PIPES FOR MOUNTING
- H. ANTENNAS (INSTALLED BY OTHERS)
- I. TRANSMISSION LINE
- J. TRANSMISSION LINE JUMPERS
- K. TRANSMISSION LINE CONNECTORS WITH WEATHERPROOFING KITS
- L. TRANSMISSION LINE GROUND KITS
- M. HANGERS
- N. HOISTING GRIPS
- O. BTS EQUIPMENT
- 2. THE CONTRACTOR IS RESPONSIBLE TO PROVIDE ALL OTHER MATERIALS FOR THE COMPLETE INSTALLATION OF THE SITE INCLUDING, BUT NOT LIMITED TO, SUCH MATERIALS AS FENCING, STRUCTURAL STEEL SUPPORTING SUB-FRAME FOR PLATFORM, ROOFING LABOR AND MATERIALS, GROUNDING RINGS, GROUNDING WIRES, COPPER-CLAD OR XIT CHEMICAL GROUND ROD(S), BUSS BARS, TRANSFORMERS AND DISCONNECT SWITCHES WHERE APPLICABLE, TEMPORARY ELECTRICAL POWER, CONDUIT, LANDSCAPING COMPOUND STONE, CRANES, CORE DRILLING, SLEEPERS AND RUBBER MATTING, REBAR, CONCRETE CAISSONS, PADS AND/OR AUGER MOUNTS, MISCELLANEOUS FASTENERS, CABLE TRAYS, NON-STANDARD ANTENNA FRAMES AND ALL OTHER MATERIAL AND LABOR REQUIRED TO COMPLETE THE JOB ACCORDING TO THE DRAWINGS AND SPECIFICATIONS. IT IS THE POSITION OF T-MOBILE TO APPLY FOR PERMITTING AND CONTRACTOR RESPONSIBLE FOR PICKUP AND PAYMENT OF REQUIRED PERMITS.
- ALL WORK SHALL CONFORM TO ALL CURRENT APPLICABLE FEDERAL, STATE, AND LOCAL CODES, INCLUDING ANS/EIA/TIA-222, AND COMPLY WITH ATC CONSTRUCTION SPECIFICATIONS.
- 4. CONTRACTOR SHALL CONTACT LOCAL 811 FOR IDENTIFICATION OF UNDERGROUND
- CONTRACTOR SHALL BE RESPONSIBLE FOR COORDINATING ALL REQUIRED INSPECTIONS.
- ALL DIMENSIONS TO, OF, AND ON EXISTING BUILDINGS, DRAINAGE STRUCTURES, AND SITE IMPROVEMENTS SHALL BE VERIFIED IN FIELD BY CONTRACTOR WITH ALL DISCREPANCIES REPORTED TO THE ENGINEER.
- 7. DO NOT CHANGE SIZE OR SPACING OF STRUCTURAL ELEMENTS
- 8. DETAILS SHOWN ARE TYPICAL; SIMILAR DETAILS APPLY TO SIMILAR CONDITIONS UNLESS
- THESE DRAWINGS DO NOT INCLUDE NECESSARY COMPONENTS FOR CONSTRUCTION SAFETY WHICH SHALL BE THE SOLE RESPONSIBILITY OF THE CONTRACTOR.
- CONTRACTOR SHALL BRACE STRUCTURES UNTIL ALL STRUCTURAL ELEMENTS NEEDED FOR STABILITY ARE INSTALLED. THESE ELEMENTS ARE AS FOLLOWS: LATERAL BRACING, ANCHOR BOLLTS, ETC.
- CONTRACTOR SHALL DETERMINE EXACT LOCATION OF EXISTING UTILITIES, GROUNDS DRAINS, DRAIN PIPES, VENTS, ETC. BEFORE COMMENCING WORK.
- 12. INCORRECTLY FABRICATED, DAMAGED, OR OTHERWISE MISFITTING OR NONCONFORMING MATERIALS OR CONDITIONS SHALL BE REPORTED TO THE T-MOBILE REP PRIOR TO REMEDIAL OR CORRECTIVE ACTION. ANY SUCH REMEDIAL ACTION SHALL REQUIRE WRITTEN APPROVAL BY THE T-MOBILE REP PRIOR TO PROCEEDING.
- 13. EACH CONTRACTOR SHALL COOPERATE WITH THE T-MOBILE REP, AND COORDINATE HIS WORK WITH THE WORK OF OTHERS.
- 14. CONTRACTOR SHALL REPAIR ANY DAMAGE CAUSED BY CONSTRUCTION OF THIS PROJECT TO MATCH EXISTING PRE-CONSTRUCTION CONDITIONS TO THE SATISFACTION OF THE T-MORIE F CONSTRUCTION MANAGER
- 15. ALL CABLE/CONDUIT ENTRY/EXIT PORTS SHALL BE WEATHERPROOFED DURING INSTALLATION USING A SILICONE SEALANT.
- WHERE EXISTING CONDITIONS DO NOT MATCH THOSE SHOWN IN THIS PLAN SET, CONTRACTOR SHALL NOTIFY THE T-MOBILE REP AND ENGINEER OF RECORD IMMEDIATELY.
- CONTRACTOR SHALL ENSURE ALL SUBCONTRACTORS ARE PROVIDED WITH A COMPLETE AND CURRENT SET OF DRAWINGS AND SPECIFICATIONS FOR THIS PROJECT.
- 18. CONTRACTOR SHALL REMOVE ALL RUBBISH AND DEBRIS FROM THE SITE AT THE END OF
- CONTRACTOR SHALL COORDINATE WORK SCHEDULE WITH AMERICAN TOWER CORPORATION (ATC), AND TAKE PRECAUTIONS TO MINIMIZE IMPACT AND DISRUPTION OF OTHER OCCUPANTS OF THE FACILITY.
- CONTRACTOR SHALL FURNISH T-MOBILE AND AMERICAN TOWER CORPORATION (ATC)
  WITH A PDF MARKED UP AS-BUILT SET OF DRAWINGS UPON COMPLETION OF WORK.
- PRIOR TO SUBMISSION OF BID, CONTRACTOR SHALL COORDINATE WITH T-MOBILE REP
   TO DETERMINE WHAT, IF ANY, ITEMS WILL BE PROVIDED. ALL ITEMS NOT PROVIDED SHALL BE PROVIDED AND INSTALLED BY THE CONTRACTOR. CONTRACTOR WILL INSTALL

   TO SUBMISSION OF BID, CONTRACTOR. SHALL BE PROVIDED.

  2. TO DETERMINE WHAT, IF ANY, ITEMS WILL BE PROVIDED. AND INSTALLED BY THE CONTRACTOR. CONTRACTOR WILL INSTALL

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  9.

- PRIOR TO SUBMISSION OF BID, CONTRACTOR SHALL COORDINATE WITH T-MOBILE REP
  TO DETERMINE IF ANY PERMITS WILL BE OBTAINED BY CONTRACTOR. ALL REQUIRED
  PERMITS NOT OBTAINED BY T-MOBILE MUST BE OBTAINED, AND PAID FOR, BY THE
  CONTRACTOR.
- CONTRACTOR SHALL INSTALL ALL SITE SIGNAGE IN ACCORDANCE WITH T-MOBILE SPECIFICATIONS AND REQUIREMENTS.
- 24. CONTRACTOR SHALL SUBMIT ALL SHOP DRAWINGS TO T-MOBILE FOR REVIEW AND APPROVAL PRIOR TO FABRICATION.
- ALL EQUIPMENT SHALL BE INSTALLED ACCORDING TO MANUFACTURER'S SPECIFICATIONS AND LOCATED ACCORDING TO T-MOBILE SPECIFICATIONS, AND AS SHOWN IN THESE PI ANS
- 26. THE CONTRACTOR SHALL SUPERVISE AND DIRECT THE PROJECT DESCRIBED HEREIN. THE CONTRACTOR SHALL BE SOLELY RESPONSIBLE FOR ALL THE CONSTRUCTION MEANS, METHODS, TECHNIQUES, SEQUENCES AND PROCEDURES AND FOR COORDINATING ALL PORTIONS OF THE WORK UNDER THE CONTRACT.
- CONTRACTOR SHALL NOTIFY T-MOBILE REP A MINIMUM OF 48 HOURS IN ADVANCE OF POURING CONCRETE OR BACKFILLING ANY UNDERGROUND UTILITIES, FOUNDATIONS OR SEALING ANY WALL, FLOOR OR ROOF PENETRATIONS FOR ENGINEERING REVIEW AND APPROVAL.
- 28. WHEN THE PROJECT SCOPE REQUIRES THE USE OF THE SAFETY CLIMB, THE GENERAL CONTRACTOR SHALL ENSURE THE SAFETY CLIMB IS FREE OF OBSTRUCTIONS, NOT RUBBING ON OR TRAPPED BY ANY INSTALLED CUSTOMER EQUIPMENT, IS VISUALLY TAUT, MEETS MANUFACTURER INSTALLATION SPECIFICATIONS, AND IS FIRMLY SECURED AT ALL CABLE GUIDE LOCATIONS UPON PROJECT COMPLETION.
- COMPLETION OF PROJECT SHALL NOT OBSTRUCT, TRAP, LOOSEN, OR OTHERWISE CAUSE FAILURE TO MEET MANUFACTURER INSTALLATION REQUIREMENTS FOR THE SAFETY CLIMB.
- CONTRACTOR SHALL BE RESPONSIBLE FOR SITE SAFETY INCLUDING COMPLIANCE WITH ALL APPLICABLE OSHA STANDARDS AND RECOMMENDATIONS AND SHALL PROVIDE ALL NECESSARY SAFETY DEVICES INCLUDING PPE AND PPM AND CONSTRUCTION DEVICES SUCH AS WELDING AND FIRE PREVENTION, TEMPORARY SHORING, SCAFFOLDING, TRENCH BOXES/SLOPING, BARRIERS, ETC.
- 31. THE CONTRACTOR SHALL PROTECT AT HIS OWN EXPENSE, ALL EXISTING FACILITIES AND SUCH OF HIS NEW WORK LIABLE TO INJURY DURING THE CONSTRUCTION PERIOD. ANY DAMAGE CAUSED BY NEGLECT ON THE PART OF THIS CONTRACTOR OR HIS REPRESENTATIVES, OR BY THE ELEMENTS DUE TO NEGLECT ON THE PART OF THIS CONTRACTOR OR HIS REPRESENTATIVES, EITHER TO THE EXISTING WORK, OR TO HIS WORK OR THE WORK OF ANY OTHER CONTRACTOR, SHALL BE REPAIRED AT HIS EXPENSE TO THE OWNER'S SATISFACTION.
- 32. ALL WORK SHALL BE INSTALLED IN A FIRST CLASS, NEAT AND WORKMANLIKE MANNER BY MECHANICS SKILLED IN THE TRADE INVOLVED. THE QUALITY OF WORKMANSHIP SHALL BE SUBJECT TO THE APPROVAL OF THE T-MOBILE REP. ANY WORK FOUND BY THE T-MOBILE REP TO BE OF INFERIOR QUALITY AND/OR WORKMANSHIP SHALL BE REPLACED AND/OR REWORKED AT CONTRACTOR EXPENSE UNTIL APPROVAL IS OBTAINED.
- IN ORDER TO ESTABLISH STANDARDS OF QUALITY AND PERFORMANCE, ALL TYPES OF MATERIALS LISTED HEREINAFTER BY MANUFACTURER'S NAMES AND/OR MANUFACTURER'S CATALOG NUMBER SHALL BE PROVIDED BY THESE MANUFACTURERS AS SPECIFIED.
- 34. T-MOBILE FURNISHED EQUIPMENT SHALL BE PICKED-UP AT THE T-MOBILE WAREHOUSE, NO LATER THAN 48HR AFTER BEING NOTIFIED INSURED, STORED, UNCRATE, PROTECTED AND INSTALLED BY THE CONTRACTOR WITH ALL APPURTENANCES REQUIRED TO PLACE THE EQUIPMENT IN OPERATION, READY FOR USE. THE CONTRACTOR SHALL BE RESPONSIBLE FOR THE EQUIPMENT AFTER PICKING IT UP.
- 35. T-MOBILE OR HIS ARCHITECT/ENGINEER RESERVES THE RIGHT TO REJECT ANY EQUIPMENT OR MATERIALS WHICH, IN HIS OWN OPINION ARE NOT IN COMPLIANCE WITH THE CONTRACT DOCUMENTS, EITHER BEFORE OR AFTER INSTALLATION AND THE EQUIPMENT SHALL BE REPLACED WITH EQUIPMENT CONFORMING TO THE REQUIREMENTS OF THE CONTRACT DOCUMENTS BY THE CONTRACTOR AT NO COST TO TAKE THE PROPERTY OF THE PROPERTY OF THE CONTRACT DOCUMENTS BY THE CONTRACTOR AT NO COST TO TAKE THE PROPERTY OF T

# SPECIAL CONSTRUCTION ANTENNA INSTALLATION NOTES:

- 1. WORK INCLUDED:
  - A. ANTENNA AND COAXIAL/HYBRID CABLES ARE FURNISHED BY T-MOBILE UNDER A SEPARATE CONTRACT. THE CONTRACTOR SHALL ASSIST ANTENNA INSTALLATION CONTRACTOR IN TERMS OF COORDINATION AND SITE ACCESS. ERECTION SUBCONTRACTOR SHALL BE RESPONSIBLE FOR THE PROTECTION OF PERSONNEL.
  - B. INSTALL ANTENNAS AS INDICATED ON DRAWINGS AND T-MOBILE
  - C. INSTALL GALVANIZED STEEL ANTENNA MOUNTS AS INDICATED ON DRAWINGS.
  - ${\tt D.} \quad {\tt INSTALL} \ {\tt FURNISHED} \ {\tt GALVANIZED} \ {\tt STEEL} \ {\tt OR} \ {\tt ALUMINUM} \ {\tt WAVEGUIDE}.$
  - E. INSTALL COAXIAL/HYBRID CABLES AND TERMINATING BETWEEN ANTENNAS AND EQUIPMENT PER MANUFACTURER'S RECOMMENDATIONS. WEATHERPROOF ALL CONNECTIONS BETWEEN THE ANTENNA AND EQUIPMENT PER MANUFACTURER'S REQUIREMENTS. TERMINATE ALL COAXIAL/HYBRID CABLE THREE (3) FEET IN EXCESS OF ENTRY PORT LOCATION UNLESS OTHERWISE STATED.
- 2. ANTENNA AND COAXIAL/HYBRID CABLE GROUNDING:
  - A. ALL EXTERIOR #6 GREEN GROUND WIRE "DAISY CHAIN" CONNECTIONS ARE TO BE WEATHER SEALED WITH RFS CONNECTORS/SPLICE WEATHERPROOFING KIT #2012/3 OP ECILIA.

B. ALL COAXIAL/HYBRID CABLE GROUNDING KITS ARE TO BE INSTALLED ON STRAIGHT RUNS OF COAXIAL/HYBRID CABLE (NOT WITHIN BENDS)

ALL DISCREPANCIES FROM WHAT IS SHOWN ON THESE
CONSTRUCTION DRAWINGS SHALL BE COMMUNICATED TO ATC
ENGINEERING IMMEDIATELY FOR CORRECTION OR RE-DESIGN.
FAILURE TO COMMUNICATE DIRECTLY WITH ATC ENGINEERING OR
ANY CHANGES FROM THE DESIGN CONDUCTED WITHOUT PRIOR
APPROVAL FROM ATC ENGINEERING SHALL BE THE SOLE
RESPONSIBILITY OF THE GENERAL CONTRACTOR.



1 FENTON MAIN SUITE 300 CARY, NC 27511 PHONE: (919) 468-0112 9053

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△_	FOR CONSTRUCTION	JLR	01/06/25
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	ATC SITE NUMBER:		

2543 ATC SITE NAME:

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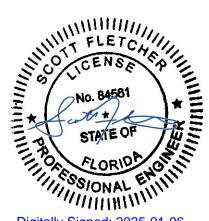
FIVE POINTS

T-MOBILE SITE NAME: FIVE POINTS I10

SITE ADDRESS:

HWY 441 & I-10 LAKE CITY, FL 32055

SEAL:



Digitally Signed: 2025-01-06

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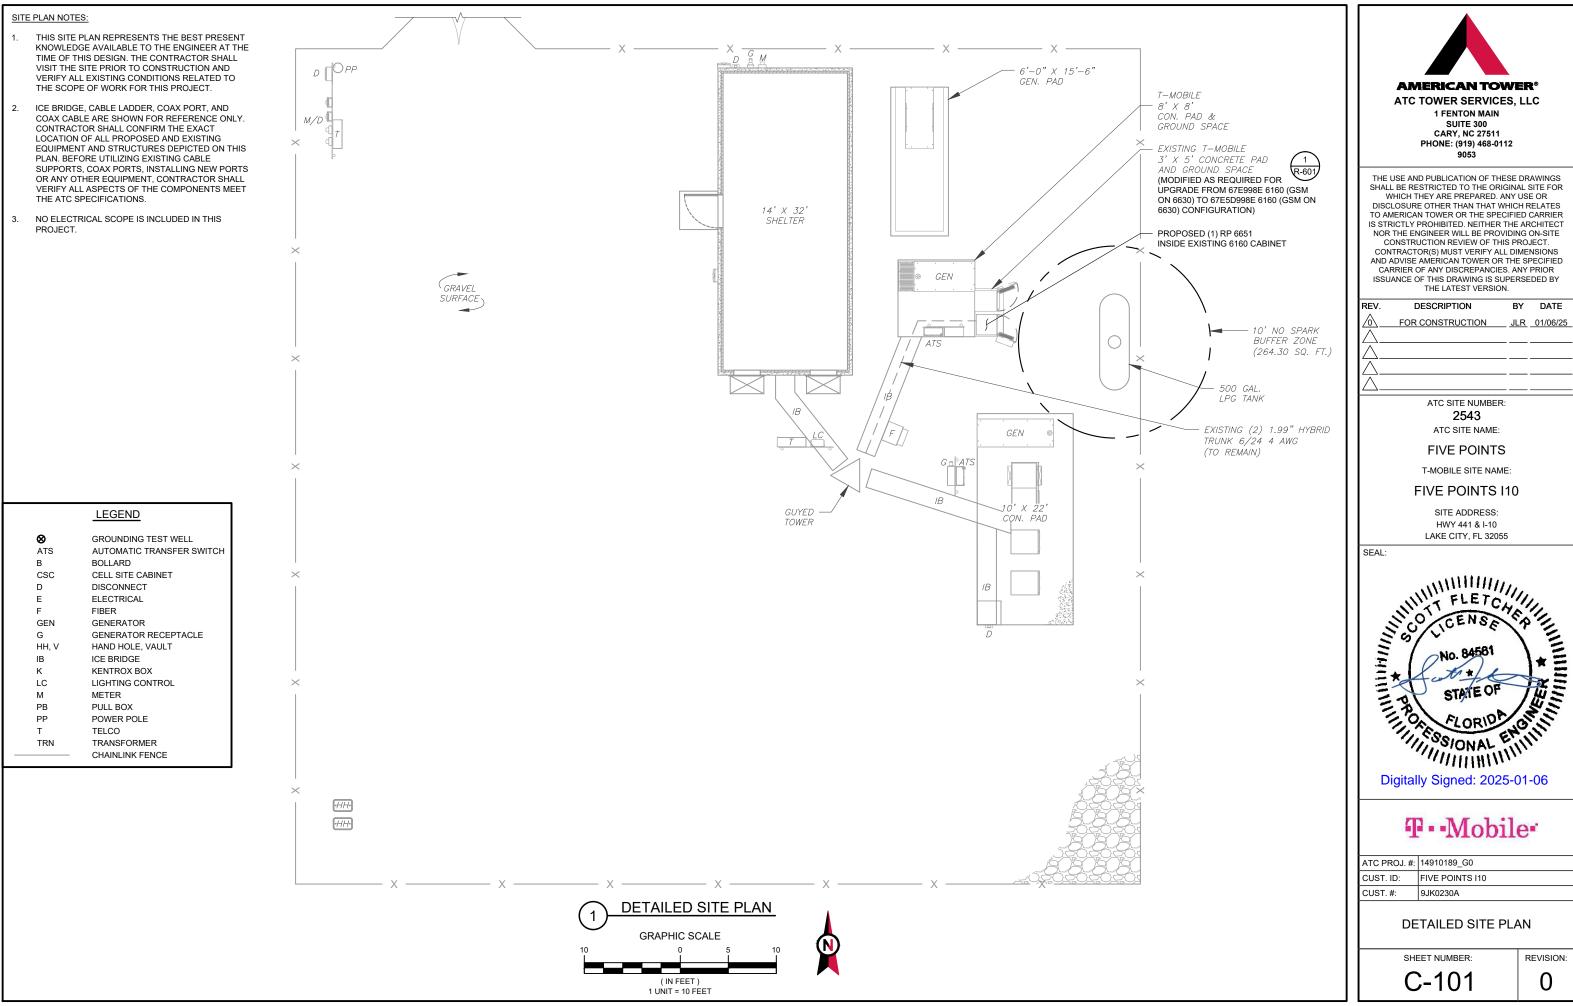
ATC PROJ. #: 14910189\_G0
CUST. ID: FIVE POINTS I10
CUST. #: 9JK0230A

**GENERAL NOTES** 

SHEET NUMBER:

G-002

REVISION




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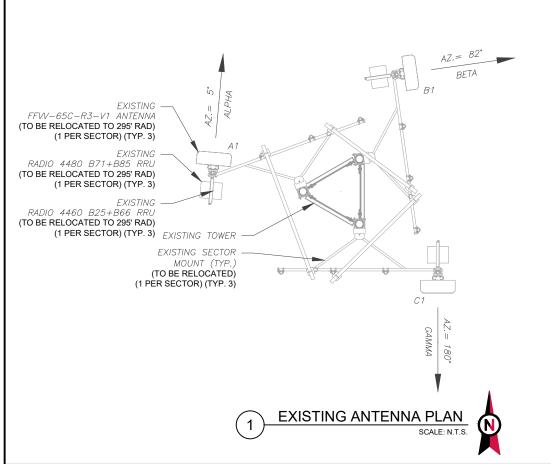
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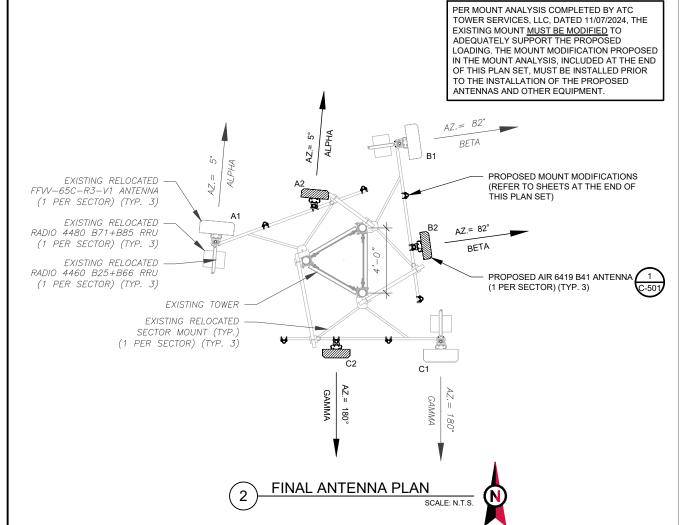


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				EX	ISTING ANTENNA SCHE	DULE				
LC	CATION			ANT	TENNA SUMMARY			NON ANTENNA SUMM	ARY	1.
SECTOR	RAD	AZ	POS	ANTENNA	BAND	MECH/ELEC D-TILT	STATUS	ADDITIONAL TOWER MOUNTED EQUIPMENT	STATUS	
ALPHA	298.5	5°	A1	FFVV-65C-R3-V1	L600/N600/L700/ L1900/G1900/ N1900/L2100	0°	REL	RADIO 4480 R71+B85 RADIO 4460 B25+B66	REL REL	2
BETA	298.5	82°	B1	FFVV-65C-R3-V1	L600/N600/L700/ L1900/G1900/ N1900/L2100	0°	REL	RADIO 4480 R71+B85 RADIO 4460 B25+B66	REL REL	3
GAMMA	298.5	180°	C1	FFW-65C-R3-V1	L600/N600/L700/ L1900/G1900/ N1900/L2100	0°	REL	RADIO 4480 R71+B85 RADIO 4460 B25+B66	REL REL	

NOTES						FINAL ANTENNA SCHE	DULE				
1. GC TO VERIFY THE FINAL RFDS	LO	CATION			ANT	TENNA SUMMARY			NON ANTENNA SUMMA	ARY	
MATCHES THE FINAL CONSTRUCTION DRAWINGS. GC TO NOTIFY ATC PM OF ANY	SECTOR	RAD	AZ	POS	ANTENNA	BAND	MECH/ELEC D-TILT	STATUS	ADDITIONAL TOWER MOUNTED EQUIPMENT	STATUS	
DISCREPANCY PRIOR TO INSTALLING THE EQUIPMENT. 2. GC TO CAP ALL UNUSED PORTS.	ALPHA	295'	5°	A1	FFVV-65C-R3-V1	L600/N600/L700/ L1900/G1900/ N1900/L2100	0°	REL	RADIO 4480 R71+B85 RADIO 4460 B25+B66	REL REL	
3. GC TO CONFIRM SPACING OF				A2	AIR 6419 B41	N2500	0°	ADD	-	-	
PROPOSED EQUIP DOES NOT CAUSE TOWER CONFLICTS NOR IMPEDE TOWER CLIMBING PEGS.	BETA	295'	82°	B1	FFVV-65C-R3-V1	L600/N600/L700/ L1900/G1900/ N1900/L2100	0°	REL	RADIO 4480 R71+B85 RADIO 4460 B25+B66	REL REL	
STATUS ABBREVIATIONS	1				B2	AIR 6419 B41	N2500	0°	ADD	-	-
RMV: TO BE REMOVED  RMN: TO REMAIN  REL: TO BE RELOCATED	GAMMA	295'	180°	C1	FFVV-65C-R3-V1	L600/N600/L700/ L1900/G1900/ N1900/L2100	0°	REL	RADIO 4480 R71+B85 RADIO 4460 B25+B66	REL REL	
ADD: TO BE ADDED				C2	AIR 6419 B41	N2500	0°	ADD	_	_	

CABLE LENGTHS FOR JUMPERS JUNCTION BOX TO RRU: 15'

EXISTING FIBER DISTRIBUTION / OVP	вох	EXISTING CABLING SUMMARY	
MODEL NUMBER	STATUS	CABLE QTY, SIZE, TYPE	STATUS
_	-	(2) 1.99" HYBRID TRUNK 6/24 4 AWG	RMN

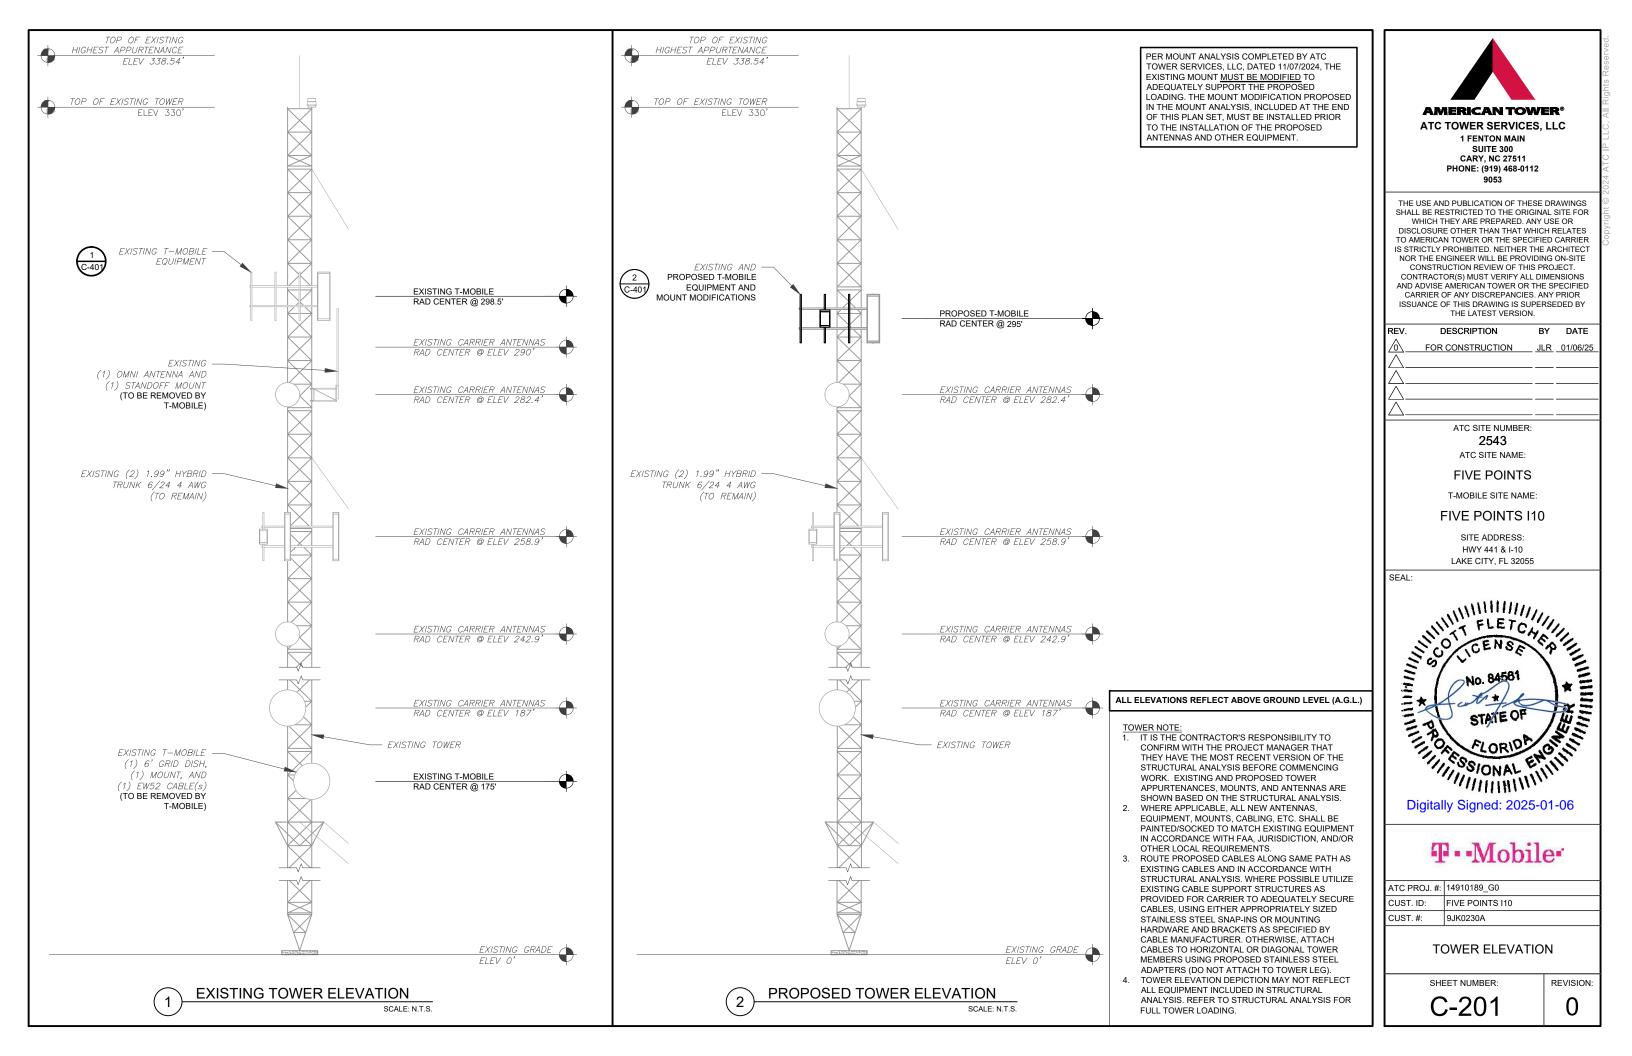$\bigcirc$	EQUIPMENT SCHEDULES
$\left( \circ \right)$	

FINAL FIBER DISTRIBUTION / OVP BO	ЭX	FINAL CABLING SUMMARY	
MODEL NUMBER	STATUS	CABLE QTY, SIZE, TYPE	STATUS
-	-	(2) 1.99" HYBRID TRUNK 6/24 4 AWG	RMN



1 FENTON MAIN SUITE 300 **CARY, NC 27511** PHONE: (919) 468-0112

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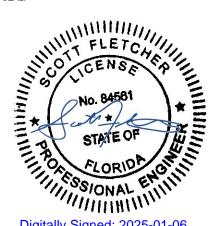
ATC SITE NUMBER: 2543 ATC SITE NAME:

FIVE POINTS

T-MOBILE SITE NAME:

**FIVE POINTS I10** 

SITE ADDRESS: HWY 441 & I-10 LAKE CITY, FL 32055



Digitally Signed: 2025-01-06

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ATC PROJ. #:	14910189_G0
CUST. ID:	FIVE POINTS I10
CUST. #:	9JK0230A


ANTENNA INFORMATION & SCHEDULE

SHEET NUMBER:

C-401

REVISION: 0

EXISTING/PROPOSED MOUNTS AND/OR MOUNT MODIFICATIONS NOT SHOWN FOR CLARITY. REFER TO ANTENNA PLANS, MOUNT ANALYSES AND/OR MOUNT MODIFICATION DOCUMENTS FOR ADDITIONAL DETAIL.

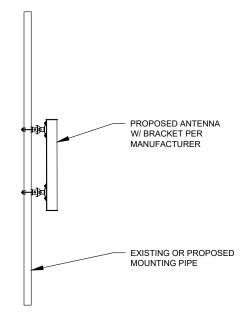

PROPOSED 5G ANTENNA MOUNTING DETAIL - TYPICAL SCALE: N.T.S.



1 FENTON MAIN SUITE 300 CARY, NC 27511 PHONE: (919) 468-0112

THE USE AND PUBLICATION OF THESE DRAWINGS SHALL BE RESTRICTED TO THE ORIGINAL SITE FOR WHICH THEY ARE PREPARED. ANY USE OR DISCLOSURE OTHER THAN THAT WHICH RELATES TO AMERICAN TOWER OR THE SPECIFIED CARRIER IS STRICTLY PROHIBITED. NEITHER THE ARCHITECT NOR THE ENGINEER WILL BE PROVIDING ON-SITE CONSTRUCTION REVIEW OF THIS PROJECT. CONTRACTOR(S) MUST VERIFY ALL DIMENSIONS AND ADVISE AMERICAN TOWER OR THE SPECIFIED CARRIER OF ANY DISCREPANCIES. ANY PRIOR ISSUANCE OF THIS DRAWING IS SUPERSEDED BY THE LATEST VERSION.

REV.	DESCRIPTION	BY	DATE
$\triangle_{-}$	FOR CONSTRUCTION	JLR	01/06/25
$\wedge_{-}$			
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2543

ATC SITE NAME:


FIVE POINTS

ATC SITE NUMBER:

T-MOBILE SITE NAME:

FIVE POINTS I10

SITE ADDRESS: HWY 441 & I-10 LAKE CITY, FL 32055

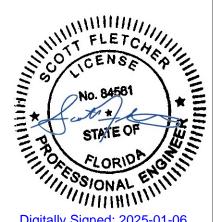

Digitally Signed: 2025-01-06

# T. Mobile


l	ATC PROJ. #:	14910189_G0
l	CUST. ID:	FIVE POINTS I10
l	CUST. #:	9JK0230A
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CONSTRUCTION **DETAILS** 

SHEET NUMBER:


C-501

REVISION 0

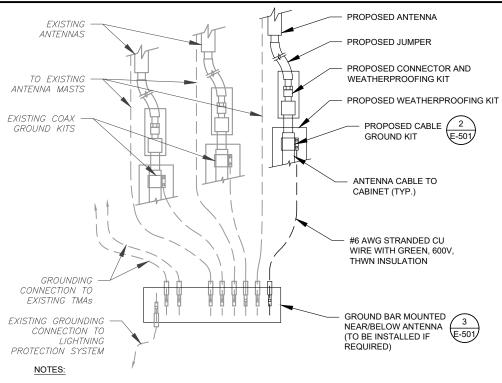

- THIS DETAIL IS INTENDED TO SHOW THE GENERAL GROUNDING REQUIREMENTS. SLIGHT ADJUSTMENTS MAY BE REQUIRED BASED ON EXISTING SITE CONDITIONS. THE CONTRACTOR SHALL MAKE FIELD ADJUSTMENTS AS NEEDED AND INFORM THE CONSTRUCTION MANAGER OF ANY CONFLICTS.
- 2. SITE GROUNDING SHALL COMPLY WITH T-MOBILE GROUNDING STANDARDS, LATEST EDITION, AND COMPLY WITH T-MOBILE GROUNDING CHECKLIST, LATEST VERSION. WHEN NATIONAL AND LOCAL GROUNDING CODES ARE MORE STRINGENT THEY SHALL GOVERN.



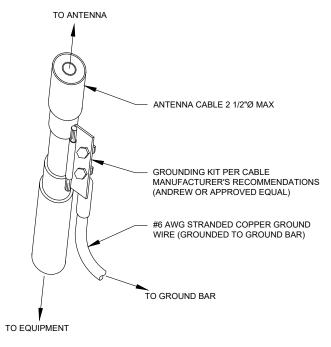


- <u>GROUND KIT NOTES:</u>

  1. DO NOT INSTALL CABLE GROUND KIT AT A BEND AND ALWAYS DIRECT GROUND WIRE DOWN TO GROUND BAR.
- 2. CONTRACTOR SHALL PROVIDE WEATHERPROOFING KIT (ANDREW PART NUMBER 221213) AND INSTALL/TAPE PER MANUFACTURER'S SPECIFICATIONS




	STANDARD CONDUIT USE TABLE				
CONDUIT TYPE	USE CASE	LOCATION	USE CASE EXAMPLE		
RMC (METALLIC)	AC, DC COMM	ABOVE GROUND	ABOVE GROUND PPC TO SSC		
PVC	AC POWER	UNDERGROUND	UNDERGROUND PPC TO SSC OR BACKHAUL TRANSPORT HUB TO SSC		
LFMC	AC, DC, COMM	MAX 6' PER CONDUIT RUN, ABOVE GROUND ONLY	TIGHT LOCATIONS BETWEEN HUB AND CONDUIT BUT NOT TO BE USED WHERE IT CAN BE STEPPED ON		
EMT	INDOOR AC, DC COMM	INDOOR NOT EXPOSED TO THE OUTDOOR ENVIRONMENT (MUST BE DRY)	CIRCUIT PANEL TO JUNCTION BOX		
LFNC	GROUND WIRE	CONCEALING AND PROTECTING BTCW RISERS ONLY	GROUND RING TO MGB OR SSC		

	EXCEPTION CONDUIT USE TABLE				
CONDUIT TYPE	USE CASE	LOCATION	USE CASE EXAMPLE		
EMT (NOT PREFERRED)	OUTDOOR DC, COMM	OUTDOOR WHEN USED WITH WATERTIGHT HUBS ONLY	BETWEEN EQUIPMENT AND BATTERY CABINET OR EQUIPMENT TO EQUIPMENT CABINETS FOR INTER CABINET CONNECTION		
RMC NONMETALLIC (ALUMINUM)	OUTDOOR/INDOOR PER NEC GUIDLINES	ABOVE GROUND	MAT BE USED AS A LOWER COST ALTERNATIVE TO METALLIC RMC, MUST MEET OR EXCEED FEDERAL SPEC: WW-C-540C, UL-6A, ANSI C80.5, NEC 344.10 (A) ALLOWS THE USE OF EITHER ALUMINUM OR GALVANIZED FITTINGS		

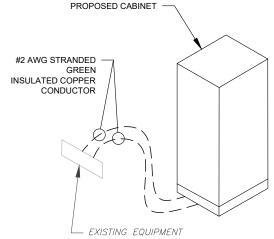


CABINET GROUNDING DETAIL 5

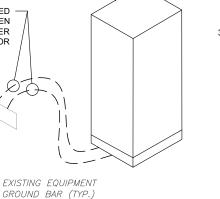

# FOR SPECIFIC CABINET / ANCILLARY EQUIPMENT WIRING

VOLTS	OCPD SIZE	WIRE SIZE	GROUND	CONDUIT
	80A/2P	3-#3 AWG	#8 AWG	1-1/4"
120/240V	100/2P	3-#2 AWG	#8 AWG	1-1/4"
OR	125A/2P	3-#3/0 AWG	#6 AWG	2"
120/208V	150A/2P	3-#3/0 AWG	#6 AWG	2"
	200A/2P	3-#3/0 AWG	#6 AWG	2"
	80A/2P	2-#3 AWG	#8 AWG	1-1/4"
240V	100/2P	2-#2 AWG	#8 AWG	1-1/4"
OR 208V	125A/2P	2-#3/0 AWG	#6 AWG	2"
	150A/2P	2-#3/0 AWG	#6 AWG	2"
	200A/2P	2-#3/0 AWG	#6 AWG	2"

**ELECTRICAL NOTES** 

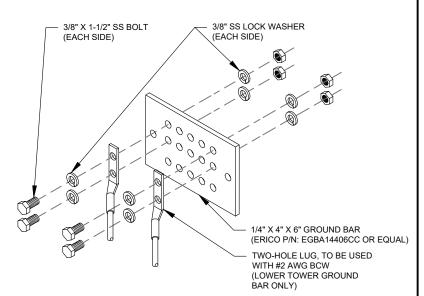

#### **GROUND BAR NOTES:**

- GROUND BAR KITS COME WITH ALL HARDWARE, NUTS, BOLTS, WASHERS, ETC. EXCEPT THE STRUCTURAL MOUNTING MEMBER(S).
- 2. GROUND BAR TO BE BONDED DIRECTLY TO TOWER.

# **TOWER GROUND BAR DETAIL**

#### **ELECTRICAL NOTES:**

- IT IS THE RESPONSIBILITY OF THE CONTRACTOR TO COORDINATE WITH THE T-MOBILE REPRESENTATIVE AND LOCAL UTILITY COMPANY FOR THE INSTALLATION OF CONDUITS, CONDUCTORS, BREAKERS, DISCONNECTS, OR ANY OTHER EQUIPMENT REQUIRED FOR ELECTRICAL SERVICE. ALL ELECTRICAL WORK SHALL BE PERFORMED IN ACCORDANCE WITH LATEST EDITION OF THE STATE AND NATIONAL CODES, ORDINANCES AND REGULATIONS APPLICABLE TO THIS PROJECT.
- ATC HAS NOT VERIFIED ANY EXISTING T-MOBILE GROUND EQUIPMENT OR ELECTRICAL LOADING. PROPOSED WORK BASED ON INSTALLATION CONFIGURATION PROVIDED BY T-MOBILE. CONTRACTOR TO VERIFY EXISTING T-MOBILE PANEL HAS SUFFICIENT SPACE FOR PROPOSED BREAKER. PROPOSED CABLE AND CONDUIT SHALL BE MINIMUM SIZE PER BELOW IN CHART.
- REQUIREMENTS, THE T-MOBILE CONTRACTOR SHOULD REFERENCE DESIGN DOCUMENTS PROVIDED BY T-MOBILE FOR THIS CURRENT PROJECT CONFIGURATION, IN ACCORDANCE WITH LOCAL JURISDICTION REQUIREMENTS & NEC STANDARDS & PRACTICES.

VOLTS	OCPD SIZE	WIRE SIZE	GROUND	CONDUIT
	80A/2P	3-#3 AWG	#8 AWG	1-1/4"
120/240V	100/2P	3-#2 AWG	#8 AWG	1-1/4"
OR	125A/2P	3-#3/0 AWG	#6 AWG	2"
120/208V	150A/2P	3-#3/0 AWG	#6 AWG	2"
	200A/2P	3-#3/0 AWG	#6 AWG	2"
	80A/2P	2-#3 AWG	#8 AWG	1-1/4"
240V	100/2P	2-#2 AWG	#8 AWG	1-1/4"
OR	125A/2P	2-#3/0 AWG	#6 AWG	2"
208V	150A/2P	2-#3/0 AWG	#6 AWG	2"
	200A/2P	2-#3/0 AWG	#6 AWG	2"

ATC TOWER SERVICES, LLC 1 FENTON MAIN SUITE 300 **CARY, NC 27511** PHONE: (919) 468-0112

**AMERICAN TOWER** 

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DESCRIPTION	BY	DATE
FOR CONSTRUCTION	JLR	01/06/25


ATC SITE NUMBER: 2543 ATC SITE NAME:

**FIVE POINTS** 

T-MOBILE SITE NAME

#### **FIVE POINTS I10**

SITE ADDRESS: HWY 441 & I-10 LAKE CITY, FL 32055

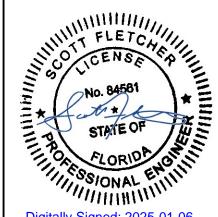

Digitally Signed: 2025-01-06



ATC PROJ. #:	14910189_G0
CUST. ID:	FIVE POINTS I10
CUST. #:	9JK0230A


**GROUNDING DETAILS** 

SHEET NUMBER

E-501

REVISION 0

CONDUIT USE TABLES

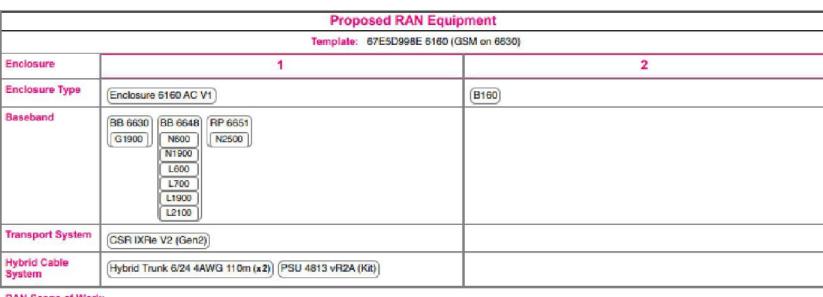


RAN Scope of Work:

4/28/21-(EMS)-Adjust RAD to 295

We have received your RFDS and upon review have identified some additional information needed to draft an application:

• RFDS RAD Feasibility: The new larger panels will physically interfere with another customer. We can lower their RAD to 295. Or they can install smaller panels.

CABINET CONFIGURATION

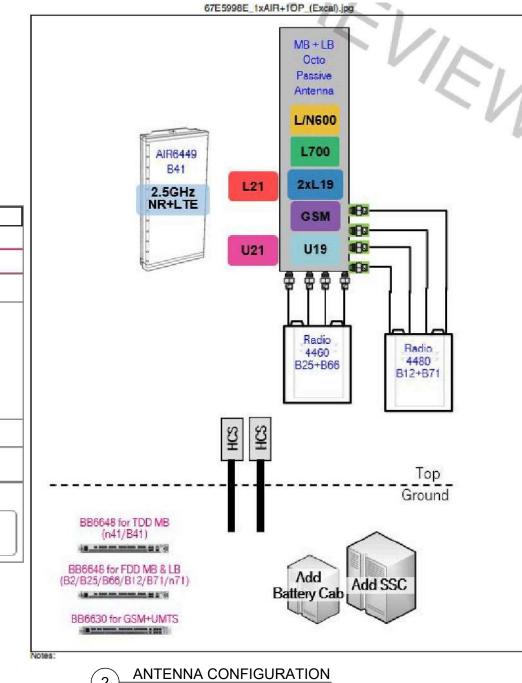

SUPPLEMENTAL


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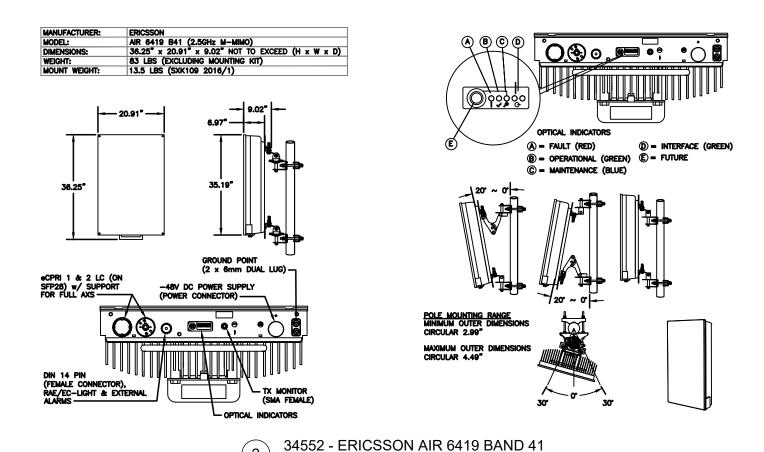
NOTE: THIS SHEET CREATED BY OTHERS AND PROVIDED

BY REQUEST OF CUSTOMER WITHOUT EDIT.

R-601

REVISION: 0



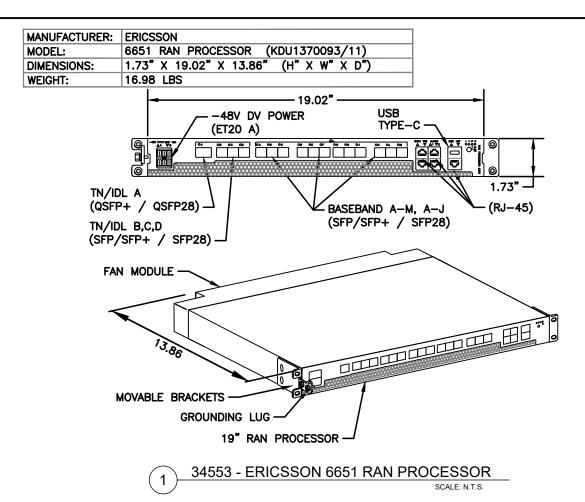

SUPPLEMENTAL

SHEET NUMBER: REVISION: 
R-602 0



#### **Mount Analysis Report**

Mount Type : 13 ft V-Frame

ATC Asset Name : Five Points

ATC Asset Number : 2543

**Engineering Number** : 14910189\_C8\_01

**Mount Elevation** : 294.5 ft

**Proposed Carrier** : T-Mobile

**Carrier Site Name** : Five Points I10

**Carrier Site Number** : 9JK0230A

Site Location : Hwy 441 & I-10

Lake City, FL 32055-4662

30.2382, -82.6368

County : Columbia

Date : November 6, 2024

Max Usage : 71%

**Analysis Result** : Contingent Pass

Prepared By: Justin York

Structural Engineer



Sarah Rucker Date: 2024.11.07 10:02:04

COA: 9053

ATC Tower Services, LLC - 1 Fenton Main, Suite 300 - Cary, NC 27511 - 919.468.0112 Office - 919.466.5414 Fax - www.americantower.com



Eng. Number 14910189\_C8\_01 November 6, 2024 Page 3

#### Introduction

The purpose of this report is to summarize results of the mount analysis performed for T-Mobile at 294.5 ft.

#### **Supporting Documents**

Specifications Sheet:	Sabre C10857007C, dated February 29, 2016	
Radio Frequency Data Sheet:	RFDS ID #9JK0230A, dated October 1, 2024	
Reference Photos:	Site photos from 2023	

#### **Analysis**

This mount was analyzed using American Tower Corporation's Mount Analysis Program and RISA-3D

Basic Wind Speed:	119 mph (3-Second Gust)
Basic Wind Speed w/ Ice:	No Ice Considered
Codes:	ANSI/TIA-222-H / 2021 IBC / 8th ED (2023) Florida Building Code
Exposure Category:	C
Risk Category:	II .
Topographic Factor Procedure:	Method 2
Feature:	Flat
Crest Height (H):	0 ft
Crest Length (L):	0 ft
Spectral Response:	Ss = 0.087, S1 = 0.051
Site Class:	D - Stiff Soil - Default
Live Loads:	Lm = 500 lbs, Lv = 250 lbs

<sup>\*</sup>Live Load(s) reduction is confirmed to either not govern or not be applicable

#### Conclusion

Based on the analysis results, the antenna mount meets the requirements per the applicable codes listed above provided the modifications listed below are completed:

- Relocate all tiebacks from adjacent sector, to adjacent tower leg. Field cut tie-back to length. Connect using existing hardware.
- Replace mount pipe in position 1 through 4 with P2.5 (2.875" x 120"). Connect with Site Pro 1 SCX7-U (or approved equivalent) crossover plate kits.
- A structural failure was addressed with the noted contingencies. The controlling member was a Horizontal with a usage of 110%.

If you have any questions or require additional information, please reach out to your American Tower contact. If you do not have an American Tower contact and have an Engineering question, please contact

MountAnalysis@americantower.com. Please include the American Tower site name, site number, and engineering number in the subject line for any questions.

ATC Tower Services, LLC - 1 Fenton Main, Suite 300 - Cary, NC 27511 - 919.468.0112 Office - 919.466.5414 Fax - www.americantower.com

NOTE: THIS SHEET WAS CREATED BY OTHERS AND PROVIDED AT THE REQUEST OF THE CUSTOMER WITHOUT EDIT. PLEASE REFERENCE THE MOUNT ANALYSIS REPORT FOR COMPLETE MOUNT

CONSTRUCTION DRAWINGS ARE FOR REFERENCE ONLY. GENERAL CONTRACTOR IS TO

ANALYSIS CALCULATIONS AND DETAILS. SUPPLEMENTAL PAGES INCLUDED IN THE

VERIFY THEY HAVE THE MOST RECENT MOUNT ANALYSIS PRIOR TO CONTRUCTION.

SUPPLEMENTAL

SHEET NUMBER:

R-603

**MOUNT ANALYSIS**