# PROPOSED AUDITION JAMES AND DANE PARKS RESIDENCE

168 SE OLUSTEE AVENUE, LAKE CITY, FL 32025

### PARCEL NUMBER

34-3\$-17-07160-000

THE EXISTING CONDITIONS AS SHOWN ON THIS SITE PLAN AND OTHER DRAWINGSID DETAILS IN THIS PLAN SET ARE FROM SURVEY PLATS AND VERIFIED BY FIELD MEASUREMENTS. STRUCTURAL PLAN SERVICES, INC. TAKES NO

### **DESIGN CRITERIA**

| CONSTRUCTION TYPE: V-B             |               |
|------------------------------------|---------------|
| WIND SPEED = 110 MPH (3 SEC. GUST) |               |
| WIND IMPORTANCE FACTOR = 1.0       |               |
| WIND EXPOSURE = CATEGORY B         |               |
| INTERNAL PRESSURE COEFF. = 0.18    |               |
| COMPONENTS AND CLADDING (PSF)      |               |
| ROOF =                             | +14.9 / -50.1 |
|                                    |               |

| COMPONENTS AND CLADDING (PSF) |                    |
|-------------------------------|--------------------|
| ROOF =                        | +14.9 / -50.       |
| WALL =                        | +25.9 / -34.       |
| SLIDING GL. DOOR =            | +26.9 / -34.       |
| WINDOWS =                     | +25.9 / -34.3      |
| ASSUMED LOAD BEARING CAPACITY | OF SOIL - 2000 PSF |

| LIVE LOADS                                |        |  |
|---|--------|--|
| ROOF =                                    | 20 PSF |  |
| FLOORS, STAIRS =                          | 40 PSF |  |
| DECKS, BALCONY =                          | 60 PSF |  |
| ATTIC, UNIHABITABLE,<br>WITHOUT STORAGE = | 10 PSF |  |
| WITH STORAGE =                            | 20 PSF |  |
| DEAD LOADS                                |        |  |
| ROOF =                                    | 7 PSF  |  |
| CEILING -                                 | 10 DCE |  |

### **GENERAL MASONRY NOTES**

- \* FLORIDA BUILDING CODE RESIDENTIAL 2007 WITH 2009 SUPPLEMENTS
- \* FLORIDA BUILDING CODE EXISTING 2007 WITH 2009 SUPPLEMENTS \* BUILDING CODE REQUIREMENTS FOR REINFORCED CONCRETE (ACI 318-98)
- \* AMERCIAN SOCIETY OF CIVIL ENGINEERS MINIIMUM DESIGN LOADS FOR BUILDS AND OTHER STRUCTURES (ASCE 7-05)

### CONCRETE

- \* CONCRETE COMPRESSIVE STRENGTH AT 28 DAYS:
- PRECAST W/ STD. REINFORCEMENT 3500 PSI
- PRECAST W/ PRESTRESSED REINFORCEMENT 5000 PSI
- CONCRETE FILL (PLACED IN FIELD) 3000 PSI \* REINFORCING BARS
- PRESTRESSED STRANDS ASTM A416 7-WIRE FIELD PLACED ASTM 615 GRADE 40
- DETAIL REINFORCEMENT IN ACCORDANCE WITH ACI 315 \* CONCRETING OPERATIONS SHALL COMPLY WITH ACI STANDARDS

- \* DESIGN AND CONSTRUCTION SHALL CONFORM TO THE SPECIFICATION OF THI
- NATIONAL CONCRETE MASONRY ASSOCIATION AND ACI 530 \* MINIMUM MASONRY UNIT STRENGTH - fm 1250 PSI \* MORTAR SHALL BE TYPE S

### STRUCTURAL

\* SAFE LOAD TABLES ARE BASED ON LINTELS HAVING A BEARING OF 8" (WITH A MINIMUM ACCEPTABLE BEARING OF 4" PER SECTION 2101.3.1 OF THE 2007 FLORIDA RESIDENTIAL BUILDING CODE (WITH 2009 REVISIONS)

- \* CONTRACTOR/MASON TO VERIFY ALL LINTEL SPANS PRIOR TO ORDERING OR
- \* ENGINEER OF RECORD MUST BE NOTIFIED IF THE GARAGE DOOR LINTEL IS LES THAN 8x17 COMPOSITE

### MISCELLANEOUS

- \* EXTRA MASONRY COURSES BETWEEN LINTEL AND BOND BEAM ARE DEEMED ACCEPTABLE IF POURED SOLID
- \* A SINGLE SOLID FILLED LINTEL OF THE SAME LENGTH MAY BE USED TO SEPARATE DOORS AND WINDOWS FROM TRANSOM ABOVE. TOP PRECAST LINTEL TO BE SIZED PER PLAN

### **GENERAL FRAMING NOTES**


- \* ALL LUMBER TO SOUTHERN YELLOW PINE No. 2 OR SPRUCE-PINE-FIR No. 2, MAXIMUM MOISTURE CONTENT OF 19%. EXTERIOR LUMBER AND LUMBER IN CONTACT WITH CONCRETE TO BE PRESSURE-TREATED.
- \* EXTERIOR WINDOWS AND GLASS DOORS MUST MEET THE REQUIREMENTS OF R-613-1 OF THE FLORIDA RESIDENTIAL BUILDING CODE 2007 EDITION IN
- R-613-1 EXTERIOR WINDOWS AND GLASS DOORS
- R-613.1.1 TESTING AND LABELING. EXTERIOR WINDOWS AND GLASS DOORS SHALL BE TESTED BY AN APPROVED INDEPENDENT TESTING LABORATORY AND BEAR AN AAMA OR WDMA OR OTHER APPROVED LABEL IDENTIFYING THE MANUFACTURER, PERFORMANCE CHARACTERISTICS, AND APPROVED PRODUCT EVALUATION ENTITY TO INDICATE COMPLIANCE WITH THE THE REQUIREMENTS OF THE FOLLOWING SPECIFICATION: WINDOWS - ANSI/AAMA/NWWDA 101/IS2 2/97.

### AREA SUMMARY

| EXISTING CONDITIONED AREA                | 1359 S.F. |  |
|--|-----------|--|
| EXISTING NON-CONDITIONED AREA            | 621 S.F.  |  |
| TOTAL EXISTING AREA UNDER ROOF           | 1980 S.F. |  |
| PROPOSED DEMOLITION AREA                 | 0 S.F.    |  |
| NET AREA UNDER ROOF                      |           |  |
| (PRIOR TO NEW CONSTRUCTION)              | 1980 S.F. |  |
| PROPOSED ADDITIONAL CONDITIONED AREA     | 80 S.F.   |  |
| PROPOSED ADDITIONAL NON-CONDITIONED AREA | 0 S.F.    |  |
| TOTAL PROPOSED ADDITIONAL AREA           | 80 S.F.   |  |
| POST-CONSTRUCTION CONDITIONED AREA       | 1439 S.F. |  |
| POST-CONSTRUCTION NON-CONDITIONED AREA   | 621 S.F.  |  |
| POST-CONSTRUCTION NET AREA UNDER ROOF    | 2060 S.F. |  |
|  |           |  |

### SHEET INDEX


- PROJECT DATA, SITE PLAN, GENERAL NOTES, DESIGN CRITERIA
- EXISTING/PROPOSED FLOOR PLANS AND ELEVATIONS
- FOUNDATION, ELECTRICAL, ROOF FRAMING PLANS & DETAILS

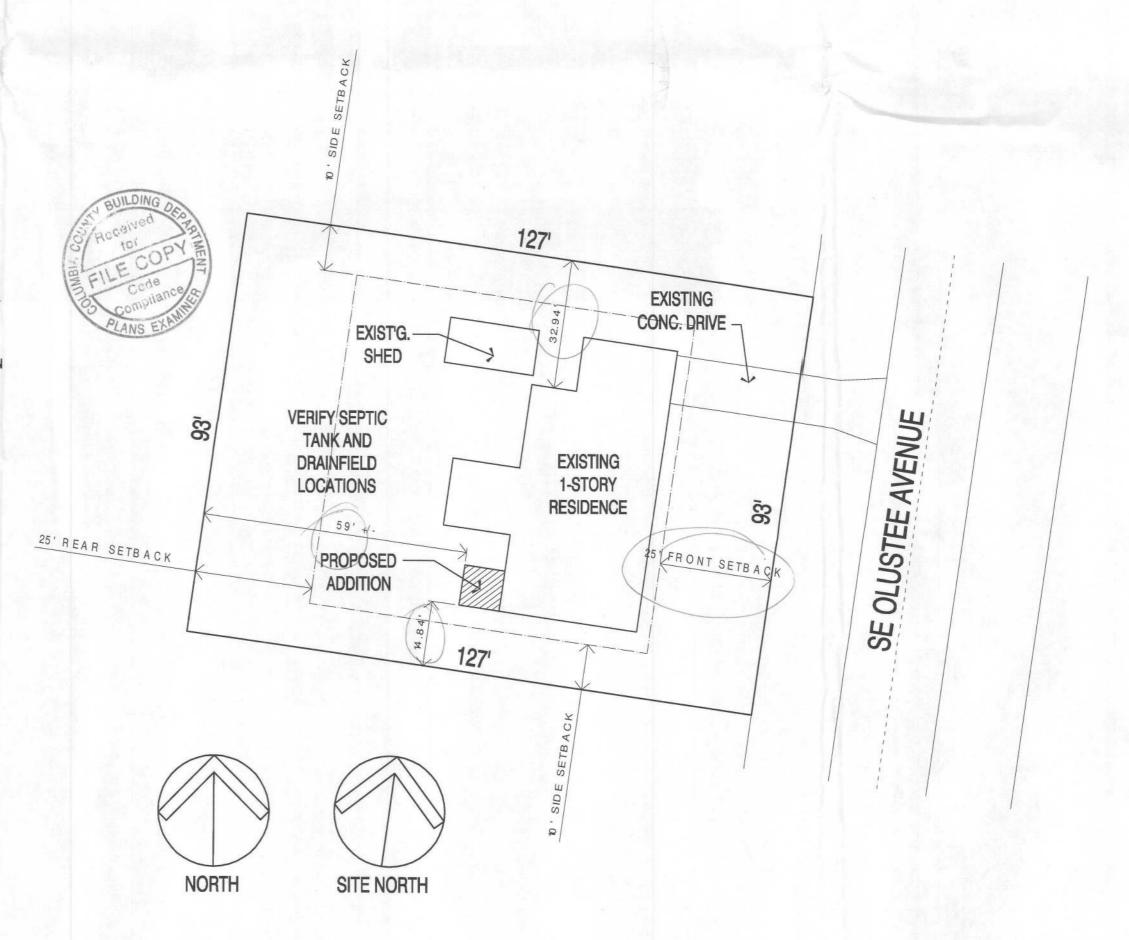

PROPOSED SITE PLAN

SCALE: 1" = 20'-0"

A 12.03.10 PERMIT SET

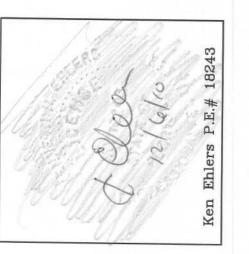


PETER WOODS, RESIDENTIAL DESIGNER 5524 PECAN RD., OCALA, FL 34472

SIDENCE AKE CITY, FL 3 PROPO( SE 168


SHEET NUMBER

OF 5 SHEETS PROJECT NO. 101101

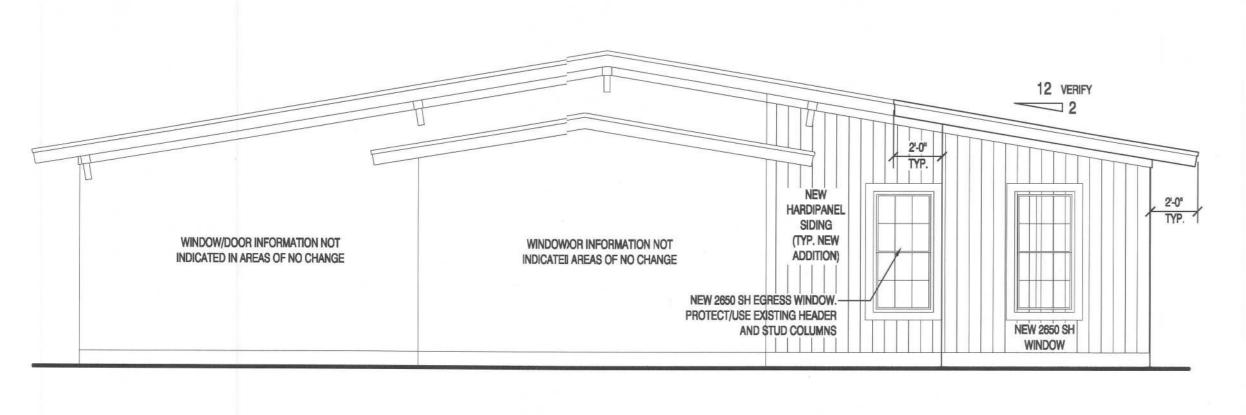

## PROPOSED PARTIAL WEST ELEVATION


SCALE: 1/4" = 1'-0"

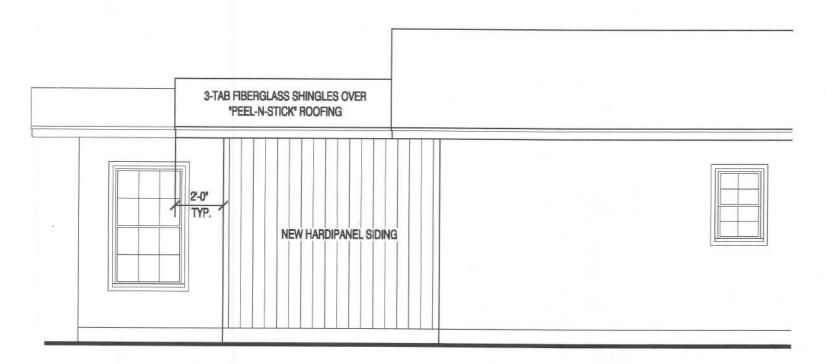


# PROP(SED PARTIAL SQU'H ELEVATION

PROPOSED PARTIAL NORTH ELEVATION


SCALE: 1/4" = 1'-0"

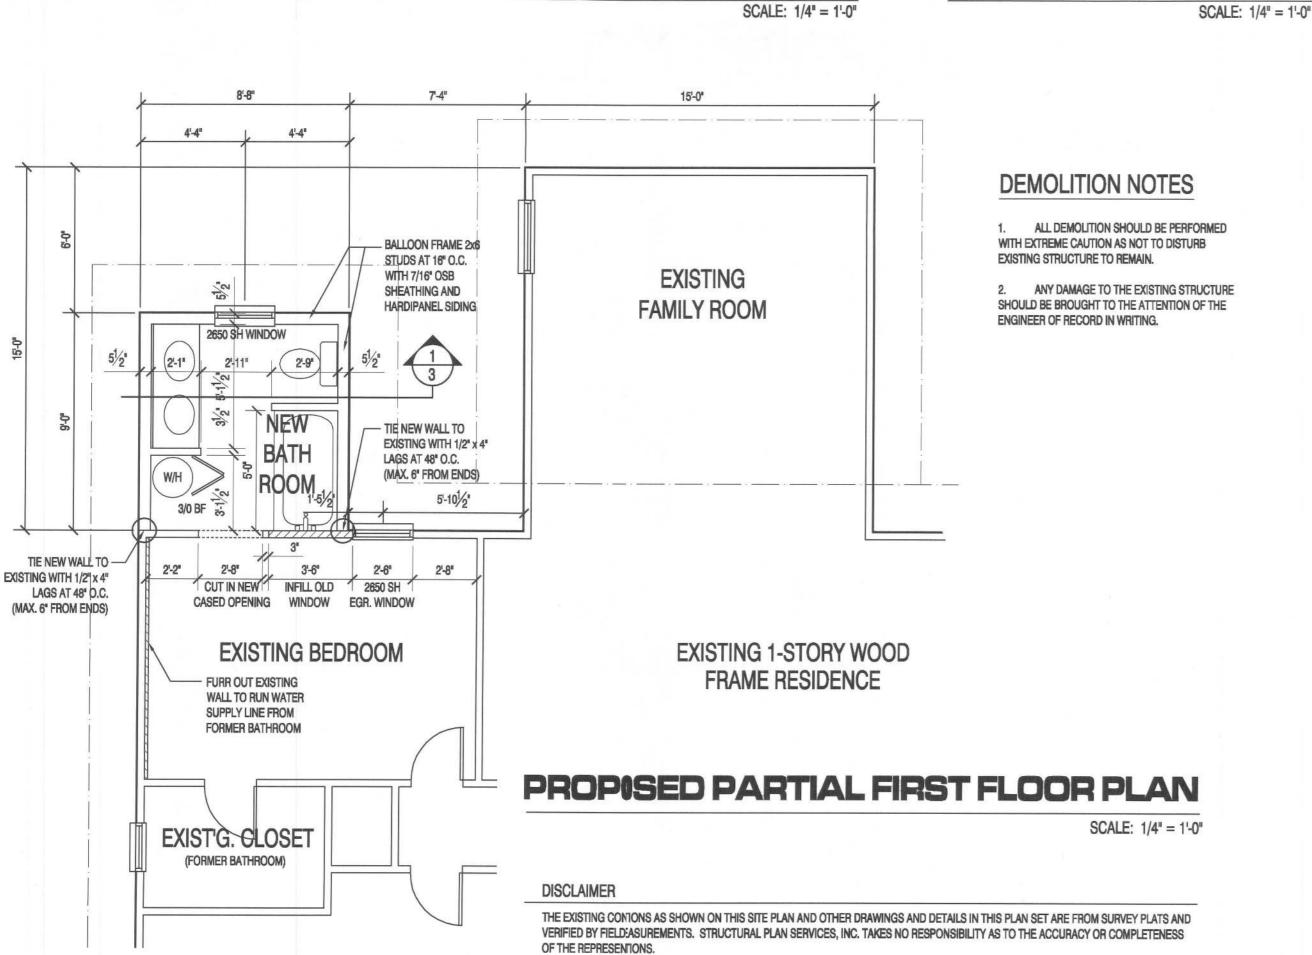

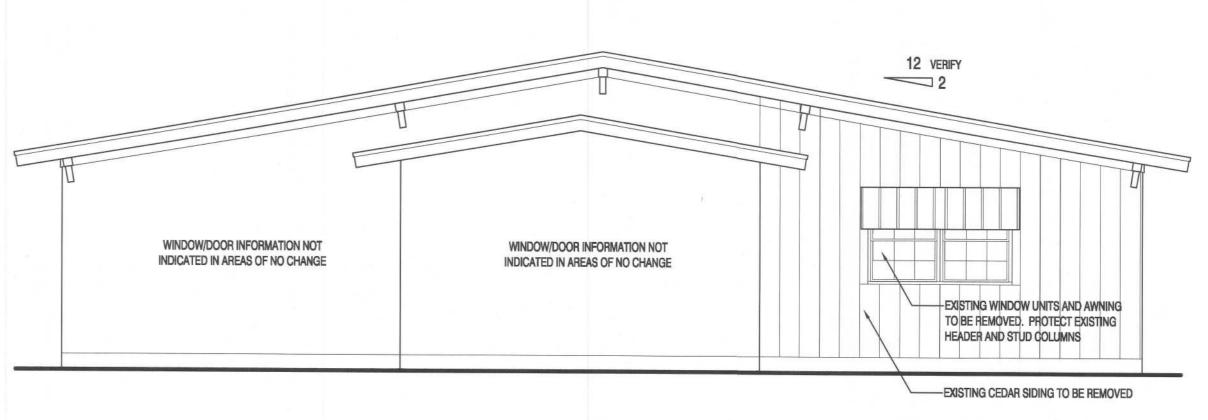


# **EXISTING PARTIAL WEST ELEVATION**

SCALE: 1/4" = 1'-0"

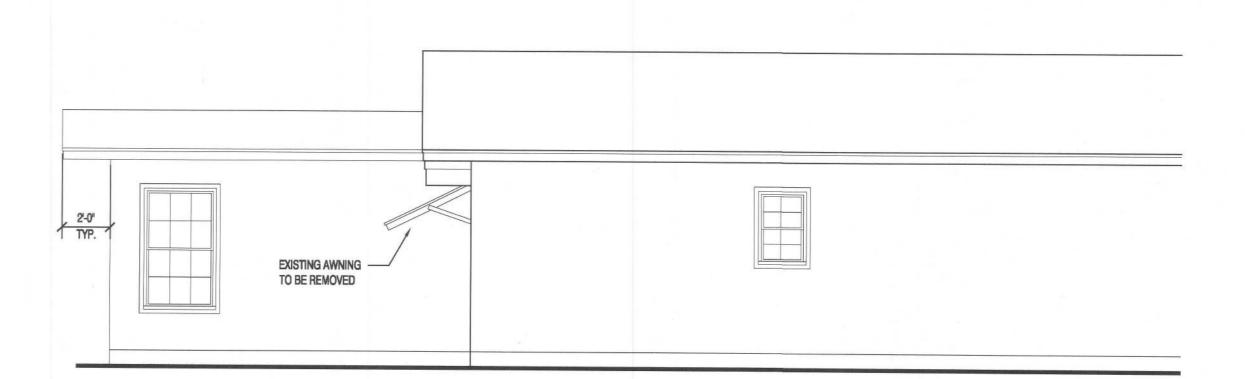

# **EXISTING PARTIAL SOUTH ELEVATION**

SCALE: 1/4" = 1'-0"

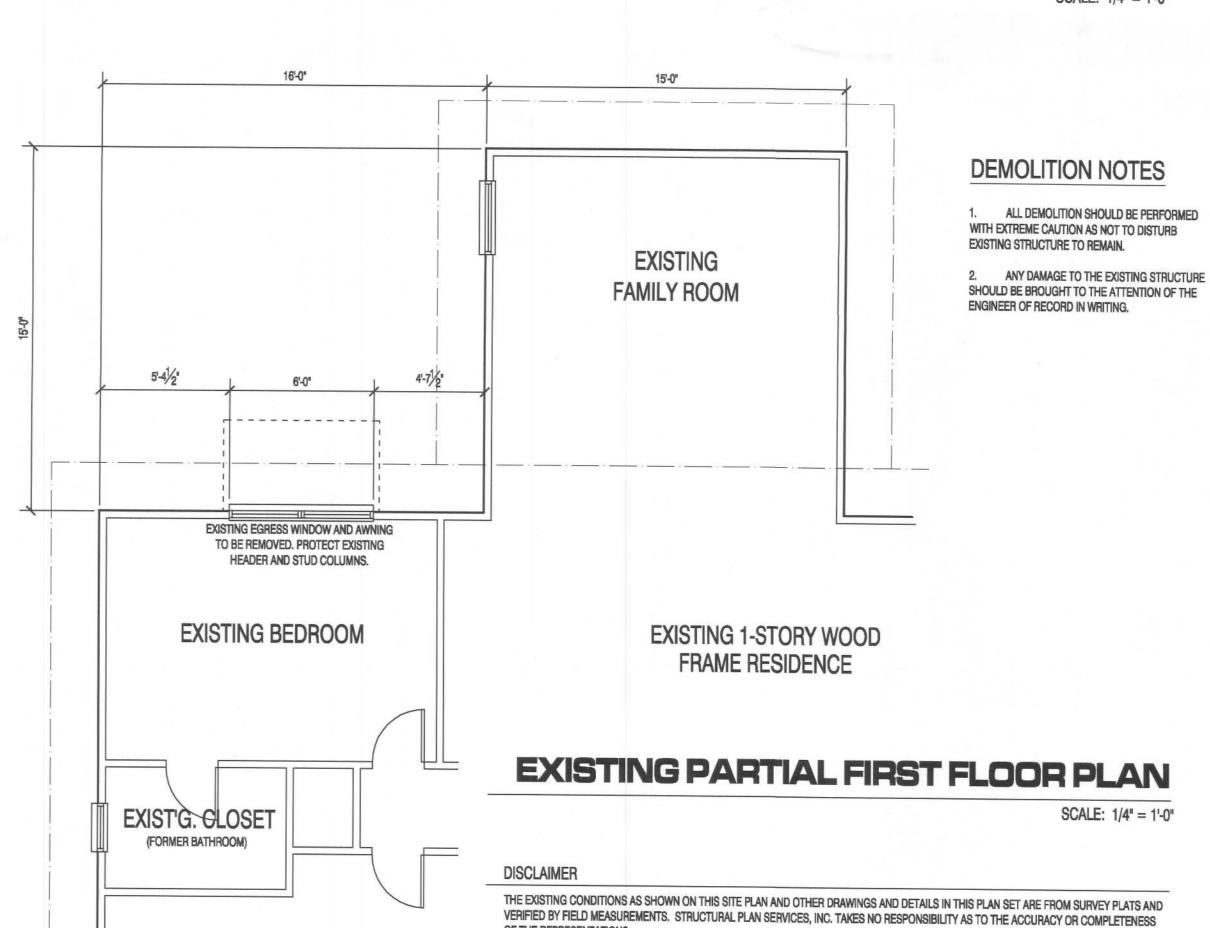

DATE REMARK A 12.03.10 PERMIT SET

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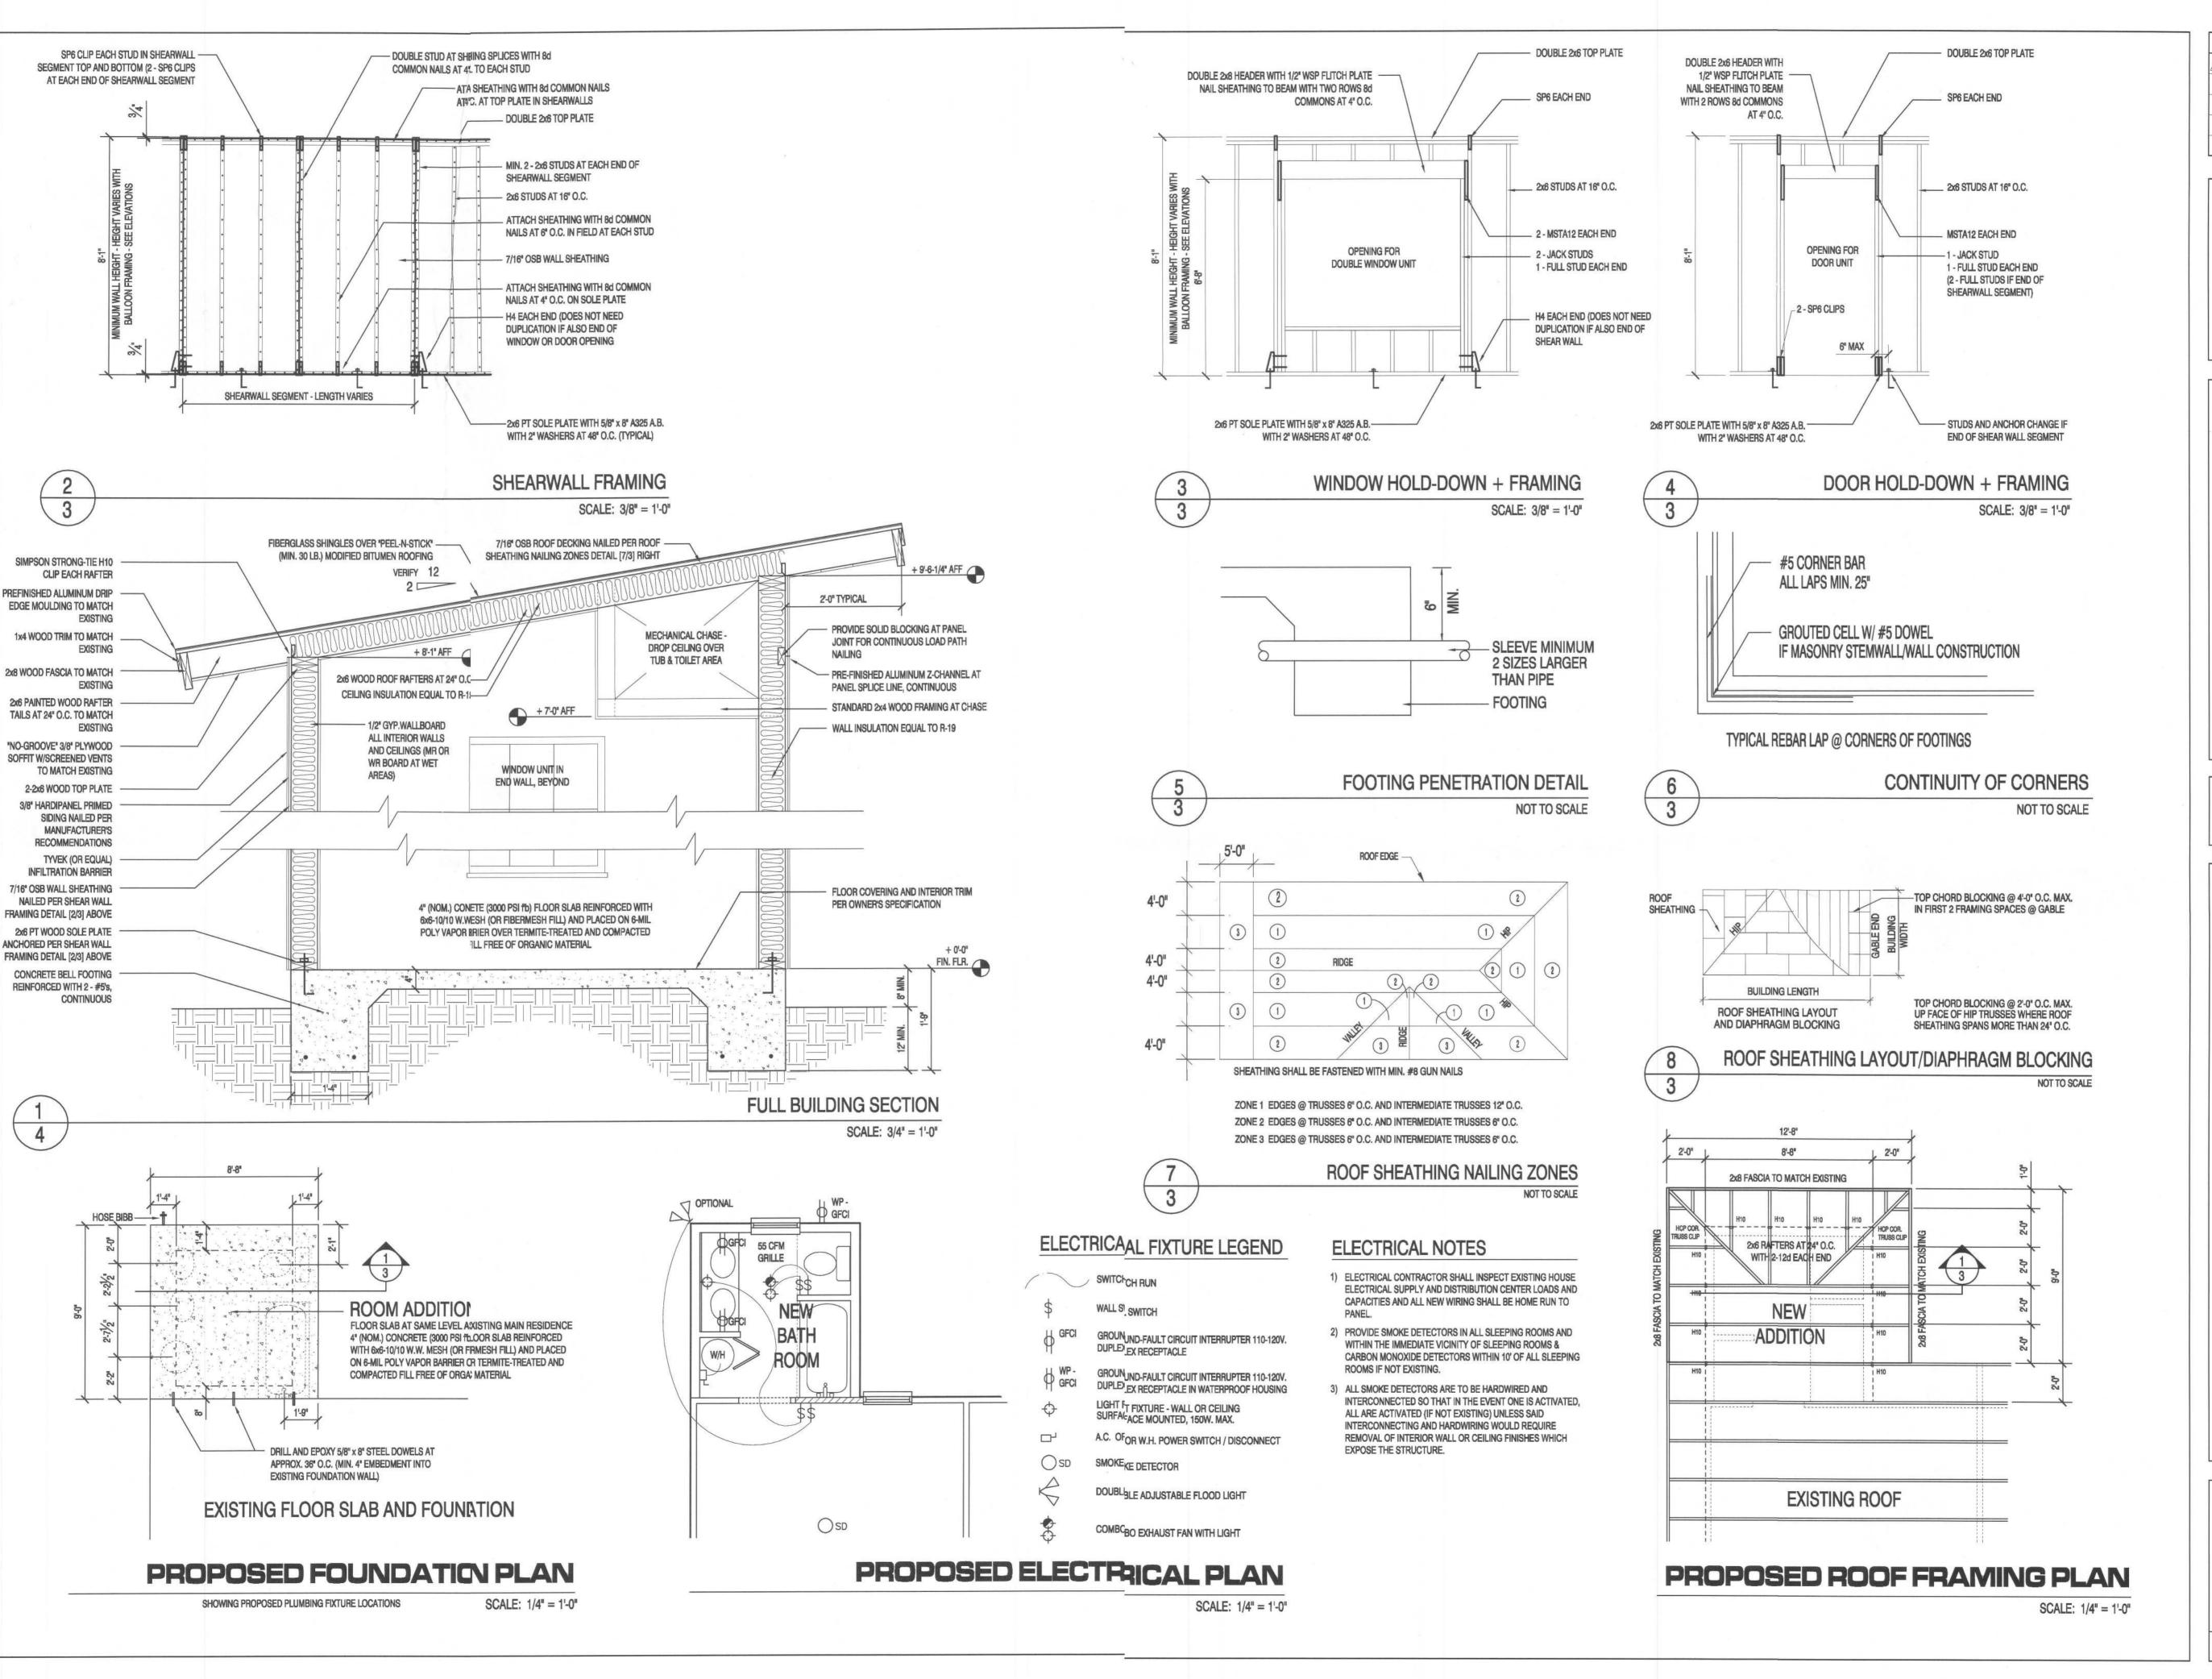
32024 AVE., LAKE CITY, FL 3. **ADDITION** SIDENCE SE OLUSTEE A PARCEL NO. **PROPOS** 

SHEET NUMBER

168

OF 3 SHEETS

PROJECT NO. 101101



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> 32024 E., LAKE CITY, FL 3

ADDITION SED SE OLUSTEE A PARCEL NO. PROPO( ARK 168

SHEET NUMBER

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