

ONE STORY WALL SECTION
SCALE: 3/4" = 1'-0"


EXTERIOR WALL STUD TABLE FOR SPF #2 STUDS

(1) 2x4 @ 16" OC	TO 11'-9" STUD HEIGHT
(1) 2x4 @ 12" OC	TO 13'-0" STUD HEIGHT
(1) 2x6 @ 16" OC	TO 18'-10" STUD HEIGHT
(1) 2x6 @ 12" OC	TO 20'-0" STUD HEIGHT


THIS STUD HEIGHT TABLE IS PER WFCM 2001, TABLE 3.20B. EXTERIOR LOAD BEARING & NON LOAD BEARING STUD LENGTHS RESISTING INTERIOR ZONE WIND LOADS 150 MPH EXPOSURE B. STUD SPACINGS SHALL BE MULTIPLIED BY 0.85 FOR FRAMING LOCATED WITHIN 4 FEET OF CORNERS FOR END ZONE LOADING. EXAMPLE 16" O.C. x 0.85 = 13.6" O.C.

CONTINUOUS FRAME TO CEILING DIAPHRAGM DETAIL
SCALE: N.T.S.

SCALE: N.T.S.

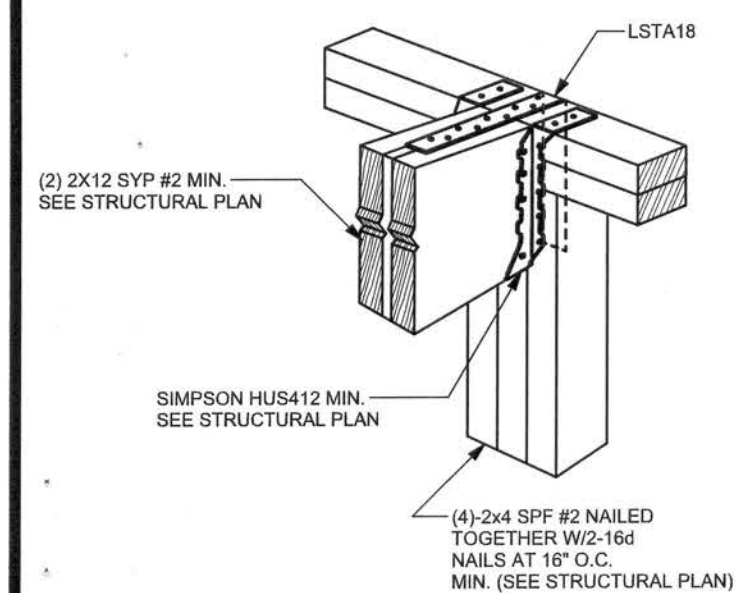


BEAM MID-WALL CONNECTION DETAIL
SCALE: N.T.S.

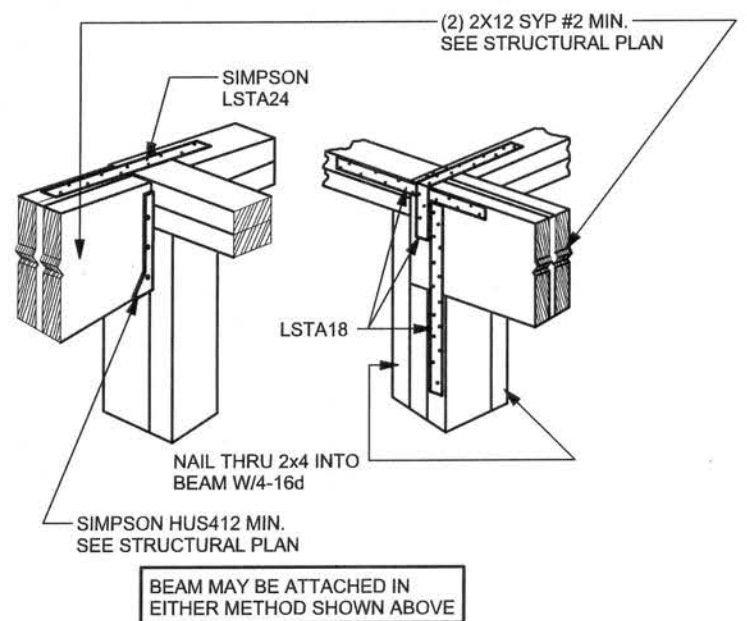

BEAM CORNER CONNECTION DETAIL
SCALE: N.T.S.


SUPPORTIVE CENTER POST TO BEAM DETAIL
SCALE: N.T.S.

SCALE: N.T.S.

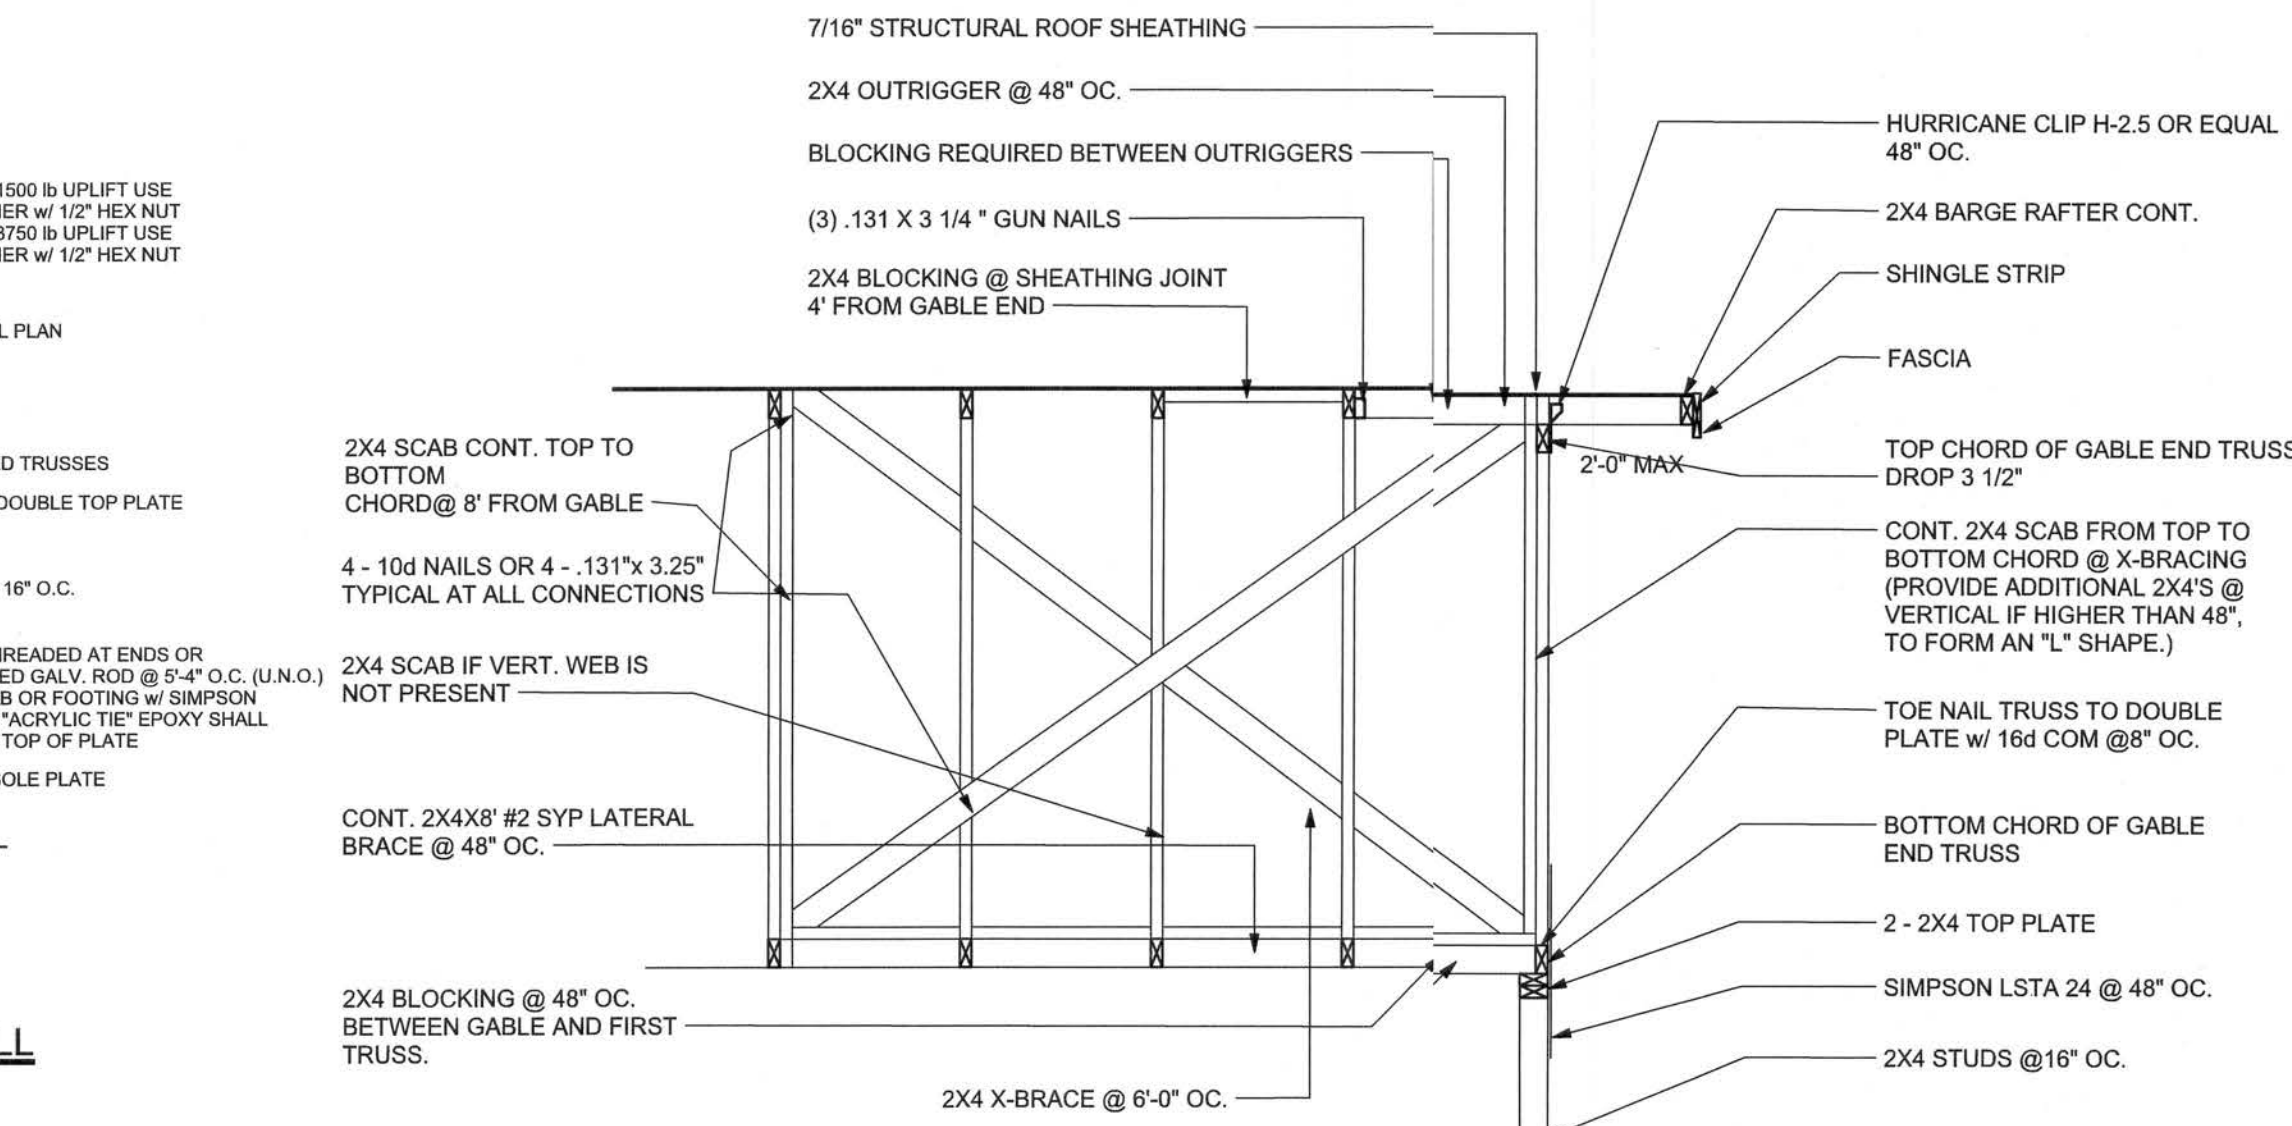

TYPICAL GABLE END (X-BRACING)

ALL MEMBERS SHALL BE SYP

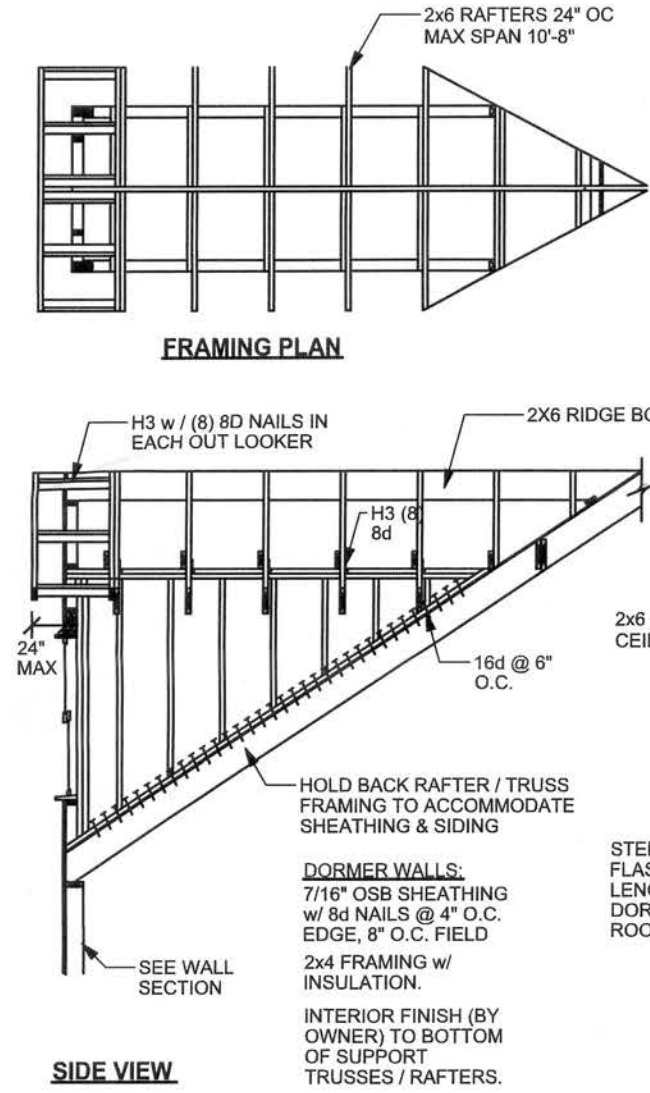


DORMER ANCHORING DETAIL (ON ROOF)
SCALE: N.T.S.

SCALE: N.T.S.

NOTE: IF TRUSS TO WALL STRAPS ARE NAILED TO THE HEADER THE SP4/6 @ 48\"/>

DORMER ANCHORING DETAIL (ON FLOOR)
SCALE: N.T.S.

SCALE: N.T.S.

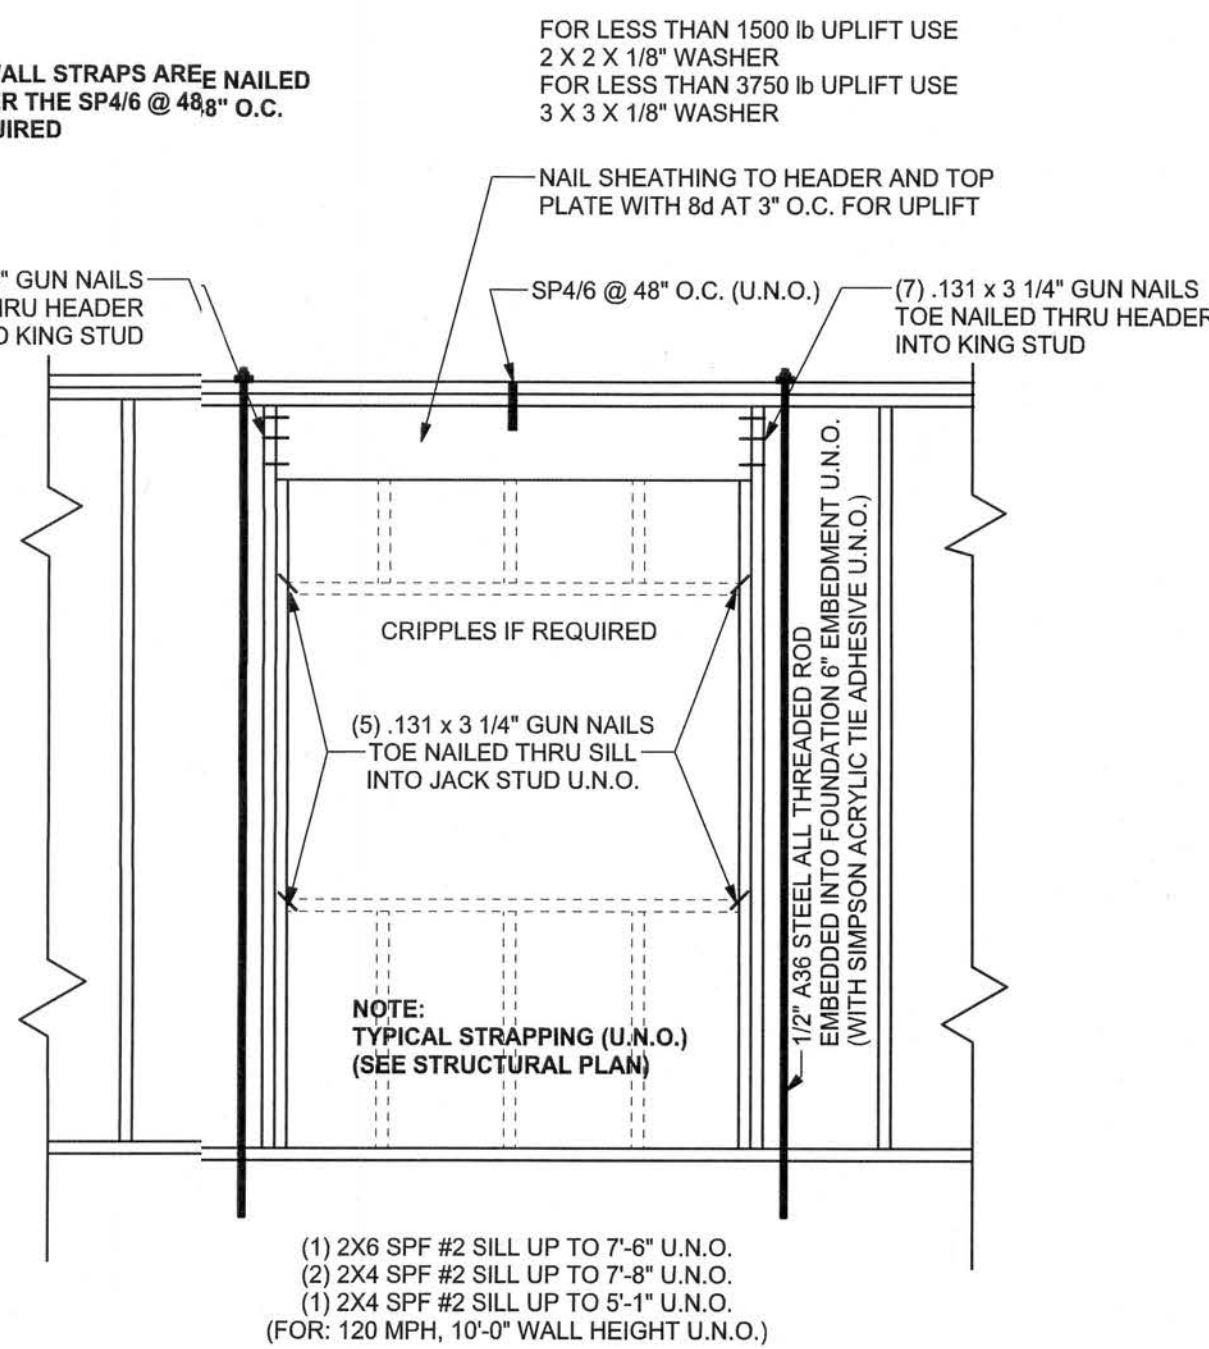

TYPICAL PORCH POST DETAIL
SCALE: 1/2\"/>

TYPICAL 1 STORY HEADER STRAPPING DETAIL
SCALE: 1/2\"/>

SCALE: 1/2" = 1'-0"

ANCHOR TABLE

OBTAIN UPLIFT REQUIREMENTS FROM TRUSS MANUFACTURER'S ENGINEERING

UPLIFT LBS. SYP	UPLIFT LBS. SPF	TRUSS CONNECTOR*	TO PLATES	TO RAFTER/TRUSS	TO STUDS
< 420	< 245	H5A	3-8d	3-8d	
< 455	< 265	H5	4-8d	4-8d	
< 360	< 235	H4	4-8d	4-8d	
< 455	< 320	H3	4-8d	4-8d	
< 415	< 365	H2.5	5-8d	5-8d	
< 600	< 535	H2.5A	5-8d	5-8d	
< 590	< 620	H8	8-8d	8-8d	
< 745	< 565	H8	5-10d, 1 1/2"	5-10d, 1 1/2"	
< 1465	< 1050	H14	12-8d, 1 1/2"	12-8d, 1 1/2"	
< 1465	< 1050	H14-2	12-8d, 1 1/2"	12-8d, 1 1/2"	
< 590	< 650	H10-1	8-8d, 1 1/2"	8-8d, 1 1/2"	
< 760	< 655	H10-2	8-10d	6-10d	
< 1470	< 1265	H16-1	10-10d, 1 1/2"	2-10d, 1 1/2"	
< 1470	< 1265	H16-2	10-10d, 1 1/2"	2-10d, 1 1/2"	
< 1000	< 860	MTS24C	7-10d 1 1/2"	7-10d 1 1/2"	
< 1450	< 1245	HTS24	12-10d 1 1/2"	12-10d 1 1/2"	
< 2900	< 2490	2-HTS24			
< 2050	< 1785	LG72	14-16d	14-16d	
HEAVY GIRDER TIEDOWNS*					
< 3965	< 3330	MG7		22-10d	1-5/8" THREADED ROD 12" EMBEDMENT
< 10980	< 6485	HGT-2		16-10d	2-5/8" THREADED ROD 12" EMBEDMENT
< 10530	< 9035	HGT-3		16-10d	2-5/8" THREADED ROD 12" EMBEDMENT
< 9250	< 9250	HGT-4		16-10d	2-5/8" THREADED ROD 12" EMBEDMENT
STUD STRAP CONNECTOR*					
< 435	< 435	SSP DOUBLE TOP PLATE	3-10d		4-10d
< 455	< 420	SSP SINGLE SILL PLATE	1-10d		4-10d
< 825	< 825	DSP DOUBLE TOP PLATE	6-10d		8-10d
< 825	< 600	DSP SINGLE SILL PLATE	2-10d		8-10d
< 885	< 760	SP4			6-10d, 1 1/2"
< 1240	< 1065	SPH4			10-10d, 1 1/2"
< 885	< 760	SP6			6-10d, 1 1/2"
< 1240	< 1065	SPH6			10-10d, 1 1/2"
< 1235	< 1165	LSTA18	14-10d		
< 1235	< 1235	LSTA21	16-10d		
< 1030	< 1030	CS20	18-8d		
< 1705	< 1705	CS16	28-8d		
STUD ANCHORS*					
< 1350	< 1305	LTT19	8-16d		1/2" AB
< 2310	< 2310	LTT31	18-10d, 1 1/2"		1/2" AB
< 2775	< 2570	HD2A	2-5/8" BOLTS		5/8" AB
< 4175	< 3655	HTT16	18-16d		5/8" AB
< 1400	< 1400	PAHD2	16-16d		
< 3335	< 3335	HPAH22	16-16d		
< 2200	< 2200	ABU44	12-16d		1/2" AB
< 2300	< 2300	ABU66	12-16d		1/2" AB
< 2320	< 2320	ABU88	18-16d		2-5/8" AB


GRADE & SPECIES TABLE

		Fb (psi)	E (10 ⁶ psi)
2x8	SYP #2	1200	1.8
2x10	SYP #2	1050	1.6
2x12	SYP #2	975	1.6
GLB	24F-V3 SP	2400	1.8
LSL	TIMBERSTRAND	1700	1.7
LVL	MICROLAM	2900	2.0
PSL	PARALAM	2900	2.0

2x6 SYP #2 GARAGE DOOR BUCK ATTACHMENT

ATTACH GARAGE DOOR BUCK TO STUD PACK EACH SIDE OF DOOR OPENING WITH 3/8"x4" LAG SCREWS w/ 1" WASHER LAG SCREWS MAY BE COUNTERSUNK. HORIZONTAL JAMBS DO NOT TRANSFER LOAD. CENTER LAG SCREWS OR STAGGER 16d NAILS OR (3) ROWS OF .131" x 1/4" ON PER TABLE BELOW:

DOOR WIDTH	3/8" x 4" LAG	16d STAGGER	(2) ROWS OF .131" x 1/4" ON
8'-10"	24" O.C.	5" O.C.	5" O.C.
11'-15"	18" O.C.	4" O.C.	4" O.C.
16'-18"	18" O.C.	3" O.C.	3" O.C.

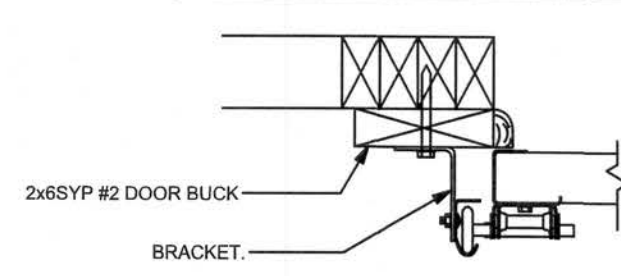

GARAGE DOOR BUCK INSTALLATION DETAIL
SCALE: N.T.S.

SCALE: N.T.S.

GENERAL NOTES:

TRUSSES: TRUSSES SHALL BE DESIGNED BY A FLORIDA LICENSED ENGINEER IN ACCORDANCE WITH THE FBCR 2004. TRUSS ENGINEERING SHALL INCLUDE TRUSS DESIGN, DETAILING PLANS, TEMPORARY AND PERMANENT BRACING DETAILS, TRUSS TO TRUSS CONNECTIONS, AND UPLIFT AND REACTION LOADS FOR ALL BEARING LOCATIONS. TRUSS ENGINEERING IS THE RESPONSIBILITY OF THE TRUSS MANUFACTURER AND SHALL BE SIGNED & SEALED BY THE MANUFACTURER'S DESIGN ENGINEER. IT IS THE BUILDER'S RESPONSIBILITY TO VERIFY THE TRUSS DESIGNER FULLY SATISFIED ALL THE ABOVE REQUIREMENTS AND TO SELECT UPLIFT CONNECTIONS BASED ON TRUSS ENGINEERING UPLIFT AND PROVIDE FOOTINGS FOR INTERIOR BEARING WALLS. BUILDER IS TO FURNISH TRUSS ENGINEERING TO WIND LOAD ENGINEER FOR REVIEW OF TRUSS REACTIONS ON THE BUILDING STRUCTURE. STRAP 2x6 RAFTERS WITH MIN UPLIFT CONNECTION 415LB EACH END; 2x8 RAFTERS 700 LB EACH END.

SITE PREPARATION: SITE ANALYSIS AND PREPARATION IS NOT PART OF THIS PLAN

FOUNDATION: CONFIRM THAT THE FOUNDATION DESIGN & SITE CONDITIONS MEET GRAVITY LOAD REQUIREMENTS (ASSUME 1000 PSF BEARING CAPACITY UNLESS VISUAL OBSERVATION OR SOILS TEST PROVES OTHERWISE)

CONCRETE: MINIMUM COMPRESSIVE STRENGTH OF CONCRETE AT 28 DAYS, F_c = 3000 PSI

WELDED WIRE REINFORCED SLAB: 8" x 6" W14 x W14, F_y = 80KSI, WELDED WIRE REINFORCEMENT FABRIC (W.W.R.) CONFORMING TO ASTM A185, LOCATED IN MIDDLE OF THE SLAB, SUPPORTED WITH APPROVED MATERIALS OR SUPPORTS AT SPACINGS NOT TO EXCEED 3'.

FIBER CONCRETE SLAB: CONCRETE SLABS ON GROUND CONTAINING SYNTHETIC FIBER REINFORCEMENT. FIBER LENGTH 12 INCH TO 2 INCHES, DOSEAGE AMOUNTS FROM 0.75 TO 1.5 POUNDS PER CUBIC YARD PER THE MANUFACTURER'S RECOMMENDATIONS. FIBERS TO COMPLY WITH ASTM C 1116. SUPPLIER TO PROVIDE ASTM C 1116 CERTIFICATION OF COMPLIANCE WHEN REQUESTED BY BUILDING OFFICIAL.

CONTROL JOINTS: WHERE SPECIFIED, SAWN CONTROL JOINTS IN SLAB-ON-GRADE SHALL BE CUT IN ACCORDANCE WITH ACI 302. JOINTS SHALL BE CUT WITHIN 12 HOURS OF SLAB PLACEMENT. THE LENGTH / WIDTH RATIO OF SLAB AREAS SHALL NOT EXCEED 1.5 AND TYPICAL SPACING OF CUTS TO BE 12 FT. DO NOT CUT WMM OR REINFORCING STEEL. RECOMMENDED LOCATION OF CONTROL JOINTS IS SUBJECT TO OWNER AND CONTRACTOR'S APPROVAL. THE CONTROL JOINTS ARE NOT INTENDED TO PREVENT CRACKS BUT RATHER TO ENCOURAGE THE SLAB TO CRACK ON A GIVEN LINE.

REBAR: ASTM A 615, GRADE 60, DEFORMED BARS, F_y = 60 KSI. ALL LAP SPLICES 40" (25" FOR #5 BARS); UNO. ALL REINFORCEMENT SHALL BE DETAILED AND PLACED IN ACCORDANCE WITH ACI 315-96, U.N.O.

GLULAM BEAMS: GLULAM BEAM, GLB, 24F-V3SP, F_b = 2400, E = 1800KSI. UNO. SUPPLIER MAY SUPPLY AN ALTERNATE BEAM WITH EQUAL PROPERTIES OR MAY SUBMIT THEIR OWN SIZING DETAILS.

ROOF SHEATHING: ALL ROOFS ARE HORIZONTAL DIAPHRAGMS. 7/16" OSB SHEATHING, UNLOCKED, APPLIED PERPENDICULAR TO FRAMING, OVER A MINIMUM OF 3 FRAMING MEMBERS, WITH PANEL EDGES STAGGERED, FASTENED WITH 8d COMMON NAILS (131), 2" OC PANEL EDGES, 12" OC INTERMEDIATE MEMBERS. GABLE ENDS AND DIAPHRAGM BOUNDARY, 4" OC, UNO.

STRUCTURAL CONNECTORS: MANUFACTURER'S AND PRODUCT NUMBER FOR CONNECTORS, ANCHORS, AND REINFORCEMENT ARE LISTED FOR EXAMPLE NOT ENDORSEMENT. AN EQUIVALENT DEVICE OF THE SAME OR OTHER MANUFACTURER CAN BE SUBSTITUTED FOR ANY DEVICES LISTED IN THE EXAMPLE TABLES AS LONG AS IT MEETS THE REQUIRED LOAD CAPACITIES. MANUFACTURER'S INSTALLATION INSTRUCTIONS MUST BE FOLLOWED TO ACHIEVE RATED LOADS.

ANCHOR BOLTS: A-307 ANCHOR BOLTS WITH MINIMUM EMBEDMENT AS SPECIFIED IN DRAWINGS BUT NO LESS THAN 7" IN CONCRETE OR REINFORCED BOND BEAM OR 15" IN GROUTED CMU.

WASHERS: WASHERS USED WITH 1/2" BOLTS TO BE 2" x 2" x 9/64", WITH 5/8" BOLTS TO BE 3" x 3" x 9/64", WITH 3/4" BOLTS TO BE 3" x 3" x 9/64", WITH 7/8" BOLTS TO BE 2" x 2" x 5/16", UNO.

NAILS: ALL NAILS ARE COMMON NAILS UNLESS OTHERWISE SPECIFIED OR ACCEPTED BY FBC TEST REPORTS AS HAVING EQUAL STRUCTURAL VALUES.

BUILDER'S RESPONSIBILITY

THE BUILDER AND OWNER ARE RESPONSIBLE FOR THE FOLLOWING, WHICH ARE SPECIFICALLY NOT PART OF THE WIND LOAD ENGINEER'S SCOPE OF WORK.

CONFIRM SITE CONDITIONS, FOUNDATION BEARING CAPACITY, GRADE AND BACKFILL HEIGHT, WIND SPEED AND DEBRIS ZONE, AND FLOOD ZONE.

PROVIDE MATERIALS AND CONSTRUCTION TECHNIQUES, WHICH COMPLY WITH FBCR 2004 REQUIREMENTS FOR THE STATED WIND VELOCITY AND DESIGN PRESSURES.

PROVIDE A CONTINUOUS LOAD PATH FROM TRUSSES TO FOUNDATION, IF YOU BELIEVE THE PLAN OMMITS A CONTINUOUS LOAD PATH CONNECTION, CALL THE WIND LOAD ENGINEER IMMEDIATELY.

VERIFY THE TRUSS MANUFACTURER'S SEALED ENGINEERING INCLUDES TRUSS DESIGN, PLACEMENT PLANS, TEMPORARY AND PERMANENT BRACING DETAILS, TRUSS-TO-TRUSS CONNECTIONS, AND UPLIFT AND REACTION LOADS FOR ALL BEARING LOCATIONS.

ROOF SYSTEM DESIGN

THE SEAL ON THESE PLANS FOR COMPLIANCE WITH FBCR 2004, SECTION R301.2.1 IS BASED ON REACTIONS, UPLIFTS, AND BEARING LOCATIONS IN TRUSS ENGINEERING SUBMITTED TO THE WIND LOAD ENGINEER. IT IS THE RESPONSIBILITY OF THE BUILDER TO CHECK ALL DETAILS OF THE COMPLETE ROOF SYSTEM DESIGN SUBMITTED BY THE TRUSS MANUFACTURER AND HAVE IT SIGNED AND SEALED BY A DESIGN PROFESSIONAL FOR CORRECT APPLICATION OF FBC 2001 REQUIRED LOADS AND ANY SPECIAL LOADS. THE BUILDER IS RESPONSIBLE TO REVIEW EACH INDIVIDUAL TRUSS MEMBER AND THE TRUSS ROOF SYSTEM AS A WHOLE AND TO PROVIDE RESTRAINT FOR ANY LATERAL BRACING. THE BUILDER SHOULD USE CARE CHECKING THE ROOF DESIGN BECAUSE THE WIND LOAD ENGINEER IS SPECIFICALLY NOT RESPONSIBLE FOR THE TRUSS LAYOUT WHICH WAS CREATED BY THE TRUSS MANUFACTURER AND THE TRUSS DESIGNER ALSO DENIES RESPONSIBILITY FOR THE LAYOUT PER NOTES ON THEIR SEALED TRUSS SHEETS.

DESIGN DATA

WIND LOADS PER FLORIDA BUILDING CODE 2004 RESIDENTIAL, SECTION R301.2.1

(ENCLOSED SIMPLE DIAPHRAGM BUILDINGS WITH FLAT, HIPPED, OR GABLE ROOFS; MEAN ROOF HEIGHT NOT EXCEEDING LEAST HORIZONTAL DIMENSION OR 60 FT; NOT ON UPPER HALF OF HILL OR ESCARPMENT GOFT IN EXP. B, 30FT IN EXP. C AND >10% SLOPE AND UNOBSTRUCTED UPWIND FOR 50x HEIGHT OR 1 MILE WHICHEVER IS LESS.)

BUILDING IS NOT IN THE HIGH VELOCITY HURRICANE ZONE

BUILDING IS NOT IN THE WIND-BORNE DEBRIS REGION

- BASIC WIND SPEED = 110 MPH
- WIND EXPOSURE = B
- WIND IMPORTANCE FACTOR = 1.0
- BUILDING CATEGORY = II
- ROOF ANGLE = 10-45 DEGREES
- MEAN ROOF HEIGHT = <30 FT
- INTERNAL PRESSURE COEFFICIENT = N/A (ENCLOSED BUILDING)
- COMPONENTS AND CLADDING DESIGN WIND PRESSURES (TABLE R301.2(2))

Zone	Effective Wind Area (ft ²)	10	100
1	19.9-21.8	18.1	-18.1
2	19.9-25.5	18.1	-21.8
2 Othg	-40.6	-40.6	-40.6
3	19.9-25.5	18.1	-21.8
3 Othg	-40.3	-40.3	-42.4
4	21.8-23.6	18.5	-20.4
5	21.8-29.1	18.5	-22.6

Doors & Windows	21.8	-29.1
Worst Case (Zone 5, 10 ft ²)		
8x7 Garage Door	19.5	-22.9
16x7 Garage Door	18.5	-21.0

DESIGN LOADS

- FLOOR 40 PSF (ALL OTHER DWELLING ROOMS)
- 30 PSF (SLEEPING ROOMS)
 - 30 PSF (ATTICS WITH STORAGE)
 - 10 PSF (ATTICS WITHOUT STORAGE, <3:12)
- ROOF 20 PSF (FLAT OR <4:12)
- 16 PSF (4:12 TO <12:12)
 - 12 PSF (12:12 AND GREATER)
- STAIRS 40 PSF (ONE & TWO FAMILY DWELLINGS)
- SOIL BEARING CAPACITY 1000PSF
- NOT IN FLOOD ZONE (BUILDER TO VERIFY)

REVISIONS

REVISIONS

Isaac Construction

Isaac Construction

Mike & Linda
Cady Addition

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Columbia County, Florida

Mark Disosway P.E.
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Fax: (386) 269 - 4871

PRINTED DATE:
June 14, 2005

DRAWN BY: STRUCTURAL BY:
David Disosway


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6 / Jun / 06

JOB NUMBER:
604122

DRAWING NUMBER



S-1
OF 4 SHEETS

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The table assumes 60 kN reinforcing bars with 8" hook in the footing and bent 24" into the reinforced slab. The vertical steel is to be placed toward the tension side of the CMU wall (away from the soil pressure), within 8" of the exterior side of the wall. If wall is over 8' high, add Duralumal lateral reinforcement at 16"OC vertically or a horizontal bond with 8's continuous at mid height. For higher parts of the wall 12" CMU may be used with reinforcement as shown in the table below.

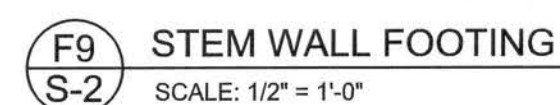STEM WALL HEIGHT (FEET)	UNBALANCED BACKFILL HEIGHT	VERTICAL REINFORCEMENT FOR 6" CMU STEM WALL (INCHES O.C.)			VERTICAL REINFORCEMENT FOR 12" CMU STEM WALL (INCHES O.C.)		
		#5	#7	#8	#5	#7	#8
3.3	3.0	96	96	96	96	96	96
4.0	3.7	88	96	96	96	96	96
4.7	4.3	88	96	96	96	96	96
5.3	5.0	56	96	96	96	96	96
6.0	5.7	40	96	96	80	96	96
6.7	6.3	32	56	80	56	96	96
7.3	7.0	24	40	56	40	80	96
8.0	7.7	16	32	48	32	64	80
8.7	8.3	8	24	32	24	48	64
9.3	9.0	8	16	24	16	40	48



P.E. 53915
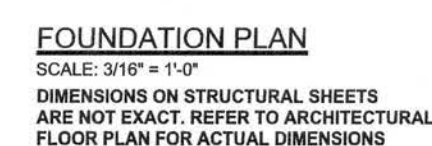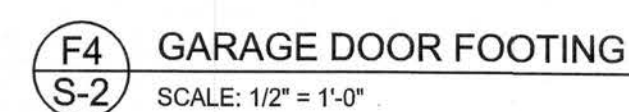
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14 JUN 06

SEAL

OF 4 SHEETS

REVISIONS

SOFTPLAN
ARCHITECTURAL DESIGN SOFTWARE

STRUCTURAL PLAN NOTES

- SN-1 ALL LOAD BEARING FRAME WALL & PORCH HEADERS SHALL BE A MINIMUM OF (2) 2X12 TYPE (U.N.O.)
- SN-2 ALL LOAD BEARING FRAME WALL HEADERS SHALL HAVE (1) JACK STUD & (1) KING STUD EACH SIDE (U.N.O.)
- SN-3 DIMENSIONS ON STRUCTURAL SHEETS ARE NOT EXACT REFER TO ARCHITECTURAL FLOOR PLAN FOR ACTUAL DIMENSIONS
- SN-4 PERMANENT TRUSS BRACING IS TO BE INSTALLED AT LOCATIONS AS SHOWN ON THE SEALED TRUSS DRAWINGS. LATERAL BRACING IS TO BE RESTRAINED PER BCSD-43, BCSD-41, BCSD-42, & BCSD-43. BCSD-41, BCSD-42, & BCSD-43 ARE FURNISHED BY THE TRUSS SUPPLIER WITH THE SEALED TRUSS PACKAGE.

WINDLOAD ENGINEER: Mark Disoway,
PE No. 53915, POB 868, Lake City, FL
32056, 386-754-5419

DIMENSIONS: Stated dimensions supercede scaled dimensions. Refer all questions to Mark Disoway, P.E. for resolution. Do not proceed without clarification.

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CERTIFICATION: I hereby certify that I have examined this plan, and that the applicable portions of the plan, relating to wind engineering comply with section FC001.2.1, Florida Building Code Residential 2004, to the best of my knowledge.

LIMITATION: This design is valid for one building, at specified location.

MARK DISOWAY
P.E. 53915

SEAL

Isaac Construction

Mike & Linda
Cady Addition

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PRINTED DATE:
June 14, 2006


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David Disoway

FINALS DATE:
06 / Jun / 06


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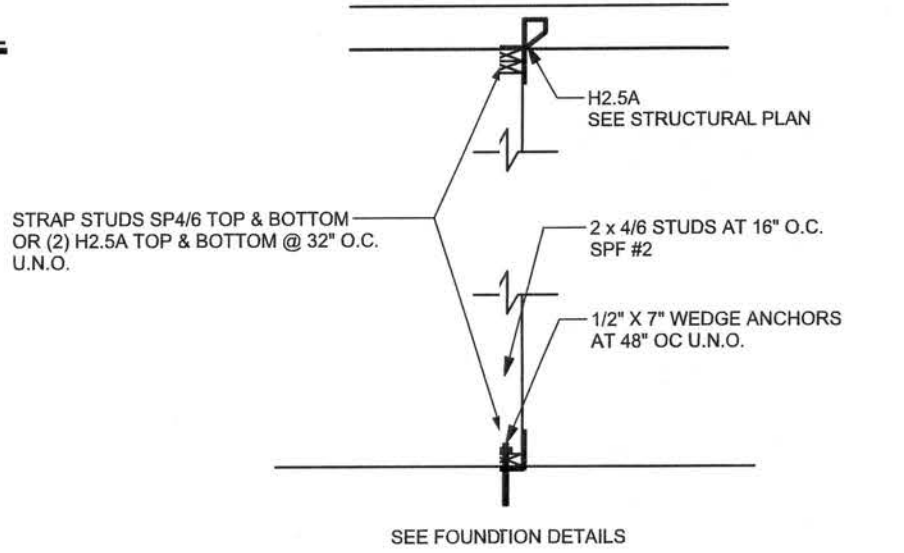
OF 4 SHEETS




TWO STORY INTERIOR BEARING WALL
SCALE: 1/2" = 1'-0"

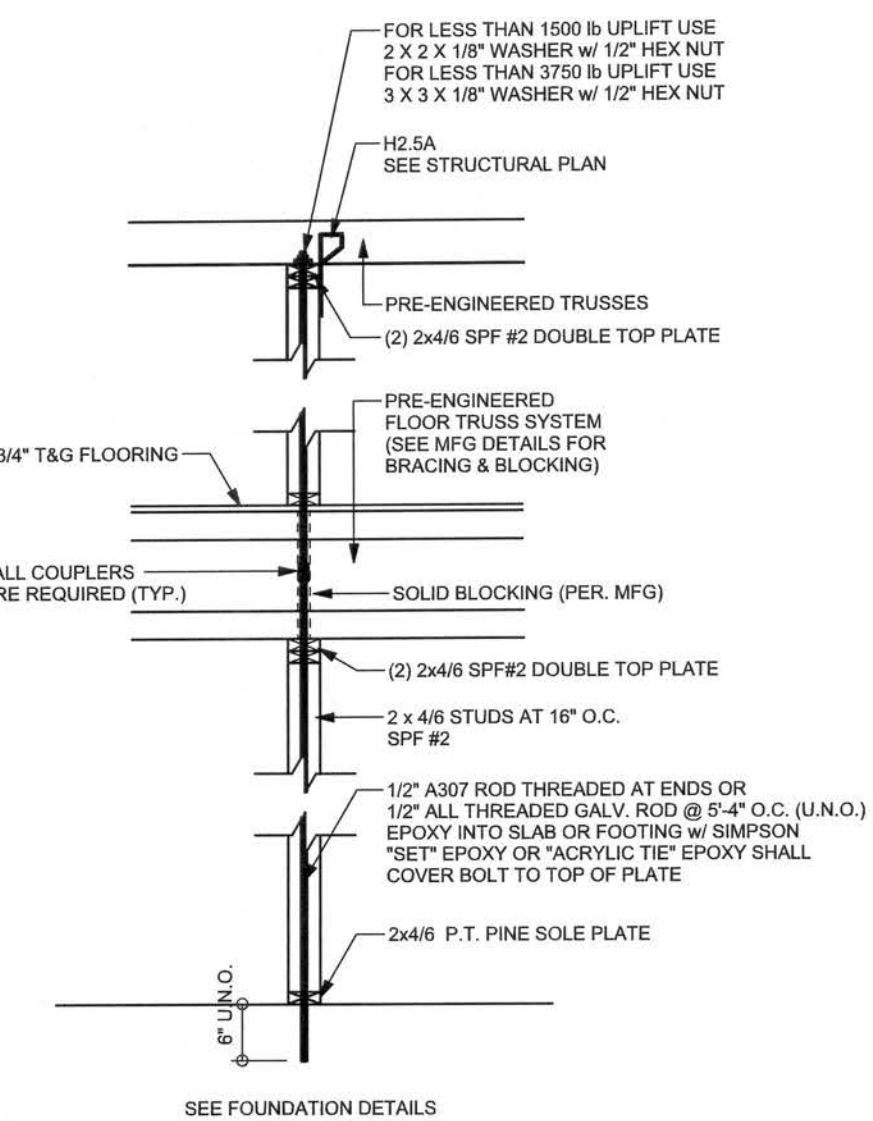

2 STORY INTERIOR BEARING WALL
SCALE: 1/2" = 1'-0"

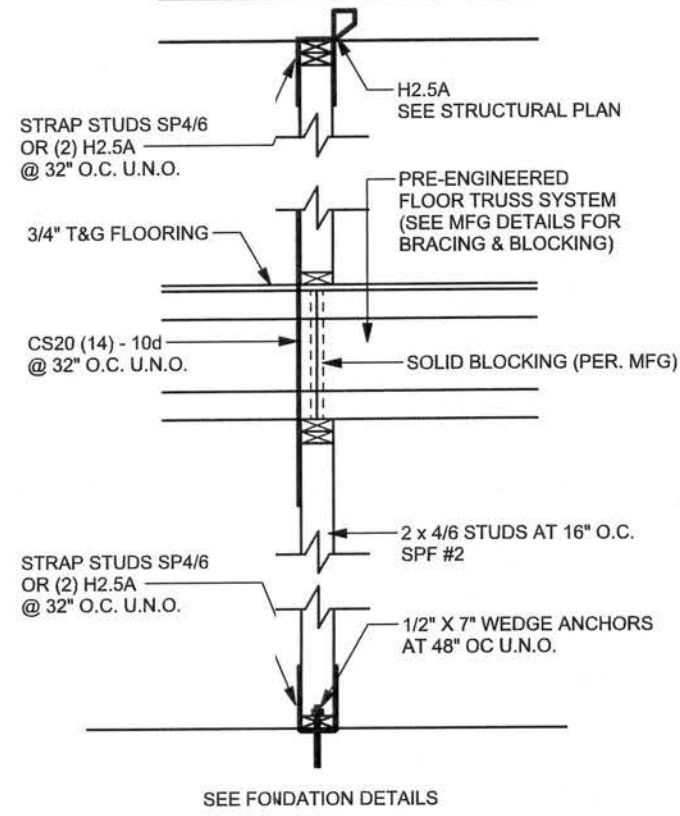

INTERIOR BEARING WALL
SCALE: 1/2" = 1'-0"

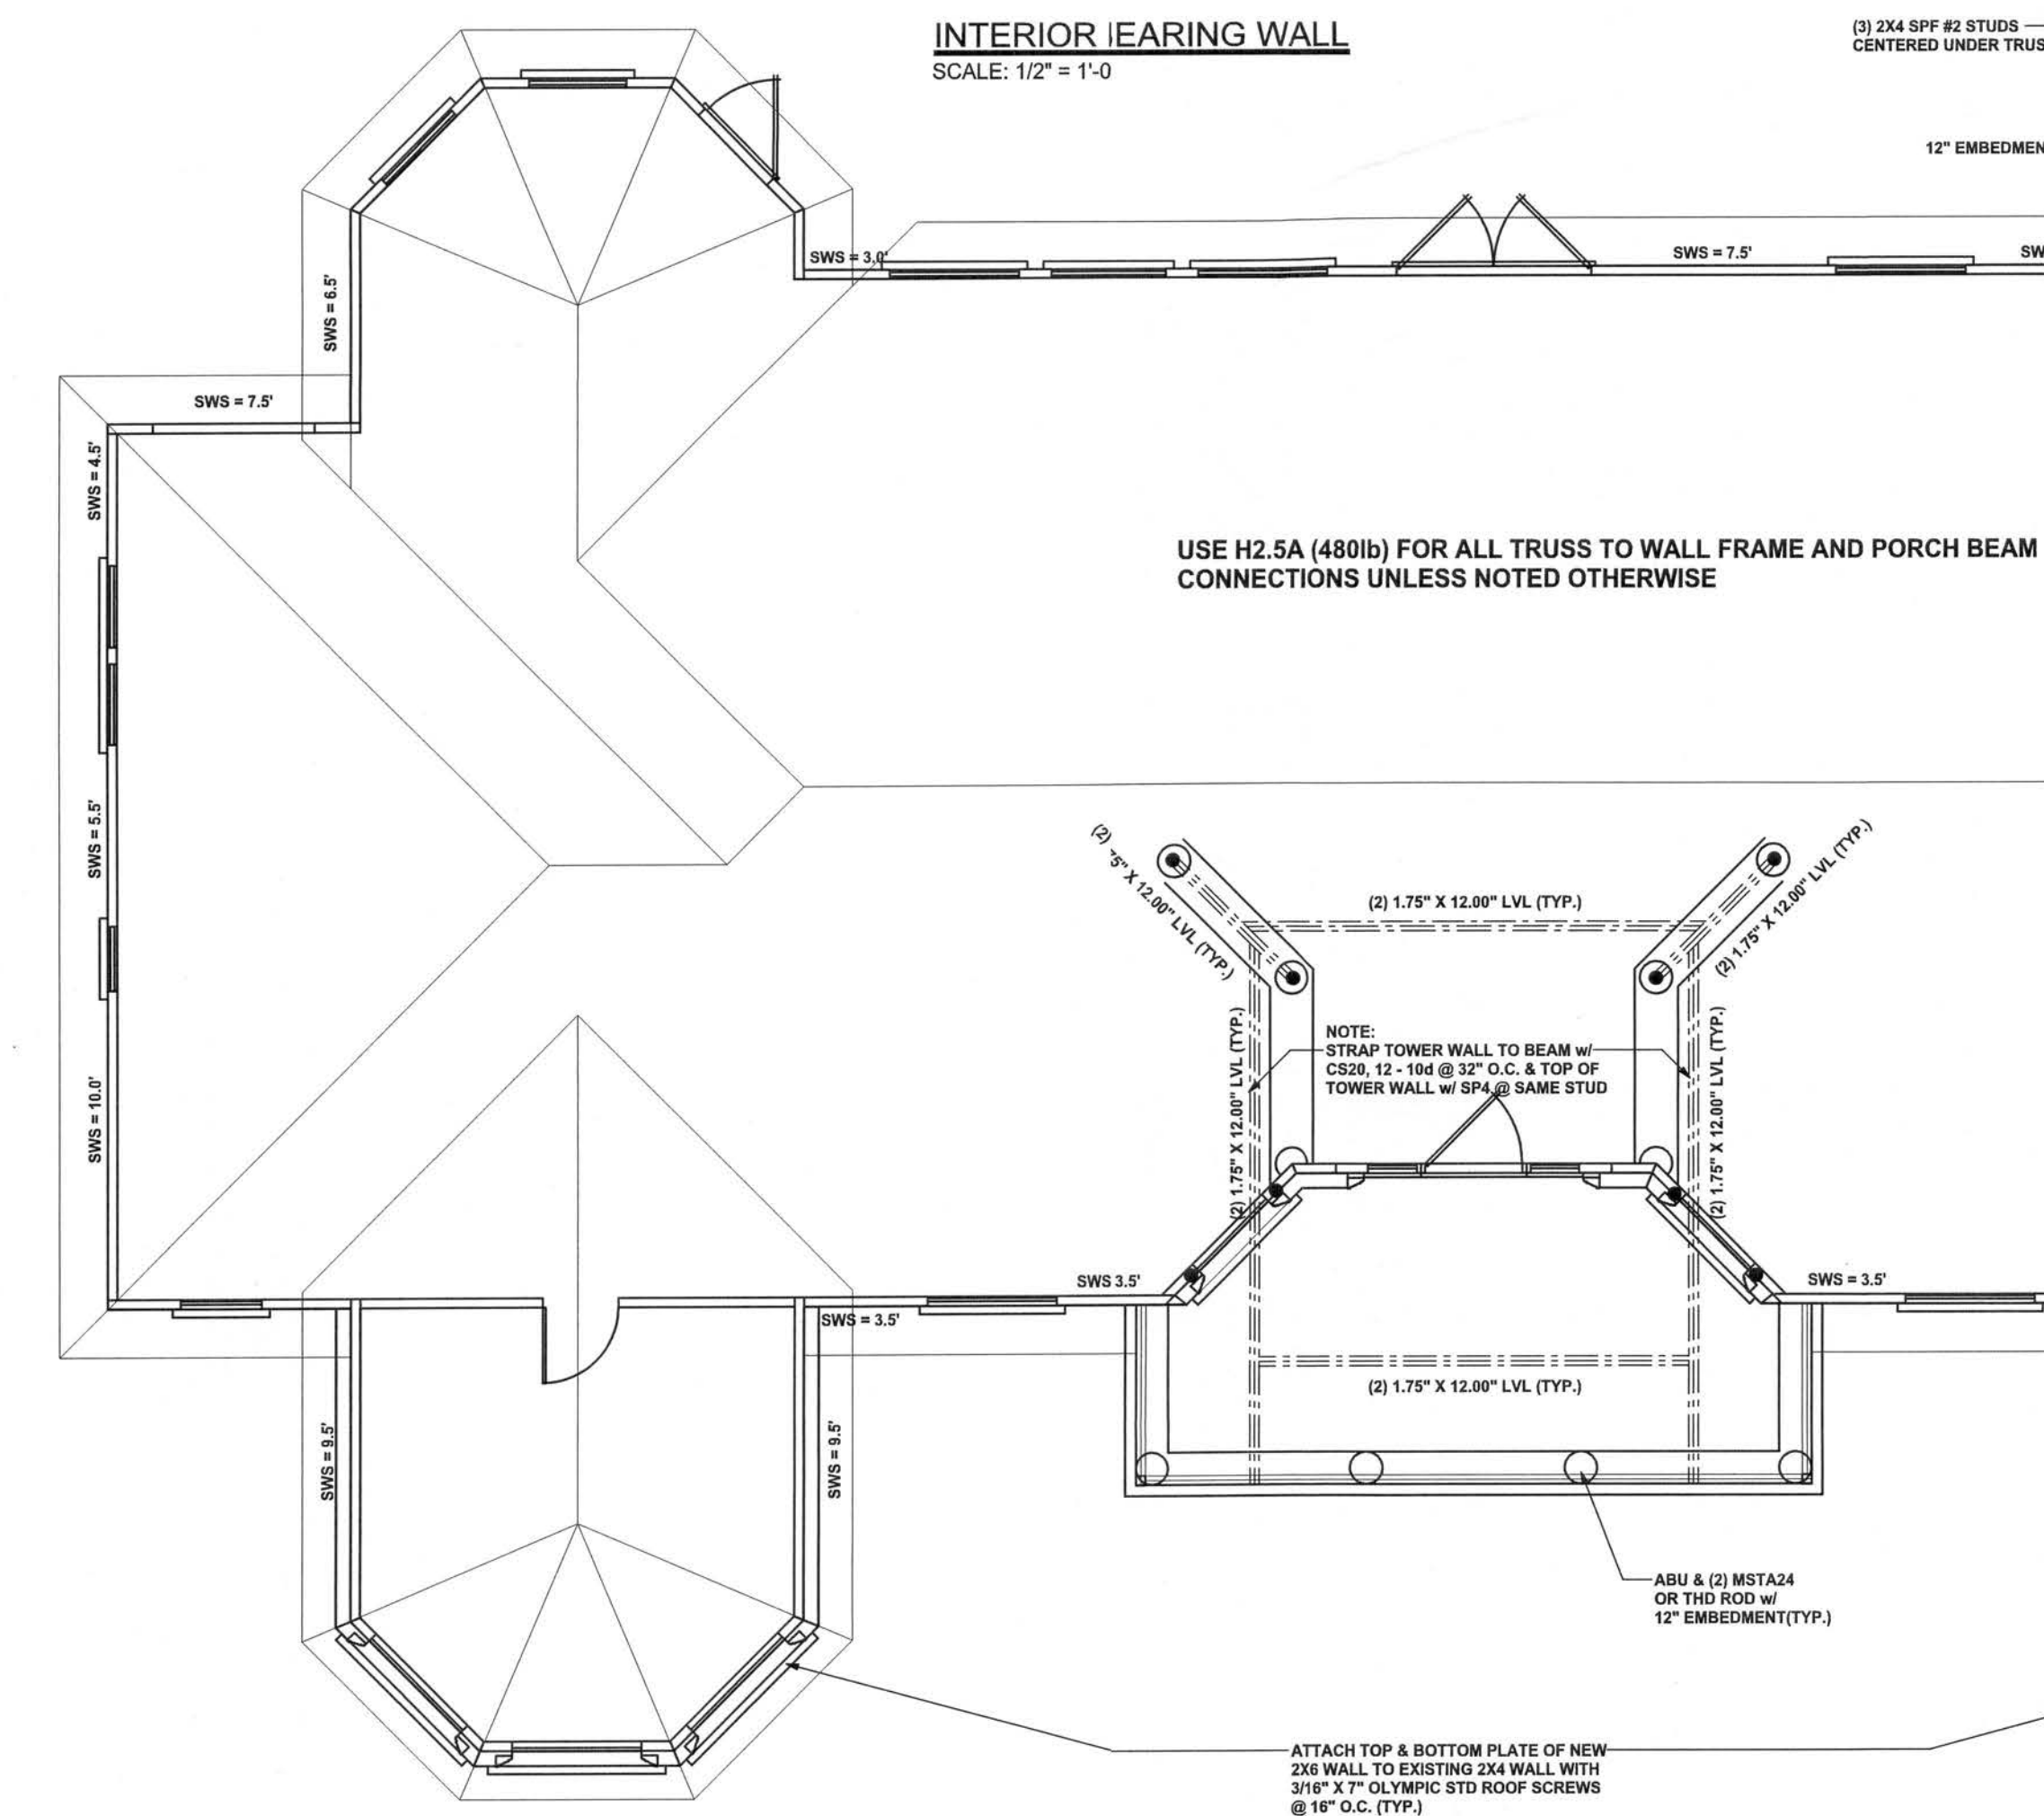

STRUCTURAL FLOOR PLAN
SCALE: 3/16" = 1'-0"

TOTAL SHEAR WALL SEGMENTS

SWS = 0.0' INDICATES SHEAR WALL SEGMENTS

REQUIRED	ACTUAL
TRANSVERSE 90.0'	167.0'
LONGITUDINAL 76.5'	136.5'

FOR WHOLE HOUSE AFTER ADDITION

14/1/2006

2X8 SYP #2 LEDGER ATTACHED TO WALL

(3) 1/4" X 4" LAGS @ 1' O.C. (TYP.)

ATTACH EACH RAFTER TO LEDGER w/ LSS02 14-16d (TYP.)

ATTACH EACH RAFTER TO BEAM w/ H2.5A (TYP.)

NOTE: IF TRUSS TO WALL STRAPS ARE NAILED TO THE HEADER THE SP4/6 @ 48" O.C. ARE NOT REQUIRED

(7) .131 x 3 1/4" GUN NAILS TOE NAILED THRU HEADER INTO KING STUD

NOTE: TYPICAL STRAPPING (U.N.O.) (SEE STRUCTURAL PLAN)

1/2" X 10" ANCHOR BOLTS WITH 2X2X.140" STEEL WASHER 24" O.C. BETWEEN RODS

1/2" X 10" ANCHOR BOLTS WITH 2X2X.140" STEEL WASHER 24" O.C. BETWEEN RODS

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OPTIONAL THREADED ROD TO FLOOR BEAM OR FLOOR JOIST

SCALE: 1/2" = 1'-0"

1/2" A36 STEEL ALL THREADED ROD ANCHORING SYSTEM ABOVE

FLOOR BEAM OR FLOOR JOIST

1/2" A36 STEEL ALL THREADED ROD ANCHORING SYSTEM BELOW

1/2" A36 STEEL ALL THREADED ROD ANCHORING SYSTEM BELOW

1/2" A36 STEEL ALL THREADED ROD ANCHORING SYSTEM BELOW

1/2" A36 STEEL ALL THREADED ROD ANCHORING SYSTEM BELOW

TYPICAL 2 STORY HEADER STRAPPING DETAIL

SCALE: 1/2" = 1'-0"


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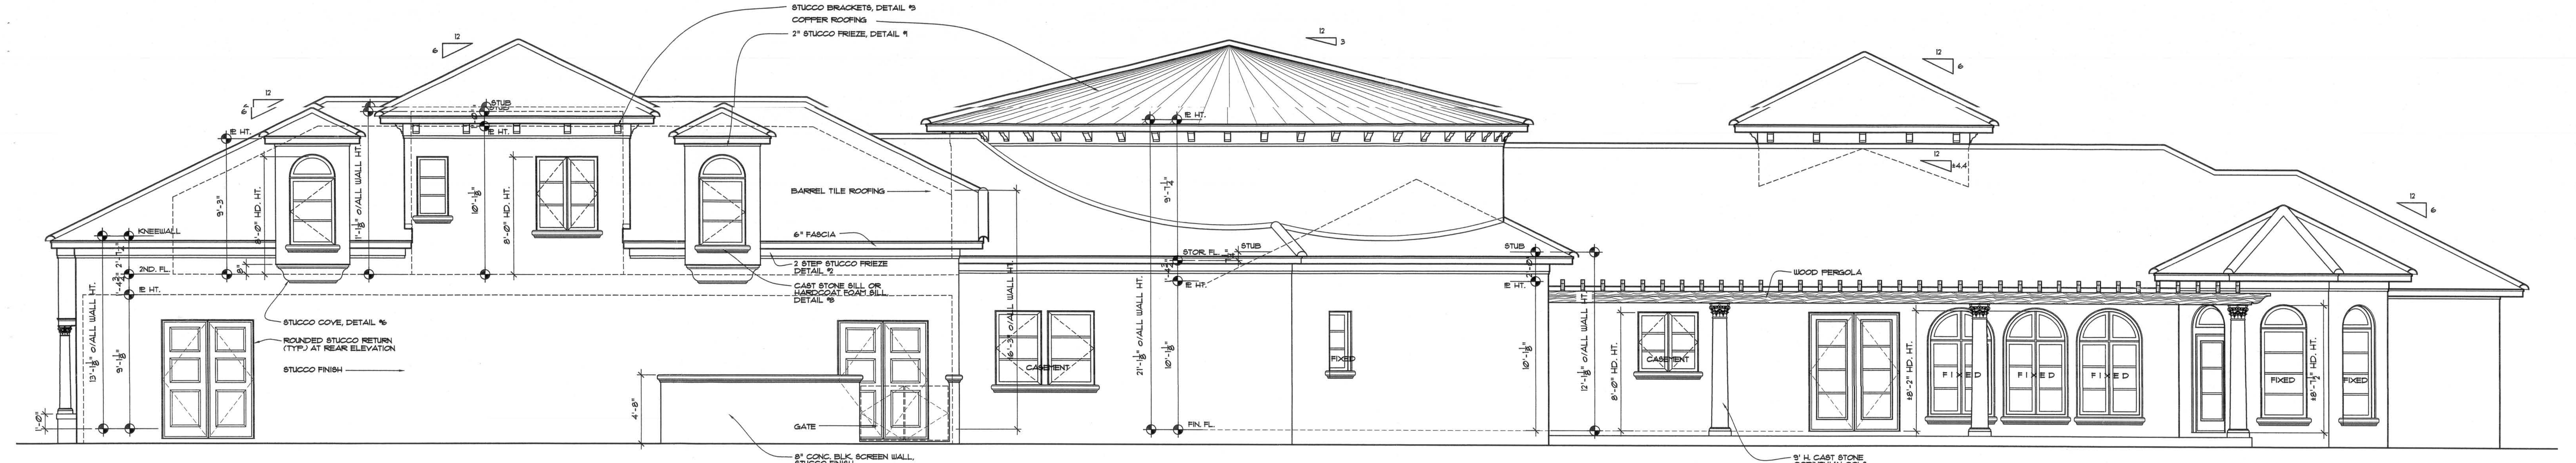
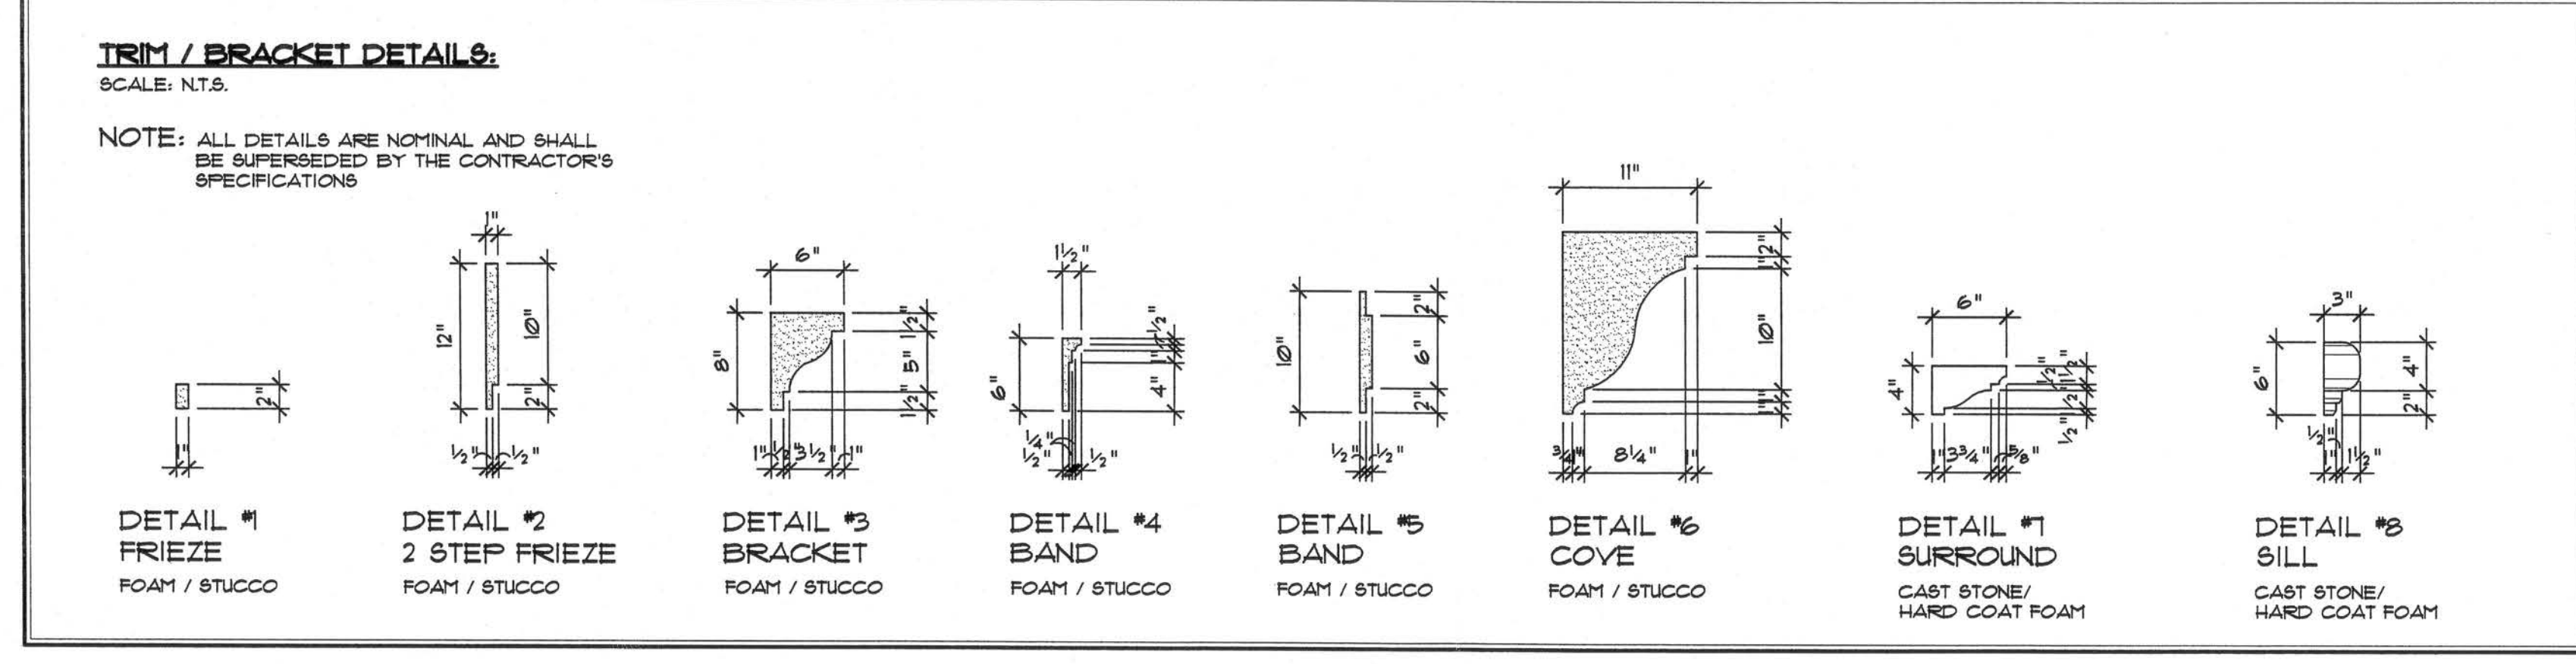
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CONNECTIONS, WALL & HEADER DESIGN IS BASED ON REACTIONS & UPLIFTS FROM TRUSS ENGINEERING FURNISHED BY BUILDER, ANDERSON TRUSS CO. JOB #6-122



FRONT ELEVATION



REAR ELEVATION

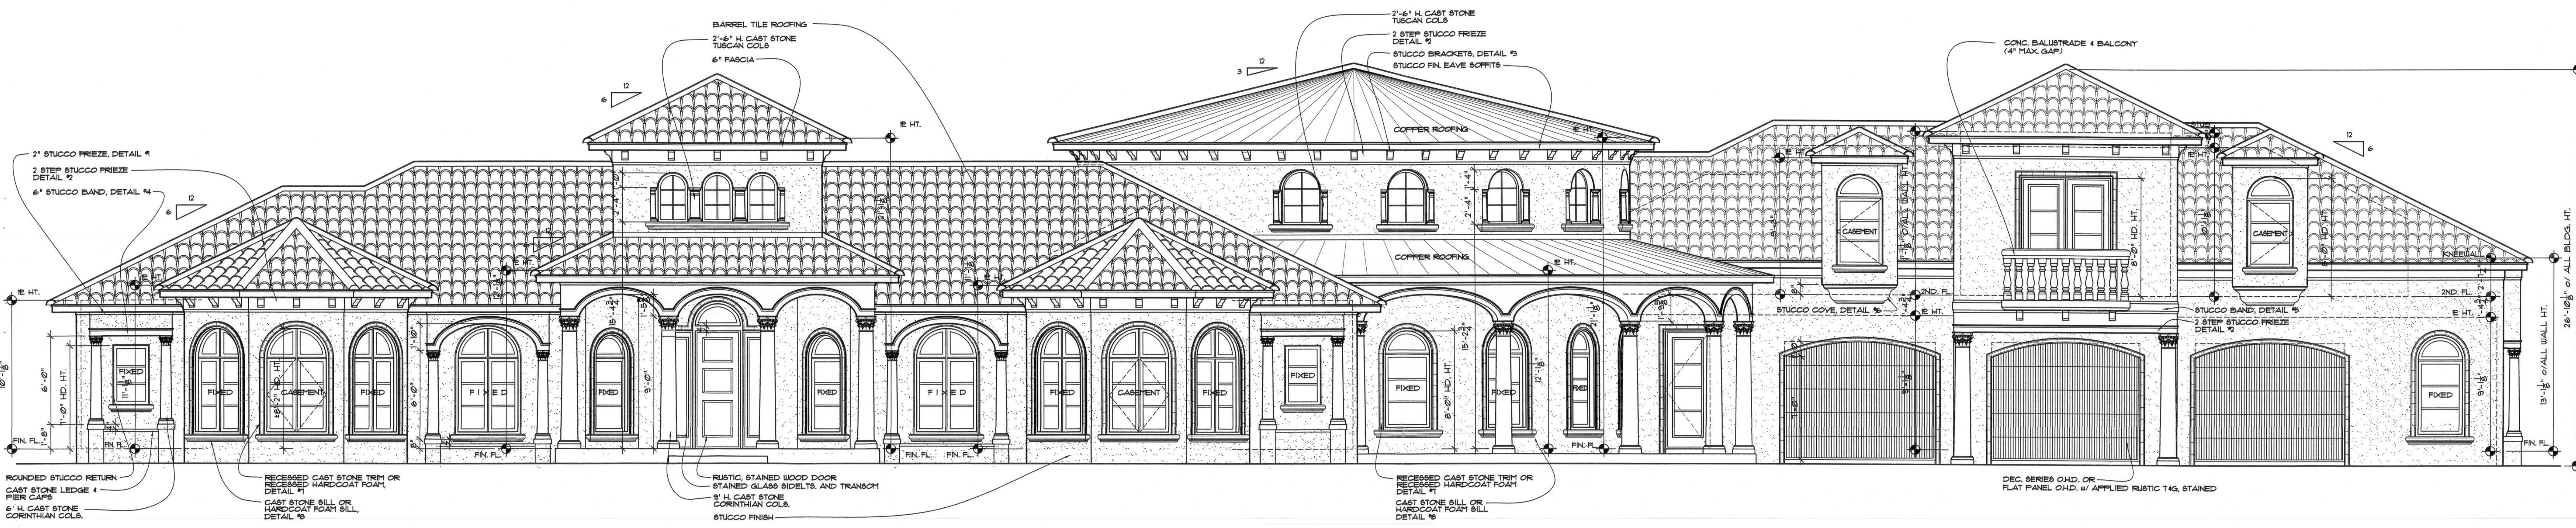STUCCO

ALL STUCCO APPLICATIONS SHALL COMPLY WITH THE RECOMMENDATIONS OF THE PORTLAND CEMENT ASSOCIATION, ASTM STANDARDS C1064-04A, C1064-04, C1064-03, C1064-02, C1064-01, C1064-00, AND THE FOLLOWING:

- DIAMOND MESH LATH WITH GRADE D FELT SHALL OVERLAP A MINIMUM OF 2 INCHES. LATH SHALL BE ATTACHED OVER WEATHERING WITH FASTENERS THAT PENETRATE WOOD FRAMING NOT LESS THAN 1/4 INCH AND SPACED NOT MORE THAN 12 INCHES ON CENTER.
- LATH SHALL NOT BE CONTIGUOUS THROUGH JOINTS. FLANGES OF ACCESSORIES SHALL BE SECURED TO THE FACE OF THE PLASTER BASE OR NOT MORE THAN 1/2 INCH INTERVAL. FELT TO BE INSTALLED BEHIND ALL CONTROL JOINTS.
- EXTERNAL CORNER REINFORCEMENT SHALL BE INSTALLED TO REINFORCE ALL EXTERNAL CORNERS. WHERE NO EXTERNAL CORNER REINFORCEMENT IS USED, LATH SHALL BE TURNED OUT AND CARRIED AROUND CORNERS NOT LESS THAN ONE WRAPPING SUPPORT ON FRAME CONSTRUCTION.
- CONTROL JOINTS SHALL BE INSTALLED IN WALLS TO DELINEATE AREAS NOT MORE THAN 144 SQUARE FEET AND TO DELINEATE AREAS NOT MORE THAN 144 SQUARE FEET FOR ALL HORIZONTAL APPLICATIONS. (E. G. CEILING, CURVES OR ANGLE-TYPE STRUCTURES). THE DISTANCE BETWEEN CONTROL JOINTS SHALL NOT EXCEED (60) FEET IN EITHER DIRECTION. AT A MINIMUM, A CONTROL JOINT SHALL BE INSTALLED AT THE CEILING WRAPPING, WHEN WRAPPING CHANGES DIRECTION AND WHERE EXPANSION AND CONTRACTION OCCUR IN THE SUBSTRATE. (I.E. AT THE BASE OF AN EXTERIOR WALL AND PENETRATING SLAB AND AT JOINTS IN CRUIAL AND CONCRETE).
- IN WALLS OR PARTITIONS, DOOR FRAMES SHALL BE CONSIDERED AS CONTROL JOINTS.
- FOUNDATION WEEP SCREED SHALL BE INSTALLED AT THE BOTTOM OF ALL STEEL OR WOOD FRAMED EXTERIOR WALLS. THE NOSE OF THE SCREED SHALL BE PLACED NOT LESS THAN 1/2 INCHES ABOVE RAW EARTH OR 1/4 INCHES ABOVE PAVED SURFACES. THE WEATHER RESISTIVE BARRIER AND LATH SHALL ENTIRELY COVER THE VERTICAL ATTACHMENT FLANGE AND TERMINATE AT THE TOP EDGE OF THE NOSE OR GROUND FLANGE.
- PLASTER THICKNESS FOR STUCCO SHALL BE INSTALLED IN COATS OVER:

A) FRAME CONSTRUCTION:
FIRST (BROWN) COAT 3/8 INCH THICK
SECOND (SCRATCH) COAT 3/8 INCH THICK
THIRD (FINISH) COAT 1/8 INCH THICK

B) MASONRY CONSTRUCTION:
BONDING AGENT ASTM C-330-03
FIRST COAT 3/8 INCH THICK
SECOND COAT 1/8 INCH THICK

B) PROVIDE AN EXTERIOR SEALANT.

NOTES:

- CONTRACTOR SHALL FIELD VERIFY EXISTING DIMENSIONS, ROOF PITCHES, AND CONDITIONS BEFORE THE START OF ANY DEMOLITION OR CONSTRUCTION.
- CONTRACTOR SHALL FIELD VERIFY EXISTING STRUCTURAL, MECHANICAL, AND ELECTRICAL SYSTEMS FOR ADEQUACY AND SAFETY. SYSTEMS SHALL BE UPGRADED AS REQUIRED.
- CONTRACTOR SHALL OBTAIN ALL APPLICABLE PERMITS AND FORMS REQUIRED TO EXECUTE THIS PROJECT.
- CONTRACTOR SHALL INSURE THAT ALL DEMOLITION, CONSTRUCTION, AND RENOVATION COMPLIED WITH ALL APPLICABLE CODES AND REGULATIONS IN EFFECT AT THE TIME OF PERMITTING.
- CONTRACTOR SHALL BE RESPONSIBLE FOR THE DAILY COLLECTION AND DISPOSAL OF ALL TRASH, DEMOLITION MATERIAL, TRIMMING, REFUSE, ETC. FROM THE SITE.
- CONTRACTOR SHALL SAVE AND RETAIN ON SITE ANY MATERIAL, EQUIPMENT, OR ITEMS DESIRED BY THE OWNER.
- NEW CONSTRUCTION, TRIM FINISHES, BRICK, ETC., SHALL MATCH EXISTING. ANY POSSIBLE DIFFERENCES SHALL BE BROUGHT TO THE ATTENTION OF THE OWNER BEFORE CONSTRUCTION.
- DURING DEMOLITION AND NEW CONSTRUCTION, ANY UNPROTECTED AREAS SHALL BE ADEQUATELY PROTECTED FROM WEATHER, STRUCTURAL DAMAGE, OR DAMAGE FROM NEW CONSTRUCTION.
- ANY ELECTRICAL, PLUMBING, OR HVAC LINES TO BE ABANDONED SHALL BE TRIMMED AND CAPPED.
- ANY AREAS WHERE NEW ROOF MEETS EXISTING ROOF AND/OR STRUCTURE SHALL BE ADEQUATELY FLASHED AND SEALED.
- STUCCO CONTROL JOINTS TO BE PROVIDED PER PORTLAND CEMENT ASSOCIATION RECOMMENDATIONS.
- CONTRACTOR TO VERIFY SETBACKS AND LOCATION OF STRUCTURE PRIOR TO CONSTRUCTION.
- ALL WOOD IN CONTACT WITH MASONRY, CONCRETE, OR EARTH SHALL BE PRESURE TREATED APPROPRIATELY FOR THE CONDITION.
- ALL INTERIOR AND EXTERIOR FLOOR TILE SHALL HAVE A NON-SLIP FINISH. FLOORING TO MEET ASTM C1028.
- STATIC COEFFICIENT OF FRICTION MIN OF 0.6.
- CONTRACTOR TO ENSURE THAT ALL CONSTRUCTION COMPLIES WITH NFPA LIFE SAFETY CODES AND 2004 FLORIDA BUILDING CODE REQUIREMENTS.

NOTE:
DIMENSIONS, HEIGHTS AND SITE ELEVATIONS ARE APPROXIMATE AND SUBJECT TO FIELD CONDITIONS. CONTRACTOR TO VERIFY BEFORE COMMENCEMENT.

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CONTRACTOR SHALL FIELD VERIFY EXISTING DIMENSIONS, ROOF PITCHES, AND CONDITIONS BEFORE THE START OF ANY DEMOLITION OR CONSTRUCTION.
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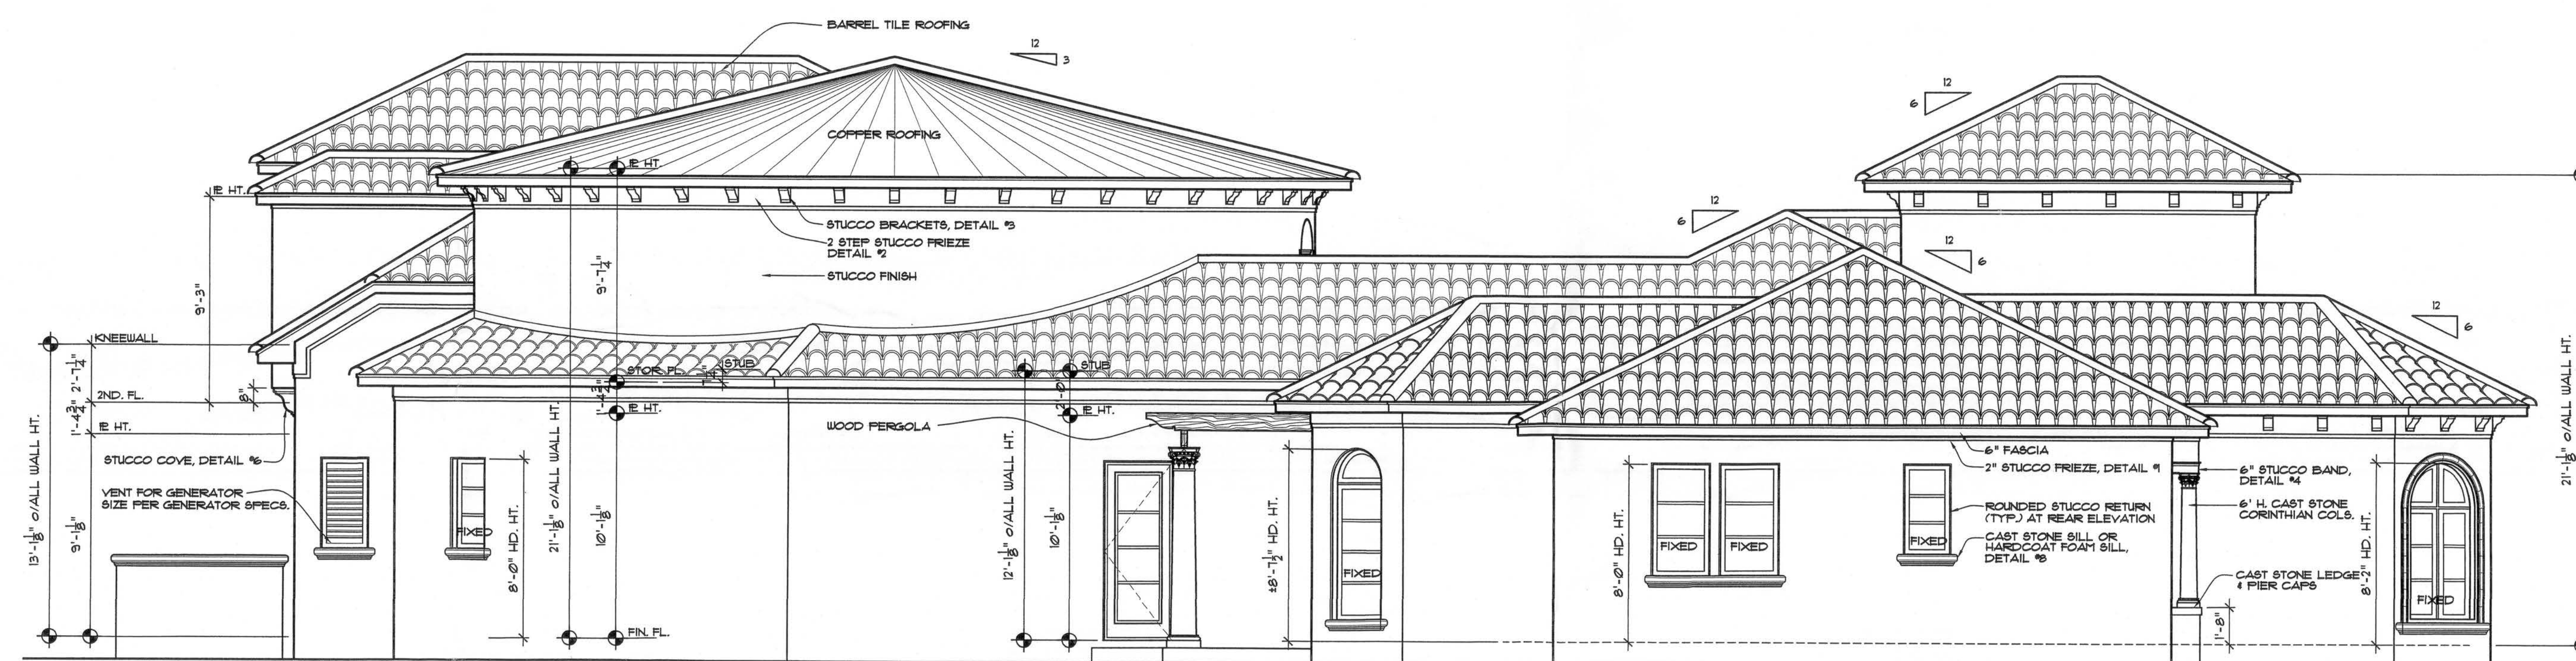
10755 Dunsmuir Park Blvd.
Suite #100
Jacksonville, Florida 32206

PHONE: (904) 384-3595
FAX: (904) 384-1850
www.kevingray.com

RESIDENTIAL DESIGNS BY KEVIN GRAY, INC.

ADDITIONS AND RENOVATIONS TO THE:
MIKE & LINDA CADY RESIDENCE
16 NW LAKE JEFFERY ROAD
LAKE CITY, FLORIDA

DRAWN BY: AA RFF
CHECKED BY:
DATE: 02/17/06
SCALE: 1/4" = 1'-0"
JOB NUMBER: ****
REVISED:
DWN NO: 3 13





LEFT SIDE ELEVATION

TRIM / BRACKET DETAILS:

SCALE: N.T.S.

NOTE: ALL DETAILS ARE NOTINAL AND SHALL BE SUPERSEDED BY THE CONTRACTORS SPECIFICATIONS

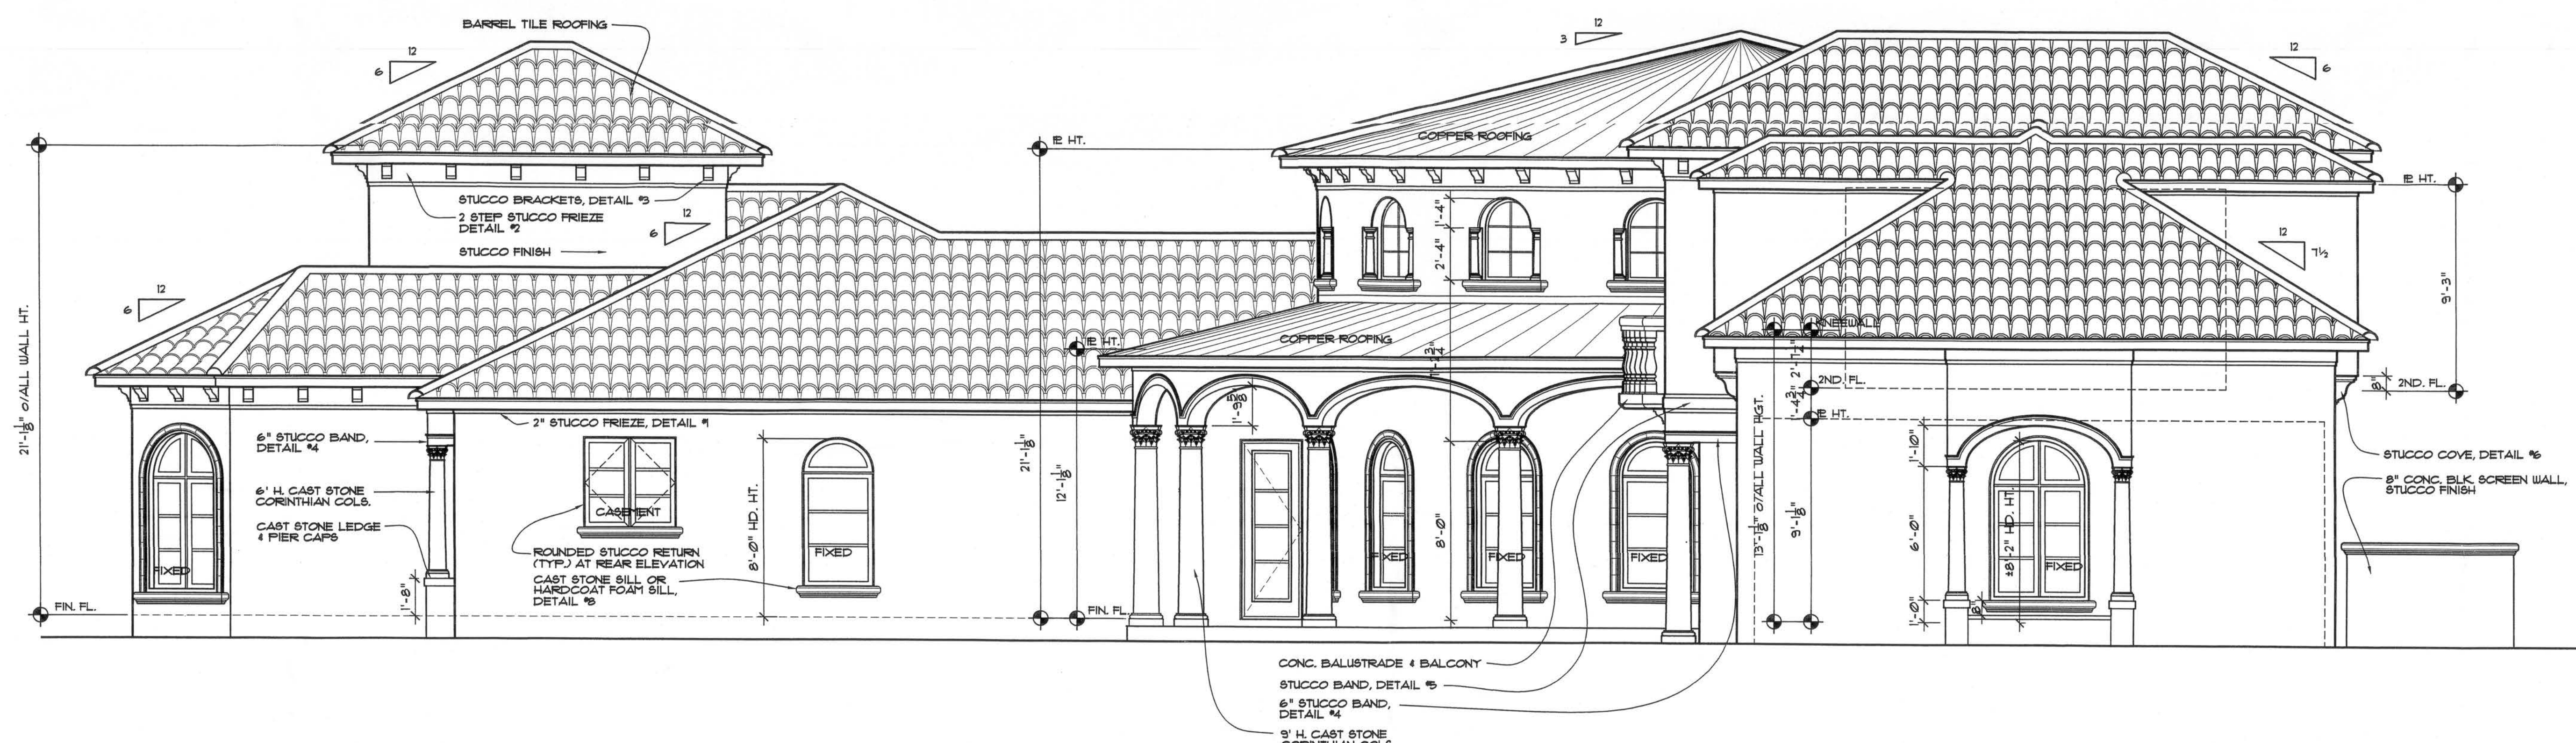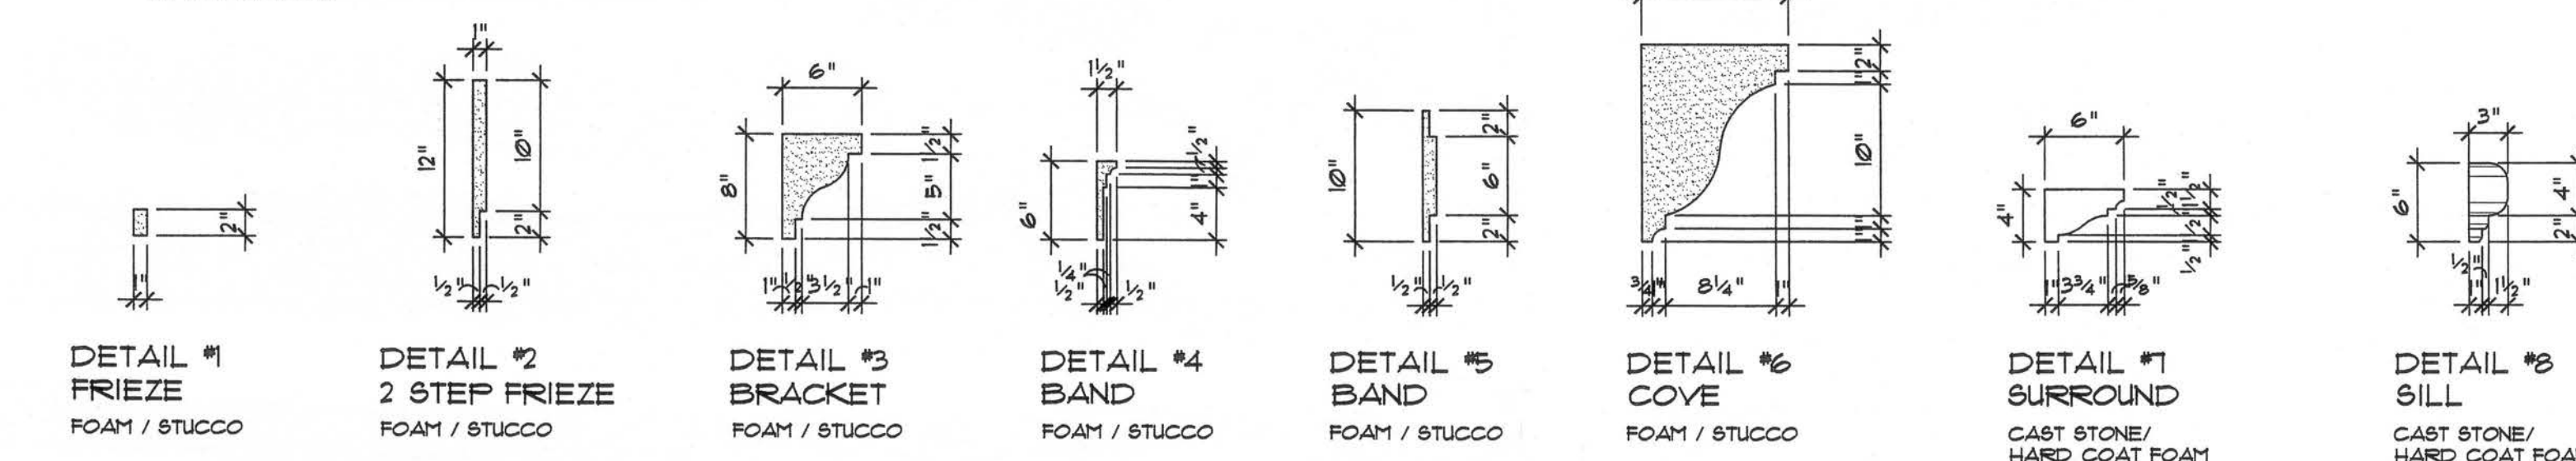

RIGHT SIDE ELEVATION

STUCCO

- ALL STUCCO APPLICATIONS SHALL COMPLY WITH THE RECOMMENDATIONS OF THE PORTLAND CEMENT ASSOCIATION, ASTM STANDARDS C94-C150, C106, C127, C138, C150, C155, C158, C159, C160, C298, 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- CONTRACTOR SHALL BE RESPONSIBLE FOR THE DAILY COLLECTION AND DISPOSAL OF ALL TRASH, DEMOLITION MATERIAL, TRIMMING, REFUSE, ETC. FROM THE SITE.
- CONTRACTORS SHALL SAVE AND RETAIN ON SITE ANY MATERIAL, EQUIPMENT, OR ITEMS DESIRED BY THE OWNER.
- NEW CONSTRUCTION, TRIM, FINISHES, BRICK, ETC. SHALL MATCH EXISTING. ANY POSSIBLE DIFFERENCES SHALL BE BROUGHT TO THE ATTENTION OF THE OWNER BEFORE CONSTRUCTION.
- DURING DEMOLITION AND NEW CONSTRUCTION, ANY UNEXPECTED AREAS SHALL BE ADEQUATELY PROTECTED FROM WEATHER, STRUCTURAL, DAMAGE, OR DAMAGE FROM NEW CONSTRUCTION.
- ANY ELECTRICAL, PLUMBING, OR HVAC LINES TO BE ABANDONED SHALL BE TRIMMED AND CAPPED.
- ANY AREAS WHERE NEW ROOF MEETS EXISTING ROOF AND/OR STRUCTURE SHALL BE ADEQUATELY FLASHED AND SEALED.
- STUCCO CONTROL JOINTS TO BE PROVIDED PER PORTLAND CEMENT ASSOCIATION RECOMMENDATIONS.
- CONTRACTOR TO VERIFY SETBACKS AND LOCATION OF STRUCTURE PRIOR TO CONSTRUCTION.
- ALL WOOD IN CONTACT WITH MASONRY, CONCRETE, OR EARTH SHALL BE PRESURE TREATED APPROPRIATELY FOR THE CONDITION.
- ALL INTERIOR AND EXTERIOR FLOOR TILE SHALL HAVE A NON-SLIP FINISH. FLOORING TO MEET ASTM C1028. STATIC COEFFICIENT OF FRICTION MIN OF 0.6.
- CONTRACTOR TO ENSURE THAT ALL CONSTRUCTION COMPLIES WITH NFPA LIFE SAFETY CODES AND 2004 FLORIDA BUILDING CODE REQUIREMENTS.


NOTE:

DIMENSIONS, HEIGHTS AND SITE ELEVATIONS ARE APPROXIMATE AND SUBJECT TO FIELD CONDITIONS. CONTRACTOR TO VERIFY BEFORE COMMENCEMENT.

ADDITIONS AND RENOVATIONS TO THE:
MIKE & LINDA CADY RESIDENCE
161 NW LAKE JEFFREY ROAD
LAKE CITY, FLORIDA

DRAWN BY: AA RFF
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SCALE: 1/4" = 1'-0"
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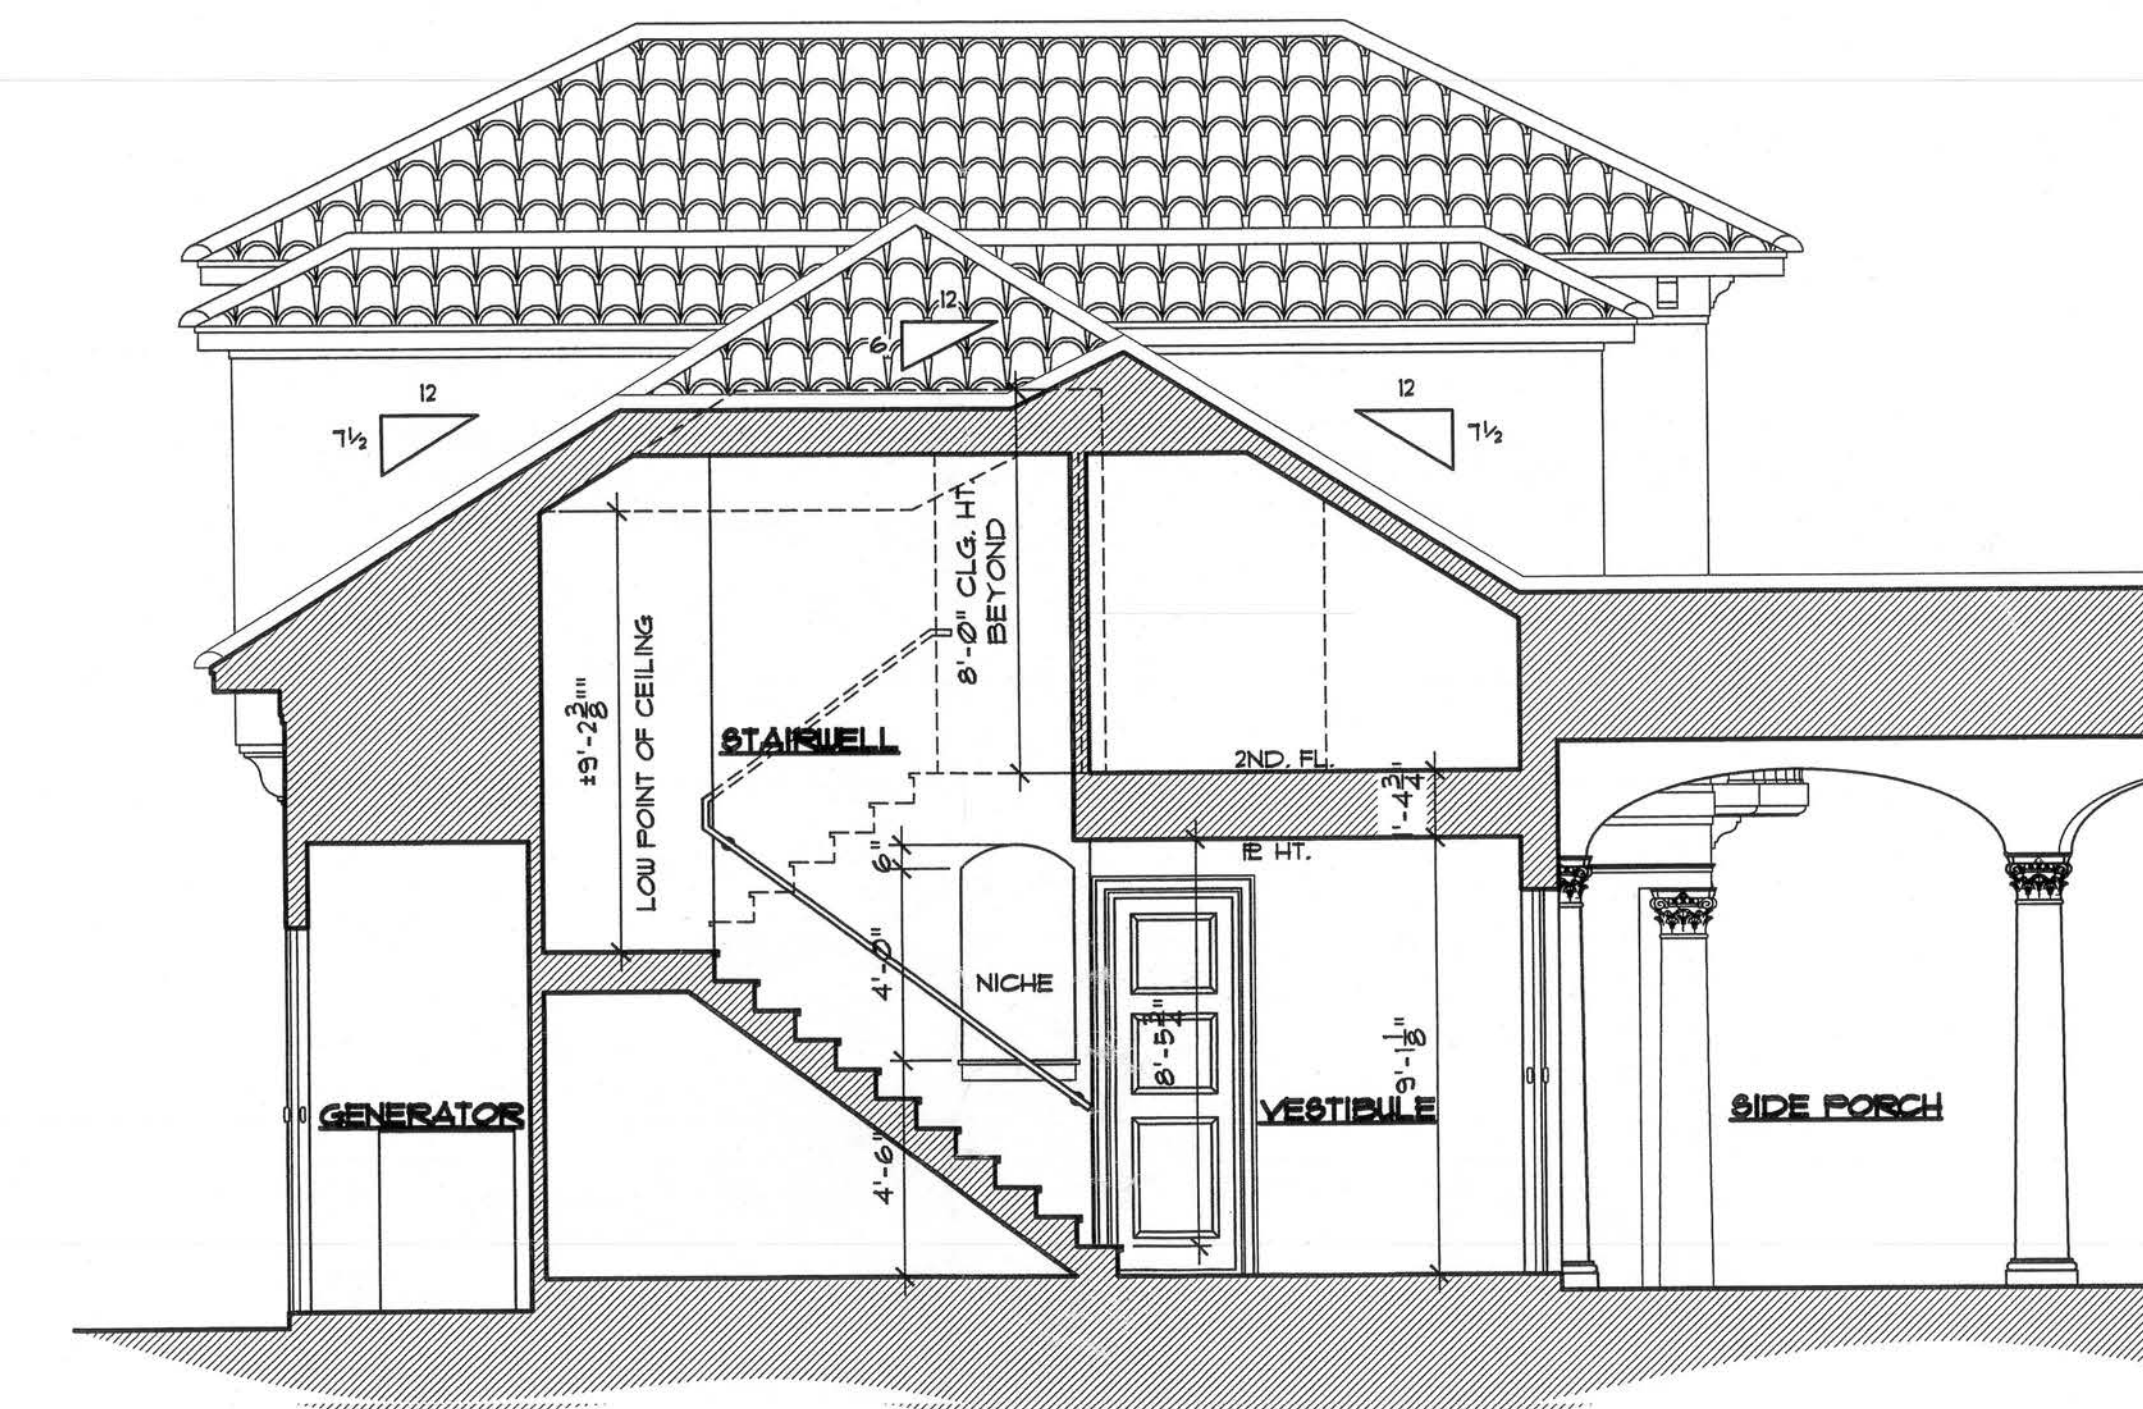
RESIDENTIAL DESIGNS BY KEVIN GRAY, INC.
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SECTION A-A

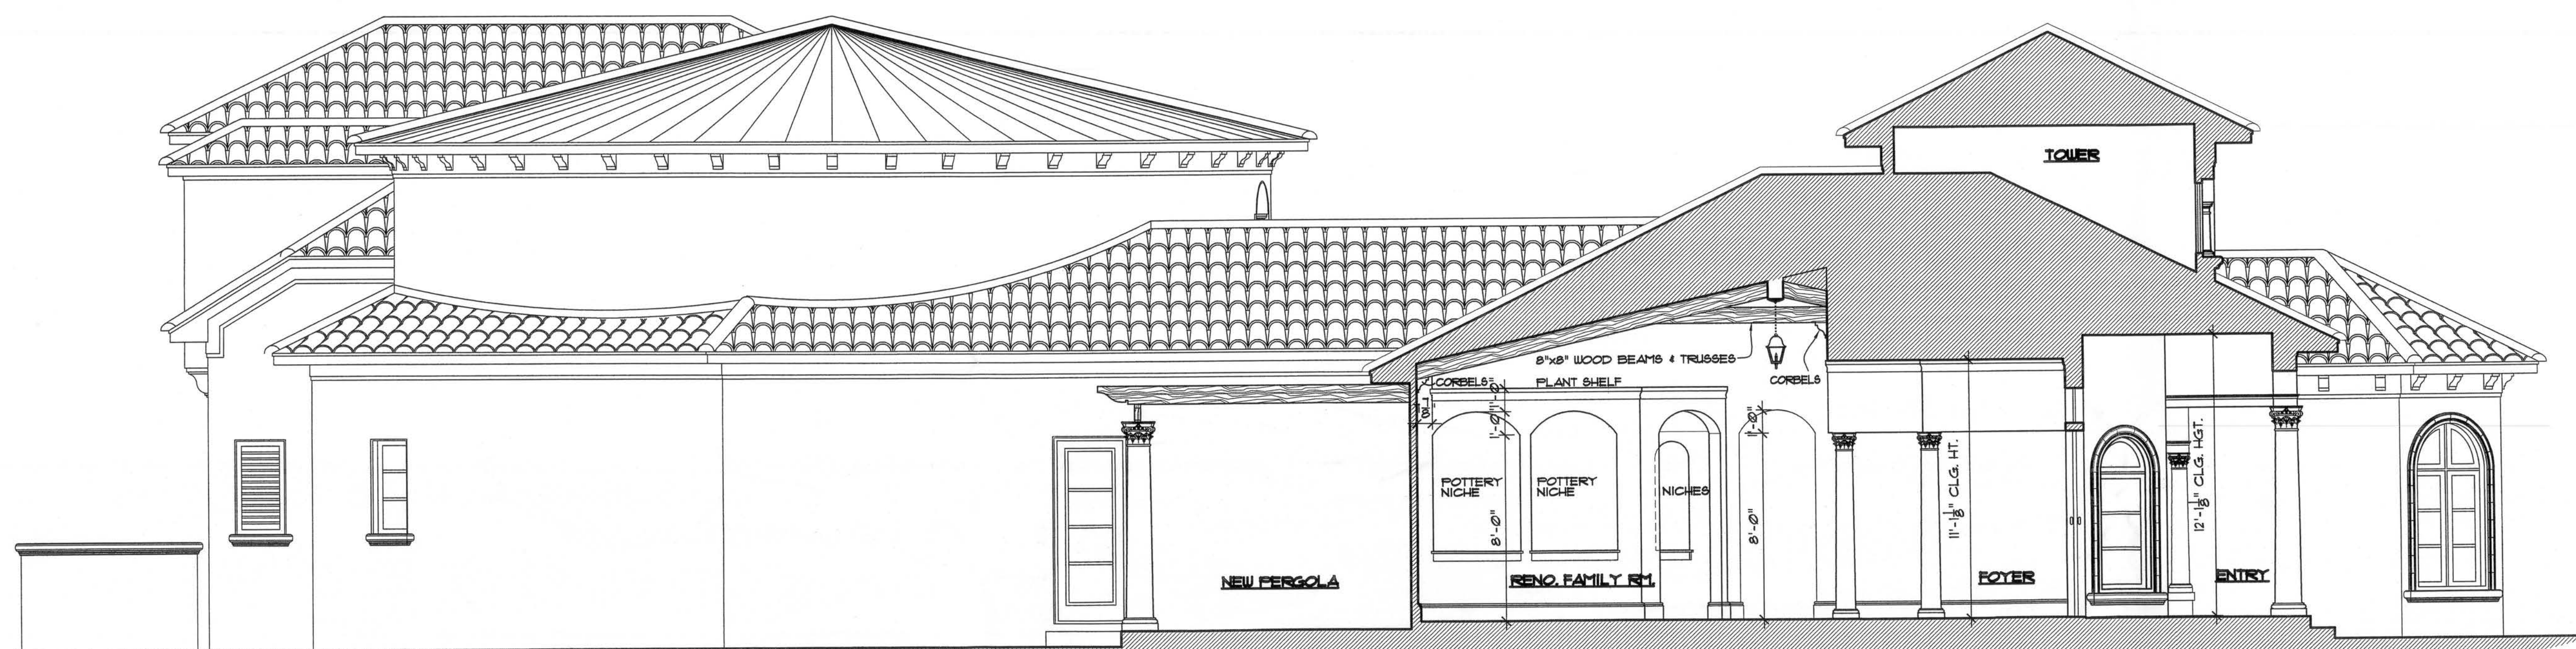

SECTION B-B




SECTION C-C




SECTION D-D




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SECTION E-E

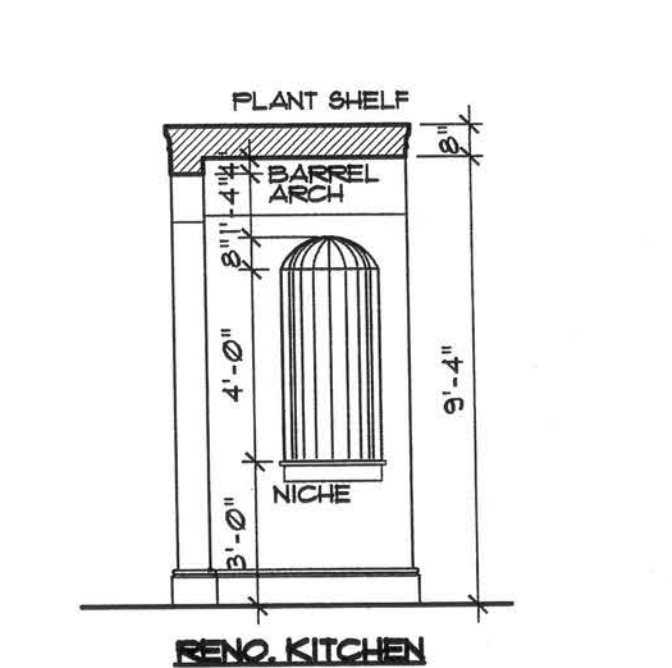STUCCO

- ALL STUCCO APPLICATIONS SHALL COMPLY WITH THE RECOMMENDATIONS OF THE PORTLAND CEMENT ASSOCIATION ASTM STANDARDS C94-98A, C94-98B, A22.1, C531-93, C531-93, C531-93, AND THE FOLLOWING:
- 1) DIAMOND MESH LATH WITH GRADE D FETL SHALL OVERLAP A MINIMUM OF 2 INCHES. LATH SHALL BE ATTACHED OVER SHEATHING WITH FASTENERS THAT PENETRATE WOOD FRAMING NOT LESS THAN 1/4 INCH AND SPACED NOT MORE THAN 12 INCHES ON CENTER.
 - 2) LATH SHALL NOT BE CONTINUOUS THROUGH CONTROL JOINTS. PLUMBER UP, ACCESSORIES SHALL BE ATTACHED TO THE FACE OF THE PLASTER BASE OR NOT MORE THAN 1/4 INCH INTERVALS. FETL TO BE INSTALLED BEING ALL CONTROL JOINTS.
 - 3) EXTERNAL CORNER REINFORCEMENT SHALL BE INSTALLED TO REINFORCE ALL EXTERIOR CORNERS. (BARS NO EXTERNAL CORNER BEAD IS USED, LATH SHALL BE TURNED OUT AND CARRIED AROUND CORNERS NOT LESS THAN ONE TRAYING SUPPORT ON FRAME CONSTRUCTION).
 - 4) CONTROL JOINTS SHALL BE INSTALLED IN WALLS TO DELINEATE AREAS NOT MORE THAN 144 SQUARE FEET AND TO DELINEATE AREAS NOT MORE THAN 800 SQUARE FEET FOR ALL HORIZONTAL APPLICATIONS. (E. GELING CURVES OR ANGLE-TYPE STRUCTURES. THE DISTANCE BETWEEN CONTROL JOINTS SHALL NOT EXCEED (80) FEET IN EITHER DIRECTION. AT A MINIMUM, A CONTROL JOINT SHALL BE INSTALLED AT THE CEILING FINISHING WHEN FINISHING CHANGES DIRECTION AND WHERE EXPANSION AND CONTRACTION OCCUR IN THE SUBSTRATE (E. G. AT THE BASE OF AN EXTERIOR WALL AND MONOLITHIC SLAB AND AT JOINTS IN CHILL AND CONCRETE).
 - 5) IN WALLS OR PARTITIONS, DOOR FRAMES SHALL BE CONSIDERED AS CONTROL JOINTS.
 - 6) FOUNDATION (DEEP SCREED) SHALL BE INSTALLED AT THE BOTTOM OF ALL STEEL OR WOOD FRAME EXTERIOR WALLS. THE NOSE OF THE SCREED SHALL BE PLACED NOT LESS THAN (6) INCHES ABOVE RAW EARTH OR (4) INCHES ABOVE PAVED SURFACES. THE WEATHER RESISTIVE BARRIER AND LATH SHALL ENTIRELY COVER THE VERTICAL ATTACHMENT FLANGE AND TERMINATE AT THE TOP EDGE OF THE NOSE OR GROUND FLANGE.
 - 7) PLASTER THICKNESS FOR STUCCO SHALL BE INSTALLED IN COATS OVER:
 - A) FRAME CONSTRUCTION:
 - FIRST (BROWN) COAT 3/8 INCH THICK
 - SECOND (SCRATCH) COAT 3/8 INCH THICK
 - THIRD (FINISH) COAT 1/8 INCH THICK
 - B) MASONRY CONSTRUCTION:
 - BONDING AGENT ASTM C-323-93
 - FIRST COAT 3/8 INCH THICK
 - SECOND COAT 1/8 INCH THICK
 - 8) PROVIDE AN EXTERIOR SEALANT.

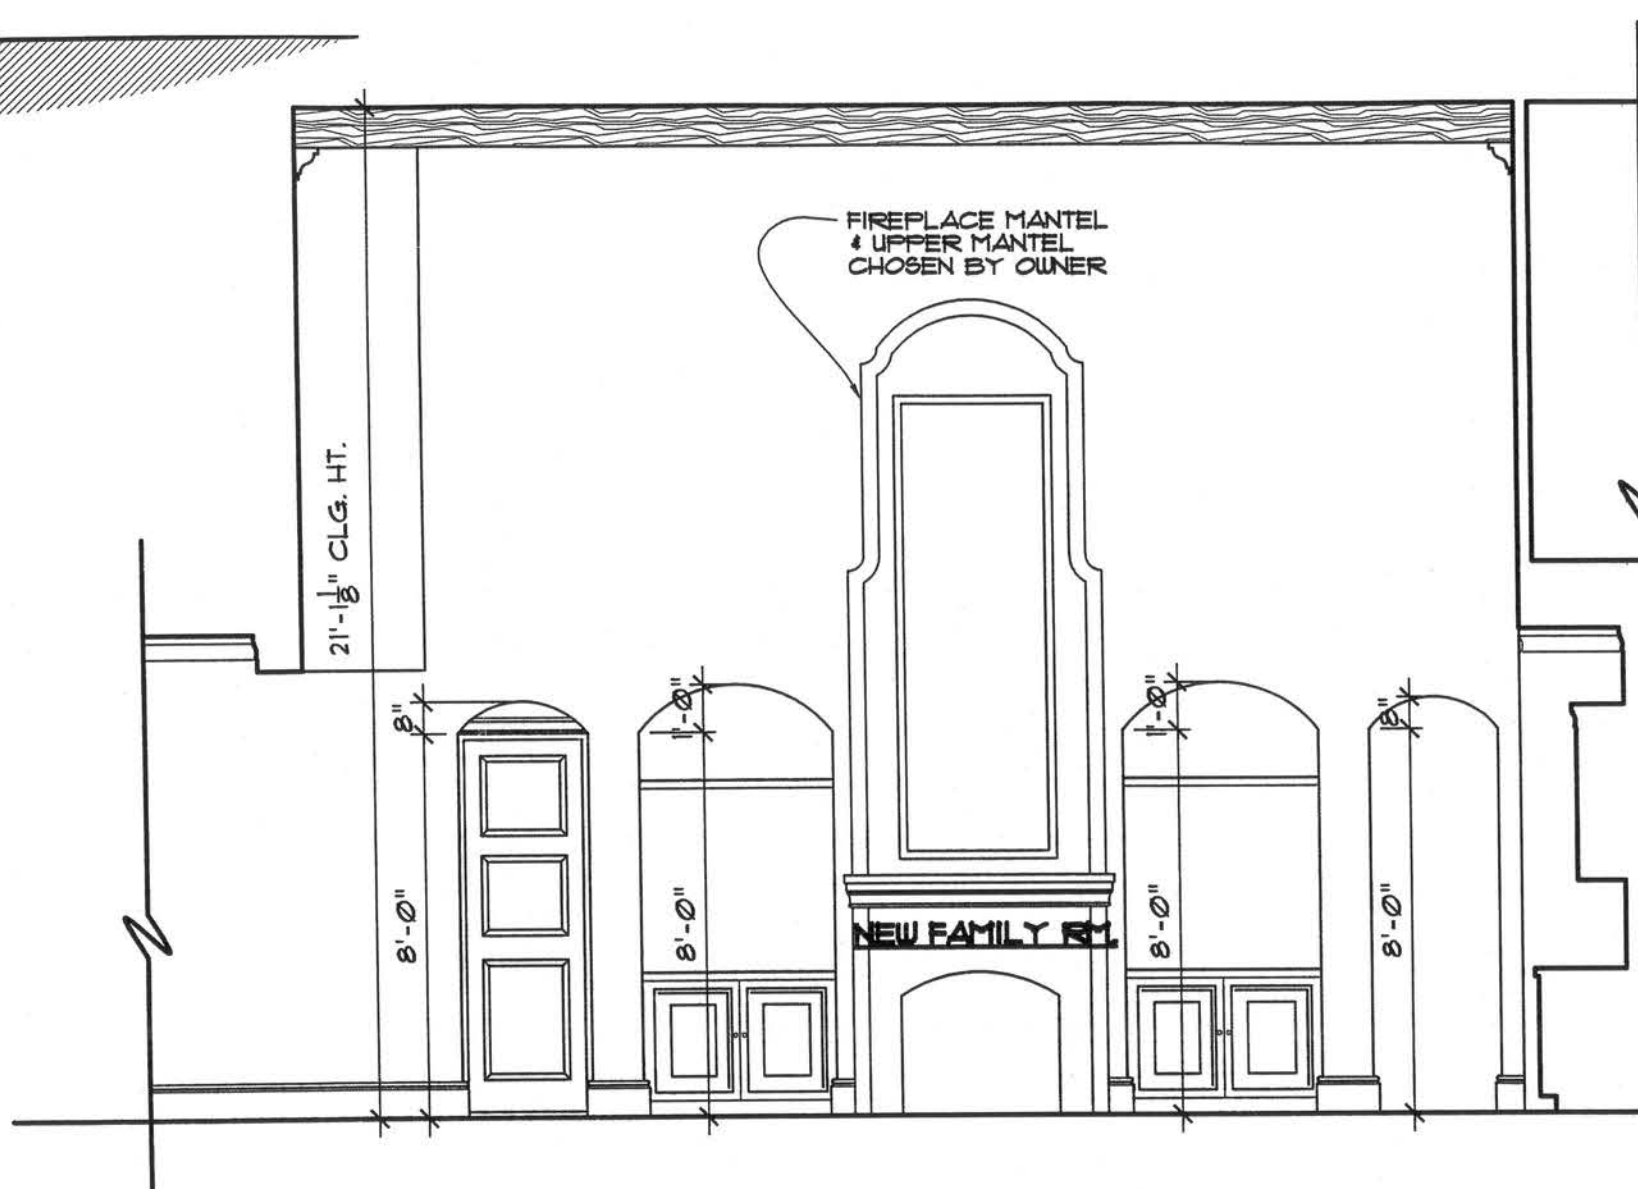NOTES:

- 1) CONTRACTOR SHALL FIELD VERIFY EXISTING DIMENSIONS, ROOF PITCHES, AND CONDITIONS BEFORE THE START OF ANY DEMOLITION OR CONSTRUCTION.
- 2) CONTRACTOR SHALL FIELD VERIFY EXISTING STRUCTURAL, MECHANICAL, AND ELECTRICAL SYSTEMS FOR ADEQUACY AND SAFETY. SYSTEMS SHALL BE UPGRADED AS REQUIRED.
- 3) CONTRACTOR SHALL OBTAIN ALL APPLICABLE PERMITS AND RECORD REQUIREMENTS TO EXISTING 1/4 INCH RECORD.
- 4) CONTRACTOR SHALL INSURE THAT ALL DEMOLITION, CONSTRUCTION, AND RENOVATION COMPLY WITH ALL APPLICABLE CODES AND REGULATIONS IN EFFECT AT THE TIME OF PERMITTING.
- 5) CONTRACTOR SHALL BE RESPONSIBLE FOR THE DAILY COLLECTION AND DISPOSAL OF ALL TRASH, DEMOLITION MATERIAL, TESTING, REUSE ETC FROM THE SITE.
- 6) CONTRACTORS SHALL SAVE AND RETAIN ON SITE ANY MATERIAL, EQUIPMENT, OR ITEMS DESIRED BY THE OWNER.
- 7) NEW CONSTRUCTION, TRIM, FINISHES, BRICK, ETC. SHALL MATCH EXISTING. ANY POSSIBLE DIFFERENCES SHALL BE BROUGHT TO THE ATTENTION OF THE OWNER BEFORE CONSTRUCTION.
- 8) DURING DEMOLITION AND NEW CONSTRUCTION, ANY UNEXPOSED AREAS SHALL BE ADEQUATELY PROTECTED FROM WEATHER, STRUCTURAL DAMAGE, OR DAMAGE FROM NEW CONSTRUCTION.
- 9) ANY ELECTRICAL, PLUMBING, OR HVAC LINES TO BE ABANDONED SHALL BE TRIMMED AND CAPPED.
- 10) ANY AREAS WHERE NEW ROOF MEETS EXISTING ROOF AND/OR STRUCTURE SHALL BE ADEQUATELY FLASHED AND SEALED.
- 11) STUCCO CONTROL JOINTS TO BE PROVIDED PER PORTLAND CEMENT ASSOCIATION RECOMMENDATIONS.
- 12) CONTRACTOR TO VERIFY SETBACKS AND LOCATION OF STRUCTURE PRIOR TO CONSTRUCTION.
- 13) ALL WOOD IN CONTACT WITH MASONRY, CONCRETE, OR EARTH SHALL BE PRESURE TREATED APPROPRIATELY FOR THE CONDITION.
- 14) ALL INTERIOR AND EXTERIOR FLOOR TILE SHALL HAVE A NON-SLIP FINISH FLOORING TO MEET ASTM C1028 STATIC COEFFICIENT OF FRICTION MIN OF 0.4.
- 15) CONTRACTOR TO ENSURE THAT ALL CONSTRUCTION COMPLES WITH NFPA LIFE SAFETY CODES AND 2004 FLORIDA BUILDING CODE REQUIREMENTS.

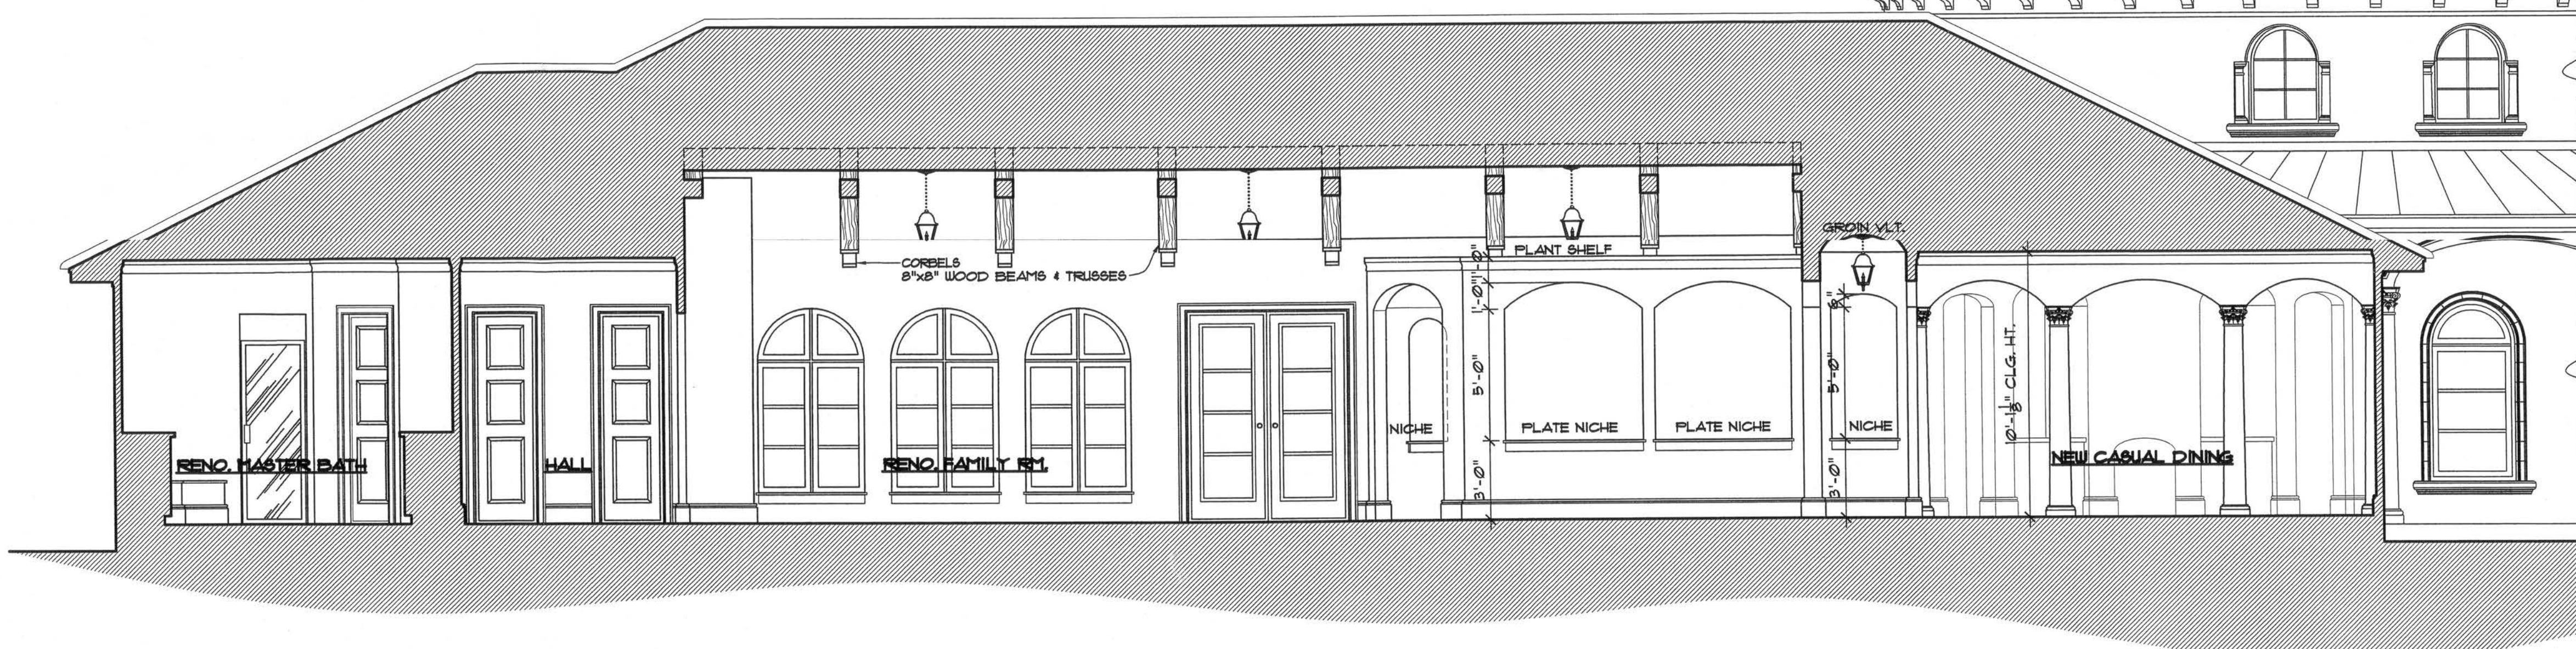
NOTE:

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ADDITIONS AND RENOVATIONS TO THE:
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161 NW LAKE JEFFERY ROAD
LAKE CITY, FLORIDA

DRAWN BY: AA RFF
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JOB NUMBER: ____
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DUS NO: 5
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RESIDENTIAL DESIGNS BY KEVIN GRAY, INC.
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Houston, Texas 77056
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FAX: (834) 389-1200
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FIRST FLOOR PLAN

AREA TABULATION

EXISTING 1st FLOOR HEATED	3612
NEW 1st FLOOR HEATED	1978
2nd FLOOR HEATED	1159
TOTAL HEATED	6749
NEW GARAGE + MECH	1451
EXISTING FRONT PORCH	1111
NEW SIDE PORCH	1734
BOX STORAGE	136
ENTRY TOWER	136
UNDER ROOF TOTALS	6665
ENTIRE STRUCTURE	7549
TOTAL ENCLOSED	1839
TOTAL UNENCLOSED	991

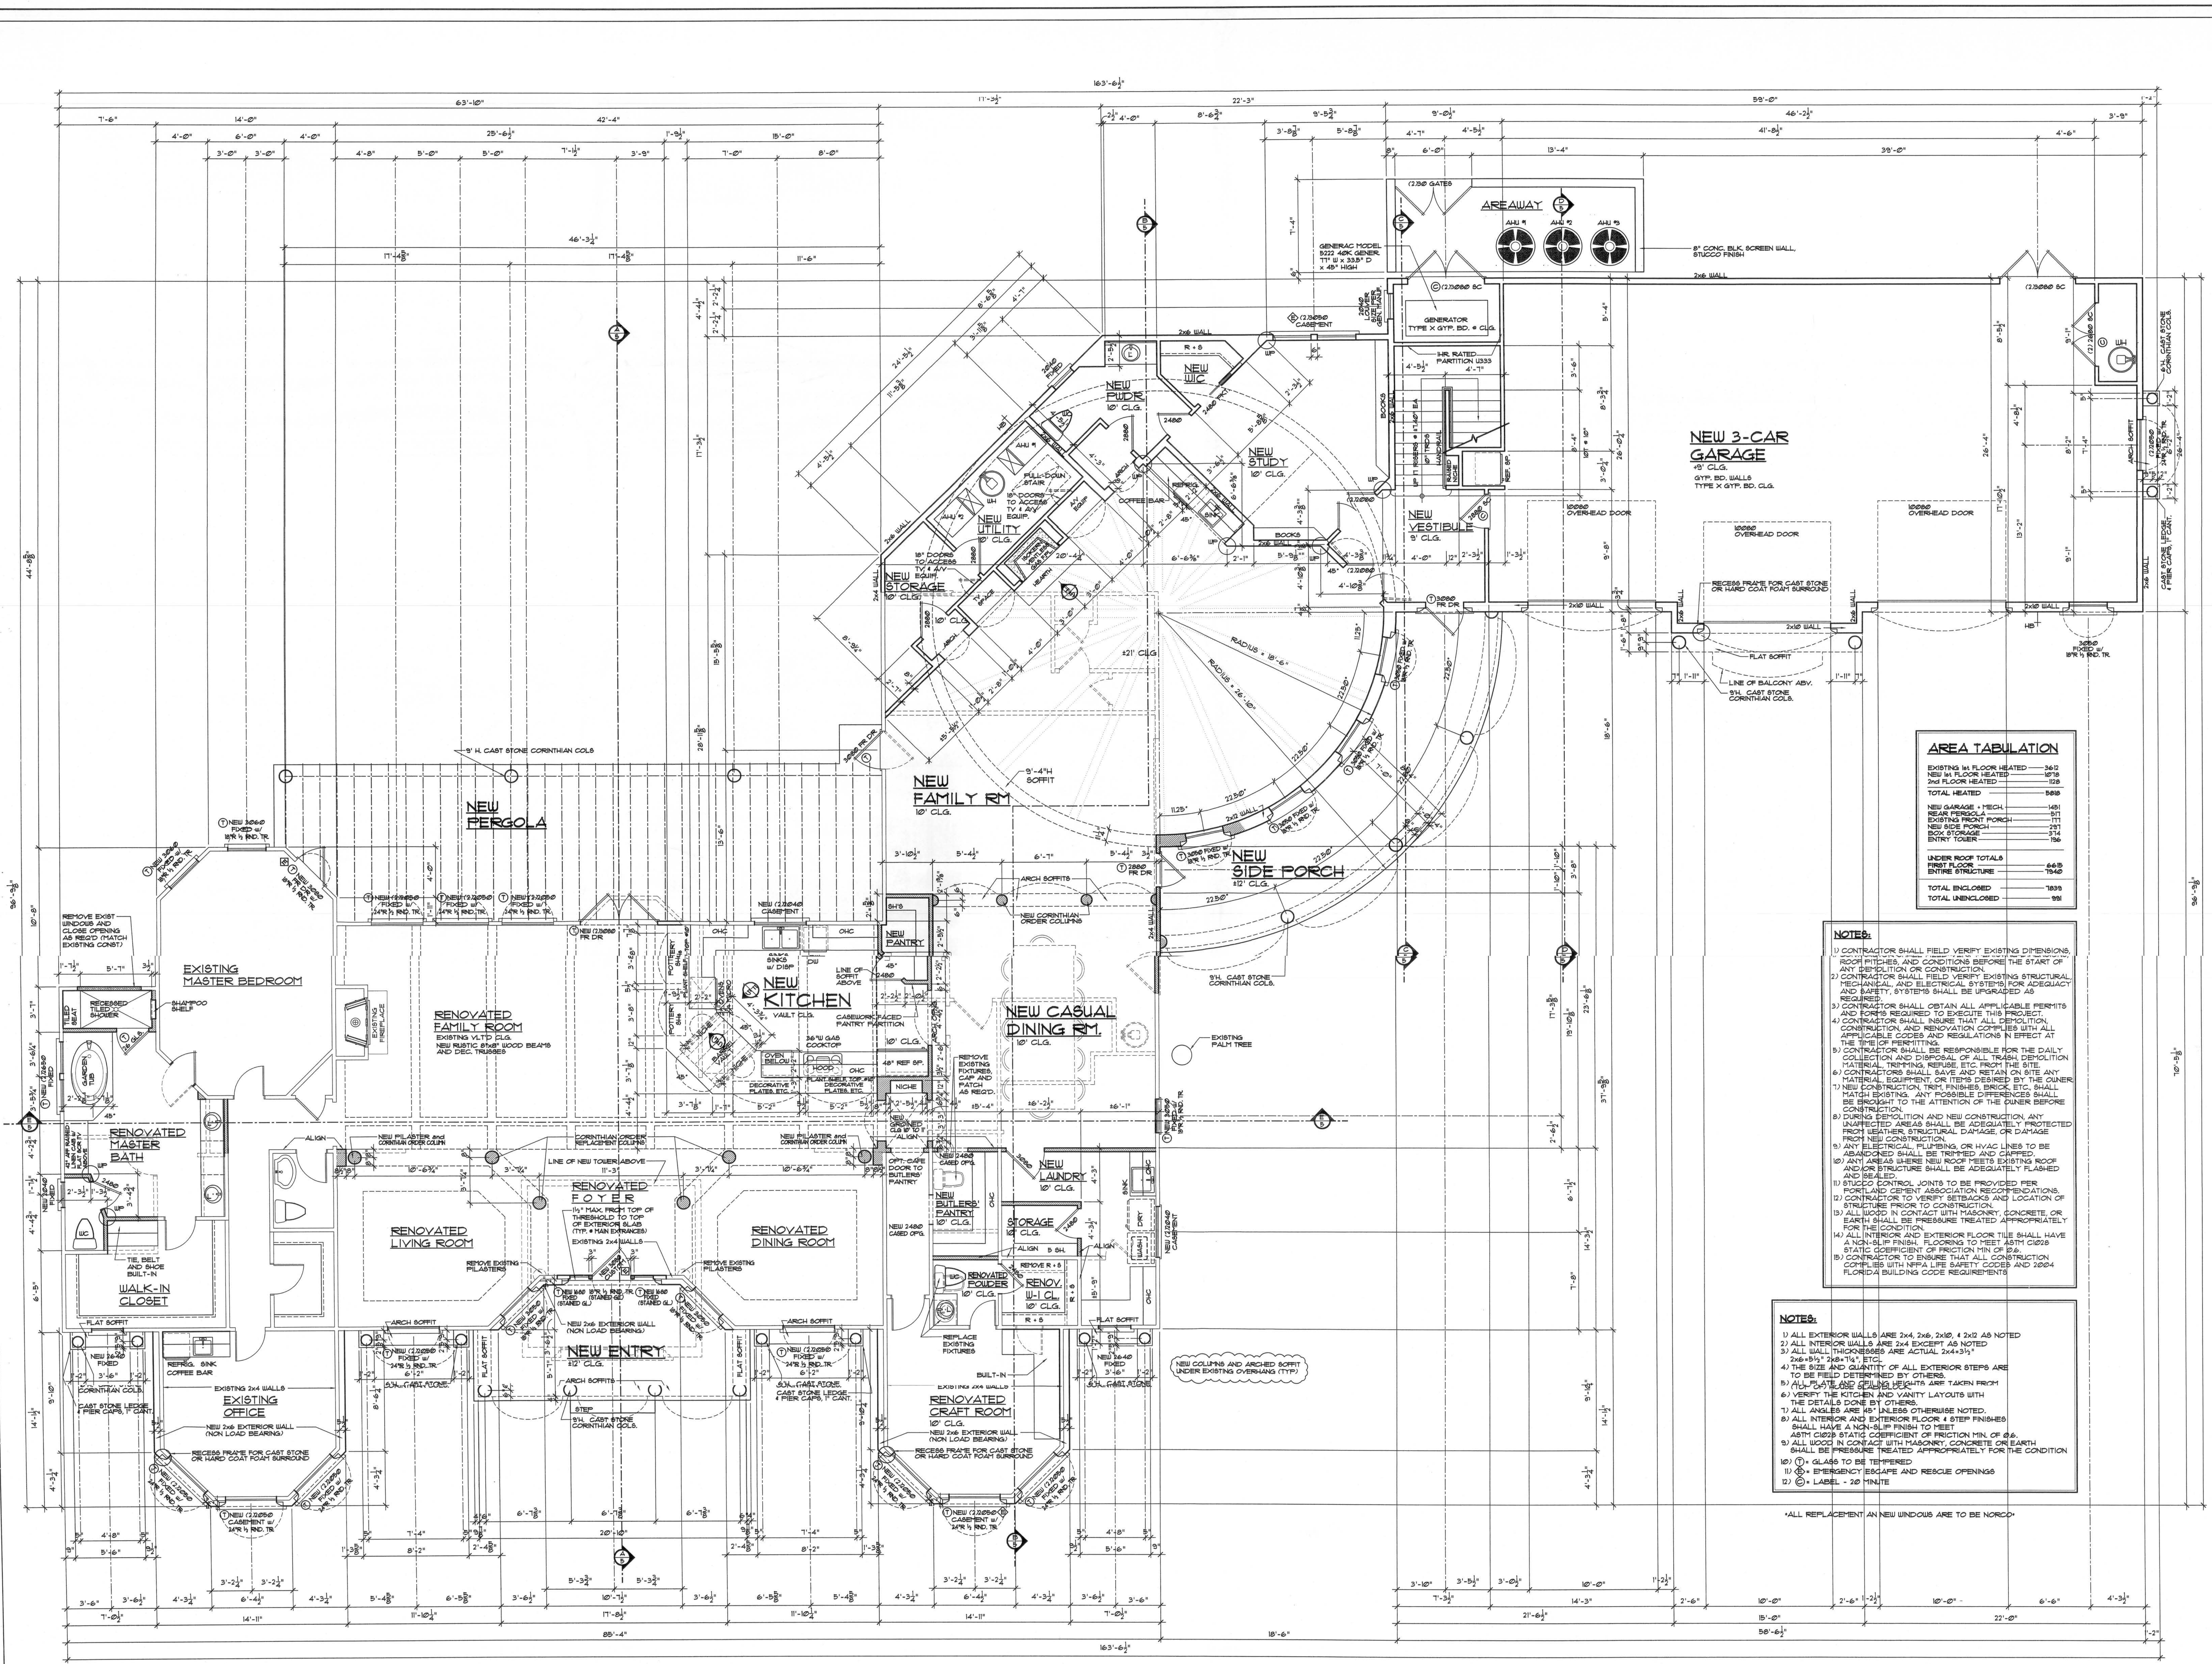- NOTES:**
- 1) CONTRACTOR SHALL FIELD VERIFY EXISTING DIMENSIONS, ROOM LAYOUTS, AND CONDITIONS BEFORE THE START OF ANY DEMOLITION OR CONSTRUCTION.
 - 2) CONTRACTOR SHALL FIELD VERIFY EXISTING STRUCTURAL, MECHANICAL, ELECTRICAL, AND PLUMBING SYSTEMS FOR ADEQUACY AND SAFETY. SYSTEMS SHALL BE REPAIRED OR REPLACED AS REQUIRED.
 - 3) CONTRACTOR SHALL OBTAIN ALL APPLICABLE PERMITS AND FORMS REQUIRED TO EXECUTE THIS PROJECT.
 - 4) CONTRACTOR SHALL MAINTAIN ACCESS TO ALL EXISTING UTILITIES AND ADJACENT PROPERTIES AT ALL TIMES.
 - 5) CONTRACTOR SHALL BE RESPONSIBLE FOR THE DAILY COLLECTION AND DISPOSAL OF ALL TRASH, DEMOLITION MATERIAL, TOPPING, CURBS, ETC. FROM THE SITE.
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 - 15) CONTRACTOR TO ENSURE THAT ALL CONSTRUCTION COMPLIES WITH NFPA LIFE SAFETY CODES AND 2004 FLORIDA BUILDING CODE REQUIREMENTS.

- NOTES:**
- 1) ALL EXTERIOR WALLS ARE 2x4, 2x6, 2x10, 4x2x8 AS NOTED.
 - 2) ALL INTERIOR WALLS ARE 2x4 EXCEPT AS NOTED.
 - 3) ALL WALL THICKNESSES ARE ACTUAL 2x4x3 1/2, 2x6x3 1/2, 2x10x3 1/2, ETC.
 - 4) THE SIZE AND QUANTITY OF ALL EXTERIOR STEPS ARE TO BE FIELD DETERMINED BY OTHERS.
 - 5) ALL PLATE AND CEILING HEIGHTS ARE TAKEN FROM FINISH FLOOR.
 - 6) VERIFY THE KITCHEN AND VANITY LAYOUTS WITH THE DETAILS DONE BY OTHERS.
 - 7) ALL ANGLES ARE 45° UNLESS OTHERWISE NOTED.
 - 8) ALL INTERIOR AND EXTERIOR FLOOR 4 STEP FINISHES SHALL HAVE A NON-SLIP FINISH TO MEET ASTM C1028.
 - 9) ALL WOOD IN CONTACT WITH MASONRY, CONCRETE OR EARTH SHALL BE PRESURE TREATED APPROPRIATELY FOR THE CONDITION.
 - 10) GLASS TO BE TINTED.
 - 11) 6" EMERGENCY ESCAPE AND RESCUE OPENINGS.
 - 12) 2" LABEL - 20 MINUTE.


*ALL REPLACEMENT OF NEW WINDOWS ARE TO BE NORDIC

NOTE:
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ADDITIONS AND RENOVATIONS TO THE:
MIKE & LINDA CADDY RESIDENCE
161 NW LAKE JEFFREY ROAD
LAKE CITY, FLORIDA


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RESIDENTIAL DESIGNS BY KEVIN GRAY, INC.
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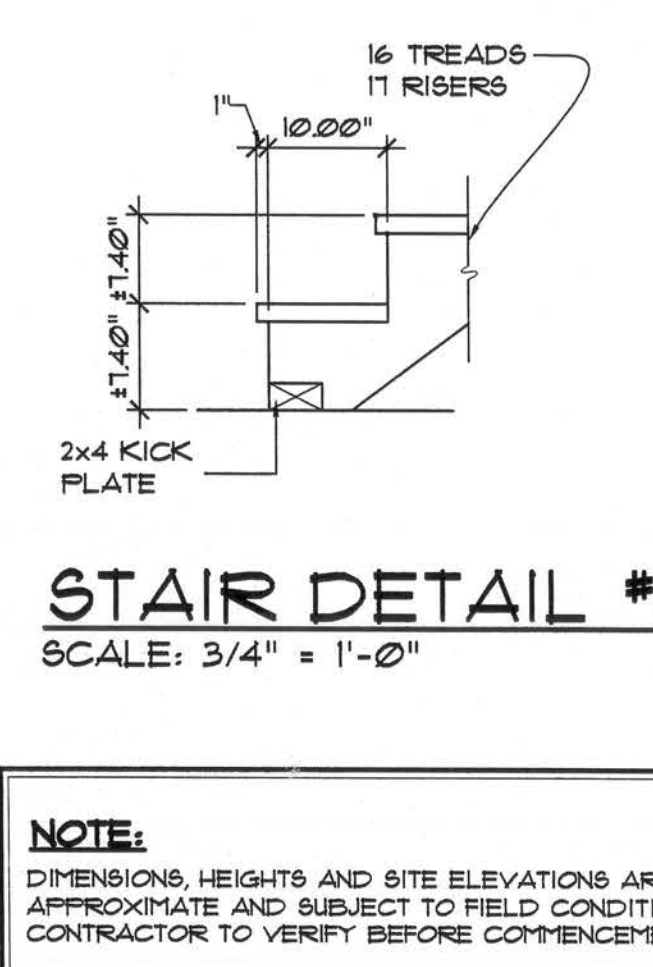
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11. STUCCO CONTROL JOINTS TO BE PROVIDED PER PORTLAND CEMENT ASSOCIATION RECOMMENDATIONS.
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15. CONTRACTOR TO ENSURE THAT ALL CONSTRUCTION COMPLIES WITH NFPA LIFE SAFETY CODES AND 2004 FLORIDA BUILDING CODE REQUIREMENTS.

SECOND FLOOR PLAN

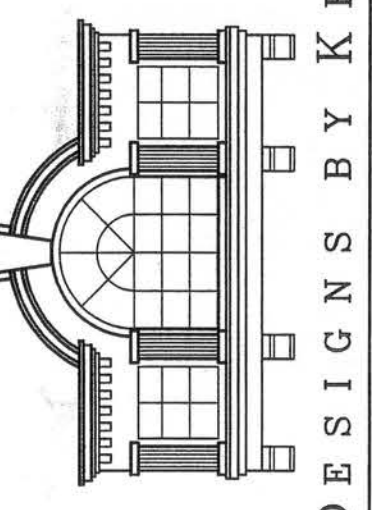

- NOTES:**
- 1) ALL EXTERIOR WALLS ARE 2x6 EXCEPT AS NOTED
 - 2) ALL INTERIOR WALLS ARE 2x4 EXCEPT AS NOTED
 - 3) ALL WALL THICKNESSES ARE ACTUAL 2x4x9 1/2"
 - 4) THE SIZE AND QUANTITY OF ALL EXTERIOR STEPS ARE TO BE FIELD DETERMINED BY OTHERS
 - 5) ALL PLATE AND CEILING HEIGHTS ARE TAKEN FROM (TOP OF HOUSE SLAB/SLACK)
 - 6) VERIFY THE KITCHEN AND VANITY LAYOUTS WITH THE DETAILS DONE BY OTHERS
 - 7) ALL ANGLES ARE 45° UNLESS OTHERWISE NOTED
 - 8) ALL INTERIOR AND EXTERIOR FLOOR FINISHES SHALL HAVE A NON-SLIP FINISH TO MEET ASTM C1028
 - 9) ALL WOOD IN CONTACT WITH MASONRY, CONCRETE OR EARTH SHALL BE PRESURE TREATED APPROPRIATELY FOR THE CONDITION
 - 10) (1) GLASS TO BE TEMPERED
 - 11) (2) EMERGENCY ESCAPE AND RESCUE OPENINGS

- NOTES:**
- 1) CONTRACTOR SHALL FIELD VERIFY EXISTING DIMENSIONS, ROOF PITCHES, AND CONDITIONS BEFORE THE START OF ANY DEMOLITION OR CONSTRUCTION
 - 2) CONTRACTOR SHALL FIELD VERIFY EXISTING STRUCTURAL, MECHANICAL, AND ELECTRICAL SYSTEMS FOR ADEQUACY AND SAFETY. SYSTEMS SHALL BE UPGRADED AS REQUIRED
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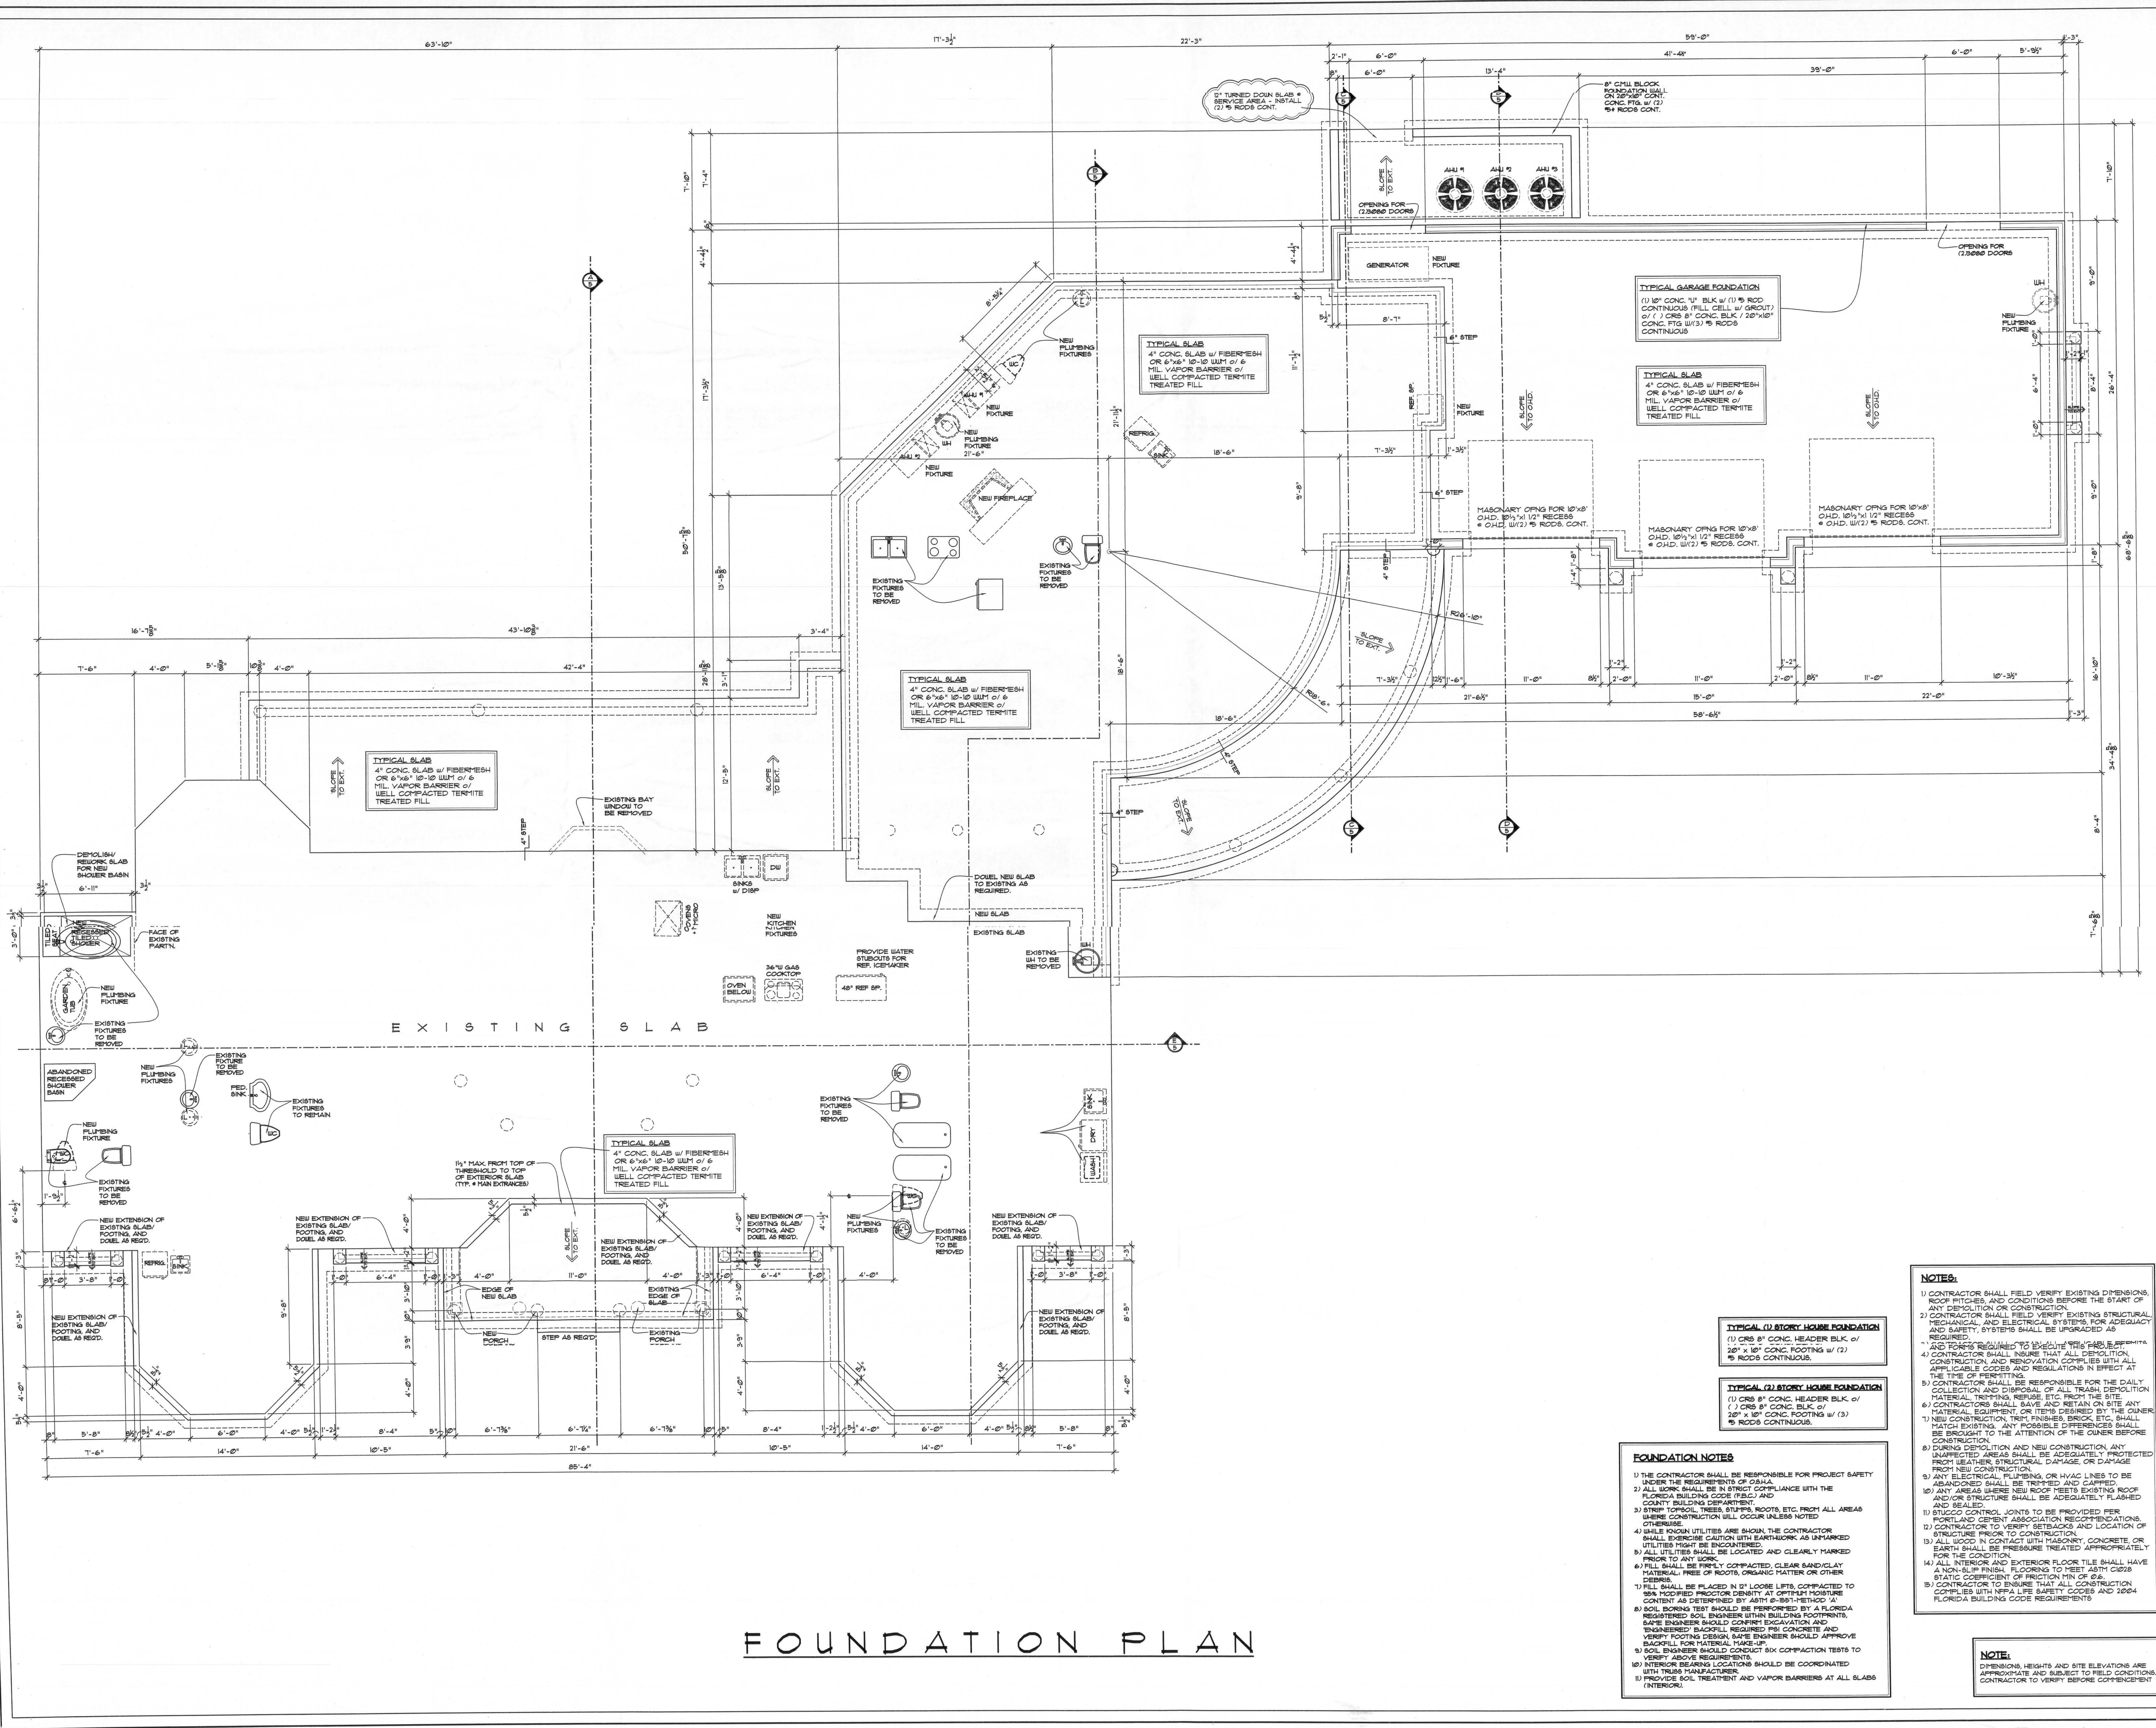

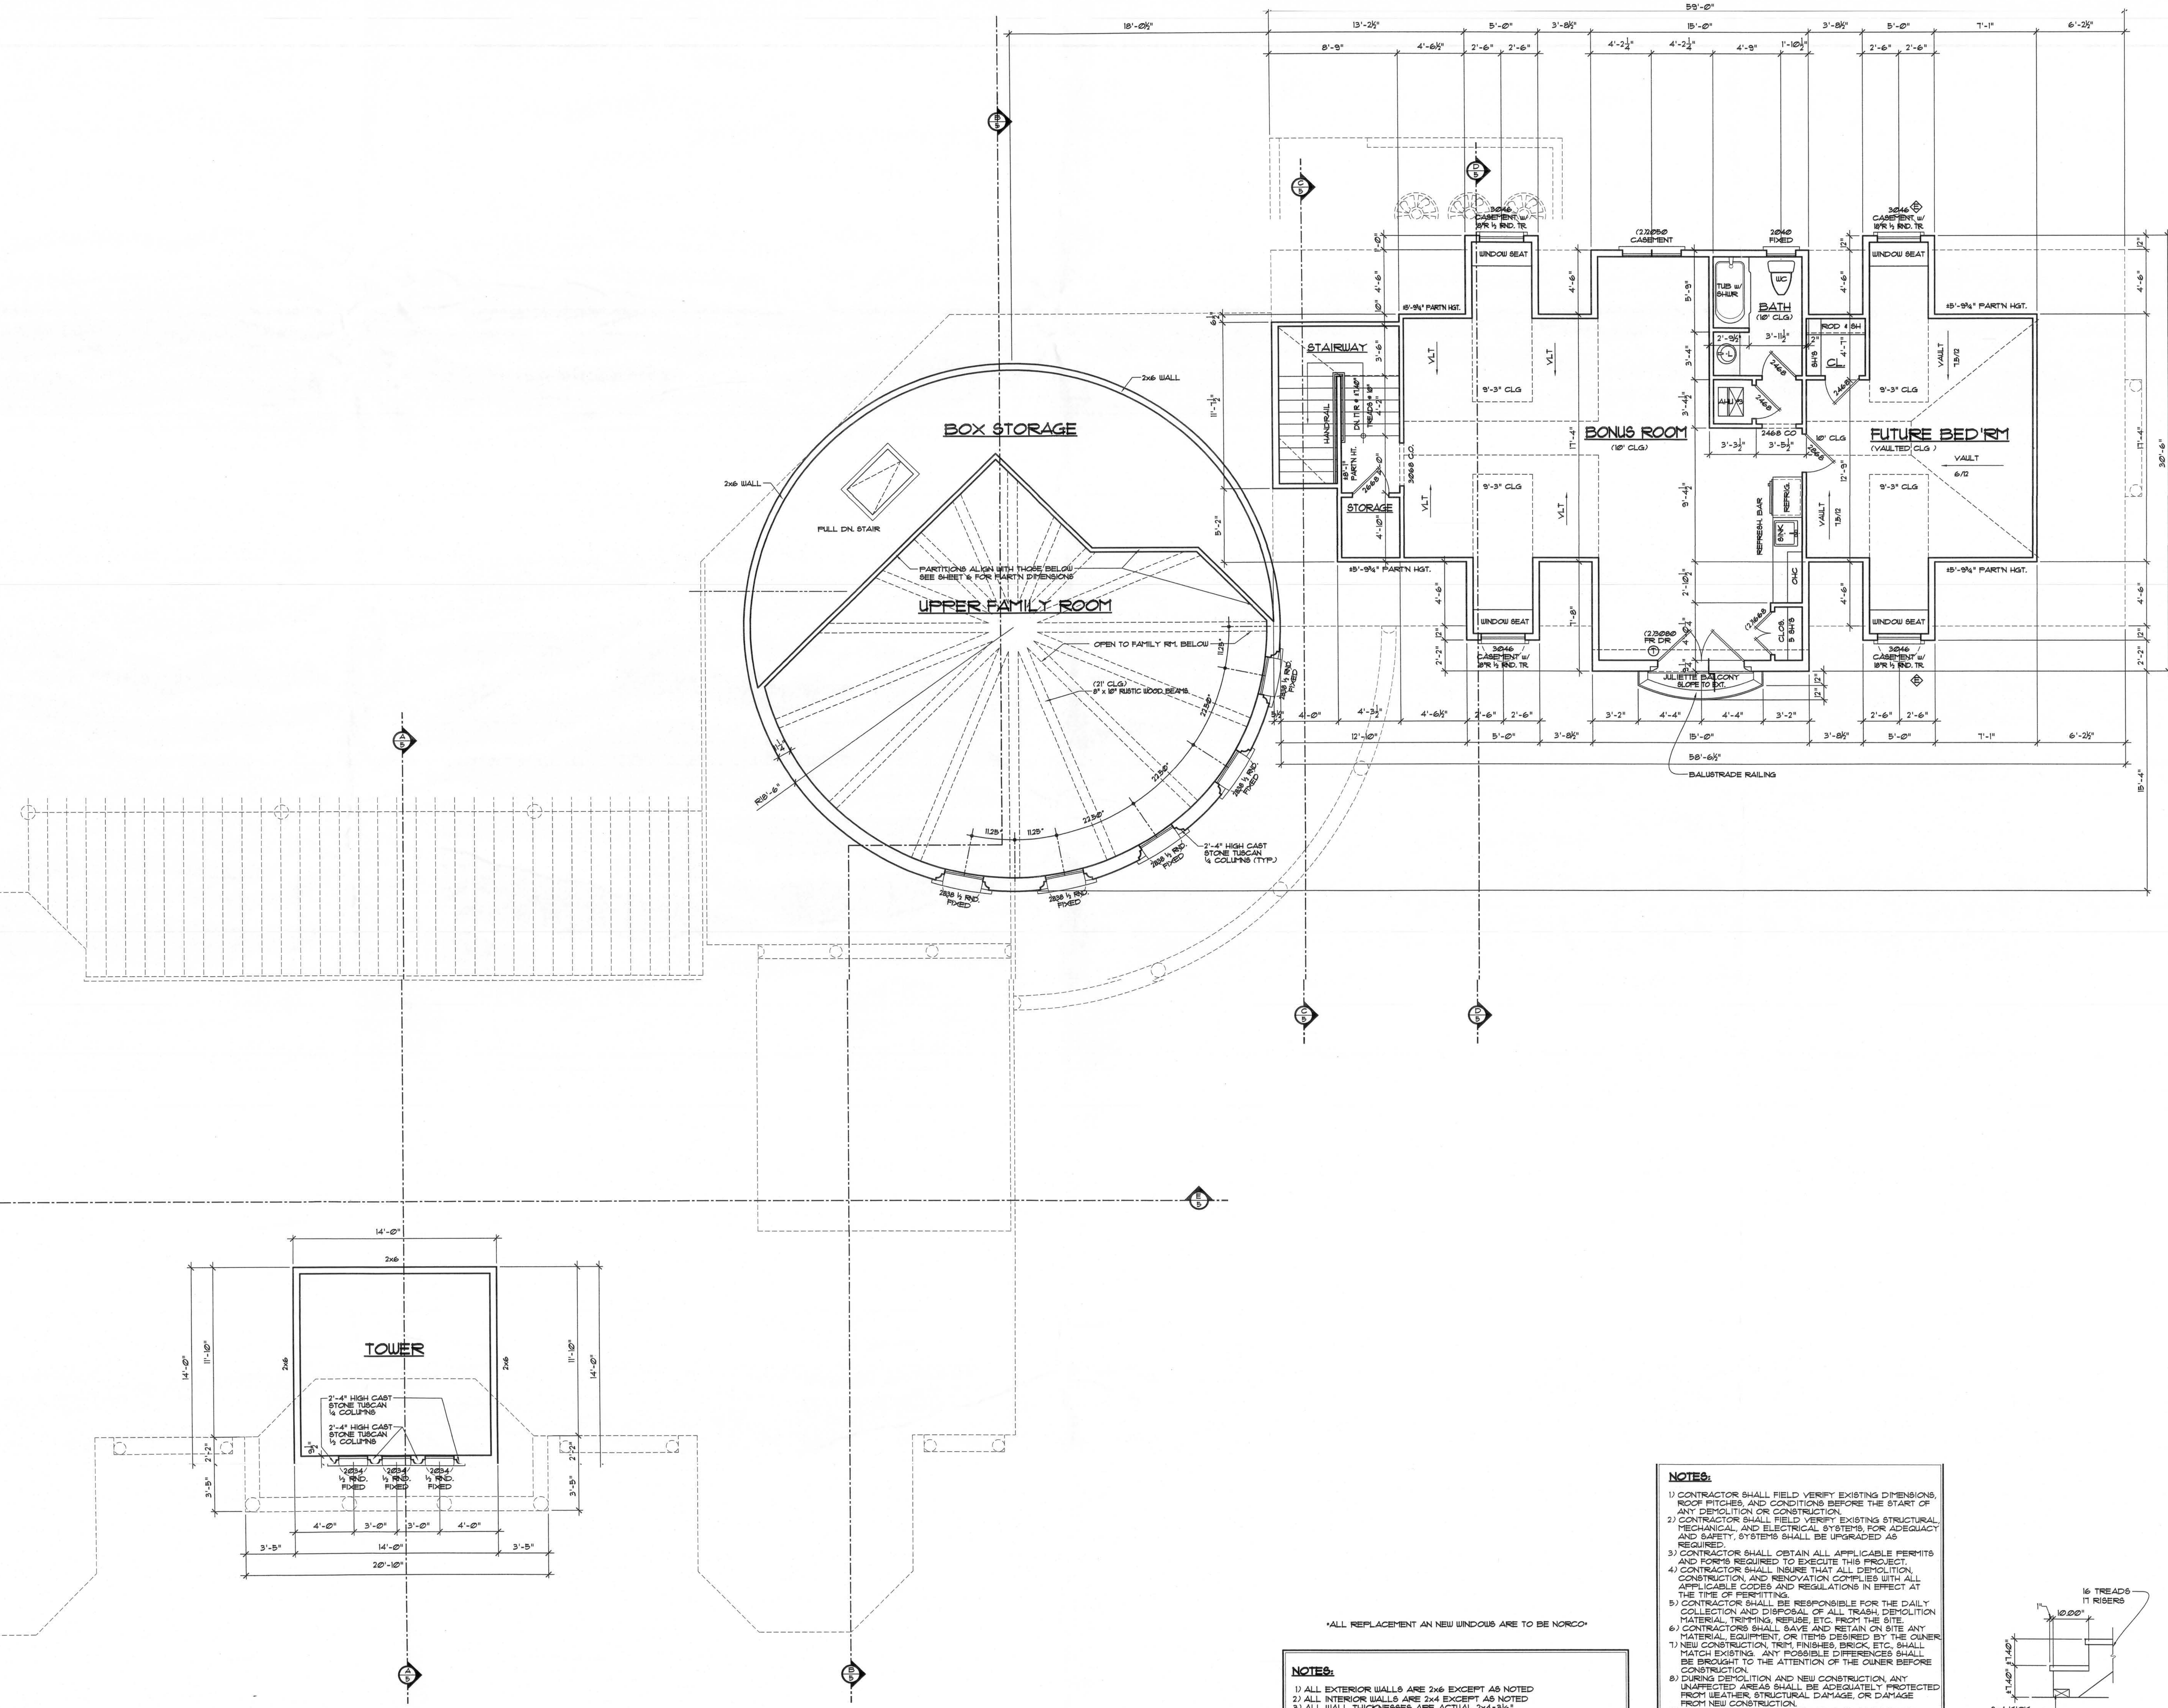
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16 NW LAKE JEFFER ROAD
LAKE CITY, FLORIDA

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RESIDENTIAL DESIGNS BY KEVIN GRAY, INC.



FOUNDATION PLAN

- FOUNDATION NOTES**
- 1) THE CONTRACTOR SHALL BE RESPONSIBLE FOR PROJECT SAFETY UNDER THE REQUIREMENTS OF OSHA.
 - 2) ALL WORK SHALL BE IN STRICT COMPLIANCE WITH THE FLORIDA BUILDING CODE (FBC) AND COUNTY BUILDING DEPARTMENT.
 - 3) STRIP TOPSOIL, TREES, STUMP, ROOTS, ETC. FROM ALL AREAS WHERE CONSTRUCTION WILL OCCUR UNLESS NOTED OTHERWISE.
 - 4) WHILE KNOWN UTILITIES ARE SHOWN, THE CONTRACTOR SHALL EXERCISE CAUTION WITH EARTHWORK AS UNMARKED UTILITIES MIGHT BE ENCOUNTERED.
 - 5) ALL UTILITIES SHALL BE LOCATED AND CLEARLY MARKED PRIOR TO ANY WORK.
 - 6) FILL SHALL BE PROPERLY COMPACTED, CLEAR SAND/CLAY MATERIAL, FREE OF ROOTS, ORGANIC MATTER OR OTHER DEBRIS.
 - 7) FILL SHALL BE PLACED IN 12\"/>
 - 8) SOIL BORING TEST SHOULD BE PERFORMED BY A FLORIDA REGISTERED SOIL ENGINEER WITHIN BUILDING FOOTPRINTS, ENGINEER BACKFILL REQUIRED PSI CONCRETE AND VERIFY FOOTING DESIGN. SAME ENGINEER SHOULD APPROVE BACKFILL FOR MATERIAL TAKE-UP.
 - 9) SOIL ENGINEER SHOULD CONDUCT SIX COMPACTION TESTS TO VERIFY ABOVE REQUIREMENTS.
 - 10) INTERIOR BEARING LOCATIONS SHOULD BE COORDINATED WITH TRUSS MANUFACTURER.
 - 11) PROVIDE SOIL TREATMENT AND VAPOR BARRIERS AT ALL SLABS (INTERIOR).

- NOTES:**
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 - 2) CONTRACTOR SHALL FIELD VERIFY EXISTING STRUCTURAL, MECHANICAL, AND ELECTRICAL SYSTEMS FOR ADEQUACY AND SAFETY. SYSTEMS SHALL BE UPGRADED AS REQUIRED.
 - 3) *AND FORKS REQUIRED TO EXHAUST THIS PLAN, REFER TO THE FOLLOWING:
 - 4) CONTRACTOR SHALL INSURE THAT ALL DEMOLITION, CONSTRUCTION, AND RENOVATION COMPLES WITH ALL APPLICABLE CODES AND REGULATIONS IN EFFECT AT THE TIME OF PERMITTING.
 - 5) CONTRACTOR SHALL BE RESPONSIBLE FOR THE DAILY COLLECTION AND DISPOSAL OF ALL TRASH/DEMOLITION MATERIAL, TRIPPING, REFUSE, ETC. FROM THE SITE.
 - 6) CONTRACTORS SHALL HAVE AND RETAIN ON SITE ANY MATERIAL, EQUIPMENT, OR ITEMS DESIRED BY THE OWNER.
 - 7) NEW CONSTRUCTION, TRIP FINISHED BRICK, ETC. SHALL MATCH EXISTING. ANY POSSIBLE DIFFERENCES SHALL BE BROUGHT TO THE ATTENTION OF THE OWNER BEFORE CONSTRUCTION.
 - 8) DURING DEMOLITION AND NEW CONSTRUCTION, ANY UNEXPECTED AREAS SHALL BE ADEQUATELY PROTECTED FROM WEATHER, STRUCTURAL DAMAGE, OR DAMAGE FROM NEW CONSTRUCTION.
 - 9) ANY ELECTRICAL, PLUMBING, OR HVAC LINES TO BE ABANDONED SHALL BE TIED AND CAPPED.
 - 10) ANY AREAS WHERE NEW ROOF MEETS EXISTING ROOF AND/OR STRUCTURE SHALL BE ADEQUATELY FLASHED AND SEALED.
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 - 13) ALL WOOD IN CONTACT WITH MASONRY, CONCRETE, OR EARTH SHALL BE PRESURE TREATED APPROPRIATELY FOR THE CONTACT.
 - 14) ALL INTERIOR AND EXTERIOR FLOOR TILE SHALL HAVE A NON-SLIP FINISH. FLOORING TO MEET ASTM C1028 STATIC COEFFICIENT OF FRICTION (COF) OR OF CONSTRUCTION COFFICES WITH NEW LIFE SAFETY CODES AND 2004 FLORIDA BUILDING CODE REQUIREMENTS.
- NOTE:**
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RESIDENTIAL DESIGNS BY KEVIN GRAY, INC.

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ROOF ATTIC/VENTILATION AREA CALCULATIONS

Excerpt of the 2004 Florida Building Code, Residential R906

Roofed ventilation shall be provided for enclosed attics and enclosed roof spaces where ceilings are applied directly to the underside of roof rafters shall have cross ventilation for enclosed attics by providing openings protected against the entrance of rain. Ventilation openings shall be provided with a minimum clear area of 1 sq. ft. per 100 sq. ft. of attic area.

R906.2 Minimum Area
The total net free ventilating area shall not be less than 1 to 50 of the area of the space ventilated except that the total area is permitted to be reduced to 1 to 100 provided at least 50 percent and not more than 50 percent of the required ventilating area is provided by ventilators located in the upper portion of the space to be ventilated at least 5 feet (1524 mm) above eave or cornice vents. As an alternative, the net free cross-ventilation area may be reduced to 1 to 100 when a vapor barrier having a transmission rate not exceeding 1 perm (0.4 eqh) is installed on the same side of the ceiling.

R906.3 Vent Clearance
Where eave or cornice vents are installed, insulation shall not block the free flow of air. A minimum of a 1-inch (25.4 mm) space shall be provided between the insulation and the roof sheathing at the location of the vent.

VENTILATION REQUIRED


HYAC	4630	Square Footage
Garage	140	Square Footage
Covered Porches	114	Square Footage
	665	Total attic sq. ft.
665 x .500	332.5	Square Footage net free area req'd
2225 x 3.500%	1169	

Roof Vent Specifications (per manufacturer)

38"x14" vent tiles provide 185 sq.ft. net free area
"O'HAGAN'S INC. VENT TILE MODEL "B" R906-20" OR EQUAL"

Vents Required

(1) 38"x14" vents = 185 sq.ft. = 12.50
12.50 Total sq.ft. net free area provided

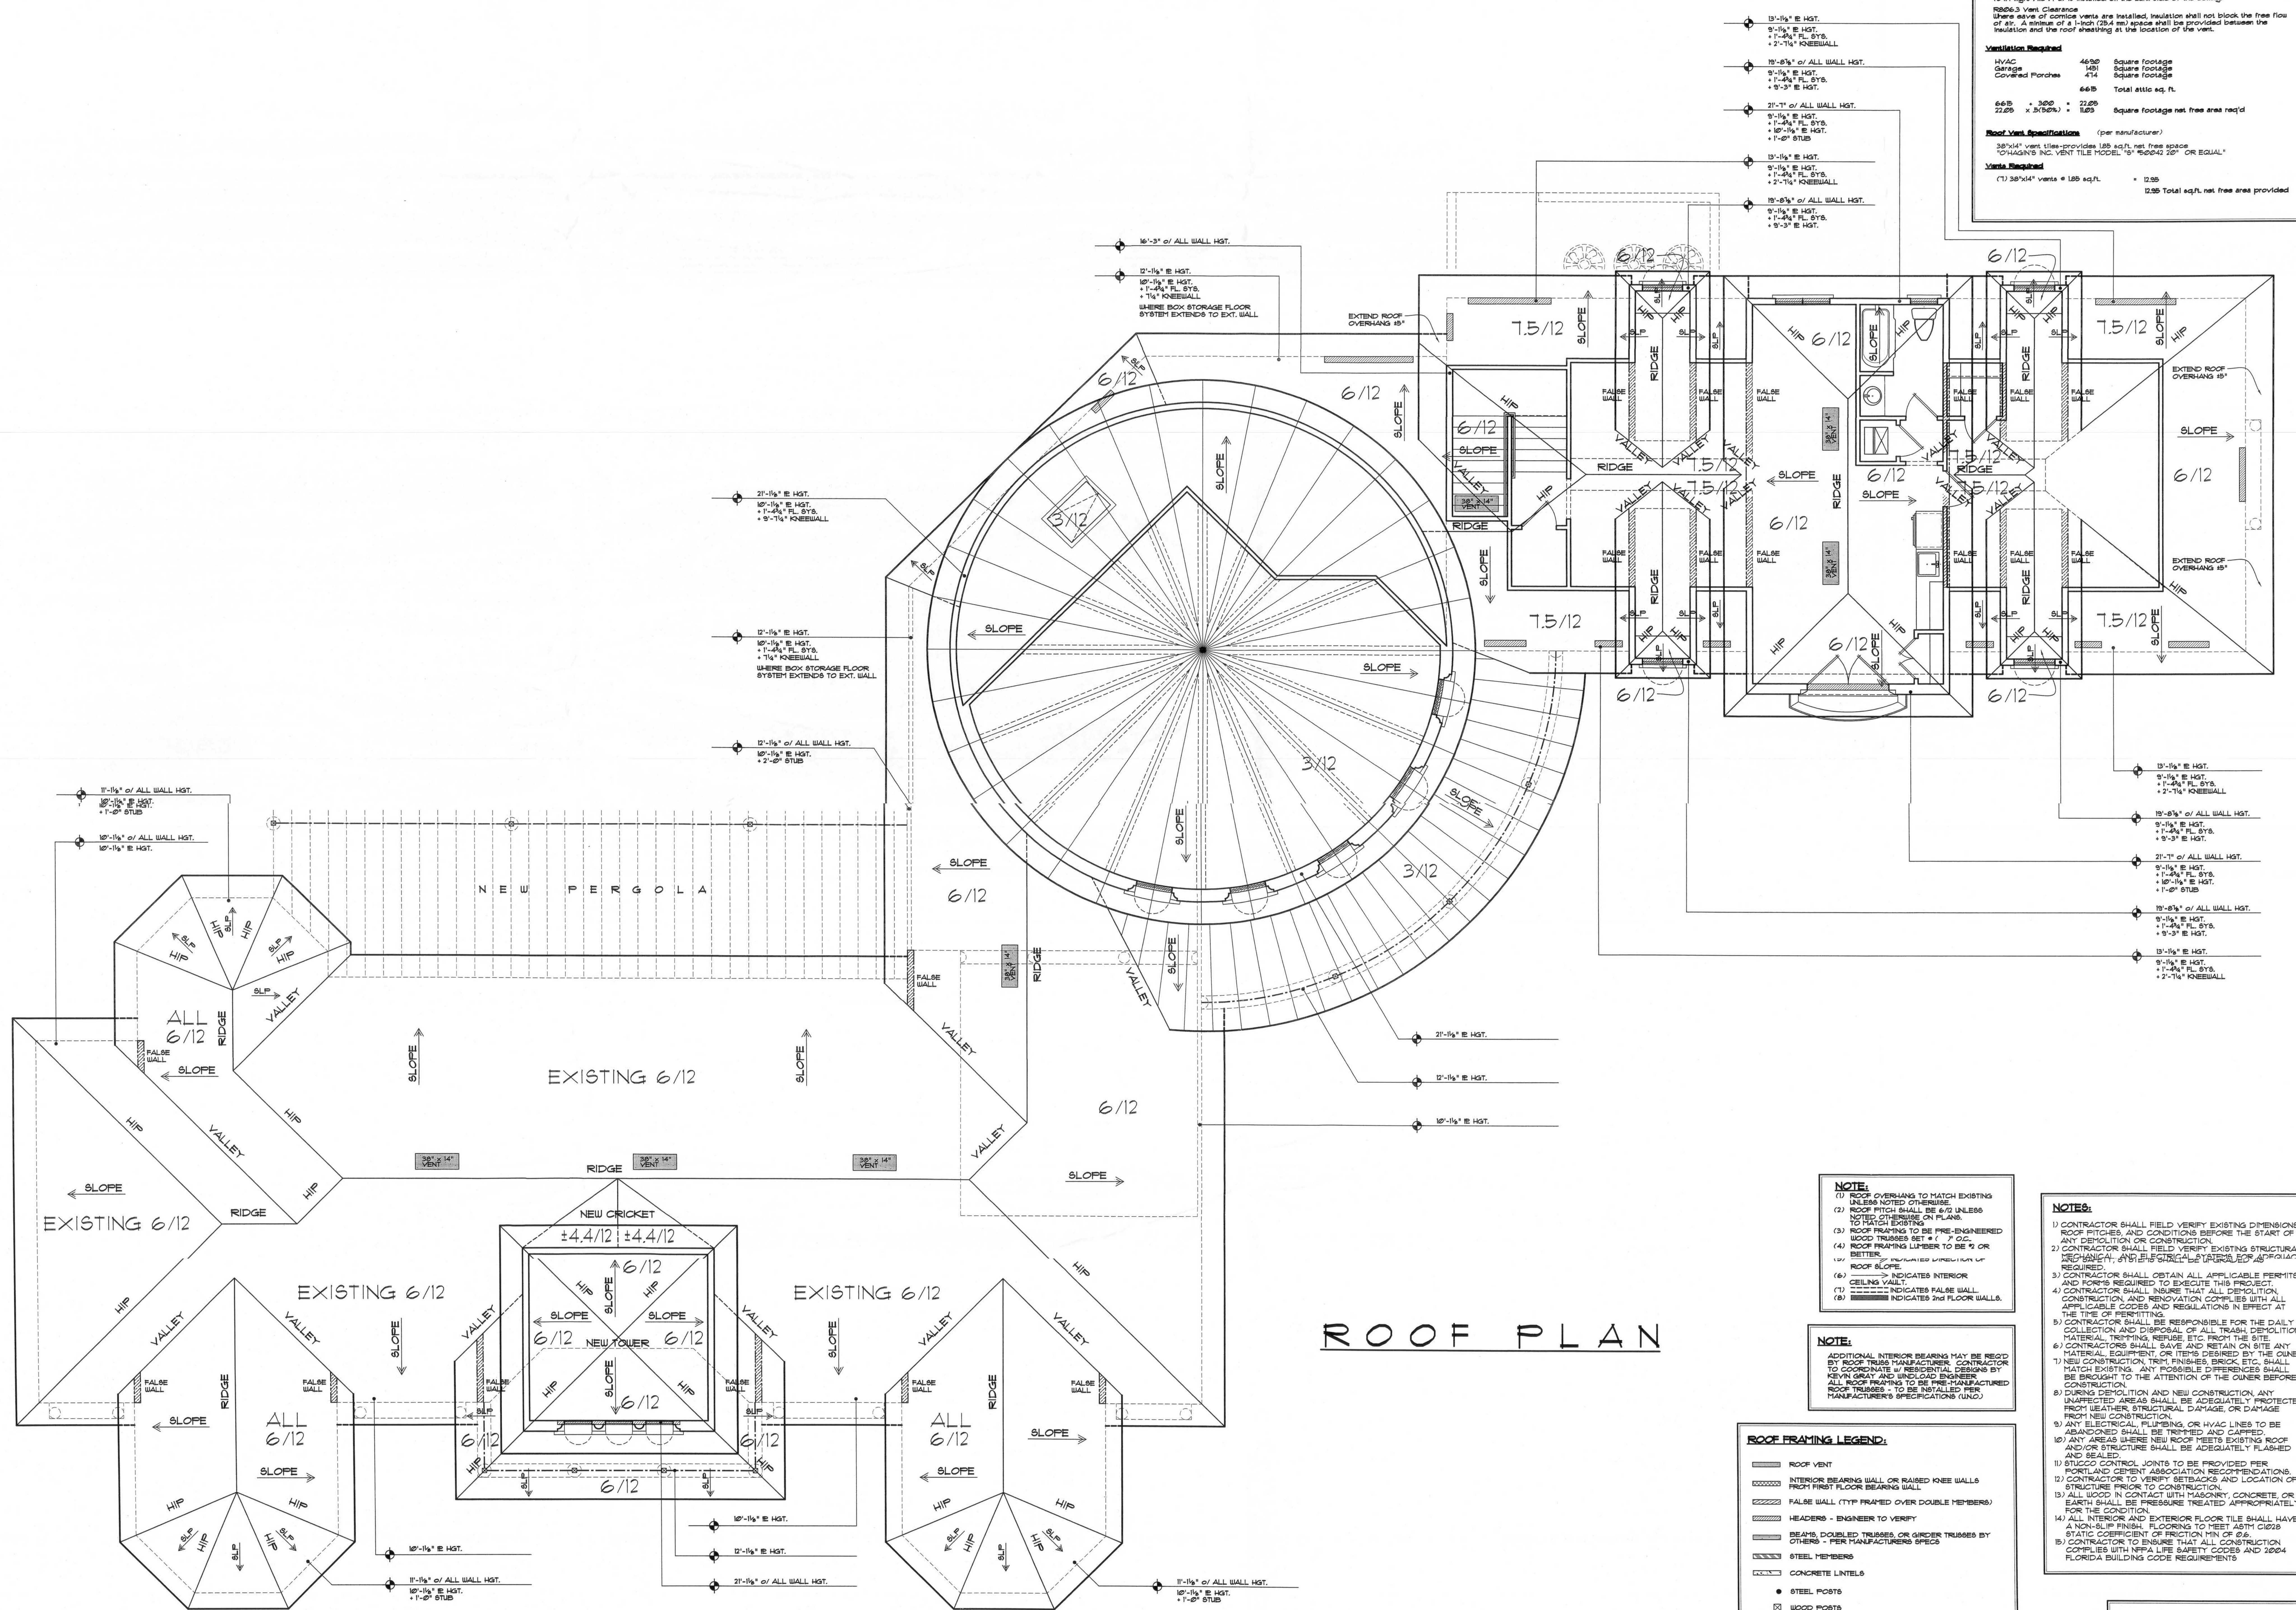

ROOF PLAN

- NOTE:**
- (1) ROOF OVERHANGS TO MATCH EXISTING UNLESS NOTED OTHERWISE
 - (2) ROOF PITCH SHALL BE 6/12 UNLESS NOTED OTHERWISE ON PLANS
 - (3) ROOF FRAMING TO BE PRE-ENGINEERED WOOD TRUSSES SET AT 7' O.C.
 - (4) ROOF FRAMING LUMBER TO BE #1 OR BETTER, UNLESS OTHERWISE SPECIFIED
 - (5) CEILING SHALL BE 5/8" INDICATES INTERIOR
 - (6) DASHED LINE INDICATES FALSE WALL
 - (7) DOTTED LINE INDICATES 2ND FLOOR WALLS

- NOTE:**
- ADDITIONAL INTERIOR BEARING MAY BE REQUIRED BY ROOF TRUSS MANUFACTURER. CONTRACTOR TO COORDINATE WITH RESIDENTIAL DESIGNER BY KEVIN GRAY AND UNILOAD ENGINEERS. ALL ROOF FRAMING TO BE PRE-MANUFACTURED TRUSSES - TO BE INSTALLED PER MANUFACTURER'S SPECIFICATIONS (UNCL).

ROOF FRAMING LEGEND:

- ROOF VENT
- INTERIOR BEARING WALL OR RAISED KNEE WALLS
- ROOF FIRST FLOOR BEARING WALL
- FALSE WALL (TYP FRAMED OVER DOUBLE MEMBERS)
- HEADERS - ENGINEER TO VERIFY
- BEAMS, DOUBLED TRUSSES, OR OTHER TRUSSES BY OTHERS - PER MANUFACTURER'S SPEC
- STEEL MEMBERS
- CONCRETE LINTELS
- STEEL POSTS
- WOOD POSTS
- ROOF JOISTS OR ROOF TRUSSES BY OTHERS
- BEAM, JOIST, OR TRUSS HANGERS


- NOTES:**
- 1) CONTRACTOR SHALL FIELD VERIFY EXISTING DIMENSIONS, ROOF PITCHES, AND CONDITIONS BEFORE THE START OF ANY DEMOLITION OR CONSTRUCTION
 - 2) CONTRACTOR SHALL FIELD VERIFY EXISTING STRUCTURAL MEMBERS, SYSTEMS, AND MATERIALS. ANY DISCREPANCIES SHALL BE BROUGHT TO THE ATTENTION OF THE OWNER BEFORE CONSTRUCTION
 - 3) CONTRACTOR SHALL OBTAIN ALL APPLICABLE PERMITS AND FORMS REQUIRED TO EXECUTE THIS PROJECT
 - 4) CONTRACTOR SHALL INSURE THAT ALL DEMOLITION, CONSTRUCTION, AND RENOVATION COMPLIES WITH ALL APPLICABLE CODES AND REGULATIONS IN EFFECT AT THE TIME OF PERMITTING
 - 5) CONTRACTOR SHALL BE RESPONSIBLE FOR THE DAILY COLLECTION AND DISPOSAL OF ALL TRASH, DEMOLITION MATERIAL, TRIMMING, REFUSE, ETC. FROM THE SITE
 - 6) CONTRACTORS SHALL SAVE AND RETAIN ON SITE ANY MATERIAL, EQUIPMENT, OR ITEMS DESIGNED BY THE OWNER
 - 7) NEW CONSTRUCTION, TRIM, FINISHES, BRICK, ETC. SHALL MATCH EXISTING. ANY POSSIBLE DIFFERENCES SHALL BE BROUGHT TO THE ATTENTION OF THE OWNER BEFORE CONSTRUCTION
 - 8) DURING DEMOLITION AND NEW CONSTRUCTION, ANY UNPROTECTED AREAS SHALL BE ADEQUATELY PROTECTED FROM WEATHER, STRUCTURAL DAMAGE, OR DAMAGE FROM NEW CONSTRUCTION
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 - 10) ANY AREAS WHERE NEW ROOF MEETS EXISTING ROOF AND/OR STRUCTURE SHALL BE ADEQUATELY FLASHED AND SEALED
 - 11) STUCCO CONTROL JOINTS TO BE PROVIDED PER PORTLAND CEMENT ASSOCIATION RECOMMENDATIONS
 - 12) CONTRACTOR TO VERIFY SETBACKS AND LOCATION OF STRUCTURE PRIOR TO CONSTRUCTION
 - 13) ALL WOOD IN CONTACT WITH MASONRY, CONCRETE, OR EARTH SHALL BE PRESURE TREATED APPROPRIATELY FOR THE CONDITION
 - 14) NON-SLIP FINISH FLOORING TO MEET ASTM C1028
 - 15) CONTRACTOR TO ENSURE THAT ALL CONSTRUCTION COMPLIES WITH NFPA LIFE SAFETY CODES AND 2004 FLORIDA BUILDING CODE REQUIREMENTS

NOTE:
DIMENSIONS, HEIGHTS AND SITE ELEVATIONS ARE APPROXIMATE AND SUBJECT TO FIELD CONDITIONS. CONTRACTOR TO VERIFY BEFORE COMMENCEMENT

ADDITIONS AND RENOVATIONS TO THE:
MIKE & LINDA CADY RESIDENCE
161 NW LAKE JEFFREY ROAD
LAKE CITY, FLORIDA

DRAWN BY: AA RFF
CHECKED BY:
DATE: 02/11/06
SCALE: 1/4" = 1'-0"
JOB NUMBER: 0000
REVISED:
FIG. NO. 9 13


10701 DUNWOOD PARK BLVD.
SUITE #200
JACKSONVILLE, FLORIDA 32206
RESIDENTIAL DESIGNS BY KEVIN GRAY, INC.
PHONE: (904) 384-3895
FAX: (904) 388-1880
www.kevingrayinc.com

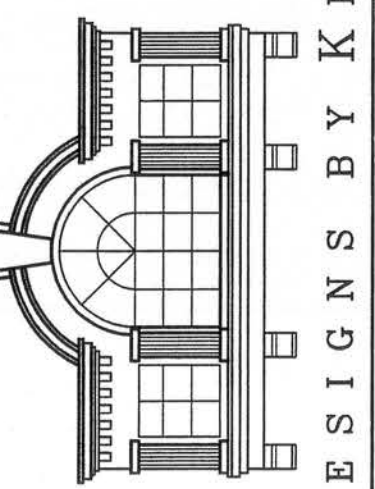

NOTES:
1. ALL DIMENSIONS ARE TO FACE UNLESS OTHERWISE NOTED.
2. ALL ROOF PITCHES ARE 6/12 UNLESS OTHERWISE NOTED.
3. ALL ROOF FRAMING LUMBER IS TO BE #1 OR BETTER UNLESS OTHERWISE NOTED.
4. ALL ROOF TRUSSES ARE TO BE PRE-ENGINEERED UNLESS OTHERWISE NOTED.
5. ALL ROOF VENTS ARE TO BE 38" X 14" UNLESS OTHERWISE NOTED.
6. ALL ROOF OVERHANGS ARE TO MATCH EXISTING UNLESS OTHERWISE NOTED.
7. ALL ROOF FLASHING IS TO BE DONE PER MANUFACTURER'S SPECIFICATIONS.
8. ALL ROOF JOISTS ARE TO BE 2" X 8" UNLESS OTHERWISE NOTED.
9. ALL ROOF TRUSSES ARE TO BE 12" X 16" UNLESS OTHERWISE NOTED.
10. ALL ROOF MEMBERS ARE TO BE KILN DRIED UNLESS OTHERWISE NOTED.
11. ALL ROOF JOISTS ARE TO BE SPACED AT 16" O.C. UNLESS OTHERWISE NOTED.
12. ALL ROOF TRUSSES ARE TO BE SPACED AT 7' O.C. UNLESS OTHERWISE NOTED.
13. ALL ROOF FLASHING IS TO BE DONE PER MANUFACTURER'S SPECIFICATIONS.
14. ALL ROOF VENTS ARE TO BE 38" X 14" UNLESS OTHERWISE NOTED.
15. ALL ROOF OVERHANGS ARE TO MATCH EXISTING UNLESS OTHERWISE NOTED.

WEATHER RESISTIVE BARRIER (WRB) APPLIED PRIOR TO THE WINDOW INSTALLATION.
FLASHING APPLIED BEHIND THE MOUNTING FLANGE.

-

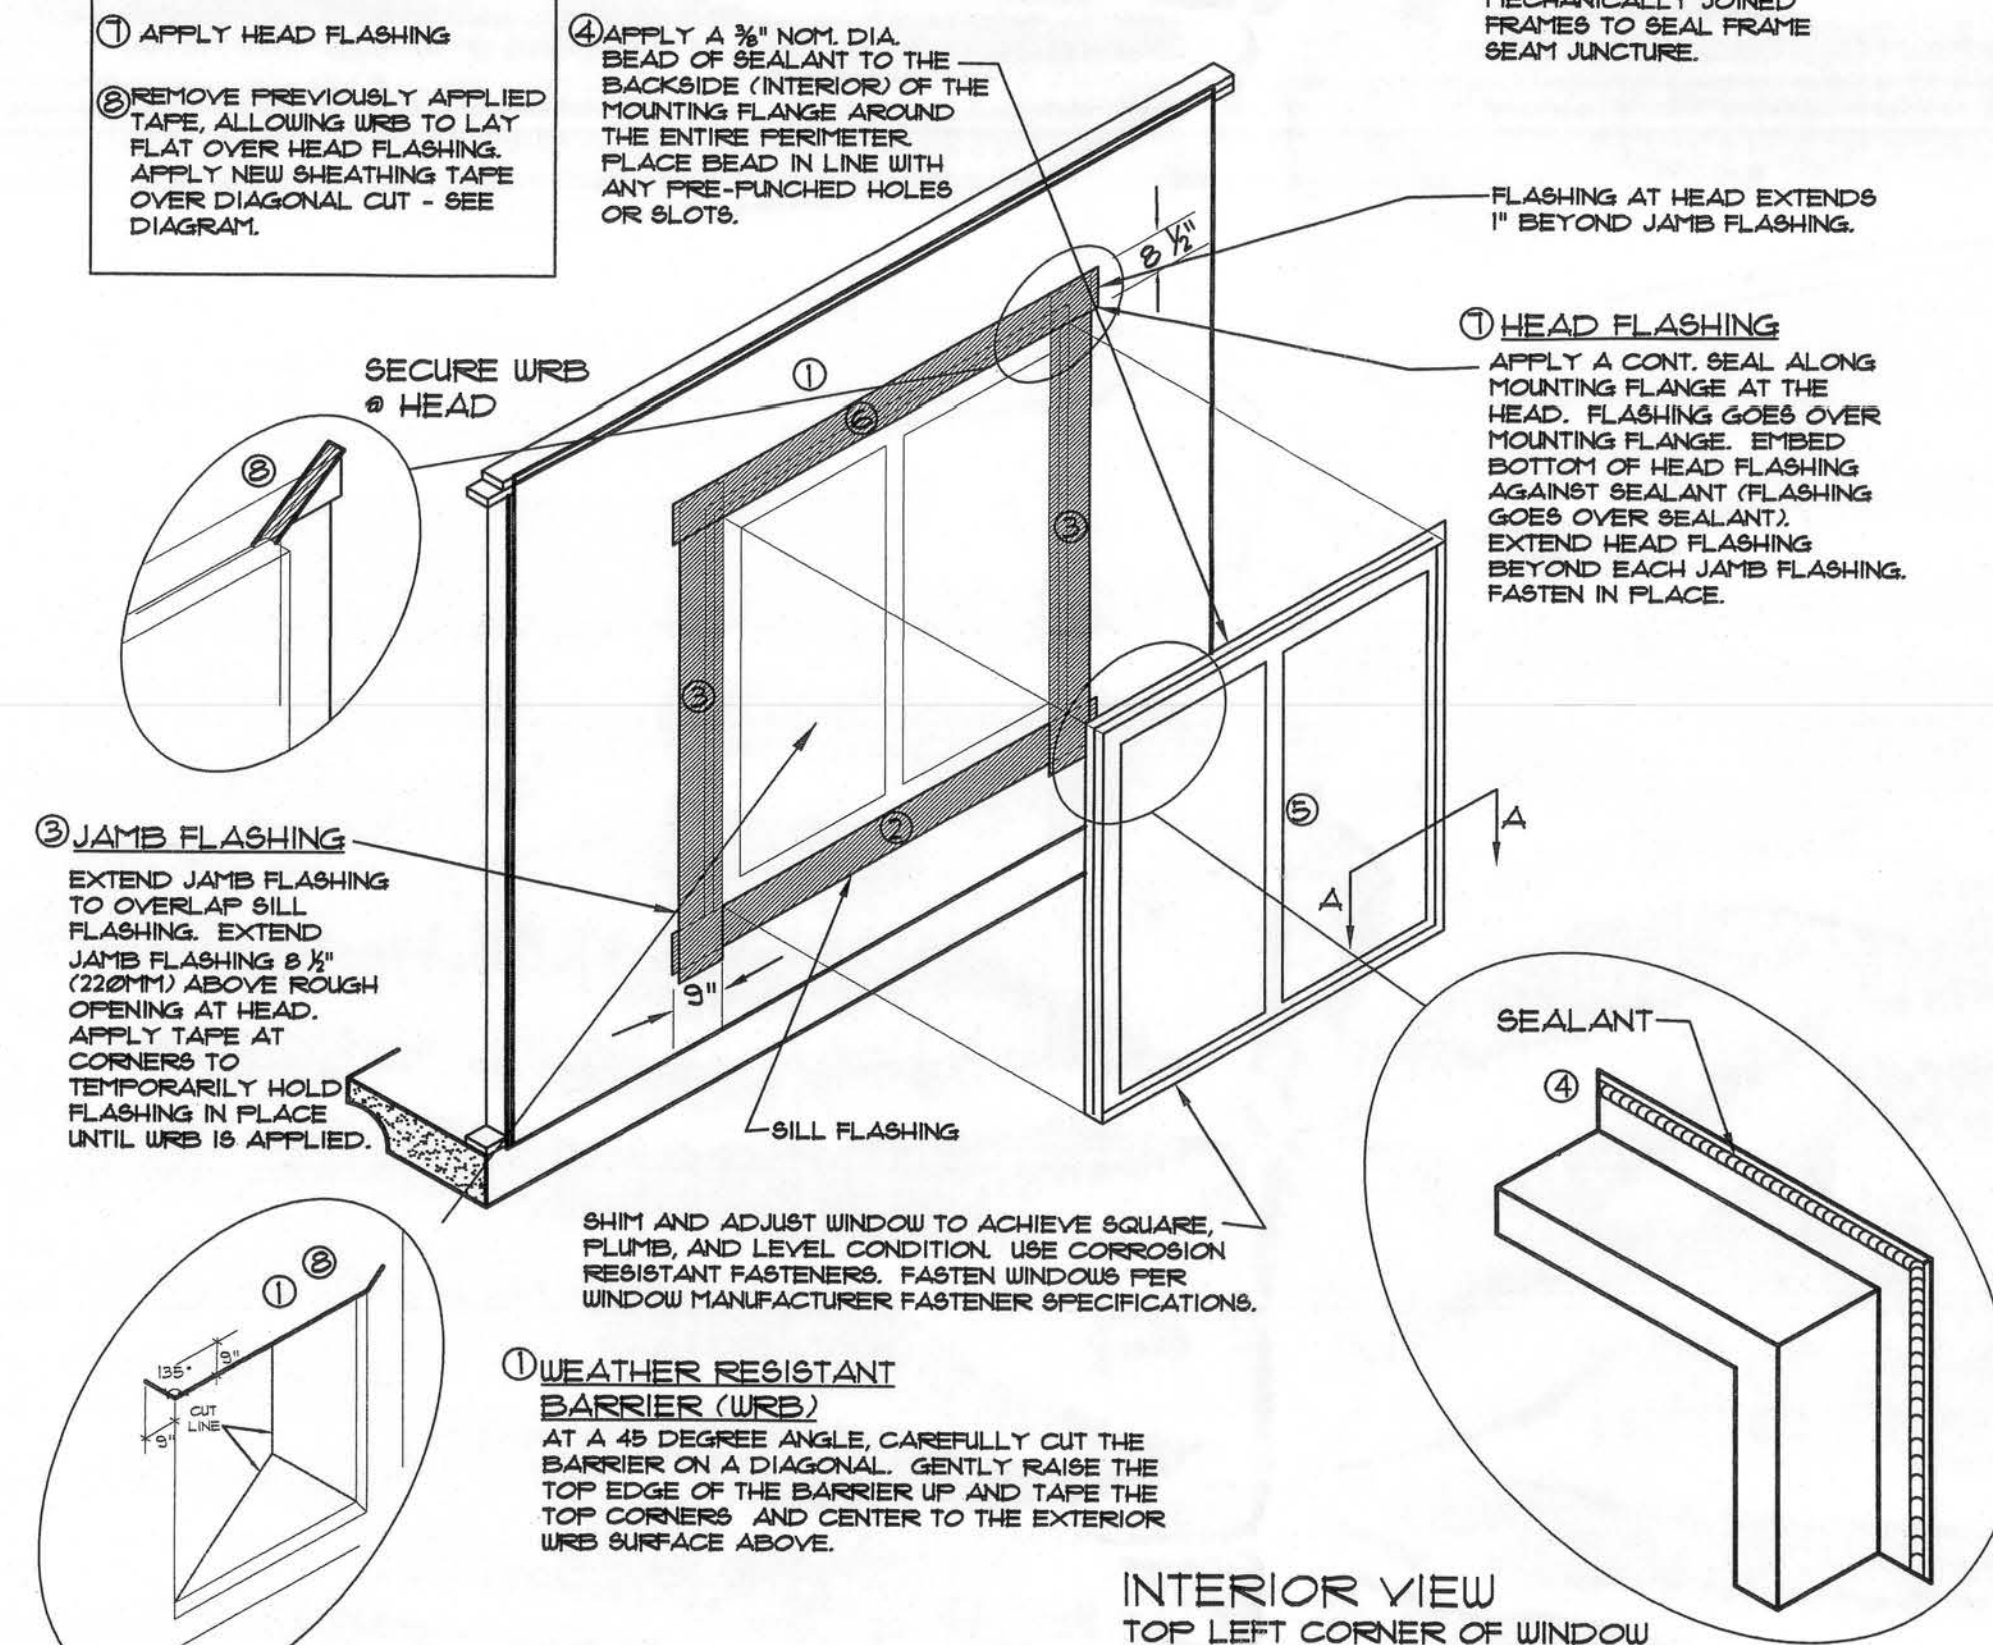


AFTER INSTALLATION
SEAL ALL CORNERS OF
MECHANICALLY JOINED
FRAMES TO SEAL FRAME
SEAM JUNCTURE.


- FLASHING AT HEAD EXTENDS 1" BEYOND JAMB FLASHING.
- ① HEAD FLASHING
- APPLY A CONT. SEAL ALONG MOUNTING FLANGE AT THE HEAD. FLASHING GOES OVER MOUNTING FLANGE. EMBED BOTTOM OF HEAD FLASHING AGAINST SEALANT (FLASHING GOES OVER SEALANT). EXTEND HEAD FLASHING BEYOND EACH JAMB FLASHING FASTEN IN PLACE.

① WEATHER RESISTANT BARRIER (WRB)
AT A 45 DEGREE ANGLE, COVER THE TOP EDGE OF THE BARRIER ON TOP CORNERS AND CENTRAL WRB SURFACE ABOVE.

INTERIOR VIEW
TOP LEFT CORNER OF WINDOW

WEATHER RESISTIVE BARRIER (WRB) APPLIED PRIOR TO THE WINDOW INSTALLATION.
FLASHING APPLIED OVER THE FACE OF THE MOUNTING FLANGE.

- 
- UNDER THE FLAP OF URB AT THE HEAD. SEE DIAGRAM
- 1 2
- 1/8" 1/8" 1/8"
- 1 WEATHER BAR AT A BAR

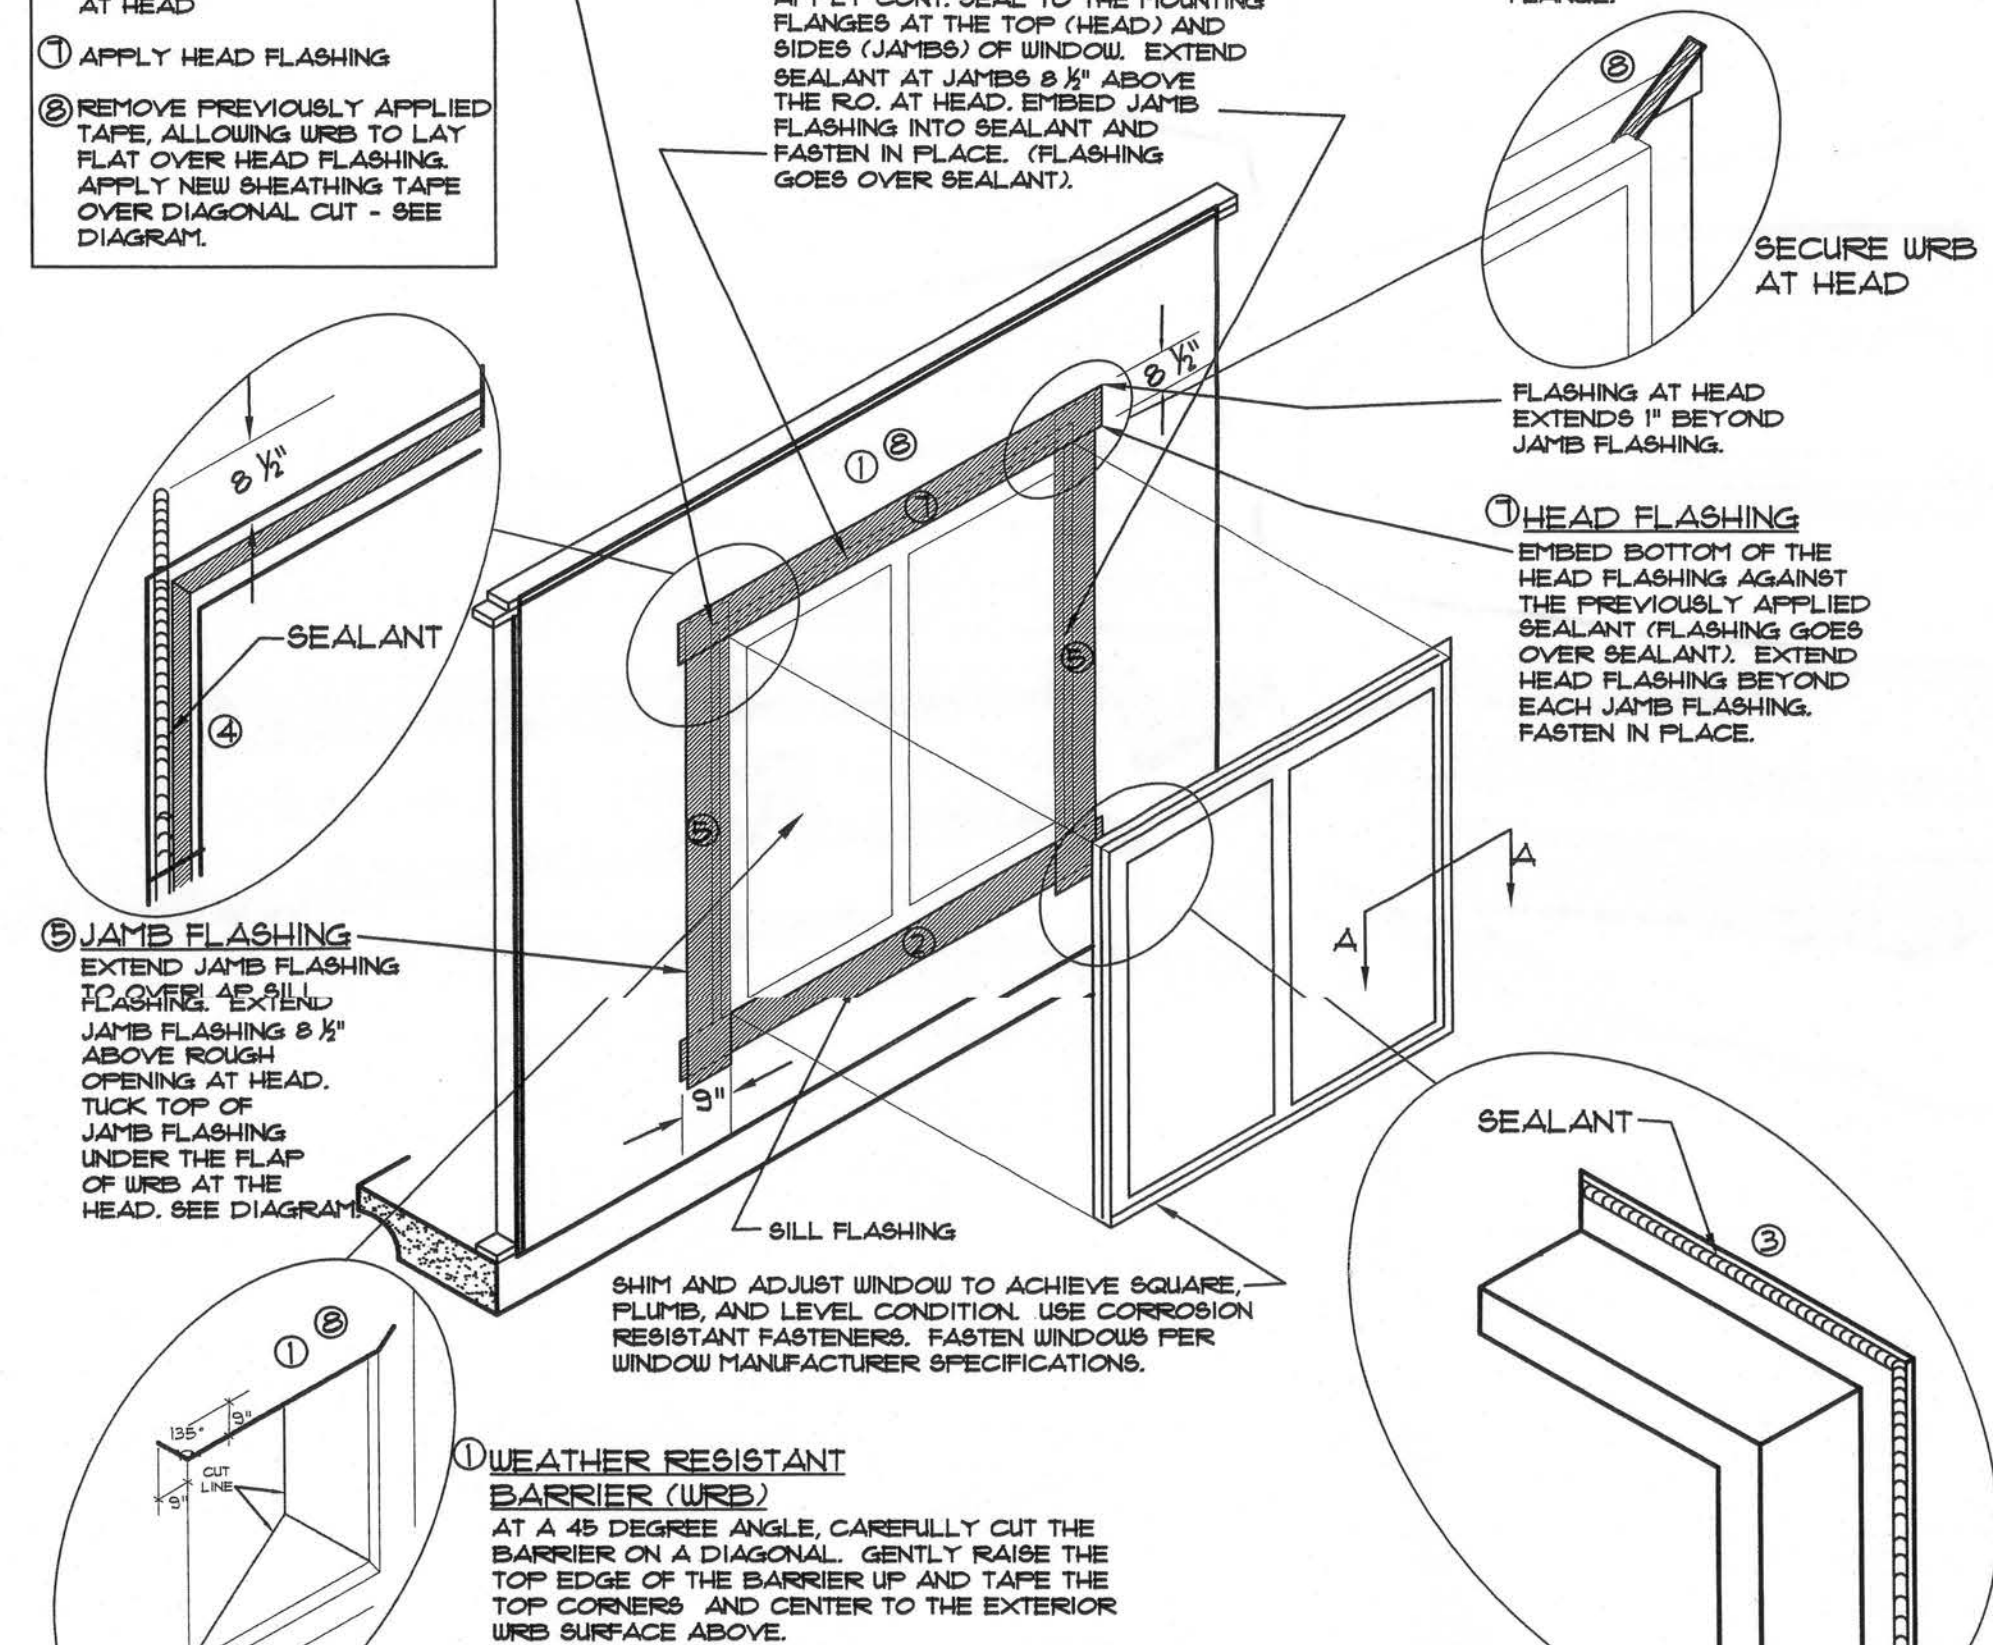

SEALANT BEAD BETWEEN FLASHING AND MOUNTING FLANGE.

SECURE AT HEAD


FLASHING AT HEAD EXTENDS 1" BEYOND JOINT FLASHING.

3 HEAD FLASHING EMBED BOTTOM OF THE HEAD FLASHING AGAINST THE PREVIOUSLY APPLIED

WEATHER RESISTANT BARRIER (WRB)
AT A 45 DEGREE ANGLE, CARBARRIER ON A DIAGONAL FROM TOP EDGE OF THE BARRIER UP TOP CORNERS AND CENTER WRB SURFACE ABOVE.

INTERIOR VIEW
TOP LEFT CORNER OF WINDOW


CONC. BARREL TILE ROOF on _____
1 x 2 PRESSURE-TREATED FURRING
STRIPS ON MINERAL SURFACED
120 ML THICK MODIFIED BITUMEN
with FIBERGLASS REINFORCEMENT,
EDGES AND PENETRATIONS SEALED
on 30lb ROOFING FELT

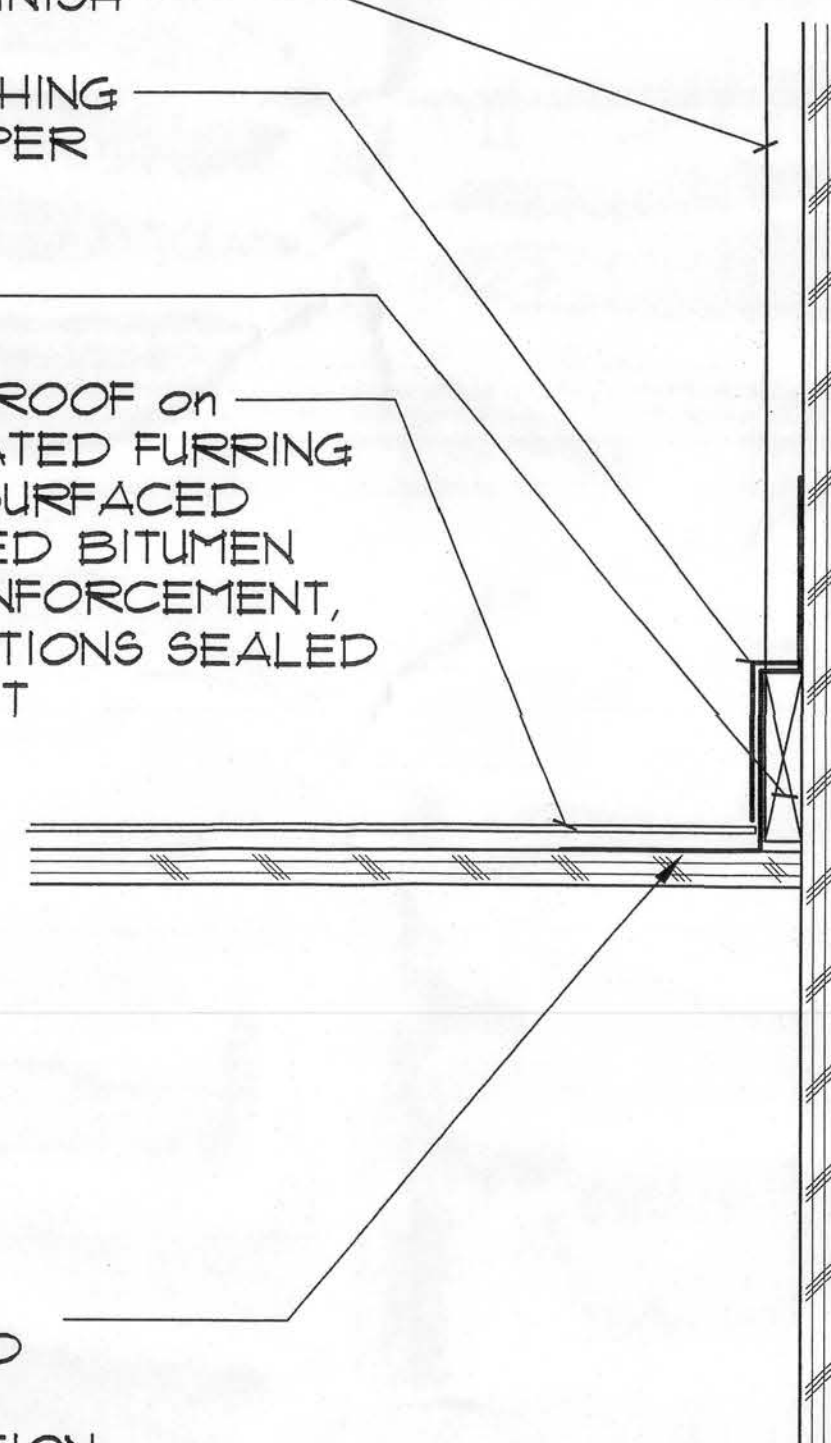

8" WIDE CONT. ROLL
FLASHING NAILED
TO SIDE OF 1x4 &
FACE OF ROOF
SHEATHING INSTALLED
PRIOR TO FELT
AND ROOF INSTALLATION

(ROOF SLOPE PARALLEL TO WALL)
SCALE: 3" = 1'-0"


CONC. BARREL TILE ROOF on _____
1 x 2 PRESSURE-TREATED FURRING
STRIPS on MINERAL SURFACED
120 ML THICK MODIFIED BITUMEN
with FIBERGLASS REINFORCEMENT,
EDGES and PENETRATIONS SEALED
on 30lb ROOFING FELT

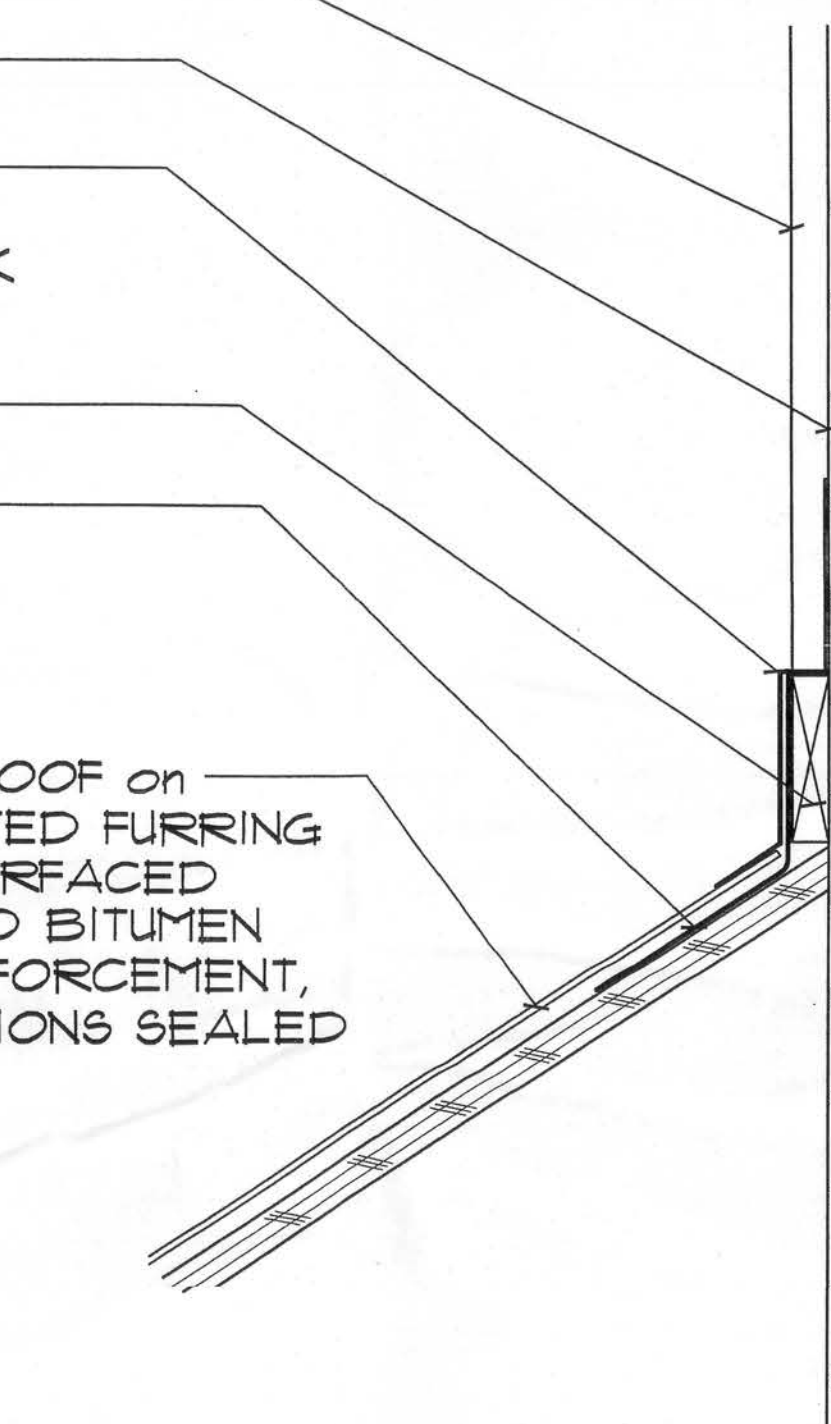

(ROOF SLOPE MEETS WALL)

SCALE: 3" = 1'-0"


DECK FINISH

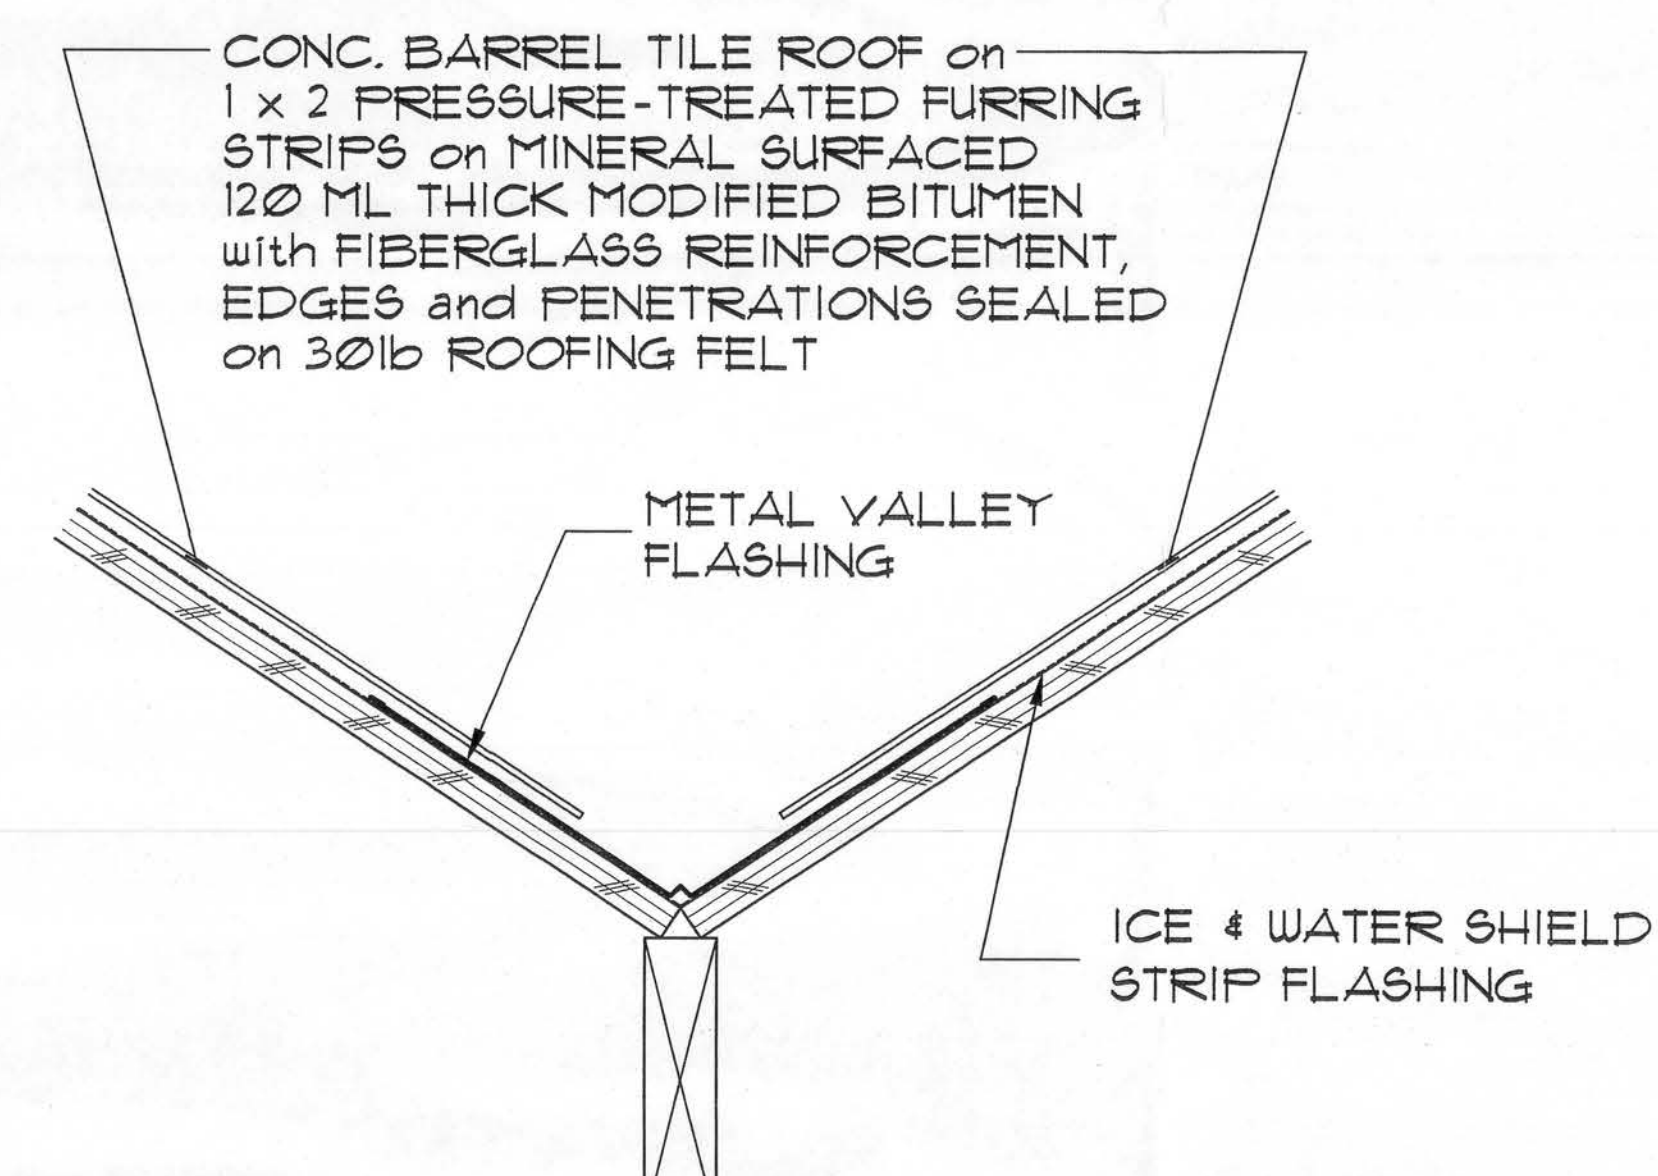

SCALE: 3" = 1'-0"

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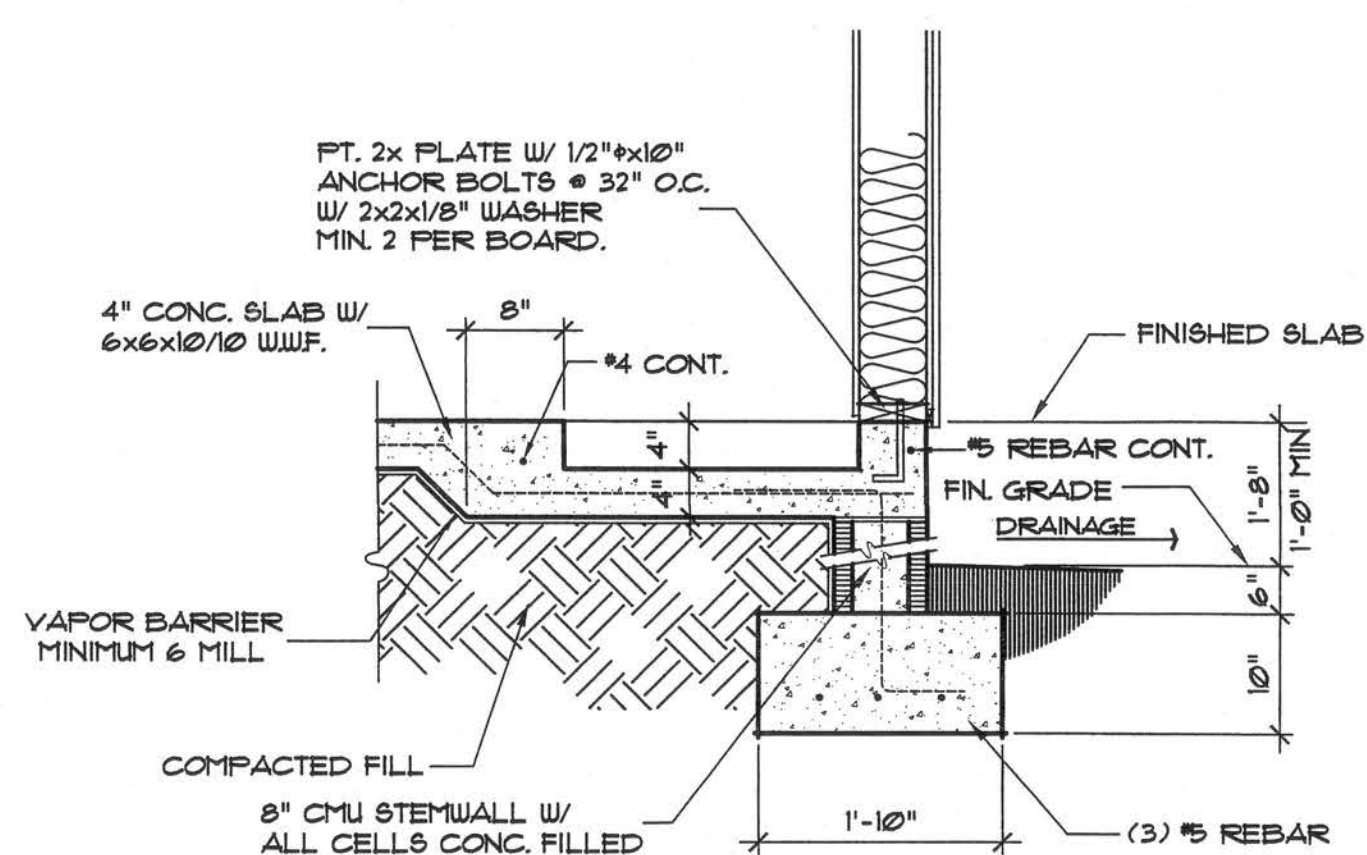
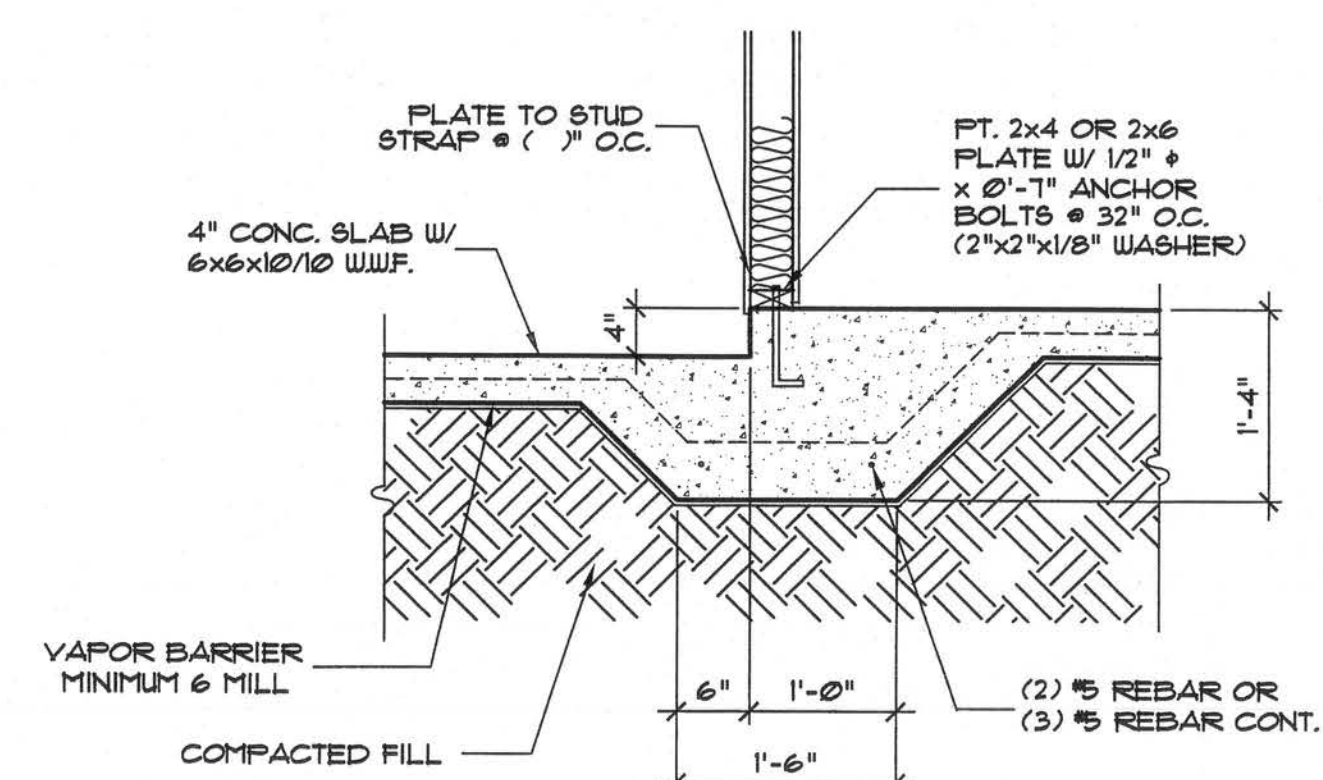
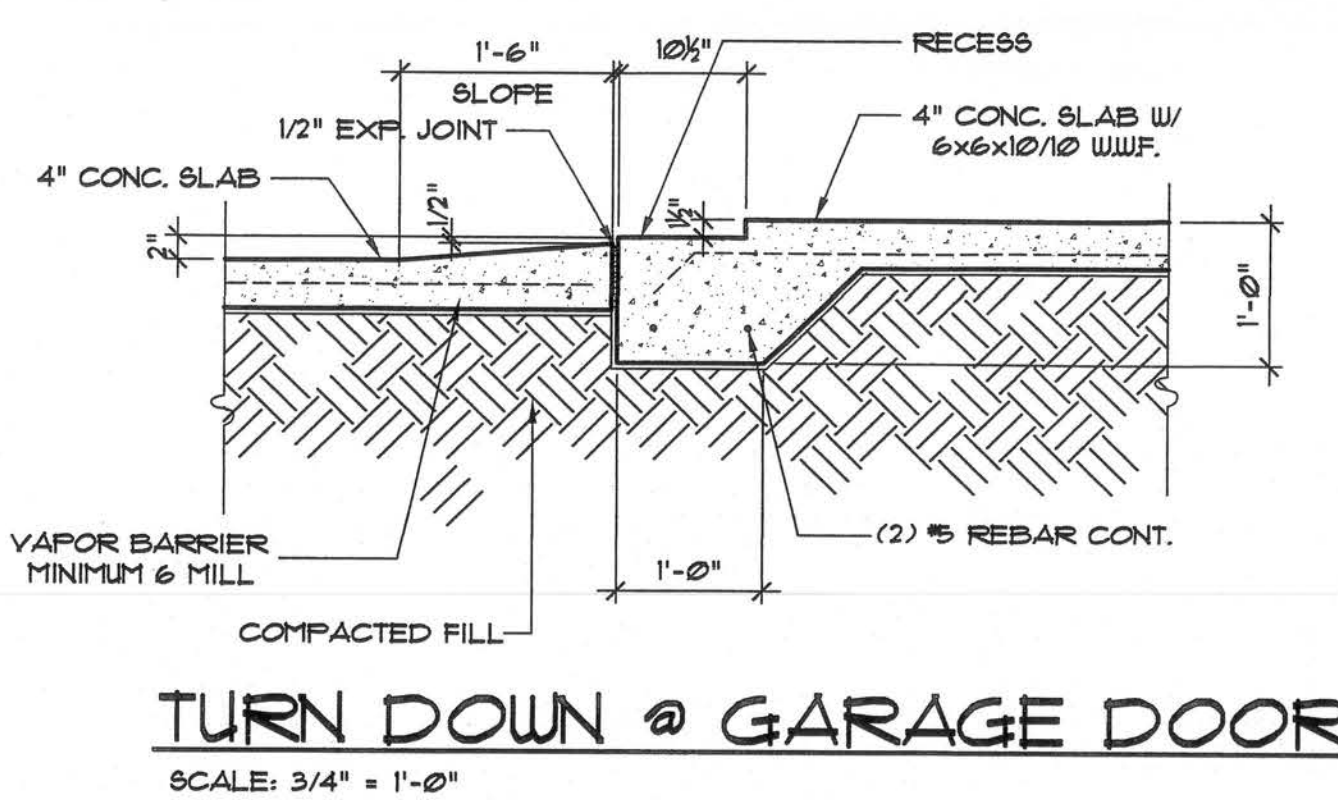
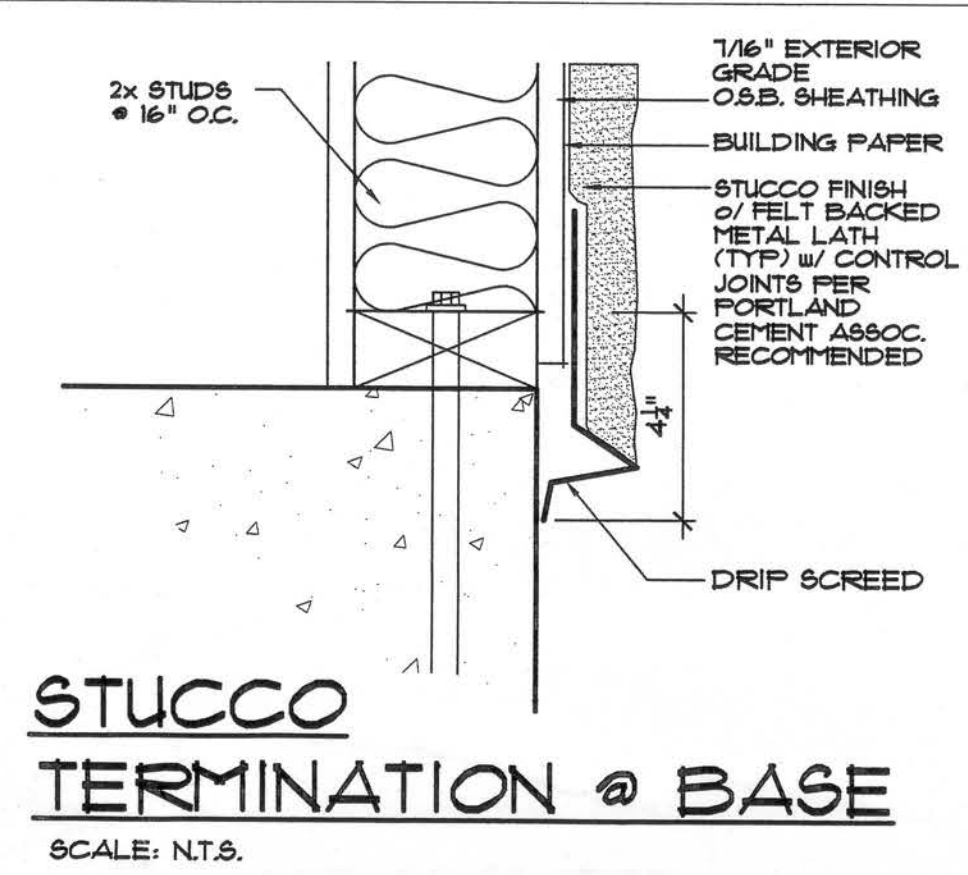
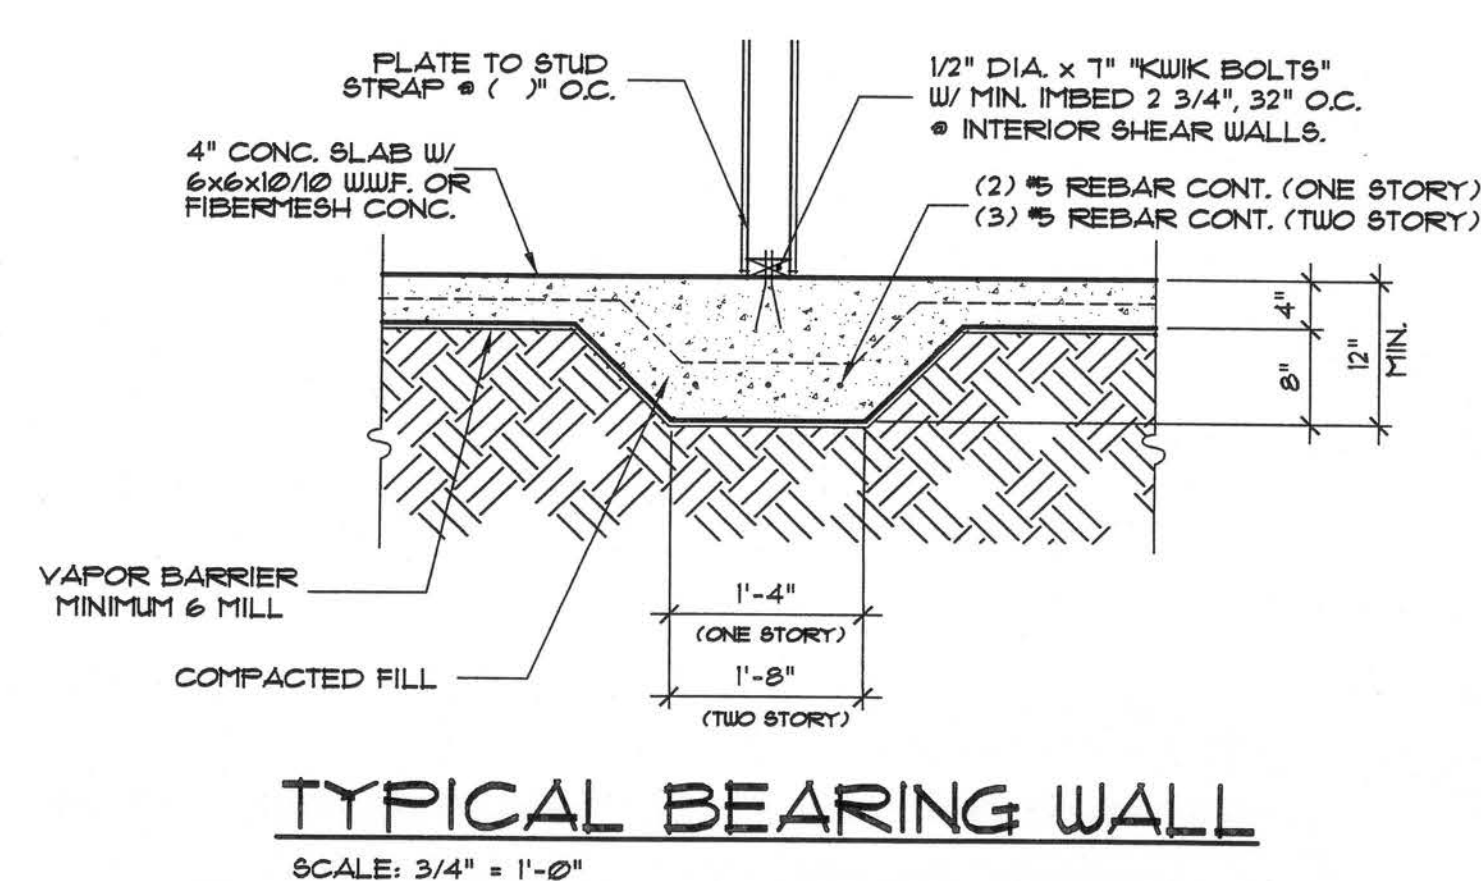
10751 Deerwood Park Blvd.
Suite #120

RESIDENTIAL DESIGNS BY KEVIN GRAY, INC.

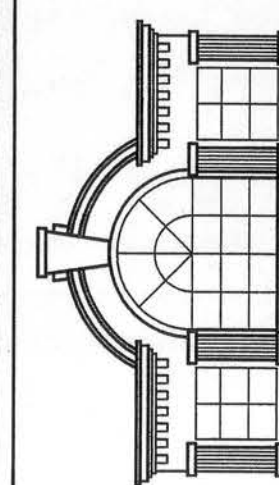ADDITIONS AND RENOVATIONS TO THE:
MIKE & LINDA CADY RESIDENCE
161 NW LAKE JEFFREY ROAD
LAKE CITY, FLORIDA


DRAIN BY:	AA RFF
CHECKED BY:	
DATE:	02/17/00
SCALE:	AS NOTE
JOB NUMBER:	****
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DRAWN BY:	

10 17




RECESSED SHOWER DETAIL

SCALE: 3/4" = 1'-0"

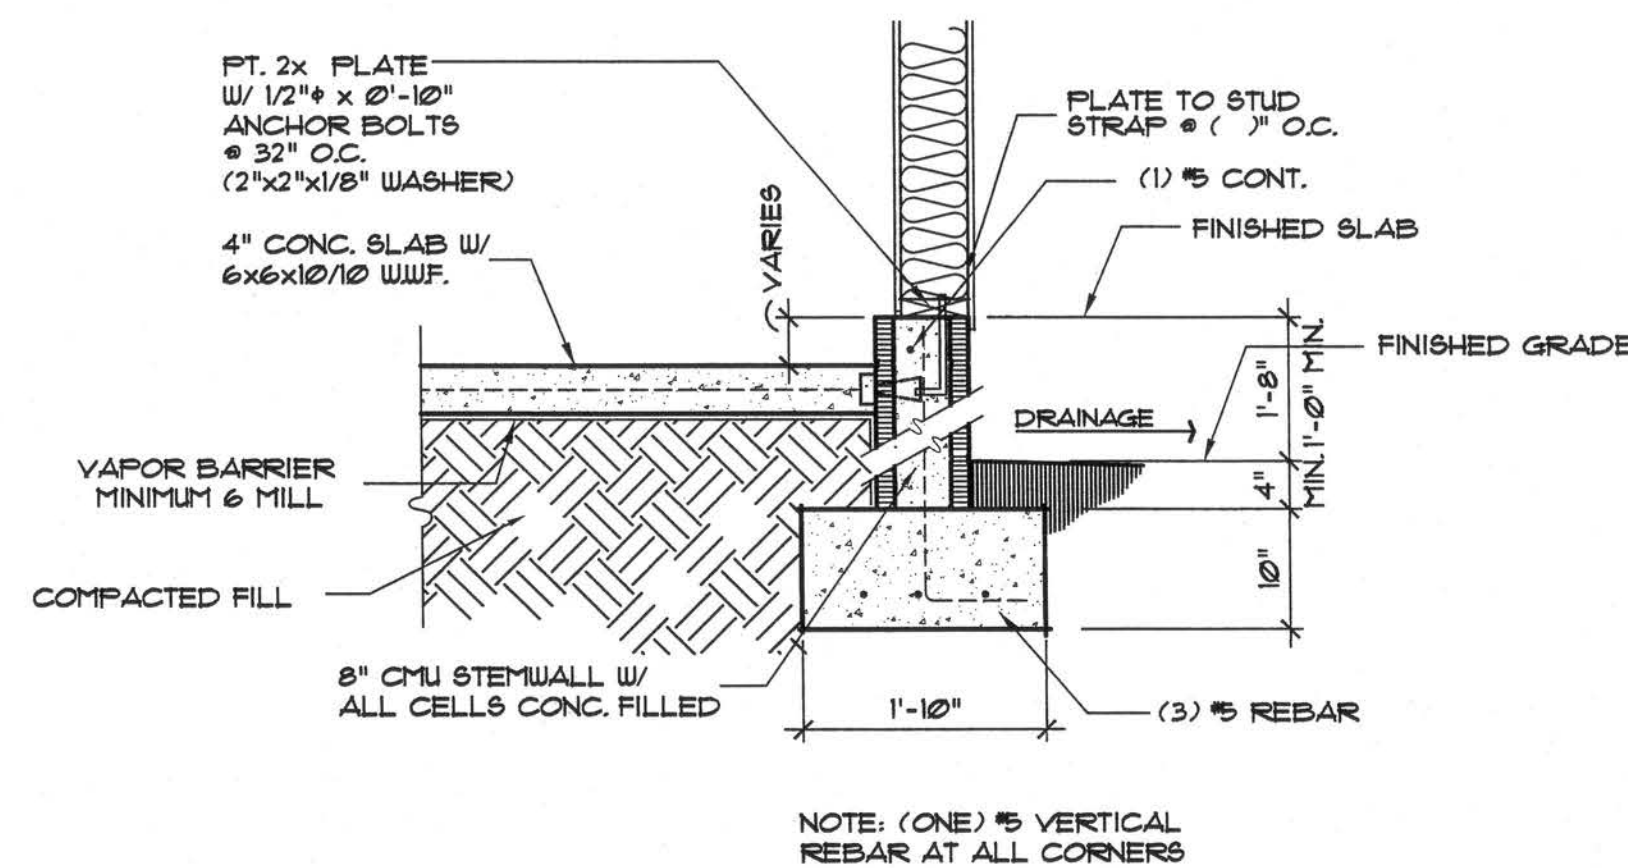


EXTERIOR WALL @ GARAGE

SCALE: 3/4" = 1'-0"

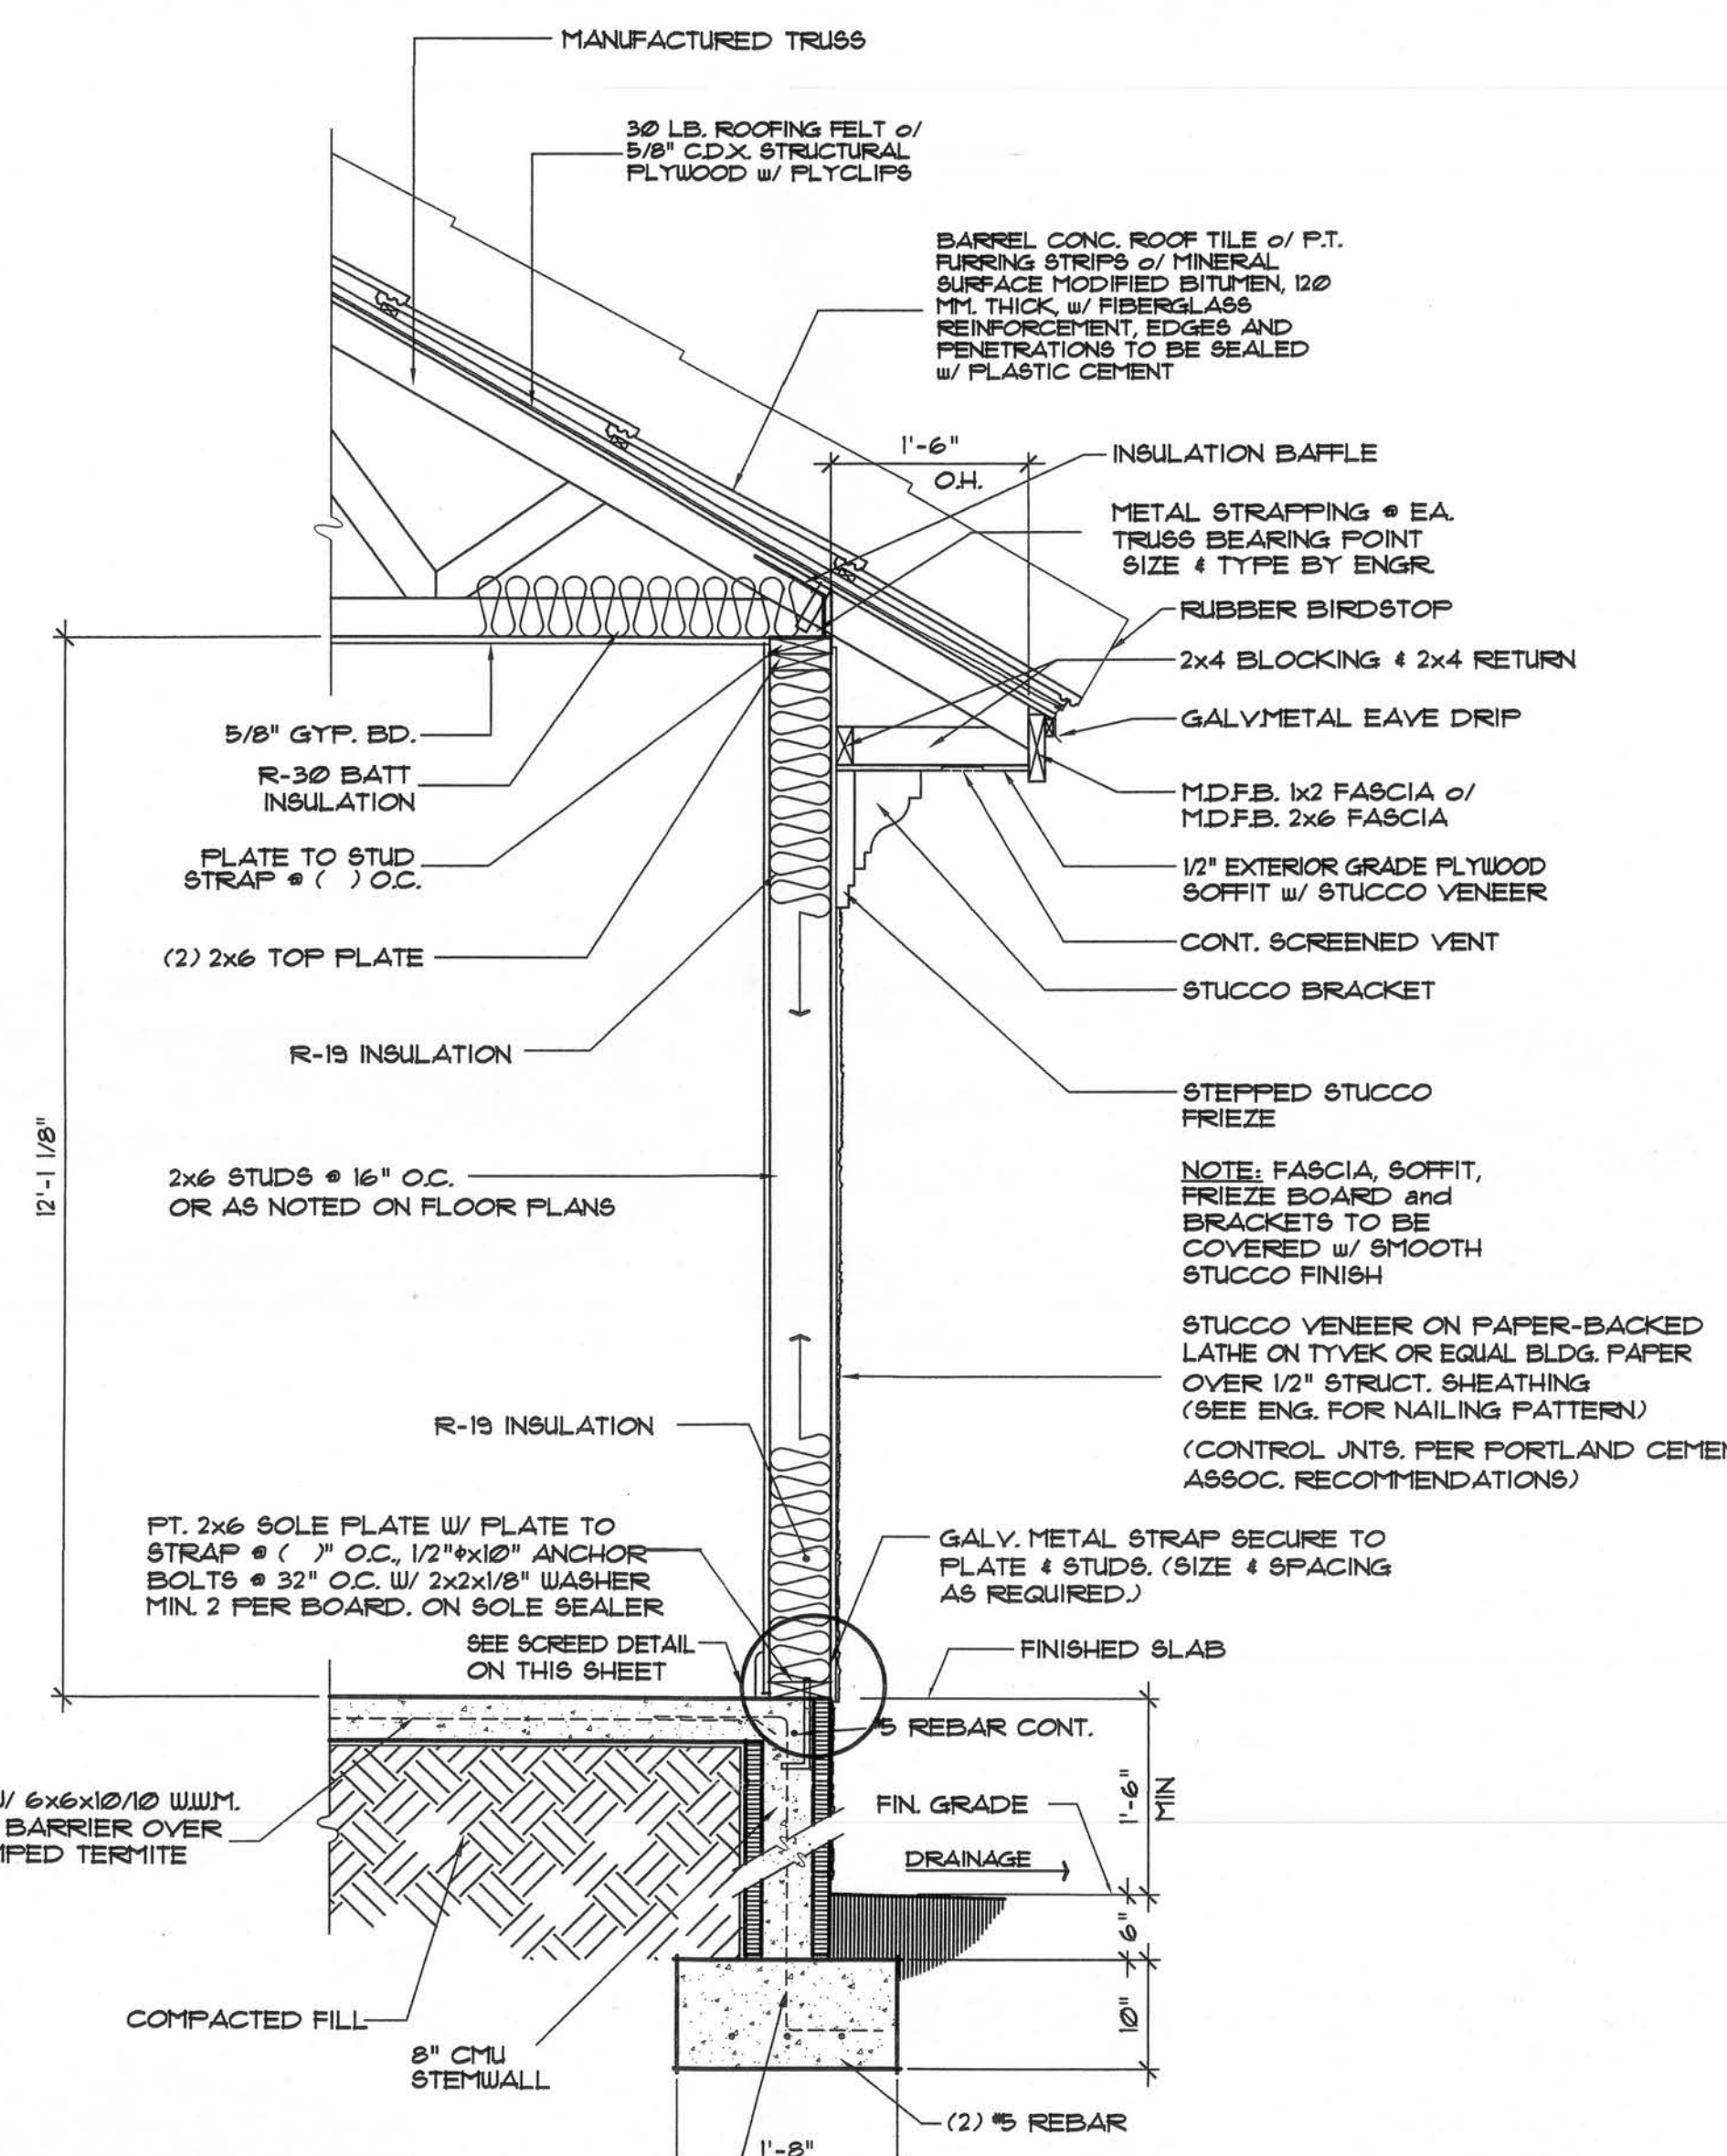


TYPICAL ONE STORY EXTERIOR WALL

SCALE: 3/4" = 1'-0"

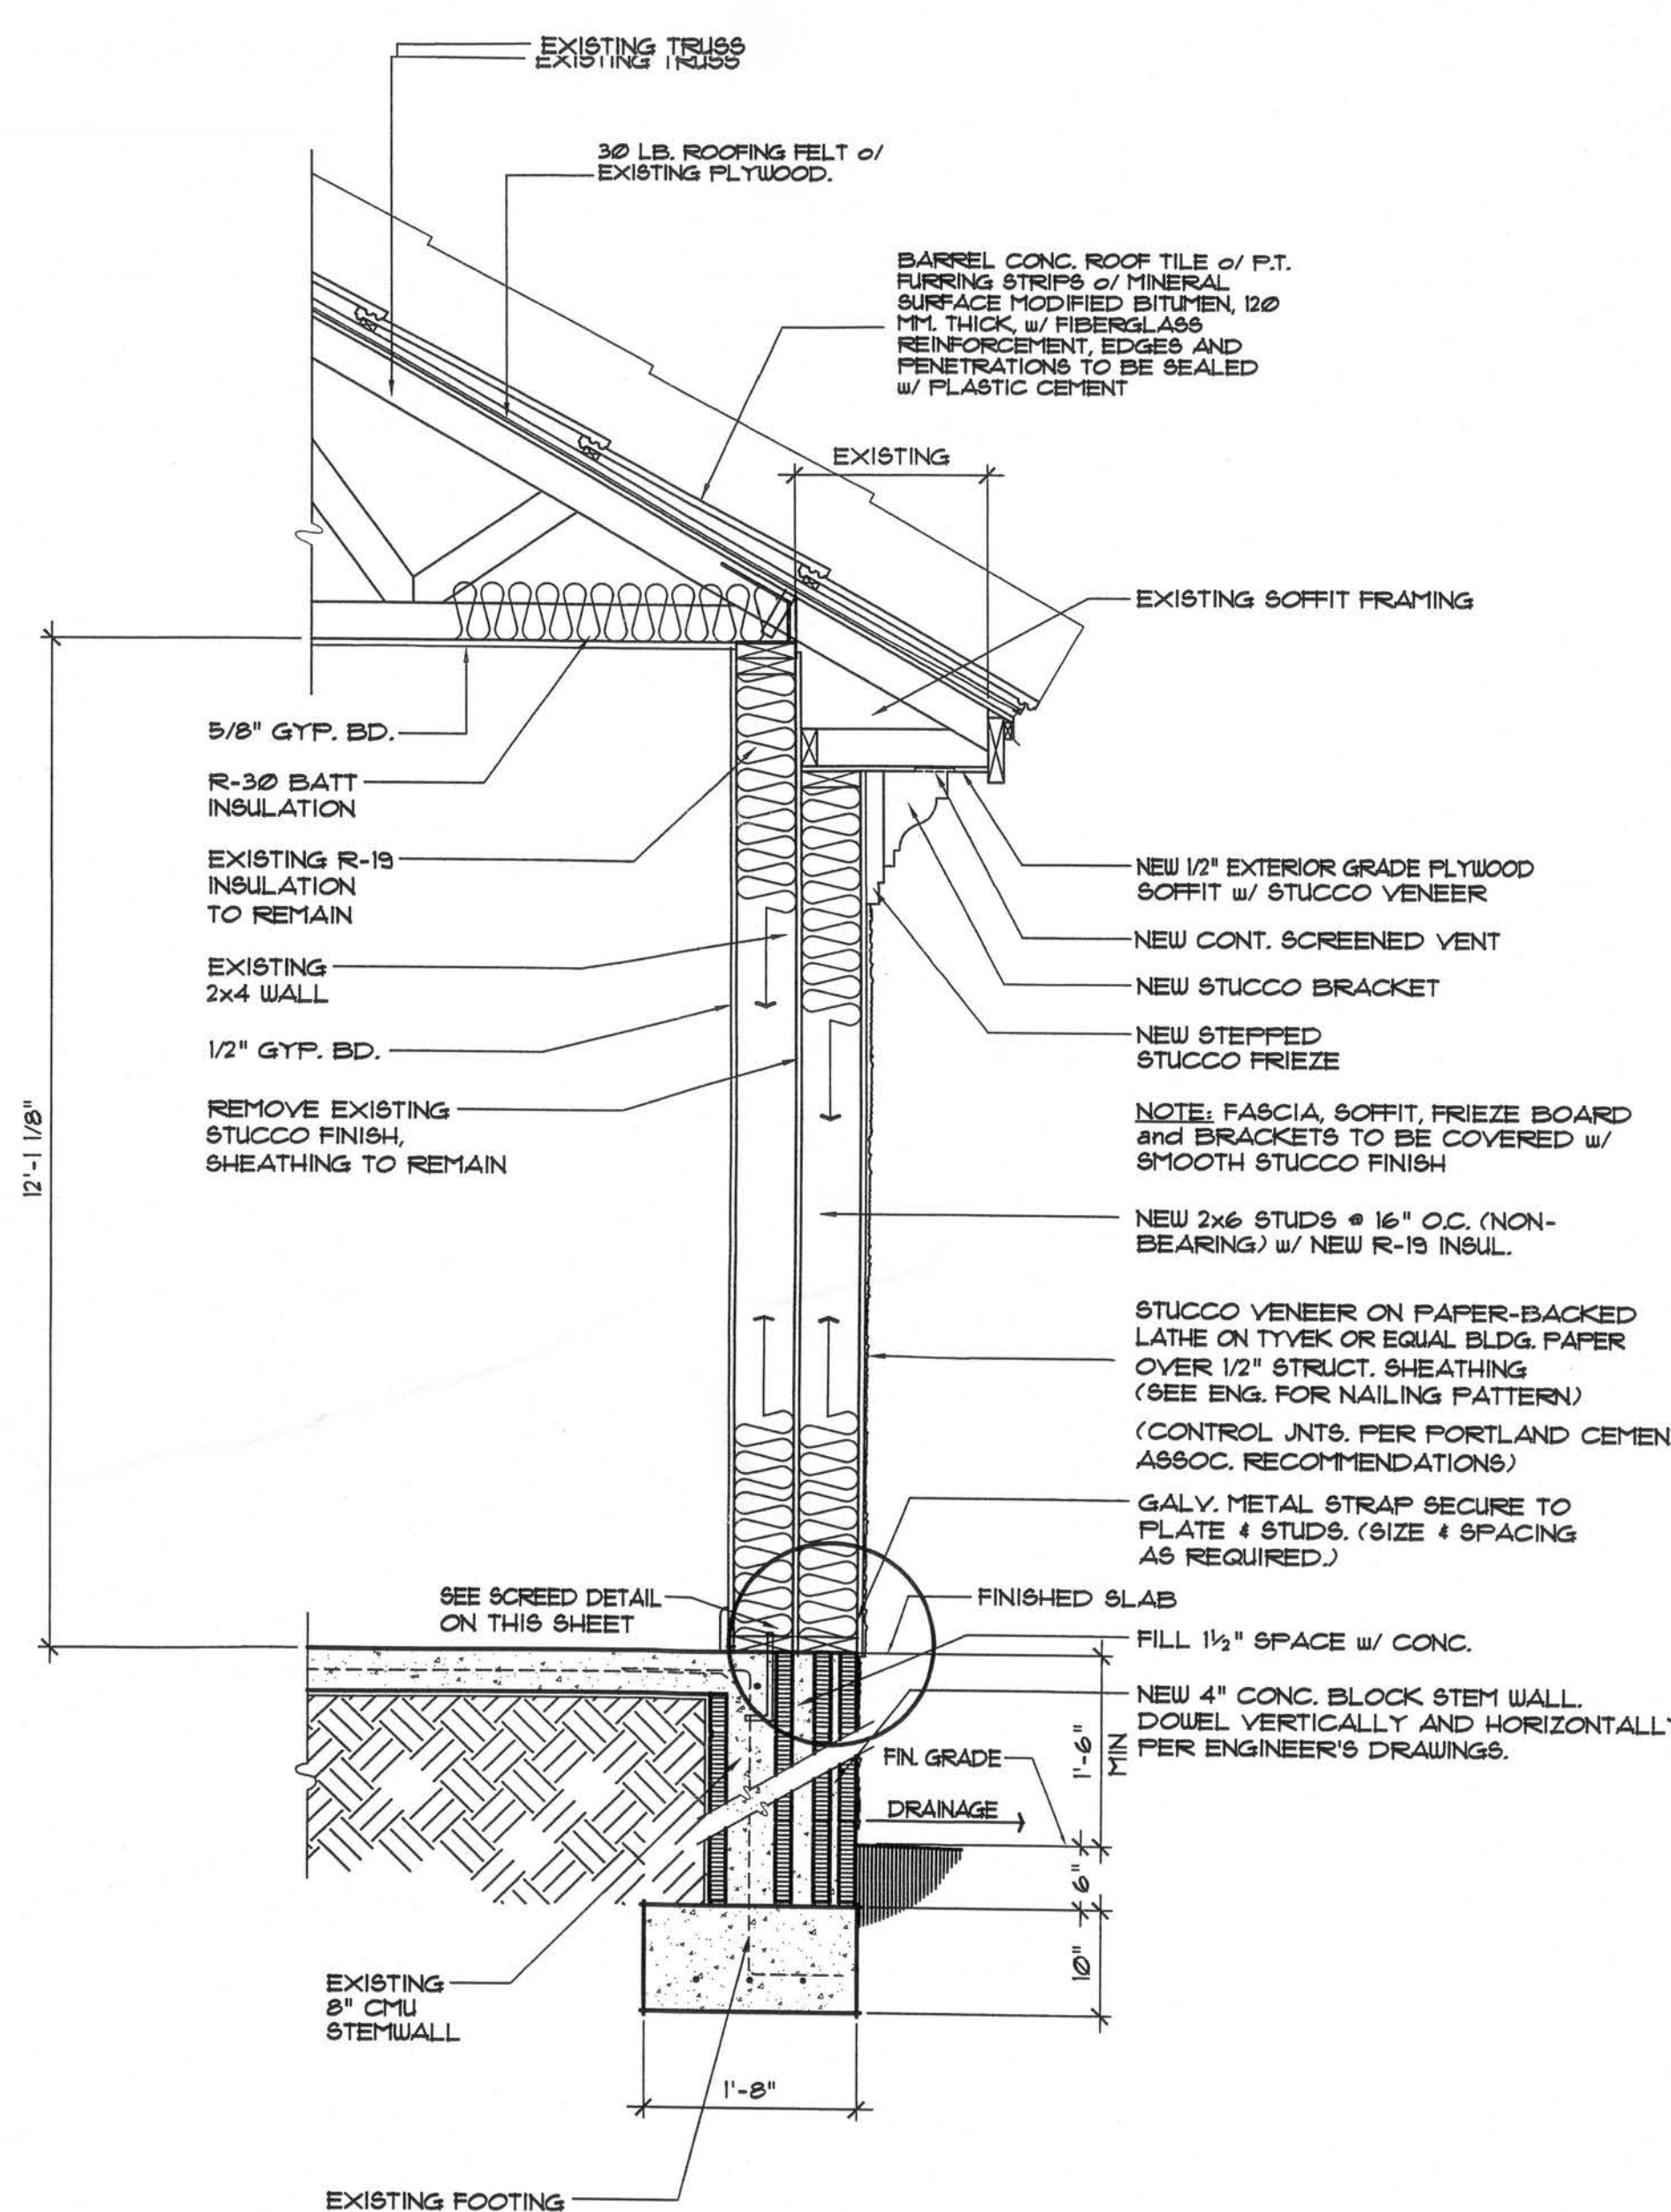


FURRED OUT EXTERIOR WALL

SCALE: 3/4" = 1'-0"

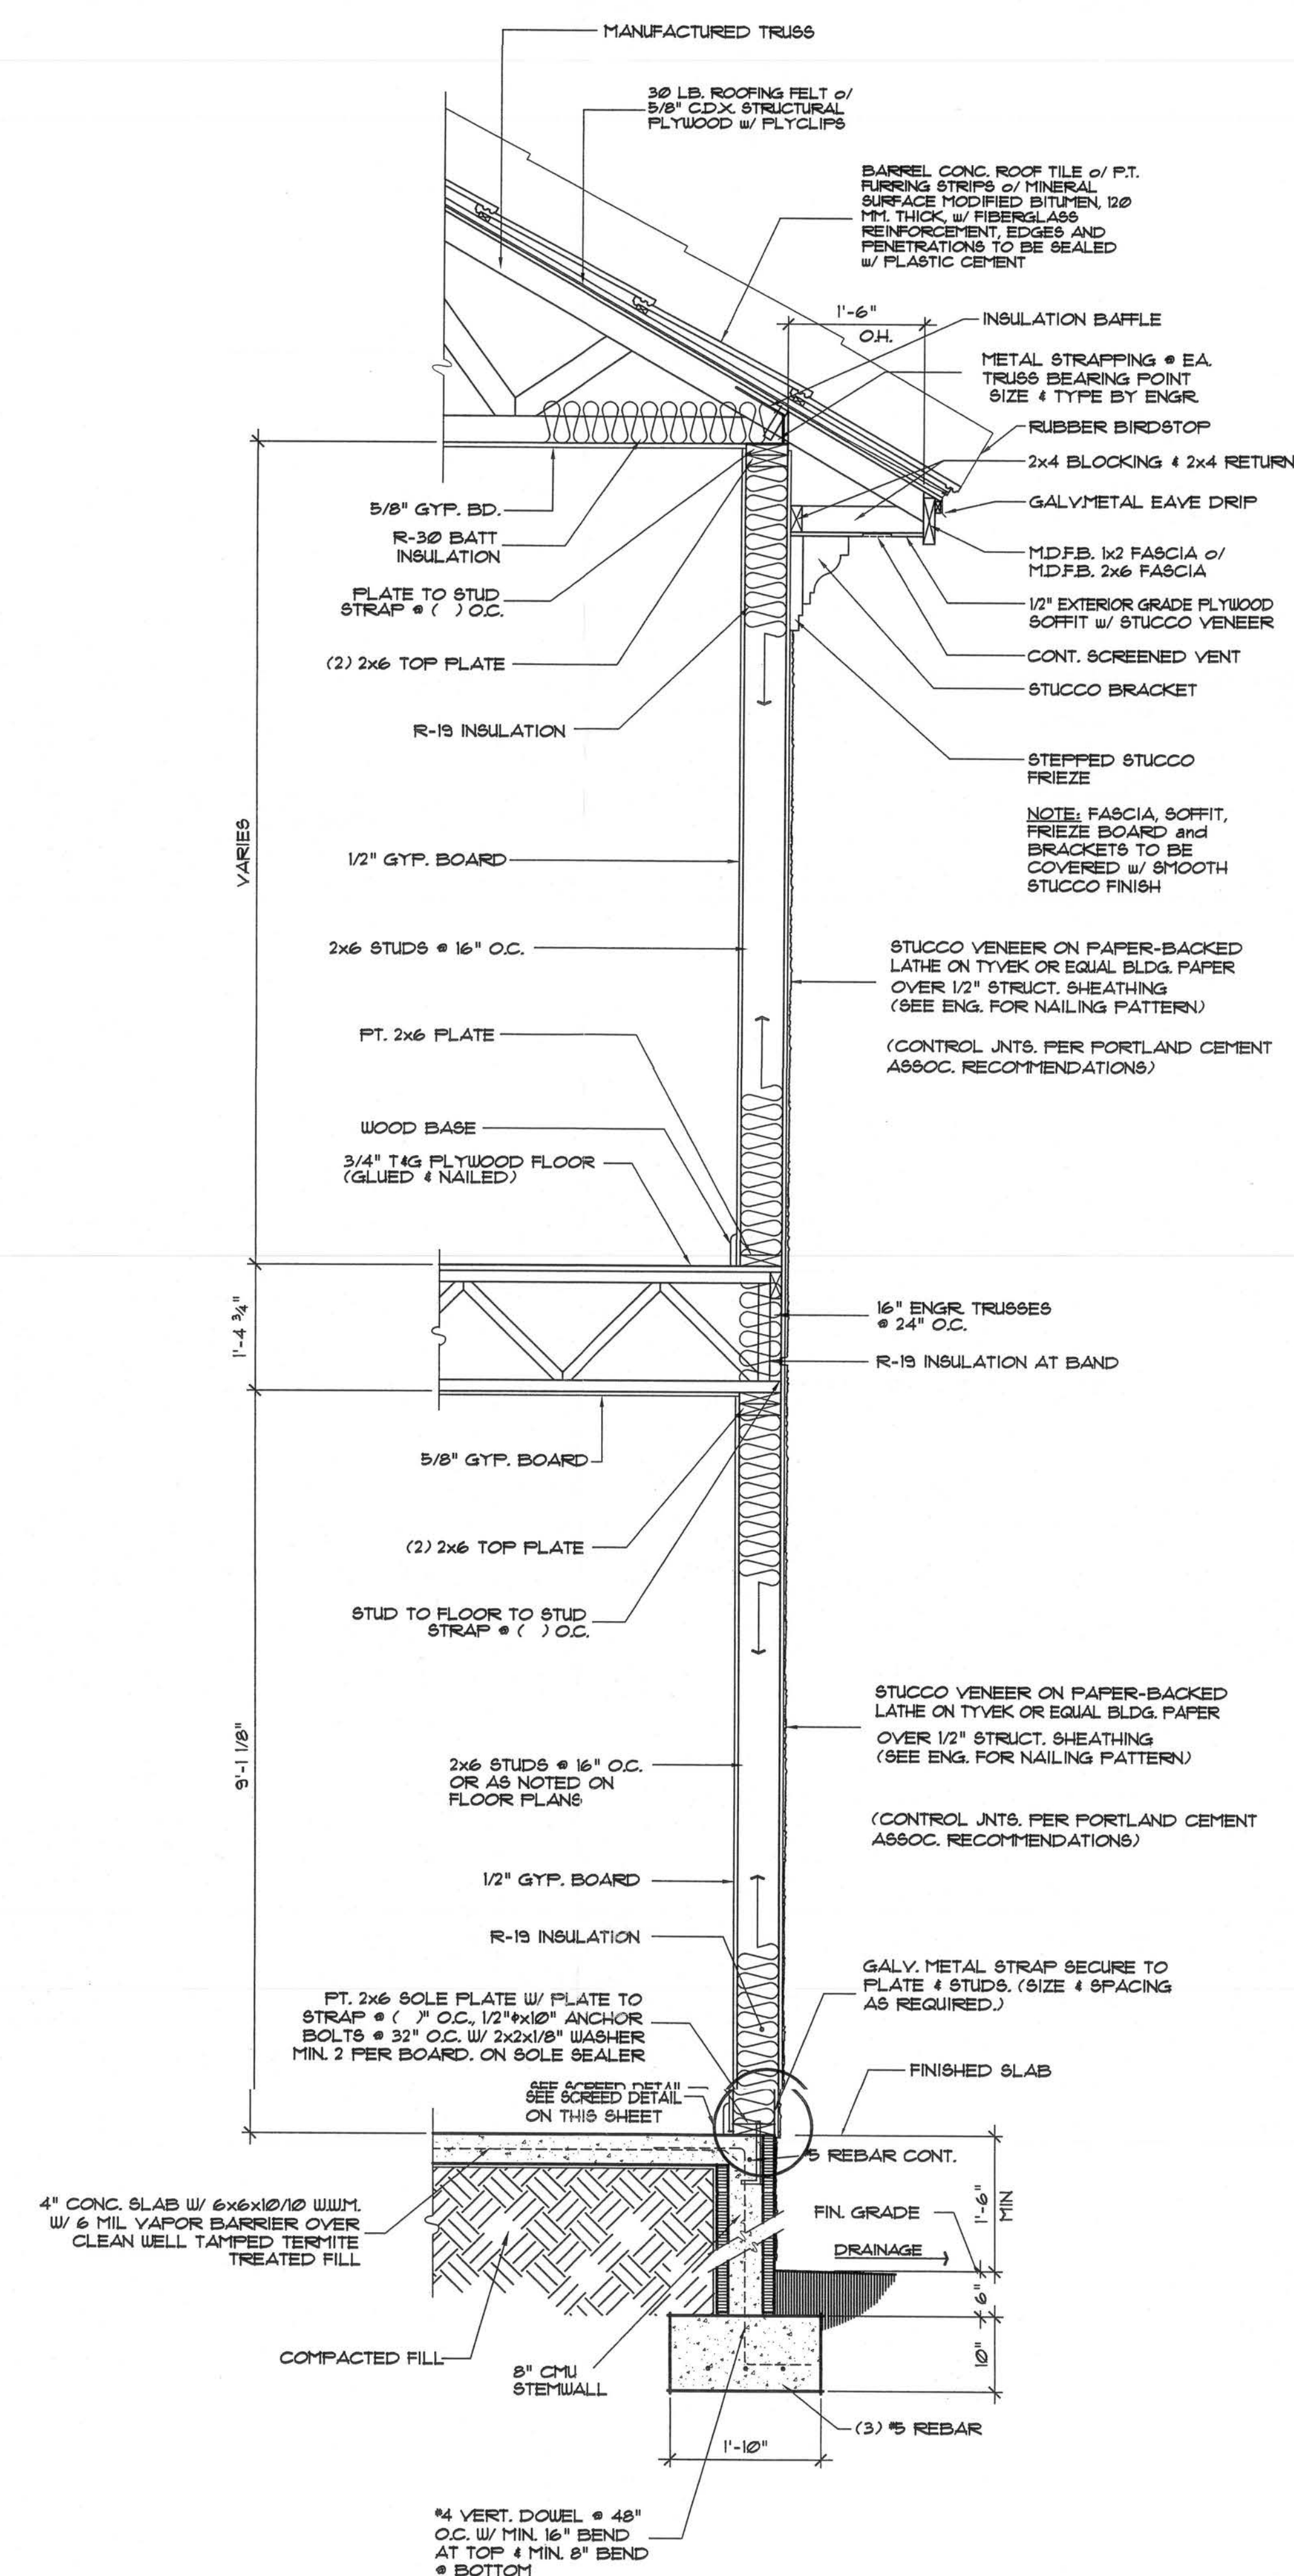

TYPICAL TWO STORY EXTERIOR WALL

SCALE: 3/4" = 1'-0"

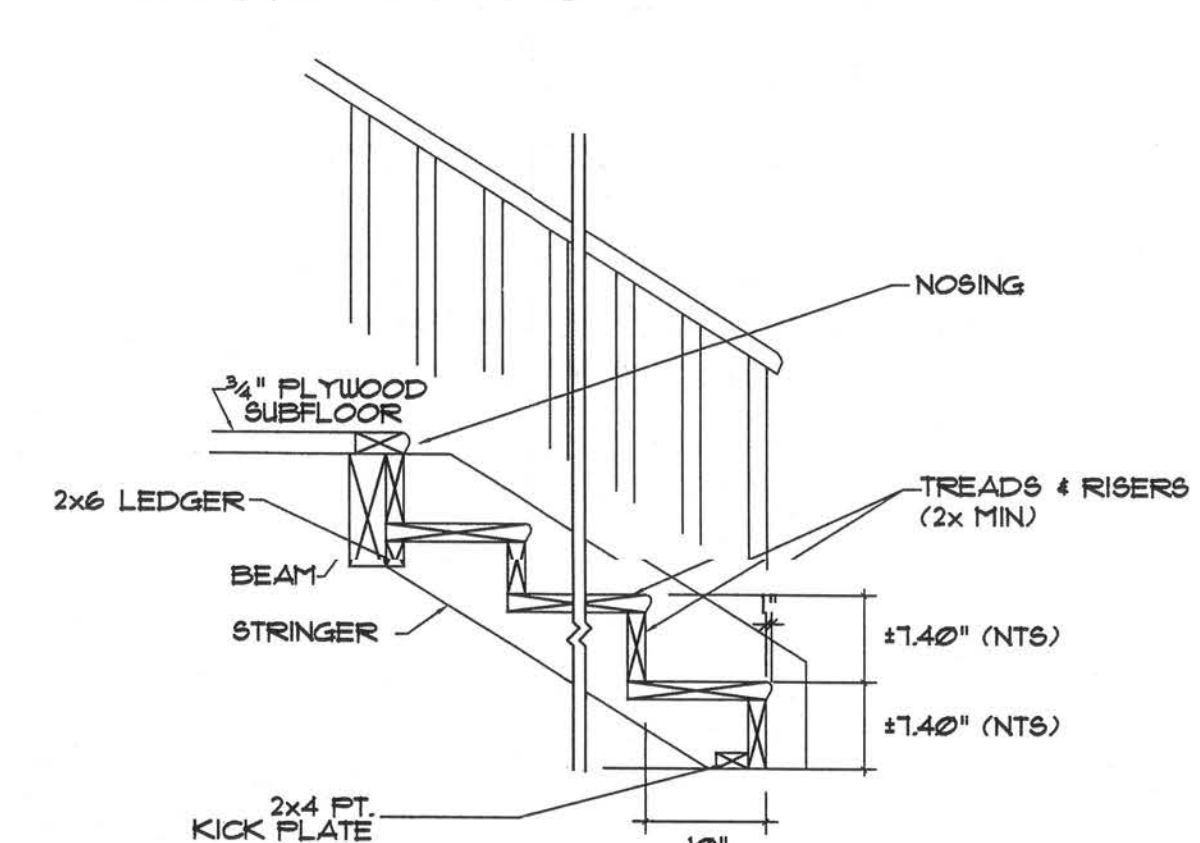

STAIR DETAIL TO 2ND FLOOR


SCALE: 3/4" = 1'-0"

DETAILS PAGE

NOTE:
ENGINEERS STRUCTURAL CRITERIA MAY OVERRIDE SHOWN DETAILS. FOR STRUCTURAL AND STRAPPING INFORMATION, REFER TO ENGINEERING SHEETS.

ADDITIONS AND RENOVATIONS TO THE:
MIKE & LINDA CADDY RESIDENCE
161 NW LAKE JEFFREY ROAD
LAKE CITY, FLORIDA

DRAWN BY:	AA RFF
CHECKED BY:	
DATE:	02/11/06
SCALE:	AS NOTED
JOB NUMBER:	***
REVISION:	
DWG NO:	

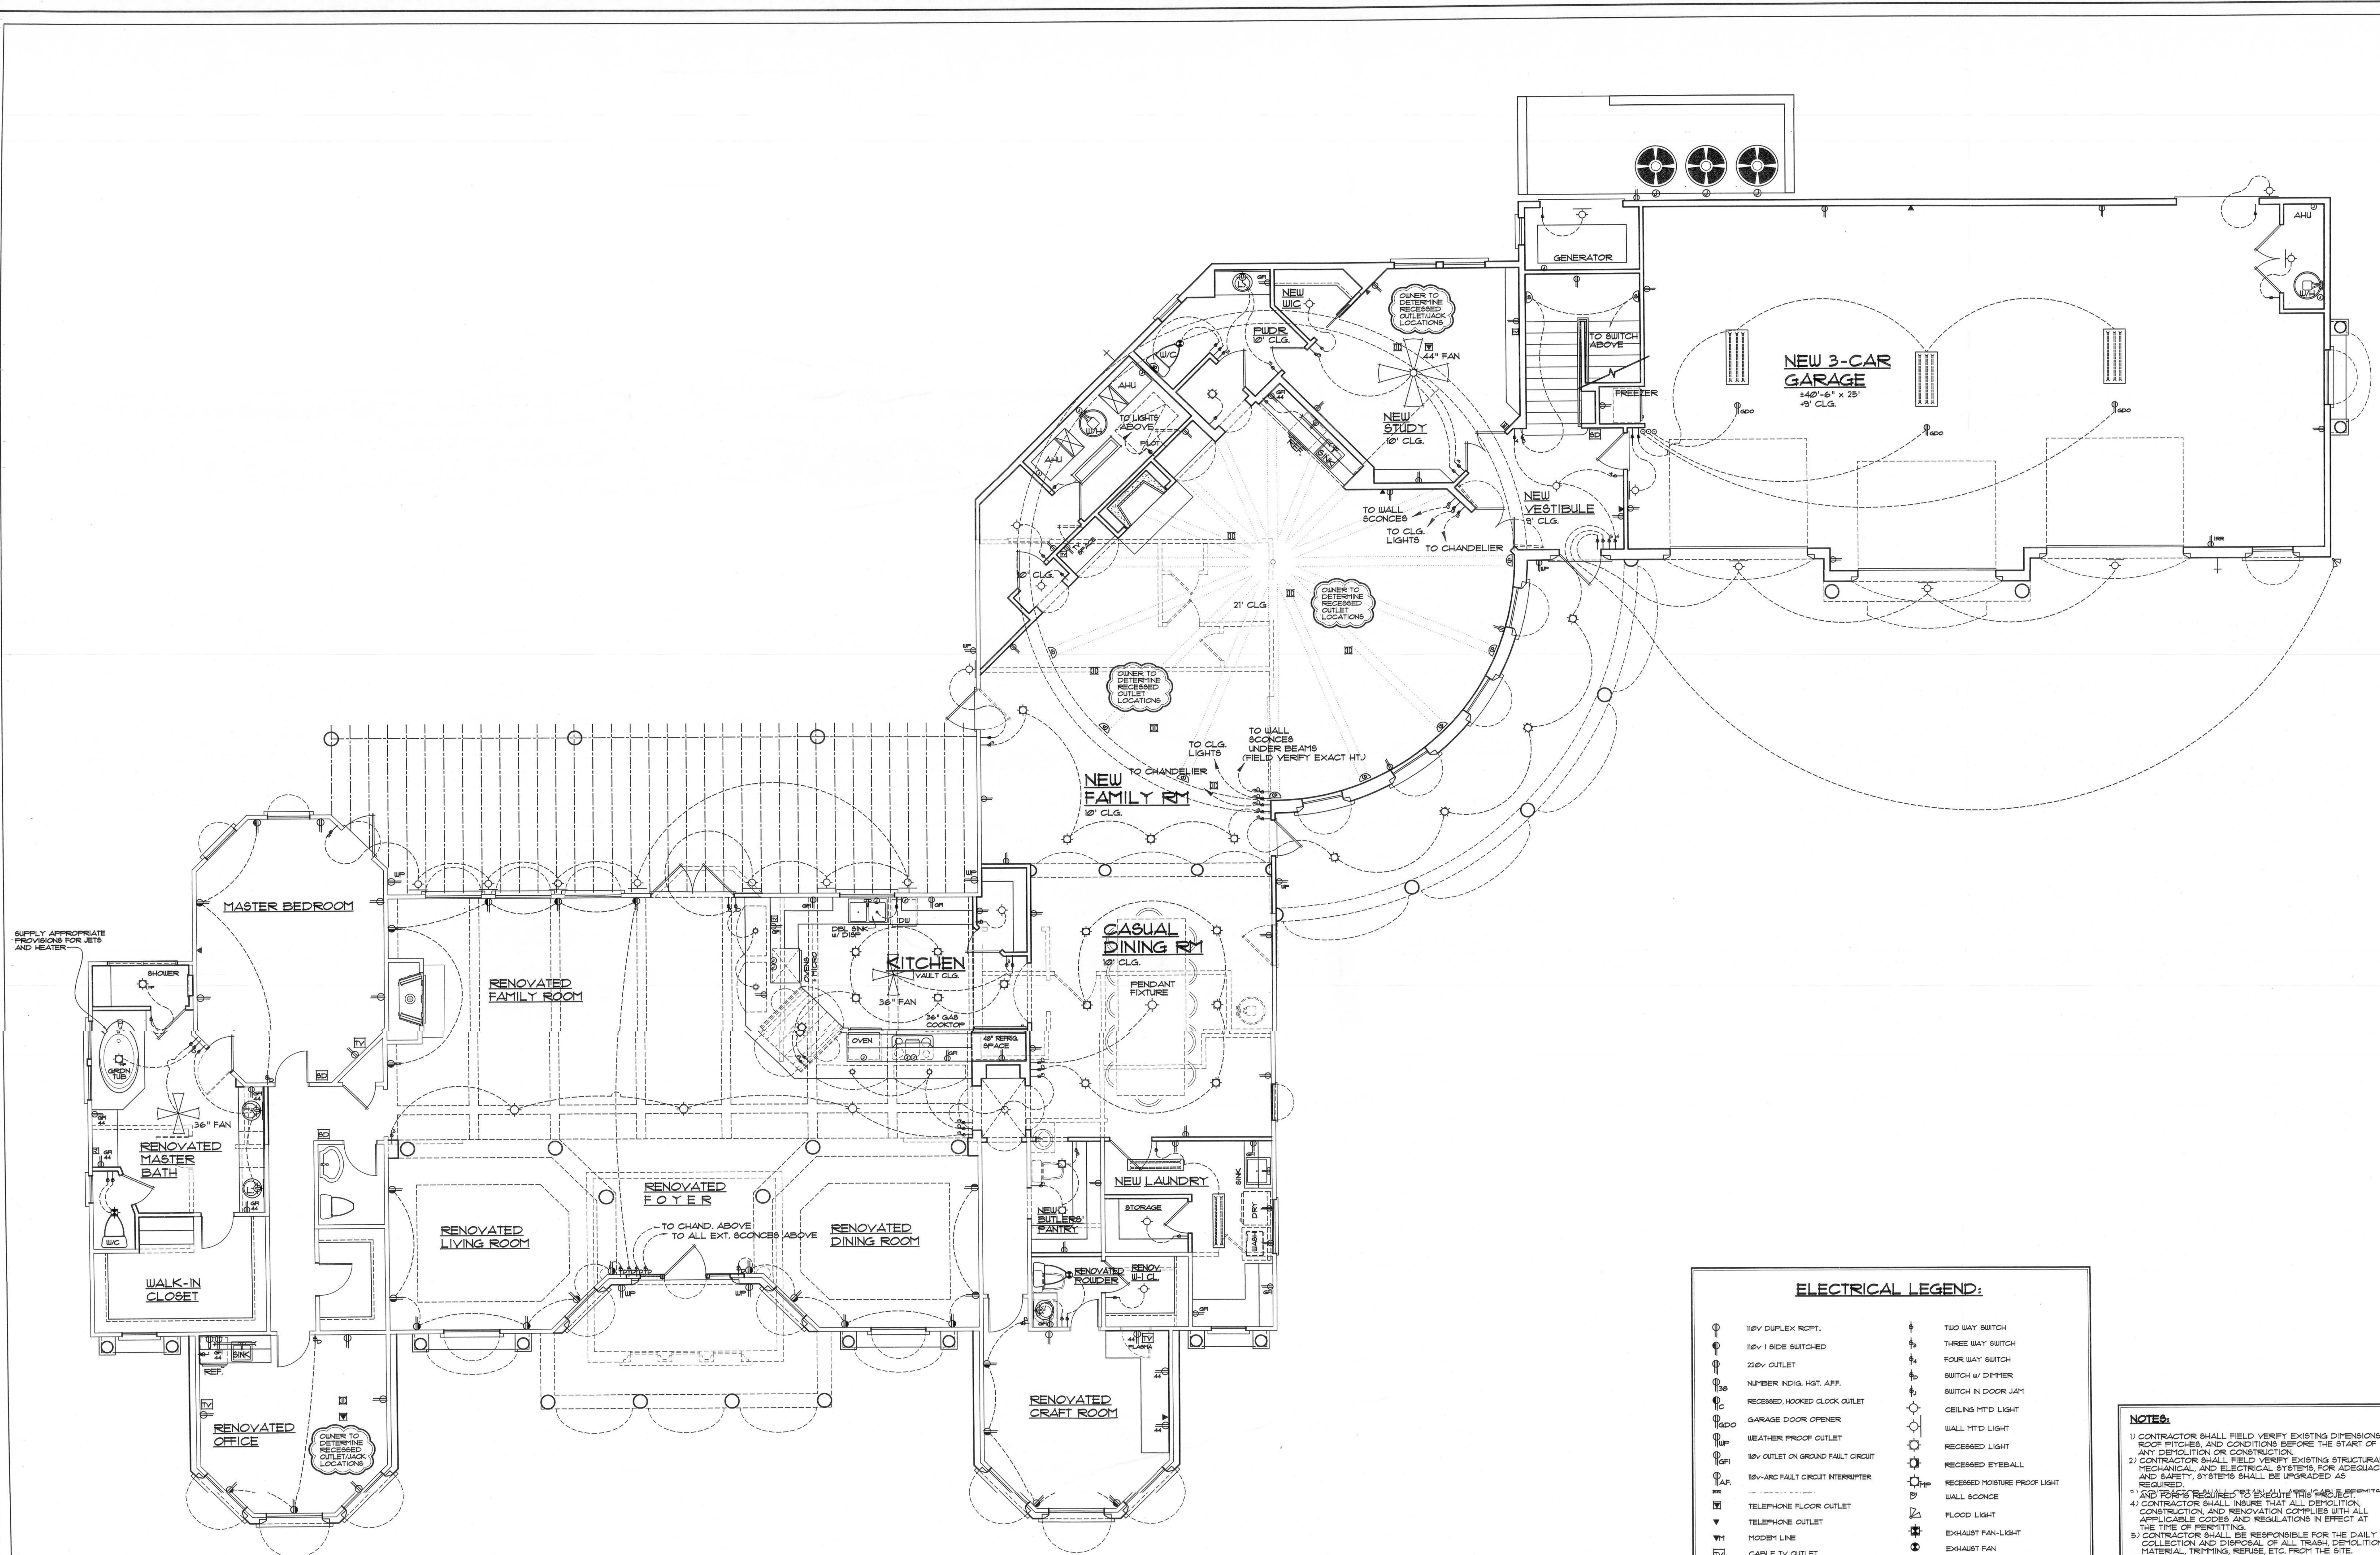

FIRST FLOOR ELECTRIC PLAN

ELECTRICAL LEGEND:			
120V DUPLEX RCPT.	120V 1 SIDE SWITCHED	220V OUTLET	NUMBER INDIC. HST. AFF.
RECESSED WOODS GLOCK OUTLET	GARAGE DOOR OPENER	WEATHER PROOF OUTLET	120V OUTLET ON GROUND FAULT CIRCUIT
120V-ARC FAULT CIRCUIT INTERRUPTER	TELEPHONE FLOOR OUTLET	TELEPHONE OUTLET	MODERN LINE
CABLE TV OUTLET	SMOKE DETECTOR	INTERCOM STATION	INTERCOM PANEL
SPEAKER	VOLUME LEVEL CONTROL	JUNCTION BOX	PUSH BUTTON
THERMOSTAT	ALARM KEYPAD	SECURITY CAMERA	CHIMES
TWO WAY SWITCH	THREE WAY SWITCH	FOUR WAY SWITCH	SWITCH W/ DIMMER
SWITCH IN DOOR JAMB	CEILING MTD LIGHT	WALL MTD LIGHT	RECESSED LIGHT
RECESSED EYE BALL	RECESSED MOISTURE PROOF LIGHT	WALL SCONCE	FLOOD LIGHT
EXHAUST FAN-LIGHT	CEILING FAN PRESURE	PANEL	TRACK LIGHTING
CEILING FAN	CEILING FAN-LIGHT	TUBE LIGHT	24 x 48 FLUORESCENT BOX FIXTURE

NOTE: 1) ALL OUTLETS IN BEDROOM TO BE "A.F.I."
 2) ALL EXTERIOR OUTLETS TO BE "G.F.I."
 3) ALL ELECTRICAL WIRING TO BE IN ACCORDANCE WITH ARTICLE 80 OF NFPA 70A

NOTES:

- 1) CONTRACTOR SHALL FIELD VERIFY EXISTING DIMENSIONS, ROOM FINISHES, AND CONDITIONS BEFORE THE START OF ANY DEMOLITION OR CONSTRUCTION.
- 2) CONTRACTOR SHALL FIELD VERIFY EXISTING STRUCTURAL, MECHANICAL, AND ELECTRICAL SYSTEMS FOR ADEQUACY AND SAFETY. SYSTEMS SHALL BE UPGRADED AS REQUIRED.
- 3) CONTRACTOR SHALL INQUIRE THAT ALL DEMOLITION, CONSTRUCTION AND RENOVATION COMPLIES WITH ALL APPLICABLE CODES AND REGULATIONS IN EFFECT AT THE TIME OF PERMITTING.
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- 8) ANY ELECTRICAL PLUMBING, OR HVAC LINES TO BE ABANDONED SHALL BE TRIMMED AND CAPPED.
- 9) ANY AREAS WHERE NEW ROOF MEETS EXISTING ROOF AND/OR STRUCTURE SHALL BE ADEQUATELY FLASHED AND SEALED.
- 10) STUCCO CONTROL JOINTS TO BE PROVIDED PER PORTLAND CEMENT ASSOCIATION RECOMMENDATIONS.
- 11) CONTRACTOR TO VERIFY SETBACKS AND LOCATION OF STRUCTURE PRIOR TO CONSTRUCTION.
- 12) ALL WOOD IN CONTACT WITH MASONRY, CONCRETE, OR EARTH SHALL BE PRESURE TREATED APPROPRIATELY FOR THE CONDITION.
- 13) ALL INTERIOR AND EXTERIOR FLOOR TILE SHALL HAVE A NON-SLIP FINISH. FLOORING TO MEET ASTM C628.
- 14) CONTRACTOR TO VERIFY SETBACKS AND LOCATION OF STRUCTURE PRIOR TO CONSTRUCTION.
- 15) CONTRACTOR TO ENSURE THAT ALL CONSTRUCTION COMPLIES WITH NFPA 70A CODES AND 2004 FLORIDA BUILDING CODE REQUIREMENTS.

NOTE:
 DIMENSIONS, HEIGHTS AND SITE ELEVATIONS ARE APPROXIMATE AND SUBJECT TO FIELD CONDITIONS. CONTRACTOR TO VERIFY BEFORE COMMENCEMENT.

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 10701 DUNSTON PARK BLVD.
 SUITE #200
 JACKSONVILLE, FLORIDA 32256
 PHONE: (904) 384-2845
 FAX: (904) 384-1280
 WWW.KGRAY.COM
 RESIDENTIAL DESIGNS BY KEVIN GRAY, INC.

ADDITIONS AND RENOVATIONS TO THE:
MIKE & LINDA CADY RESIDENCE
 161 NW LAKE JEFFREY ROAD
 LAKE CITY, FLORIDA

DRAWN BY: AA RFF
 CHECKED BY: _____
 DATE: 02/17/06
 SCALE: 1/4" = 1'-0"
 JOB NUMBER: 0000
 REVISIONS:
 Dwg No: 12 13

SECOND FLOOR ELECTRIC PLAN

ELECTRICAL LEGEND:	
110V DUPLEX RCPT.	TWO WAY SWITCH
110V 1 SIDE SWITCHED	THREE WAY SWITCH
220V OUTLET	FOUR WAY SWITCH
NUMBER INDIC. HGT. AFF.	SWITCH w/ DIMMER
RECESSED, HOOKED GLOB. OUTLET	SWITCH IN DOOR JAMB
GARAGE DOOR OPENER	CEILING MTD LIGHT
WEATHER PROOF OUTLET	RECESSED LIGHT
10V OUTLET ON GROUND FAULT CIRCUIT	RECESSED EYEBALL
10V-ARC FAULT CIRCUIT INTERRUPTER	RECESSED MOISTURE PROOF LIGHT
110V FLOOR OUTLET	WALL SCONCE
TELEPHONE FLOOR OUTLET	FLOOD LIGHT
TELEPHONE OUTLET	EXHAUST FAN-LIGHT
MODERN LINE	EXHAUST FAN
CABLE TV OUTLET	CEILING FAN PREWIRE
SMOKE DETECTOR	PANEL
INTERCOM STATION	TRACK LIGHTING
INTERCOM PANEL	CEILING FAN
SPEAKER	CEILING FAN-LIGHT
VOLUME LEVEL CONTROL	TUBE LIGHT
JUNCTION BOX	24 x 48 FLUORESCENT BOX FIXTURE
PUSH BUTTON	
THERMOSTAT	
ALARM KEYPAD	
SECURITY CAMERA	
CHIMES	

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2) ALL EXTERIOR OUTLETS TO BE "G.F.I.".
3) ALL ELECTRICAL WIRING TO BE IN ACCORDANCE WITH ARTICLE 80 OF NFPA 70A

NOTES:

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- 14) ALL INTERIOR AND EXTERIOR FLOOR TILE SHALL HAVE A NON-SLIP FINISH. FLOORING TO MEET ASTM C1028 STATIC COEFFICIENT OF FRICTION MIN OF 0.4.
- 15) CONTRACTOR TO ENSURE THAT ALL CONSTRUCTION COMPLIES WITH NFPA LIFE SAFETY CODES AND 2004 FLORIDA BUILDING CODE REQUIREMENTS.


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ADDITIONS AND RENOVATIONS TO THE:
MIKE & LINDA CADY RESIDENCE
161 NW LAKE JEFFERY ROAD
LAKE CITY, FLORIDA

DESIGN BY: AA RFF
CHECKED BY:
DATE: 02/17/06
SCALE: 1/4" = 1'-0"
JOB NUMBER: ***
REVISED:
JOB NO:
13 13

RESIDENTIAL DESIGNS BY KEVIN GRAY, INC.
10701 Highway 17, Suite 100
Jacksonville, Florida 32218
PHONE: (904) 384-3300
FAX: (904) 384-3305
www.kevingray.com

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
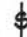




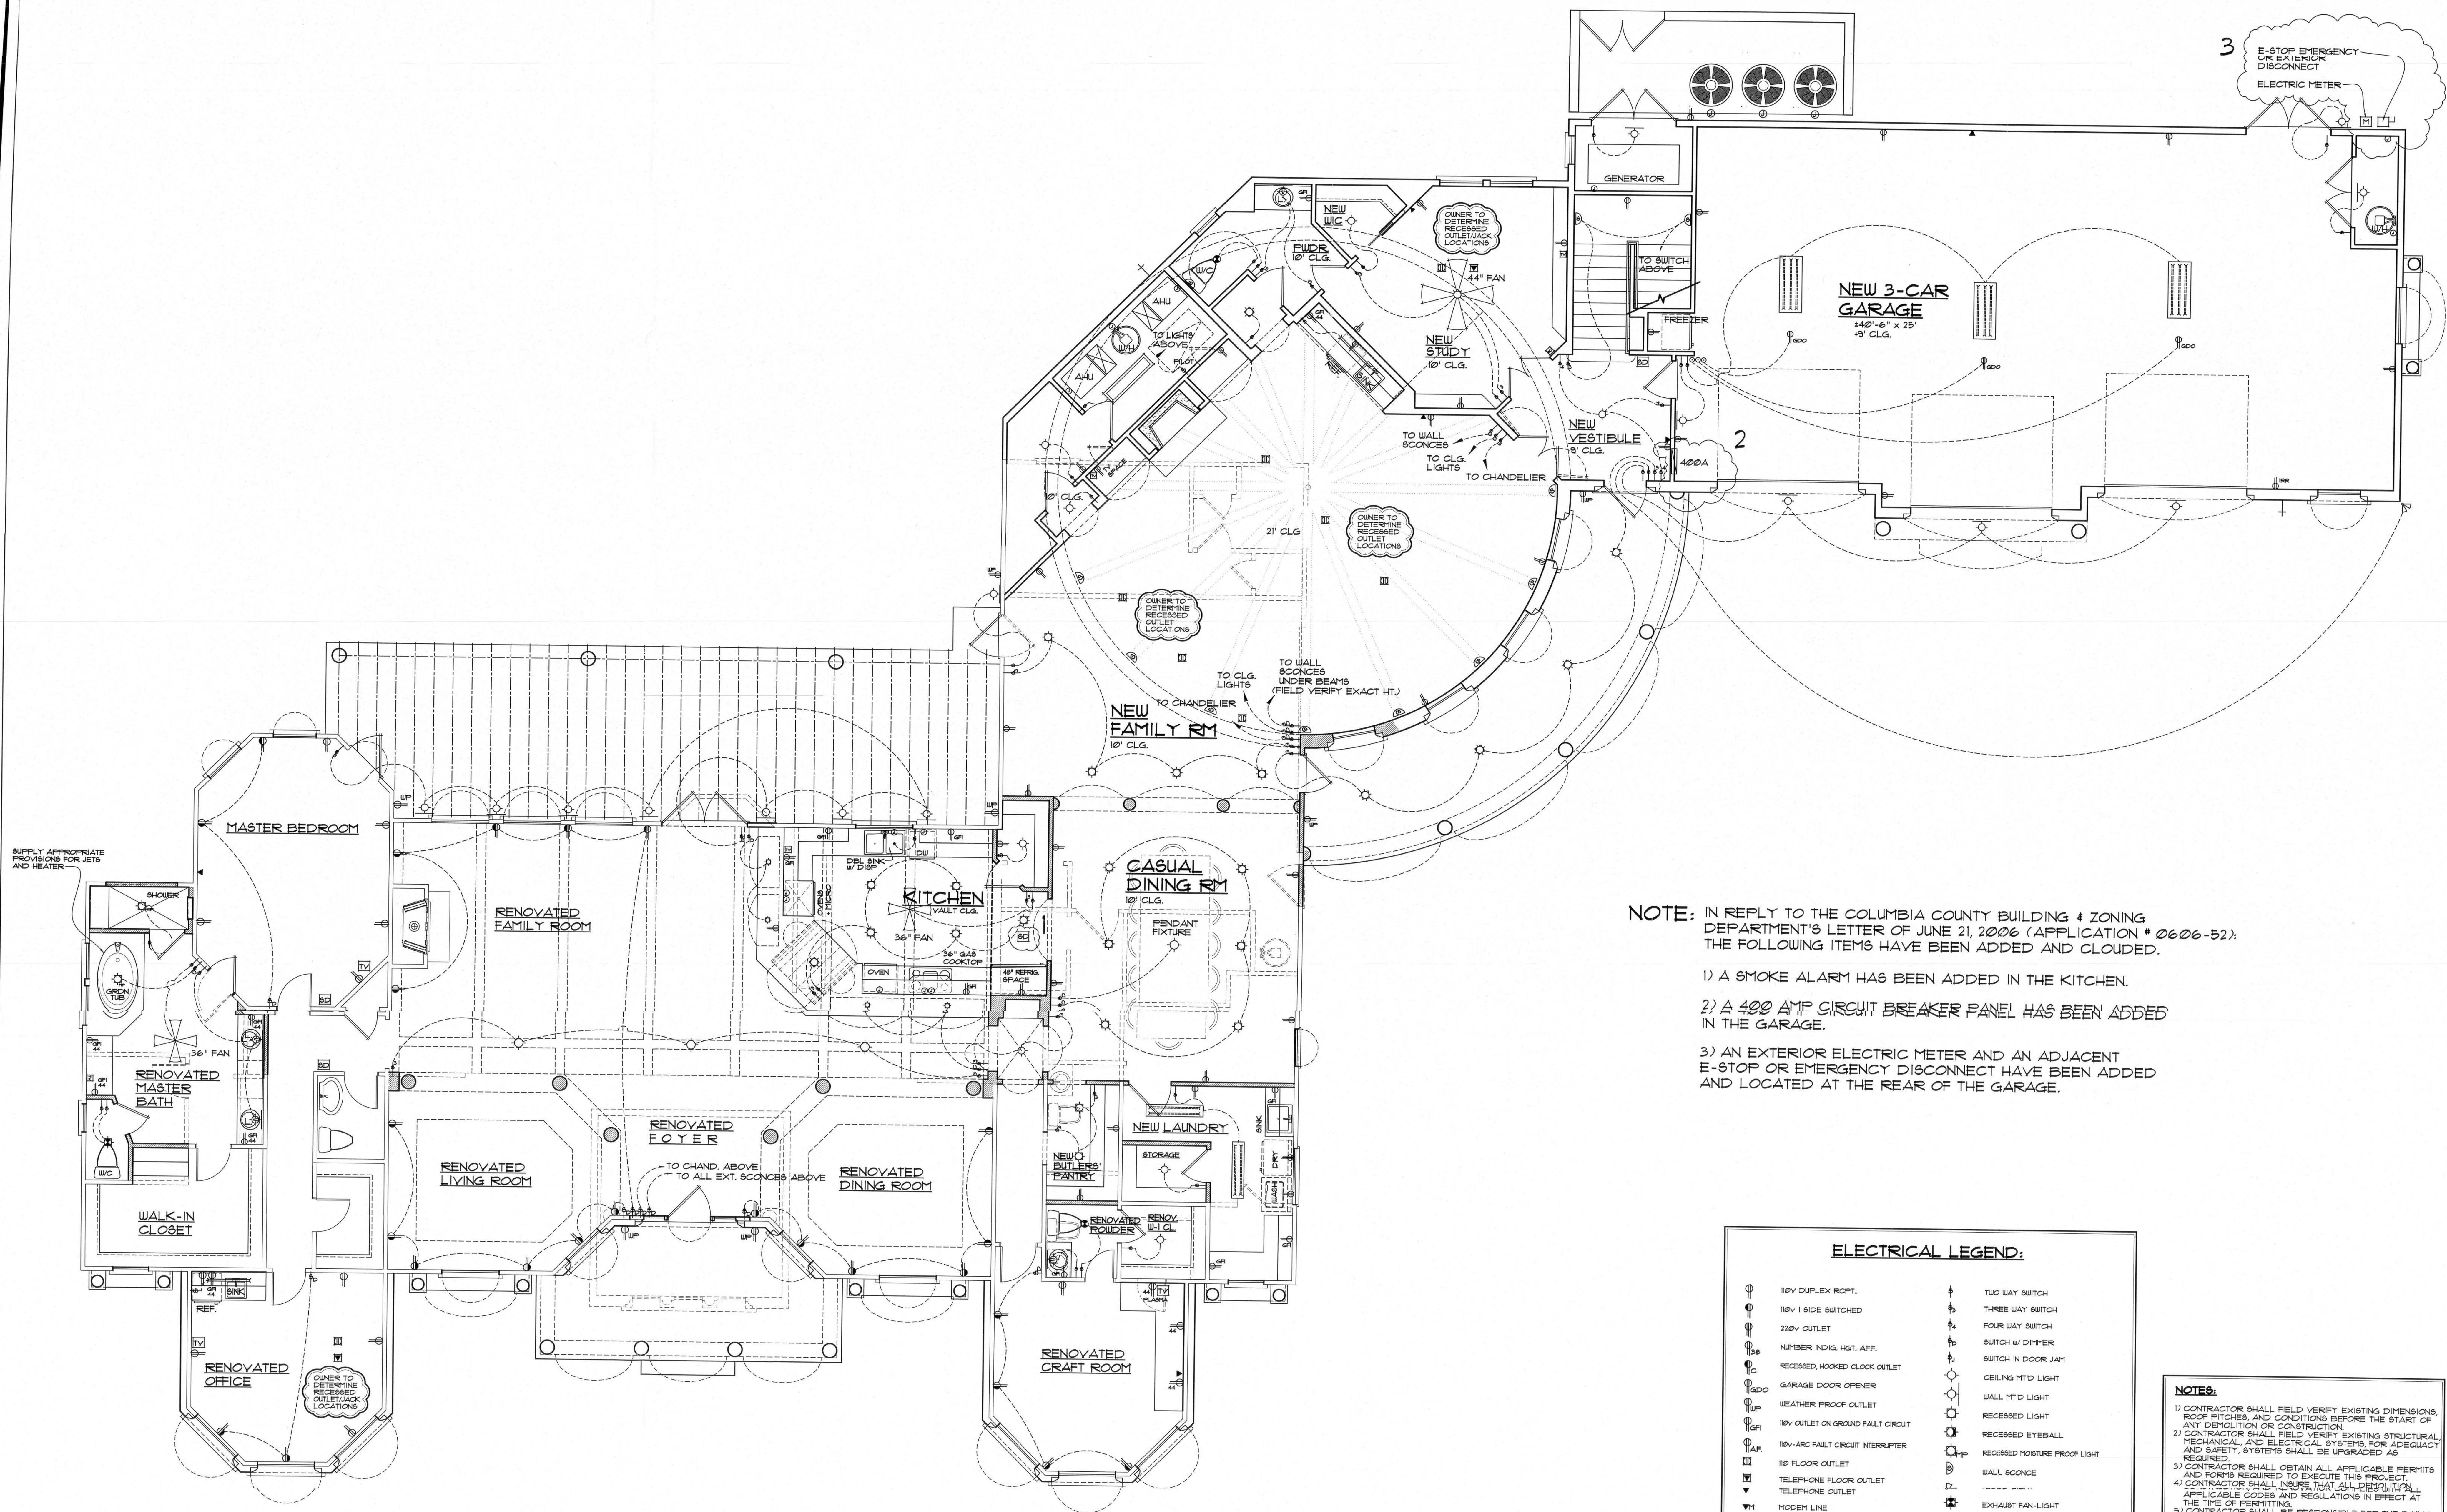

















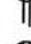

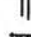










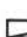







FIRST FLOOR ELECTRIC PLAN

NOTE: IN REPLY TO THE COLUMBIA COUNTY BUILDING & ZONING DEPARTMENT'S LETTER OF JUNE 21, 2006 (APPLICATION # 0606-52); THE FOLLOWING ITEMS HAVE BEEN ADDED AND CLOUDED.

- 1) A SMOKE ALARM HAS BEEN ADDED IN THE KITCHEN.
- 2) A 400 AMP CIRCUIT BREAKER PANEL HAS BEEN ADDED IN THE GARAGE.
- 3) AN EXTERIOR ELECTRIC METER AND AN ADJACENT E-STOP OR EMERGENCY DISCONNECT HAVE BEEN ADDED AND LOCATED AT THE REAR OF THE GARAGE.

ELECTRICAL LEGEND:

	100V DUPLEX RECEPT.		TWO WAY SWITCH
	100V 1/2 SIDE SWITCHED		THREE WAY SWITCH
	220V OUTLET		FOUR WAY SWITCH
	NUMBER INDIC. HGT. AFF.		SWITCH W/ DIMMER
	RECESSED, HOOKED CLOOT OUTLET		SWITCH IN DOOR JAM
	GARAGE DOOR OPENER		CEILING MTD LIGHT
	WEATHER PROOF OUTLET		WALL MTD LIGHT
	100V OUTLET ON GROUND FAULT CIRCUIT		RECESSED LIGHT
	100V-ARC FAULT CIRCUIT INTERRUPTER		RECESSED EYEBALL
	100 FLOOR OUTLET		RECESSED MOISTURE PROOF LIGHT
	TELEPHONE FLOOR OUTLET		WALL SCONCE
	TELEPHONE OUTLET		EXHAUST FAN-LIGHT
	MODERN LINE		EXHAUST FAN
	CABLE TV OUTLET		CEILING FAN PRESURE
	SMOKE DETECTOR		PANEL
	INTERCOM STATION		TRACK LIGHTING
	SPEAKER		CEILING FAN
	VOLUME LEVEL CONTROL		CEILING FAN-LIGHT
	JUNCTION BOX		TUBE LIGHT
	PUSH BUTTON		
	THERMOSTAT		
	ALARM KEYPAD		
	SECURITY CAMERA		
	CHIMES		24 x 48 FLUORESCENT BOX FIXTURE

NOTE: 1) ALL OUTLETS IN BEDROOM TO BE "A.F.I.". 2) ALL EXTERIOR OUTLETS TO BE "G.F.I.". 3) ALL ELECTRICAL WIRING TO BE IN ACCORDANCE WITH ARTICLE 80 OF NFPA 70A

NOTES:

- 1) CONTRACTOR SHALL FIELD VERIFY EXISTING DIMENSIONS, ROOF PITCHES, AND CONDITIONS BEFORE THE START OF ANY DEMOLITION OR CONSTRUCTION.
- 2) CONTRACTOR SHALL FIELD VERIFY EXISTING STRUCTURAL, MECHANICAL, AND ELECTRICAL SYSTEMS, FOR ADEQUACY AND SAFETY. SYSTEMS SHALL BE UPGRADED AS REQUIRED.
- 3) CONTRACTOR SHALL OBTAIN ALL APPLICABLE PERMITS AND FORMS REQUIRED TO EXECUTE THIS PROJECT.
- 4) CONTRACTOR SHALL INSURE THAT ALL DEMOLITION, APPLICABLE CODES AND REGULATIONS IN EFFECT AT THE TIME OF PERMITTING.
- 5) CONTRACTOR SHALL BE RESPONSIBLE FOR THE DAILY COLLECTION AND DISPOSAL OF ALL TRASH, DEMOLITION MATERIAL, TRIMMINGS, REFUSE, ETC. FROM THE SITE.
- 6) CONTRACTORS SHALL SAVE AND RETAIN ON SITE ANY MATERIAL, EQUIPMENT, OR ITEMS DESIRED BY THE OWNER. MATCH EXISTING, ANY POSSIBLE DIFFERENCES SHALL BE BROUGHT TO THE ATTENTION OF THE OWNER BEFORE CONSTRUCTION.
- 7) DURING DEMOLITION AND NEW CONSTRUCTION, ANY UNEXPECTED AREAS SHALL BE ADEQUATELY PROTECTED FROM WEATHER, STRUCTURAL DAMAGE, OR DAMAGE.
- 8) ANY ELECTRICAL, PLUMBING, OR HVAC LINES TO BE ABANDONED SHALL BE TRIMMED AND CAFFEED.
- 9) ANY AREAS WHERE NEW ROOF MEETS EXISTING ROOF AND/OR STRUCTURE SHALL BE ADEQUATELY FLASHED AND SEALED.
- 10) STUCCO CONTROL JOINTS TO BE PROVIDED PER PORTLAND CEMENT ASSOCIATION RECOMMENDATIONS.
- 11) CONTRACTOR TO VERIFY SETBACKS AND LOCATION OF STRUCTURE PRIOR TO CONSTRUCTION.
- 12) ALL WOOD IN CONTACT WITH MASONRY, CONCRETE, OR EARTH SHALL BE PRESURE TREATED APPROPRIATELY FOR THE CONDITION.
- 13) ALL INTERIOR AND EXTERIOR FLOOR TILE SHALL HAVE A NON-SLIP FINISH. FLOORING TO MEET ASTM D1895. STATIC COEFFICIENT OF FRICTION MIN OF 0.6.
- 14) CONTRACTOR TO ENSURE THAT ALL CONSTRUCTION COMPLES WITH NFPA LIFE SAFETY CODES AND 2004 FLORIDA BUILDING CODE REQUIREMENTS.

NOTE:


DIMENSIONS, HEIGHTS AND SITE ELEVATIONS ARE APPROXIMATE AND SUBJECT TO FIELD CONDITIONS. CONTRACTOR TO VERIFY BEFORE COMMENCEMENT.

NOTES:
This plan was prepared by the undersigned architect, engineer, or other professional person, and it is hereby certified that the same were prepared by him or under his direct supervision and that he is a duly licensed professional person in the State of Florida.

10701 Deerswood Park Blvd.
Jacksonville, Florida 32256
PHONE: (904) 384-3885
FAX: (904) 384-3880
WWW.KRIVINSKY.COM
RESIDENTIAL DESIGNS BY KEVIN GRAY, INC.

ADDITIONS AND RENOVATIONS TO THE:
MIKE & LINDA CADY RESIDENCE
161 NW LAKE JEFFERY ROAD
LAKE CITY, FLORIDA

DRAWN BY: AA RFF
CHECKED BY:
DATE: 02/11/06
SCALE: 1/4" = 1'-0"
JOB NUMBER: 0000
REVISED: 06/23/06
DWS NO: 13

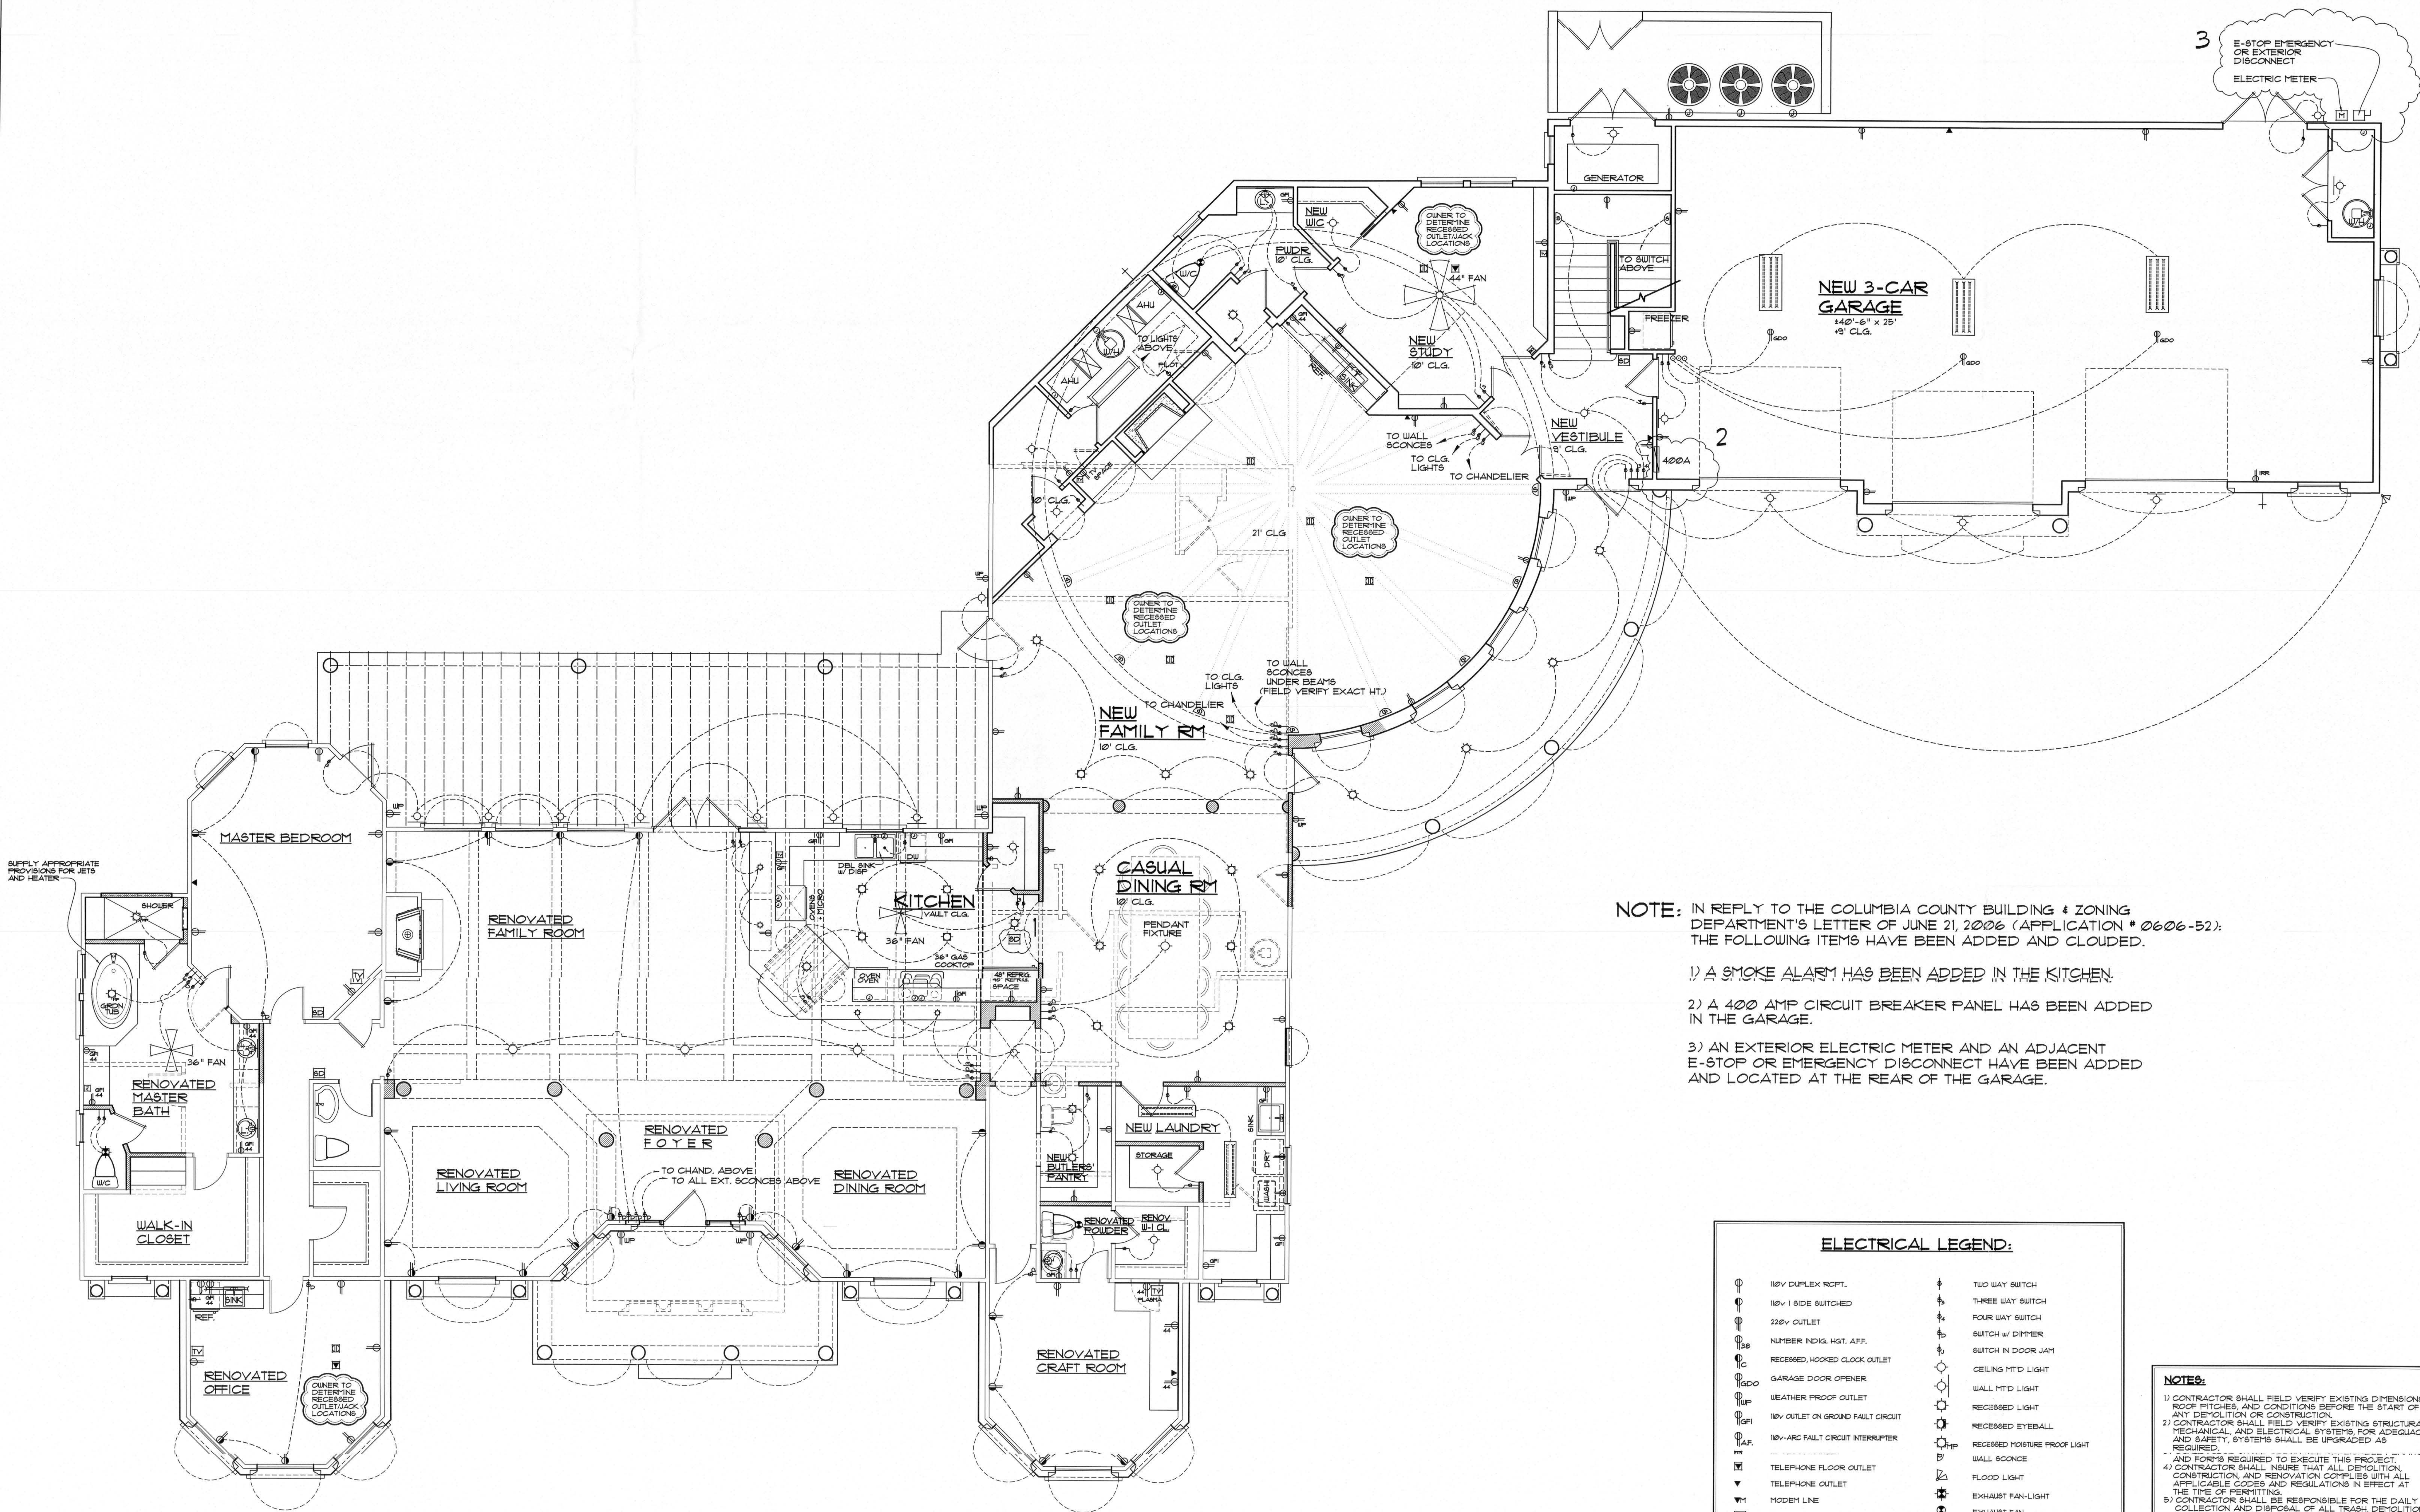

FIRST FLOOR ELECTRIC PLAN

NOTE: IN REPLY TO THE COLUMBIA COUNTY BUILDING & ZONING DEPARTMENT'S LETTER OF JUNE 21, 2006 (APPLICATION # 0606-52); THE FOLLOWING ITEMS HAVE BEEN ADDED AND CLOUDED.

- 1) A SMOKE ALARM HAS BEEN ADDED IN THE KITCHEN.
- 2) A 400 AMP CIRCUIT BREAKER PANEL HAS BEEN ADDED IN THE GARAGE.
- 3) AN EXTERIOR ELECTRIC METER AND AN ADJACENT E-STOP OR EMERGENCY DISCONNECT HAVE BEEN ADDED AND LOCATED AT THE REAR OF THE GARAGE.

ELECTRICAL LEGEND:

120V DUPLEX RECP.	TWO WAY SWITCH
120V 1 SIDE SWITCHED	THREE WAY SWITCH
220V OUTLET	FOUR WAY SWITCH
NUMBER INDG. HST. AFF.	SWITCH W/ DIMMER
RECESSED, HOOKED CLOCK OUTLET	SWITCH IN DOOR JAMB
GARAGE DOOR OPENER	CEILING MTD LIGHT
WEATHER PROOF OUTLET	WALL MTD LIGHT
120V OUTLET ON GROUND FAULT CIRCUIT	RECESSED LIGHT
120V-ARC FAULT CIRCUIT INTERRUPTER	RECESSED EYE BALL
TELEPHONE FLOOR OUTLET	RECESSED MOISTURE PROOF LIGHT
TELEPHONE OUTLET	WALL SCONCE
MODERN LINE	FLOOD LIGHT
CABLE TV OUTLET	EXHAUST FAN-LIGHT
SMOKE DETECTOR	EXHAUST FAN
INTERCOM STATION	CEILING FAN PRELURE
INTERCOM PANEL	PANEL
SPEAKER	TRACK LIGHTING
VOLUME LEVEL CONTROL	CEILING FAN
JUNCTION BOX	CEILING FAN-LIGHT
PUSH BUTTON	TUBE LIGHT
THERMOSTAT	
ALARM KEYPAD	
SECURITY CAMERA	
CHIMES	
	24 x 48 FLUORESCENT BOX FIXTURE

NOTE: 1) ALL OUTLETS IN BEDROOM TO BE "A.F.I.".
2) ALL EXTERIOR OUTLETS TO BE "G.F.I.".
3) ALL ELECTRICAL WIRING TO BE IN ACCORDANCE WITH ARTICLE 80 OF NFPA 70A

NOTES:


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- 2) CONTRACTOR SHALL FIELD VERIFY EXISTING STRUCTURAL, MECHANICAL, AND ELECTRICAL SYSTEMS FOR ADEQUACY AND SAFETY. SYSTEMS SHALL BE UPGRADED AS REQUIRED.
- 3) AND FORMS REQUIRED TO EXECUTE THIS PROJECT.
- 4) CONTRACTOR SHALL INSURE THAT ALL DETENTION, CONSTRUCTION, AND RENOVATION COMPLY WITH ALL APPLICABLE CODES AND REGULATIONS IN EFFECT AT THE TIME OF PERMITTING.
- 5) CONTRACTOR SHALL BE RESPONSIBLE FOR THE DAILY COLLECTION AND CHARGING OF ALL TRASH, DETENTION MATERIAL, TRIPPING, REFUSE, ETC. FROM THE SITE.
- 6) CONTRACTOR SHALL MAINTAIN AND RETAIN ON SITE ANY MATERIAL, EQUIPMENT, OR ITEMS DESIRED BY THE OWNER.
- 7) NEW CONSTRUCTION, TRIM FINISHES, BRICK, ETC. SHALL MATCH EXISTING. ANY POSSIBLE DIFFERENCES SHALL BE BROUGHT TO THE ATTENTION OF THE OWNER BEFORE CONSTRUCTION.
- 8) DURING DETENTION AND NEW CONSTRUCTION, ANY UNPAVED AREAS SHALL BE ADEQUATELY PROTECTED FROM WEATHER, STRUCTURAL DAMAGE, OR DAMAGE FROM NEW CONSTRUCTION.
- 9) ANY ELECTRICAL, PLUMBING, OR HVAC LINES TO BE ABANDONED SHALL BE PROPERLY TIED AND CAPPED.
- 10) ANY AREAS WHERE NEW ROOF MEETS EXISTING ROOF AND/OR STRUCTURE SHALL BE ADEQUATELY FLASHED AND SEALED.
- 11) STUCCO CONTROL JOINTS TO BE PROVIDED PER PORTLAND CEMENT ASSOCIATION RECOMMENDATIONS.
- 12) CONTRACTOR TO VERIFY SETBACKS AND LOCATION OF STRUCTURE PRIOR TO CONSTRUCTION.
- 13) ALL WOOD IN CONTACT WITH MASONRY, CONCRETE, OR EARTH SHALL BE PRESURE TREATED APPROPRIATELY FOR THE CONDITION.
- 14) ALL INTERIOR AND EXTERIOR FLOOR TILE SHALL HAVE A NON-SLIP FINISH, FLOORING TO MEET ASTM C1028.
- 15) CONTRACTOR TO ENSURE THAT ALL CONSTRUCTION COMPLIES WITH NFPA LIFE SAFETY CODES AND 2004 FLORIDA BUILDING CODE REQUIREMENTS.

NOTE:

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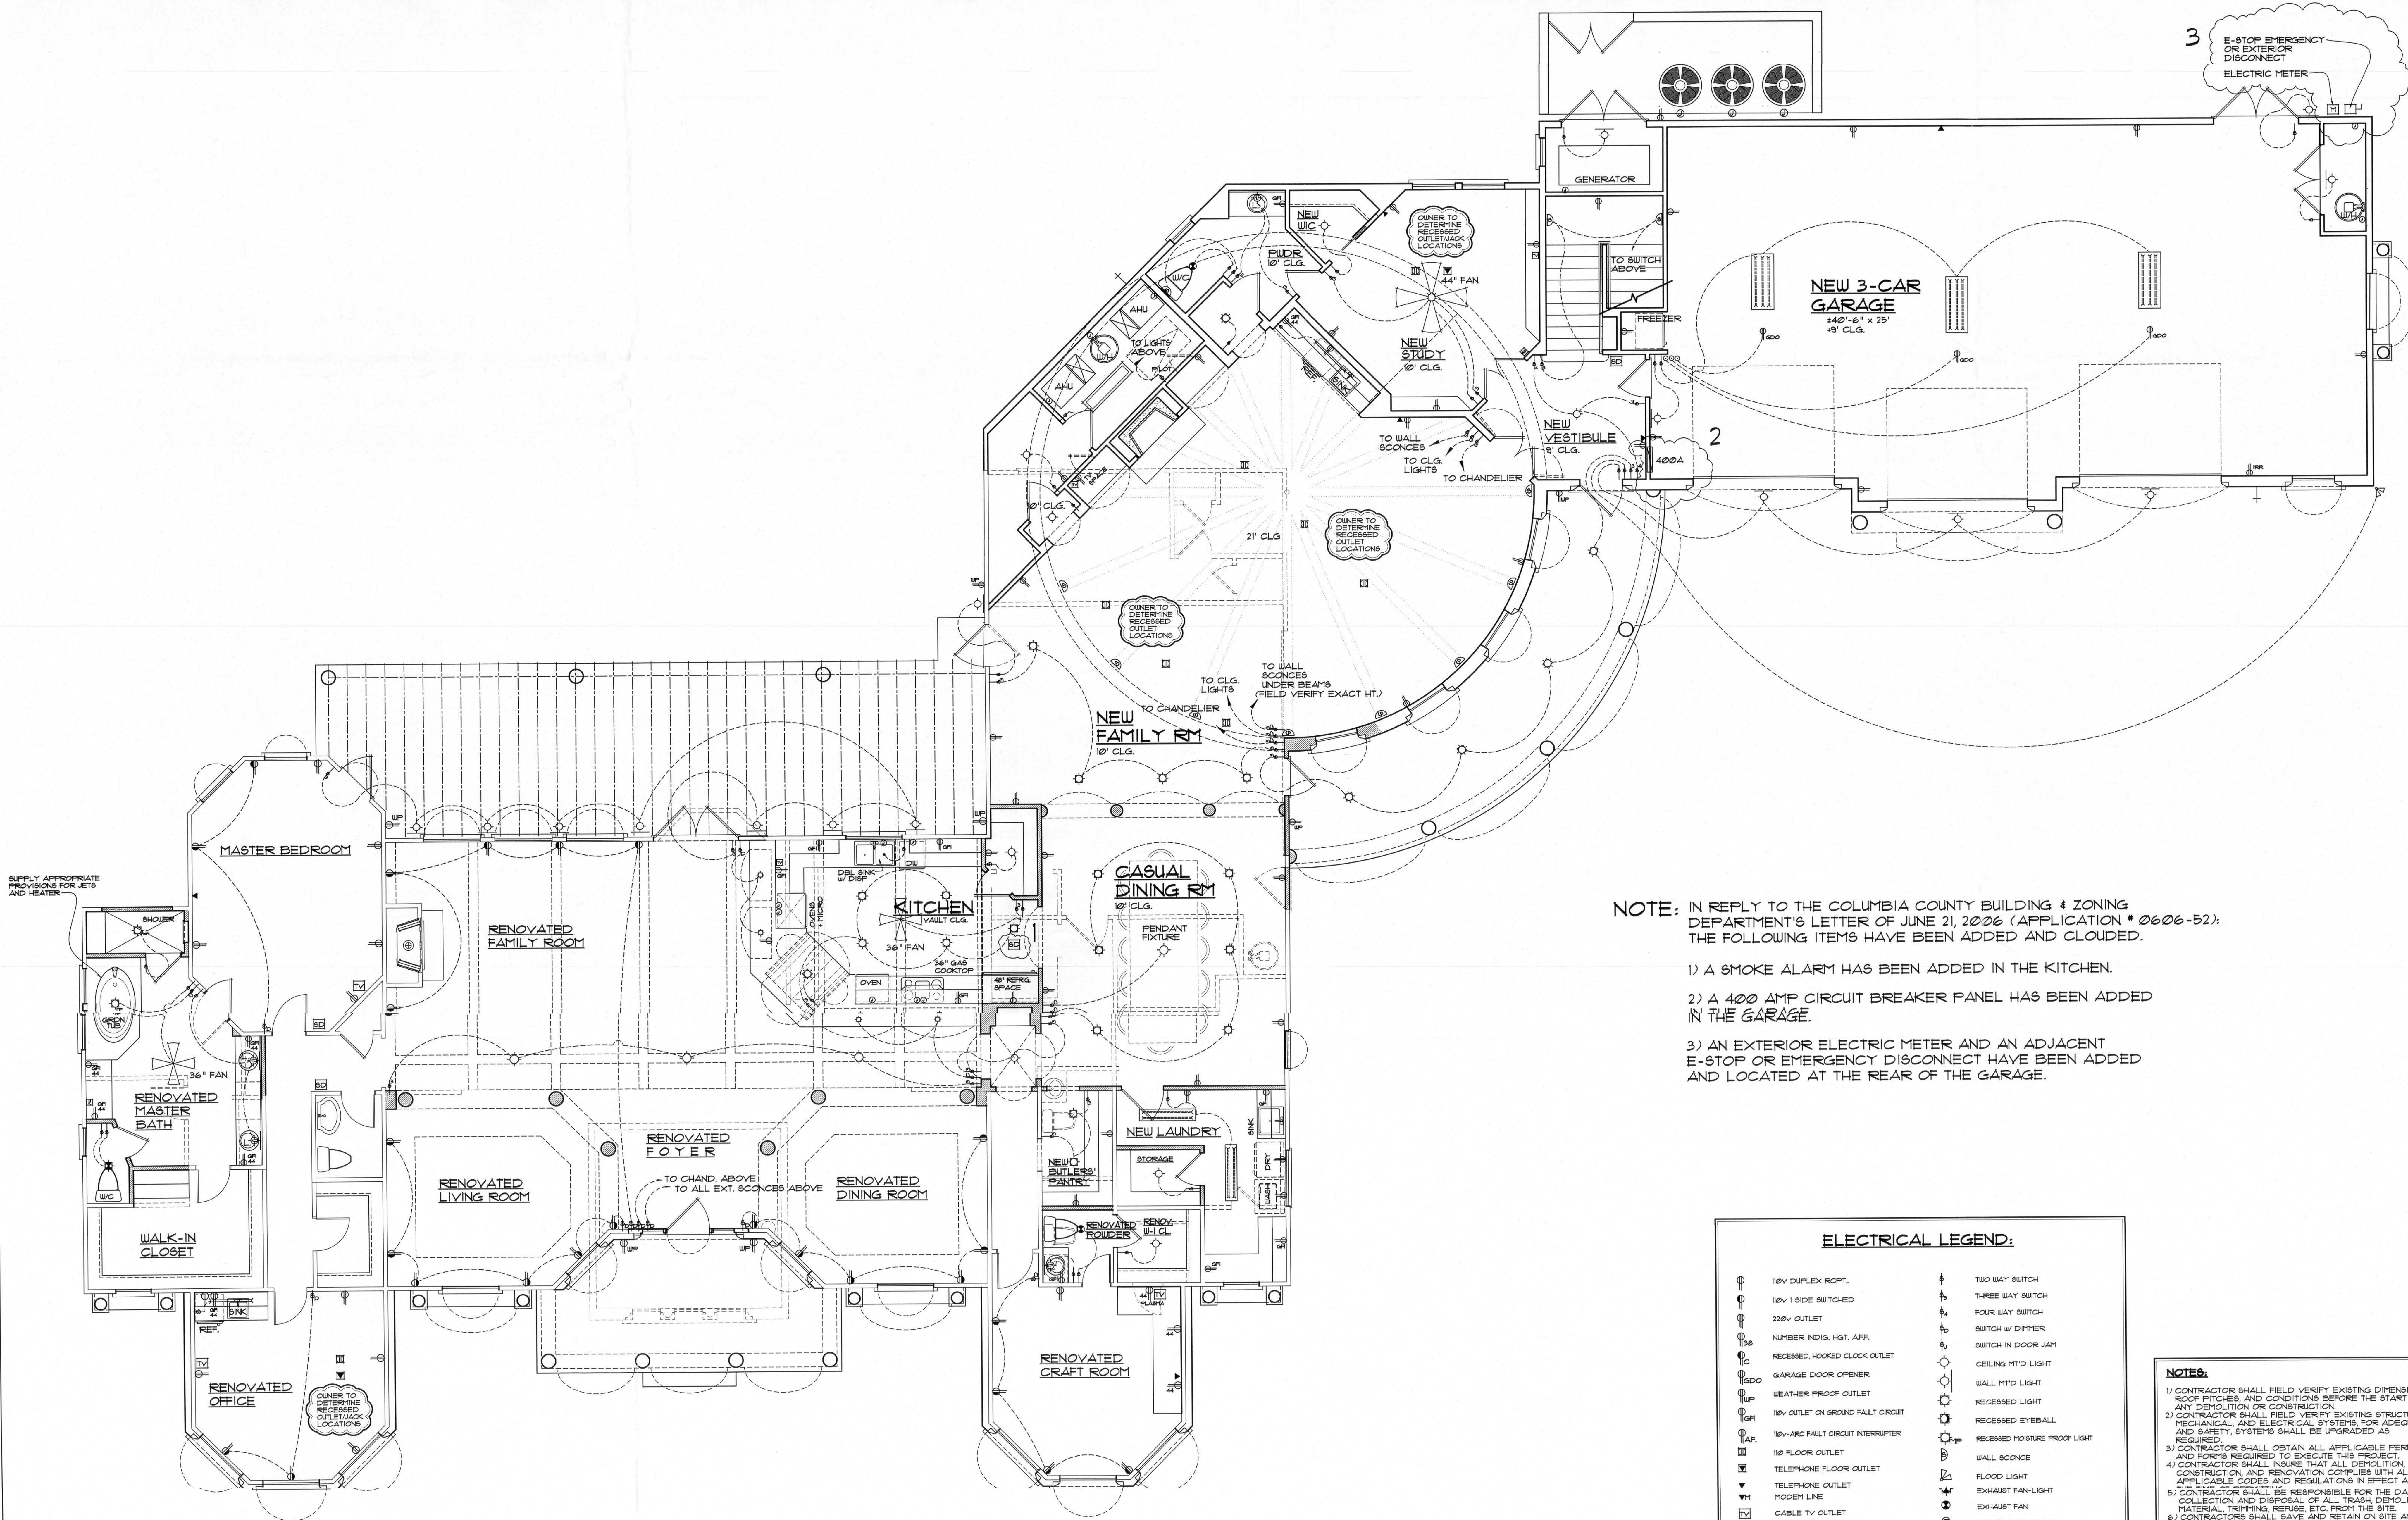
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12 13



RESIDENTIAL DESIGNS BY KEVIN GRAY, INC.
10791 Duneswood Park Blvd.
State #150
Jacksonville, Florida 32256
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FAX: (904) 984-1380
www.kevingray.com
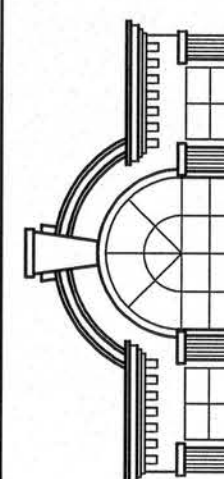
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120V DUPLEX REPT.	120V 1 SIDE SWITCHED	220V OUTLET	NUMBER INDIC. HST. APP.	RECESSED, HOOKED CLOCK OUTLET	GARAGE DOOR OPENER	WEATHER PROOF OUTLET	120V OUTLET ON GROUND FAULT CIRCUIT	120V-ARC FAULT CIRCUIT INTERRUPTER	120 FLOOR OUTLET	TELEPHONE FLOOR OUTLET	TELEPHONE OUTLET	MODERN LINE	CABLE TV OUTLET	SMOKE DETECTOR	INTERCOM STATION	INTERCOM PANEL	SPEAKER	VOLUME LEVEL CONTROL	JUNCTION BOX	PUSH BUTTON	THERMOSTAT	ALARM KEYPAD	SECURITY CAMERA	CHIMES	TWO WAY SWITCH	THREE WAY SWITCH	FOUR WAY SWITCH	SWITCH W/ DIMMER	SWITCH IN DOOR JAMB	CEILING MTD LIGHT	WALL MTD LIGHT	RECESSED LIGHT	RECESSED EYE BALL	RECESSED MOISTURE PROOF LIGHT	WALL SCONCE	FLOOD LIGHT	EXHAUST FAN-LIGHT	EXHAUST FAN	CEILING FAN PRESURE	PANEL	TRACK LIGHTING	CEILING FAN	CEILING FAN-LIGHT	TUBE LIGHT	24 x 48 FLUORESCENT BOX FIXTURE
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- 6) CONTRACTORS SHALL SAVE AND RETAIN ON SITE ANY MATERIAL, EQUIPMENT, OR ITEMS DESIRED BY THE OWNER.
- 7) NEW CONSTRUCTION, TRIM FINISHES, BRICK, ETC. SHALL MATCH EXISTING. ANY POSSIBLE DIFFERENCES SHALL BE BROUGHT TO THE ATTENTION OF THE OWNER BEFORE CONSTRUCTION.
- 8) DURING DEMOLITION AND NEW CONSTRUCTION, ANY UNPAVED AREAS SHALL BE ADEQUATELY PROTECTED FROM WEATHER, STRUCTURAL DAMAGE, OR DAMAGE FROM NEW CONSTRUCTION.
- 9) ANY ELECTRICAL, PLUMBING, OR HVAC LINES TO BE ABANDONED SHALL BE TRIMMED AND CARPED.
- 10) ANY AREAS WHERE NEW ROOF MEETS EXISTING ROOF AND/OR STRUCTURE SHALL BE ADEQUATELY FLASHED AND SEALED.
- 11) STUCCO CONTROL JOINTS TO BE PROVIDED PER PORTLAND CEMENT ASSOCIATION RECOMMENDATIONS.
- 12) CONTRACTOR TO VERIFY SETBACKS AND LOCATION OF STRUCTURE PRIOR TO CONSTRUCTION.
- 13) ALL WOOD IN CONTACT WITH MASONRY, CONCRETE, OR EARTH SHALL BE PRESURE TREATED APPROPRIATELY FOR THE CONDITION.
- 14) ALL INTERIOR AND EXTERIOR FLOOR TILE SHALL HAVE A NON-SLIP FINISH FLOORING TO MEET ASTM C1028 STATIC COEFFICIENT OF FRICTION MIN OF 0.6.
- 15) CONTRACTOR TO INSURE THAT ALL CONSTRUCTION COMPLIES WITH NFPA LIFE SAFETY CODES AND 2004 FLORIDA BUILDING CODE REQUIREMENTS.

NOTE:

DIMENSIONS, HEIGHTS AND SITE ELEVATIONS ARE APPROXIMATE AND SUBJECT TO FIELD CONDITIONS. CONTRACTOR TO VERIFY BEFORE COMMENCEMENT.

ADDITIONS AND RENOVATIONS TO THE:
MIKE & LINDA CADY RESIDENCE
161 NW LAKE JEFFREY ROAD
LAKE CITY, FLORIDA

DRAWN BY: AA RFF

CHECKED BY:

DATE: 02/17/06

SCALE: 1/4" = 1'-0"

JOB NUMBER: ****


REVISED: 06/23/06

DWG NO:

12 13

OF

RESIDENTIAL DESIGNS BY KEVIN GRAY, INC.
10751 Sherrill Park Blvd.
Jacksonville, Florida 32256
PHONE: (904) 351-3500
FAX: (904) 351-1500
WWW.KGRAYDESIGN.COM

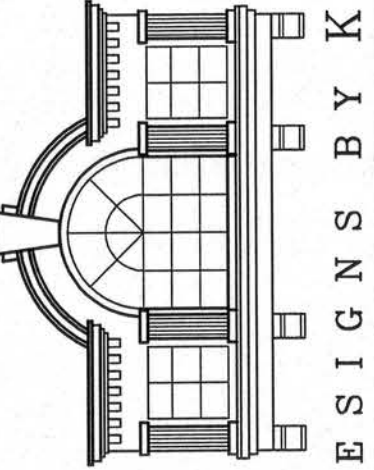

RESIDENTIAL DESIGNS BY KEVIN GRAY, INC.

NOTES:
Contractor shall field verify existing dimensions, roof pitches, and conditions before the start of any demolition or construction.
Contractor shall field verify existing structural, mechanical, and electrical systems, for adequacy and safety. Systems shall be upgraded as required.
Contractor shall obtain all applicable permits and forms required to execute this project.
Contractor shall insure that all demolition, construction and renovation complies with all applicable codes and regulations in effect at the time of construction.
Contractor shall be responsible for the daily collection and disposal of all trash, demolition material, trimming, rubbish, etc. from the site.
Contractors shall save and retain on site any material, equipment, or items desired by the owner.
New construction, trim finishes, brick, etc. shall match existing. Any possible differences shall be brought to the attention of the owner before construction.
During demolition and new construction, any unpaved areas shall be adequately protected from weather, structural damage, or damage from new construction.
Any electrical, plumbing, or HVAC lines to be abandoned shall be trimmed and carped.
Any areas where new roof meets existing roof and/or structure shall be adequately flashed and sealed.
Stucco control joints to be provided per Portland Cement Association recommendations.
Contractor to verify setbacks and location of structure prior to construction.
All wood in contact with masonry, concrete, or earth shall be pressure treated appropriately for the condition.
All interior and exterior floor tile shall have a non-slip finish flooring to meet ASTM C1028 static coefficient of friction min of 0.6.
Contractor to insure that all construction complies with NFPA life safety codes and 2004 Florida Building Code requirements.