OWNER

JONES SHED

ADDRESS

3398 SW CUSTOM MADE CL LAKE CITY, FL 32056

CONSTRUCTION DRAWINGS

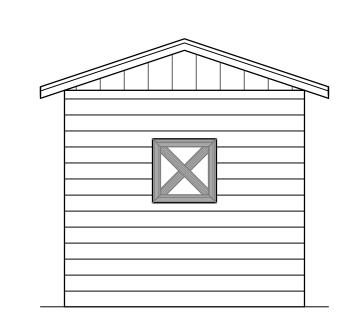
JONES SHED
LAKE CITY, FL 32056

DESIGNER



RESIDENTIAL AND COMMERCIAL DESIGN 1311 W. MARVIN ST. LONGWOOD, FL 32750 (407) 462 - 4489

FRONT ELEVATION



ABBREVIATIONS

						D.D.	DOOF DRAIN
ιBV.	ABOVE	E.J.	EXPANSION JOINT	MAS.	MASONRY	R.D.	ROOF DRAIN
CT	ACOUSTICAL CEILING TILE	ELEC.	ELECTRICAL ELEVATION	MATL	MATERIAL	RTU	ROOF TOP UNIT
NDJ.	ADJUSTABLE	ELELEV.	ELEVATION	MAX.	MAXIMUM	R.M.	ROOM
	ABOVE FINISHED FLOOR	FOLIP	FOLIPMENT	MECH.	MECHANICAL	R.O.	ROUGH OPENING
NHU .	AIR HANDLING UNIT	FOUIV	EQUIVALENT	MEP	MECHANICAL, ELECTRICAL, PLUMBING	S/A S.A.C.	SUPPLY AIR
	ALUMINUM	FSCAI	ELECTRIC WATER HEATER	MET.	METAL	S.A.C.	SUSPENDED ACOUSTICAL CEILING
NOD.	ANODIZED	E.W.C.	ESCALATOR	MFR.	METAL MANUFACTURER MINIMUM MISCELLANEOUS MASONRY OPENING	SAN.	SANITARY
	ANUUIZEU	E.W.U.	EXTERIOR	MFK.	MANUFACIURER		SOLID CORE
	APPROXIMATE	EXT.		MIN.	MINIMUM	3.0. C.E	SQUARE FOOT
RCH.	ARCHITECTURAL	F.C.O.	FLOOR CLEAN OUT	MISC.	MISCELLANEOUS	J.F.	
		F.D.	FLOOR DRAIN	M.O.	MASONRY OPENING	SIM.	SIMILAR
BD.	BOARD	F.S.	FLOOR SINK	M.S.G.	MANUFACTURER STANDARDS GAGE	SPEC.	SPECIFICATIONS
BLDG.	BUILDING	F.E.	FIRE EXTINGUISHER	MTD.	MOUNTED	SPKLR.	SPRINKLER
SLK.	BLOCK	F.E.C.	FIRE EXTINGUISHER AND CABINET			SQ.	SQUARE
EKG.	BLOCKING	F.H.C.	FIRE HOSE CABINET	N.I.C.	NOT IN CONTRACT	s/s	STAINLESS STEEL
BM.	BEAM	FIN.	FINISH	NONCOM	NONCOMBUSTIBLE	STRUCT.	STRUCTURAL
				NUNCOM.	NOT TO COALE	OTTO	STANDARD
3.F.F.	BELOW FINISHED FLOOR	FLR.	FLOOR	N.T.S.	MINIMUM MISCELLANEOUS MASONRY OPENING MANUFACTURER STANDARDS GAGE MOUNTED NOT IN CONTRACT NONCOMBUSTIBLE NOT TO SCALE ON CENTER OVERFLOW DRAIN OVERHEAD DOOR. OPENING	STD.	STEEL
BOT.	BOTTOM	FLOUR.	FLUORESCENT			SIL.	SUSPENDED
		FTG.	FOOTING	0.C.	ON CENTER	2025	
LG.	CEILING			0.D.	OVERFLOW DRAIN	S&K	SHELF AND ROD
.J.	CONTROL JOINT	GA.	GAUGE	0.H. DR.	OVERHEAD DOOR.		
	CENTER LINE	GALV.	GALVANIZED	OPNG.	OPENING	THK.	THICK
	CLEAN OUT	G.C.	GENERAL CONTRACTOR			T.O.S.	TOP OF STEEL
л.о. С.м.U.	CONCRETE MASONRY UNIT	G.F.I.	GROUND FAULT INTERCEPTOR	PL.	OVERHEAD DOOR. OPENING PLATE PLASTIC LAMINATE PLASTER	T.O.W.	TOP OF WALL
	COLUMN		GALVANIZED IRON	PL. PLAM	DI ACTIC I AMINIATE	TRD.	TREAD
OL.		G.I.	GALVANIZEU IKUN	PLAM	PLASTIC LAMINATE	TYP.	TYPICAL
	CONTINUOUS	GND.	GROUND	PLAS.	PLASTER	HE.	IIIIOAL
	CONTRACTOR	GYP.	GYPSUM	PLYWD.	PLYWOOD	11110	LINI FOR MOTED OTHERWISE
ONC.	CONCRETE			PNL.	PANEL POINT OF BEGINNING	U.N.O.	UNLESS NOTED OTHERWISE
T	CERAMIC TILE	HDWD.	HARDWOOD	P.O.B.	POINT OF BEGINNING POLISHED PREFABRICATED PRESSURE TREATED POLINDS PER SOLIARE FOOT		
W	COLD WATER	HDWR	HARDWARE	POL.	POLISHED	V.C.T.	VINYL COMPOSITION TILE
		H.C.	HANDICAP	PRFFAR	PREFABRICATED	VERT.	VERTICAL
BL.	DOUBLE	H.S.	HANDSINK	P.T.	PRESSURE TREATED	VEST.	VESTIBULE
EG.	DEGREE		HOLLOW METAL	P.S.F.	POUNDS PER SQUARE FOOT	V.I.F.	VERIFY IN FIELD
		H.M.	HOLLOW METAL	r.s.r.		7.1.1	TERM I III I ILLU
EPT.	DEPARTMENT	HOR.	HORIZONTAL	P.S.I.	POUNDS PER SQUARE INCH	W/	WITH
ETL.	DETAIL	H.P.	HIGH POINT	PT	POINT	W/0	
IAM.	DIAMETER	HR.	HOUR			W/0	WITH OUT
IM.	DIMENSION	HT.	HEIGHT	QT	QUARRY TILE	W.C.O.	WALL CLEAN OUT
N.	DOWN	HW	HOT WATER			W.C.	WATER CLOSET
R.	DOOR	,	·····	R	RISER	WD.	WOOD
S.	DOWN SPOUT	I.D.	INSIDE DIAMETER	R R/A	RETURN AIR	WH	WATER HEATER
WG.	DRAWING		INCANDESCENT	REBAR		WT	WEIGHT
WG.	DRAMING		INCANDESCENT	REDAK	REINFURUING DAK	W.W.F.	WELDED WIRE FABRIC
	F. 0.1	INSUL.	INSULATION	KECEP I.	RECEPTACLE	W.W.M.	WELDED WIRE MESH
Α	EACH			REF.	KEFERENCE	₩.₩.M.	METRED MIKE MESU
.l.F.S.	EXTERIOR INSULATION FINISH SYSTEM	JAN.	JANITOR	REINF.	REINFORCED		/
		JST.	JOIST	REQ'D	RECEPTACLE REFERENCE REINFORCED REQUIRED	YD	YARD /
			GENERAL CONTRACTOR GROUND FAULT INTERCEPTOR GALVANIZED IRON GROUND GYPSUM HARDWOOD HARDWARE HANDICAP HANDSINK HOLLOW METAL HORIZONTAL HIGH POINT HOUR HEIGHT HOT WATER INSIDE DIAMETER INCANDESCENT INSULATION JANITOR JOIST				

ARCHITECTURAL SYMBOLS

A-000 INTERIOR ELEVATIONS	#	DOOR NUMBER INDICATION
WALL SECTIONS	000	- ROOM NUMBER - ROOM NAME
BUILDING SECTIONS	● 102	EXTERIOR WALL TYPES
DRAWING NO. — EXTERIOR ELEVATIONS SHEET NO.	FEO-	FIRE EXTINGUISHER
1 KEYNOTES	*	WALL / PARTITION TYPE IDENTIFICATION
REVISIONS	EL. Ø'-ØØ' AFF. REF. POINT	ELEVATION DATUM POINT
ENLARGED DETAILS OR FLOOR PLAN	FLOOR PLAN	DRAWING TITLE

DRAWINGS INDEX

TITLE	SHEET #	REVISIONS
COVERSHEET	A-00	
SITE PLAN	A-01	
FLOOR PLAN AND ELEVATIONS	A-02	
ROOF FRAMING PLAN	A-03	
BUILDING SECTION	A-04	
DETAILS	DS-01	
		$\overline{}$

NARRATIVE:
THE PURPOSE OF THESE PLANS IS TO PROVIDE CONSTRUCTION DRAWINGS FOR A WOOD POST FRAME BUILDING.



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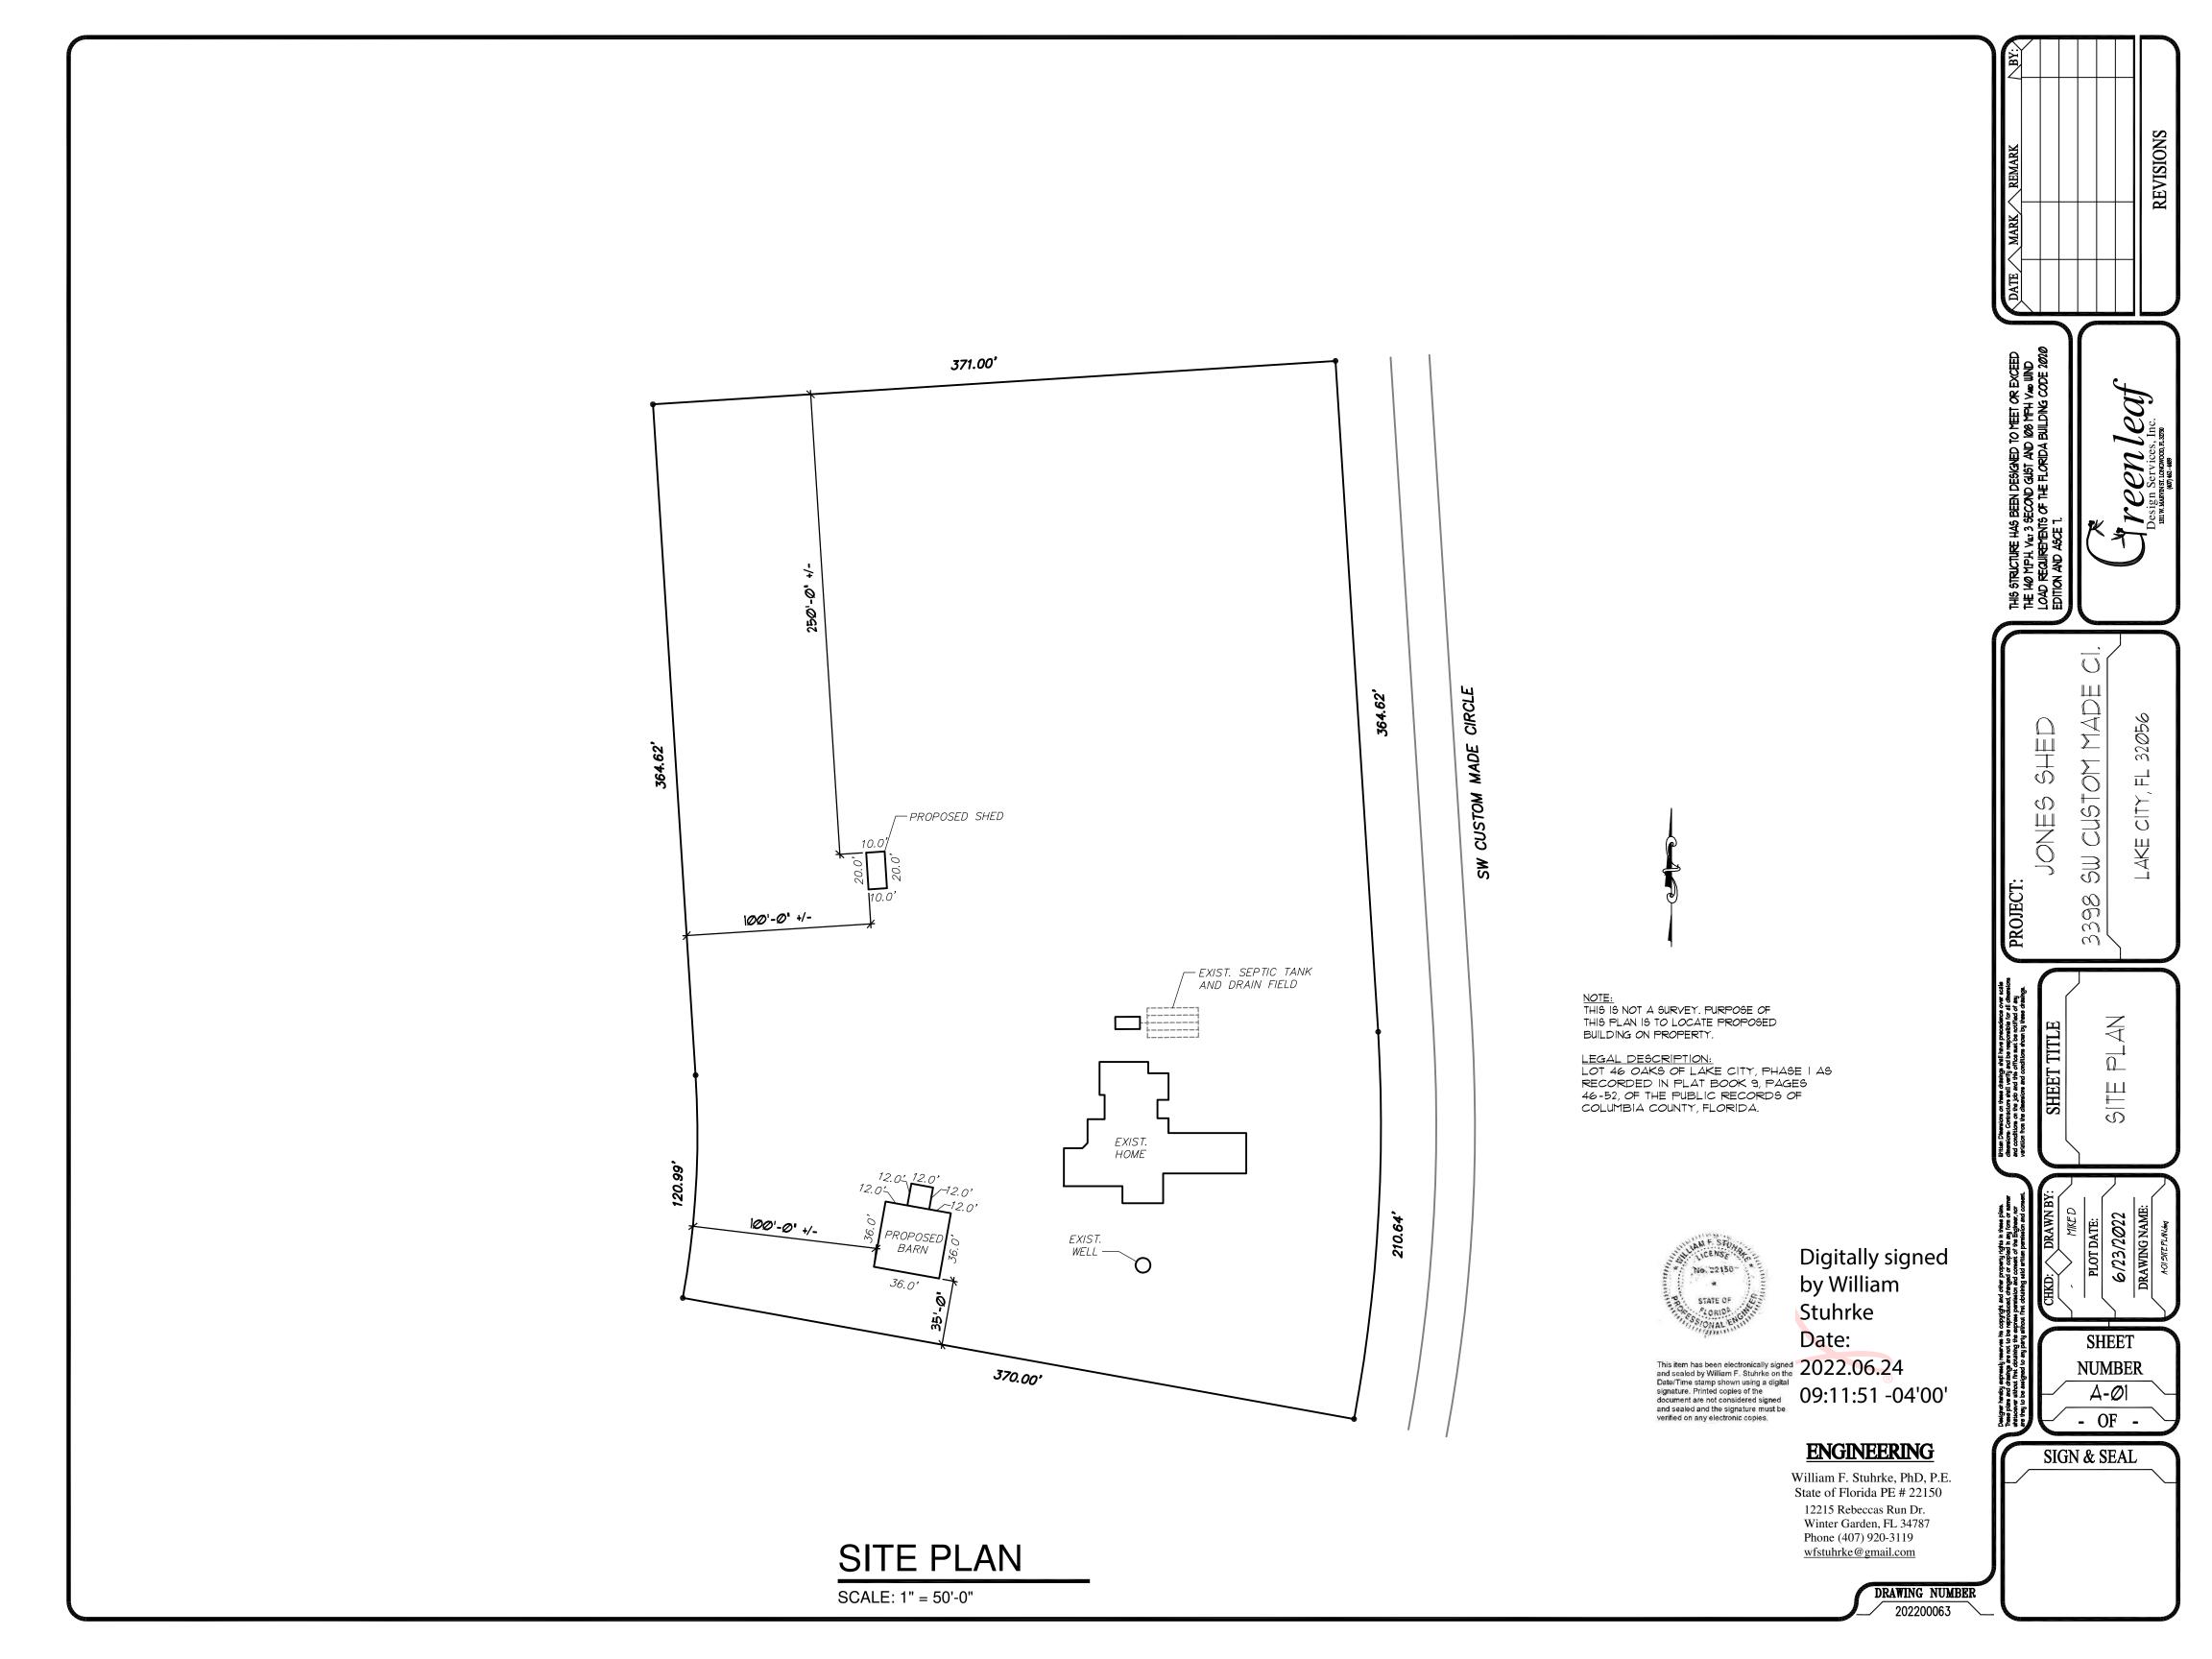
JONES SHED


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2022.06.24 09:11:30 -04'00'

ENGINEERING

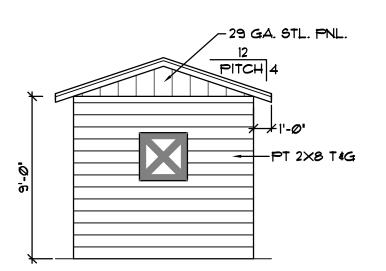
William F. Stuhrke, PhD, P.E. State of Florida PE # 22150 12215 Rebeccas Run Dr. Winter Garden, FL 34787 Phone (407) 920-3119 wfstuhrke@gmail.com






FRONT ELEVATION

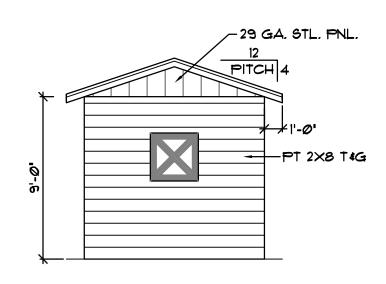SCALE: 3/16" = 1'-0"




REAR ELEVATION

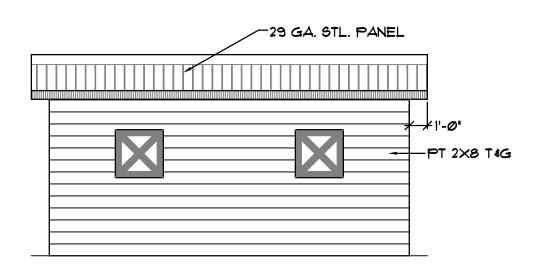SCALE: 3/16" = 1'-0"




RIGHT ELEVATION

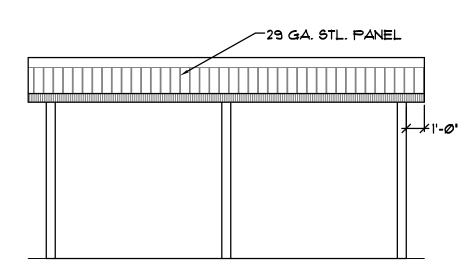SCALE: 3/16" = 1'-0"



LEFT ELEVATION

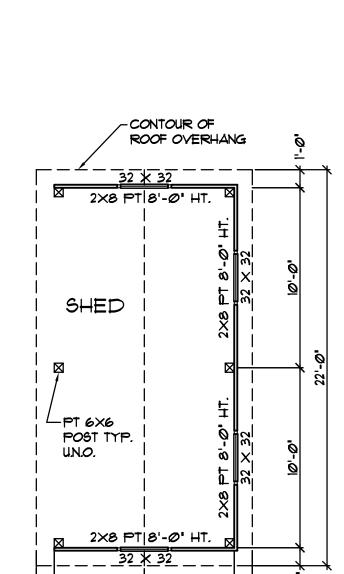SCALE: 3/16" = 1'-0"





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NOTE: FOR DOOR AND WINDOW PRESSURE REQUIREMENTS SEE SHEET DS-ØI - "WIND

REQUIREMENTS COMPONENTS AND CLADDING!

ENGINEERING


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FLOOR PLAN

12'-**0"**

SCALE:3/16" = 1'-0"

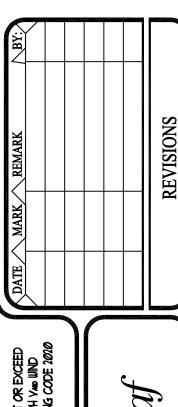
DRAWING NUMBER 202200063




급 \mathbb{O} $\stackrel{\textstyle 3}{\cong}$ 3398

SHEET NUMBER A-Ø2 - OF -

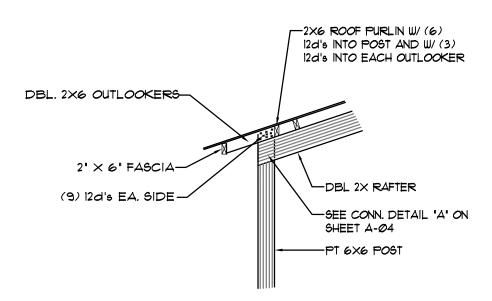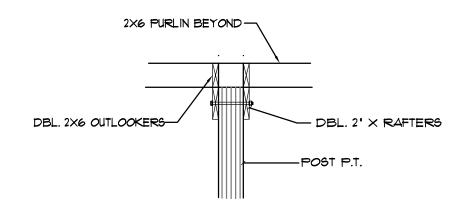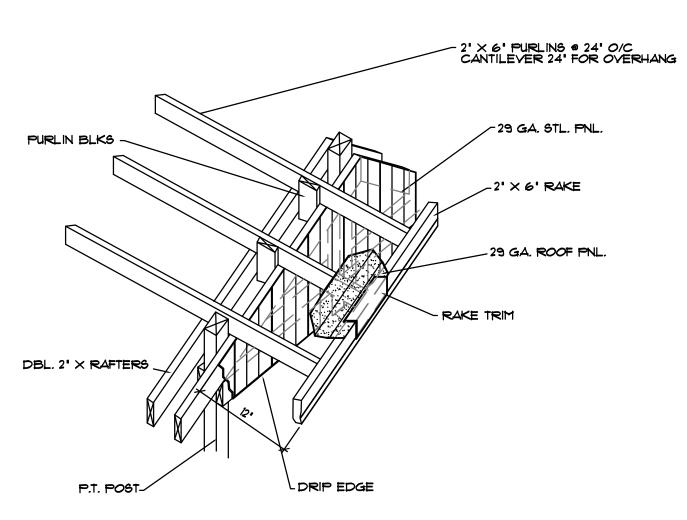
SIGN & SEAL



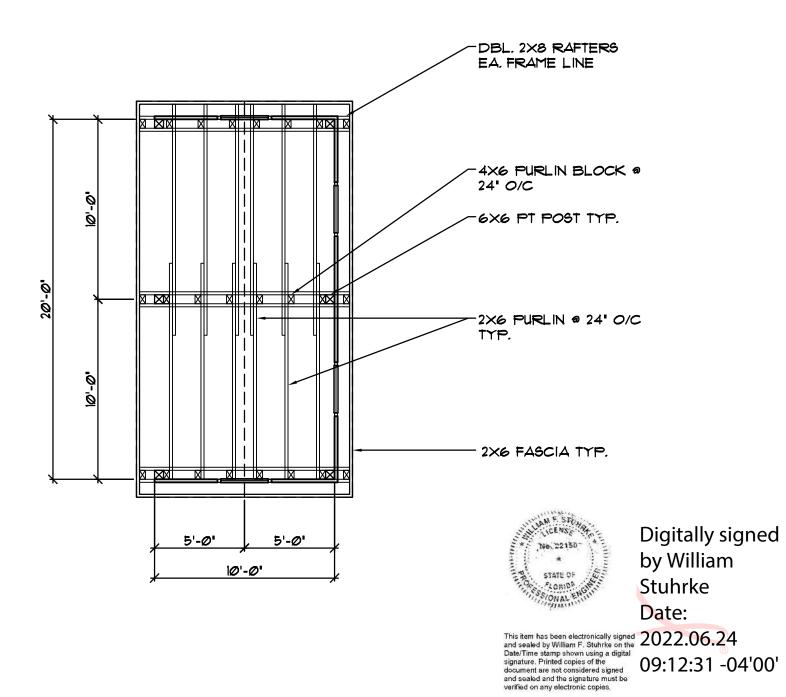












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09:12:31 -04'00'

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ROOF FRAMING PLAN

SCALE: 3/16" = 1'-0"

DRAWING NUMBER 202200063

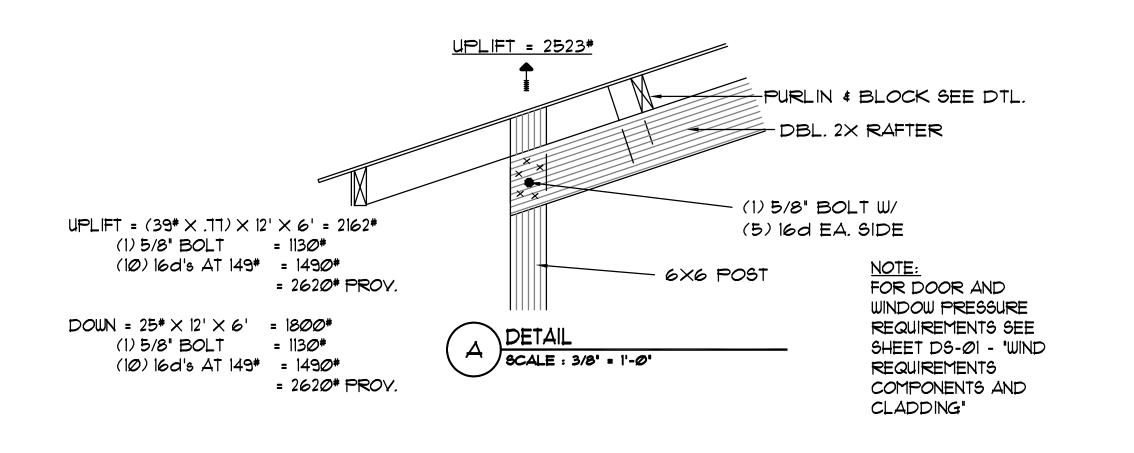
급 \mathbb{O} $\stackrel{\textstyle 3}{\cong}$ 9 $\frac{\omega}{\omega}$ FRAMING **SHEET**

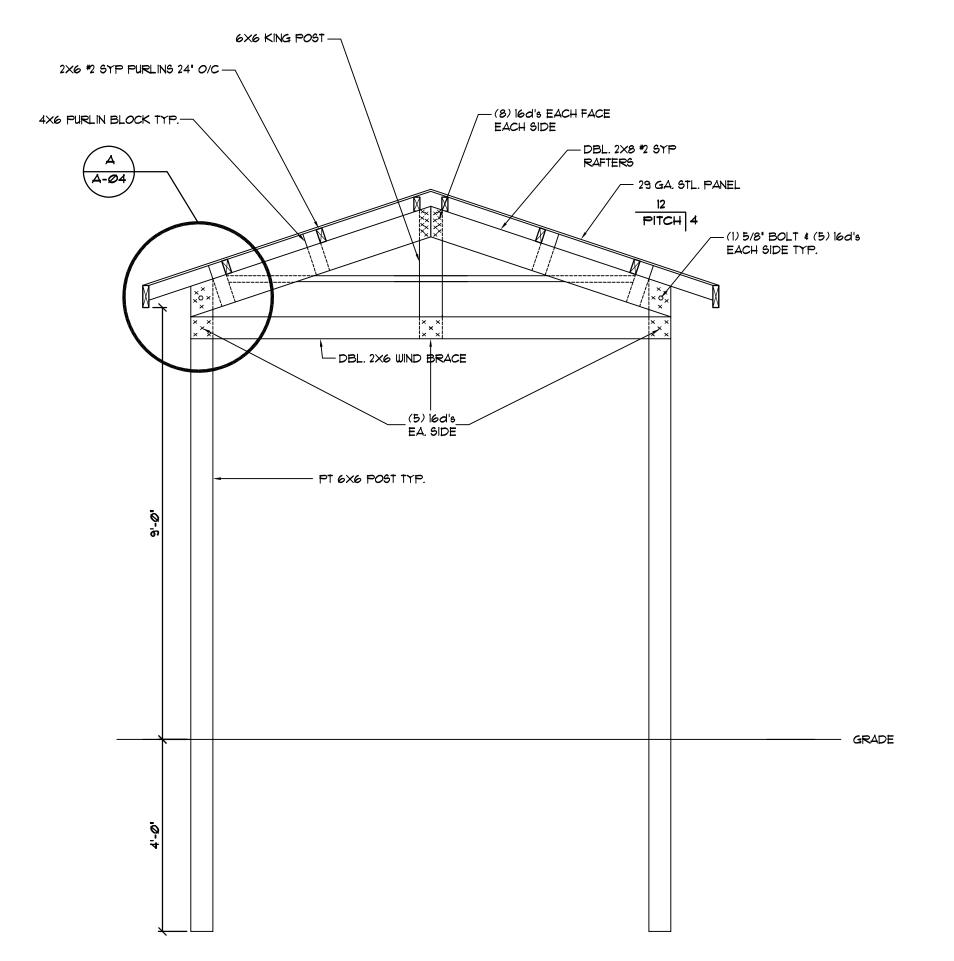
NUMBER

A-Ø3

- OF -

SIGN & SEAL





BUILDING SECTION

SCALE: 1/2" = 1'-0"



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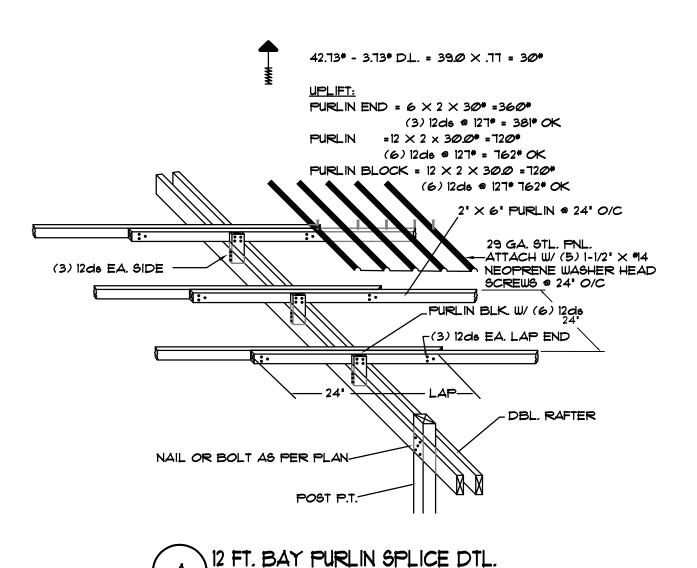
DRAWING NUMBER


REVISIONS \mathbb{A}_{A} 급 S $\stackrel{\textstyle 3}{\cong}$ 9 $\frac{\omega}{\omega}$ BUILDING SECTION

SHEET **NUMBER** A-Ø4 - OF -

SIGN & SEAL

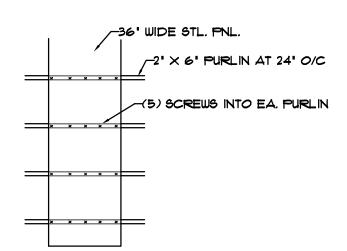202200063





B) SCREW PLACEMENT PLAN

FLORIDA PRODUCT APPROVALS

METAL PNL. SIDING: 29 GA. MID FL. METAL ROOFING SUPPLY FL. *31397.1 METAL PNL. ROOFING: 29 GA. MID FL. METAL ROOFING SUPPLY FL. *23490.1

WIND REQUIREMENTS

BASIC WIND SPEED = 140 MPH (3 SEC. GUST)

BLDG. CATEGORY = 1

WIND IMPORTANCE FACTOR = 0.77

WIND EXPOSURE CATEGORY = B

DESIGN WIND LOADS:

WALLS = +23.8 -28.93 PSF ROOF = +11.76 -37.05 PSF COMPONENTS & CLADDING:

WALLS = +27.14 -33.18 PSF ROOF = +12.98 -42.73 PSF 3030 WDW. = +35.3 -47.2 PSF 4080 DR = +33.7 -44.0 PSF 3068 DR = +35.3 -382 PSF

ROOF LOADS: LL. = 2Ø* D.L. = 05*

BLDG. CLASSIFICATION:

GENERAL NOTES:

- 1.) ALL LUMBER TO BE #2 S.Y.P.
- 2.) BEARING POSTS TO BE 0.6 PCF C.C.A. OR 0.6 PCF ACQ.
- 3.) NAILS TO BE .131 X 12d GALY. GUN NAILS.
- 4.) BOLTS TO BE A307 W/ WASHERS. 5.) IF ACQ TREATED LUMBER IS USED, NAILS TO BE HOT

DIPPED GALY.



Stuhrke Date:

Digitally

signed by


William

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202200063



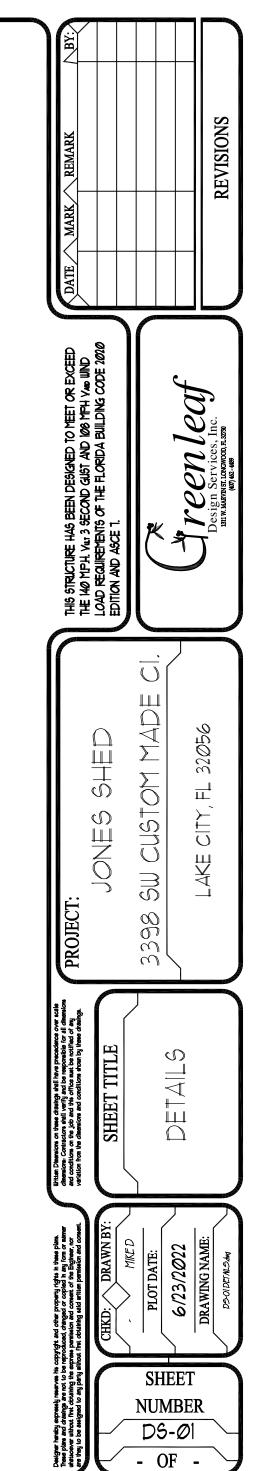SIGN & SEAL

DRAWING NUMBER