### **GENERAL NOTES**

- ALL WORK SHALL CONFORM TO CURRENT INTERNATIONAL RESIDENTIAL CODES AND

### CONSTRUCTION NOTES

FASTENERS: FOR ALL PRESERVATIVE-TREATED & FIRE- RETARDANT TREATED: CONNECTORS

DEPENDING ON THE ALLOWABLE SOIL PRESSURE AND THE LOAD. THE BOTTOM OF THE

NON-TOXIC ELASTOMERIC MATERIAL APPLIED ON THE EXTERIOR SURFACE FROM THE FOOTINGS TO THE FINISHED GRADE LINE, TO MAKE THE WALL WATERTIGHT AGAINST

FLOOR JOISTS: JOISTS SHOULD BE INSTALLED, LOCATED & SPACED ACCORDING TO LOCA

- 3. ZERO-VOC, NON-TOXIC & NON-CARCINOGENIC CAULKS, SEALANTS & ADHESIVES

### **BUGS & PESTS:**

1. NO BROAD SPECTRUM INSECTICIDES OR HERBICIDES TO BE APPLIED BEFORE, DURING OR AFTER THE FOUNDATION WORK, APPLY TERMITE SHIELDS ONLY, IF REQ'D. PROPERLY SCREEN VENTING & OPENINGS.

- 1. NUMBER OF JACK STUDS FOR ALL GIRDER & HEADER SPANS PER IRC TABLE R502.5 (1) & (2) - FOOTNOTE 'D'.
- 2. POSITIVE CONNECTION & TRANSFER OF LOAD FROM ROOF TO LOAD SUPPORTING
- 3. PROVIDE ANCHORAGE OF BEAMS OR GIRDERS TO POSTS PER IRC SEC'S R407.3, R502.9 & R802.11 4. THIS STRUCTURE TO COMPLY WITH MIN. FASTENER SCHEDULE, IRC TABLES R602.3 (1)
- 5. SOLID BLOCKING REQ'D @ ALL BEARING POINTS OF FLOOR, CEILING & ROOF SYSTEMS
- ACCORDING TO IRC SEC'S R502 & R802 6. ATTIC VENTILATION PER IRC SEC R806.

### FLOOR PLAN NOTES:

1. ALL ROOMS TO BE USED FOR SLEEPING PURPOSES & BASEMENTS WITH HABITABLE SPACE REQUIRE EMERGENCY & RESCUE OPENING COMPLYING WITH IRC SEC R310.1 2. AT LEAST ONE DOOR SHALL MEET EGRESS REQ. IRC R311. THIS DOOR MUST BE SIDE HINGED WITH MIN. 32" (813 MM) CLEAR WIDTH WHEN MEASURED B/T THE FACE OF THE DOOR & THE STOP W/ DOOR AT 90 DEGREES (1.57 RAD.). MIN. CLEAR HEIGHT OF DOOR MUST NOT BE < THAN 78" (1981 MM) MEASURED FROM TOP OF THRESHOLD TO BOTTOM OF STOP.

### WINDOW REQUIREMENTS:

- 1. MINIMUM 5.7 SQ. FT. NET CLEAR OPENABLE AREA, EXCEPT GRADE FLOOR OPENINGS
- PERMIT MIN. 5 SQ. FT. OPENABLE AREA.
- 2. MINIMUM 24" NET CLEAR OPENABLE HEIGHT 3. MINIMUM 20" NET CLEAR OPENABLE WIDTH.
- 4. SILL HEIGHT SHALL NOT BE MORE THAN 44" ABOVE THE FLOOR. 5. OPENINGS SHALL BE OPERATIONAL FROM THE INSIDE OF THE ROOM WITHOUT THE USE OF KEYS, TOOLS OR SPECIAL KNOWLEDGE.

### MINIMUM ROOM AREAS & CEILING HEIGHT:

- 1. HABITABLE ROOMS PER IRC SEC R304 FOR FLOOR AREA.
- 2. HABITABLE ROOMS PER IRC SEC R305 FOR CEILING HEIGHT. SECOND FLOOR HALLWAYS, BEDROOMS & BATHROOMS TO MEET R305 EXCEPTIONS (1) AND (2) FOR SLOPED CEILINGS.

1. STAIRWAYS & STAIRWAY LANDINGS, HANDRAILS & ILLUMINATION SHALL COMPLY WITH IRC SEC R311. GUARDS PER IRC SEC R312.

### MINIMUM FIREPLACE REQUIREMENTS:


1. PROPANE & SOLID FUEL BURNING FIREPLACES INSTALLATION SHALL COMPLY WITH IRC CHAP. 10 2. PROPANE & SOLID FUEL BURNING FIREPLACES TO BE INSTALLED ACCORDING TO MANUFACTURER'S INSTRUCTIONS.


### OWNERSHIP OF DOCUMENTS

By accepting these Drawings, Property owners signify their agreement that residential Designer shall remain the owner of the Drawings and non-standard design concepts produced in connection with this construction project. Property owners understand and agree that the Drawings and non-standard design concepts may be used exclusively for purposes of this project and that the Drawings and non-standard design concepts may not be used in connection with any extension of this project or any other project in whole or part. Property owners may retain copies of the Drawings for information and reference in connection with the use and occupancy of the Property. Architectural Works Copyright Protection ACT of 1990.



FRONT ELEVATION

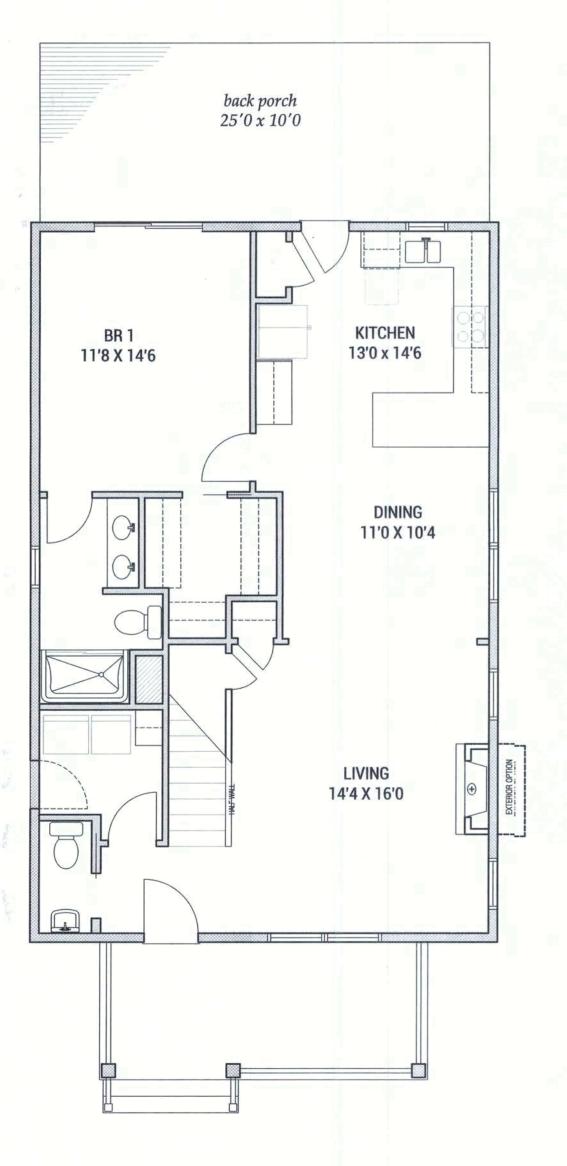

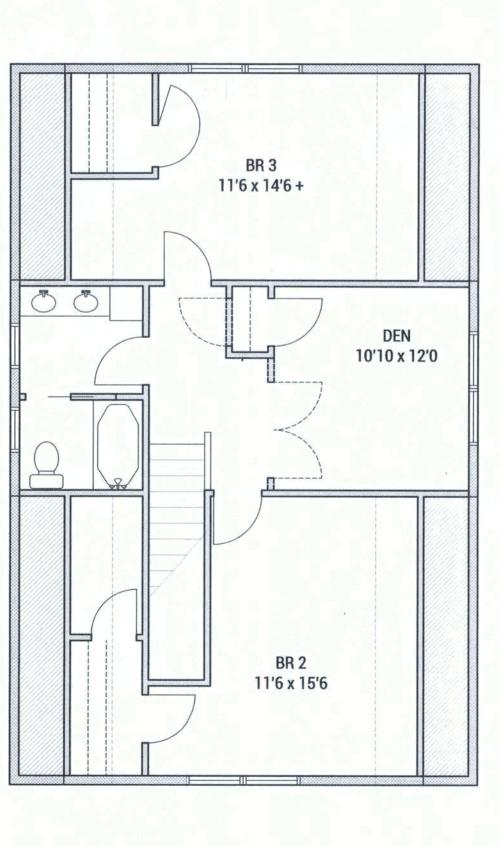

FLOOR PLANS 3/16" = 1'



# THE LEMOLO 4

## SHEET INDEX

- A0 Cover Sheet
- A1 Foundation Plan
- A2 Floor Plans
- A3 Building Section and Roof Plan
- A4 Elevations
- A5 Wall Section Typical & Porch Section
- E1 Electrical Layout

## SQUARE FOOTAGE

First Floor 1040 SF Second Floor 872 SF Total 1912 SF

177 SF Front Porch

BUILDING HEIGHT 26'- 0" AFF

BUILDING CODE 2018 International Residential Code R-3 Occupancy SEE SHEET SI+SZ

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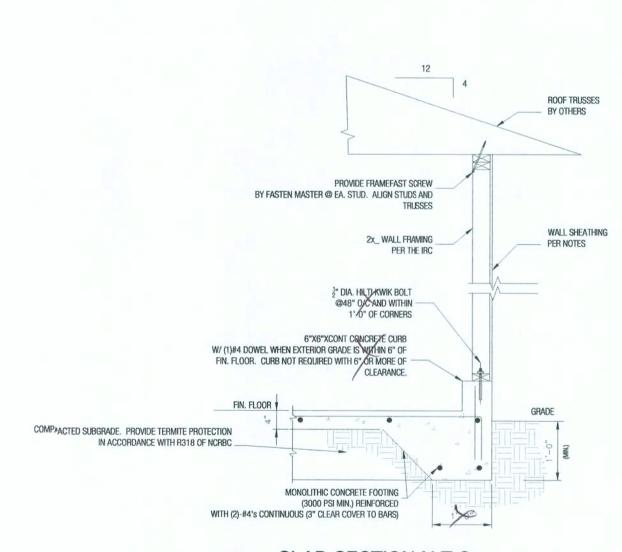
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experience of local and site specific conditions and codes

sheet no.


### MECHANICAL AND FOUNDATION NOTES

- A. LCCATE HVAC IN BASEMENT FOR MOST EFFICIENT USSE. AC UNIT, IF SPECIFIED, IS TO BE PLACED OUT OFF PUBLIC VIEW, I.E.. AT THE REAR OF THE HOUSE.
- B. PLACE FLOOR DRAIN NEAR MECHANICALS.
- C. ALL FOOTINGS SHALL REST ON VIRGIN, UNDISTURBED SOIL.
- D. ASSUMED SOIL SHALL BE SAND OR GRAVEL, WITH MINIMUM TRACES OF DRY CLAY, WITH A MINIMUM BEFARING CAPACITY OF 2000 LBS/SQ FT.
- E. UINLESS OTHERWISE NOTED, ALL SLABS ON GFRADE SHALL BE 4,000 P.S.I. (28 DAY CCOMPRESSIVE STRENGTH) CONCRETE ON 6" GFRAVEL FILL MINIMUM WITH 6X6 WII.4XWI.4WWM REINFORCING. INTERIOR SLABS SI-HALL BE PLACED ON CONCRETE RATED VAPOR BARRIER.
- F. PROVIDE I/2" EXPANSION JOINT MATERIAL BETWEEN ALL CONCRETE SLABS ON ABUTTING CONCRETE OF MASONRY WALLS OCCURRING IN EXTERIOR OR UNHEATED INTERIOR AREAS.
- G. PLACE 1/2" DIAMETER X 10" SILL PLATE ANCHOR BC)LTS AT EACH VERTICAL REBAR (WHERE OCCURRING) OR AT 4"-0" ON CENTER AND 12" FROM EACH CORNER MAXIMUM AND BOTH SIDES OFF OPENINGS.
- H. FO)OTING SIZES SHOWN ARE ONLY TYPICAL FOR STRATED SOIL PRESSURES AND CONTINENT COMPACTION; WHICHEVER IS MORE RESTRICTIVE.
- I. CCONTRACTOR TO VERIFY FOOTINGS DEPTHS WITH LOCAL FROST REQUIREMENTS OR EXISTING SOIL CCONDITIONS; WHICHEVER IS MORE RESTRICTIVE.
- J. PROVIDE TERMITE PROTECTION AS REQUIRED BY LO)CAL CODES.
- K. PROVIDE DEEP SCORE CONTROL JOINTS AT MID POINTS OF ALL GARAGES, BOTH DIRECTIONS MIN OR AS SHOWN IN PLAN IF DIFFERENT.
- L. MASONRY VENEER MUST BE ANCHORED TO BACK-UP CONSTRUCTION WITH GALVANIZED CORRUGATED METAL TIES SPACED 16" ON CENTER HORIZONTALLY AND 16" ON CENTER VERTICALLY.
- M. INSTALL CONTINUOUS APPROVED FLASHINGS AND CO)TTON CORD WEEPS AT 48" ON CENTER WITHIN FIRST EXPOSED COURSE ABOVE GRADE.
- N. FO)UNDATION DIMENSIONS ARE TAKEN FROM THE FA\(CE\) OF THE CONCRETE. INTERIOR DIMENSIONS ARE FROM FACE OF STUD TO FACE OF STUD. EXTERIOR DIMENSIONS ARE FROM THE OUTSIDE FA\(CE\) OF THE PLYWOOD SHEATHING.
- O. FINAL SUMP PUMP LOCATION TO BE CONFIRMED BY BUILDER.
- P. INCLUDED HOSE BIBS LOCATED BY HO)MEOWNER/SALESPERSON.



SLAB SECTION N.T.S.

SEE FOUNDATION PLAN ON SHEET
S-2 FOR FOOTER DETAIS AND LAYOUT

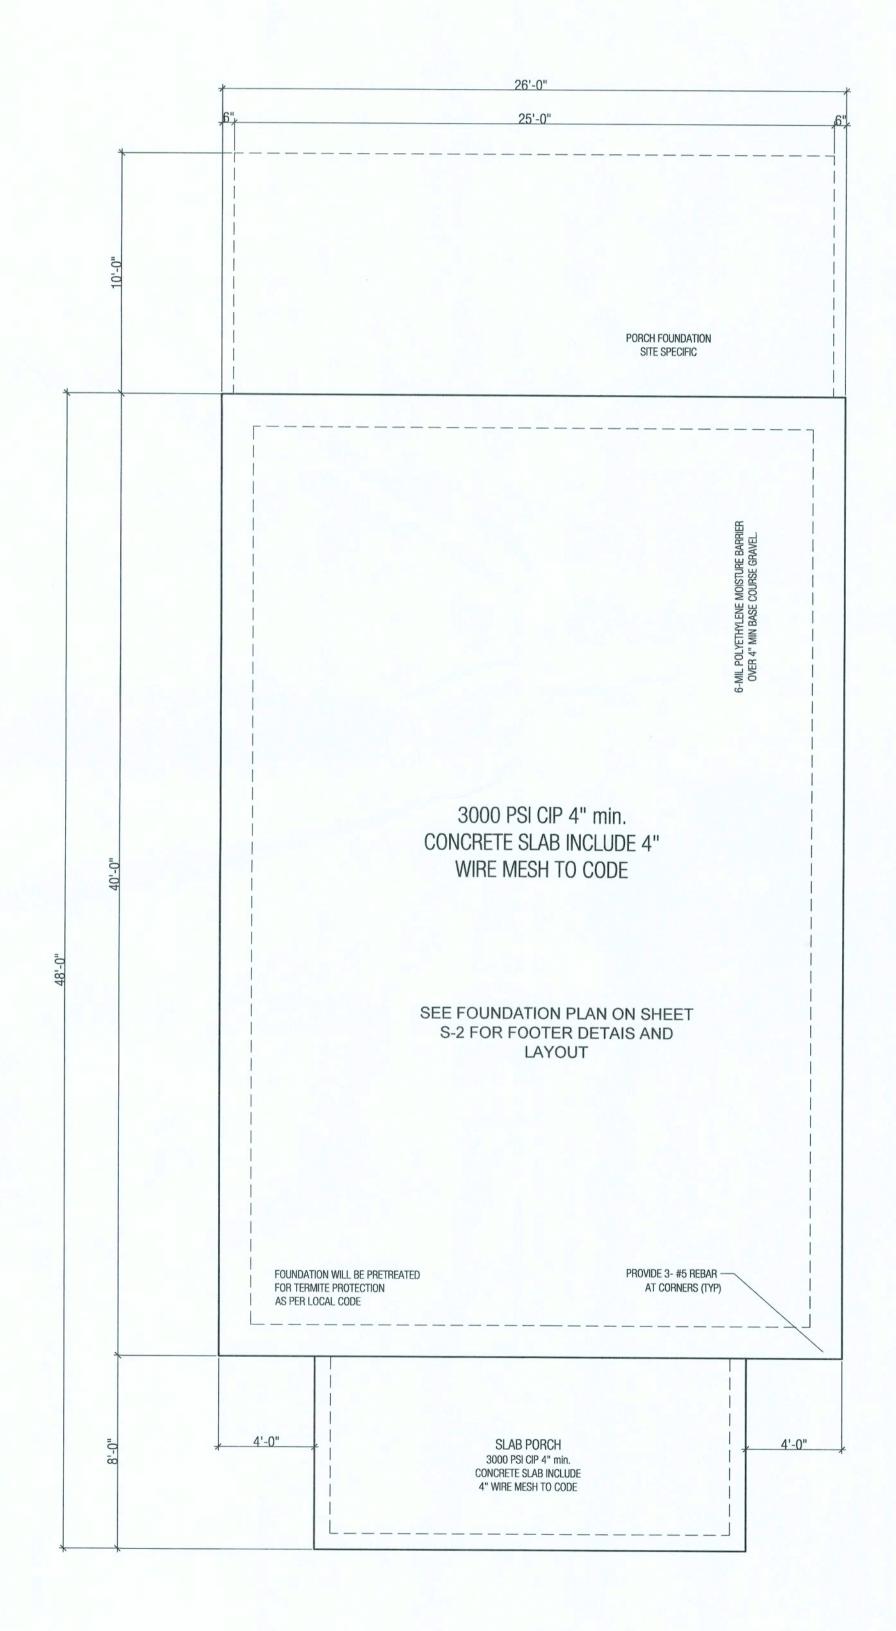

HOMEPATTERNS crafted s
30 Elm Place, Hastings on Hudson, NY 1
(864) 278 0068 INFO@HOMEPATTERNS

simplicity 10706 IS.COM

Revisions/Additions By Other late of Issue: 15 May 2019

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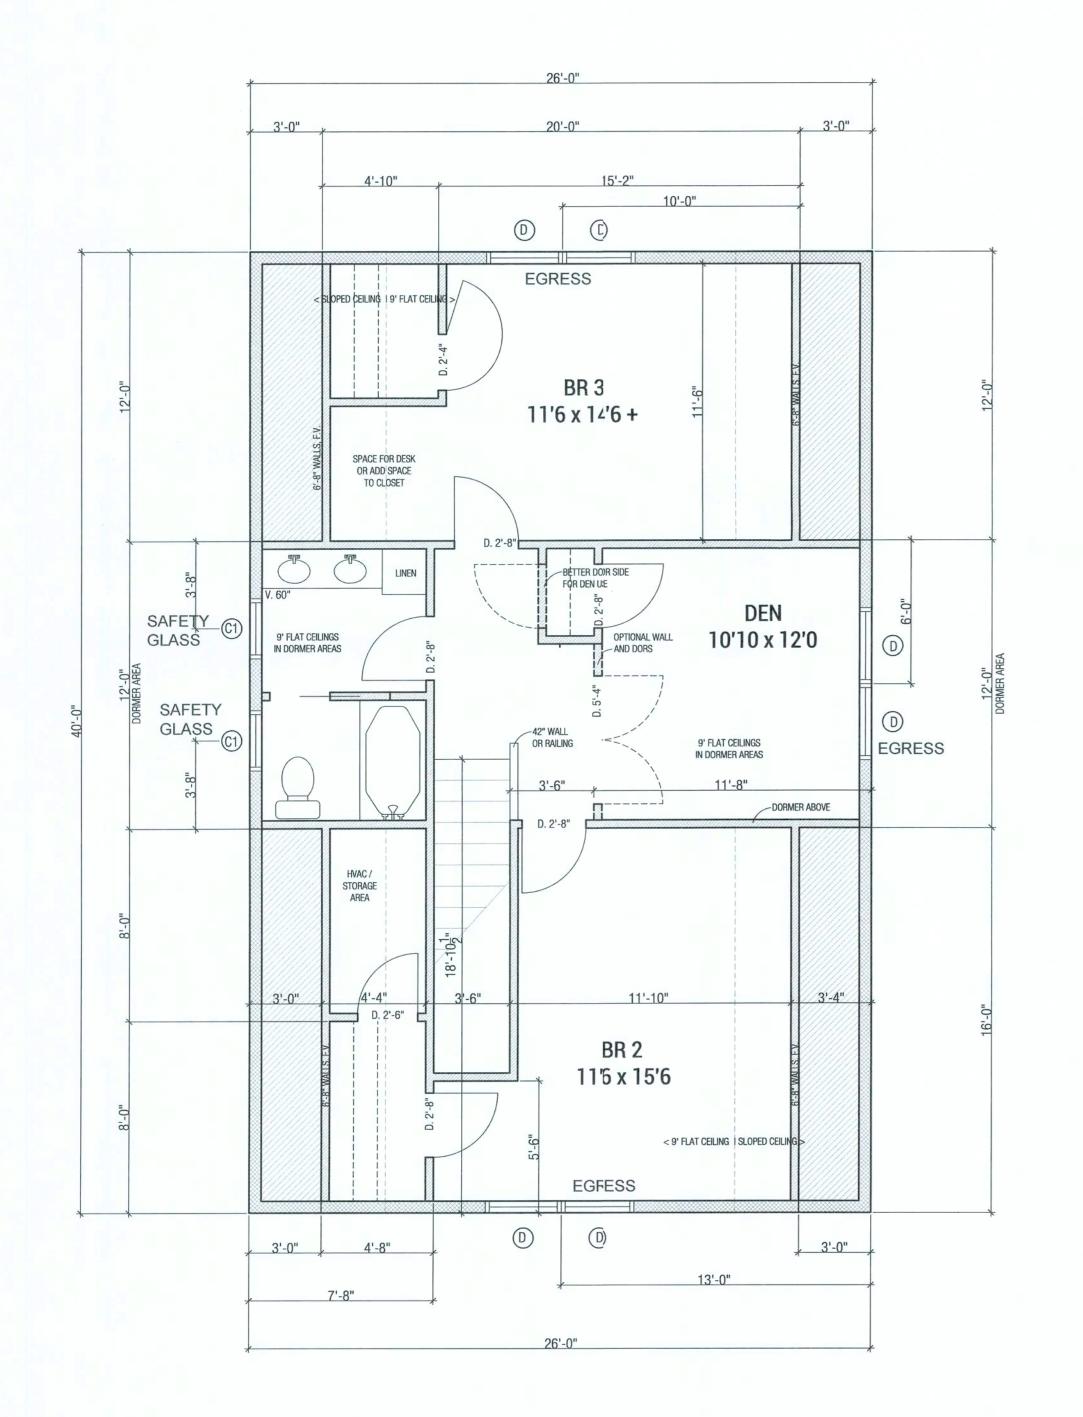
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sheet no.

A<sub>1</sub>

FOUNDATION PLAN

1/4"=1'-0"



### FLOOR PLAN NOTES

- A. INTERIOR DIMENSIONS ARE FROM FACE OF STUD TO FACE OF STUD, DIMENSIONS TAKEN TO EXTERIOR EDGE OF THE BUIL DING ARE MEASURED TO THE FACE OF SHEATHING.
- B. WINDOW SIZES INDICATED ON PLANS ARE NOTED BY ROUGH OPENING SIZES, REFER TO PLANS AND EXTERIOR ELEVATIONS FOR W/INDOW TYPES.
- C. DO NOT SCALE DRAWINGS, FOLLOW DIMENSIONS O'NLY.
- D. CONTRACTOR SHALL FIELD VERIFY ALL CABINET DIMIENSIONS BEFORE
- E. ALL BATH AND TOILET AREA WALLS AND CEILINGS SHALL HAVE WATER RESISTANT GYPSUM BOARD.
- F. ALL INTERIOR WALLS SHALL BE COVERED WITH 1/2" (GYPSUM BOARD AND METAL CORNER REINFORCING. USE 5/8" GYPSUM BOJARD ON CEILINGS.
- G. HANDRAILS SHALL BE MOUNTED 32"-34" ABOVE NOISING OF STAIRS. GUARDRAILS SHALL BE MOUNTED AT 36"
- H. PROVIDE ACCESS TO ALL CONCEALED ATTIC SPACES.

ALL EXTERIOR WALLS ARE 2x6 CONSTRUCTION

WINDOW SCHEDUL,E


24 x 24 Fixed

30 x 24 Awning

36 x 64 Double Hung

24 x 42 Double Hung

24 x 48 Double Hung

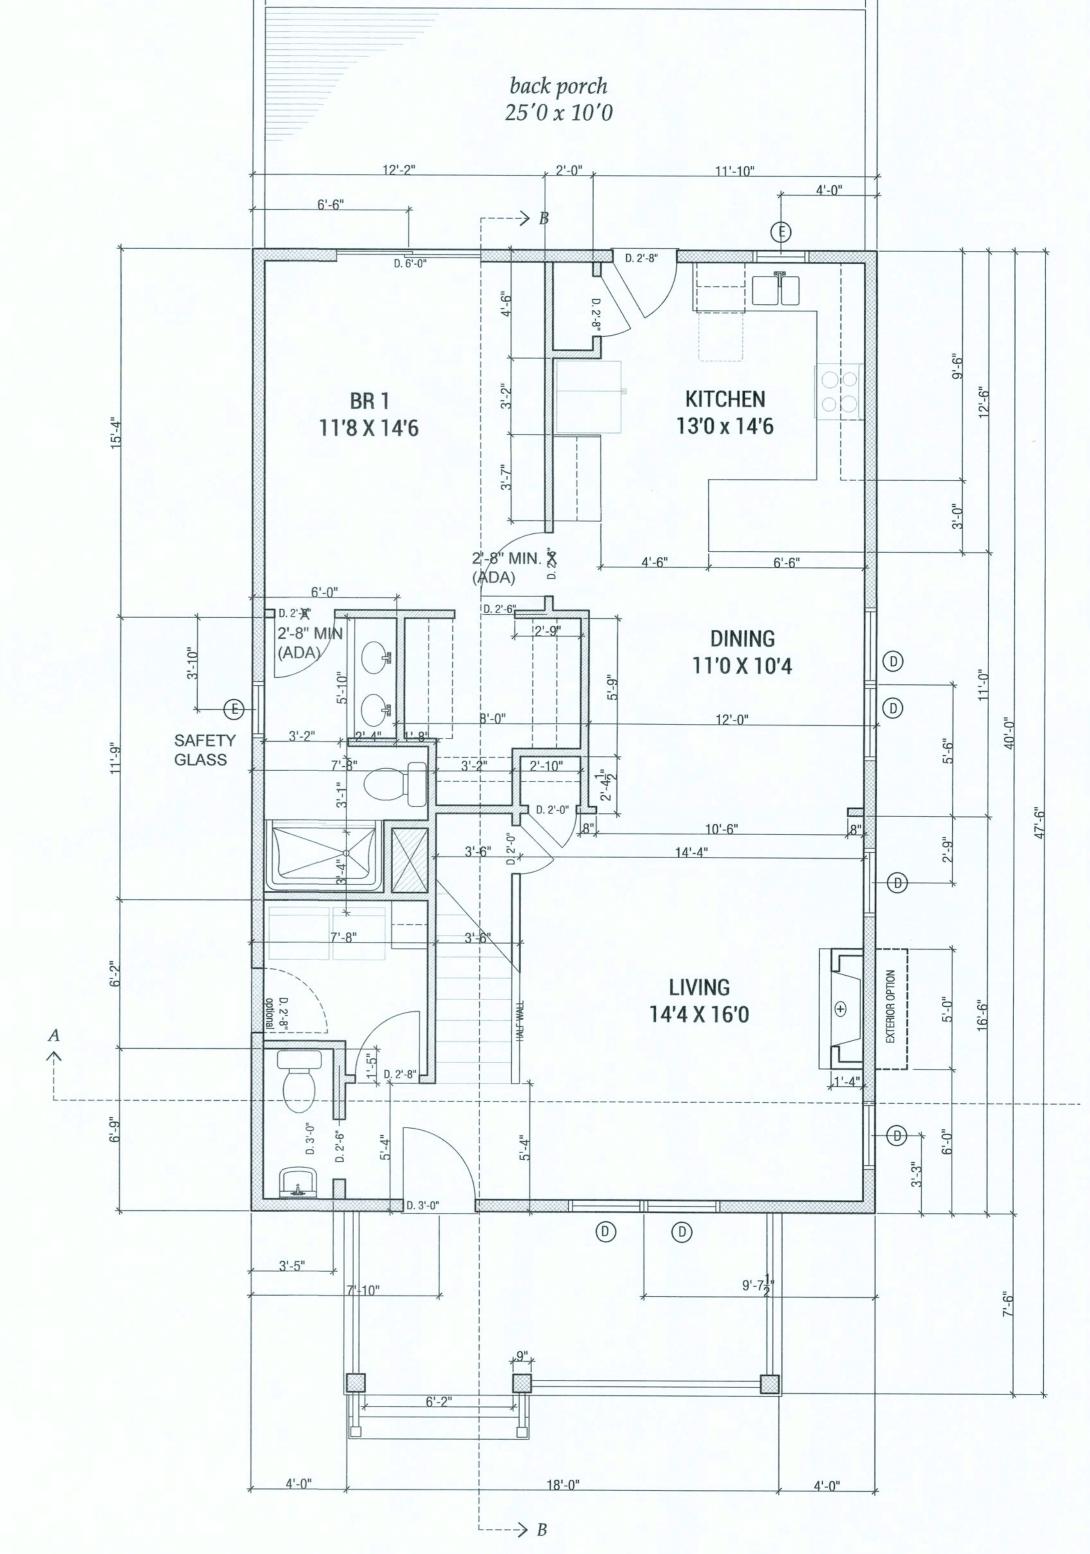

26'-0"

SECOND FLOOR PLAN

1/4"=1'-0"

FIRST FLOOR PLAN

1/4"=1'-0"

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Other By dditions Revisions/A

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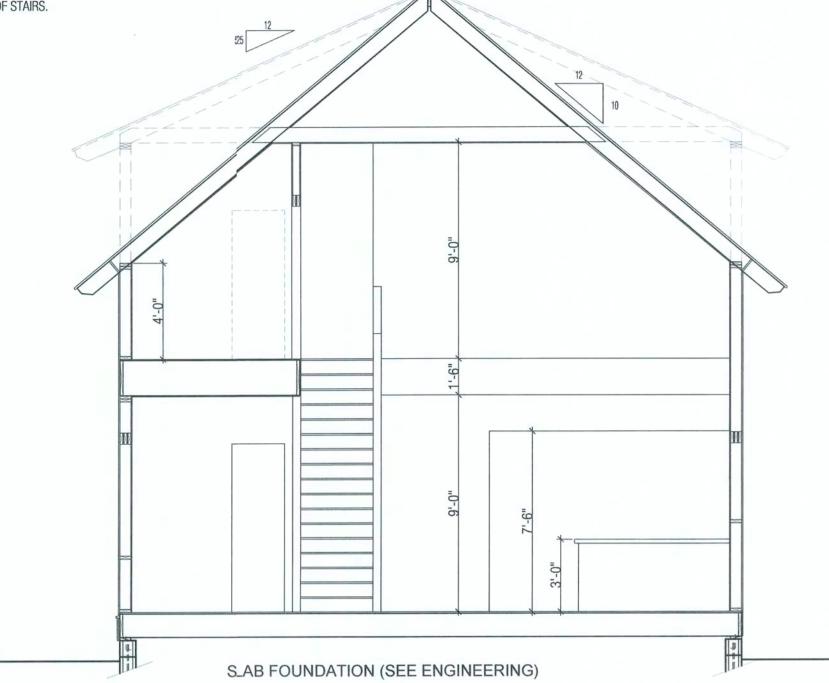
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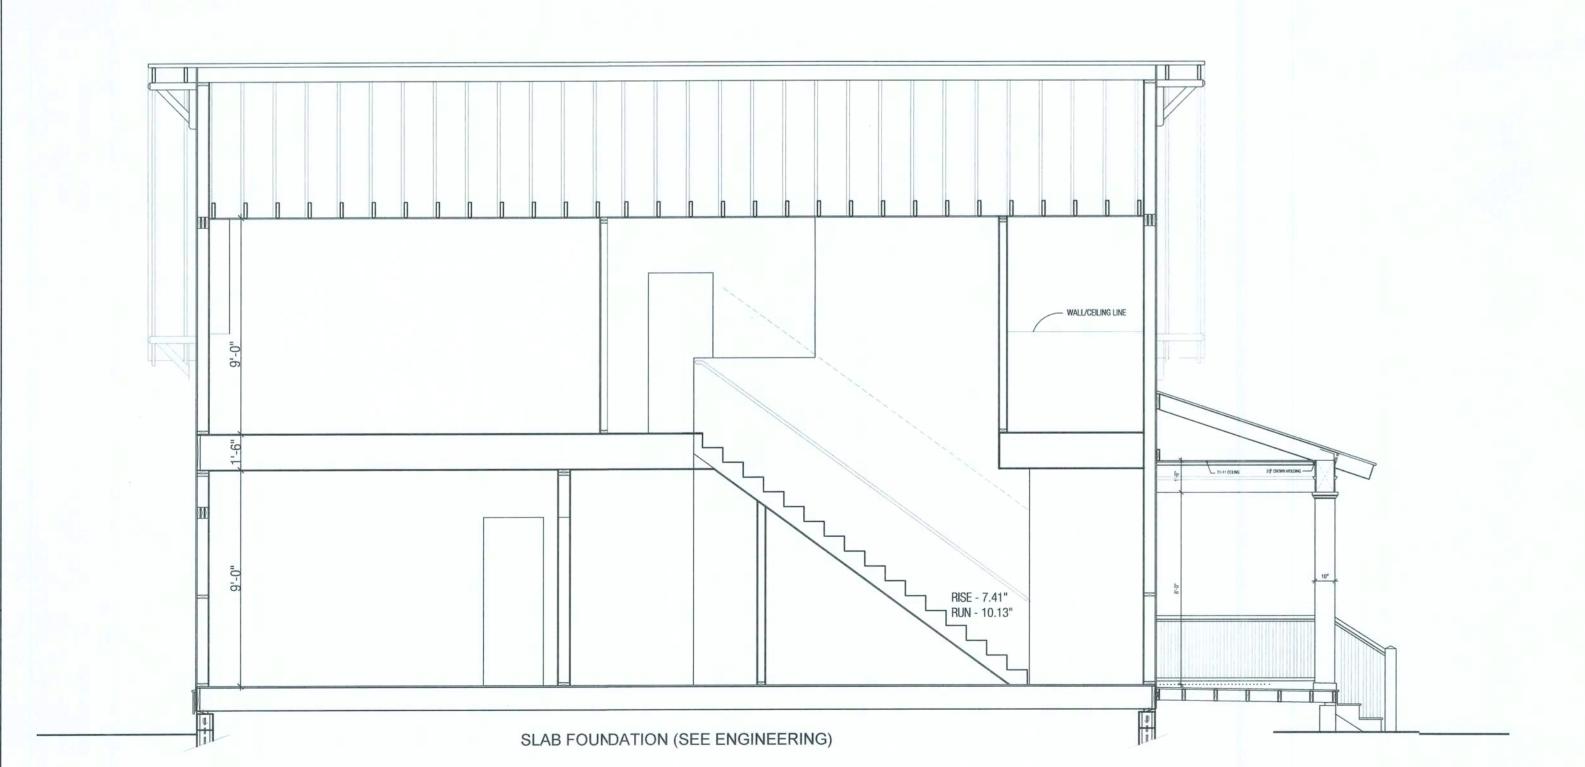
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sheet no.

### SECTION NOTES

- A. PROVIDE INSULATION BAFFLES AT EAVE VENTS BETWEEN RAFTERS / TRUSSES.
- B. RIDGES, VALLEY AND HIP MEMBERS SHALL BE FULL VERTICAL DEPTH OF FRAMING MEMBERS.
- C. PROVIDE 2x6 COLLAR TIES AT 48" O.C. (UNLESS ROOF IS TRUSSED).
- D. PROVIDE CONTINUOUS 2x6 PURLINS AT MID-SPAN OF RAFTERS, SPACE AT 8'-6" MAX. (UNLESS ROOF IS TRUSSED)
- E. PROVIDE 2x4 STRUTS AT 48" O.C. FROM PURLINS TO BEARING WALLS AT 45° MINIMUM ANGLE. (UNLESS ROOF IS TRUSSED)
- F. HANDRAILS SHALL BE MOUNTED 32"-34" ABOVE NOSING OF STAIRS. GUARDRAILS SHALL BE MOUNTED AT 36".






**BUILDING SECTION** 

1/4"=1'-0"

### ROOFING, FLASHING, AND GUTTER NOTES

- A. GUTTERS TO BE INSTALLED CONTINUOUS AT ALL EAVES. GUTTERS AND DOWNSPOUTS TO BE PREFORMED 5" OGEE STYLE, CONSTRUCTED OF ALUMINUM AND INSTALLED PREFINISHED ON A BRACK HANGER SYSTEM. NO DOWNSPOUTS TO FOUNDATION DRAINS.
- B. ALL METAL PREFORMED FLASHING TO BE INSTALLED WITH 1/2" HEMMED EDGES.
- C. WATERPROOFING SHINGLE UNDERLAYMENT: INSTALL CERTAINTEED WINTERGAURD AT ALL ROOF EAVES (LESS THAN 4:12) AND ROOF PENETRATIONS. WINTERGAURD TO BE INSTALLED BEHIND ALL STEP FLASHING, SIDE WALL FLASHING, LEVEL WALL FLASHING, AND VALLEY FLASHING PER MANUFACTURES SPECIFICATIONS.
- D. EAVE FLASHING: INSTALL CONTINUOUS DRIP EDGE FLASHING AT ALL EAVES, EXTEND FROM OUTSIDE EDGE OF EXTERIOR HEATED WALL 48" OVER HEATED SPACE, FELT TO LAP OVER DRIP EDGE. ALL DRIP EDGE TO LAP FASCIA BOARD AND GUTTER IF APPLICABLE.
- E. RAKE FLASHING: INSTALL CONTINUOUS DRIP EDGE FLASH OVER SHINGLES AT ALL ROOF EAVES. RAKE FLASHING TO LAP BARGE AND SHADOW BOARDS.
- F. LEVEL WALL FLUSHING: INSTALL LEVEL WALL FLASHING OVER SHINGLES. EXTEND PREFORMED METAL FLASHING 5 INCHES UP VERTICAL WALL AND 5 INCHES ONTO ROOF, ALL EDGES TO BE HEMMED.
- G. VALLEY FLASHING: INSTALL VALLEY FLASHING OVER "WINTERGAURD". INSTALL CONTINUOUS PREFORMED METAL VALLEY FLASHING CRIMPED 1" AT CENTER. ROOFING TO OVERLAP SHINGLES MINIMUM 5" EACH SIDE. MAINTAIN 5" CLEAR BETWEEN ROOFING EDGES. ALL FLASHING EDGES TO BE HEMMED.
- H. STEP/SIDE WALL FLASHING: INSTALL CERTAINTEED "WINTERGAURD" WHERE VERTICAL WALLS MEET ROOF, LAP CERTAINTEED "WG" 12 INCHES UP WALL AND 12 INCHES ON TO ROOF. INSTALL STEP FLASHING AND COMPOSITION ROOFING OVER "WG". ALL STEP FLASHING TO EXTEND 4 INCHES UP WALL AND 4 INCHES ON TO ROOF. WEAVE STEP FLASHING IN WITH COMPOSITION ROOFING. STEP FLASHING MUST LAP A MINIMUM OF 2" AT SIDEWALLS. MAINTAIN MINIMUM 2 INCHES FROM BOTTOM OF VERTICAL SISING TO ROOF
- I. ROOF FELT: INSTALL 15 LB FELT OVER SHEATHING. ON SLOPES OF LESS 3:12 OR LESS, USE TWO LAYERS. LAP ALL HORIZONTAL AND VERTICAL SEAMS 6 INCHES MINIMUM IN SHINGLE FASHION.
- J. ROOFING: INSTALL 30 YEAR COMP. ROOFING PER MANUFACTURERS RECOMMENDATIONS.

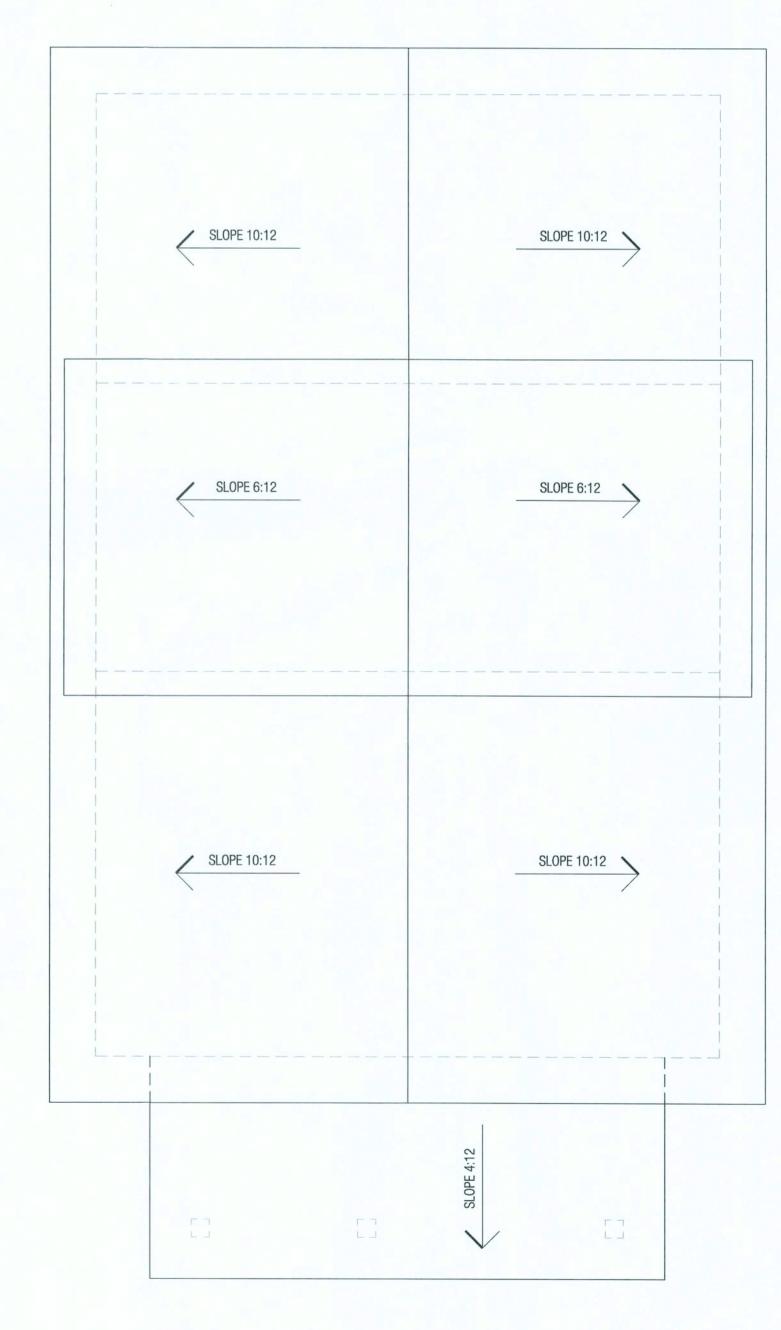

**ROOF PLAN** 

1/4"=1'-0"

simplicity crafted on HO 0 0 0 0 E (4

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Revisions/

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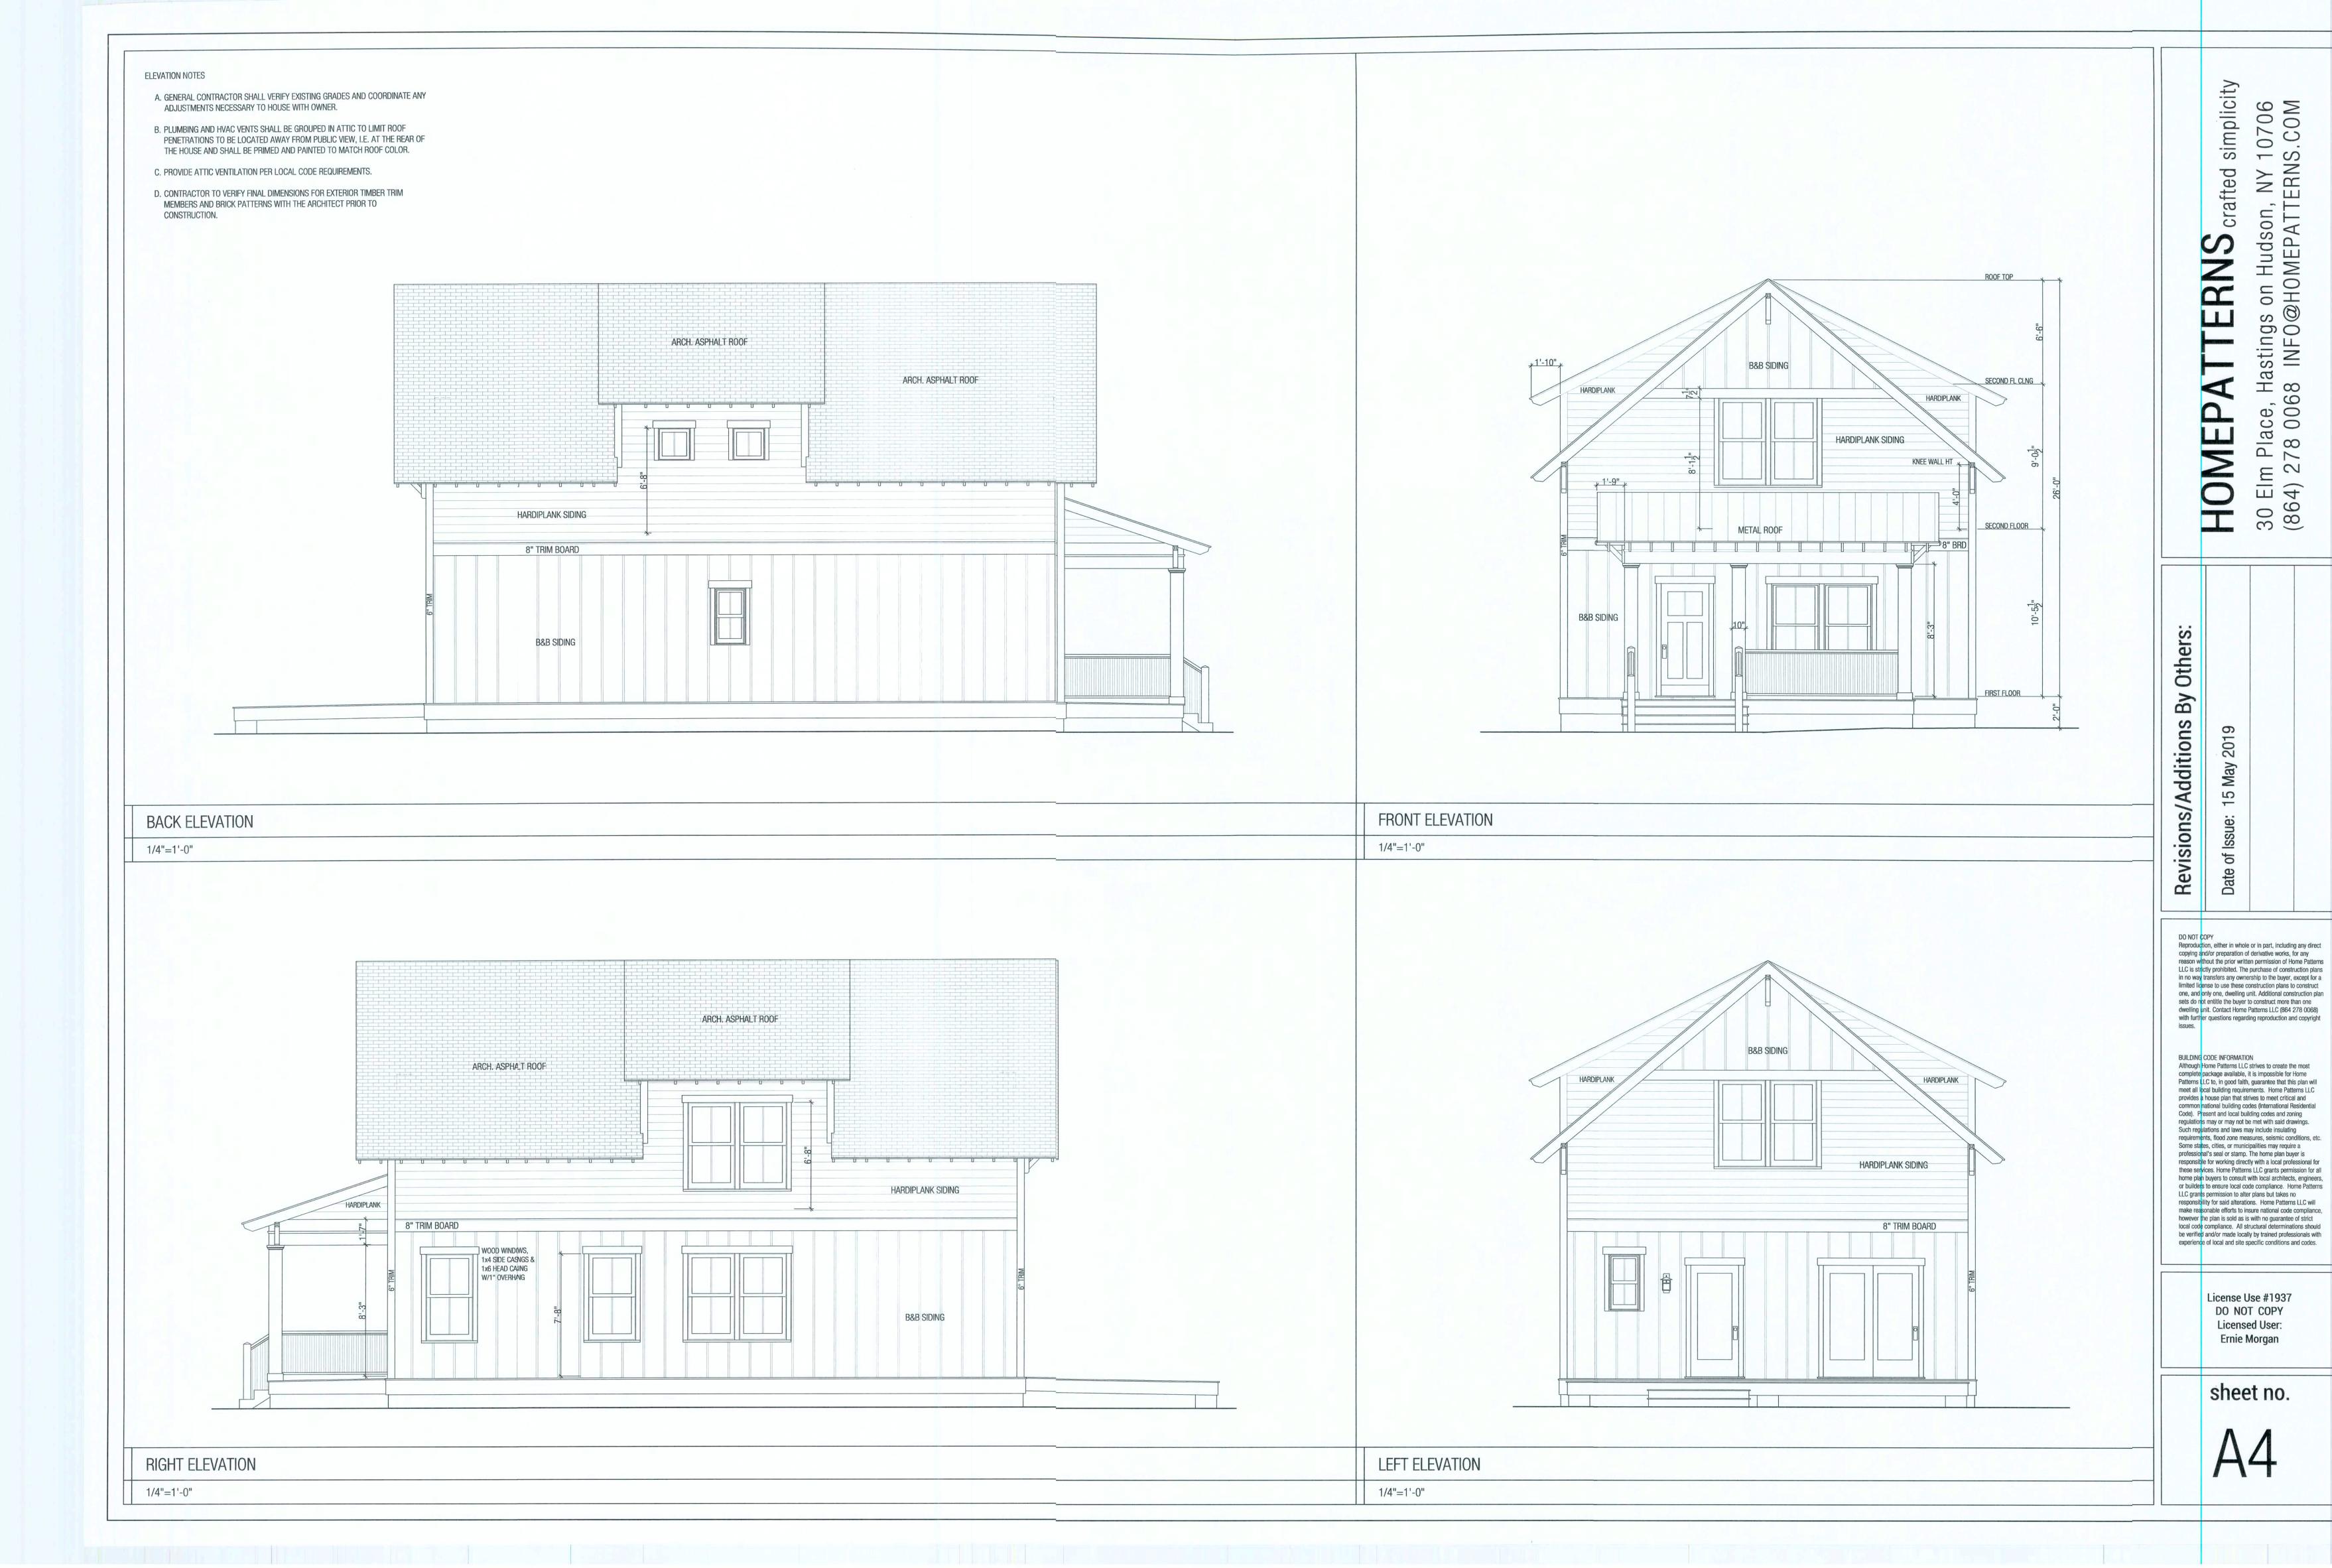
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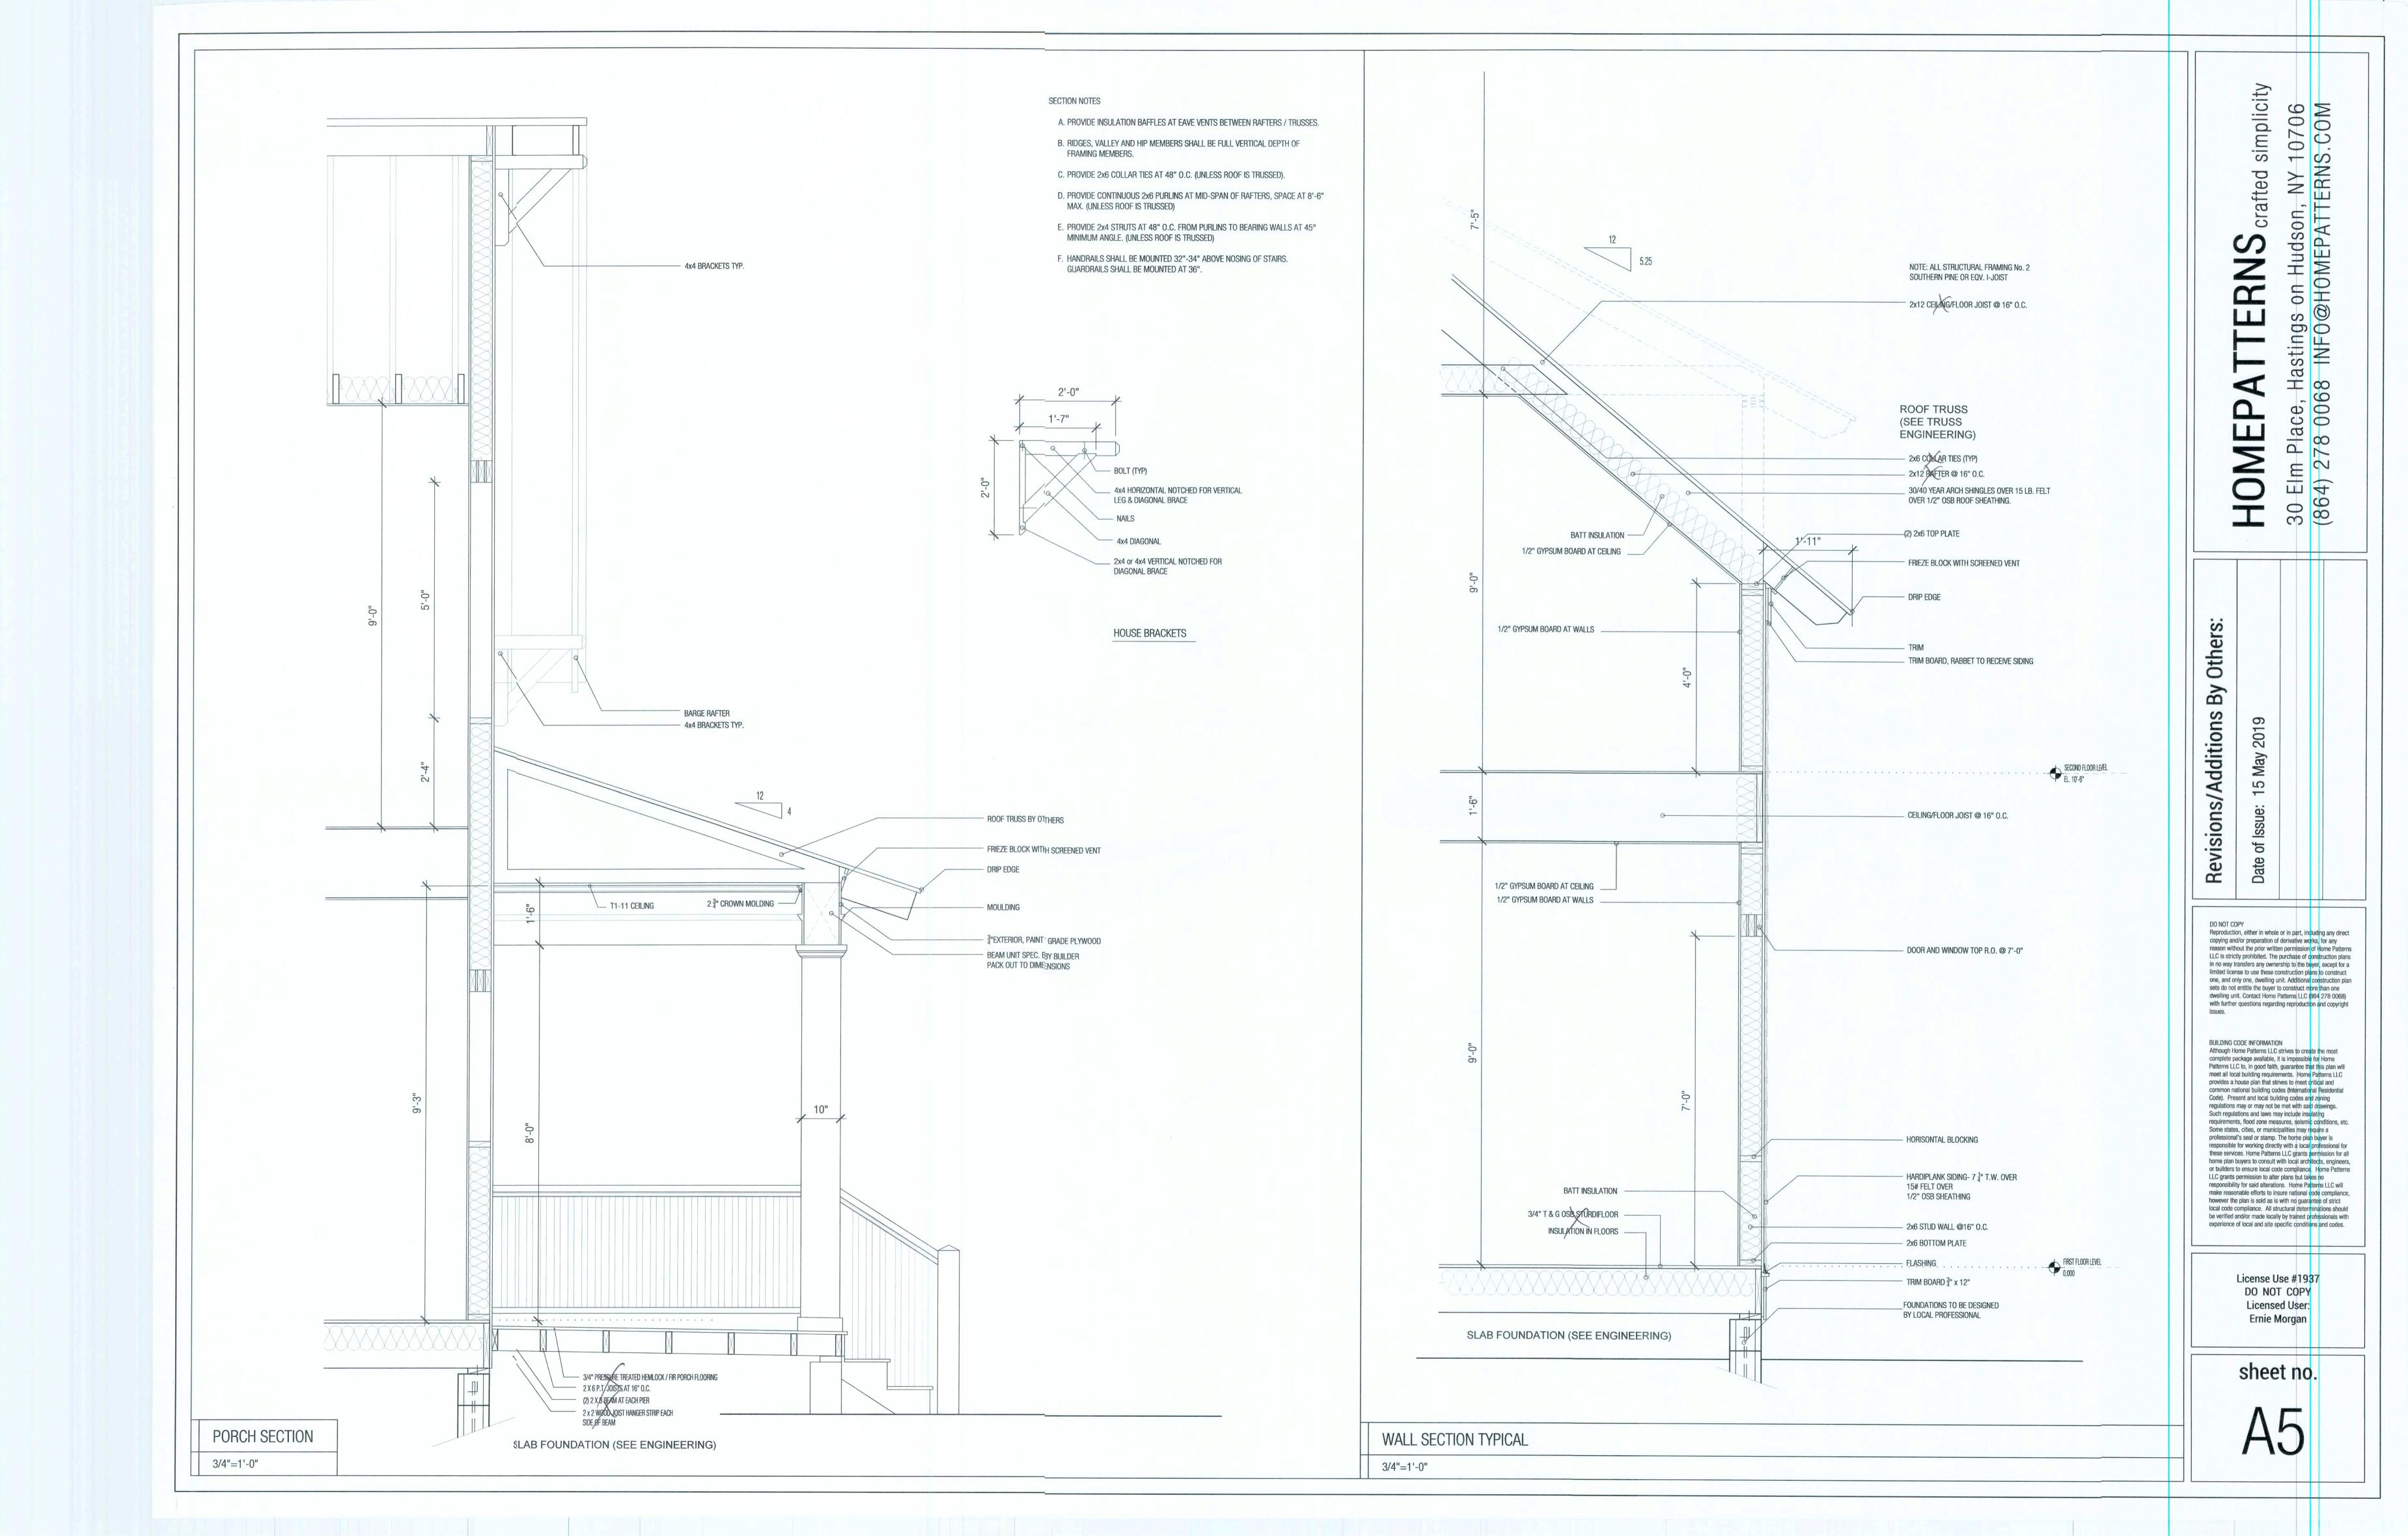
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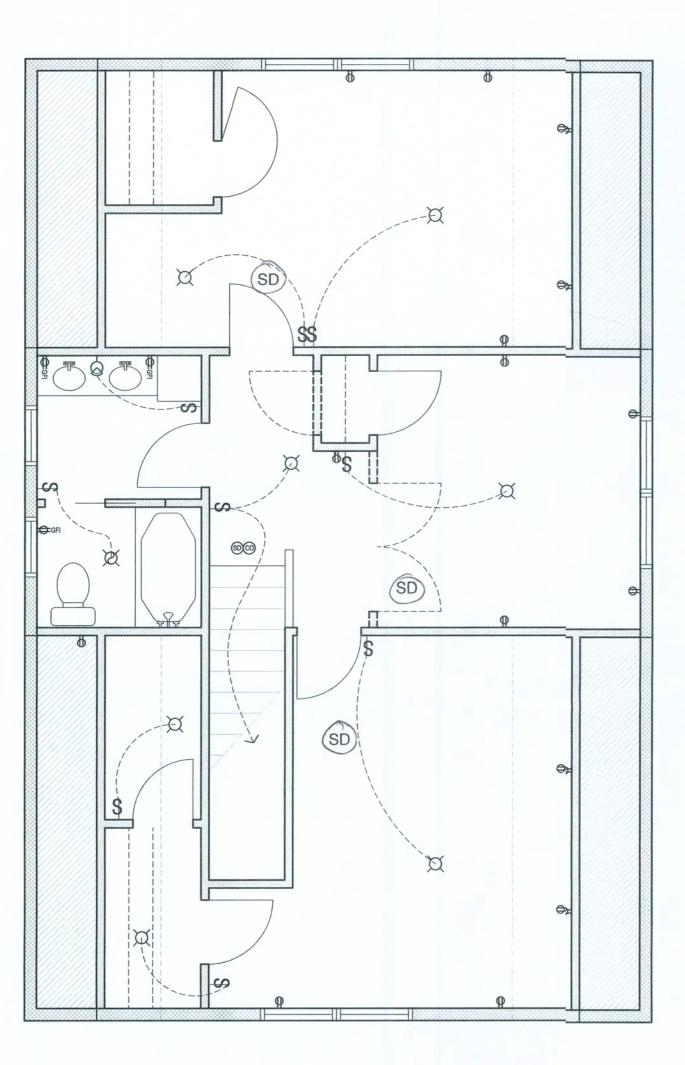
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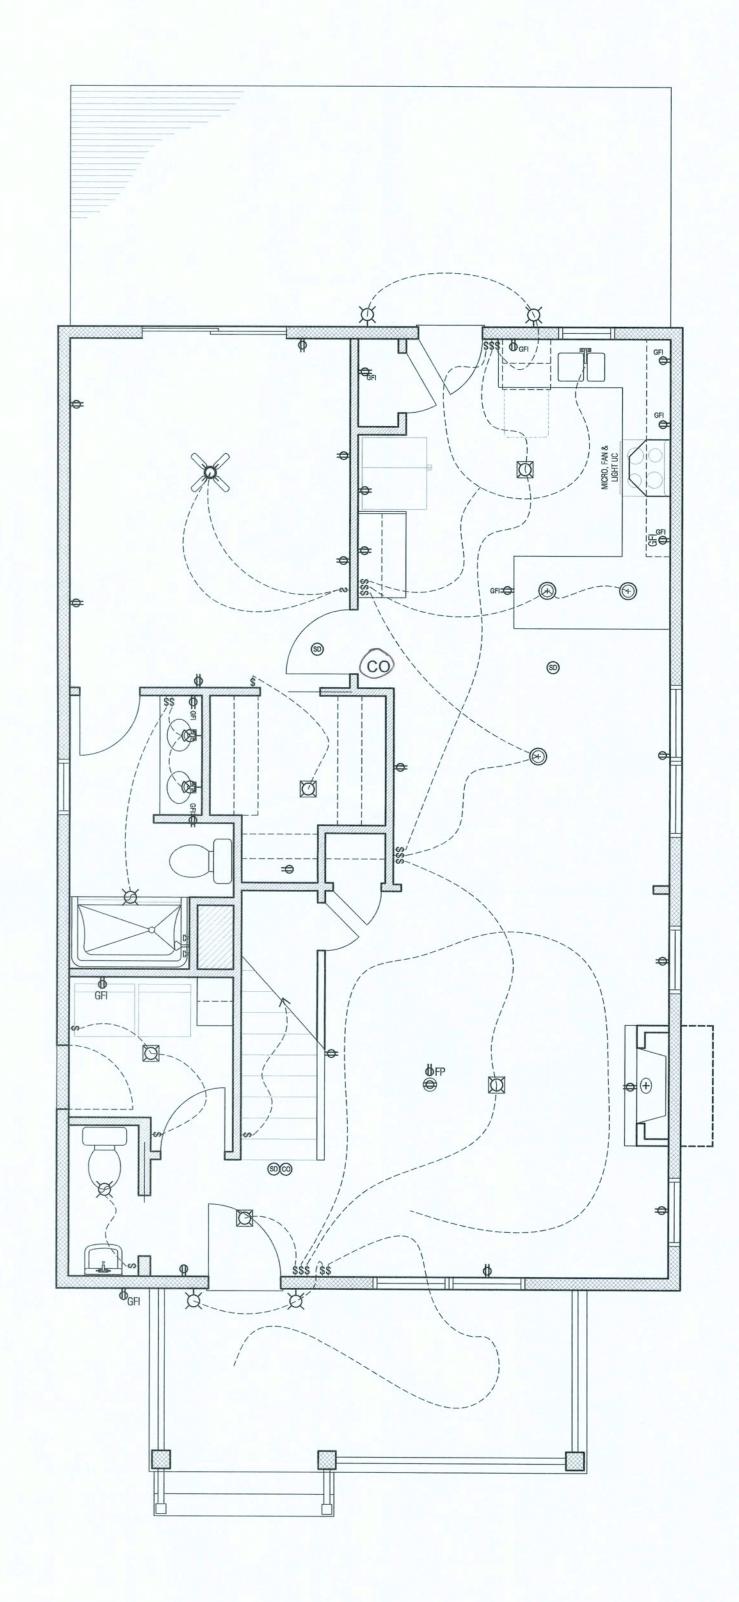


### **ELECTRICAL NOTES**

- A. ELECTRICAL WORK SHALL CONFORM TO THE NATIONAL ELECTRIC CODE AND ANY APPLICABLE LOCAL COIES.
- B. PROVIDE HARDWIRED SMOKE DETECTORS, NATURAL GAS DETECTOR, AND CARBON MONOXIDE MONITORING WITH BATTERY BACKUP, ON ALL FLOORS AND IN EACH BEDROOM, VERIFY WITH LOCAL CODE REQUIREMENTS AND SECURITY SYSTEM CONTRACTOR IF APPLICABLE.
- C. PROVIDE GROUND FAULT PROTECTION PER CODE AND ON ALL KITCHEN, BATH AND GARAGE OUTLETS.
- D. PREWIRE FOR GARAGE DOOR OPENERS.
- E. PROVIDE OUTLET ABOVE RANGE FOR MICROWAVE OR HOOD VENT IF FINAL KITCHEN LAYOUT REQUIRES.
- F. SYMBOLS WITH AN E ARE TO BE READ AS EXISTING.
- G. INCLUDED CABLE OUTLETS, PHONE JACKS, 220 OUTLETS FOR RANGE AND/OR DRYER LOCATED BY HOME(WNER/SALESPERSON.
- H. INCLUDED GAS LINE TO RANGE, DRYER AND/OR FIREPLACE LOCATED BY HOMEOWNER/SALESPERSON.









astings on Hudson, INFO@HOMEPATT

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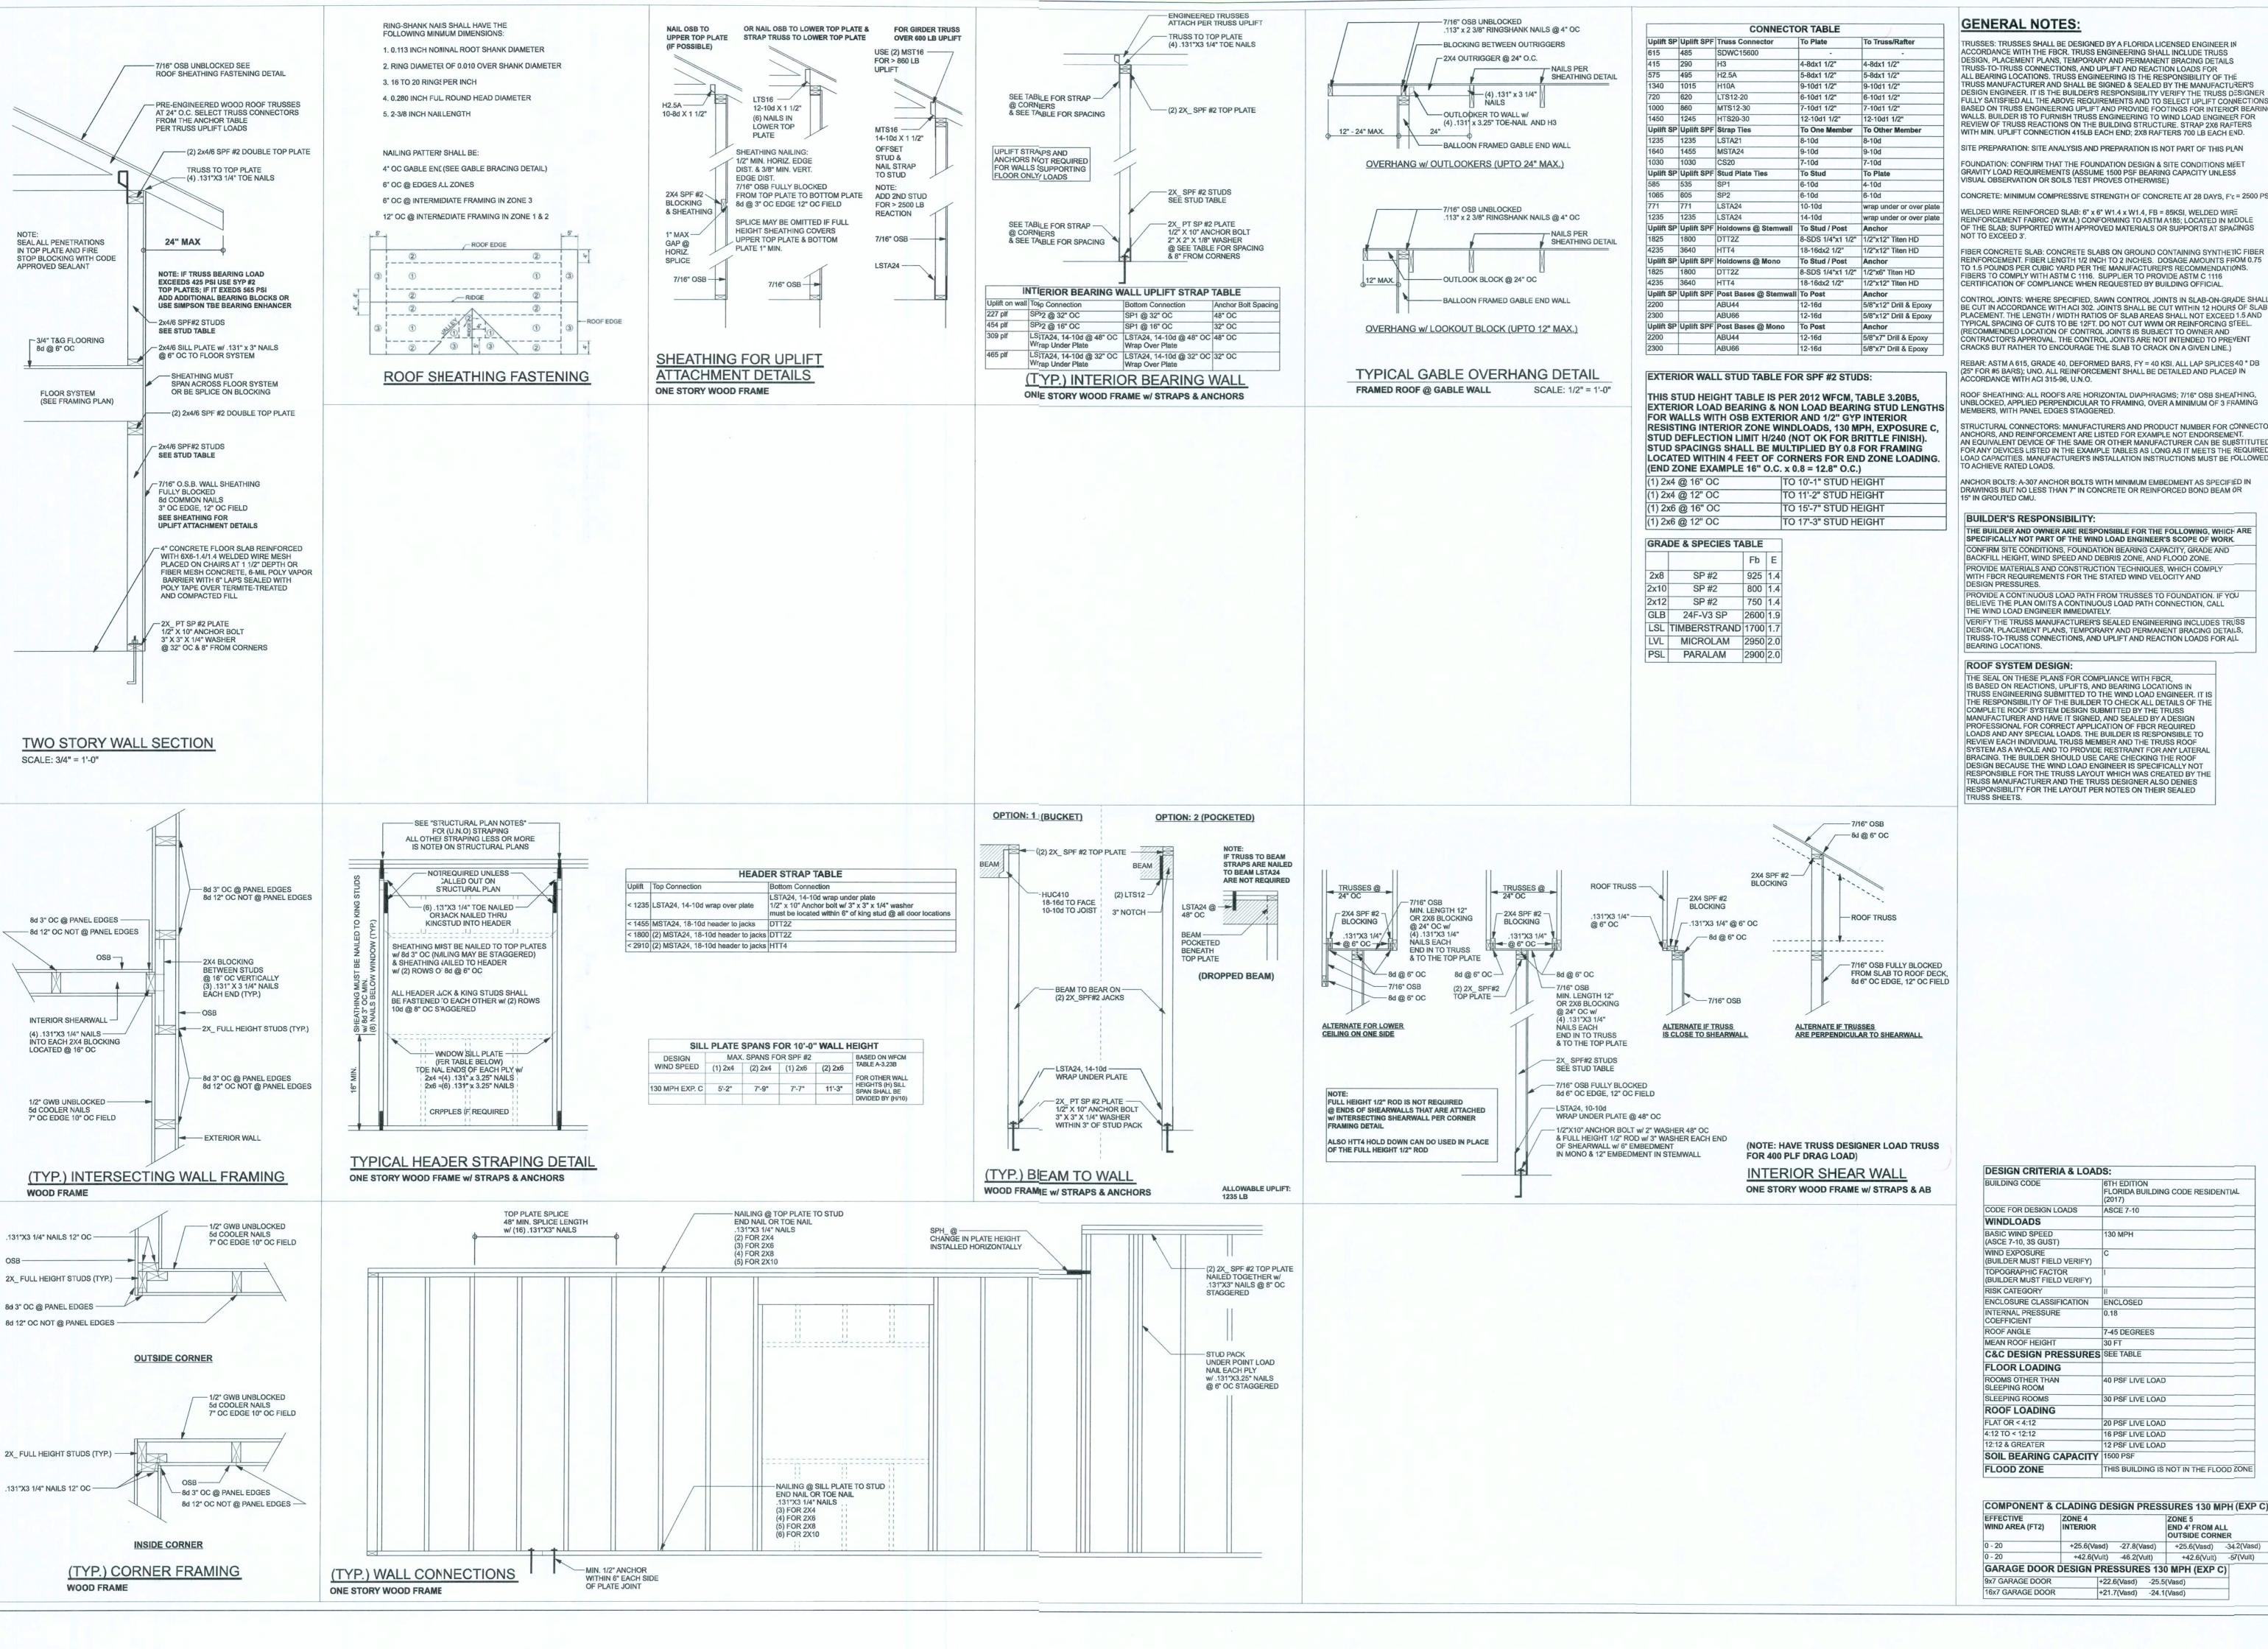
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ELECTRICITY LAYOUT - SECOND FLOOR

1/4"=1'-0"

ELECTRICITY LAYOUT - FIRST FLOOR

1/4"=1'-0"



**GENERAL NOTES:** 

TRUSSES: TRUSSES SHALL BE DESIGNED BY A FLORIDA LICENSED ENGINEER IN ACCORDANCE WITH THE FBCR. TRUSS ENGINEERING SHALL INCLUDE TRUSS DESIGN, PLACEMENT PLANS, TEMPORARY AND PERMANENT BRACING DETAILS TRUSS-TO-TRUSS CONNECTIONS, AND UPLIFT AND REACTION LOADS FOR ALL BEARING LOCATIONS. TRUSS ENGINEERING IS THE RESPONSIBILITY OF THE TRUSS MANUFACTURER AND SHALL BE SIGNED & SEALED BY THE MANUFACTURER'S DESIGN ENGINEER. IT IS THE BUILDER'S RESPONSIBILITY VERIFY THE TRUSS DESIGNER FULLY SATISFIED ALL THE ABOVE REQUIREMENTS AND TO SELECT UPLIFT CONNECTIONS ASED ON TRUSS ENGINEERING UPLIFT AND PROVIDE FOOTINGS FOR INTERIOR BEARING WALLS. BUILDER IS TO FURNISH TRUSS ENGINEERING TO WIND LOAD ENGINEER FOR REVIEW OF TRUSS REACTIONS ON THE BUILDING STRUCTURE, STRAP 2X6 RAFTERS WITH MIN. UPLIFT CONNECTION 415LB EACH END; 2X8 RAFTERS 700 LB EACH END.

SITE PREPARATION: SITE ANALYSIS AND PREPARATION IS NOT PART OF THIS PLAN FOUNDATION: CONFIRM THAT THE FOUNDATION DESIGN & SITE CONDITIONS MEET

CONCRETE: MINIMUM COMPRESSIVE STRENGTH OF CONCRETE AT 28 DAYS, F'c = 2500 PSI. WELDED WIRE REINFORCED SLAB: 6" x 6" W1.4 x W1.4, FB = 85KSI, WELDED WIRE REINFORCEMENT FABRIC (W.W.M.) CONFORMING TO ASTM A185; LOCATED IN MIDDLE OF THE SLAB; SUPPORTED WITH APPROVED MATERIALS OR SUPPORTS AT SPACINGS

FIBER CONCRETE SLAB: CONCRETE SLABS ON GROUND CONTAINING SYNTHETIC FIBER REINFORCEMENT, FIBER LENGTH 1/2 INCH TO 2 INCHES. DOSAGE AMOUNTS FROM 0.75 TO 1.5 POUNDS PER CUBIC YARD PER THE MANUFACTURER'S RECOMMENDATIONS. IBERS TO COMPLY WITH ASTM C 1116. SUPPLIER TO PROVIDE ASTM C 1116 CERTIFICATION OF COMPLIANCE WHEN REQUESTED BY BUILDING OFFICIAL

CONTROL JOINTS: WHERE SPECIFIED, SAWN CONTROL JOINTS IN SLAB-ON-GRADE SHALL BE CUT IN ACCORDANCE WITH ACI 302. JOINTS SHALL BE CUT WITHIN 12 HOURS OF SLAB PLACEMENT. THE LENGTH / WIDTH RATIOS OF SLAB AREAS SHALL NOT EXCEED 1.5 AND TYPICAL SPACING OF CUTS TO BE 12FT. DO NOT CUT WWM OR REINFORCING STEEL. (RECOMMENDED LOCATION OF CONTROL JOINTS IS SUBJECT TO OWNER AND CONTRACTOR'S APPROVAL. THE CONTROL JOINTS ARE NOT INTENDED TO PREVENT

REBAR: ASTM A 615. GRADE 40. DEFORMED BARS, FY = 40 KSI, ALL LAP SPLICES 40 \* DB (25" FOR #5 BARS); UNO. ALL REINFORCEMENT SHALL BE DETAILED AND PLACED IN ACCORDANCE WITH ACI 315-96, U.N.O.

ROOF SHEATHING: ALL ROOFS ARE HORIZONTAL DIAPHRAGMS: 7/16" OSB SHEATHING, UNBLOCKED, APPLIED PERPENDICULAR TO FRAMING, OVER A MINIMUM OF 3 FRAMING MEMBERS, WITH PANEL EDGES STAGGERED.

STRUCTURAL CONNECTORS: MANUFACTURERS AND PRODUCT NUMBER FOR CONNECTORS, ANCHORS, AND REINFORCEMENT ARE LISTED FOR EXAMPLE NOT ENDORSEMENT.
AN EQUIVALENT DEVICE OF THE SAME OR OTHER MANUFACTURER CAN BE SUBSTITUTED FOR ANY DEVICES LISTED IN THE EXAMPLE TABLES AS LONG AS IT MEETS THE REQUIRED DAD CAPACITIES. MANUFACTURER'S INSTALLATION INSTRUCTIONS MUST BE FOLLOWED TO ACHIEVE RATED LOADS.

DRAWINGS BUT NO LESS THAN 7" IN CONCRETE OR REINFORCED BOND BEAM OR

### **BUILDER'S RESPONSIBILITY:**

THE BUILDER AND OWNER ARE RESPONSIBLE FOR THE FOLLOWING, WHICH ARE SPECIFICALLY NOT PART OF THE WIND LOAD ENGINEER'S SCOPE OF WORK. CONFIRM SITE CONDITIONS, FOUNDATION BEARING CAPACITY, GRADE AND BACKFILL HEIGHT, WIND SPEED AND DEBRIS ZONE, AND FLOOD ZONE. PROVIDE MATERIALS AND CONSTRUCTION TECHNIQUES, WHICH COMPLY WITH FBCR REQUIREMENTS FOR THE STATED WIND VELOCITY AND

PROVIDE A CONTINUOUS LOAD PATH FROM TRUSSES TO FOUNDATION. IF YOU BELIEVE THE PLAN OMITS A CONTINUOUS LOAD PATH CONNECTION, CALL THE WIND LOAD ENGINEER IMMEDIATELY. VERIFY THE TRUSS MANUFACTURER'S SEALED ENGINEERING INCLUDES TRUSS

DESIGN, PLACEMENT PLANS, TEMPORARY AND PERMANENT BRACING DETAILS, TRUSS-TO-TRUSS CONNECTIONS, AND UPLIFT AND REACTION LOADS FOR ALL

### ROOF SYSTEM DESIGN:

THE SEAL ON THESE PLANS FOR COMPLIANCE WITH FBCR. S BASED ON REACTIONS, UPLIFTS, AND BEARING LOCATIONS IN THE RESPONSIBILITY OF THE BUILDER TO CHECK ALL DETAILS OF THE COMPLETE ROOF SYSTEM DESIGN SUBMITTED BY THE TRUSS MANUFACTURER AND HAVE IT SIGNED, AND SEALED BY A DESIGN PROFESSIONAL FOR CORRECT APPLICATION OF FBCR REQUIRED LOADS AND ANY SPECIAL LOADS. THE BUILDER IS RESPONSIBLE TO REVIEW EACH INDIVIDUAL TRUSS MEMBER AND THE TRUSS ROOF SYSTEM AS A WHOLE AND TO PROVIDE RESTRAINT FOR ANY LATERAL BRACING. THE BUILDER SHOULD USE CARE CHECKING THE ROOF DESIGN BECAUSE THE WIND LOAD ENGINEER IS SPECIFICALLY NOT RESPONSIBLE FOR THE TRUSS LAYOUT WHICH WAS CREATED BY THE TRUSS MANUFACTURER AND THE TRUSS DESIGNER ALSO DENIES RESPONSIBILITY FOR THE LAYOUT PER NOTES ON THEIR SEALED

FLORIDA BUILDING CODE RESIDENTIAL

ASCE 7-10

7-45 DEGREES

40 PSF LIVE LOAD

30 PSF LIVE LOAD

20 PSF LIVE LOAD

16 PSF LIVE LOAD

12 PSF LIVE LOAD

INTERIOR

THIS BUILDING IS NOT IN THE FLOOD ZONE

+25.6(Vasd) -27.8(Vasd) +25.6(Vasd) -34.2(Vasd)

+42.6(Vult) -46.2(Vult) +42.6(Vult) -57(Vult)

+22.6(Vasd) -25.5(Vasd)

+21.7(Vasd) -24.1(Vasd)

END 4' FROM ALL

**OUTSIDE CORNER** 

DIMENSIONS: Stated dimensions supercede scaled dimensions. Refer all questions to Mark Disosway, P.E. for resolution. Do not proceed without clarification

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permission and consent of Mark Disosway. CERTIFICATION: I hereby certify that I have examined this plan, and that the applicable portions of the plan, relating to wind engineering omply with the 6th Edition Florida Building Code Residential (2017) to the best of my knowledge.


ouilding, at specified location. MARK DISOSWAY P.E. 53915

LIMITATION: This design is valid for one



Mark Disosway P.E. 163 SW Midtown Place Suite 103 Lake City, Florida 32025 386.754.5419 disoswaydesign@gmail.com

JOB NUMBER: 190802 **S-1** OF 2 SHEETS

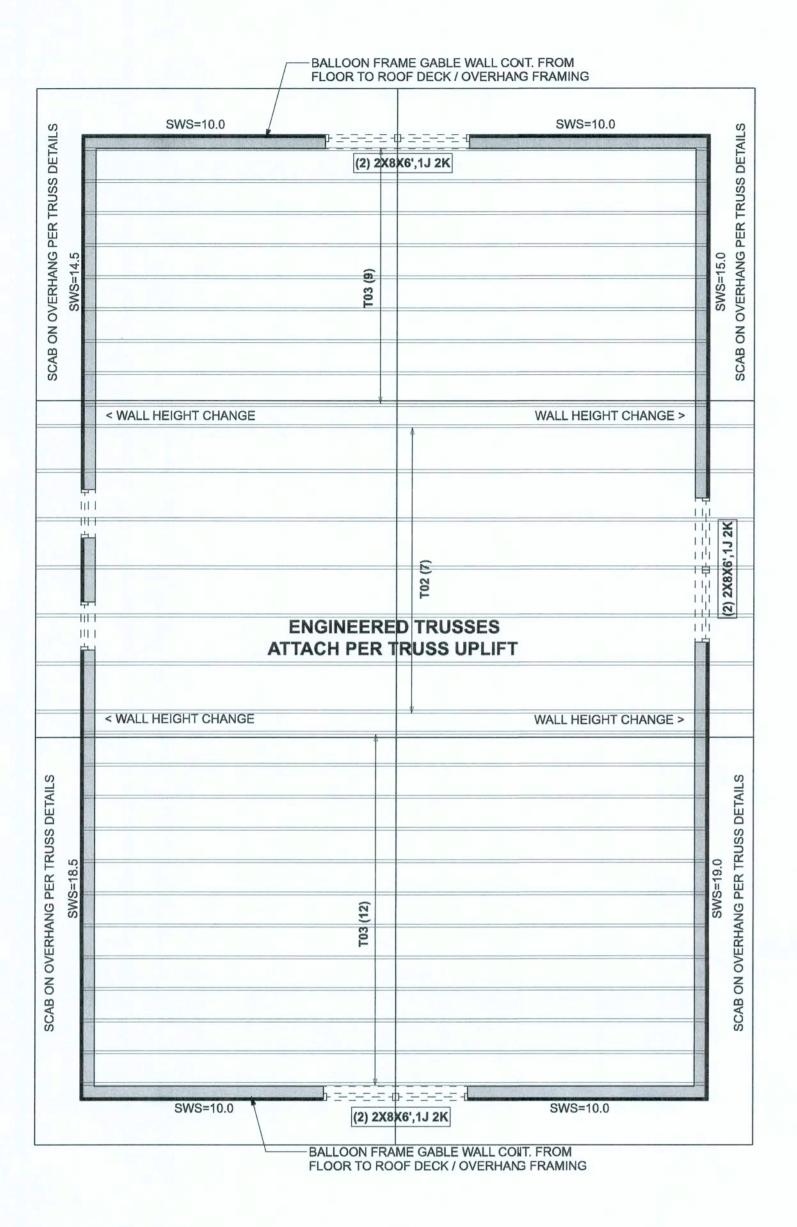


2nd FLOOR STRUCTURAL PLAN SCALE: 3/16" = 1'-0"

ALL EXTERIOR WALLS ARE 2x6 UNLESS NOTED

## ACTUAL vs REQUIRED SHEARWALL 2nd FLOOR TRANSVERSE LONGITUDUNAL ACTUAL 15800 LBF 26130 LBF


### **HEADER LEGEND**

REQUIRED 12429 LBF

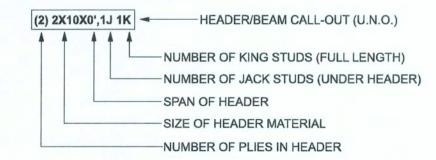

5775 LBF

CONNECTIONS, WALL, & HEADER DESIGN IS BASED ON REACTIONS & UPLIFTS FROM TRUSS ENGINEERING FURNISHED BY BUILDER. BUILDERS FIRST SOURCE JOB #2035952

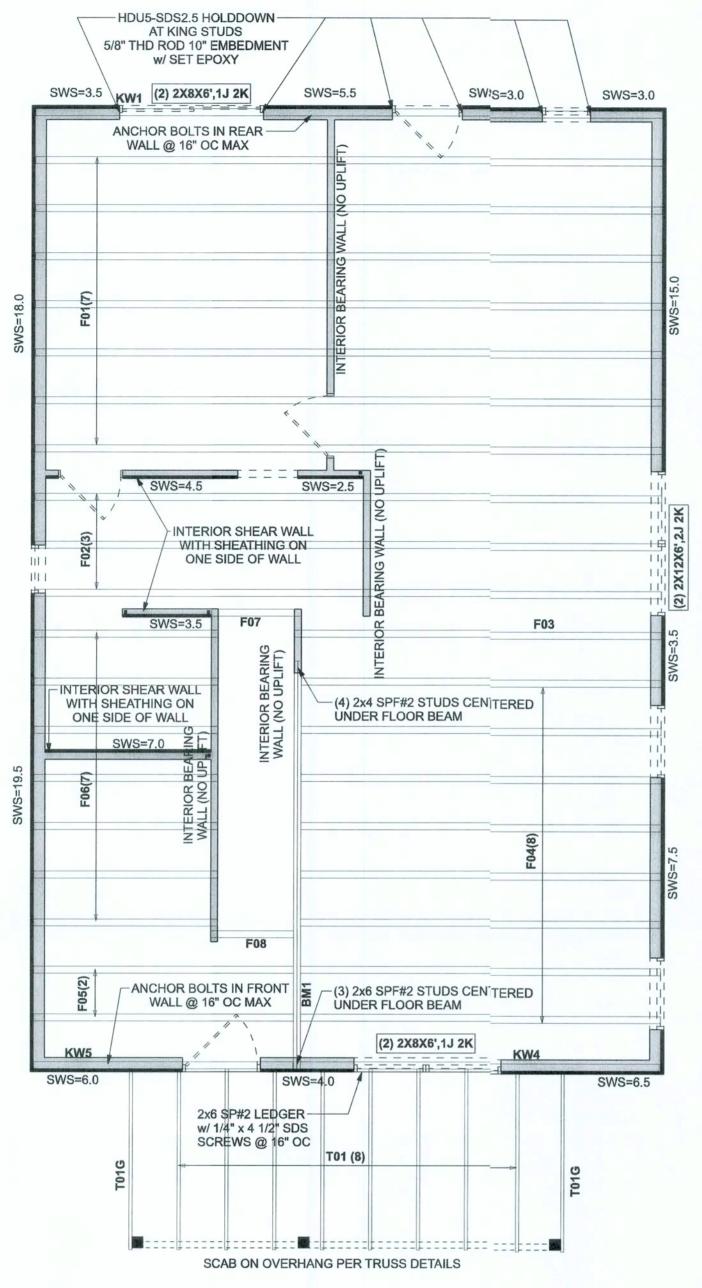

### 1st FLOOR STRUCTURAL PLAN

SCALE: 3/16" = 1'-0"

ALL EXTERIOR WALLS ARE 2x6 UNLESS NOTED

<b>ACTUAL vs REQUIRED SHEARWAL</b>		
1st FLOOR	TRANSVERSE	LONGITUDUNAL
ACTUAL	25270 LBF	25146 LBF
REQUIRED	24391 LBF	13652 LBF

### STRUCTURAL PLAN NOTES

EACH SIDE (U.N.O.)

N-1 ALL LOAD BEARING FRAME WALL & PORCH HEADERS SHALL BE A MINIMUM OF (2) 2X8 SP #2 (U.N.O.)

SN-2 ALL LOAD BEARING FRAME WALL HEADERS SHALL HAVE (1) JACK STUD & (1) KING STUD

@ ALL DOOR LOCATIONS (U.N.O.)

SN-3

ALL HEADERS W/ UPLIFT TO BE STRAPPED DOWN @ EACH SILDE WITH (1) LSTA24, 14-10d @ TOP & BOTTOM OF WALL WRAP OVER TOP PLATE AND TO WALL OR BEAM OR UNDER BOTTOM PLATE @ SLAB WITH 1/2" X 10" ANCHOR BOLT W/ 3" X 3" X 1/4" WASHER MUST BE LOCATED WITHIN 6" OF KING STUD


SN-4 USE ONE JACK STUD GIRDER SUPPORT PER 2500 LB LOAD

N-5
DIMENSIONS ON STRUCTURAL SHEETS
ARE NOT EXACT. REFER TO ARCHITECTURAL
FLOOR PLAN FOR ACTUAL DIMENSIONS

PERMANENT TRUSS BRACING IS TO BE INSTALLED AT LOCATIONS AS SHOWN ON THE SEALED TRUSS DRAWINGS.

LATERAL BRACING IS TO BE RESTRAINED PER BCSI1-03, BCSI-B1, BCSI-B2, & BCSI-B3. BCSI-B1, BCSI-B2, & BCSI-B3. ARE FURNISHED BY THE TRUSS SUPPLIER, WITH THE SEALEID TRUSS PACKAGE



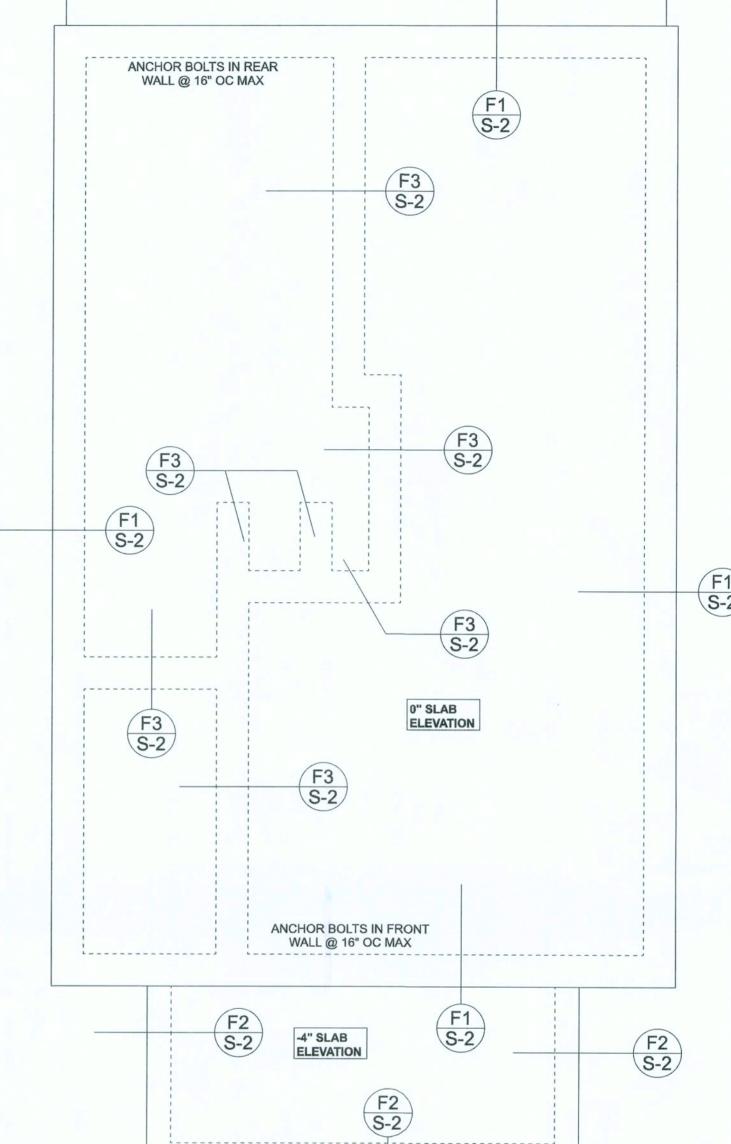

FOUNDATION PLAN

FOUNDATION NOTES


FOUNDATION NOTES

FN - 1 DIMENSIONS ON FOUNDATION & STRUCTURAL SHEETS ARE NOT EXACT. REFER TO ARCHITECTURAL PLANS FOR ACTUAL DIMENSIONS, RECESSES IN SLAB, STEP DOWNS, ETC. DISOSWAY DESIGN GROUP OR MARK DISOSWAY, PE IS NOT RESPONSIBLE FOR DIMENSION ERRORS ON THIS PLAN.


CONTRACTOR SHALL VERIFY NEED FOR INTERIOR BEARING FN - 2 IN ALL AREAS BY REVIEWINGTHE ROOF TRUSS PLAN (BY THE SUPPLIER) BEFORE FINALIZING FOUNDATION PLAN

FN - 3 THE SLAB SHALL BE: 4" CONCRETE SLAB REINFORCED W/ 6X6-1.4/1.4 WELDED WIRE MESH PLACED ON CHAIRS @ 1 1/2" DEPTH OR FIBER MESH CONCRETE, 6-MIL POLY VAPOR BARRIER W/ 6" LAPS SEALED W/ POLY TAPE OVER TERMITE-TREATED & COMPACTED FILL (ALSO, ANY OTHER CODE APPROVED TERMITE-TREATMENT METHOD CAN BE USED INSTEAD)


BOTTOM OF EXTERIOR FOOTINGS SHALL BE A MINIMUM OF 12" BELOW UNDISTURBED SOIL OR ENGINEERED FILL PER FBC 2017-RES. SECTION R403.1.4

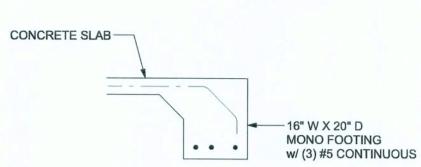

F1 HOUSE MONOLITHIC FOOTING
S-2 SCALE: 1/2" = 1'-0"

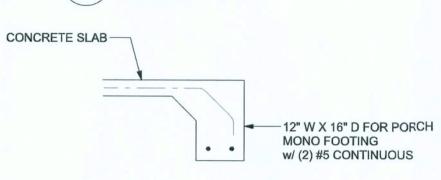

F2 PORCH MONOLITHIC FOOTING
S-2 SCALE: 1/2" = 1'-0"

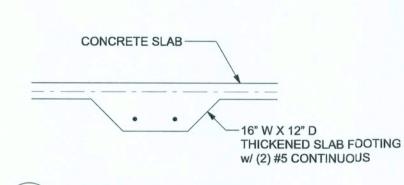


F3 INTERIOR BEARING FOOTING
S-2 SCALE: 1/2" = 1'-0"

 8.7
 8.3
 8
 24
 32
 24
 48
 64

 9.3
 9.0
 8
 16
 24
 16
 40
 48

The table assumes 60 ksi reinforcing bars with 6" hook in the footing and bent 24" into the

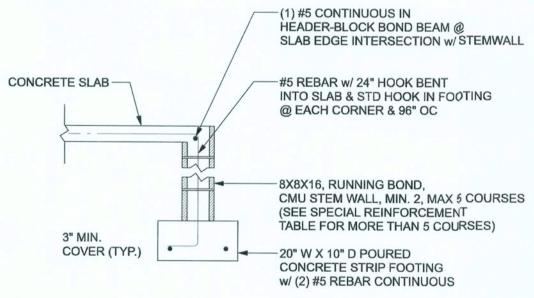

OPTIONAL STEM WALL FOOTING
(USE IN PLACE OF MONO F1 & F2)
SCALE: 1/2" = 1'-0"

MASONRY CONSTRUCTION AND MATERIALS FOR THIS PROJECT

MASONRY NOTE:

3.3.E.7 Movement joints

SHALL CONFORM TO ALL REQUIREMENTS OF "SPECIFICATION FOR MASONRY STRUCTURES" (ACI 530.1/ASCE 6/TMS 602). THE CONTRACTOR AND MASON MUST IMMEDIATELY, BEFORE PROCEEDING, NOTIFY THE ENGINEER OF ANY CONFLICTS BETWEEN ACI 530.1-02 AND THESE DESIGN DRAWINGS. ANY EXCEPTIONS TO ACI 530.1-02 MUST BE APPROVED BY THE ENGINEER IN WRITING.			
	ACI530.1-02 Section	Specific Requirements	
1.4A	Compressive strength	8" block bearing walls F'm = 1500 psi	
2.1	Mortar	ASTM C 270, Type N, UNO	
2.2	Grout	ASTM C 476, admixtures require approve	
2.3	CMU standard	ASTM C 90-02, Normal weight, Hollow, medium surface finish, 8"x8"x16" running bond and 12"x12" or 16"x16" column block	
2.3	Clay brick standard	ASTM C 216-02, Grade SW, Type FBS, 5.5"x2.75"x11.5"	
2.4	Reinforcing bars, #3 - #11	ASTM 615, Grade 40, Fy = 40 ksi, Lap splices min 40 bar dia. (25" for #5)	
2.4F	Coating for corrosion protection	Anchors, sheet metal ties completely embedded in mortar or grout, ASTM A525, Class G60, 0.60 oz/ft2 or 304SS	
2.4F	Coating for corrosion protection	Joint reinforcement in walls exposed to moisture or wire ties, anchors, sheet met ties not completely embedded in mortar of grout, ASTM A153, Class B2, 1.50 oz/ft2	

3.3.E.2 Pipes, conduits, and accessories Any not shown on the project drawings

require engineering approval.

detailed on project drawings.

Contractor assumes responsibility for type and location of movement joints if not

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CERTIFICATION: I hereby certify that I have examined this plan, and that the applicable portions of the plan, relating to wind engineering comply with the 6th Edition Florida Building Code Residential (2017) to the best of my knowledge.

LIMITATION: This design is valid for one building, at specified location.

MARK DISOSWAY P.E. 53915

Stated dimensions supercede scaled

imensions. Refer all questions to

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Do not proceed without clarification.

STATE OF

OR NAL

Thursday, August 15, 2019

Mark Disosway P.E. 163 SW Midtown Place Suite 103 Lake City, Florida 32025 386.754.5419 disoswaydesign@gmail.com

> JOB NUMBER: 190802 **S-2**

> > OF 2 SHEETS