

5 PHONE WIRING

E1.1 SCALE: N.T.S.

ELECTRICAL SPECIFICATIONS

- A. ALL WIRING SHALL SHALL BE CONTAINED IN CONDUIT OF PROPER SIZE.
- SERVICE IS TO BE A MINIMUM 400 AMP, 3 PHASE (PREFERRED), 600 AMP, 1 PHASE OR LARGER IF REQUIRED BY CODE OR ELECTRICAL LOAD.
- REQUIRED CUSTOM BUILT POWER POLE ASSEMBLIES AVAILABLE FROM D&P CUSTOM LIGHTS & PRODUCTS INC., PHONE: (800) 251-2200 OR (615) 350-7800, 7111 COCKRILL BEND INDUSTRIAL ROAD,
- NASHVILLE, TN 37209. SEE E3.1.
- EXTERIOR EXPOSED PHONE LINES TO BE INSTALLED IN RIGID CONDUIT. PROVIDE EMERSON 3/4" X 5-FT. METALLIC CABLE U-GUARD #755, OR EQUAL..
- ELECTRICAL PANEL TO BE LABELED CORRECTLY WITH LEGIBLE PRINT.
- G. LOW VOLTAGE VENDOR TO PROVIDE AND INSTALL ONE (1) 24 GA., 4 TWISTED-PAIR, CATEGORY-FIVE (CAT5) DATA CABLE WITH MODULAR COMBO RJ-11/RJ-45 JACK AT MANAGER'S OFFICE. CABLE TO BE RUN FROM JACK TO DATA HUB LOCATION WITH 6'-0" LEFT COILED FOR INSTALLATION TO DATA HUB. A RJ-45 MALE FITTING SHOULD BE CRIMPED ON THIS END. DOLLAR GENERAL STORE OPENING TEAM WILL MAKE FINAL CONNECTION INTO THE DATA HUB.
- PROVIDE 1 1/2" EMT CONDUIT TO ACT AS ACCESS SLEEVE TO ALLOW PHONE COMPANY TO TERMINATE AT DMARC. CONTRACTOR TO PROVIDE AND INSTALL PHONE WIRING & RJ-11 PHONE JACK FOR COMPLETED WORKING SYSTEM PRIOR TO PHONE COMPANY FINAL HOOK UP.
- ALL 120 VOLT OUTDOOR RECEPTACLES TO HAVE "WET LOCATION IN USE" COVERS.
- ALL CONDUCTORS TO BE COPPER, #12 AWG MINIMUM SIZE, OR AS REQUIRED BY LOAD AND OVER CURRENT PROTECTION.
- K. SEE EMS SHEETS EMS1 AND EMS2 FOR ENERGY MANAGEMENT SYMBOLS AND INFORMATION. L. ELECTRICIAN TO PROVIDE 1 1/2" CONDUIT WITH PULL STRINGS FOR SATELLITE LOCATION.
- M. ALL POWER AND DATA TO BE ROUTED OVERHEAD. <u>UNDER SLAB NOT ALLOWED</u>.
- N. WITHIN 30 DAYS OF SYSTEM ACCEPTANCE, RECORD DRAWINGS OF THE INSTALLATION SHALL BE PROVIDED TO THE BUILDING OWNER, INCLUDING:
- N.A. A SINGLE-LINE DIAGRAM OF THE BUILDING ELECTRICAL DISTRIBUTION SYSTEM. N.B. FLOOR PLANS INDICATING LOCATION AND AREA SERVED FOR ALL DISTRIBUTION.
- O. OPERATING AND MAINTENANCE MANUALS SHALL BE PROVIDED TO THE BUILDING OWNER, AND SHALL INCLUDE THE FOLLOWING AT A MINIMUM:
- O.A. SUBMITTAL DATA STATING EQUIPMENT RATING AND SELECTED OPTIONS FOR EACH PIECE OF EQUIPMENT REQUIRING MAINTENANCE, EACH PIECE OF LIGHTING EQUIPMENT, AND ALL LIGHTING
- O.B. OPERATIONS MANUALS AND MAINTENANCE MANUALS FOR EACH PIECE OF EQUIPMENT REQUIRING MAINTENANCE AND EACH PIECE OF LIGHTING EQUIPMENT. REQUIRED ROUTINE MAINTENANCE, CLEANING, AND RELAMPING ACTIONS SHALL BE CLEARLY IDENTIFIED.
- O.C. A NARRATIVE OF HOW EACH SYSTEM IS INTENDED TO OPERATE, INCLUDING RECOMMENDED
- O.D. A SCHEDULE FOR INSPECTING AND RECALIBRATING ALL LIGHTING CONTROLS.
- O.E. NAMES AND ADDRESSES OF AT LEAST ONE QUALIFIED SERVICE AGENCY.
- P. A REGISTERED DESIGN PROFESSIONAL SHALL PROVIDE EVIDENCE THAT THE LIGHTING CONTROL SYSTEMS HAVE BEEN TESTED IN ACCORDANCE WITH FBC C408.3.1.1-3.1.3. DOCUMENTATION SHALL BE PROVIDED TO THE BUILDING OWNER OR AUTHORIZED AGENT WITHIN 90 DAYS OF RECEIPT OF THE CERTIFICATE OF OCCUPANCY. REPORT SHALL INCLUDE THE FOLLOWING:
- P.A. RESULTS OF FUNCTIONAL PERFORMANCE TESTS.
- P.B. DISPOSITION OF DEFICIENCIES FOUND DURING TESTING, INCLUDING DETAILS OF CORRECTIVE MEASURES USED OR PROPOSED.

B. ALL WIRING SHALL CONFORM TO LOCAL, STATE AND FEDERAL CODES.

696 1ST AVE N, STE 200 ST. PETERSBURG, FL 33701 PE #76961

KENNETH W HUNTER, P.E.

PROFESSIONAL ENGINEER

CTH W. HU LICENSE No. 76961 Digitally signed by Kenneth V Hunger Contact Info FATE P.#7696 Date: 2084.04.14 16:31:03-049NAL

ں ك

GENER/

(352) 238-6366

Hunter Design FL CA #31946

& CONSULTING GA CA #PEF00717

www.hdceng.com

696 1st Ave N, Ste. 200 St. Petersburg, FL 3370

DRAWING DATE: / DRAWN B 4/5/24 - KWH REVISION DATE: / REVISED BY:

PROJECT NUMBER: 4000.249 DRAWING TITLE: POWER PLAN

REGISTER ELECTRICAL DETAIL


CONNECTOR DRW #2004-12

10' CABLE KIT (SET OF 4 WHIPS)

4 747DGS032A

This item has been electronically signed and sealed by Kenneth W. Hunter, P.E. on 4/14/24 using a Digital Signature Printed copies of this document are not considered signed and

sealed and the signature must be verified on any electronic copies.

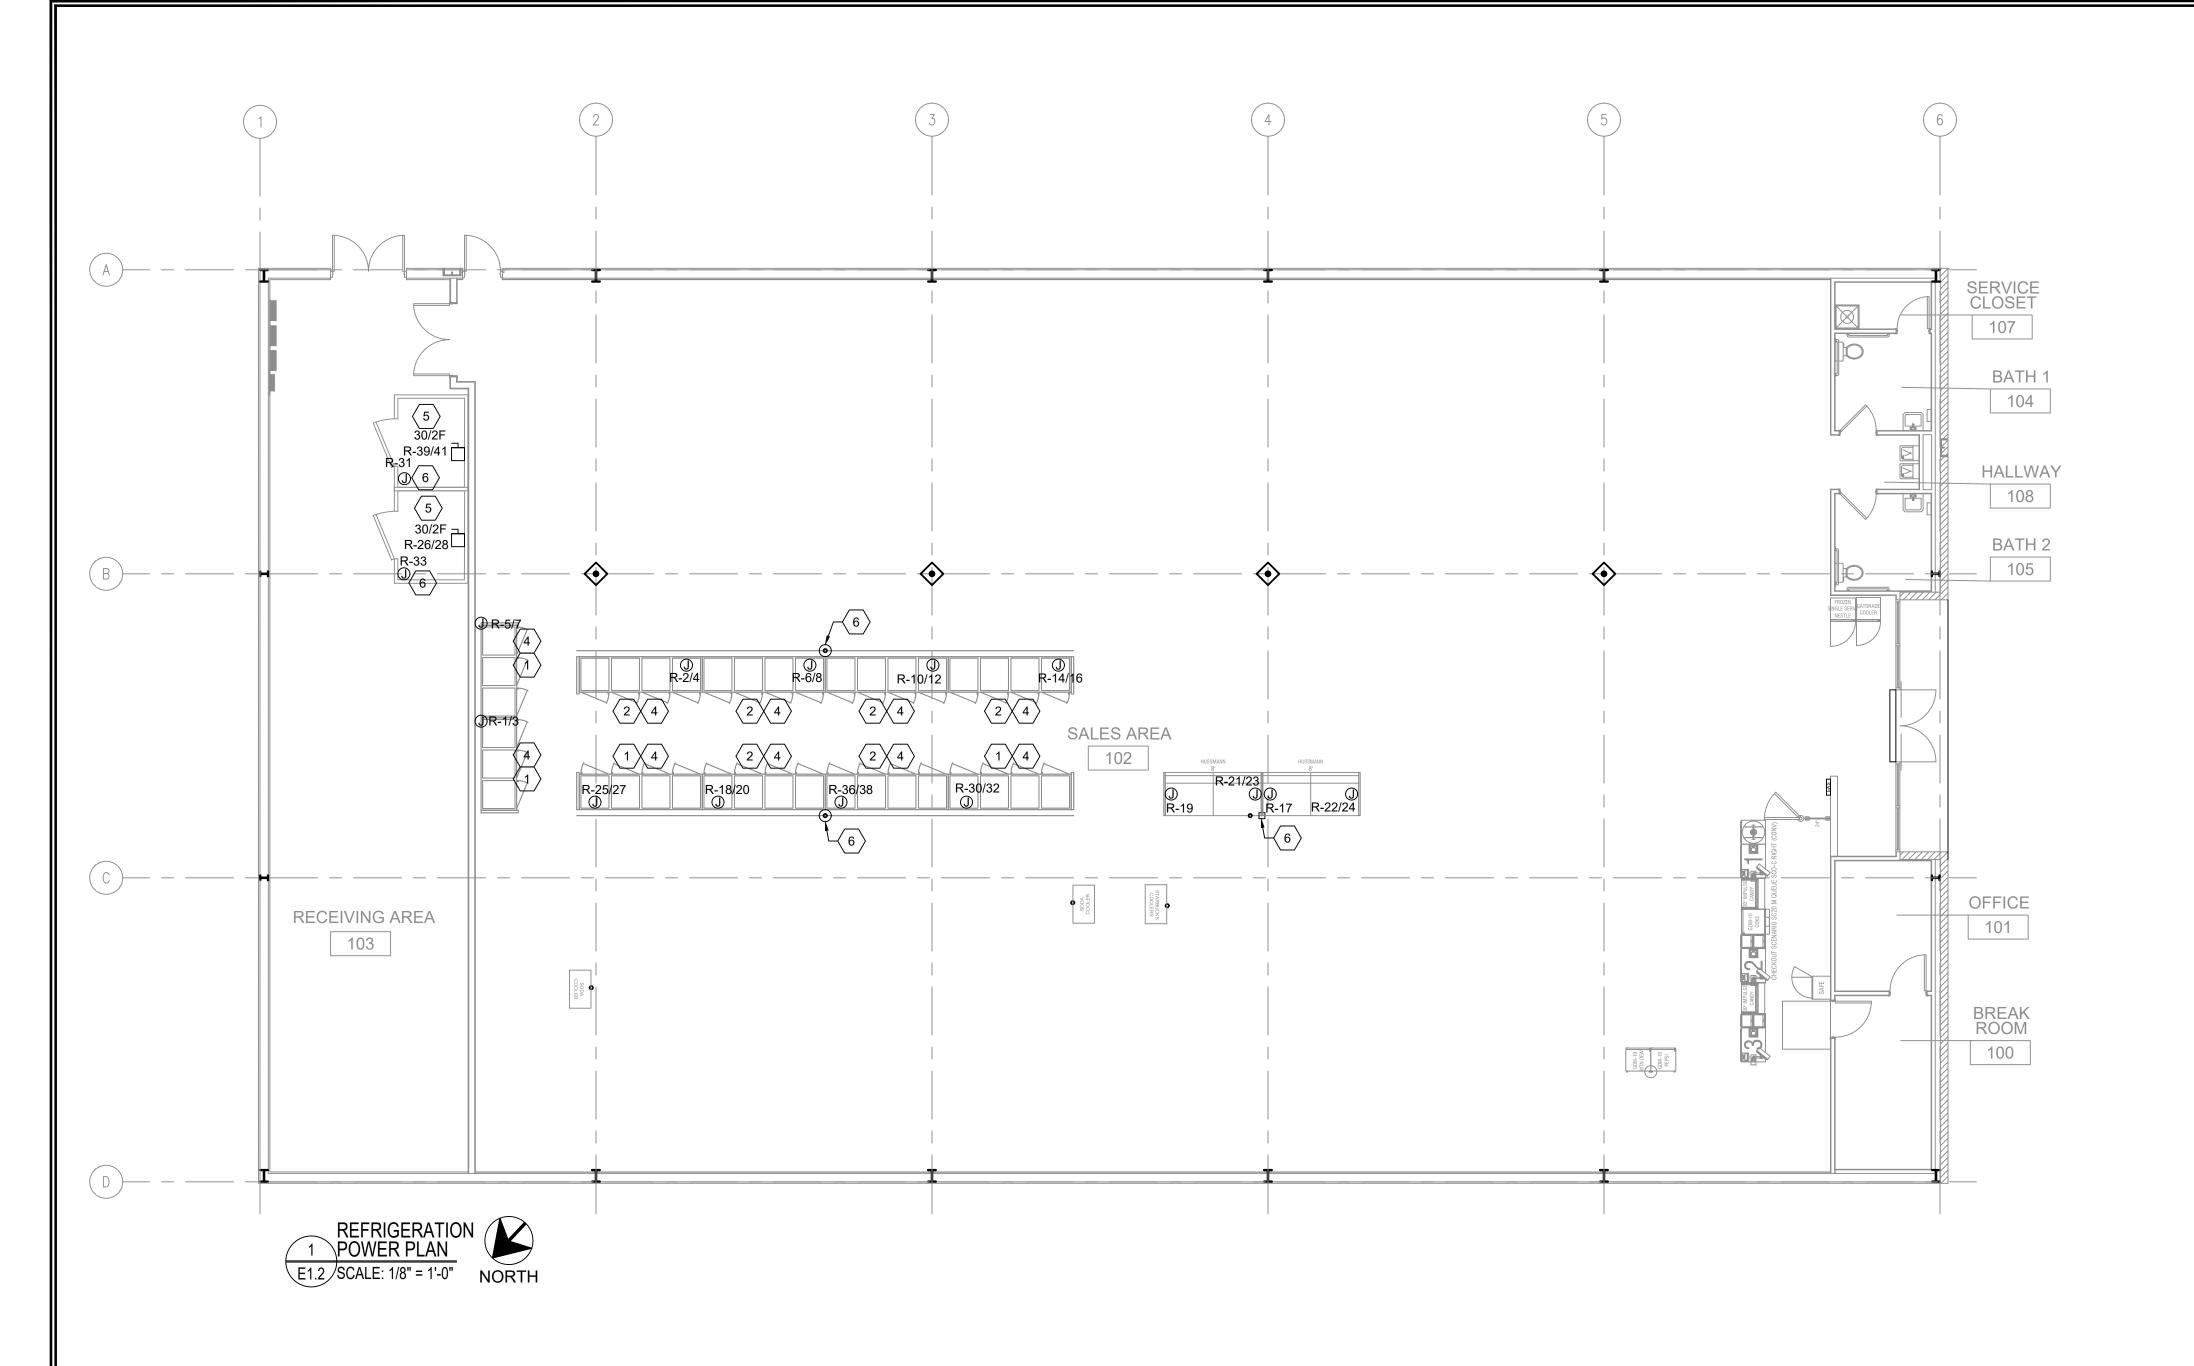


	LEGEND
SYMB	DESCRIPTION
©	BUZZER - TORK MDL #TA725 W/ TRANSFORMER MDL#TA592
	COMMERCIAL GRADE PUSH BUTTON
\Leftrightarrow	125V NEMA 5-20R DUPLEX
€	125/250V NEMA L14-20-R 4 PRONG TWIST LOCK
#	125V NEMA 5-20R QUAD
1	DISCONNECT
	BLACK MAGIC POWER POLE
◀	PHONE JACK
0	RJ-11, RJ-45 DATA JACK, PHONE COMBO
A-23	PANEL-CIRCUIT NUMBER
\$m	PROVIDE OCCUPANCY LIGHT SENSOR- LEVITON ODS10-IDW
\$	20 AMP TOGGLE SWITCH
NL	NIGHT LIGHT CIRCUIT

GENERAL NOTES:

- A. CONFIRM POWER REQUIREMENTS WITH REFRIGERATION PRIOR TO WORK.
- B. MOUNT ALL REFRIGERATOR OUTLETS AT 12" AFF.

PLAN NOTES:

- 1. PROVIDE 208V, 1 PHASE CONNECTION TO A J-BOX AT 90" AFF WITH (3)#12 CU. & #12 GROUND IN 3/4"C. R.C. TO PROVIDE AND INSTALL 30A-2NF DISCONNECT SWITCH AND WIRE FROM DISCONNECT SWITCH TO EQUIPMENT CONNECTIONS.
- 2. PROVIDE 208V, 1 PHASE CONNECTION TO A J-BOX AT 90" AFF WITH (3)#8 CU. & #10 GROUND IN 1"C. R.C. TO PROVIDE AND INSTALL 60A-2NF DISCONNECT SWITCH AND WIRE FROM DISCONNECT SWITCH TO EQUIPMENT CONNECTIONS.
- 3. PROVIDE 208V, 1 PHASE CONNECTION TO A J-BOX AT 90" AFF WITH (3)#10 CU. & #10 GROUND IN 3/4"C. R.C. TO PROVIDE AND INSTALL 30A-2NF DISCONNECT SWITCH AND WIRE FROM DISCONNECT SWITCH TO EQUIPMENT CONNECTIONS.
- 4. MOUNT J-BOX 11" FROM THE RIGHT SIDE OF EACH UNIT. CONFIRM EXACT LOCATION WITH REFRIGERATION VENDOR PRIOR TO WORK (TYP). COORDINATE ELECTRICAL AND ALL REQUIREMENTS WITH VENDOR/SUPPLIER.
- 5. J-BOX FOR CONNECTION TO LIGHTS/DOOR HEATER. COORDINATE ALL REQUIREMENTS WITH SUPPLIER/INSTALLER.
- 6. GROUP AND ROUTE RELATED COOLER/FREEZER CONDUITS OVERHEAD TO A SINGLE DROP LOCATION FOR DISTRIBUTION. SUPPORT CONDUITS USING CONDUIT RACK. RUN EXPOSED CONDUIT PARALLEL AND PERPENDICULAR TO WALLS.

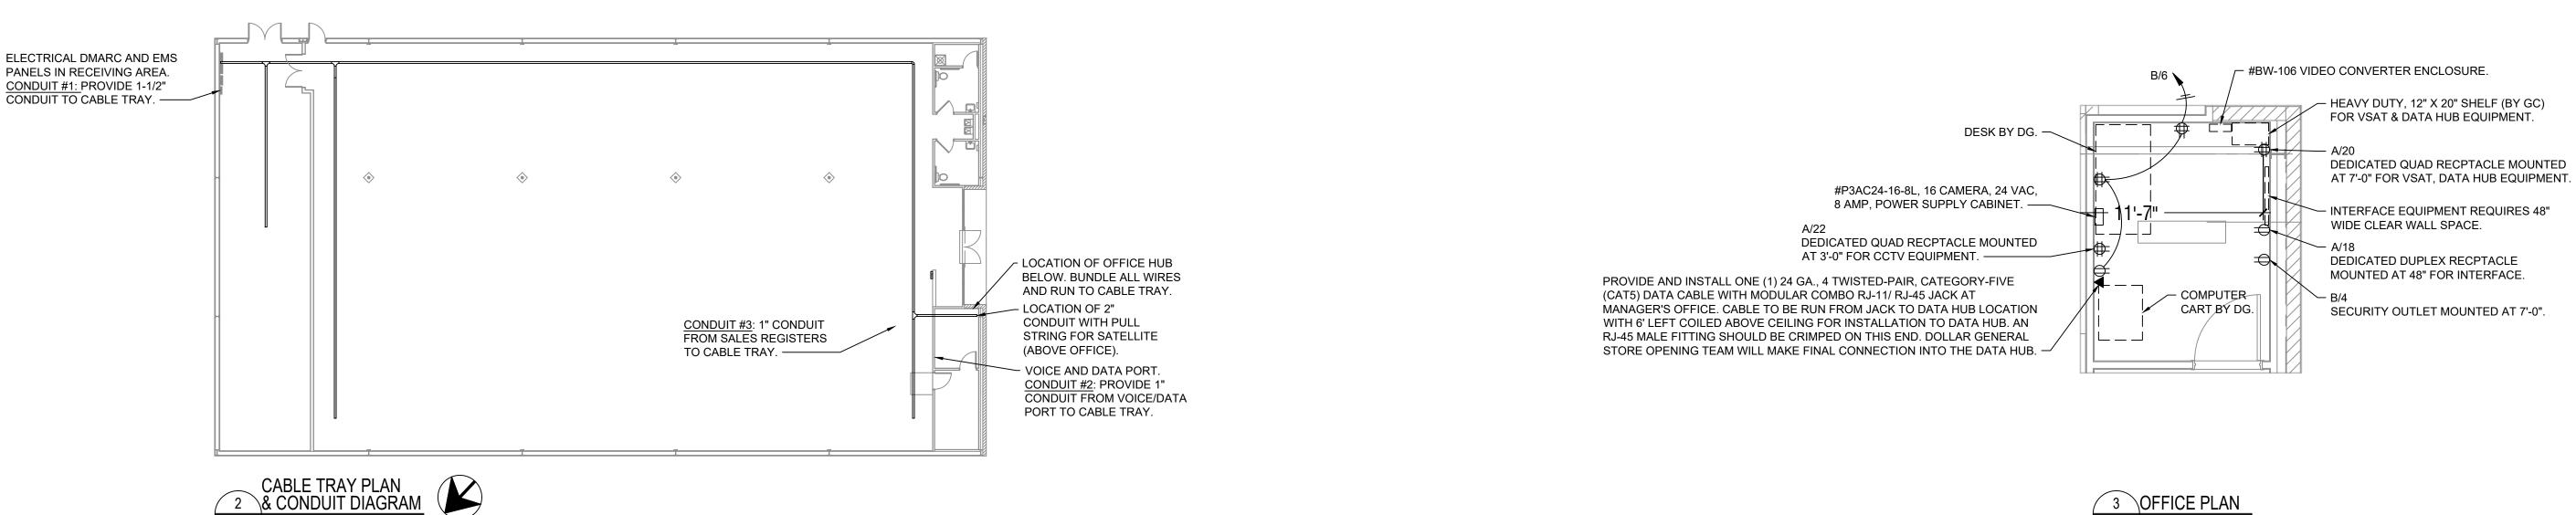



This item has been electronically signed and sealed by Kenneth W. Hunter, P.E. on 4/14/24 using a Digital Signature. Printed copies of this document are not considered signed and sealed and the signature must be verified on any electronic copies.

(352) 238-6366 www.hdceng.com **6**96 1st Ave N, Ste. 200 – St. Petersburg, FL 3370 Hunter Design FL CA #31946 & CONSULTING GA CA #PEF007171

KENNETH W HUNTER, P.E. PROFESSIONAL ENGINEER 696 1ST AVE N, STE 200 ST. PETERSBURG, FL 33701 PE #76961


ETH W. 4,

U

GENERAI

4/5/24 - KWH REVISION DATE: / REVISED BY:

PROJECT NUMBER: 4000.249 REFRIGERATION POWER & CABLE TRAY PLAN

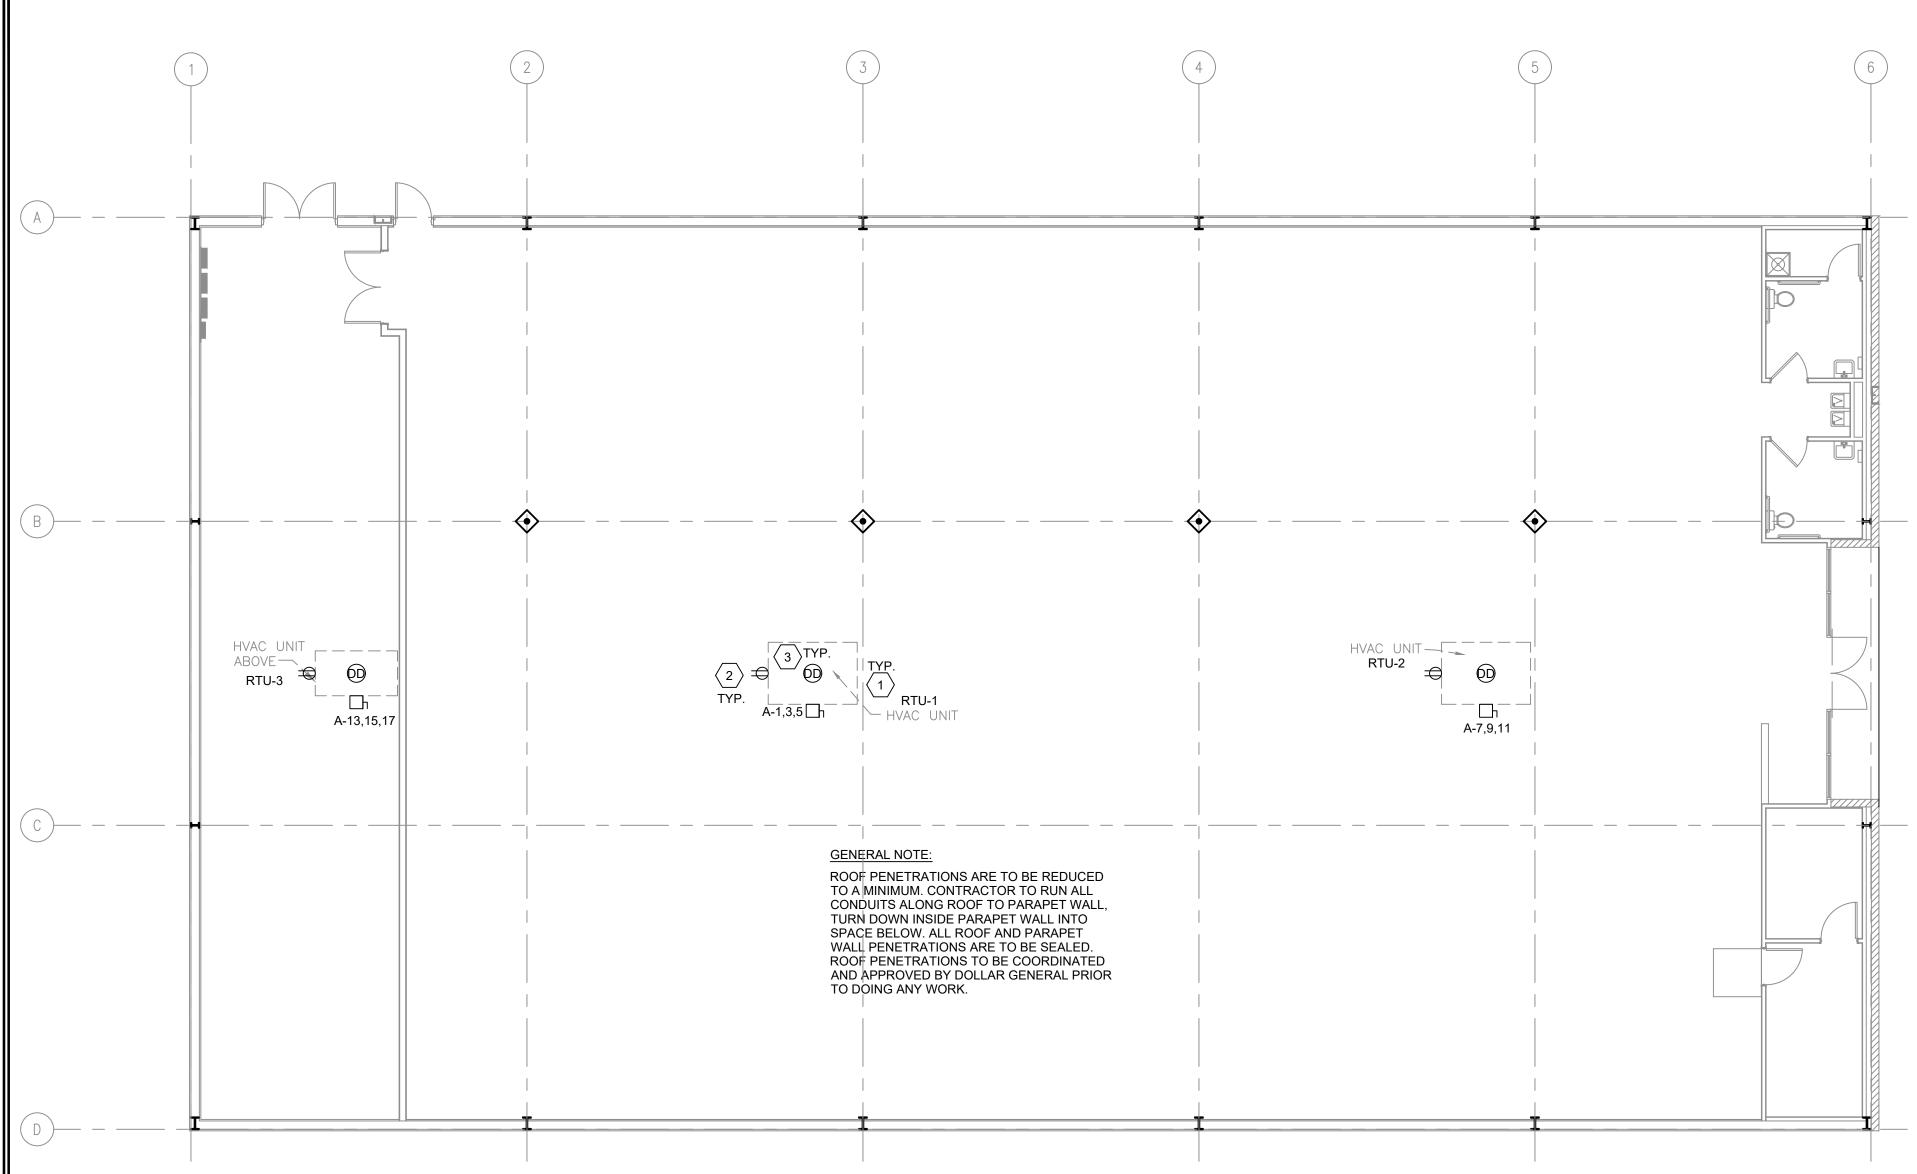

PLAN NOTES:

- 1. LOCATIONS SHOWN FOR MECHANICAL UNITS ARE ONLY APPROXIMATE, CONTRACTOR MUST CONSULT MECHANICAL OR STRUCTURAL DRAWINGS TO DETERMINE ACTUAL UNIT LOCATIONS. PROVIDE 1/2"C. PENETRATION THRU ROOF WITHIN FOOTPRINT OF UNIT FOR USE WITH CONTROL WIRING TO UNIT BY OTHERS. PROVIDE PROPER WATERSEAL (TYPICAL).
- 2. FACTORY MOUNTED POWERED CONVENIENCE OUTLET. FIELD VERIFY THAT OUTLET IS POWERED, WIRE ALL WITH THIS NOTE TO CIRCUIT R-34 IF THEY ARE NOT POWERED.
- 3. PHOTOELECTRIC DUCT DETECTOR WITH HOUSING. TIE TO LED READOUT. STAND ALONE DEVICE, 120V. SIMPLEX #4098-9687 IS SPECIFIED WITH 4098-9842 CONTROL STATION. PROVIDE ONE DEVICE PER UNIT. MOUNT DEVICE IN SUPPLY AIR DUCTWORK. DEVICE SHALL BE PROVIDED AND WIRED TO THE CONTROL STATION BY THE ELECTRICAL CONTRACTOR. HIRE THE MECHANICAL CONTRACTOR FOR INSTALLATION IN DUCTWORK AND CONNECTION TO SHUTDOWN CONTROLS. ELECTRICAL CONTRACTOR SHALL PROVIDE ALL REQUIRED RELAYS AND 120V POWER, <u>DO NOT POWER DUCT DETECTORS</u>
 FROM HVAC UNIT LOW VOLATGE. PLACE ANY REQUIRED
 LABELING ON CEILING TILE DIRECTLY BELOW UNIT. RUN CONDUIT & WIRE UNDERGROUND FROM UNIT TO INSIDE OF SPACE.

1 ROOF POWER PLAN	
E1.3 SCALE: 1/8" = 1'-0"	NORTH

				HVA	C UNIT	WIRIN	IG TAE	BLE				
UNIT	WIRE	COND	DISC	FUSE	ENCL	PH	VOLT	GND	BRKR	LOAD	CFM	TONS
RTU-1	#3	1 1/4"	100A/3P	90A	NEMA 3R	3ф	208	#8	90A/3P	24,770	5,000	12.5
RTU-2	#3	1 1/4"	100A/3P	90A	NEMA 3R	3ф	208	#8	90A/3P	22,770	5,000	12.5
RTU-3	#6	1"	60A/3P	40A	NEMA 3R	3ф	208	#10	45A/3P	11,520	2,000	5.0
EF-1	EF-1 #12 3/4" MOTOR RATED SWITCH					1ф	120	#12	W/ LIGHTS	50	75	
EF-2	#12	3/4"	MOTOR RAT	TED SWITCH	NEMA 1	1ф	120	#12	20A/1P	50	75	
TABLE NO	ABLE NOTES:											

1. THE ELECTRICAL CONTRACTOR SHALL FIELD COORDINATE WITH THE MECHANICAL CONTRACTOR CONCERNING THE ELECTRICAL INFO OF ALL MECHANICAL DEVICES REQUIRING AN ELECTRICAL CONNECTION PRIOR TO DOING ANY WORK. ANY DISCREPANCIES BETWEEN THE FIELD OBTAINED INFORMATION AND THE INFORMATION SHOWN ON THE ELECTRICAL PLANS SHALL BE BROUGHT TO THE ATTENTION OF THE ENGINEER PRIOR TO DOING ANY WORK.

2. PROVIDE NEUTRALS ON AS REQUIRED BASIS, FIELD VERIFY.


3. ALL DISCONNECTS TO BE HEAVY DUTY. FUSES TO BE RK-5 TYPE, SUBMIT SHOP DRAWINGS. BUSSMAN FRN-R-(AMP) IS SPECIFIED.

4/5/24 - KWH REVISION DATE: / REVISED BY:

> PROJECT NUMBER: 4000.249 DRAWING TITLE: ROOF POWER PLAN

This item has been electronically signed and sealed by Kenneth W. Hunter, P.E. on 4/14/24 using a Digital Signature. Printed copies of this document are not considered signed and sealed and the signature must be verified on any electronic copies.



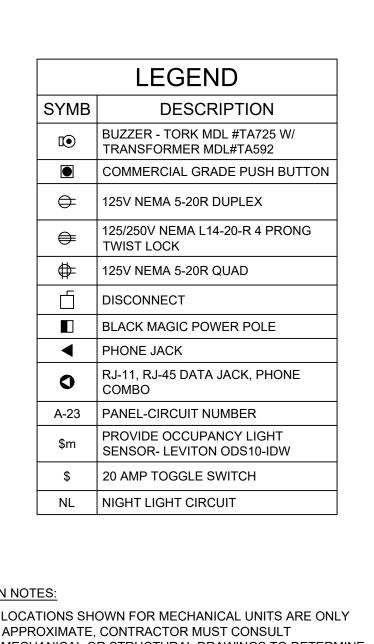


U o

KENNETH W HUNTER, P.E. PROFESSIONAL ENGINEER 696 1ST AVE N, STE 200 ST. PETERSBURG, FL 33701 PE #76961

> SETH W. HU. LICENSE

II SS/ONAL


CHECKOUT SCENARIO SC27 QUEUE SCO RIGHT

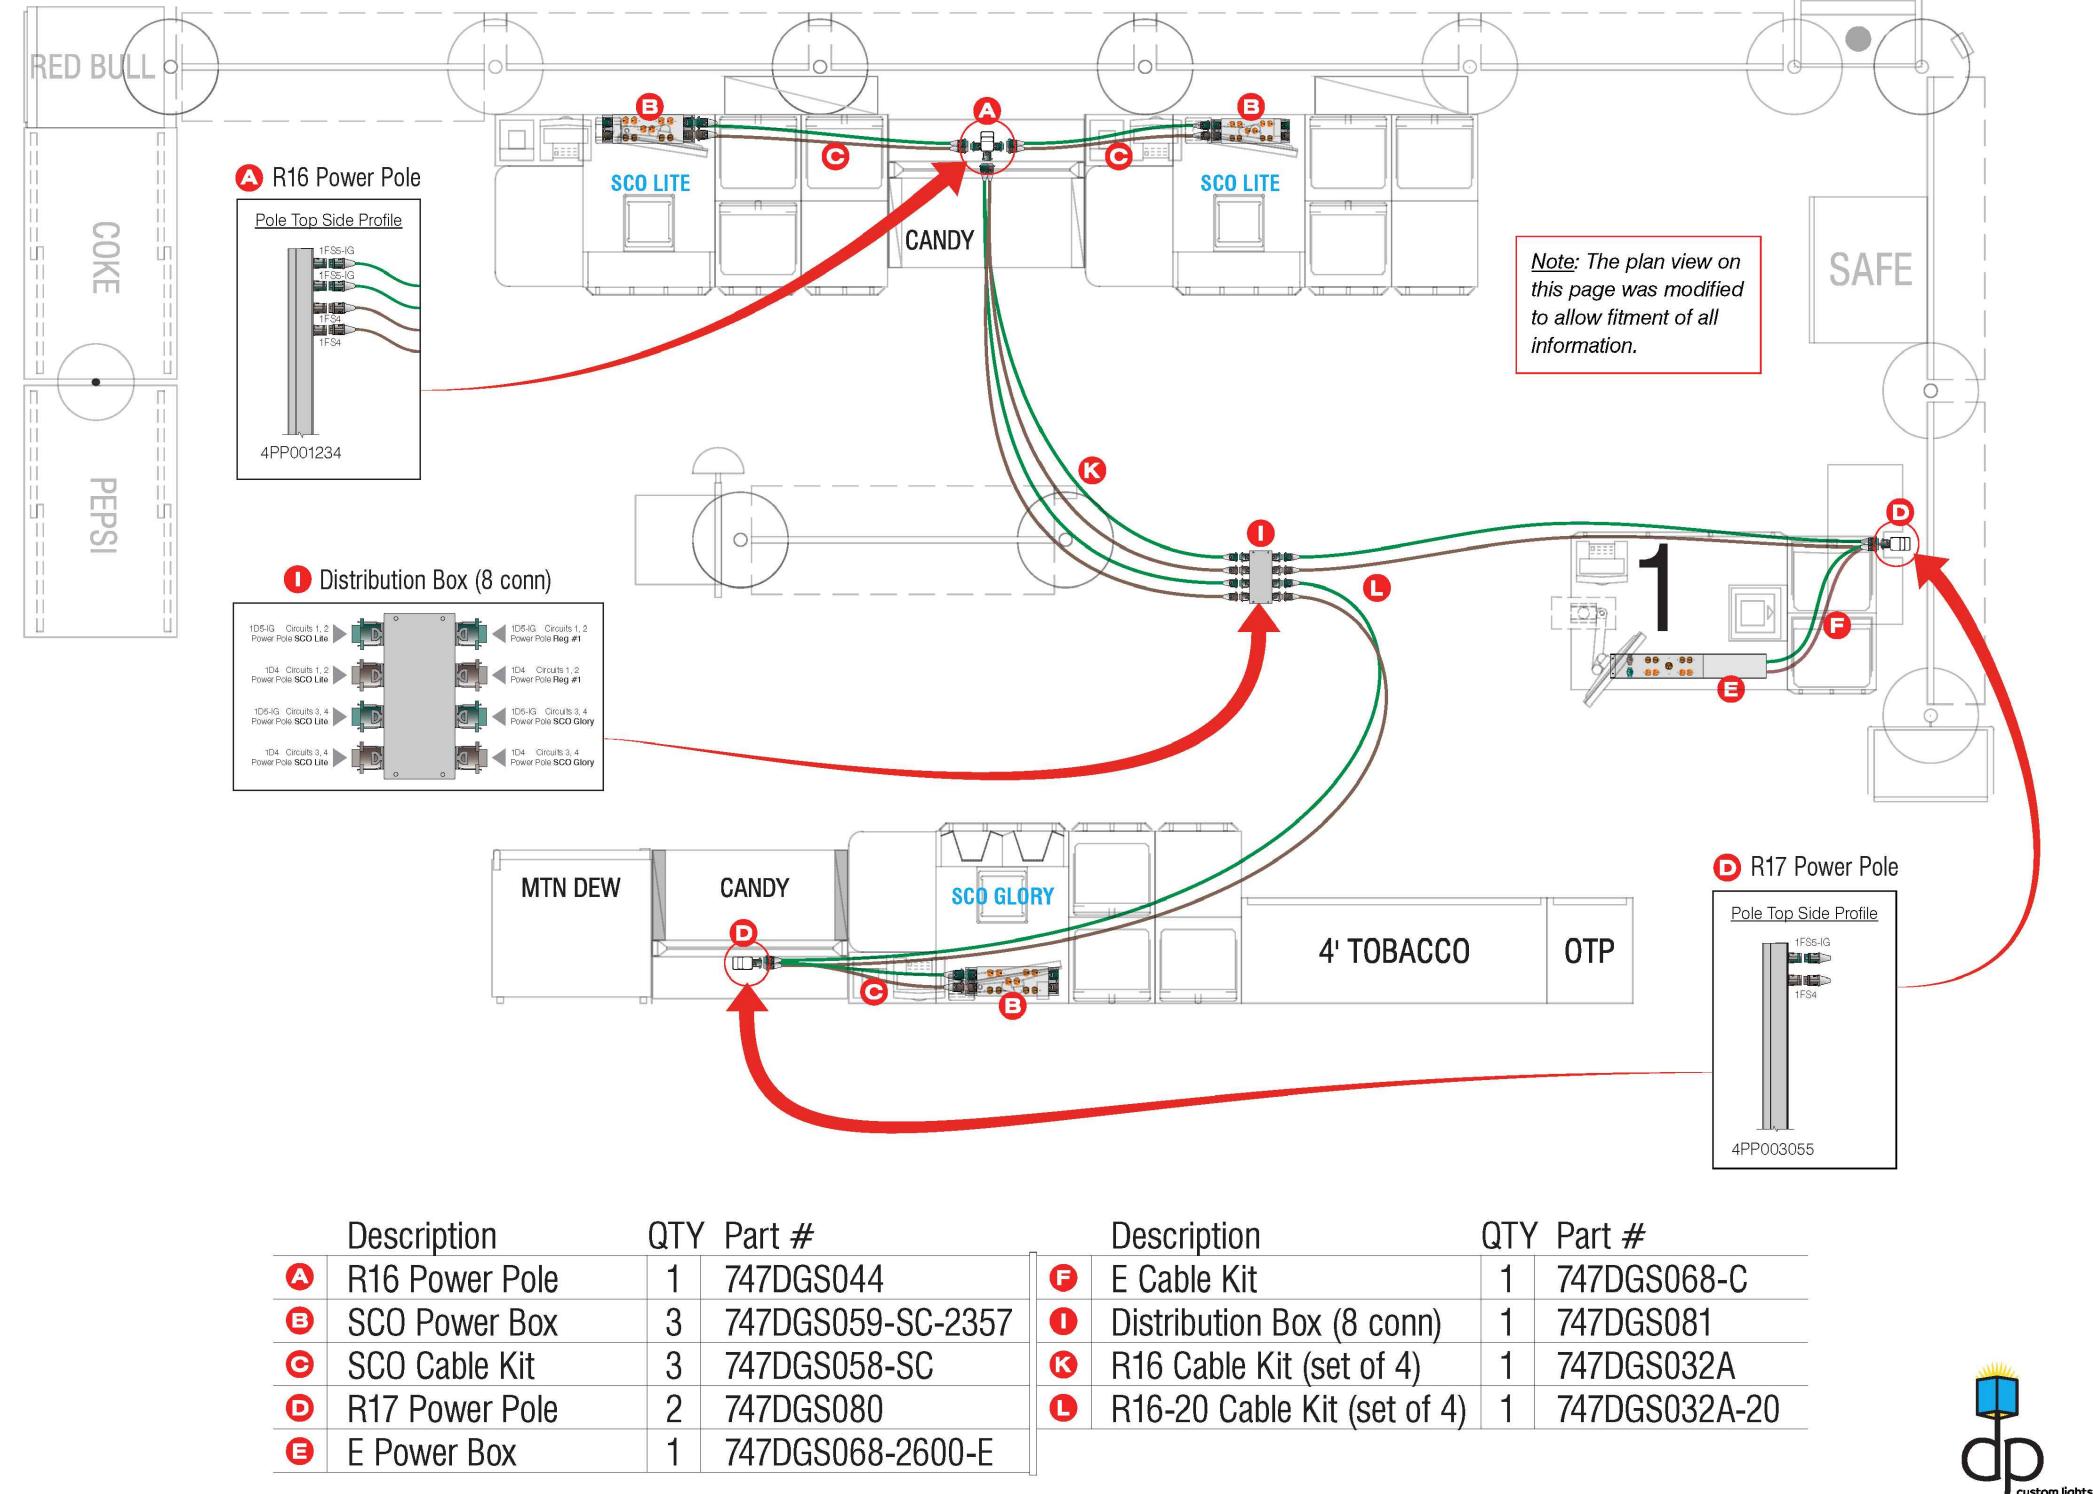

File: SCOFlowScenarios 2023

custom lights & wiring systems, inc.

NOTE: COORDINATE REGISTER POWER POLE INSTALLATION WITH STORE REGISTER LAYOUT.

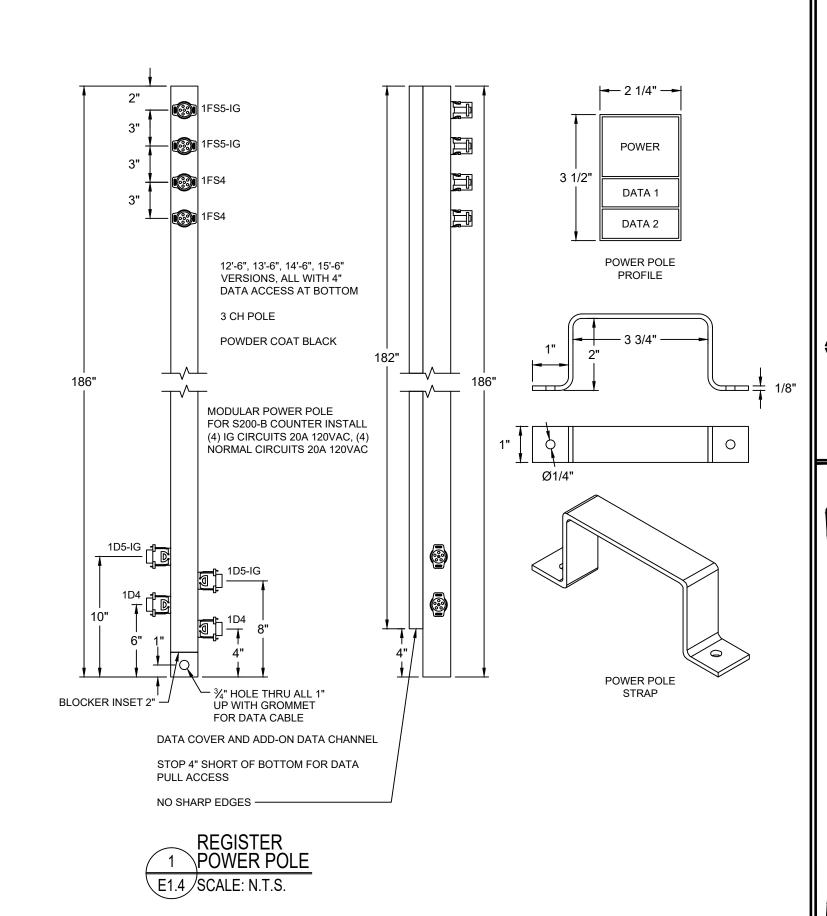

KENNETH W. HUNTER, P.E.

PROFESSIONAL ENGINEER
696 1ST AVE N, STE 200
ST. PETERSBURG, FL 33701
PE #76961

SE DRAWINGS HAVE BEEN PREPARED, IN PART, BASED UPON INFORMATION FURNISHED BY OTHERS. WHILE THIS FORMATION IS BELIEVED TO BE RELIABLE, THE ARCHITECT SUMED NO RESPONSIBILITY FOR THE ACCURACY OF THESI AWINGS FOR ANY ERORS OR OMISSIONS THAT MAY HAVE EEN INCORPORATED INTO IT AS A RESULT OF INCORRECT ORMATION PROVIDED TO THE ARCHITECT. THOSE RELYING THIS DOCUMENT ARE ADVISED TO OBTAIN VERIFICATION CACCURACY. ALL WORK SHALL COMPLY WITH ANY AND ALLICABLE CODES AND ORDINANCES. SUPERINTENDENTS AND ALL SUMETIVE AND SULL DING TECHNIQUES HELD WITH THE PART OF THE P

1449 SW 74th DR, SU. 200 / GAINESVILE, FL 32607
LICENCE# CGC-1515491
PH: 877-309-1091/CANGENITE NICENTER AND CONFORMED SINCE A

AR GENERAL
US HWY 27
WHITE, FL 32038

DOLLAR GE
US HWY
FT WHITE, FL
STORE # 258

DRAWING DATE: / DRAWN BY:

4/5/24 - KWH

REVISION DATE: / REVISED BY:

PROJECT NUMBER:
4000.249

DRAWING TITLE:


REGISTER POWER POLE

E1.4

St. Petersburg, FL 3370

Hunter Design FL CA #31946 & CONSULTING GA CA #PEF007171

sealed and the signature must be verified on any electronic copies.

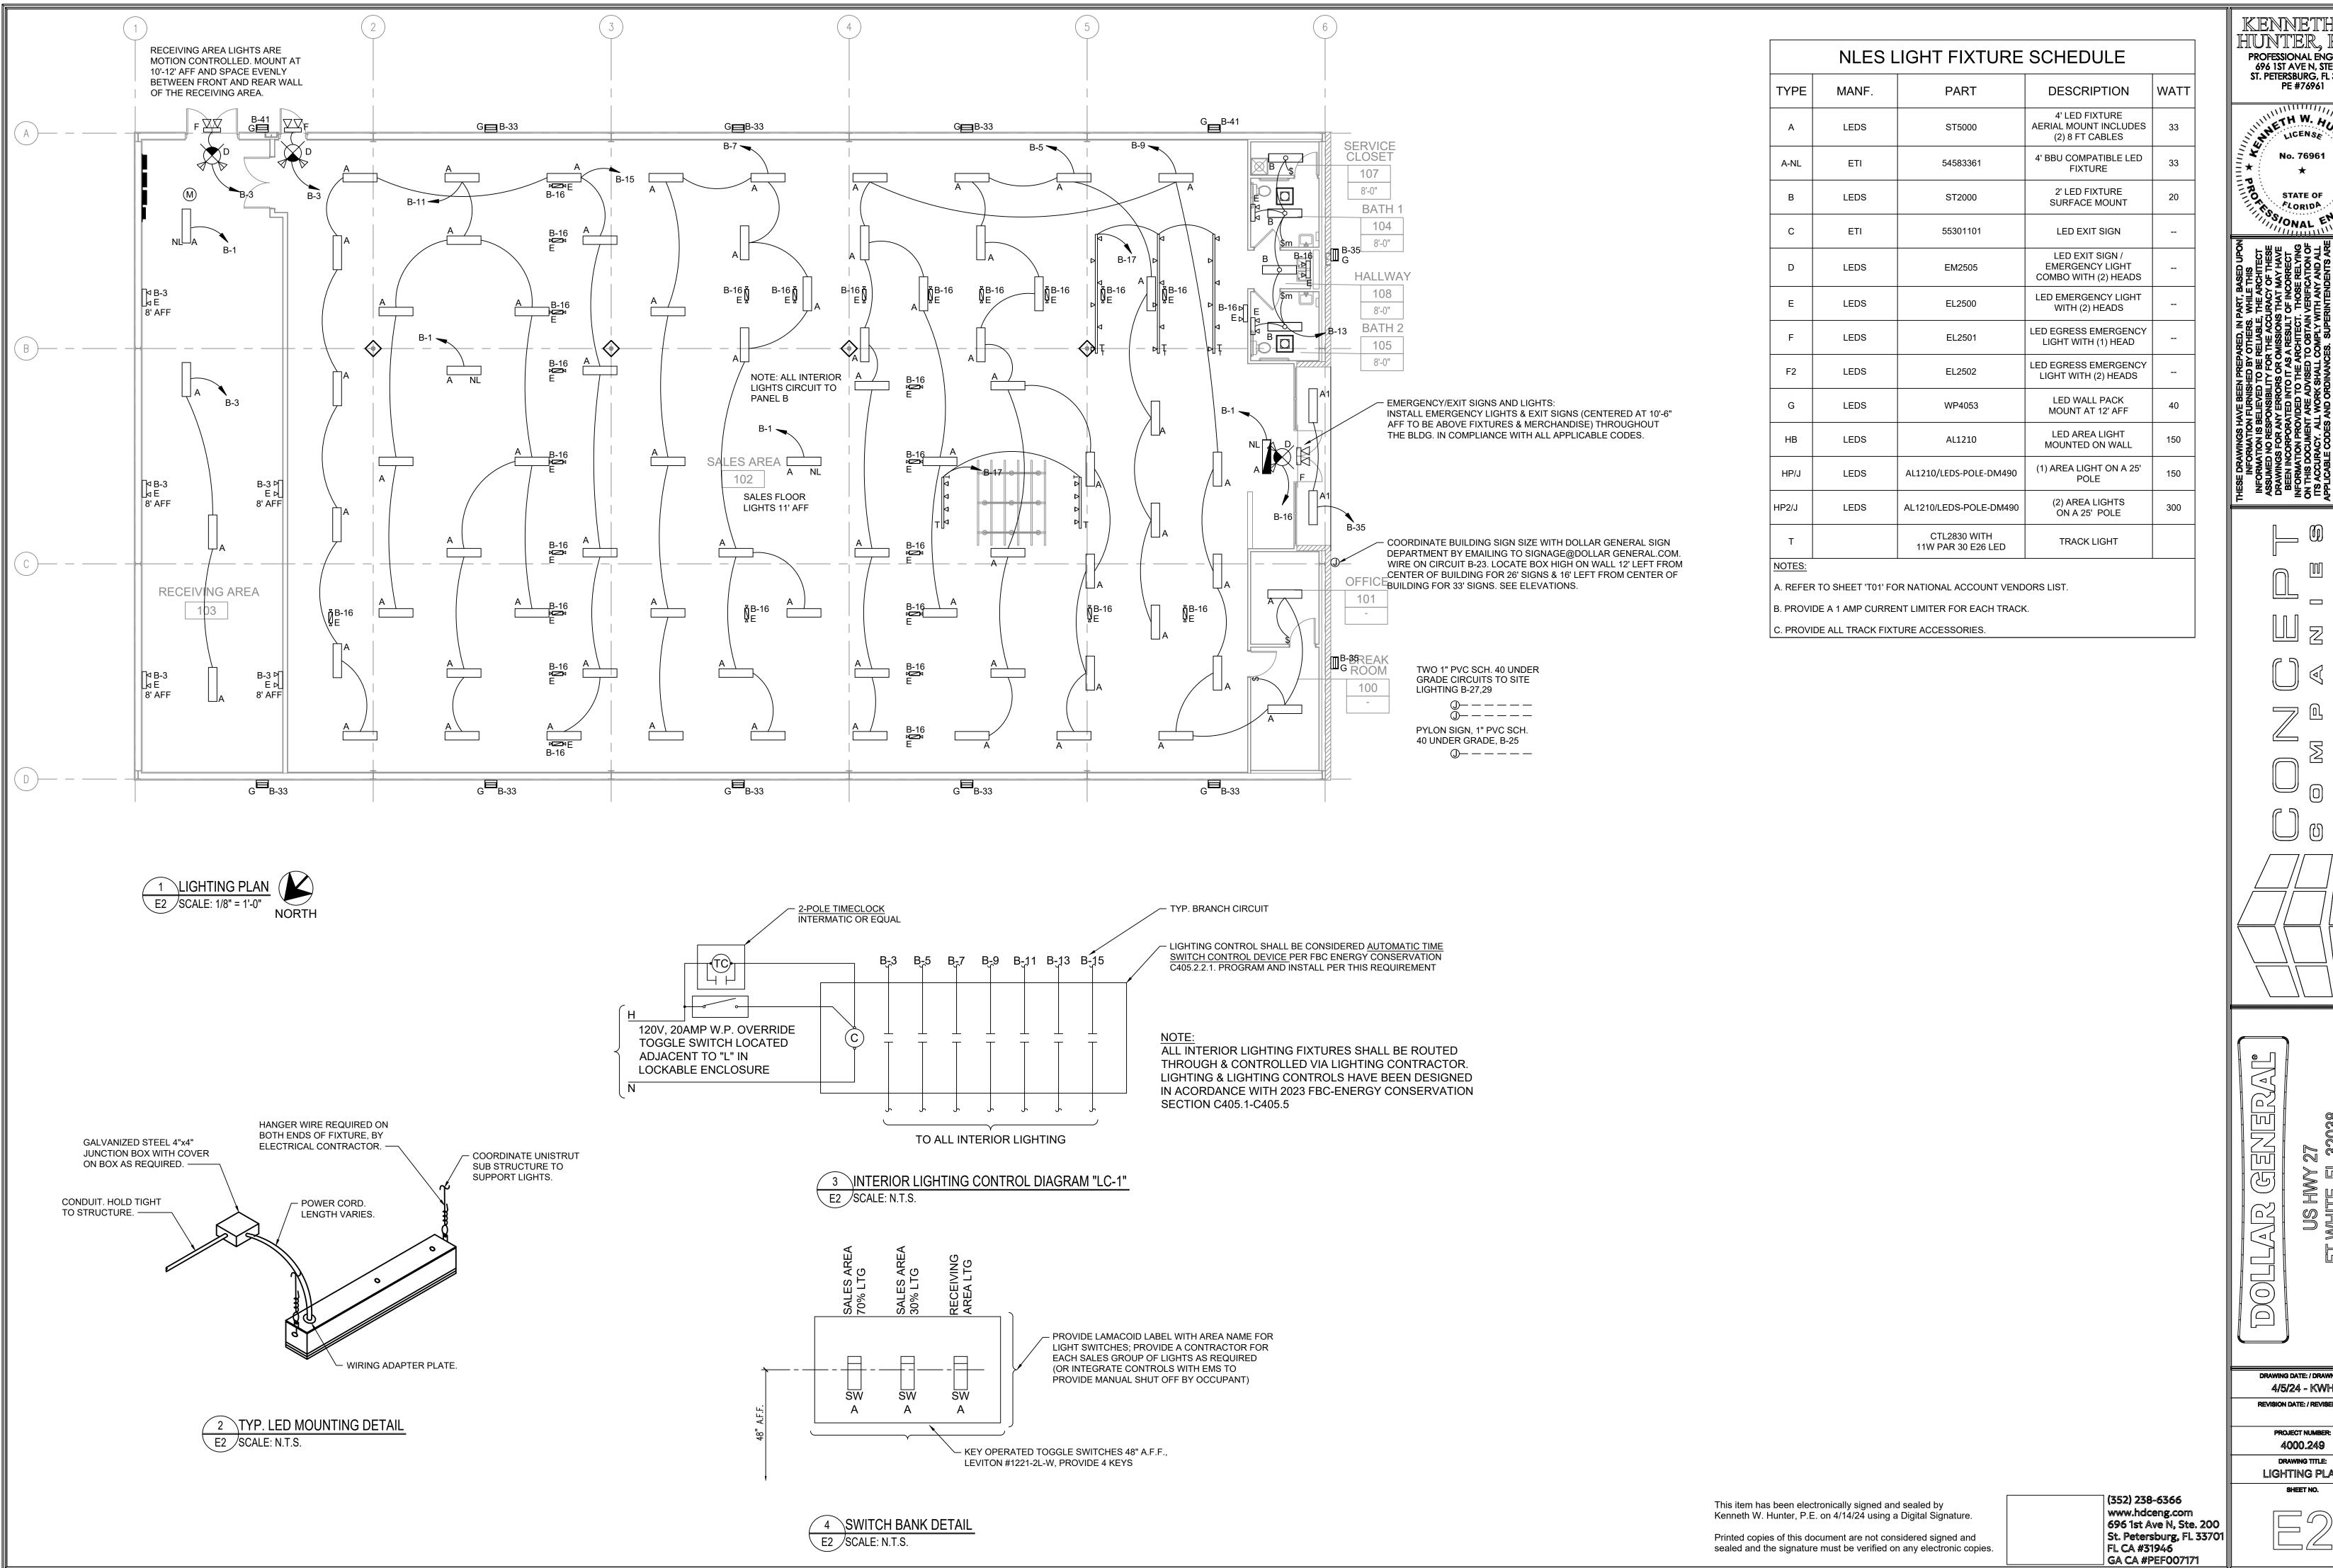

PROFESSIONAL ENGINEER 696 1ST AVE N, STE 200 ST. PETERSBURG, FL 33701

ETH W. HU

DRAWING DATE: / DRAWN BY: 4/5/24 - KWH REVISION DATE: / REVISED BY:


PROJECT NUMBER: LIGHTING PLAN


PAN	EL "A"	120/208V, 3-PHASE, 4-WIRE			600A FF	RAME, 50	00A MCE	3		SURFACE MOUNT	NEM	A 1
CKT#	LOAD (WATTS)	DESCRIPTION	(СВ	TOTAL P	IN WATTS	(СВ	DESCRIPTION	LOAD (WATTS)	CKT#	
	(11/11/0)		AMP	POLE	Α	В	С	AMP	POLE		(WATTS) 100 360 180 180 180 180 100 100 500 500 960	
1	8260				8360			20	1	AUTOMATIC DOOR	100	2
3	8260	HVAC UNIT # 1	90	3		8620		20	1	TELEPHONE BOARD/BUZZER	360	4
5	8260						8440	20	1	ENERGY MANAGEMENT	180	6
7	8260				8440			20	1	OUTDOOR HVAC RECEP.	180	8
9	8260	HVAC UNIT # 2	90	3		8440		20	1	OUTDOOR DRINK VENDING	180	10
11	8260						8440	20	1	OUTDOOR CONVRECEPT.	180	12
13	3840				3940			20	1	EXHAUST FAN	100	14
15	3840	HVAC UNIT # 3	40	3		3940		20	1	EXHAUST FAN	100	16
17	3840						4340	20	1	INTERFACE EQUIP.	500	18
19	1800	HAND DRYER	20	1	2300			20	1	VSAT, DATA HUB EQUIP.	500	20
21	1800	HAND DRYER	20	1		2760		20	1	CCTV EQUIP.	960	22
23		\$PARE	20	1			0	20	1	SPARE		24
25	1650	WATER HEATER	20	1	1650			20	1	SPARE		26
27		SPARE	20	1		0		20	1	SPARE		28
29	500	DRINKING FOUNTAINS	20	1			500	20	1	SPARE		30
31	1200	OUTDOOR ICE MERCHANDISER	20	1	25725						24525	32
33		SPARE	20	1		23609		225	3	PANEL "R"	23609	34
35	960	SODA COOLERS	20	1			26468	1			25508	36
37	1600	DRINK COOLERS	20	1	8646						7046	38
39	1600	SODA COOLERS	20	1		6869		150	3	PANEL "B"	5269	40
41		SPARE	15	1			9327	1			9327	42
	* LI	ANDLE LOCK ON DEVICE		TOTAL	59061	54238	57515		<u> </u>	TOTAL CONNECTED	= 170814	WATTS
	• • • • • • • • • • • • • • • • • • • •	ANDEL LOOK ON DEVICE		,				_			474	AMPS

			LOAD SUMMARY		
208V	3-PHASE	, 4-WIRE	CAPACITY: 500 AMP		
TVDE	CONNECTED	DEMAND	DEMAND FORMULA	TOTAL	LOAD
DAD TYPE	CONNECTED	DEIMAND	DEIMAND FORMULA	CONNECTED	DEMAND
ITING	8.38 KW	10.47 KW	LOAD x 125% (NEC 210.19 CONTINUOUS)		
EPT.	19.40 KW	14.70 KW	10KVA + 50% REMAINDER (NEC220.44)	170.81 KW	168.21 KW
/AC	61.28 KW	61.28 KW	LOAD x 100%	7	
SC	81.76 KW	81.76 KW	LOAD x 100% (NEC 210.19 NON-CONT)		
IP	0.00 KW	0.00 KW	0 NONCOINCIDENTAL LOADS (NEC 220.60)	474.13 AMPS	466.90 AMPS
81	.76 KW	81.76 KW	LOAD x 100% (NEC 210.19 NON-CONT)	474.13 AMPS	466.90 AMPS

PAN	EL "B"	120/208V, 3-PHASE, 4-WIRE			1	50A ML	0			SURFACE MOUNT	NEM	A 1
CKT#	LOAD (WATTS)	DESCRIPTION		СВ	TOTAL PI	ER PHASE	IN WATTS	(СВ	DESCRIPTION	LOAD (WATTS)	CKT#
	(711 (110)		AMP	POLE	Α	В	С	AMP	POLE		(1.1.1.10)	
1	132	NIGHT LIGHTS	20	1	132			20	1	SPARE		2
3	198	RECEIMNG LIGHTS	20	1		698		20	1	SECURITY RECEP.	500	4
5	627	70% SALES LIGHTS - ROWS 2 & 3	20	1			1167	20	1	OFFICE RECEPS.	540	6
7	495	70% SALES LIGHTS - ROWS 5 & 6	20	1	1035			20	1	BREAK RM. RECEPS.	540	8
9	845	30% SALES LIGHTS - ROWS 1 & 4	20	1		845		20	1	SPARE		10
11	396	70% SALES LIGHTS - ROWS 8 & 9	20	1			396	20	1	SPARE		12
13	159	BREAK RM./OFF./R.R. LIGHTS	20	1	1379			20	1	AIR CURTAIN	1220	14
15	396	30% SALES LIGHTS - ROWS 7 & 10	20	1		446		20	1	EMERGENCY/EXIT LIGHTS	50	16
17	300	TRACK LIGHTING	20	1			300	20	1	SPARE		18
19		SPARE	20	1	0			20	1	SPARE		20
21		SPARE	20	1		0		20	1	SPARE		22
23	900	BUILDING SIGN	20	1			900	20	1	SPARE		24
25	900	PYLON SIGN	20	1	900			20	1	SPARE		26
27	300	SITE LIGHTING	20	1		300		20	1	SPARE		28
29	1400	SITE LIGHTING	20	1			2600	20	1	POWER TERMINAL BROWN	1200	30
31		SPARE	20	1	1200			20	1	POWER TERMINAL BROWN	1200	32
33	400	LEFT SIDE EXT. WALL LTS	20	1		1600		20	1	POWER TERMINAL GREEN	1200	34
35	600	FRONT EXT. WALL/CANOPY LTS	20	1			1800	20	1	POWER TERMINAL GREEN	1200	36
37		SPARE	20	1	1200			20	1	POWER TERMINAL GREEN	1200	38
39		SPARE	20	1		1200		20	1	POWER TERMINAL GREEN	1200	40
41	100	EXTERIOR DUSK/DAWN	20	1			1300	20	1	POWER TERMINAL BROWN	1200	42
43		SPARE	20	1	1200			20	1	POWER TERMINAL BROWN	1200	44
45		SPARE	20	1		0		20	1	SPARE		46
47		\$PARE	20	1			0	20	1	SPARE		48
49		\$PARE	20	1	0			20	1	SPARE		50
51		SPARE	20	1		180		20	1	DISPLAY LIGHT	180	52
53		SPARE	20	1			864	20	1	GATORADE	864	54
		ANDLE LOCK ON DEVICE		TOTAL	7046	5269	9327			TOTAL CONNECTED =	21642	WAT

	PAN	IEL "R"	120/208V, 3-PHASE, 4-WIRE			2	25A ML	0			SURFACE MOUNT	NEMA 1		
	CKT#	LOAD (WATTS)	DESCRIPTION	(СВ	TOTAL P	ER PHASE	IN WATTS	(СВ	DESCRIPTION	LOAD (WATTS)	CKT#	
		(44/110)		AMP	POLE	Α	В	С	AMP	POLE		(88/110)		
*	1	1300	A-1-A REACH-IN DAIRY CASE	20	2	4514			40	2	A-2-A REACH-IN FROZEN CASE	3214	2	*
	3	1300	ATTAINEACHTIN DAINT CASE	20	-		4514		1 🕶		AZ-AREACH-IN PROZEN GASE	3214	4	
*	5	1300	A-1-B REACH-IN DAIRY CASE	20	2			4514	40	2	A-2-B REACH-IN FROZEN CASE	3214	6	*
	7	1300	AT-B REACH-IN DAIRT CASE	20		4514			1 "`		A-Z-B REACH-IN FROZEN CASE	3214	8	
	9		SPARE	20	2		3214		40	2	A-2-C REACH-IN FROZEN CASE	3214	10	*
	11		SFARE	20	-			3214	1 40		A2-C REACTI-INT ROZEN CASE	3214	12	
	13		SPARE	20	2	3214			40	2	A-3 REACH-IN FROZEN CASE	3214	14	*
	15		OFARE	20	-		3214		1 🕶		AS REACHINT ROZEN CASE	3214	16	
*	17	1150	PRODUCE COOLER	15	1			4364	40	2	72" FREEZER	3214	18	*
*	19	1150	MEAT COOLER	15	1	4364] ~		72 TIVLLELIN	3214	20	
*	21	3120	MEAT COOLER	35	2		7280		50	2	PRODUCE COOLER	4160	22	*
	23	3120	WEAT GOOLEN	33	_			7280] ~		TROBUGE GOOLER	4160	24	
*	25	1123	REACH IN DAIRY CASE	20	2	2205			20	2	FREEZER CU	1082	26	*
	27	1123	NEXOTIN DAILY GAGE	20			2205]		TREEZER GO	1082	28	
	29		SPARE	20	1			1300	20	2	COOLER	1300	30	*
*	31	1200	COOLER LGTS/HEATER	20	1	2500] [-	OOOLEN	1300	32	
*	33	1200	FREEZER LGTS/HEATER	20	1		1560		20	1	SERVICE RECEPS ON ROOF	360	34	
	35		SPARE	15	2			3214	40	2	FROZEN CASE	3214	36	*
	37		OI / NAC	'	_	3214]		TROZEN GAGE	3214	38	
*	39	1622	COOLER CU	25	2		1622		20	1	SPARE		40	
	41	1622						1622	20	1	SPARE		42	
* HANDLE LOCK ON DEVICE						24525	23609	25508			TOTAL CONNECTED =	73642	WATTS	
												204	AMPS	ĺ

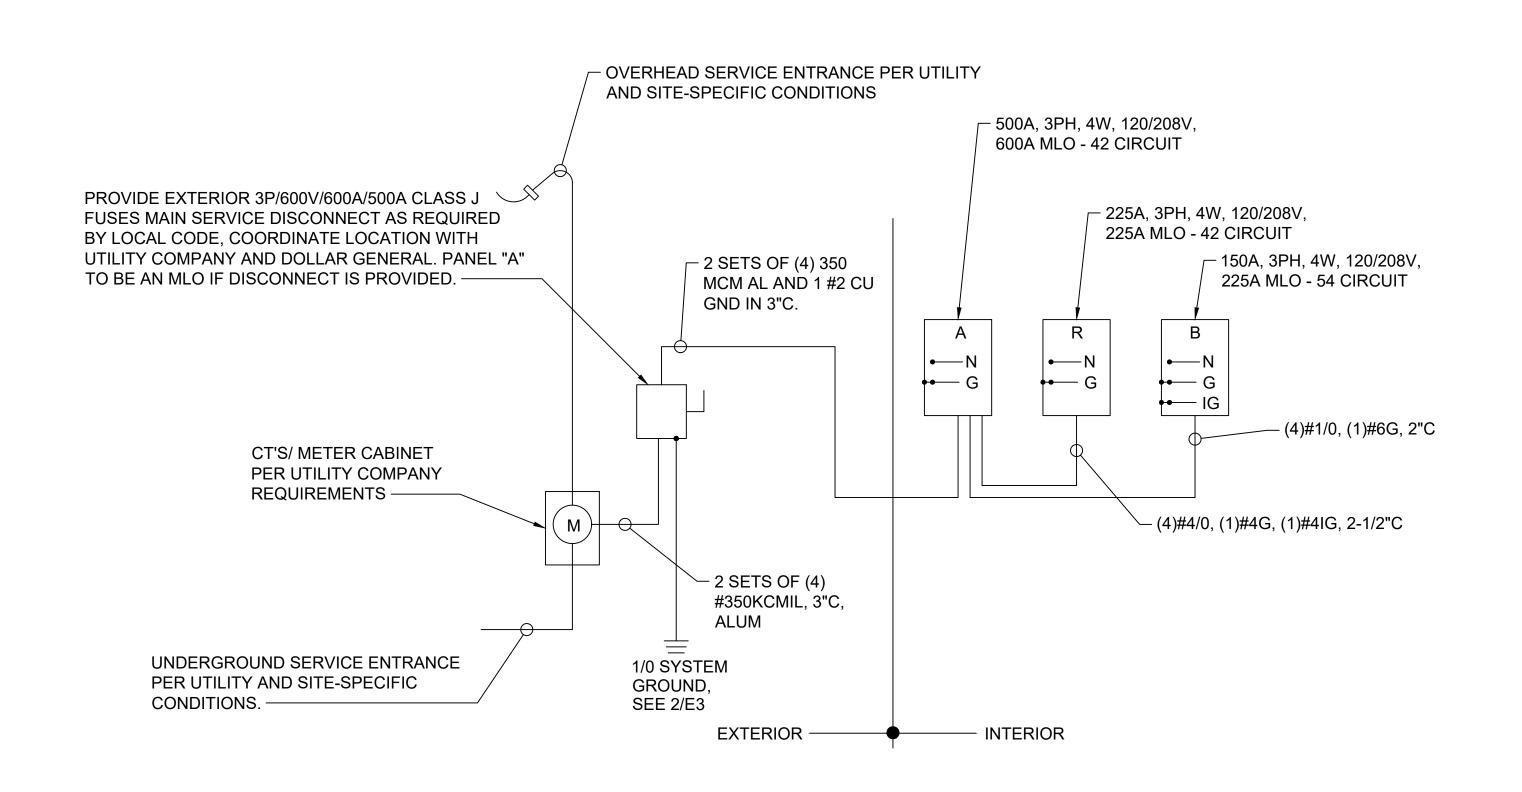

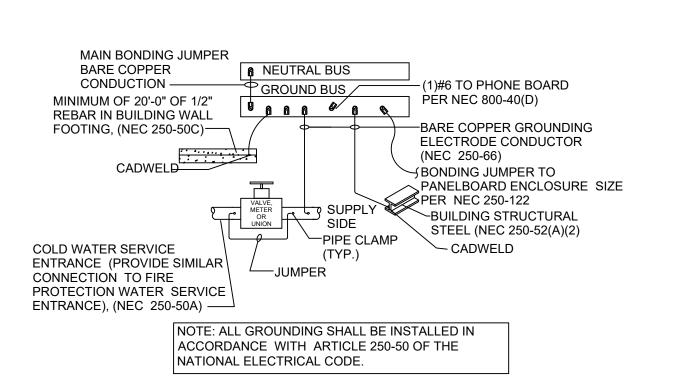


This item has been electronically signed and sealed by Kenneth W. Hunter, P.E. on 4/14/24 using a Digital Signature.

Printed copies of this document are not considered signed and sealed and the signature must be verified on any electronic copies.



PROFESSIONAL ENGINEER
696 1ST AVE N, STE 200
ST. PETERSBURG, FL 33701
PE #76961

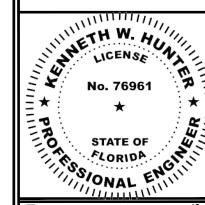

INFORMATION FURNISHED BY OTHERS. WHILE THIS INFORMATION FURNISHED BY OTHERS. WHILE THIS INFORMATION IS BELIEVED TO BE RELIABLE, THE ARCHITECT SSUMED NO RESPONSIBILITY FOR THE ACCURACY OF THESE PRAWINGS FOR ANY ERRORS OR OMISSIONS THAT MAY HAVE BEEN INCORPORATED INTO IT AS A RESULT OF INCORRECT IFORMATION PROVIDED TO THE ARCHITECT. THOSE RELYING INTHIS DOCUMENT ARE ADVISED TO OBTAIN VERIFICATION OF SACCURACY. ALL WORK SHALL COMPLY WITH ANY AND ALL PLICABLE CODES AND ORDINANCES. SUPERINTENDENTS ARE TO VERIFY ALL DIMENSIONS PRIOR TO CONSTRUCTION. ALL CORMATION, DESIGN AND BUILDING TECHNIQUES HELD WITHIN ETHE EXCLUSIVE PROPERTY OF THE PARTIES NOTED ON THIS

DOLLAR GENERAL
US HWY 27
FT WHITE, FL 32038
STORE # 25861
STORE # 25861


DRAWING DATE: / DRAWN BY:
4/5/24 - KWH
REVISION DATE: / REVISED BY:

PROJECT NUMBER:
4000.249

DRAWING TITLE:

DRAWING TITLE:
DGHP ELECTRICAL PANELS
SHEET NO.


E3

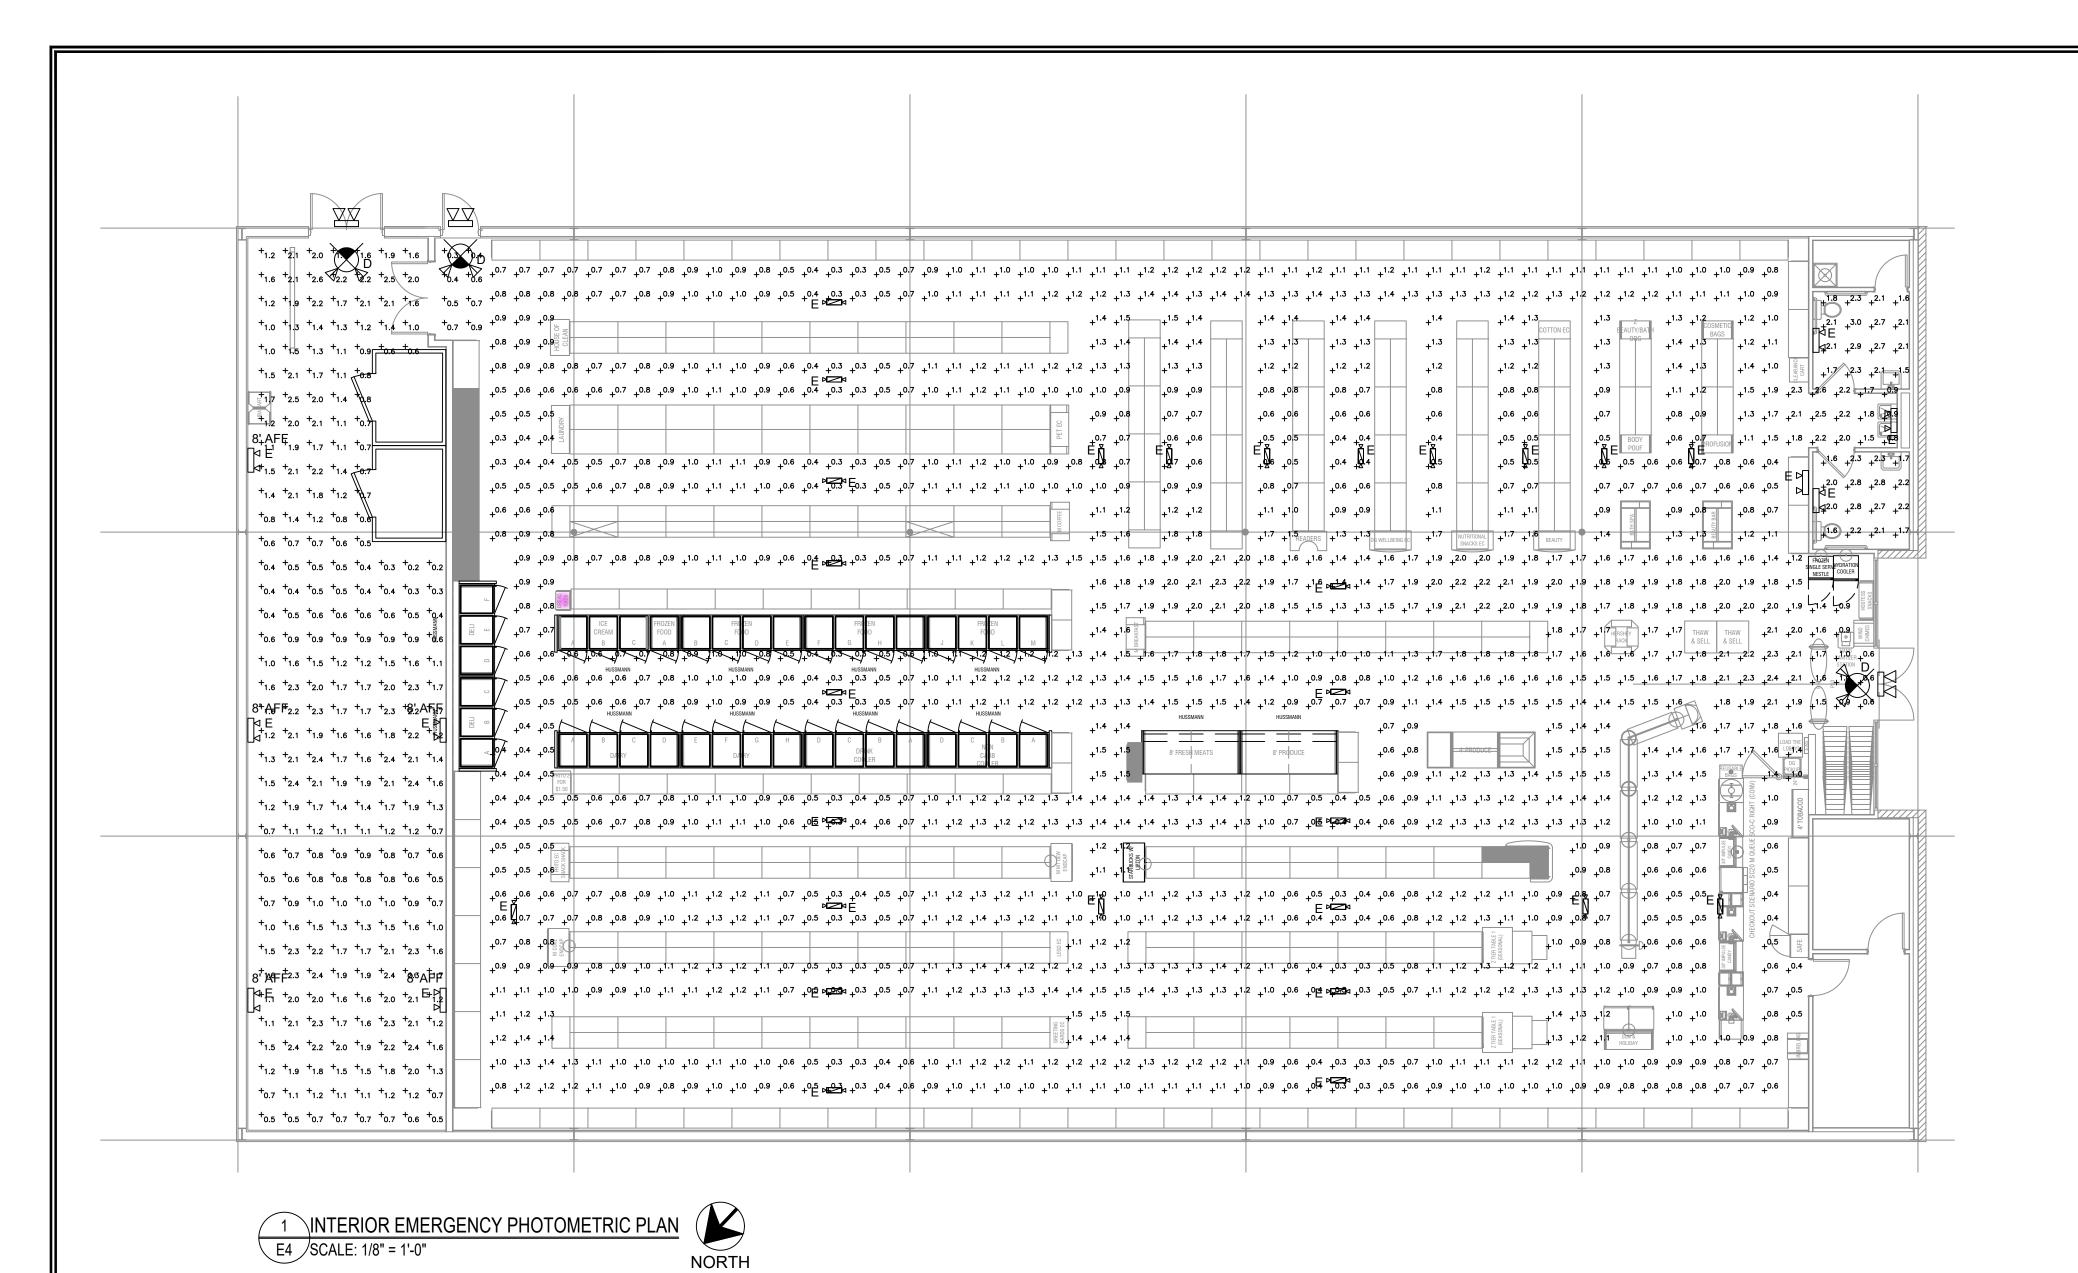


Emergency Egress Photometric Statistics												
Description	Symbol	Avg	Max	Min	Max/Min	Avg/Min						
SALES AREA EGRESS	+	1.1 fc	2.6 fc	0.3 fc	8.7:1	3.7:1						
RR 104 EGRESS	+	2.2 fc	3.0 fc	1.5 fc	2.0:1	1.5:1						
RR 104 EGRESS	+	2.2 fc	2.8 fc	1.6 fc	1.8:1	1.4:1						
RECEIVING EGRESS	+	1.3 fc	2.6 fc	0.4 fc	6.5:1	3.3:1						

Fixture	ixture Schedule for Emergency Egress Photometrics											
Symbol	Label	QTY	Manufacturer	Catalog Number	Description	Lamp	Filename	Lumens per Lamp	LLF			
×	D	3	LEDS-LLC	EM2505	COMBINATION EXIT/EMERGENC	ULTRA BRIGHT LED	EU2C.ies	125	1			
	E	36	LEDS-LLC	E2500	LED TWIN-HEAD UNIT	ULTRA BRIGHT LED	EU2C.ies	125	1			

KENNETH W. HUNTER, P.E. PROFESSIONAL ENGINEER 696 1ST AVE N, STE 200 ST. PETERSBURG, FL 33701 PE #76961

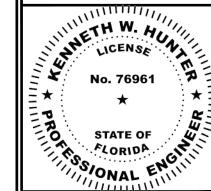

U o

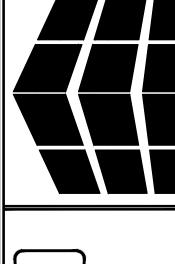

GENERAL


DOLL

DRAWING DATE: / DRAWN BY 4/5/24 - KWH

REVISION DATE: / REVISED BY: PROJECT NUMBER: 4000.249

EMERGENCY PHOTOMETRIC PLANS
SHEET NO.

(352) 238-6366 www.hdceng.com 696 1st Ave N, Ste. 200

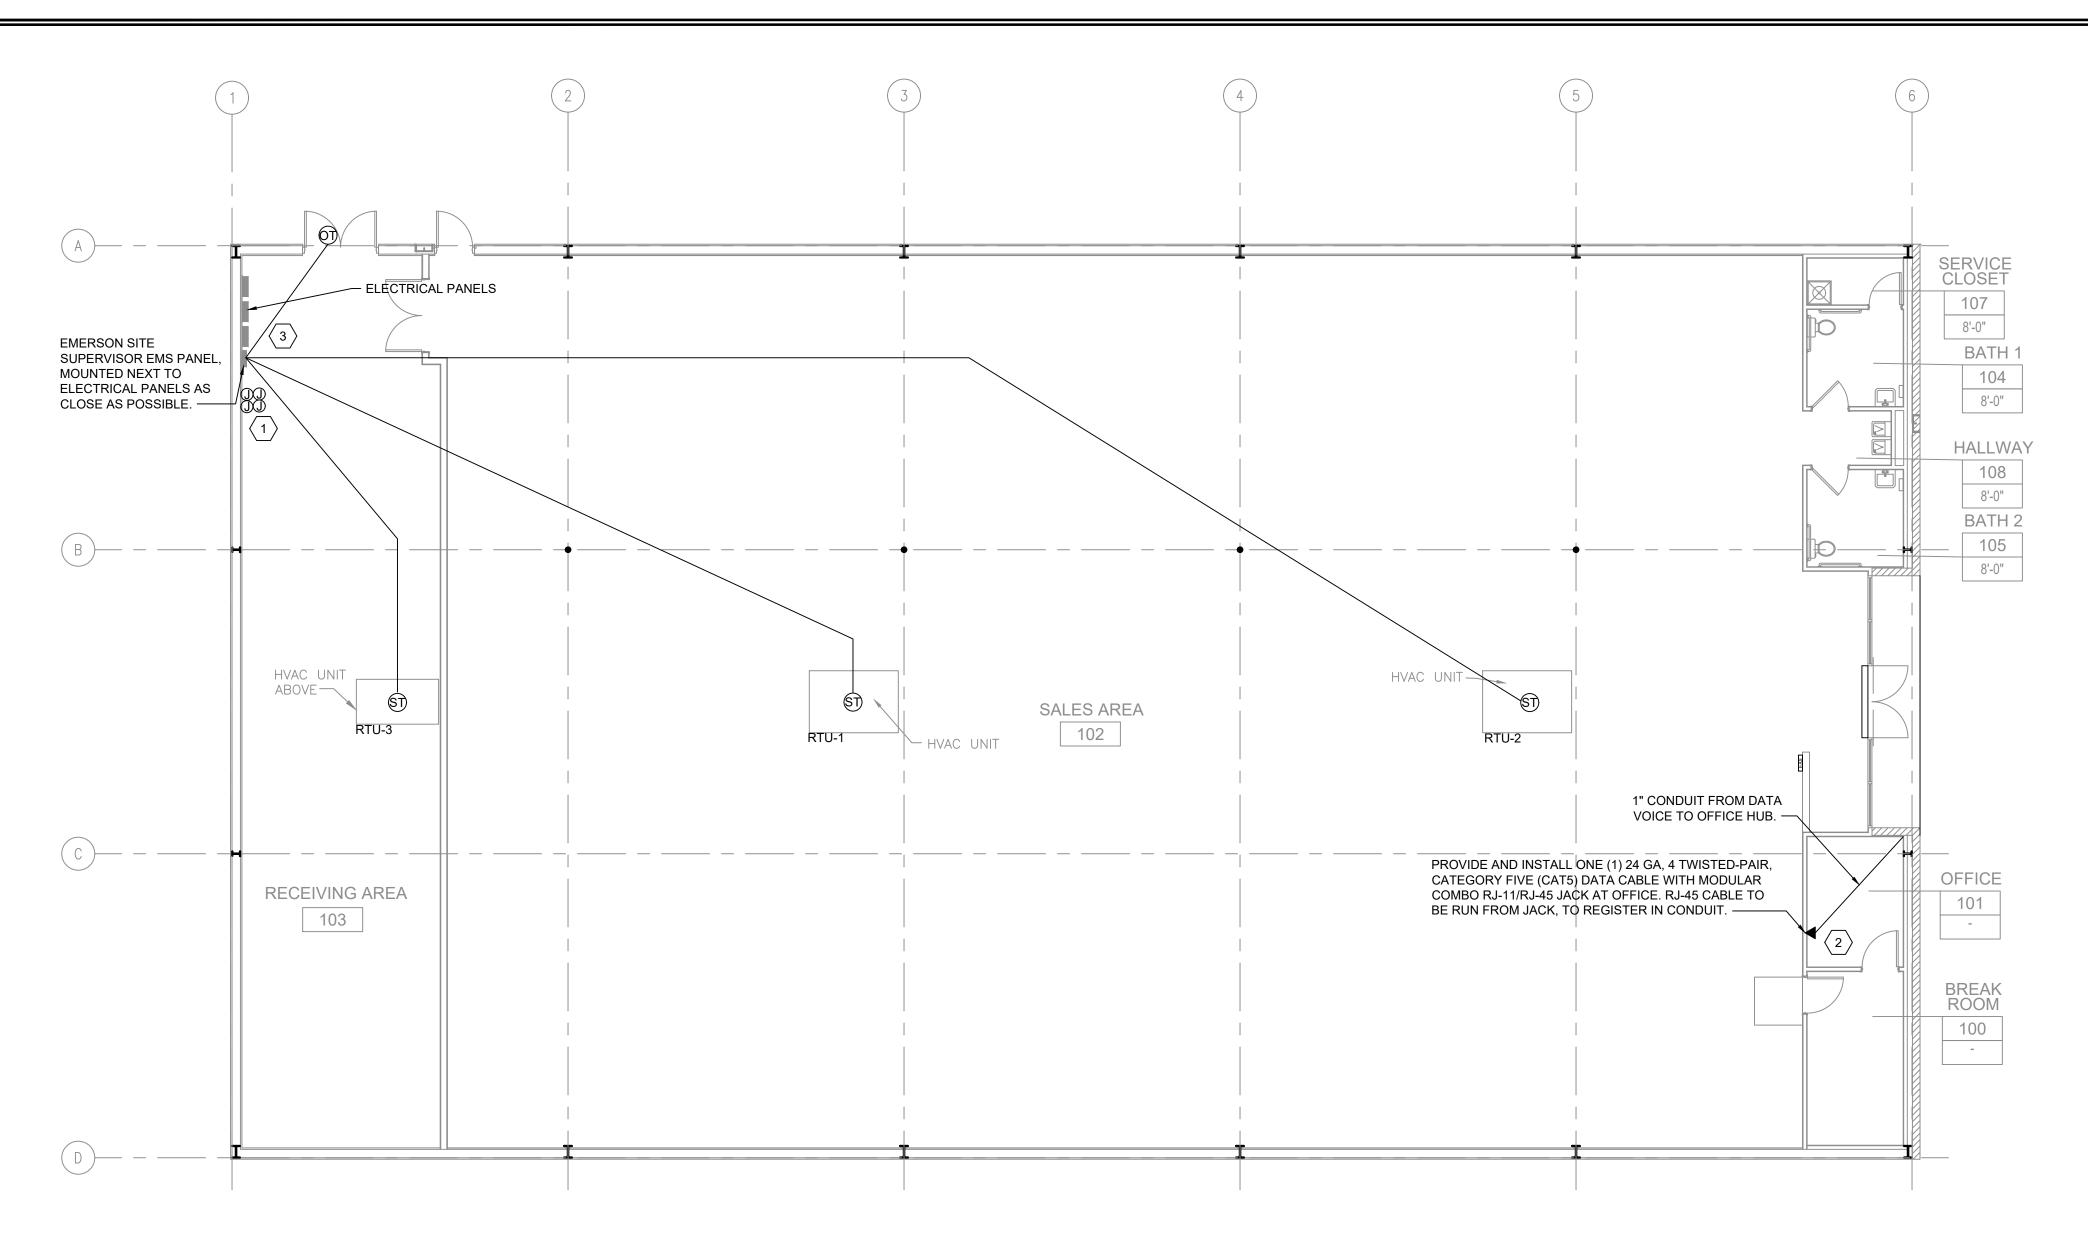

1 EMS LOW VOLTAGE PLAN EMS1/SCALE: 1/8" = 1'-0" NORTH **GENERAL NOTES:**

- A. REFER TO E1 FOR GENERAL CONTRACTOR RESPONSIBILITIES. E.C.MAY USE CABLE TRAY FOR LOW VOLTAGE CABLES, SEE 2/E2.
- B. RUN CONDUIT FROM SENSORS TO BOTTOM OF STRUCTURE.
- C. REFRIGERATION UNITS TO BE CONNECTED TO EMS PANEL BY DOLLAR GENERAL REFRIGERATION CONTRACTOR.
- D. PLAN IS DIAGRAMIC ONLY. HOLD CONDUIT TIGHT TO EXPOSED MAIN GIRTS AND RUN AS HIGH AS POSSIBLE ALONG PERIMETER WALLS TO RECEIVING AREA.
- E. REFER TO M1 FOR LOCATIONS OF THERMOSTATS.

PLAN NOTES:

- TEST/RESET STATION FOR STAND ALONE DUCT DETECTOR. ONE FOR EACH DEVICE, SEE KEY NOTE 3 ON SHEET E1.2. SIMPLEX #4098-9842 IS SPECIFIED WITH PIEZO AND LED INDICATOR LIGHT.
- 2. PHONE LINE #1 TWO RJ-11 PORTS. ONE (1) LOCATED IN OFFICE W/RJ-45 DATA JACK COMBO AND ONE (1) AT REGISTER. 24 GA. CAT 5, 4-PAIR TWISTED WIRE ONLY. USE BLUE AND BLUE & WHITE WIRES. HOOK TO LINE #1 TERMINAL IN RJ-11 JACK EACH PHONE JACK TO HAVE DEDICATED, SEPARATE HOME RUN TO DMARC. LABEL AS "PHONE" AT THE DESTINATION AND AT DMARC. PHONE COMPANY PROVIDES FINAL HOOK UP TO DMARC ONLY.PHONE LINE #2 - RJ-11 PHONE JACK SUPPLIED AND WIRED BY CONTRACTOR.
- 3. EMS REFRIGERATION PANEL CX E2 400. PANEL BY OTHERS. CONNECTION FROM THIS PANEL TO HVAC AND LIGHTING PANEL BY OTHERS. ELECTRICAL CONTRACTOR TO RUN AN EMPTY 1-1/2"C. WITH PULL ROPE BETWEEN THE TWO

EMS NOTES:

- A. EMS SUPPLIER NOTE: CUSTOMIZED DOLLAR GENERAL EMS PANEL REQUIRES STORE #, CITY, STATE, ZIP CODE & QTY. OF HVAC UNITS OF THE INSTALL SITE WHEN ORDERING. EMS SYSTEMS INSTALLATION GUIDE WITH PHOTOS IS AVAILABLE ON NATIONAL ACCOUNT WEBSITE, ALL QUESTIONS PERTAINING TO THE EMS PANEL, SYSTEM INSTALLATION & SETUP SHOULD BE DIRECTED TO EMERSON'S DOLLAR GENERAL SUPPORT TEAM AT 770-425-2724.
- B. ALL SIGN & LIGHTING CIRCUITS MUST BE FED THROUGH THE DESIGNATED CONTACTORS AS NOTED ON THIS PAGE.
- C. ALL LOW VOLTAGE HVAC & DOOR SENSORS MUST BE CONNECTED TO THE PROPER TERMINAL. 24 GA. SHIELDED (SHIELD MUST BE GROUNDED) CABLE, BELDEN #8641, 2 CONDUCTOR WIRE OR IT'S EQUIVALENT IS REQUIRED.
- D. COOLER & FREEZER HOME RUNS WILL BE TERMINATED AT ALL POINTS BY DOLLAR GENERAL REFRIGERATION DEPARTMENT.
- E. CONTACT EMERSON FOR FULL DETAILS. CONTACT NATIONAL ACCOUNT MANAGER BRAD KYLE, (770) 425-2724 OPTION 4, BRAD.KYLE@EMERSON.COM

TESTING NOTES:

- A. TESTING OF HVAC UNITS THRU EMS PANEL IS ACCOMPLISHED BY SIMPLY WARMING UP OR COOLING DOWN A SPACE TEMPERATURE SENSOR (USING A BLOW DRYER OR ELECTRONIC EQUIPMENT DUSTER AEROSOL) AND WATCH THE FAN, HEAT AND COOL STAGES CYCLE ON AND OFF. THIS REQUIRES TWO PEOPLE AT ALL TIMES....ONE TO WATCH THE SCREEN AND THE OTHER TO WATCH OPERATION OF THE AHU. WHEN COMPLETE, PRESS THE HOME BUTTON TO RETURN TO THE MAIN SCREEN.
- B. EMS SYSTEM SHOULD BE TESTED FOR HVAC OPERATION, INTERIOR LIGHTING, EXTERIOR LIGHTING AND SIGN LIGHTING PRIOR TO CONTRACTOR'S ELECTRICAL POSSESSION DATE. USE OUTSIDE LIGHT AND SIGN LIGHT OVERRIDE FOR EXTERIOR TESTING.

	DEVICE SCHEDULE												
YMB	DESCRIPTION	CABLE TYPE	SUPPLIER	INSTALLER	NOTES								
OT)	OUTDOOR AIR TEMP MOUNTED 8'-0" A.F.F.	BELDEN 8761 OR EQUIVALENT (22AWG, 2C, STRANDED, SHIELDED)	EMS SUPPLIER	GENERAL CONTRACTOR	(1) PER RECEIVING ENTRY								
S T	SUPPLY TEMP (501-1121) IN SUPPLY DUCT	BELDEN 8761 OR EQUIVALENT (22AWG, 2C, STRANDED, SHIELDED)	EMS SUPPLIER	GENERAL CONTRACTOR	(1) PER HVAC UNIT								
TS)	TEMP SPACE SENSOR (809-6590) 8'-0" A.F.F.	BELDEN 8761 OR EQUIVALENT (22AWG, 2C, STRANDED, SHIELDED)	EMS SUPPLIER	GENERAL CONTRACTOR	(1) PER HVAC UNIT ZONE								
0	RJ-11/RJ-45 DATA JACK PHONE COMBO	CAT-5 DATA CABLE (24AWG, 4 TWISTED PAIR)	GENERAL CONTRACTOR	GENERAL CONTRACTOR	(1) AT OFFICE COMPUTER CART								

This item has been electronically signed and sealed by Kenneth W. Hunter, P.E. on 4/14/24 using a Digital Signature. Printed copies of this document are not considered signed and


St. Petersburg, FL 337 Hunter Design FL CA #31946 CONSULTING GA CA #PEF007171

KENNETH W PROFESSIONAL ENGINEER

696 1ST AVE N, STE 200

ST. PETERSBURG, FL 33701 PE #76961

ETH W. HU LICENSE CORIDA SONAL F

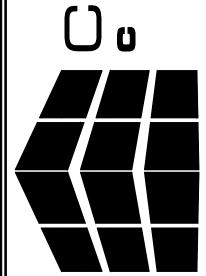


GENER/ DOLL

4/5/24 - KWH REVISION DATE: / REVISED BY:

PROJECT NUMBER:

4000.249 DRAWING TITLE: EMS LOW VOLTAGE PLAN


sealed and the signature must be verified on any electronic copies.

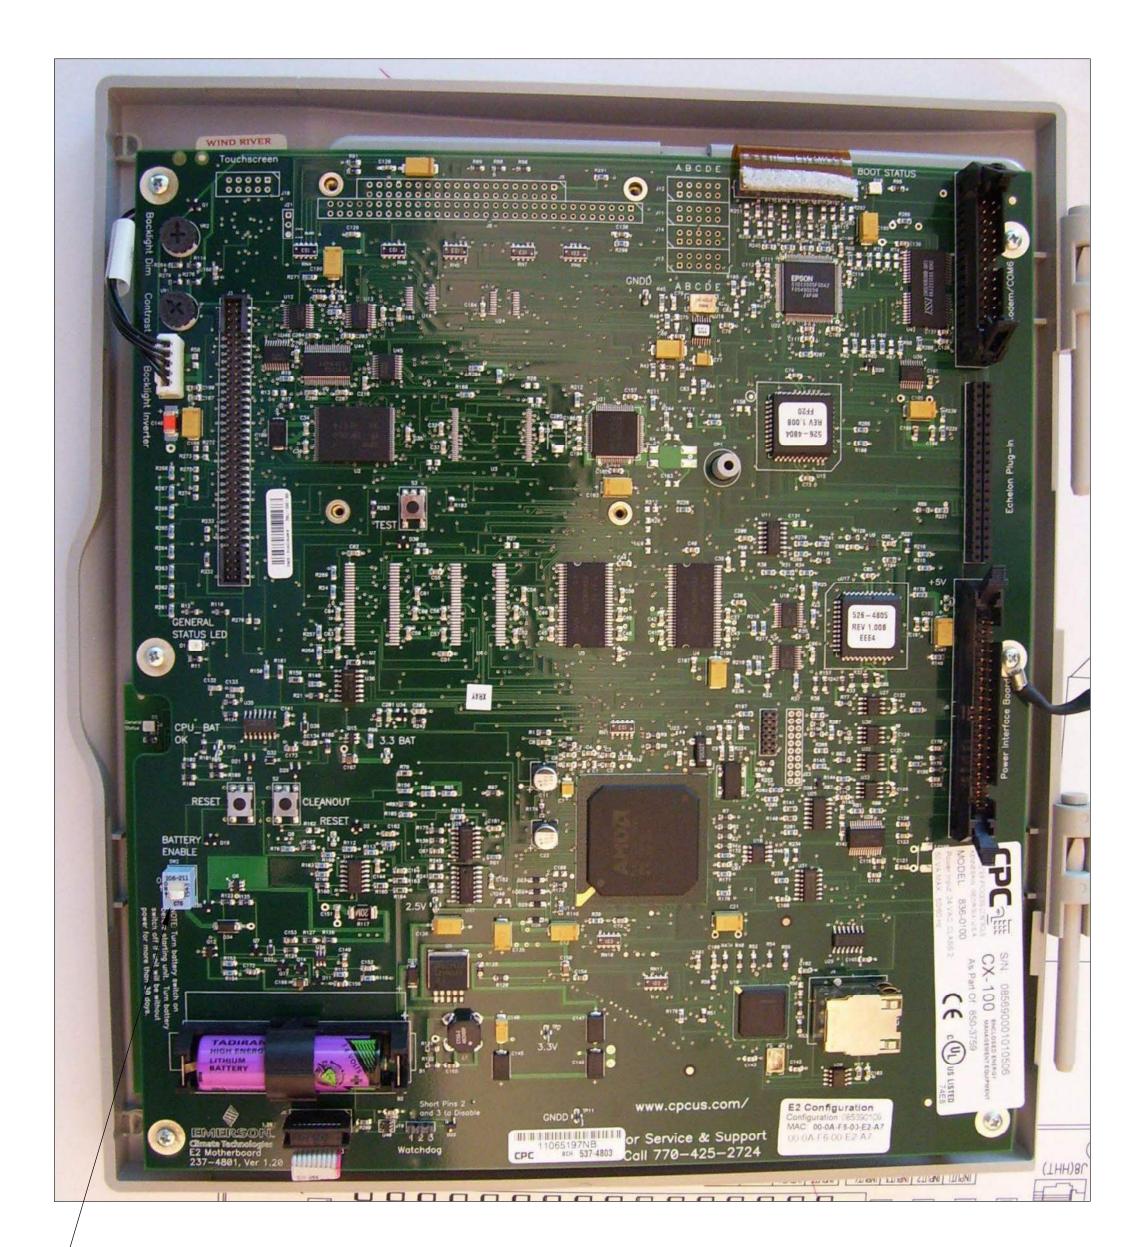


- GENERAL CONTRACTOR TO ENSURE THAT THE BATTERY ENABLE IS SWITCHED TO "ON" POSITION

1 CPU TERMINAL DIAGRAM

EMS2/SCALE: N.T.S.

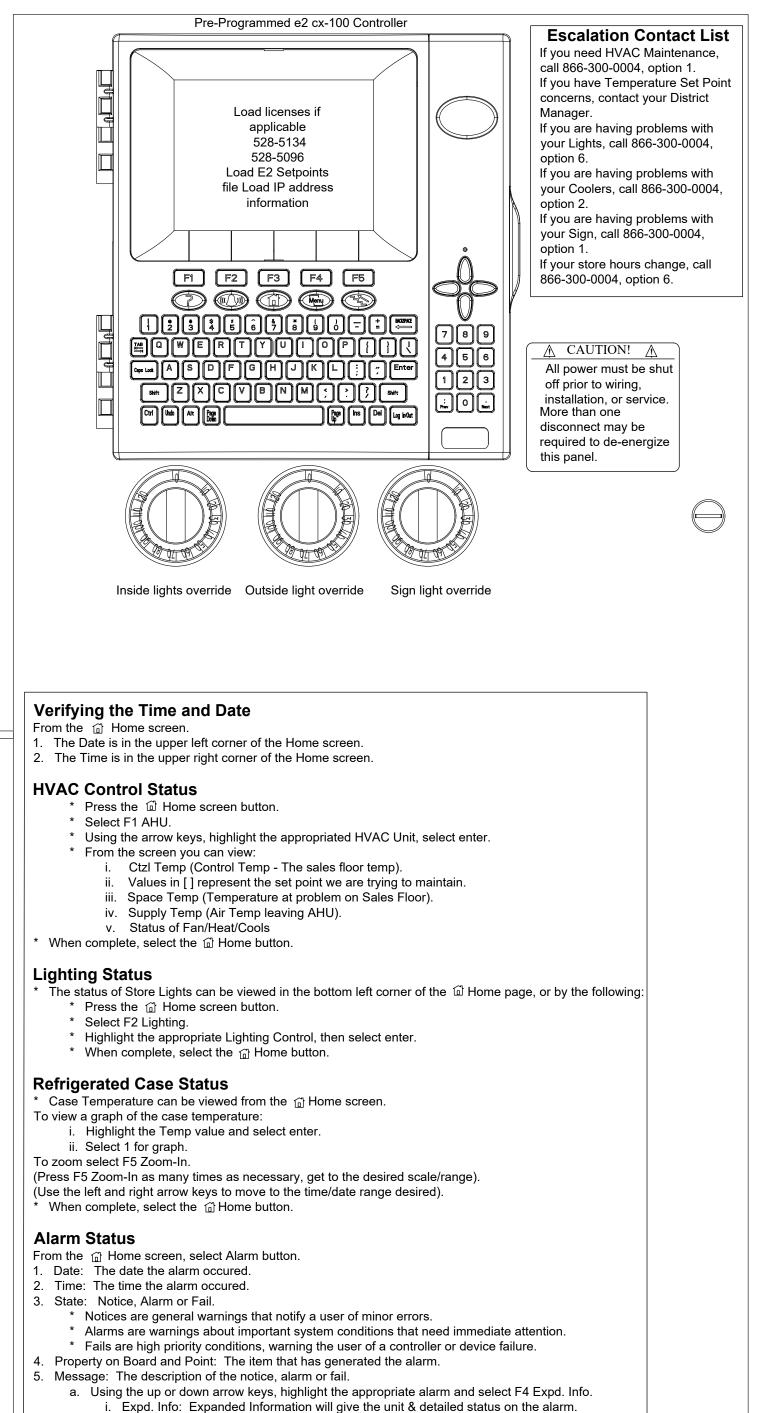

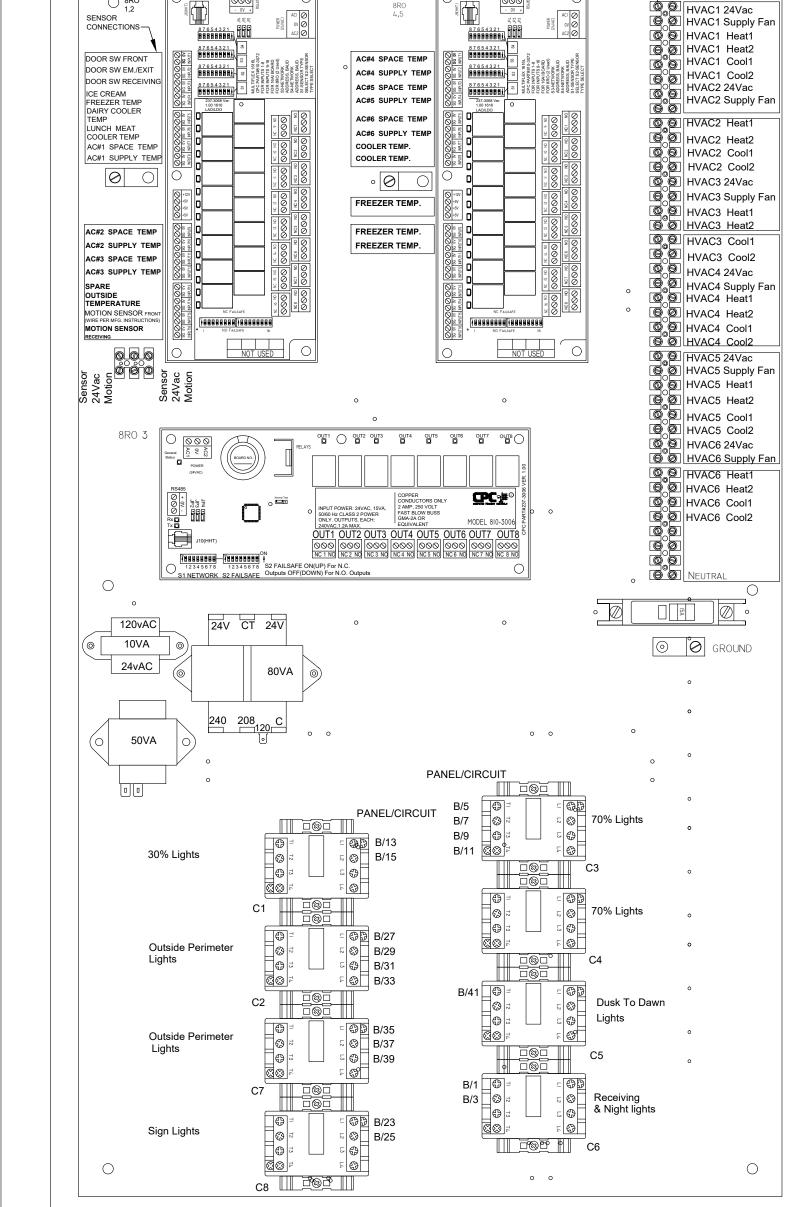

TESTING NOTES

TESTING OF HVAC UNITS THRU EMS PANEL IS ACCOMPLISHED BY SIMPLY WARMING UP OR COOLING DOWN A SPACE TEMPERATURE SENSOR (USING A BLOW DRYER OR ELECTRONIC EQUIPMENT DUSTER AEROSOL) AND WATCH THE FAN, HEAT AND COOL STAGES CYĆLE ON AND OFF. THIS REQUIRES TWO PEOPLE AT ALL TIMES....ONE TO WATCH THE SCREEN AND THE OTHER TO WATCH OPERATION OF THE AHU. WHEN COMPLETE, PRESS THE HOME BUTTON TO RETURN TO THE MAIN SCREEN.

HVAC Control Wires To Utilize

Standard 8 Conductor, 18 Ga.,

Color Coated. See Photo This

- EMS PANEL REQUIRES STORE #, CITY, STATE, ZIP CODE PHOTOS IS AVAILABLE ON NATIONAL ACCOUNT WEBSITE. SYSTEM INSTALLATION & SETUP SHOULD BE DIRECTED 770-425-2724.
- ALL SIGN & LIGHTING CIRCUITS MUST BE FED THROUGH THE DESIGNATED CONTACTORS AS NOTED ON THIS
- CONNECTED TO THE PROPER TERMINAL. 24 GA. SHIELDED (SHIELD MUST BE GROUNDED) CABLE, BELDEN #8641, 2 CONDUCTOR WIRE OR IT'S EQUIVALENT IS REQUIRED.
- 4. COOLER & FREEZER HOME RUNS WILL BE TERMINATED AT ALL POINTS BY DOLLAR GENERAL REFRIGERATION DEPARTMENT.

EMS2/SCALE: N.T.S.

FOR REFERENCE

This item has been electronically signed and sealed by Kenneth W. Hunter, P.E. on 4/14/24 using a Digital Signature. Printed copies of this document are not considered signed and sealed and the signature must be verified on any electronic copies.

(352) 238-6366 www.hdceng.com 📤 696 1st Ave N, Ste. 200 St. Petersburg, FL 3370 **Hunter Design** FL CA #31946 & CONSULTING GA CA #PEF007171

DRAWING DATE: / DRAWN BY 4/5/24 - KWH REVISION DATE: / REVISED BY:

> DRAWING TITLE: **EMS PANEL CONTROLS** SHEET NO.

ENER

PROJECT NUMBER: 4000.249

KENNETH W HUNTER, P.E.

PROFESSIONAL ENGINEER

696 1ST AVE N, STE 200

ST. PETERSBURG, FL 33701

PE #76961

CTH W. HI

LICENSE

FLORIDA

U 0

SONAL T

2 PROGRAMMER CONTROLLER

EMS GENERAL NOTES

EMS SUPPLIER NOTE: CUSTOMIZED DOLLAR GENERAL & QTY. OF HVAC UNITS OF THE INSTALL SITE WHEN ORDERING. EMS SYSTEMS INSTALLATION GUIDE WITH ALL QUESTIONS PERTAINING TO THE EMS PANEL, TO EMERSON'S DOLLAR GENERAL SUPPORT TEAM AT


ALL LOW VOLTAGE HVAC & DOOR SENSORS MUST BE

3 CONTROL WIRING DIAGRAM

ONLY

ii. When finished viewing detailed status, select enter. * When complete, select the Home button. EMS SYSTEM SHOULD BE TESTED FOR HVAC OPERATION, INTERIOR LIGHTING, EXTERIOR LIGHTING AND SIGN LIGHTING PRIOR TO CONTRACTOR'S ELECTRICAL POSSESSION DATE. USE OUTSIDE LIGHT AND SIGN LIGHT OVERRIDE FOR EXTERIOR TESTING.

EMS2/SCALE: N.T.S.

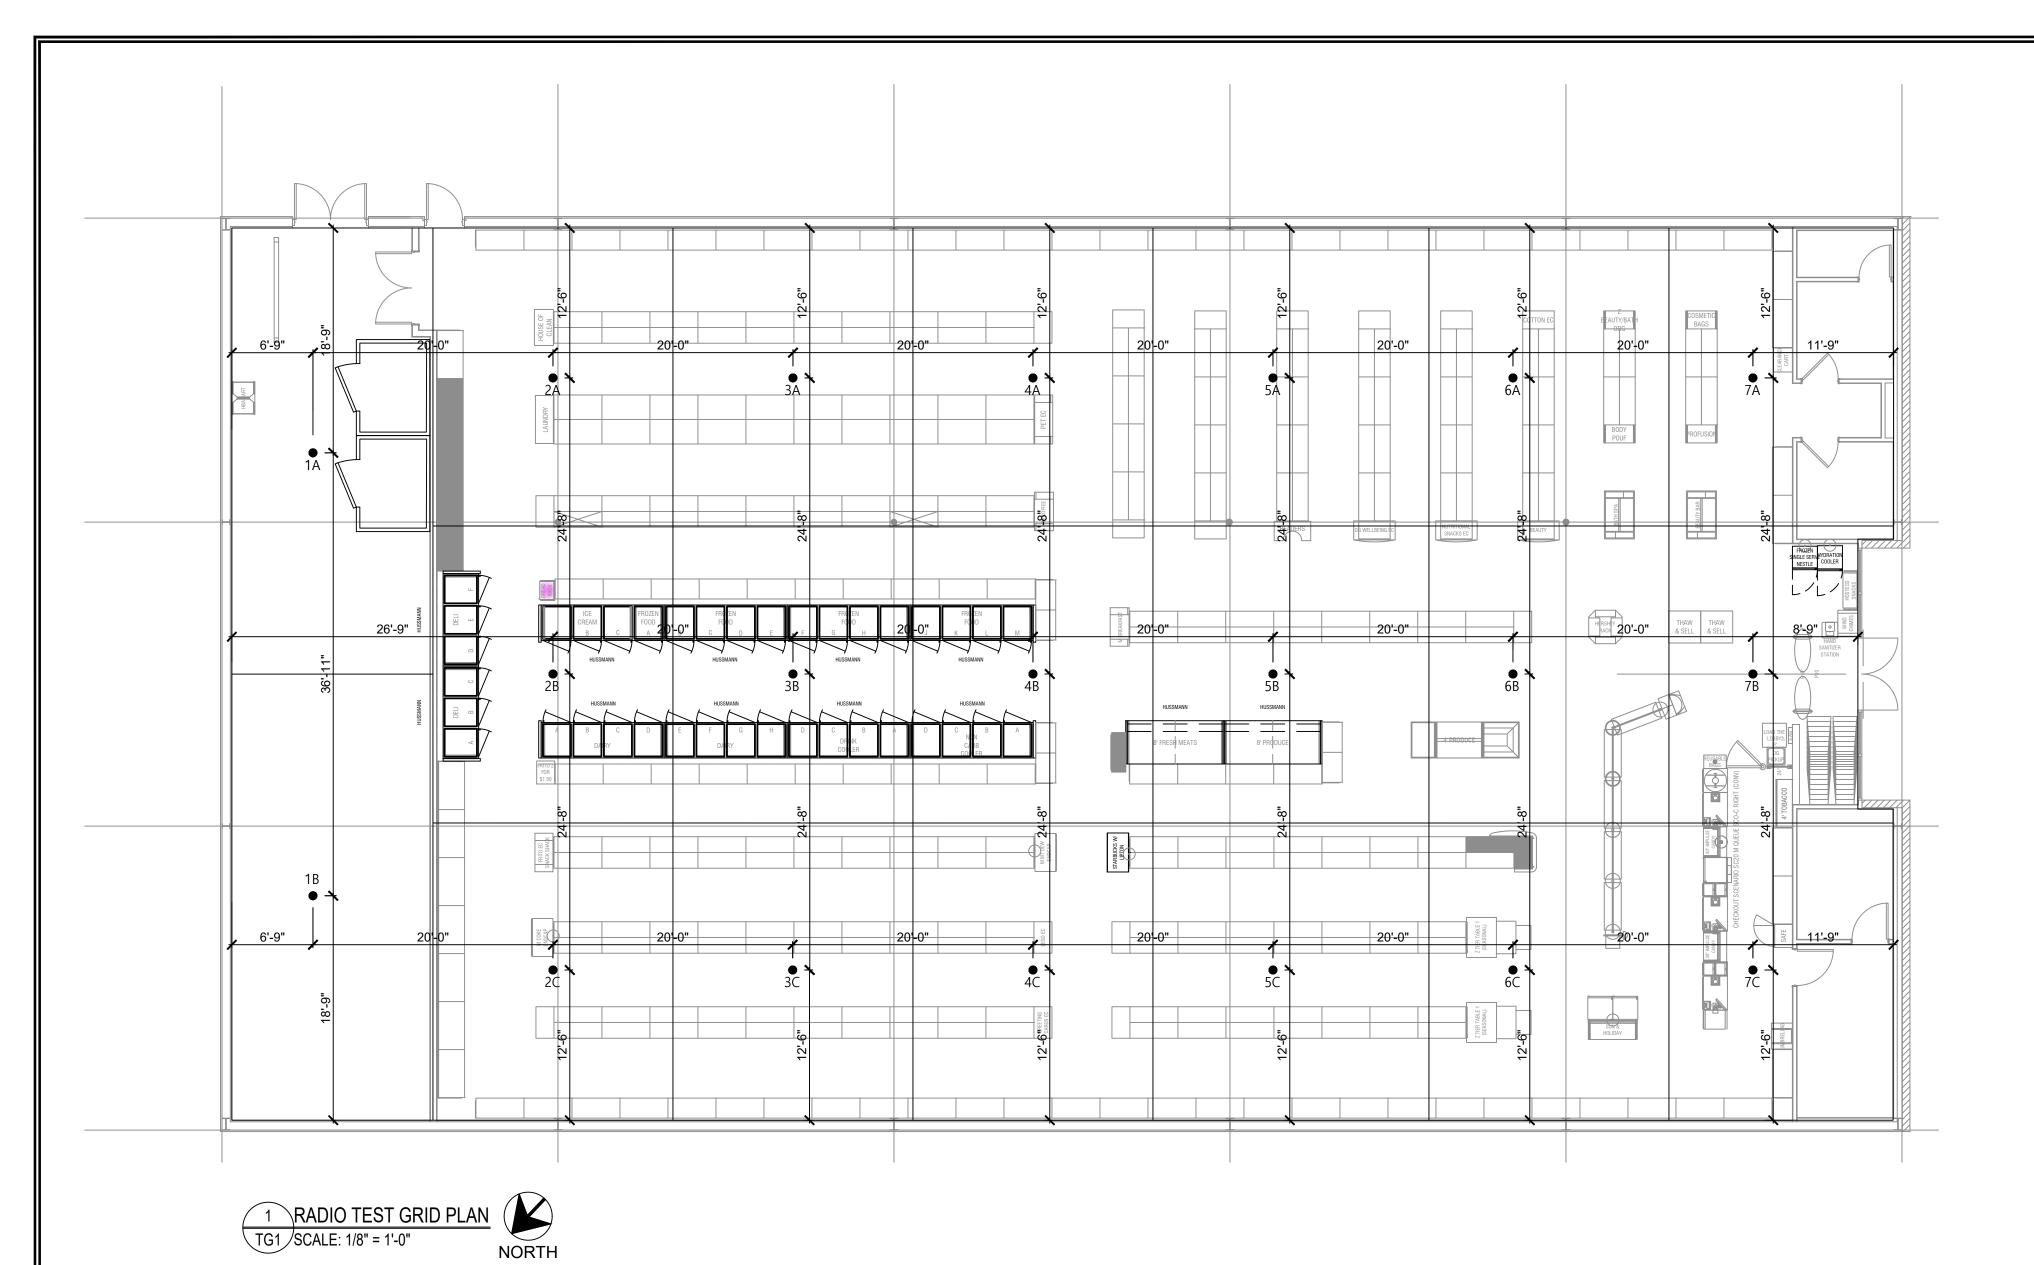

TWO-WAY COMMUNICATION TESTING NOTES

- 1. PRIOR TO BUILDING INSPECTION, THE BUILDING OWNER SHALL HAVE THE RADIO SYSTEM TESTED TO VERIFY THAT TWO-WAY COVERAGE IS NOT LESS THAN 95%.
- READINGS SHALL BE TAKEN AT EACH OF THE POINTS INDICATED ON THE RADIO TEST GRID PLAN.
- THE TEST SHALL BE CONDUCTED USING A CALIBRATED PORTABLE RADIO OF THE LATEST BRAND AND MODEL APPROVED BY THE FIRE CODE OFFICIAL.
- MINIMUM INBOUND SIGNAL STRENGTH SHALL BE SUFFICIENT TO PROVIDE USABLE VOICE COMMUNICATIONS THROUGHOUT THE COVERAGE AREA AS SPECIFIED BY THE FIRE CODE OFFICIAL. THE INBOUND SIGNAL LEVEL SHALL BE SUFFICIENT TO PROVIDE NOT LESS THAN A DELIVERED AUDIO QUALITY (DAQ) OF 3.0 OR AN EQUIVALENT SIGNAL-TO-INTERFERENCE-PLUS-NOISE RATIO (SINR) APPLICABLE TO THE TECHNOLOGY FOR EITHER ANALOG OR DIGITAL SIGNALS.
- MINIMUM OUTBOUND SIGNAL STRENGTH SHALL BE SUFFICIENT TO PROVIDE USABLE VOICE COMMUNICATIONS THROUGHOUT THE COVERAGE AREA AS SPECIFIED BY THE FIRE CODE OFFICIAL. THE INBOUND SIGNAL LEVEL SHALL BE SUFFICIENT TO PROVIDE NOT LESS THAN A DAQ OF 3.0 OR AN EQUIVALENT SINR APPLICABLE TO THE TECHNOLOGY FOR EITHER ANALOG OR DIGITAL SIGNALS.
- SIGNAL STRENGTH SHALL BE SUFFICIENT TO MEET THE REQUIREMENTS OF THE APPLICATIONS BEING UTILIZED BY PUBLIC SAFETY FOR EMERGENCY OPERATIONS THROUGH THE COVERAGE AREA AS SPECIFIED BY THE FIRE CODE OFFICIAL.
- 7. FAILURE OF MORE THAN ONE TEST AREA SHALL RESULT IN FAILURE OF THE TEST.
- UPON FAILURE OF THE TEST, A TWO-WAY RADIO COMMUNICATION ENHANCEMENT SYSTEM SHALL BE INSTALLED. SYSTEM SHALL COMPLY WITH NFPA 72 & NFPA 1221 AS APPLICABLE. SYSTEM SHALL BE TESTED AFTER INSTALLATION.

TEST :	ZONE (AREA)												
1A	(623SF)	2A	(496SF)	3A	(496SF)	4A	(496SF)	5A	(496SF)	6A	(496SF)	7A	(496SF)
1B	(623SF)	2B	(496SF)	3B	(496SF)	4B	(496SF)	5B	(496SF)	6B	(496SF)	7B	(396SF)
		2C	(496SF)	3C	(496SF)	4C	(496SF)	5C	(496SF)	6C	(496SF)	7C	(496SF)

KENNETH W. HUNTER, P.E. PROFESSIONAL ENGINEER 696 1ST AVE N, STE 200 ST. PETERSBURG, FL 33701 PE #76961

WETH W. HU NO CORIL

Uo

GENERAI DOLL

4/5/24 - KWH

REVISION DATE: / REVISED BY: PROJECT NUMBER:

DRAWING TITLE: RADIO TEST GRID PLAN

www.hdceng.com

696 1st Ave N, Ste. 200

4000.249

This item has been electronically signed and sealed by Kenneth W. Hunter, P.E. on 4/14/24 using a Digital Signature. Printed copies of this document are not considered signed and

