


DESIGN SPECIFICATIONS

- DESIGN CODES:
ASCE 7-22
2023 FLORIDA BUILDING CODE - RESIDENTIAL
- WIND ZONE INFORMATION
BASIC WIND SPEED: 130 MPH
BUILDING RISK CATEGORY: II
WIND EXPOSURE CATEGORY: B
INT. PRESSURE COEF: ±0.18
- DESIGN LOADS
ROOF LIVE LOAD: 20 PSF
ROOF DEAD LOAD: 10 PSF


FLOOR LIVE LOAD: 40 PSF
FLOOR DEAD LOAD: 20 PSF
- COMPONENTS & CLADDING
ZONE 1: +11.12/-25.03
ZONE 2: +11.12/-32.61
ZONE 3: +11.12/-35.14
ZONE 4: +14.92/-16.18
ZONE 5: +14.92/-19.37

MATERIAL SPECIFICATIONS

HARDWARE AND ANCHORS:
ANCHOR BOLTS & THREADED ROD: SHALL BE IN ACCORDANCE WITH ASTM A307 OR ASTM F 1554 GRADE 36.
WASHERS: SHALL BE IN ACCORDANCE WITH ASTM A500 (GRADE B).
NUTS: SHALL BE IN ACCORDANCE WITH ASTM A 563 GRADE A HEX.
METAL CONNECTORS: ALL METAL CONNECTORS WHICH ARE EXPOSED TO EXTERIOR SHALL BE GALVANIZED.
RETROFIT REBAR/ROD INSTALLATION: EMBEDMENT OF RODS OR REBAR DOWELS SHALL BE 12 BAR DIAMETER MINIMUM, HOLES SHALL BE $\frac{1}{4}$ " LARGER THAN REBAR SIX AND $\frac{1}{6}$ " LARGER THAN THREADED ROD SIZE (U.O.N.)
ANCHORING ADHESIVE: SHALL BE ONE OF THE FOLLOWING PRODUCTS (DUAL CARTRIDGE INSTALLATION ONLY):
EPOXY: ITW RED HEAD A7
REINFORCING STEEL: SHALL BE ASTM A615, GRADE 60.
STRUCTURAL STEEL: SHALL BE ASTM A992, GRADE 50.
WELDED WIRE FABRIC (WWF): SHALL BE ASTM A185.
LAMINATED VENEER LUMBER (LVL): ALL LAMINATED VENEER LUMBER SHALL MEET OR EXCEED THE FOLLOWING DESIGN PARAMETERS - ELASTIC MODULUS (E)1,900ksi, BENDING STRESS (Fb) 2600psi

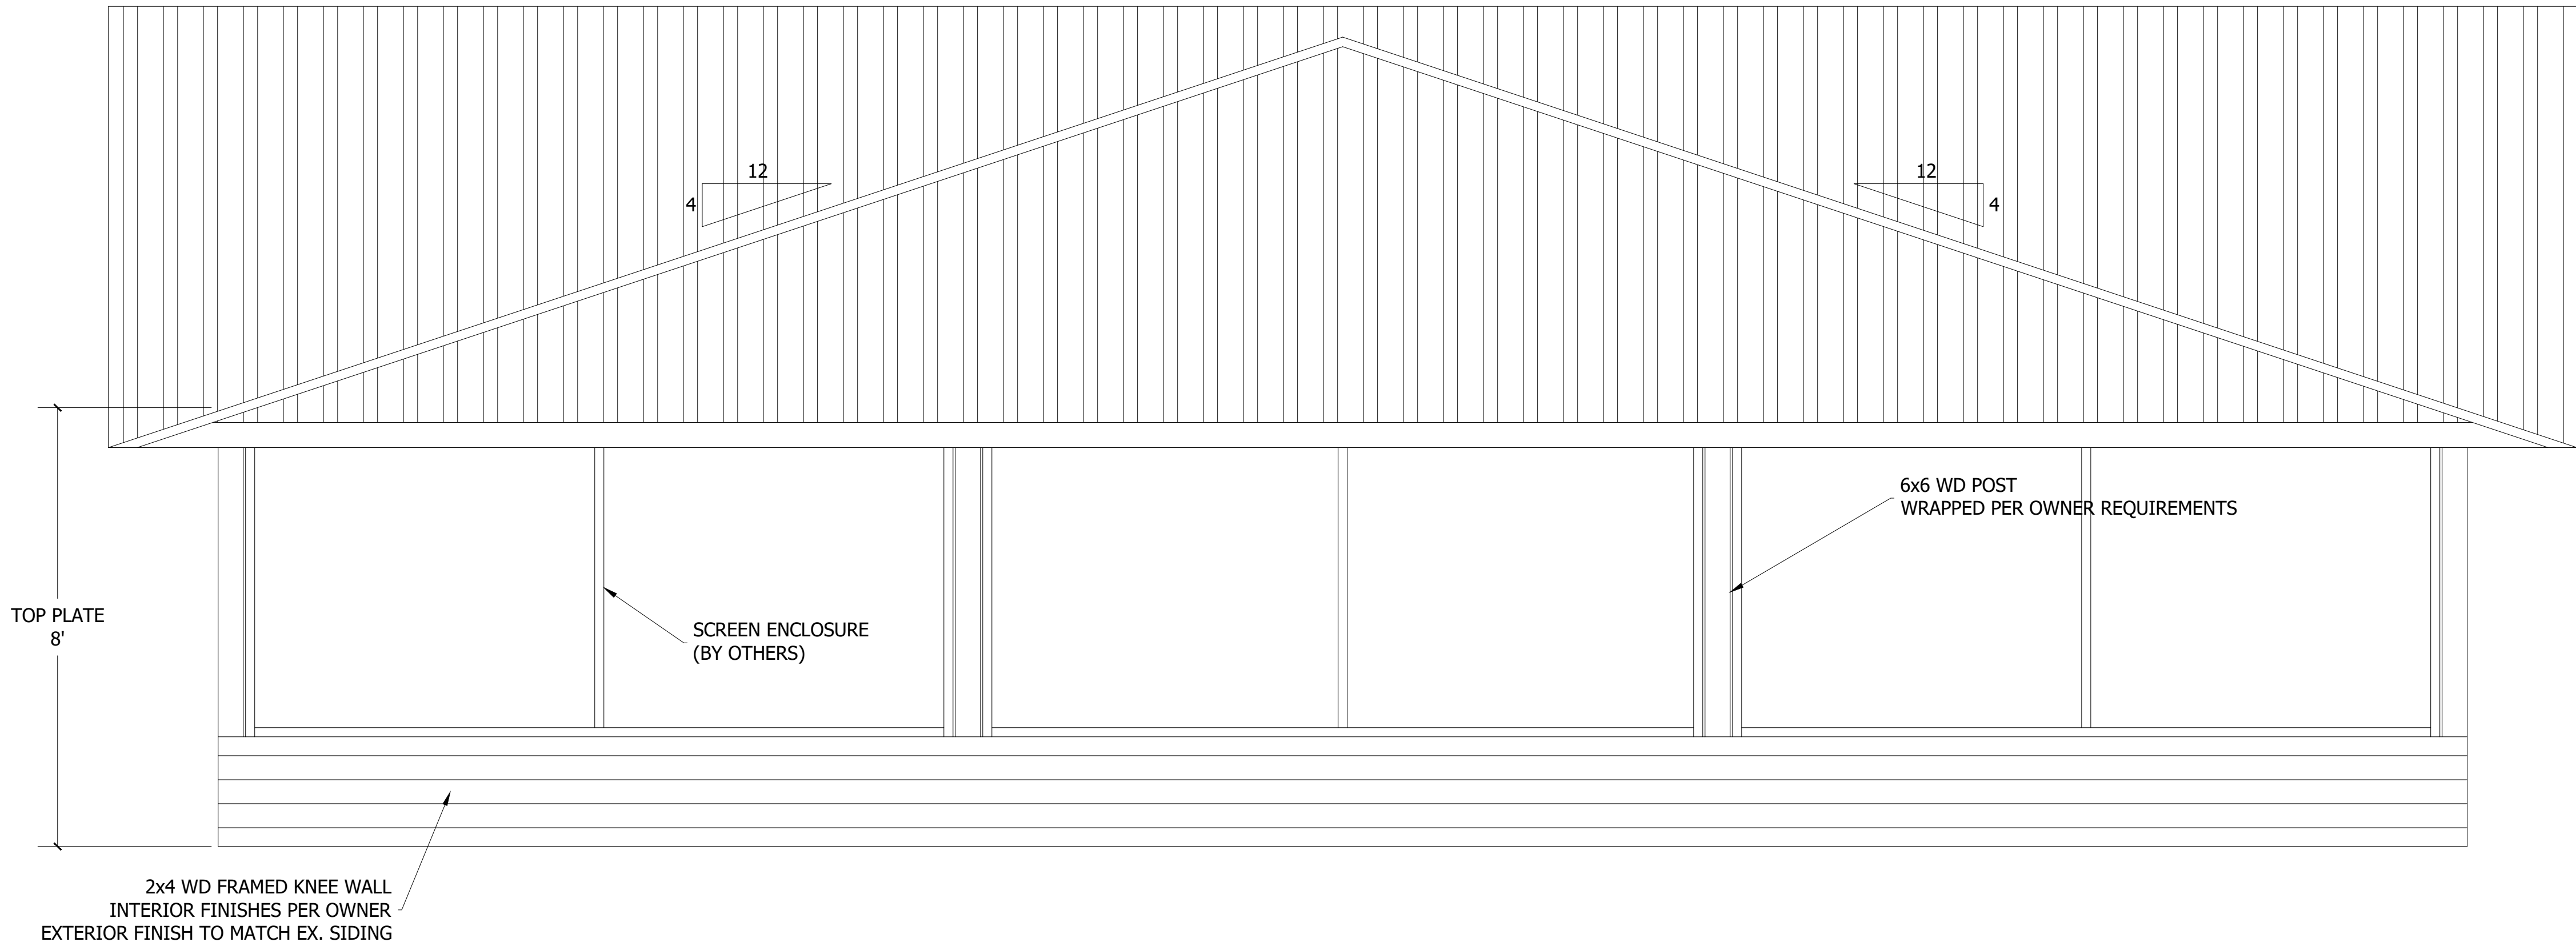

REAR ELEVATION
SCALE: NTS

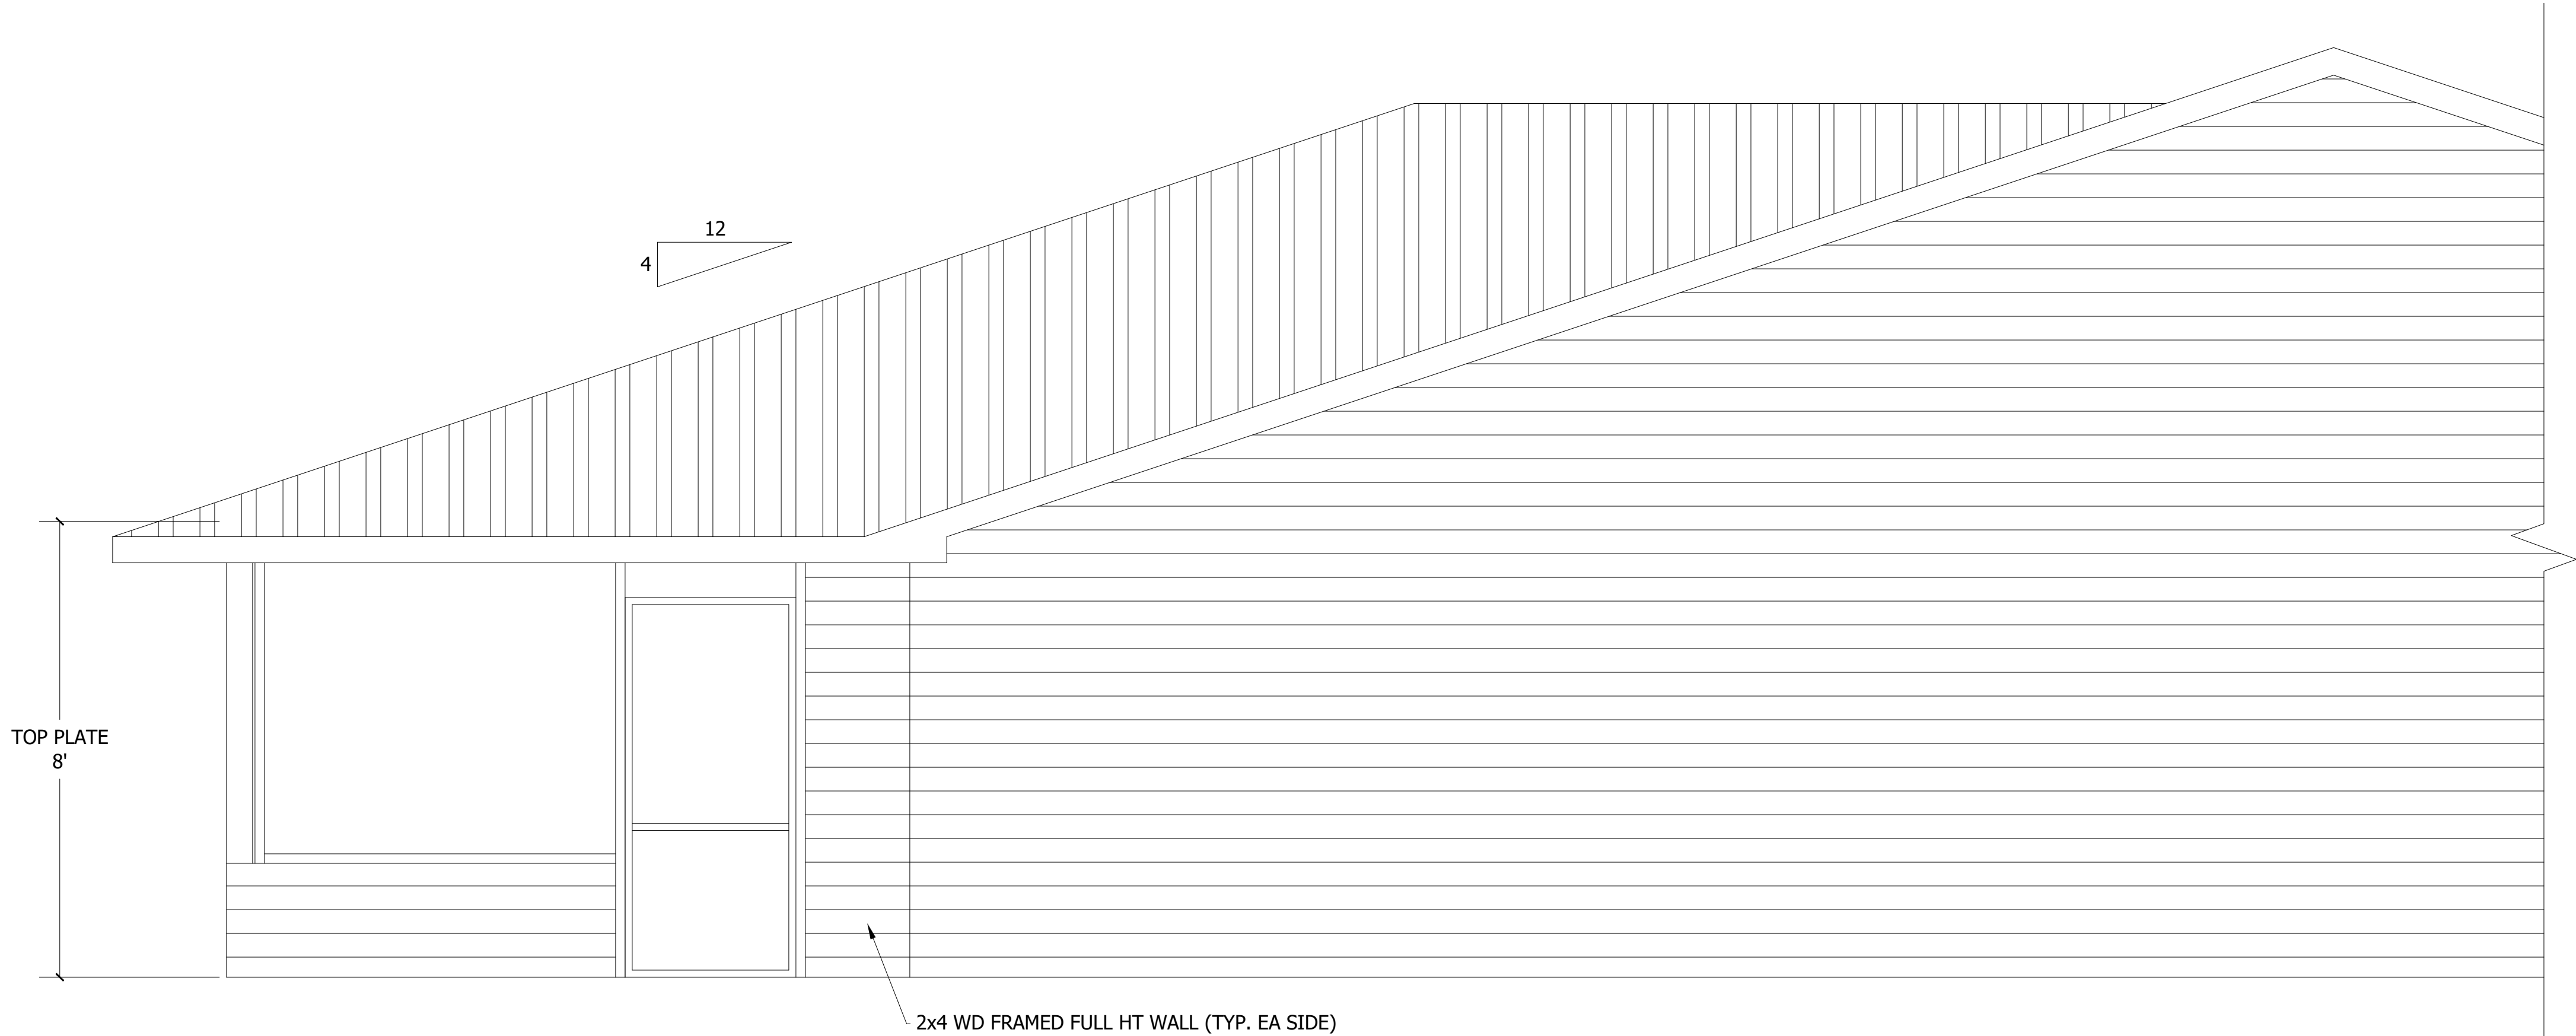

SIDE ELEVATION (TYP.)
SCALE: NTS

JARVIS SCREEN PORCH ADDITION

256 SE ELM LOOP, LAKE CITY, FL 32025


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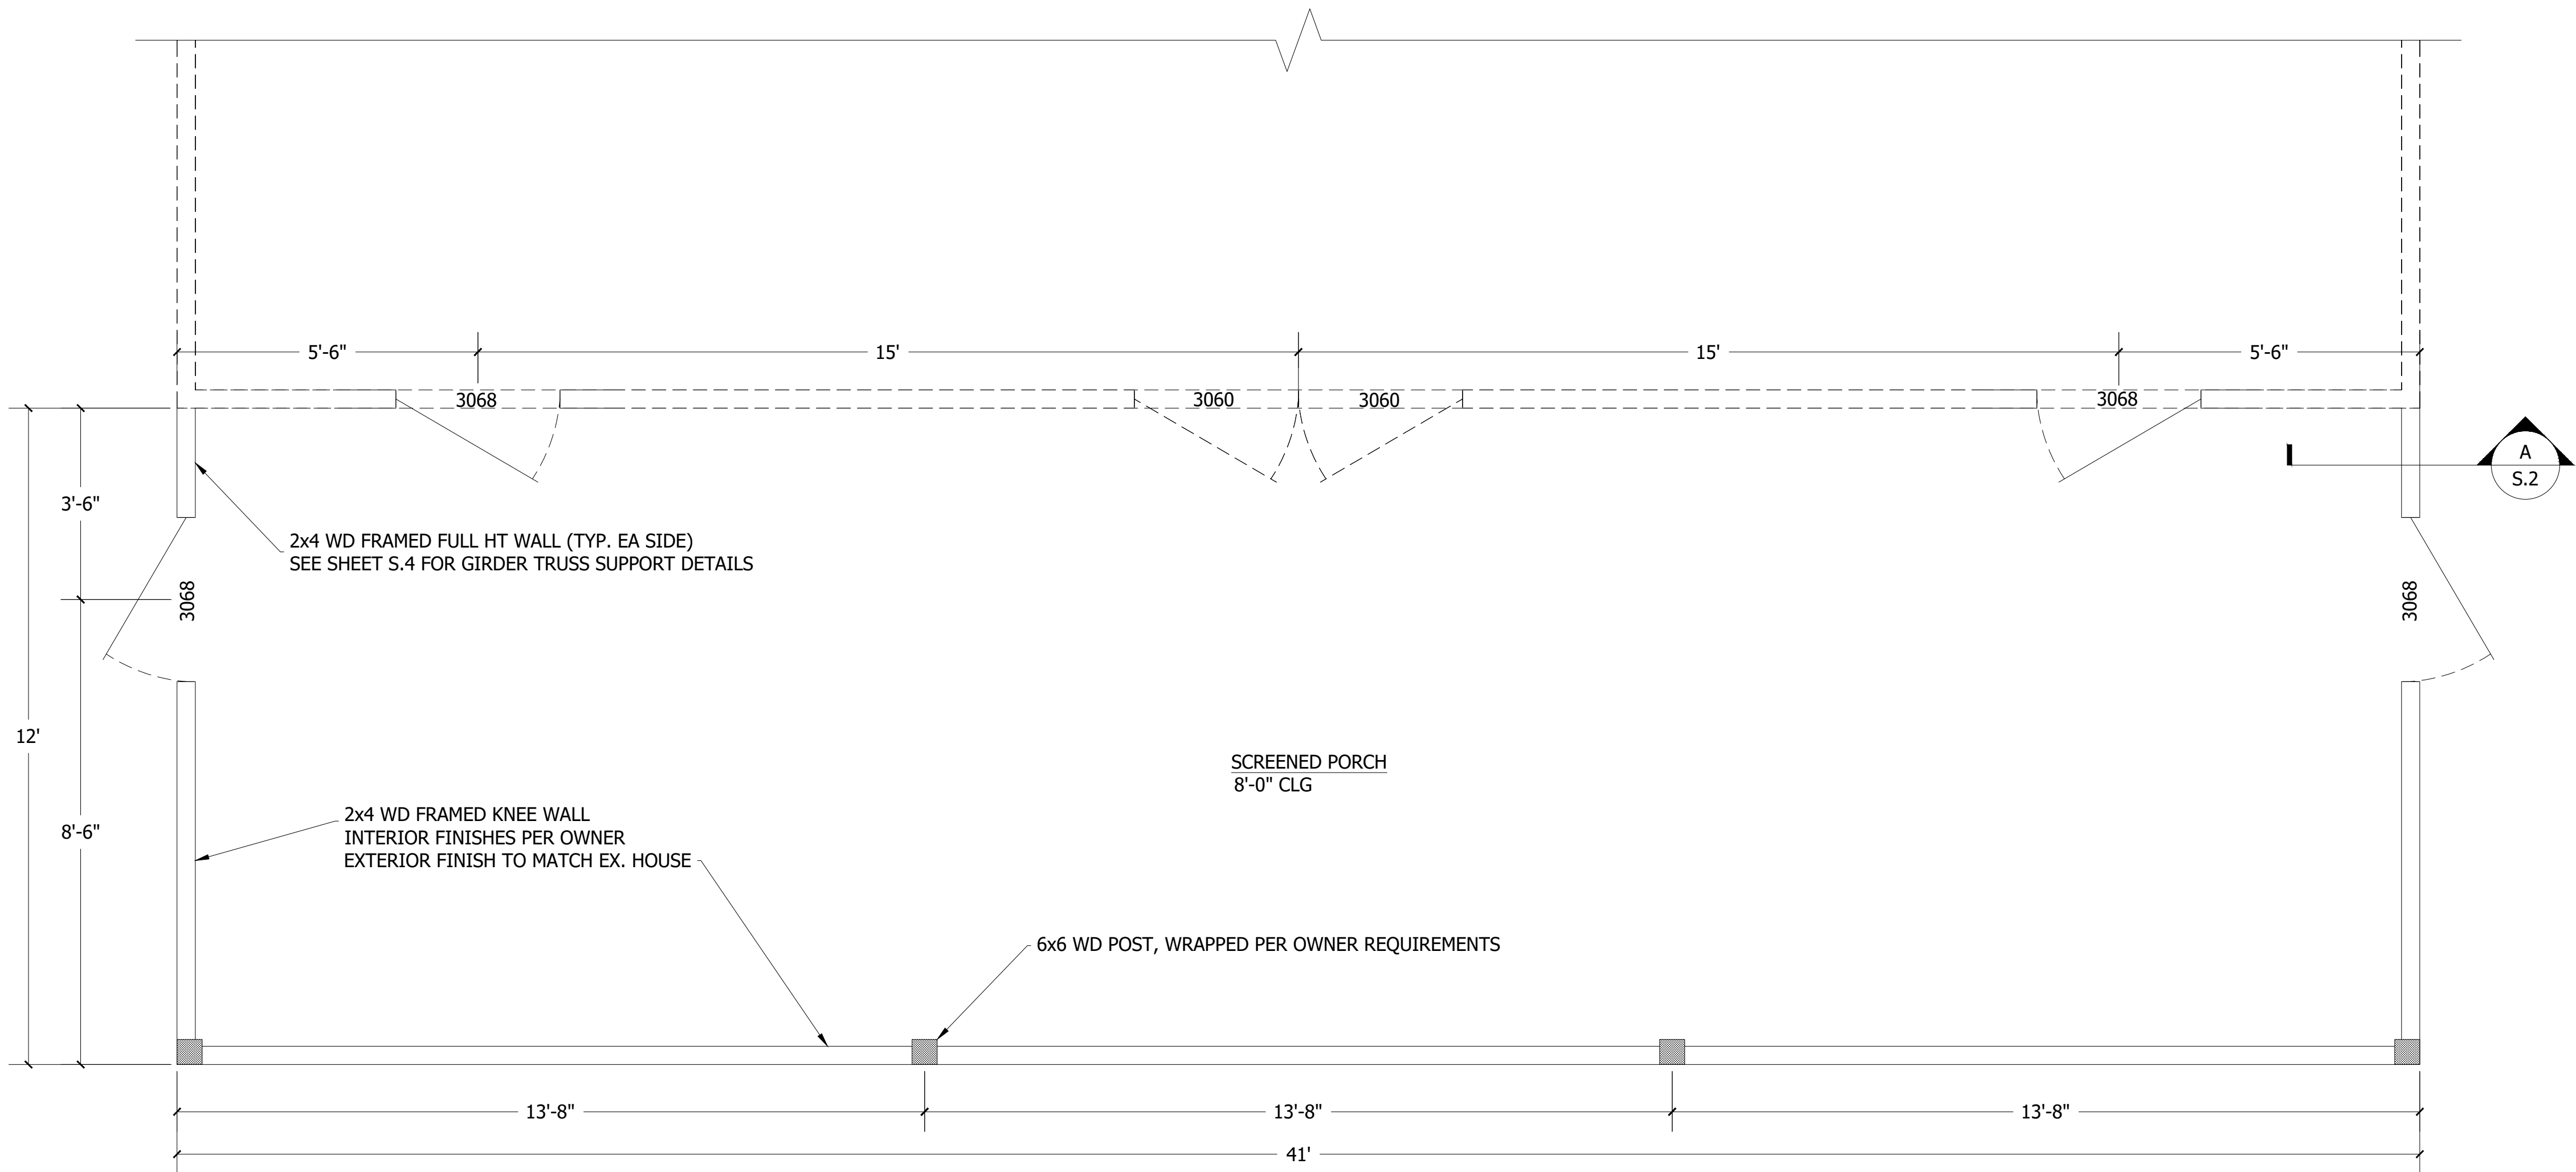
JOB NUMBER
STR010

ELEVATION
VIEWS


SHEET NUMBER
S.1
OF 4 SHEETS





EXISTING FLOOR PLAN
SCALE: 1/2"=1'-0"

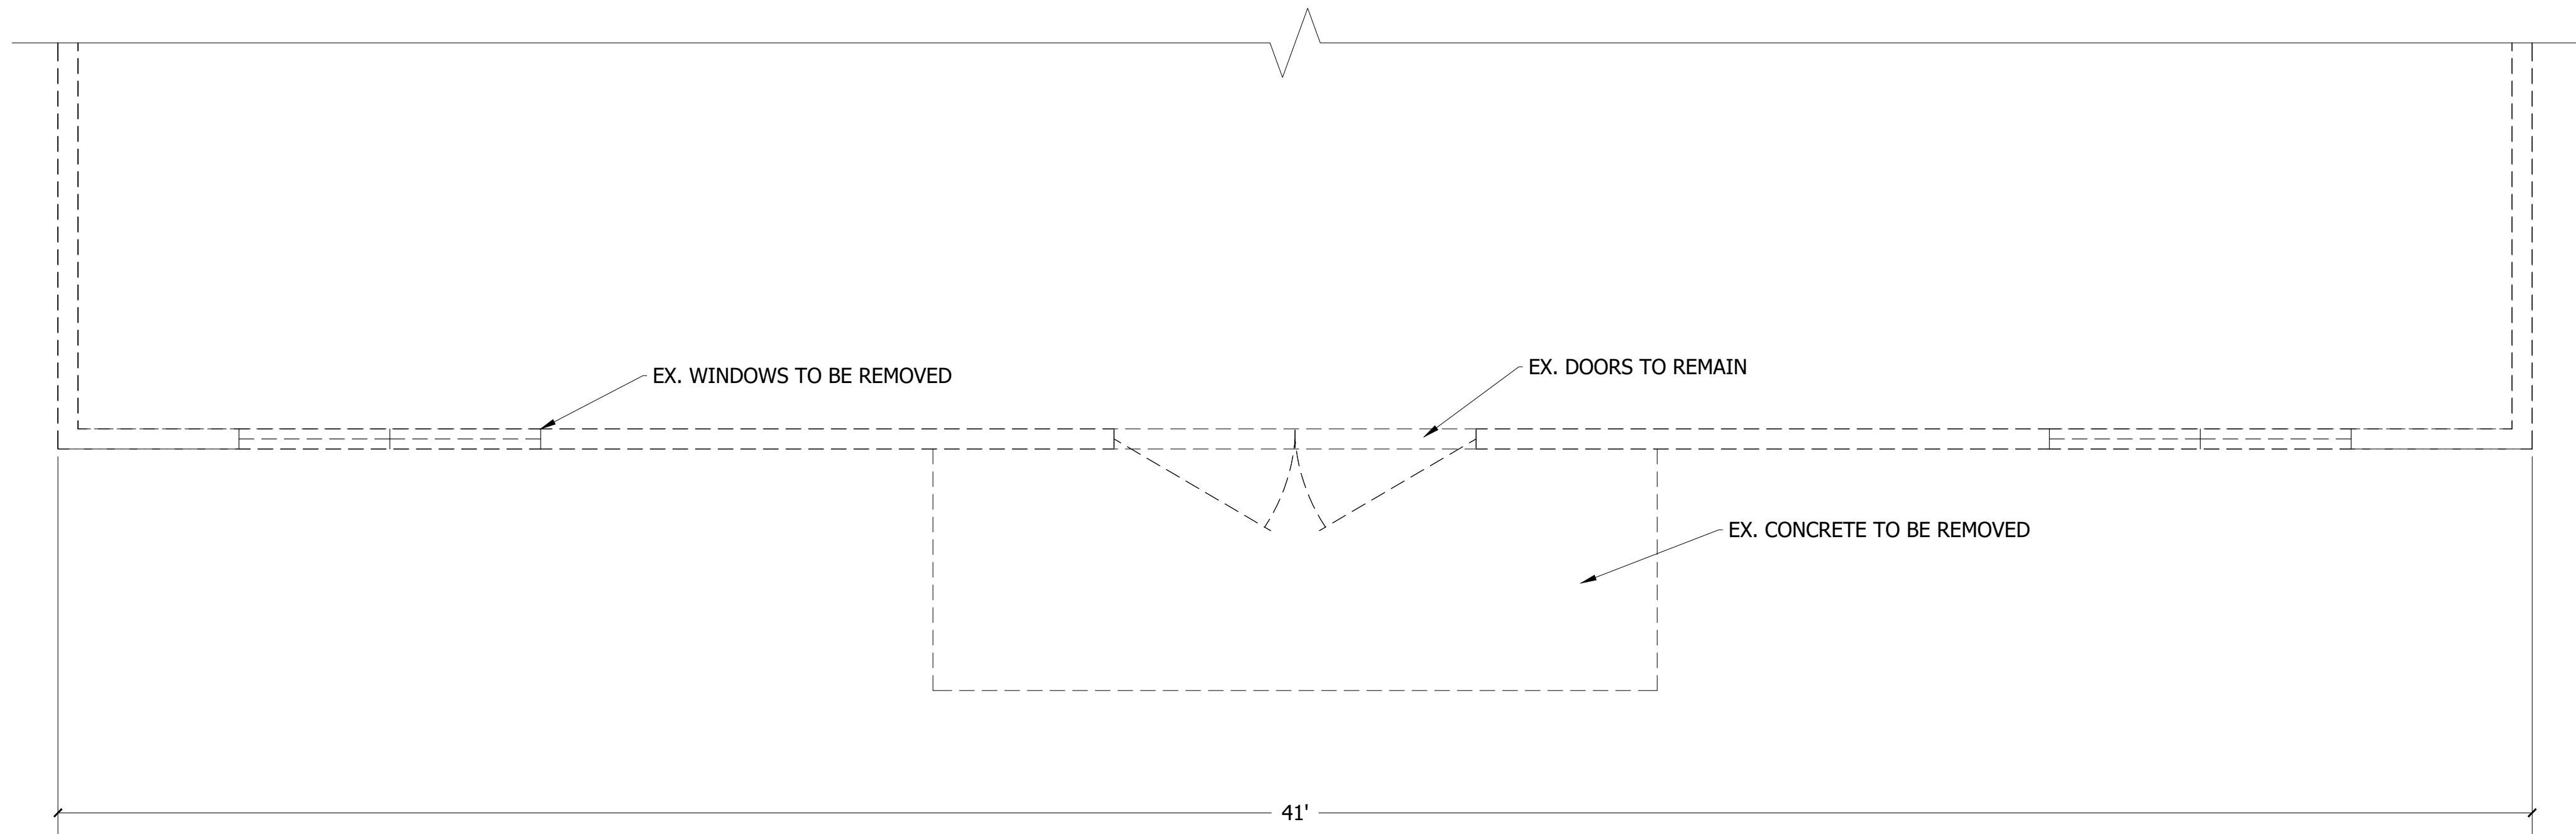

PROPOSED FLOOR PLAN
SCALE: 1/2"=1'-0"

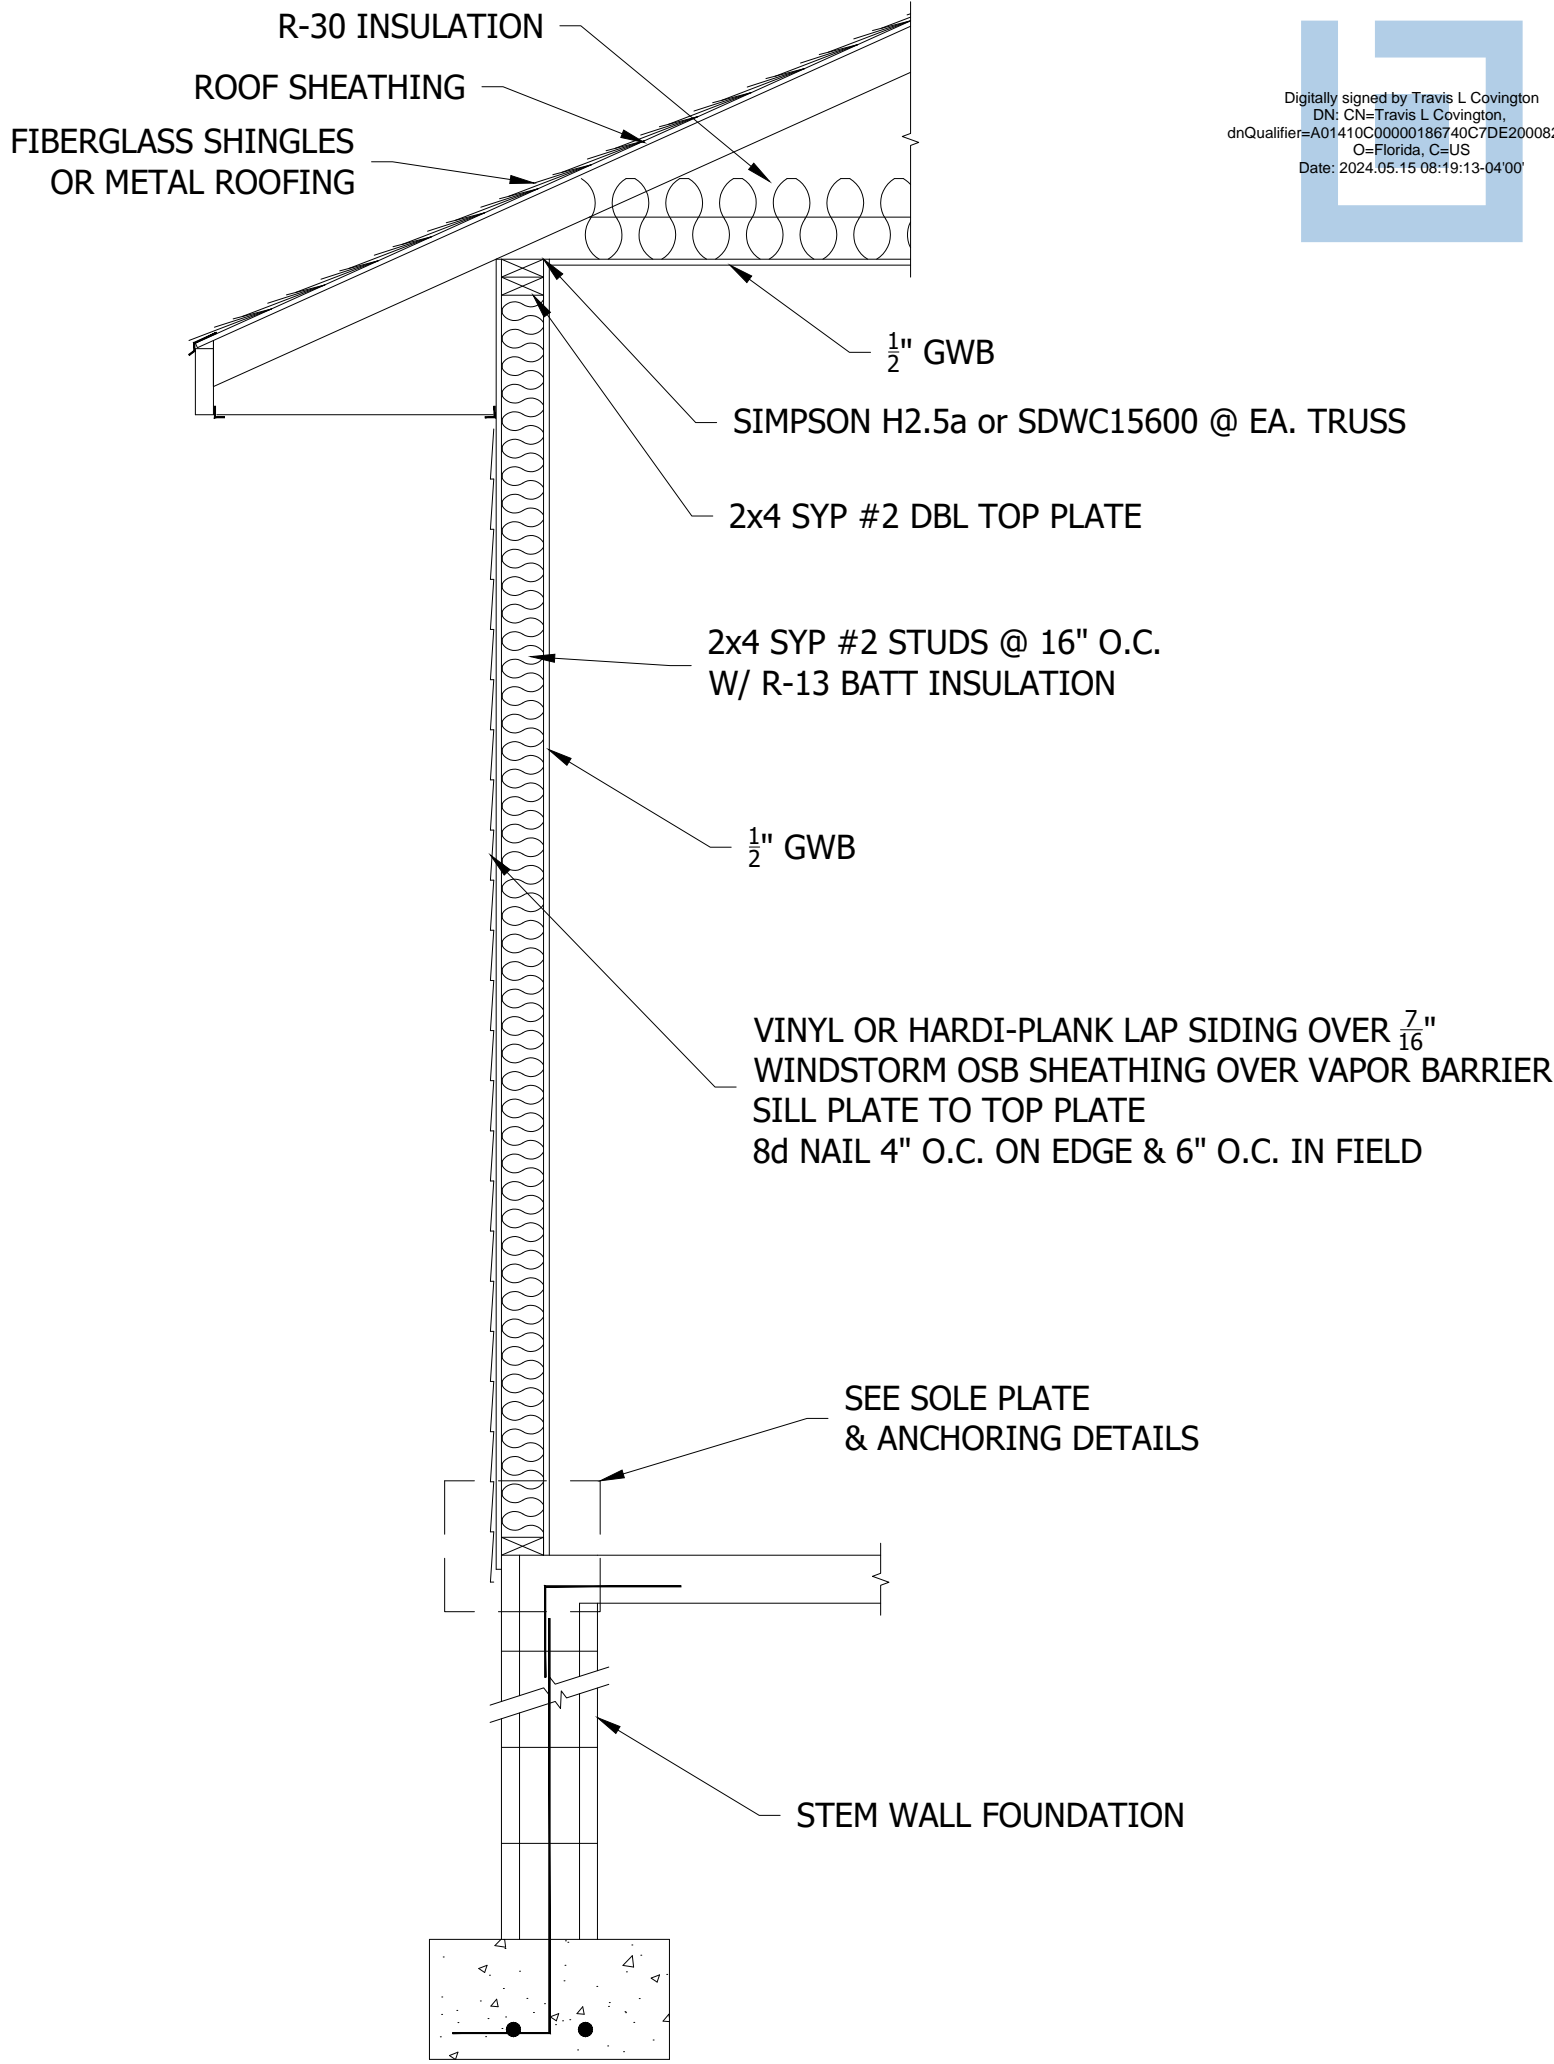

A
S.2
FULL HEIGHT WALL SECTION
SCALE: 3/4"=1'-0"

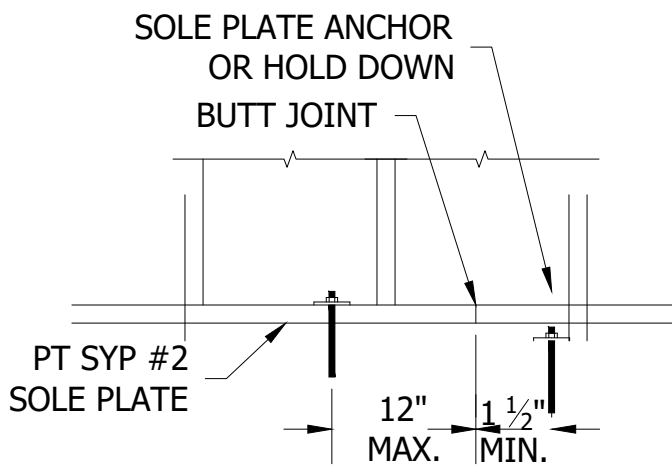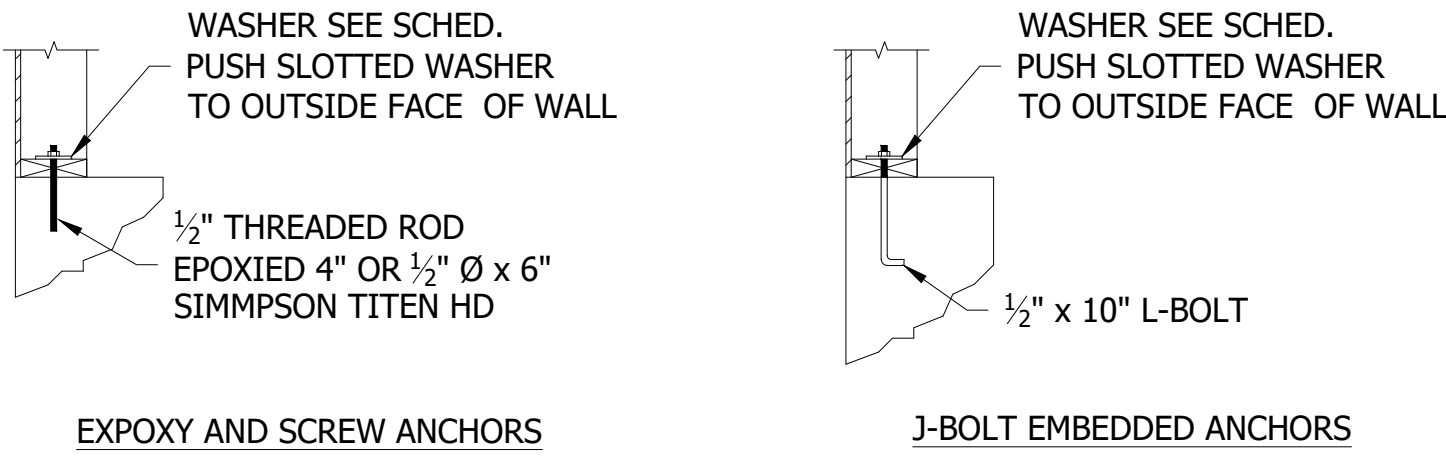


SOLE PLATE BREAK

SOLE PLATE ANCHOR SCHEDULE						
ANCHOR	EXT. WALL SPACING	SHEARWALL SPACING	WASHER SPEC		EMBEDMENT DEPTH	MIN. EDGE DISTANCE
			2x4 WALL	2x6 WALL		
TITEN HD	42"	24"	2x2x ⁵ / ₈ "	3x3x0.229"	4"	2"
EPOXY	42"	24"	2x2x ⁵ / ₈ "	3x3x0.229"	4"	2"
J-BOLT	42"	24"	2x2x ⁵ / ₈ "	3x3x0.229"	7"	2"

- NOTES:
- SOLE PLATE ANCHORS ARE REQUIRED AT ALL EXTERIOR WALLS AND ADJACENT TO CORNERS AND PLATE BREAKS.
 - 3x3 WASHERS SHALL BE SLOTTED.
 - AS AN ALTERNATE TO THE 3x3x³/₄" PLATE WASHER, A 3x3x⁵/₈" W/ 1 ¹/₂"Ø ROUND STEEL WASHER MAY BE USED.

1
S.2
SOLE PLATE ANCHOR DETAIL & SCHEDULE
SCALE: 3/4"=1'-0"

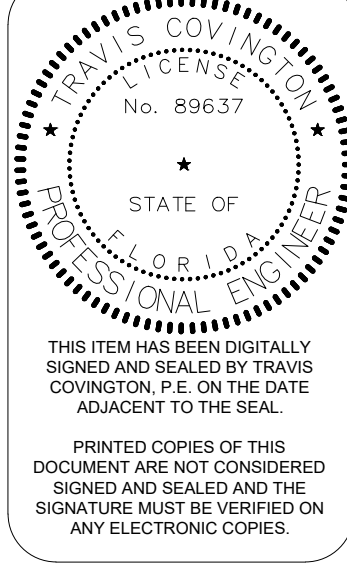

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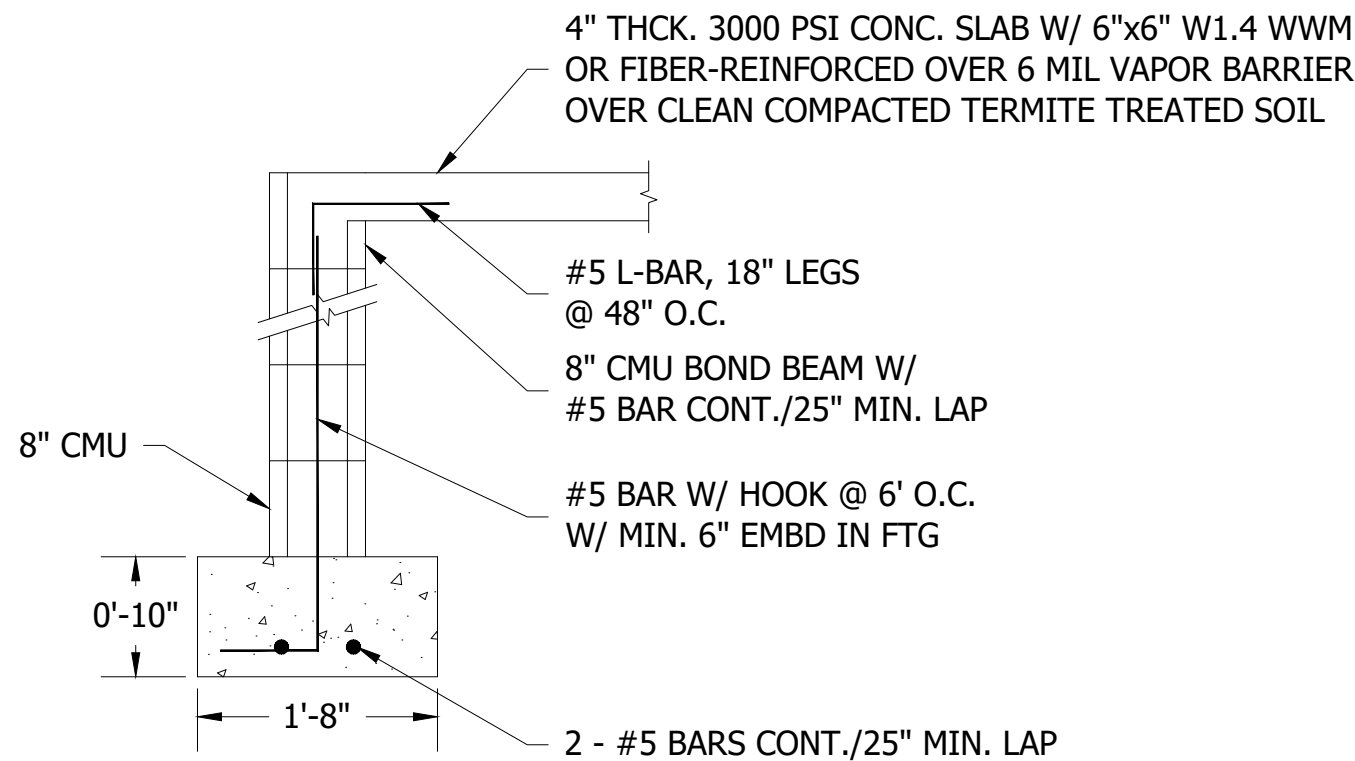
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FLOOR PLAN

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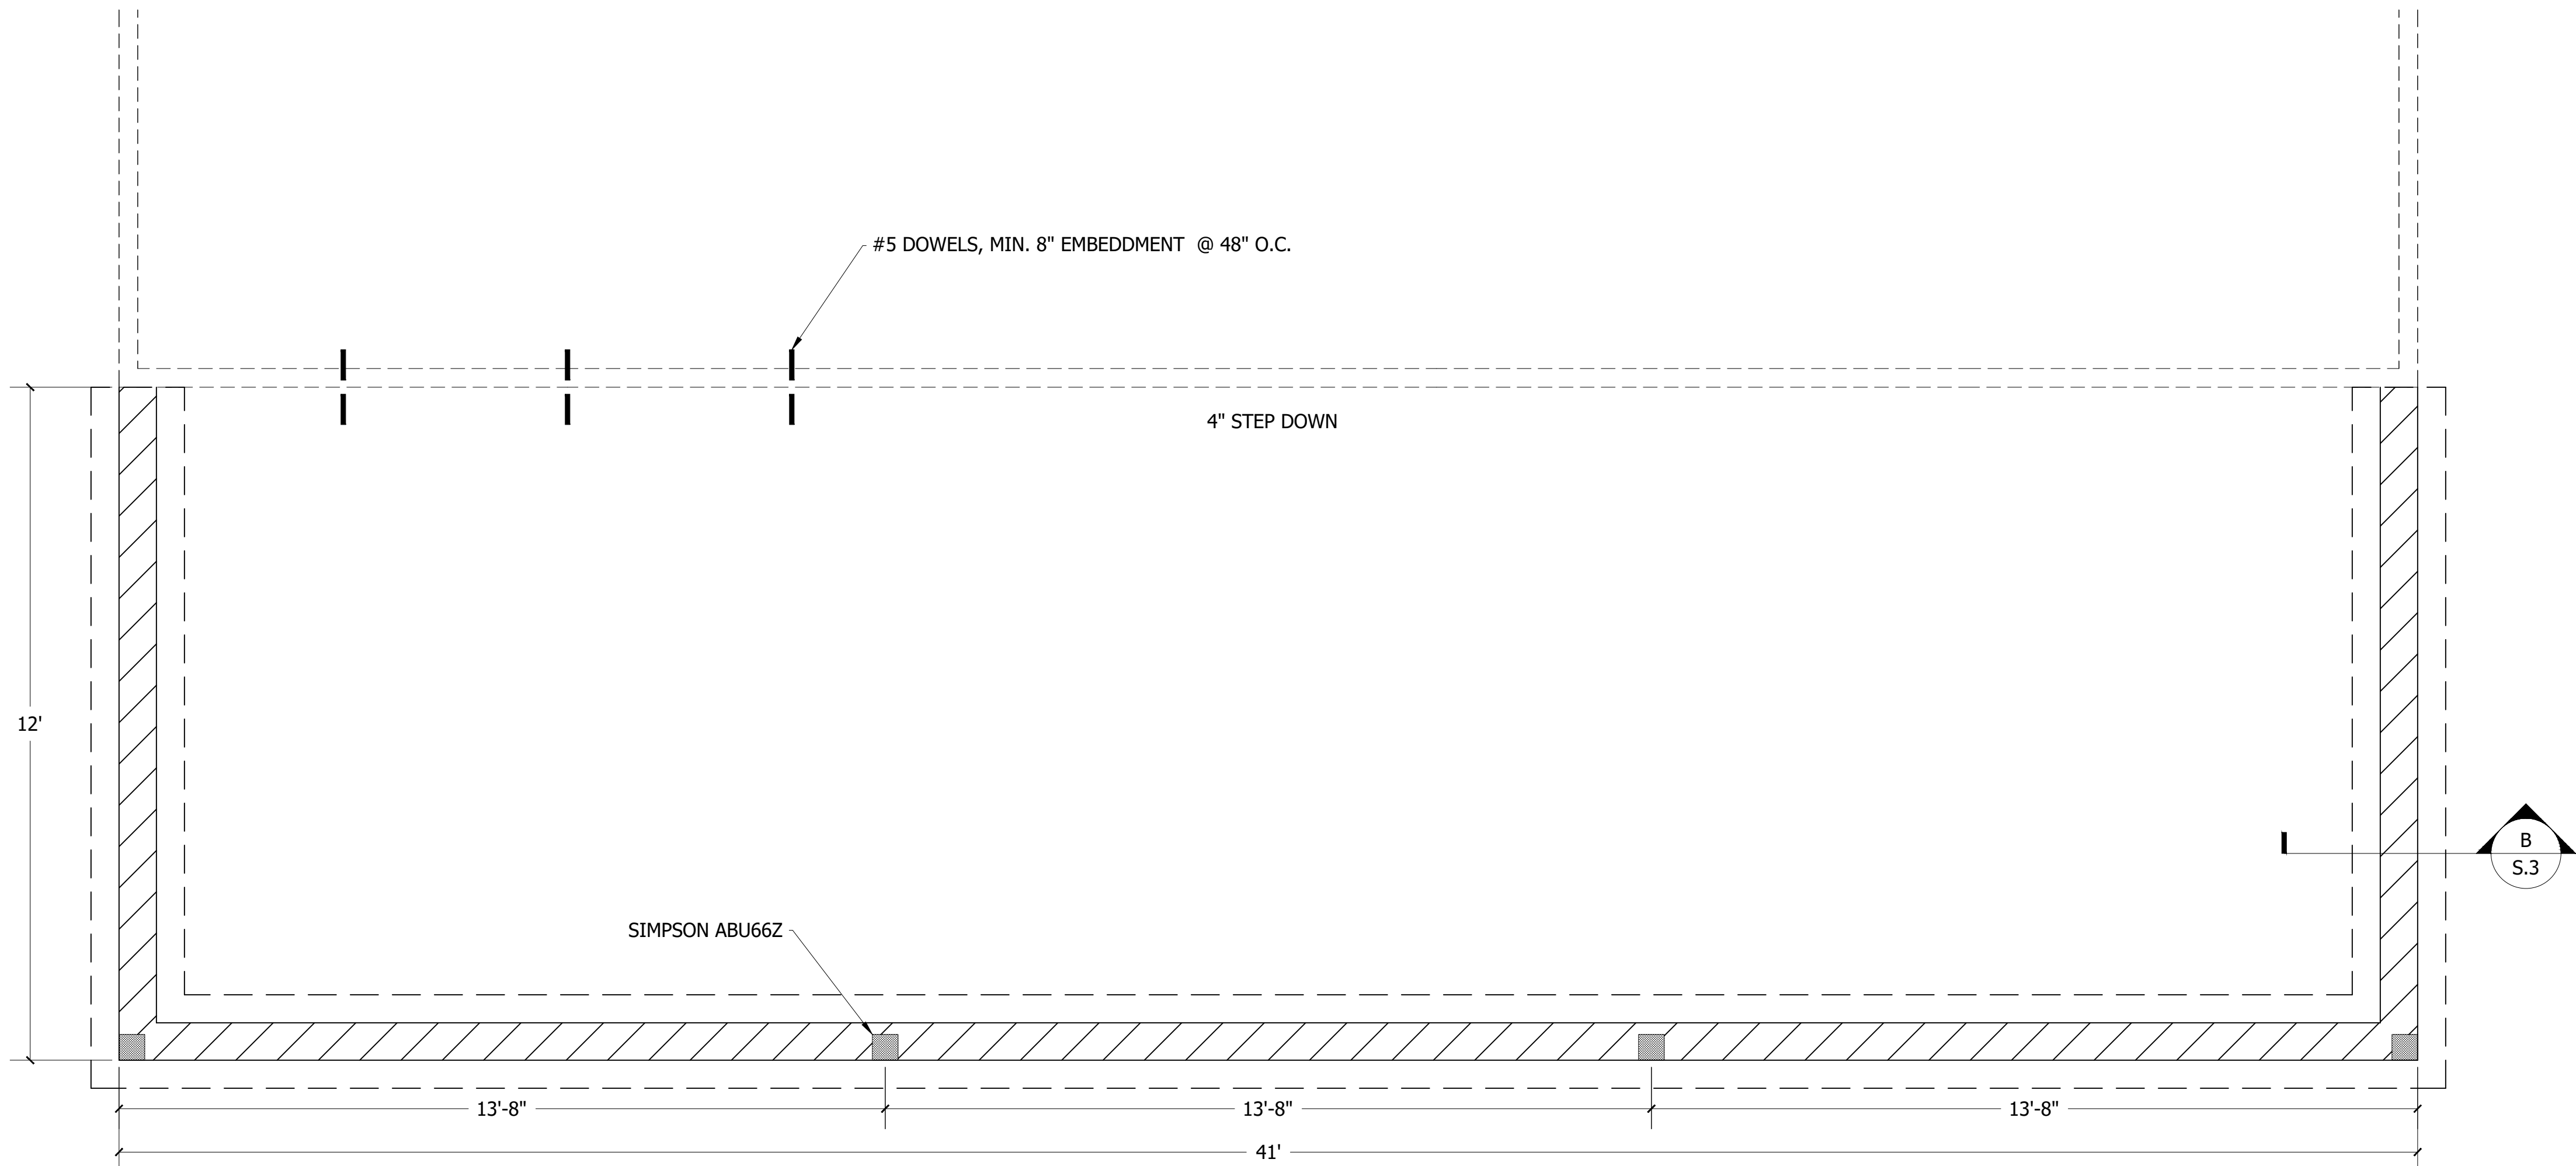
CONCRETE/MASONRY/METAL NOTES:

- DESIGN SOIL BEARING PRESSURE: 2000 PSF
- EXPANSIVE SOILS: WHERE DIRECTED BY THE SOILS ENGINEER, SOIL AUGMENTATION PER THE SOILS ENGINEER'S SPECIFICATIONS SHALL BE IMPLEMENTED PRIOR TO PLACING ANY FOUNDATIONS - TESTS AS SPECIFIED SHALL BE PERFORMED TO DETERMINE THE SUITABILITY OF THE SUB-GRADE TO SUPPORT THE DESIGN LOADS.
- CLEAN SAND FILL OVER STRIPPED AND COMPACTED EXISTING GRADE SHALL BE PLACED IN 12" LIFTS. BOTH SUB-SOIL AND FILL COMPACTION SHALL BE NOT LESS THAN 98% AS MEASURED BY A MODIFIED PROCTOR TEST AT THE RATE OF ONE TEST FOR EACH 1500 SF OF BUILDING PAD AREA, OR FRACTION THEREOF, FOR EACH 12" LIFT.
- REINFORCING STEEL SHALL BE GRADE 60 AND MEET THE REQUIREMENTS OF ASTM A615, ALL BENDS SHALL BE MADE COLD.
- WELDED WIRE MESH SLAB REINFORCING SHALL MEET THE REQUIREMENTS OF ASTM A185 - MIN. YIELD STRESS - 85 KSI.
- CONCRETE SHALL BE STANDARD MIX F'c = 3000 PSI FOR ALL FTGS, SLABS, COLUMNS, AND BEAMS OR SHALL BE STANDARD PUMP MIX F'c = 3000 PSI. STRENGTH SHALL BE ATTAINED WITHIN 28 DAYS OF PLACEMENT, MIXING, PLACING AND FINISHING SHALL BE AS PER ACI STANDARDS.
- CONCRETE BLOCK SHALL BE AS PER MANUFACTURER'S PRODUCT GUIDE FOR ASTM C-90 REQUIREMENTS WITH MEDIUM SURFACE FINISH - F'm = 1500 PSI
- MORTAR SHALL BE TYPE "M" OR "N" FOR ALL MASONRY UNITS.
- STRUCTURAL STEEL SHALL CONFORM TO ASTM A36 STANDARDS FOR STRENGTH, BOLTS SHALL BE ASTM A307 / GRADE 1 OR A325, AS PER PLAN REQUIREMENTS
- WELDS SHALL BE AS PER "AMERICAN WELDING SOCIETY" STANDARDS FOR STRUCTURAL STEEL APPLICATIONS.





B
S.3

STEM WALL FOUdnATION DETAIL
SCALE: 3/4"=1'-0"



FOUNDATION PLAN
SCALE: 1/2"=1'-0"

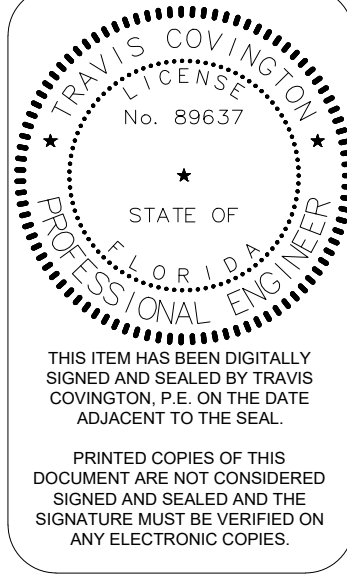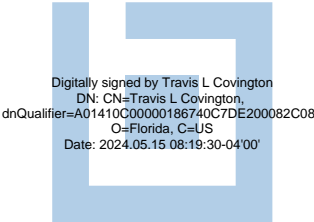

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FOUNDATION
PLAN

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ENGINEERED TRUSSES

SHALL BEAR THE SEAL OF AN ENGINEER IN THE STATE WHERE PROJECT IS BEING BUILT AND SHALL COMPLY WITH NFPA, TPI, AND AITC 100. CONTRACTOR SHALL VERIFY THAT ADEQUATE TRUSS BEARING IS INSTALLED AT ALL TRUSSES AS INDICATED IN THE TRUSS SHOP DRAWINGS. ALL TRUSS-TO-TRUSS CONNECTIONS AND TRUSS PROFILES ARE THE RESPONSIBILITY OF THE DELEGATED TRUSS ENGINEER. ALL TRUSSES SHALL HAVE TEMPORARY BRACING PER "COMMENTARY" AND RECOMMENDATION FOR HANDLING, INSTALLING, & BRACING METAL PLATE CONNECTED WOOD TRUSSES, HIB-91." AT MULTIPLE STRAP CONNECTIONS, SPREAD STRAPS TO AVOID NAILING CONFLICTS THROUGH TRUSS. WHEN USING (2) STRAPS ON SINGLE PLY TRUSSES, PLACE DIAGONALLY ACROSS DBL. TOP PLATE FROM EA. OTHER.


ROOF COVERING SPECIFICATIONS

THE CONTRACTOR SHALL BE RESPONSIBLE FOR THE DESIGN AND INSTALLATION OF THE ROOF COVERING SYSTEM. ASPHALT SHINGLES SHALL COMPLY WITH ASTM D3161 AND BE INSTALLED ACCORDING TO THE MANUFACTURER'S REQUIREMENTS. CLAY AND TILE ROOFS SHALL BE INSTALLED PER THE "CONCRETE AND CLAY ROOF TILE INSTALLATION MANUAL." AND THE MANUFACTURERS REQUIREMENTS. STANDING SEAM METAL ROOFS SHALL COMPLY WITH ASTM E1514AND BE INSTALLED ACCORDING TO THE MANUFACTURERS REQUIREMENTS. THE CONTRACTOR SHALL BE RESPONSIBLE FOR THE DESIGN AND INSTALLATION OF ALL METAL FLASHING AND VALLEY MATERIALS.


ROOF SHEATHING SPECIFICATIONS

METAL:
MIN. 1/2", 24/16 , APA RATED PLYWOOD SHEATHING, NAILED w/ 0.113x2" RING SHANK NAILS @ 6" O.C. EDGE & 6" O.C. FIELD (AT GABLE END DECREASE EDGE NAIL SPACING TO 4" O.C. WITHIN 4'-0" OF ROOF EDGE)



STANDARD HEADER SCHEDULE			
ROUGH OPENING	MATERIAL	FASTENING	STUD SPECS
0'-0" UP TO 6'-0"	DBL. 2x8 SYP #2 w/ OSB SOLID CONT. SPACER GLUED AND NAILED	10d x 0.128"x3" NAILS IN 2 ROWS @ 12" O.C. STAGGERED EA. SIDE	1 - HEADER STUD 1 - FULL HEIGHT STUD EA. SIDE
0'-6" UP TO 9'-0"	DBL. 2x12 SYP #2 w/ OSB SOLID CONT. SPACER GLUED AND NAILED	10d x 0.128"x3" NAILS IN 2 ROWS @ 12" O.C. STAGGERED EA. SIDE	1 - HEADER STUD 2 - FULL HEIGHT STUD EA. SIDE
0'-9" UP TO 16'-0"	DBL. 2x12 SYP #2 w/ OSB SOLID CONT. SPACER GLUED AND NAILED	10d x 0.128"x3" NAILS IN 2 ROWS @ 12" O.C. STAGGERED EA. SIDE	2 - HEADER STUD 3 - FULL HEIGHT STUD EA. SIDE

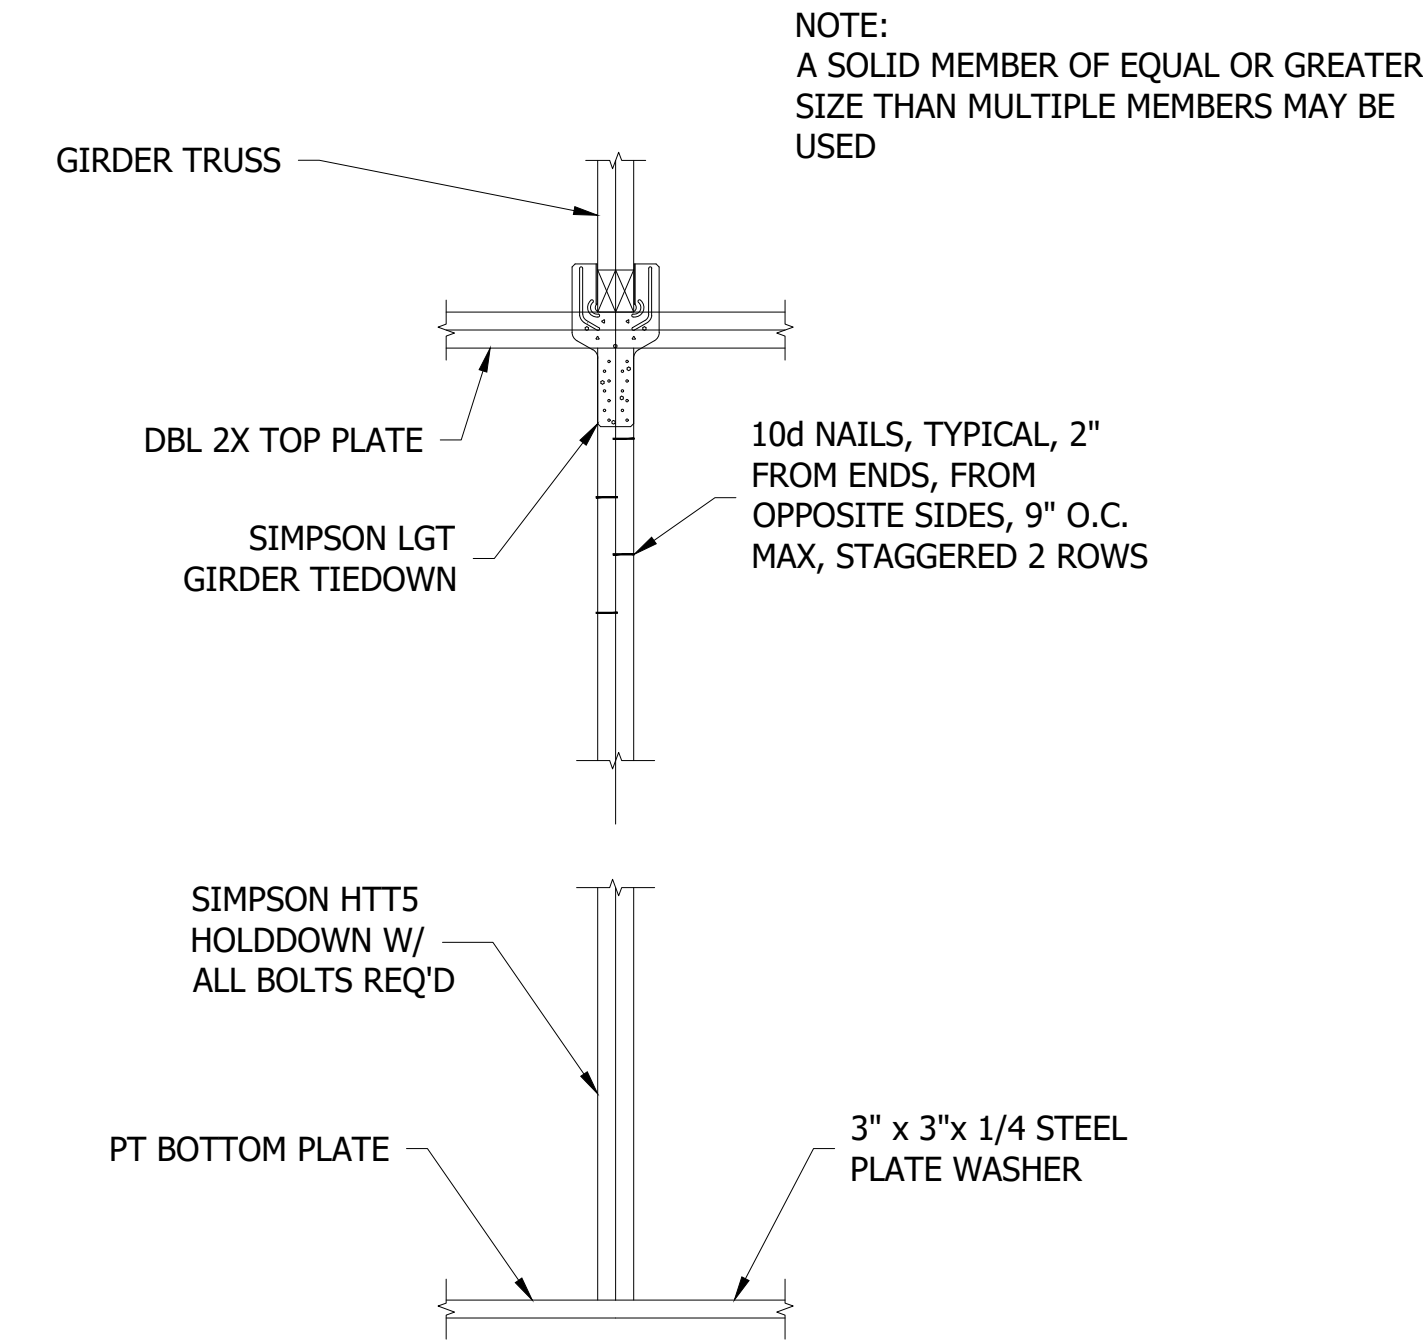

GIRDER TRUSS COLUMN DETAIL

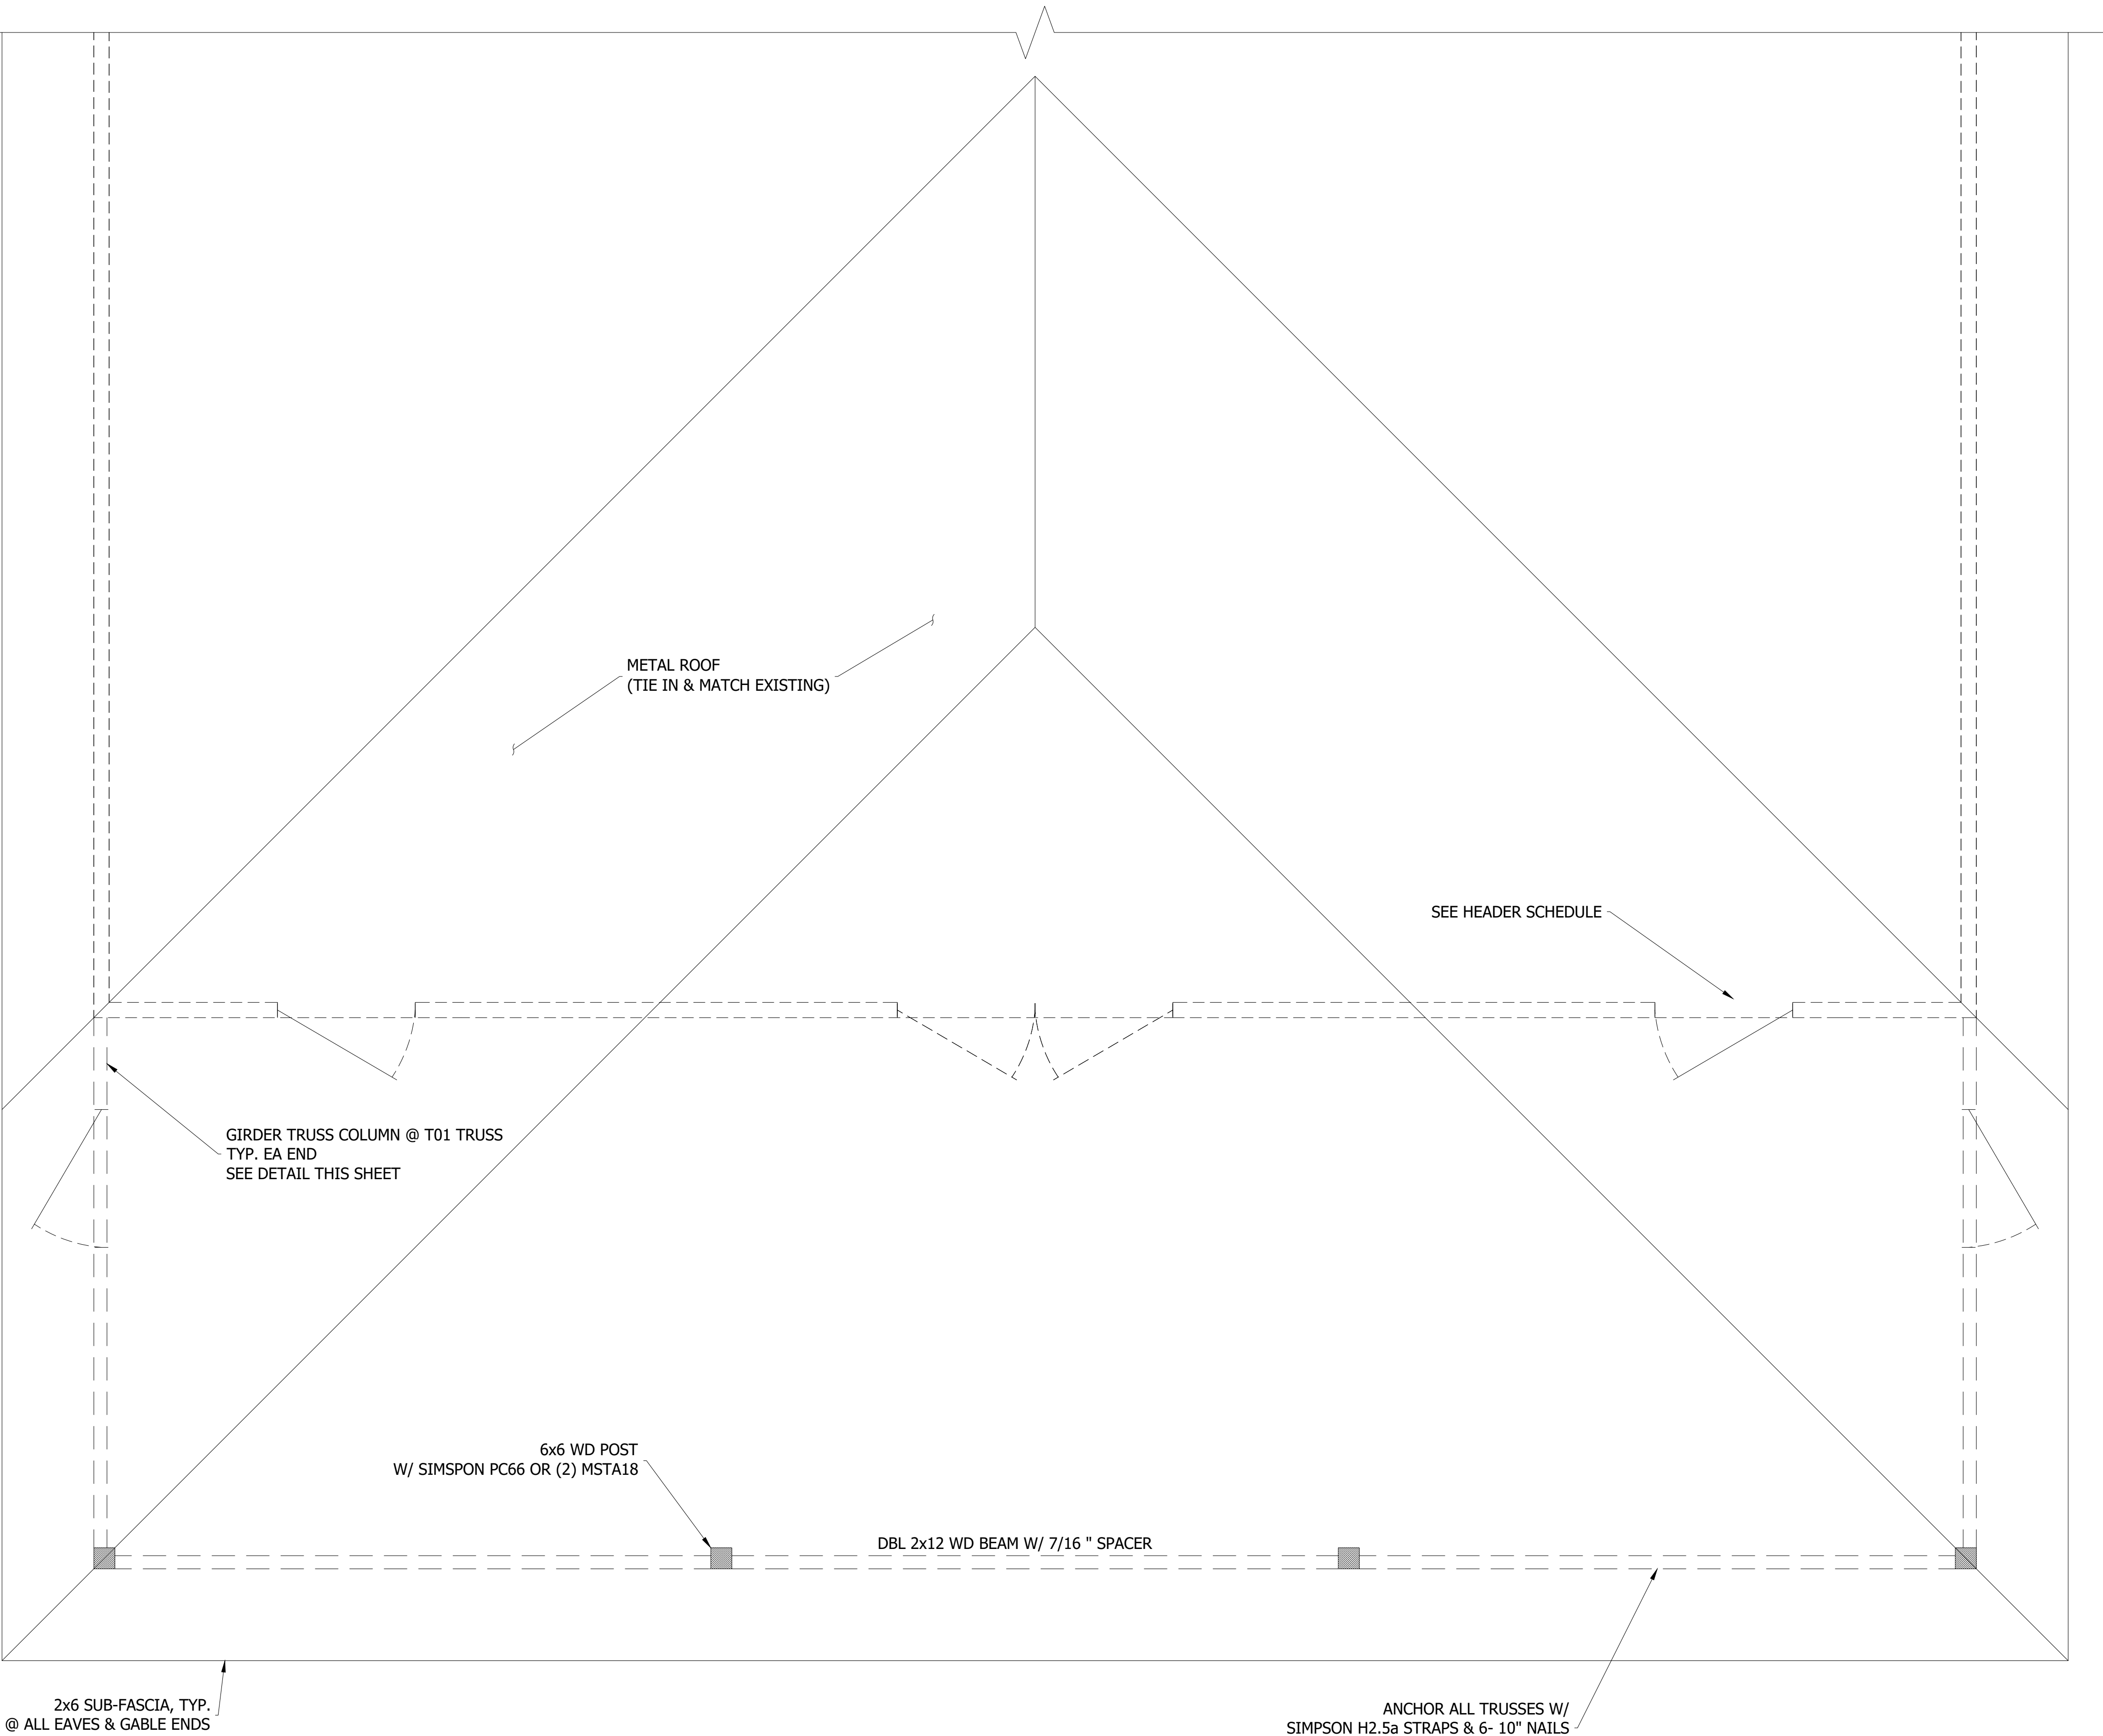

ROOF FRAMING PLAN
SCALE: 1/2"=1'-0"

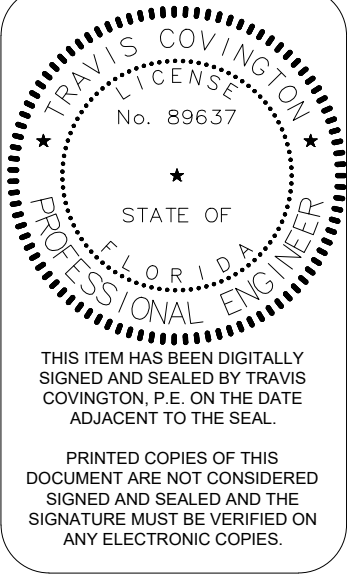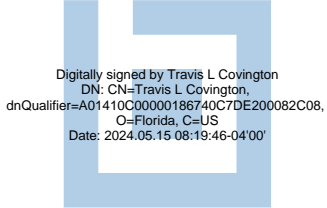

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ROOF PLAN

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