




SOFTPIAN

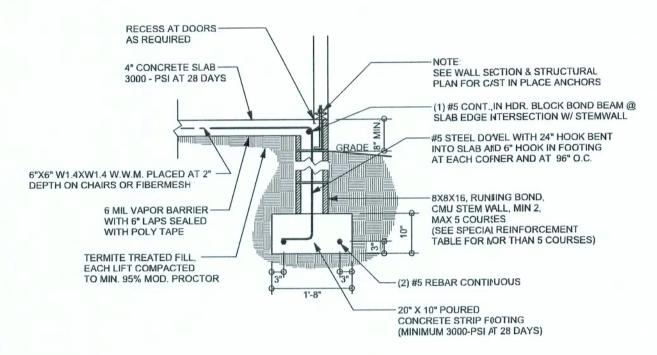


F9 STEM WALL FOOTING S-2 SCALE: 1/2" = 1'-0"

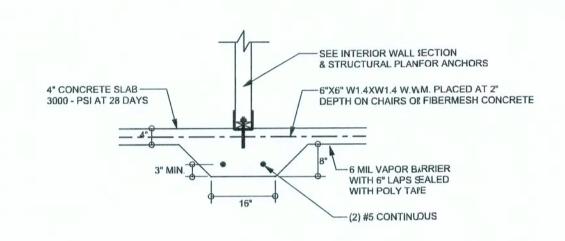


INTERIOR BEARING FOOTING S-2 SCALE: 1/2" = 1'-0"

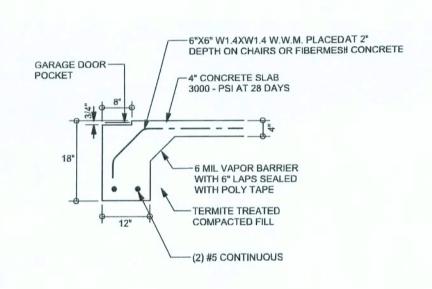

GARAGE DOOR FOOTING S-2 SCALE: 1/2" = 1'-0"

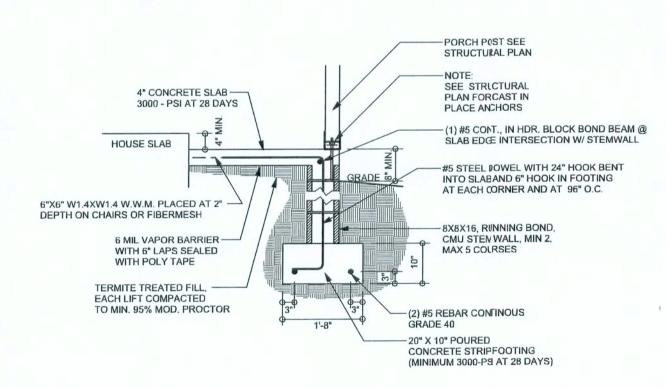

ALT. STEM WALL PORCH FCOTING S-2 SCALE: 1/2" = 1'-0"

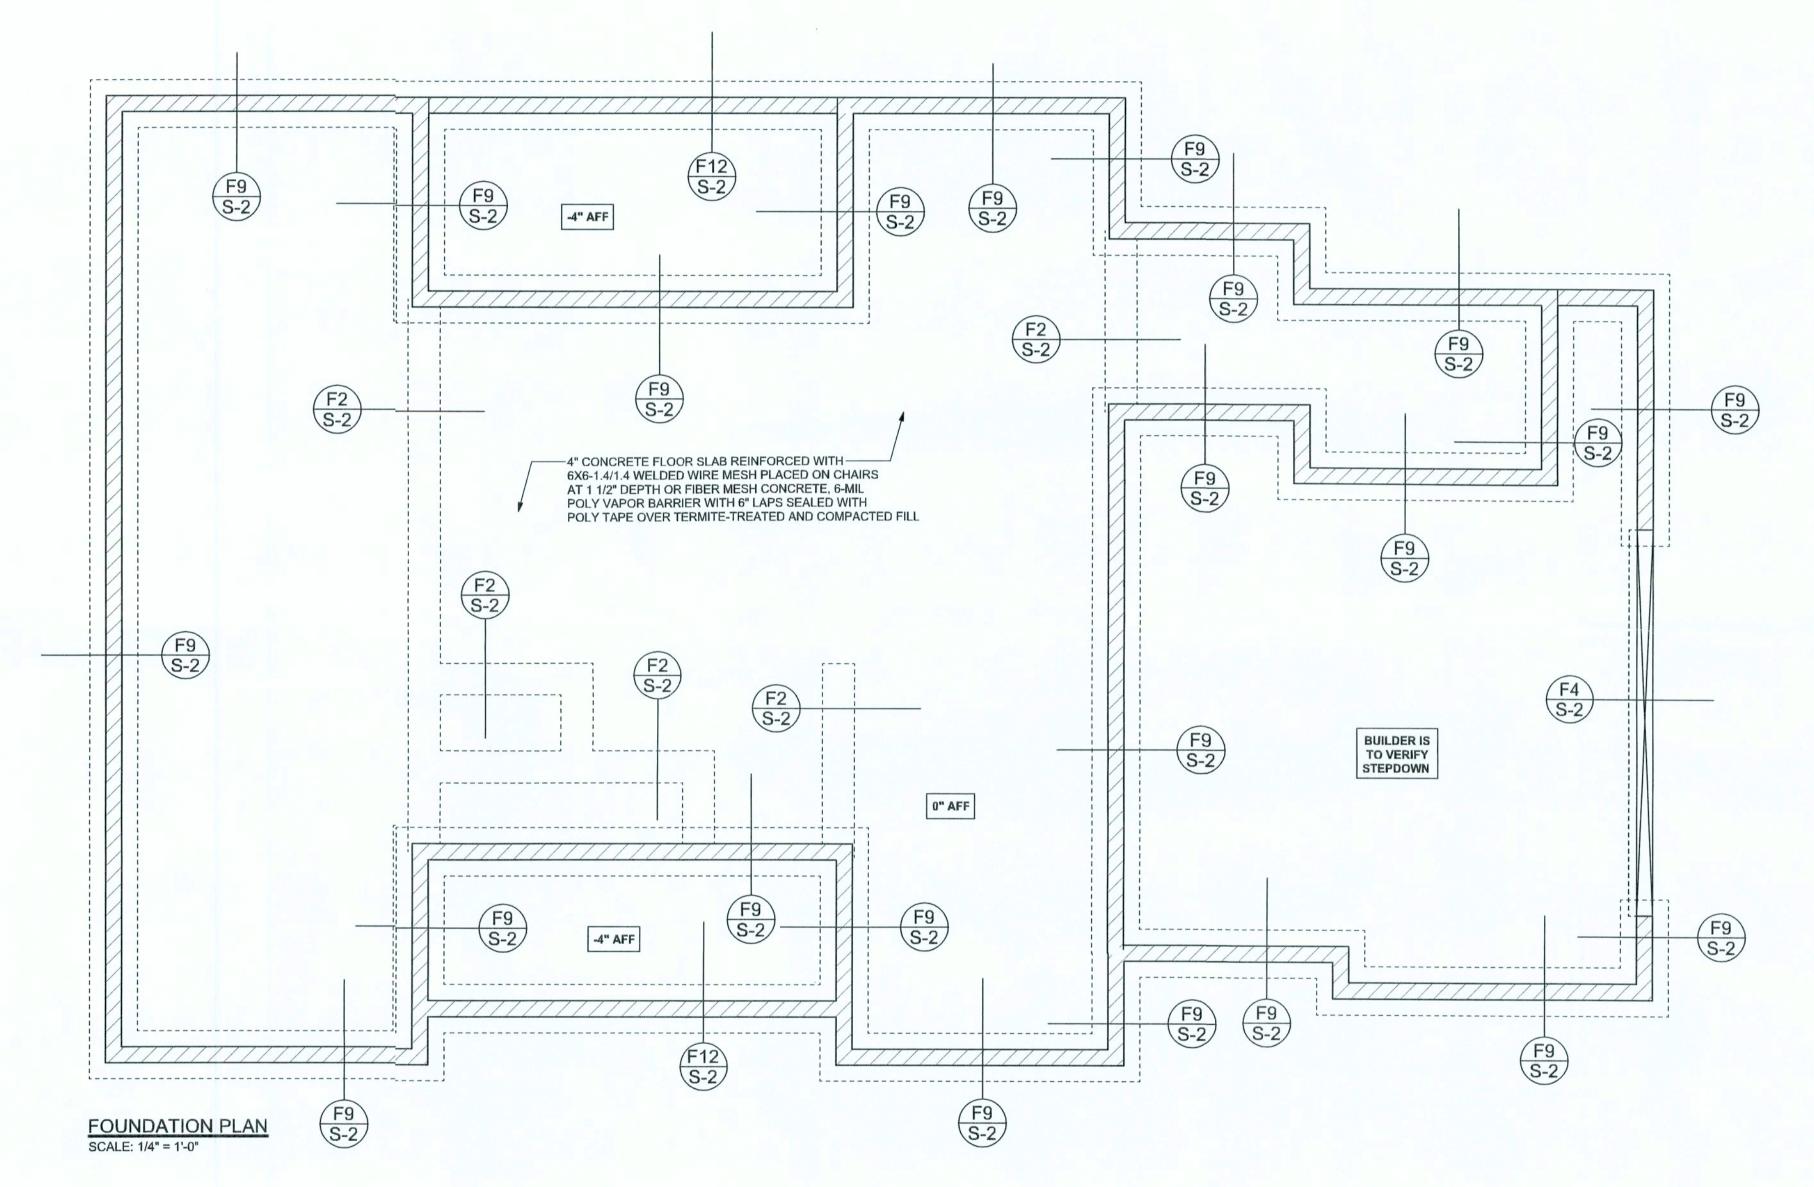

TALL STEM WALL TABLE


The table assumes 60 ksi reinforcing bars with 6" hook in the footing and bent 24" into the reinforced slab at the top. The vertical steel is to be placed toward the tension side of the CMU wall (away from the soil pressure, within 2" of the exterior side of the wall). If the wall is over 8' high, add Durowall ladder reinforcement at 16"OC vertically or a horizontal bond beam with 1#5 continuous at mid height. For higher parts of the wall 12" CMU may be used with reinforcement as shown in the table below.

| | UNBALANCED BACKFILL HEIGHT | VERTICAL REINFORCEMENT FOR 8" CMU STEMWALL (INCHES O.C.) | | | VERTICAL REINFORCEMENT FOR 12" CMU STEMWALL (INCHES O.C.) | | |
|-----|----------------------------------|--|----|----|---|----|----|
| | | #5 | #7 | #8 | #5 | #7 | #8 |
| 3.3 | 3.0 | 96 | 96 | 96 | 96 | 96 | 96 |
| 4.0 | 3.7 | 96 | 96 | 96 | 96 | 96 | 96 |
| 4.7 | 4.3 | 88 | 96 | 96 | 96 | 96 | 96 |
| 5.3 | 5.0 | 56 | 96 | 96 | 96 | 96 | 96 |
| 6.0 | 5.7 | 40 | 80 | 96 | 80 | 96 | 96 |
| 6.7 | 6.3 | 32 | 56 | 80 | 56 | 96 | 96 |
| 7.3 | 7.0 | 24 | 40 | 56 | 40 | 80 | 96 |
| 8.0 | 7.7 | 16 | 32 | 48 | 32 | 64 | 80 |
| 8.7 | 8.3 | 8 | 24 | 32 | 24 | 48 | 64 |
| 9.3 | 9.0 | 8 | 16 | 24 | 16 | 40 | 48 |

DIMENSIONS: Stated dimensions supercede scaled nensions. Refer all questions to Mark Disosway, P.E. for resolution. Do not proceed without clarification. COPYRIGHTS AND PROPERTY RIGHTS: Mark Disosway, P.E. hereby expressly reserves its common law copyrights and property right in these instruments of service. This document is not to be reproduced, altered or copied in any form or manner without first the express written permission and consent of Mark Disosway. CERTIFICATION: I hereby certify that I have examined this plan, and that the applicable portions of the plan, relating to wind engineering comply with section R301.2.1, florida building code residential 2004, to the best of my

WINDLOAD ENGINEER: Mark Disosway, PE No.53915, POB 868, Lake City, FL 32056, 386-754-5419

LIMITATION: This design is valid for one building, at specified location.

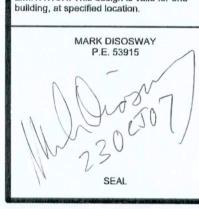

ZAC COOK RESIDENCE

ADDRESS: Rose Creek Cove S/D Columbia County, Florida

Mark Disosway P.E. P.O. Box 868 Lake City, Florida 32025 Phone: (386) 754 - 5419 Fax: (386) 269 - 4871 windloadengineer@bellsouth.net PRINTED DATE:

October 23, 2007 DRAWN BY: CHECKED BY: Evan Beamsley

wan Beamsley FINALES DATE:


Oct. 17, 2007


JOB NUMBER: 708211 DRAWING NUMBER


> S2 OF 8 SHEETS


REVISIONS

SOFTPIAN ARCHITECTURAL DESIGN SOFTWARE

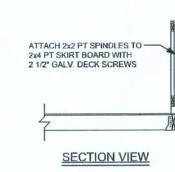

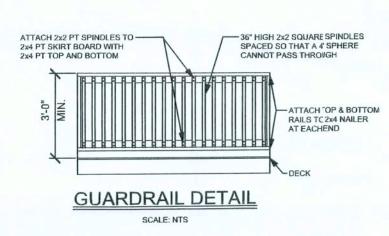

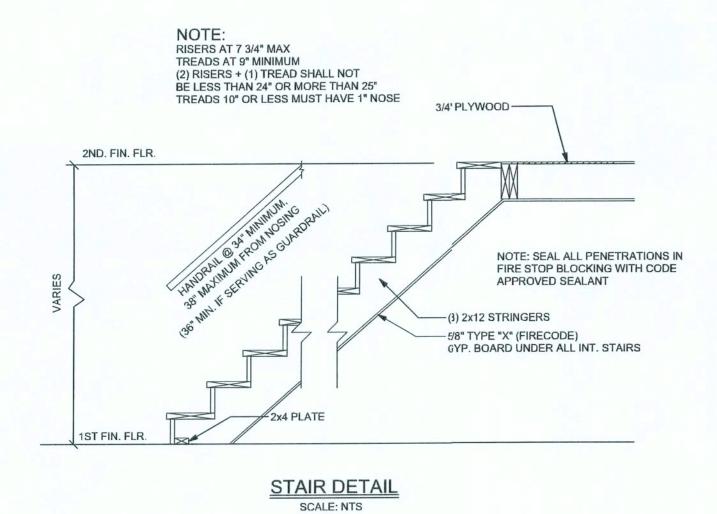

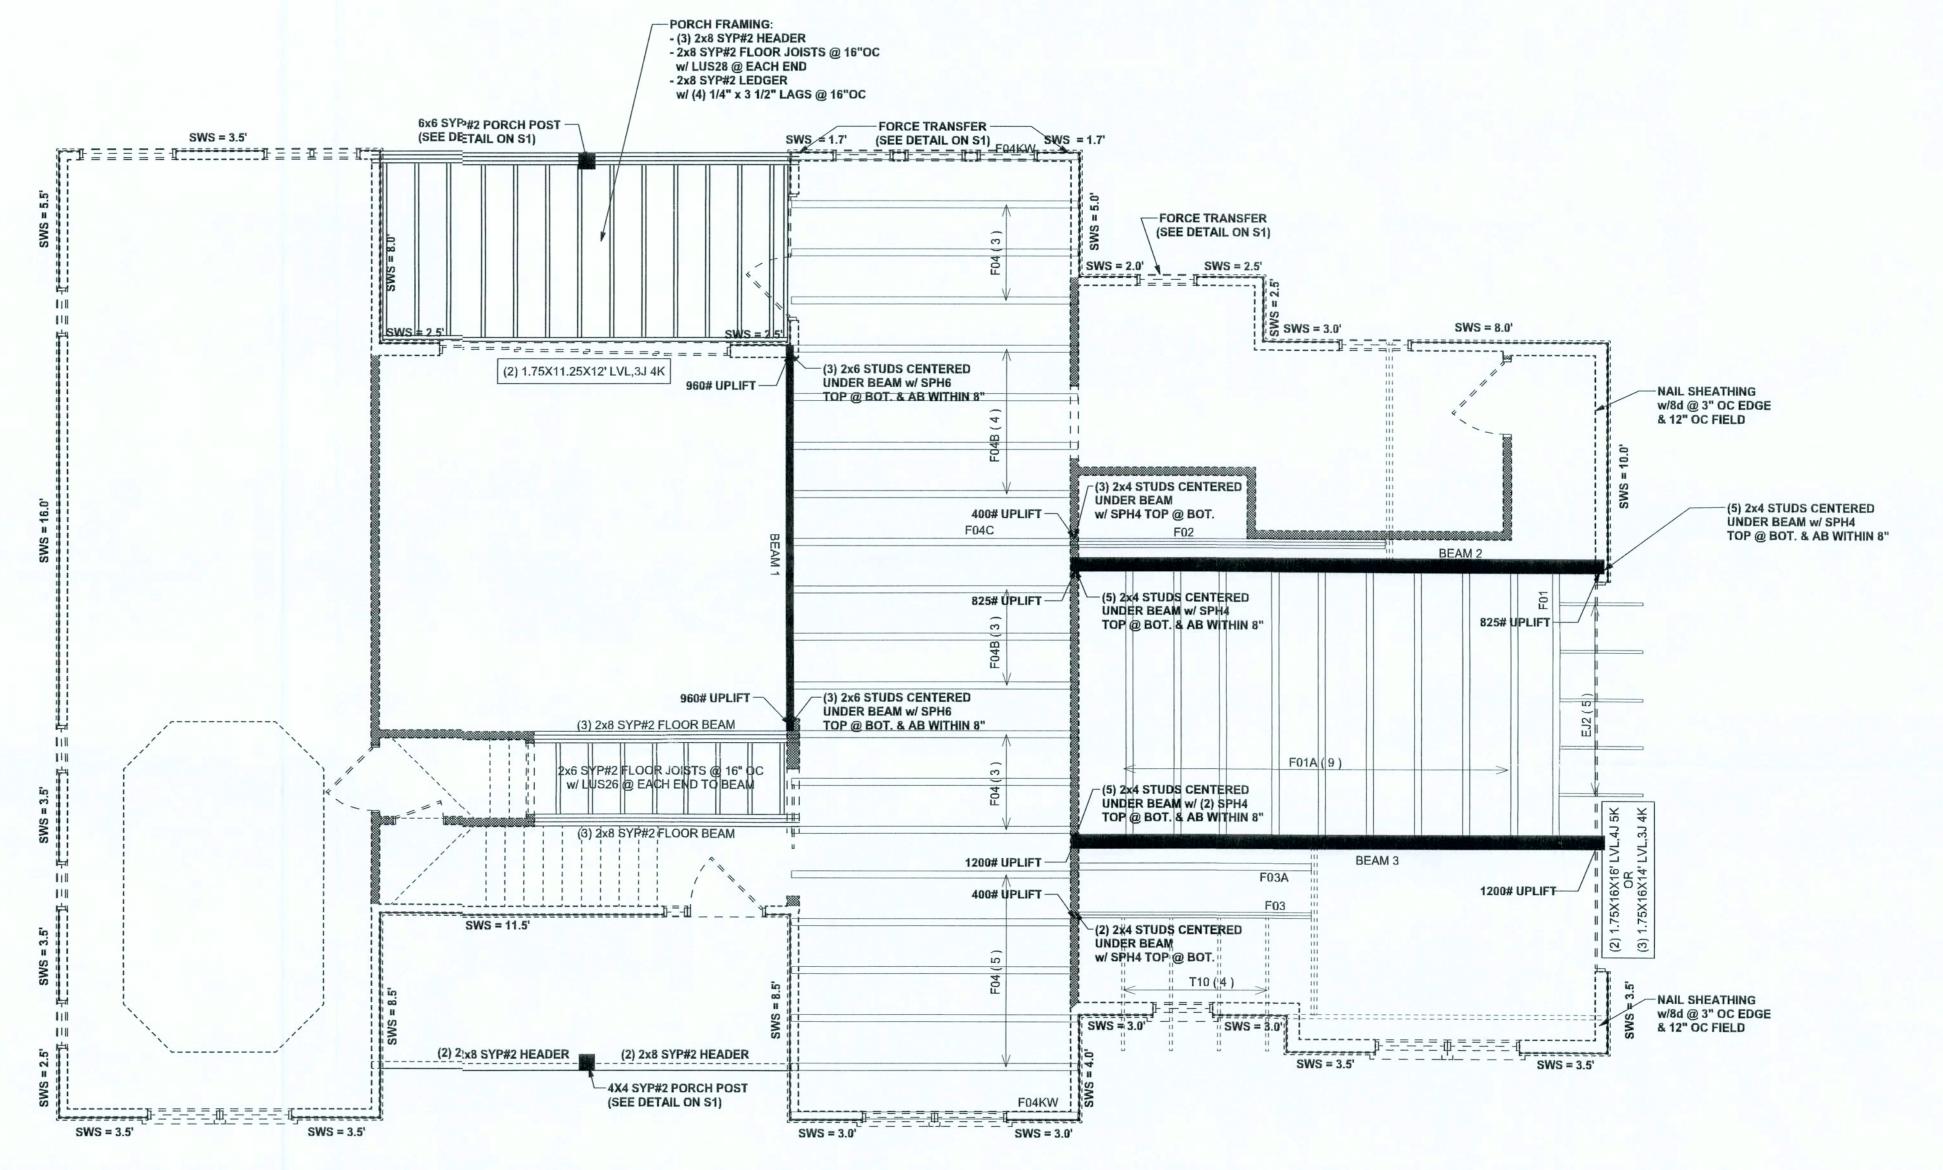

STRUCTURAL FLOOR PLAN SCALE: 1/4" = 1'-0"

STRUCTURAL PLAN NOTES

SN-1 ALL LOAD BEARING FRAME WALL & PORCH HEADERS SHALL BE A MINIMUM OF (2) 2X10 SYP#2 (U.N.O.)

SN-2 ALL LOAD BEARING FRAME WALL HEADERS SHALL HAVE (1) JACK STUD & (1) KING STUD

EACH SIDE (U.N.O.)

DIMENSIONS ON STRUCTURAL SHEETS

SN-3 ARE NOT EXACT. REFER TO ARCHITECTURAL FLOOR PLAN FOR ACTUAL DIMENSIONS

TRUSS PACKAGE

PERMANENT TRUSS BRACING IS TO BE INSTALLED AT LOCATIONS AS SHOWN ON THE SEALED TRUSS DRAWINGS:

LATERAL BRACING IS TO BE RESTRAINED PER BCSI1-03,
BCSI-B1, BCSI-B2, & BCSI-B3, BCSI-B1, BCSI-B2, & BCSI-B3

ARE FURNISHED BY THE TRUSS SUPPLIER, WITH THE SEALED

WALL LEGEND

| SWS = 0.0' | 1ST FLOOR EXTERIOR WALL | | |
|------------|--|--|--|
| SWS = 0.0' | 2ND FLOOR EXTERIOR | | |
| IBW | 1ST FLOOR INTERIOR BEARING WALLS SEE DETAILS ON SHEET S-1 | | |
| IBW | 2ND FLOOR INTERIOR BEARING WALLS SEE DETAILS ON SHEET S-1 | | |

1ST FLOOR TOTAL SHEAR WALL

 SWS = 0.0' INDICATES SHEAR WALL SEGMENTS

 TRANSVERSE LONGITUDINAL

 ACTUAL
 39285 LB
 28296 LB

 REQUIRED
 26684 LB
 18560 LB

| <u> </u> |
|--|
| WINDLOAD ENGINEER: Mark Disosway, PE No.53915, POB 868, Lake City, FL 32056, 386-754-5419 |
| DIMENSIONS: Stated dimensions supercede scaled dimensions. Refer all questions to Mark Disosway, P.E. for resolution. Do not proceed without clarification. |
| COPYRIGHTS AND PROPERTY RIGHTS: Mark Disosway, P.E. hereby expressly reserv its common law copyrights and property right these instruments of service. This document i not to be reproduced, altered or copied in any form or manner without first the express writt permission and consent of Mark Disosway. CERTIFICATION: I hereby certify that I have examined this plan, and that the applicable |
| portions of the plan, relating to wind engineer comply with section R301.2.1, florida building code residential 2004, to the best of my knowledge. LIMITATION: This design is valid for one building, at specified location. |
| MARK DISOSWAY P.E. 53915 |
| SEAL |

ZAC COOK RESIDENCE

ADDRESS: Rose Creek Cove S/D Columbia County, Florida

Mark Disosway P.E.
P.O. Box 868
Lake City, Florida 32025
Phone: (386) 754 - 5419
Fax: (386) 269 - 4871
windloadengineer@bellsouth.net

PRINTED DATE:
October 23, 2007

DRAWN BY: CHECKED BY:
Evan Beamsley

DESIGNED BY:
Evan Beamsley


FINALES DATE: Oct. 17, 2007

JOB NUMBER: 708211 DRAWING NUMBER

> S3 OF 8 SHEETS

REVISIONS

SOFTPIAN

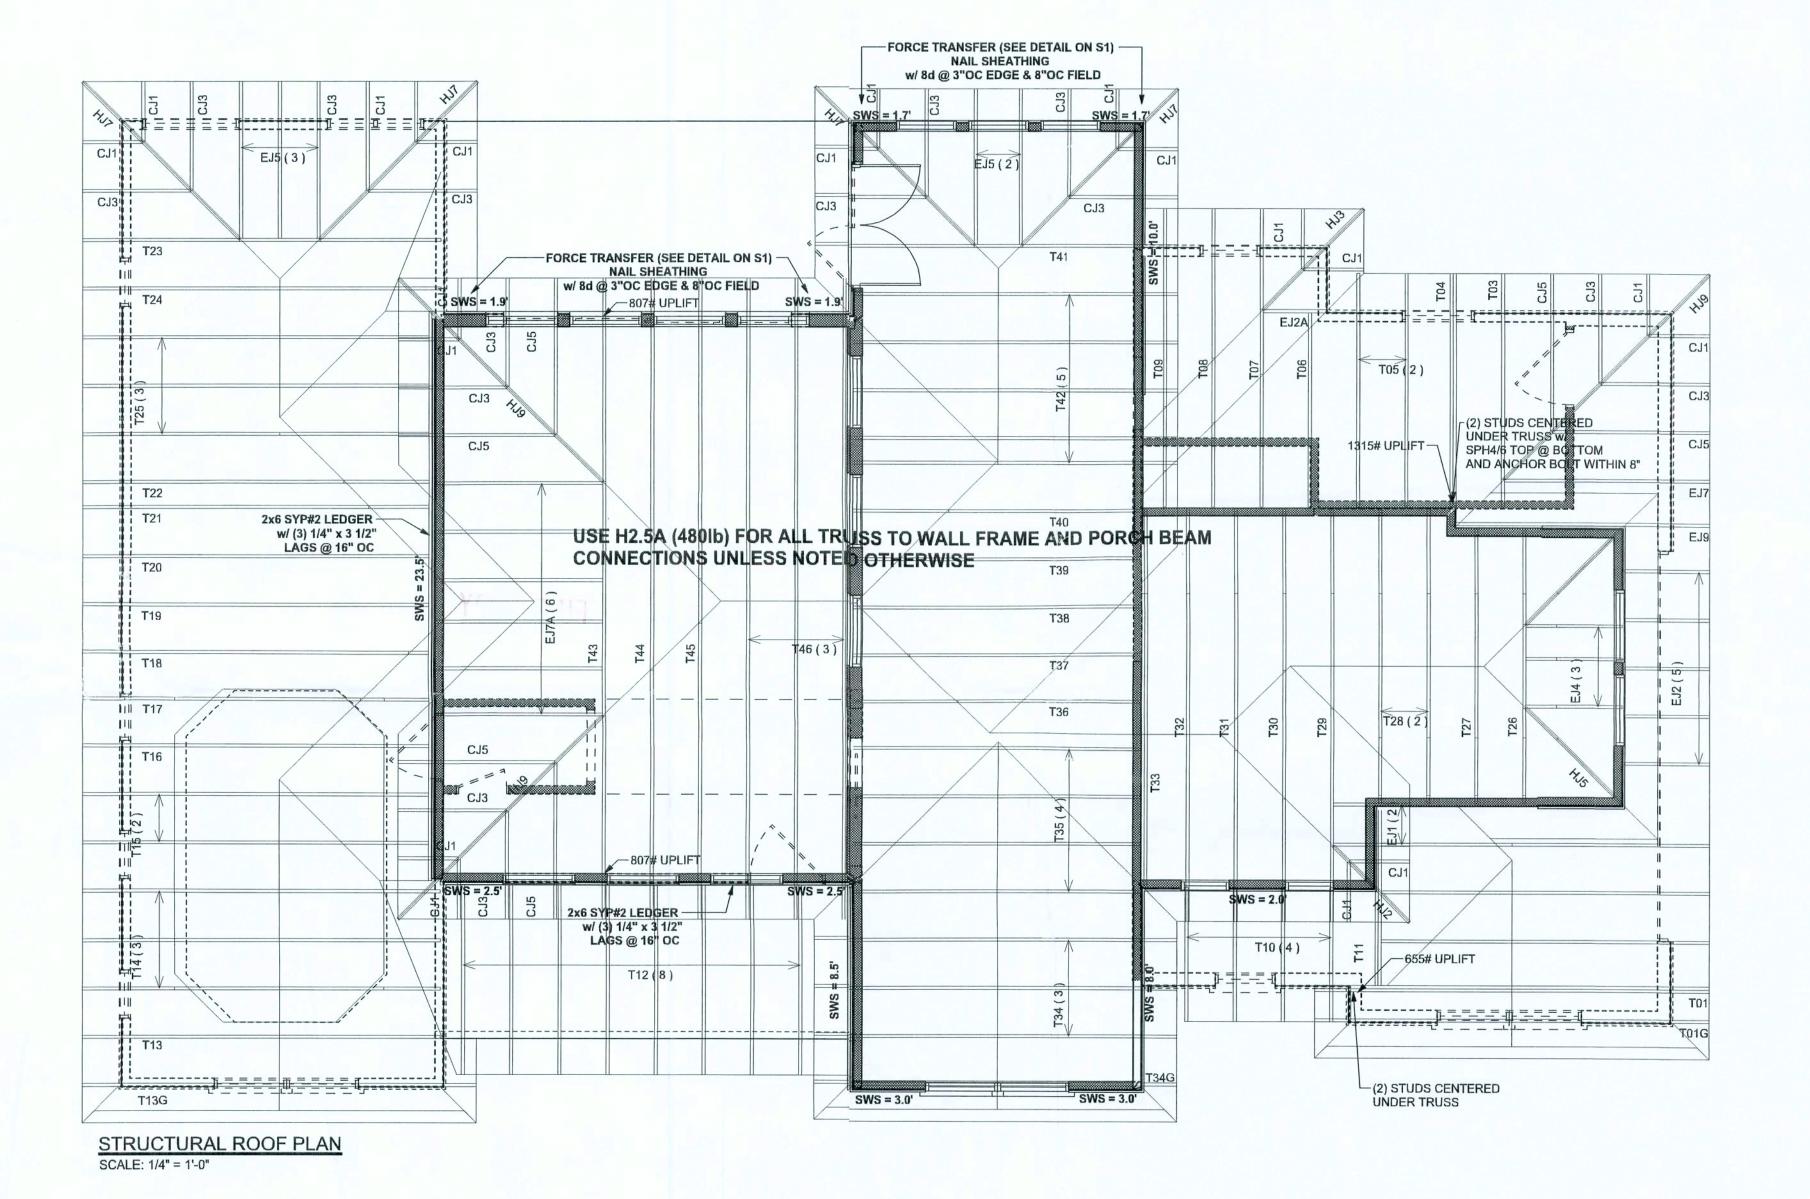

STRUCTURAL PLAN NOTES

SN-1 ALL LOAD BEARING FRAME WALL & PORCH HEADERS SHALL BE A MINIMUM OF (2) 2X10 SYP#2 (U.N.O.)

SN-2 ALL LOAD BEARING FRAME WALL HEADERS SHALL HAVE (1) JACK STUD & (1) KING STUD EACH SIDE (U.N.O.)


SN-3 DIMENSIONS ON STRUCTURAL SHEETS ARE NOT EXACT. REFER TO ARCHITECTURAL FLOOR PLAN FOR ACTUAL DIMENSIONS

PERMANENT TRUSS BRACING IS TO BE INSTALLED AT LOCATIONS AS SHOWN ON THE SEALED TRUSS DRAWINGS. LATERAL BRACING IS TO BE RESTRAINED PER BCSI1-03, BCSI-B1, BCSI-B2, & BCSI-B3, BCSI-B1, BCSI-B2, & BCSI-B3 ARE FURNISHED BY THE TRUSS SUPPLIER, WITH THE SEALED TRUSS PACKAGE

WALL LEGEND

| sws = 0.0' | 1ST FLOOR EXTERIOR WALL |
|------------|--|
| SWS = 0.0' | 2ND FLOOR EXTERIOR |
| IBW | 1ST FLOOR INTERIOR BEARING WALLS SEE DETAILS ON SHEET S-1 |
| IBW | 2ND FLOOR INTERIOR BEARING WALLS SEE DETAILS ON SHEET S-1 |

HEADER LEGEND

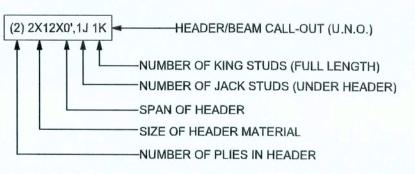

2ND FLOOR TOTAL SHEAR WALL


| | TRANSVERSE | LONGITUDINAL |
|---------|------------|--------------|
| CTUAL | 21800 LB | 11019 LB |
| EQUIRED | 10115 LB | 8538 LB |

CONNECTIONS, WALL, & HEADER DESIGN IS BASED ON REACTIONS & UPLIFTS FROM TRUSS ENGINEERING FURNISHED BY BUILDER. BUILDER FIRST SOURCE JOB # L256809

WINDLOAD ENGINEER: Mark Disosway, PE No.53915, POB 868, Lake City, FL DIMENSIONS: Stated dimensions supercede scaled intensions. Refer all questions to Mark Disosway, P.E. for resolution. Do not proceed without clarification. COPYRIGHTS AND PROPERTY RIGHTS:

Mark Disosway, P.E. hereby expressly reserves its common law copyrights and property right in these instruments of service. This document is not to be reproduced, altered or copied in any form or manner without first the express written permission and consent of Mark Disosway. CERTIFICATION: I hereby certify that I have examined this plan, and that the applicable potions of the plan, relating to wind engineering cornply with section R301.2.1, florida building code residential 2004, to the best of my kncwledge.

LINITATION: This design is valid for one building, at specified location.

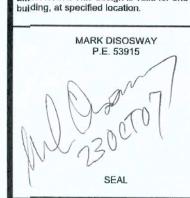

ZAC COOK RESIDENCE

ADDRESS: Rose Creek Cove S/D Columbia County, Florida

Mark Disosway P.E. P.O. Box 868 Lake City, Florida 32025 Phone: (386) 754 - 5419 Fax: (386) 269 - 4871 windloadengineer@bellsouth.net PRINTED DATE:

October 23, 2007 DRAWN BY: CHECKED BY: Evan Beamsley


Evan Beamsley FINALES DATE: Oct. 17, 2007


JOB NUMBER: 708211 DRAWING NUMBER


OF 8 SHEETS


REVISIONS

SOFTPIAN ARCHITECTURAL DESIGN SOFTWARE

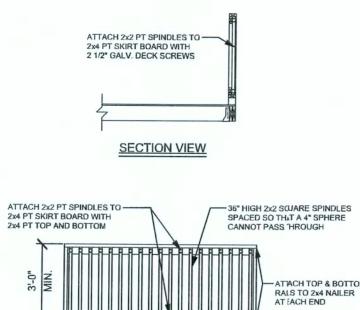

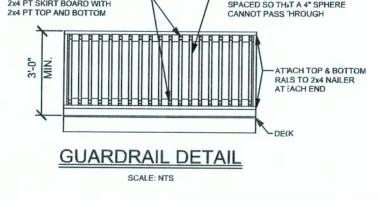

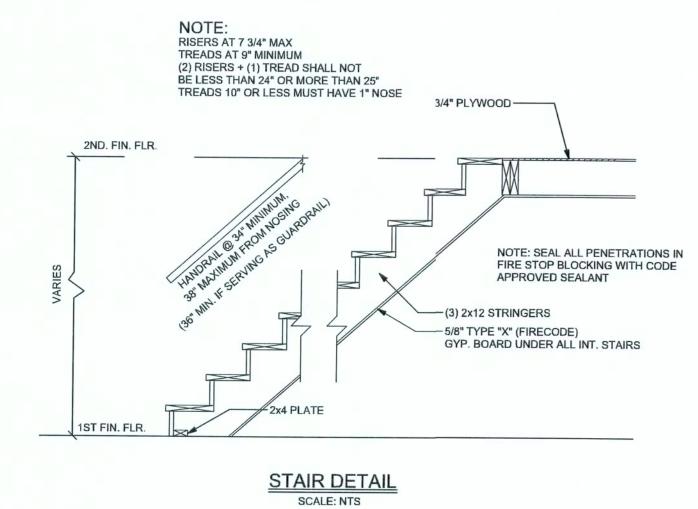

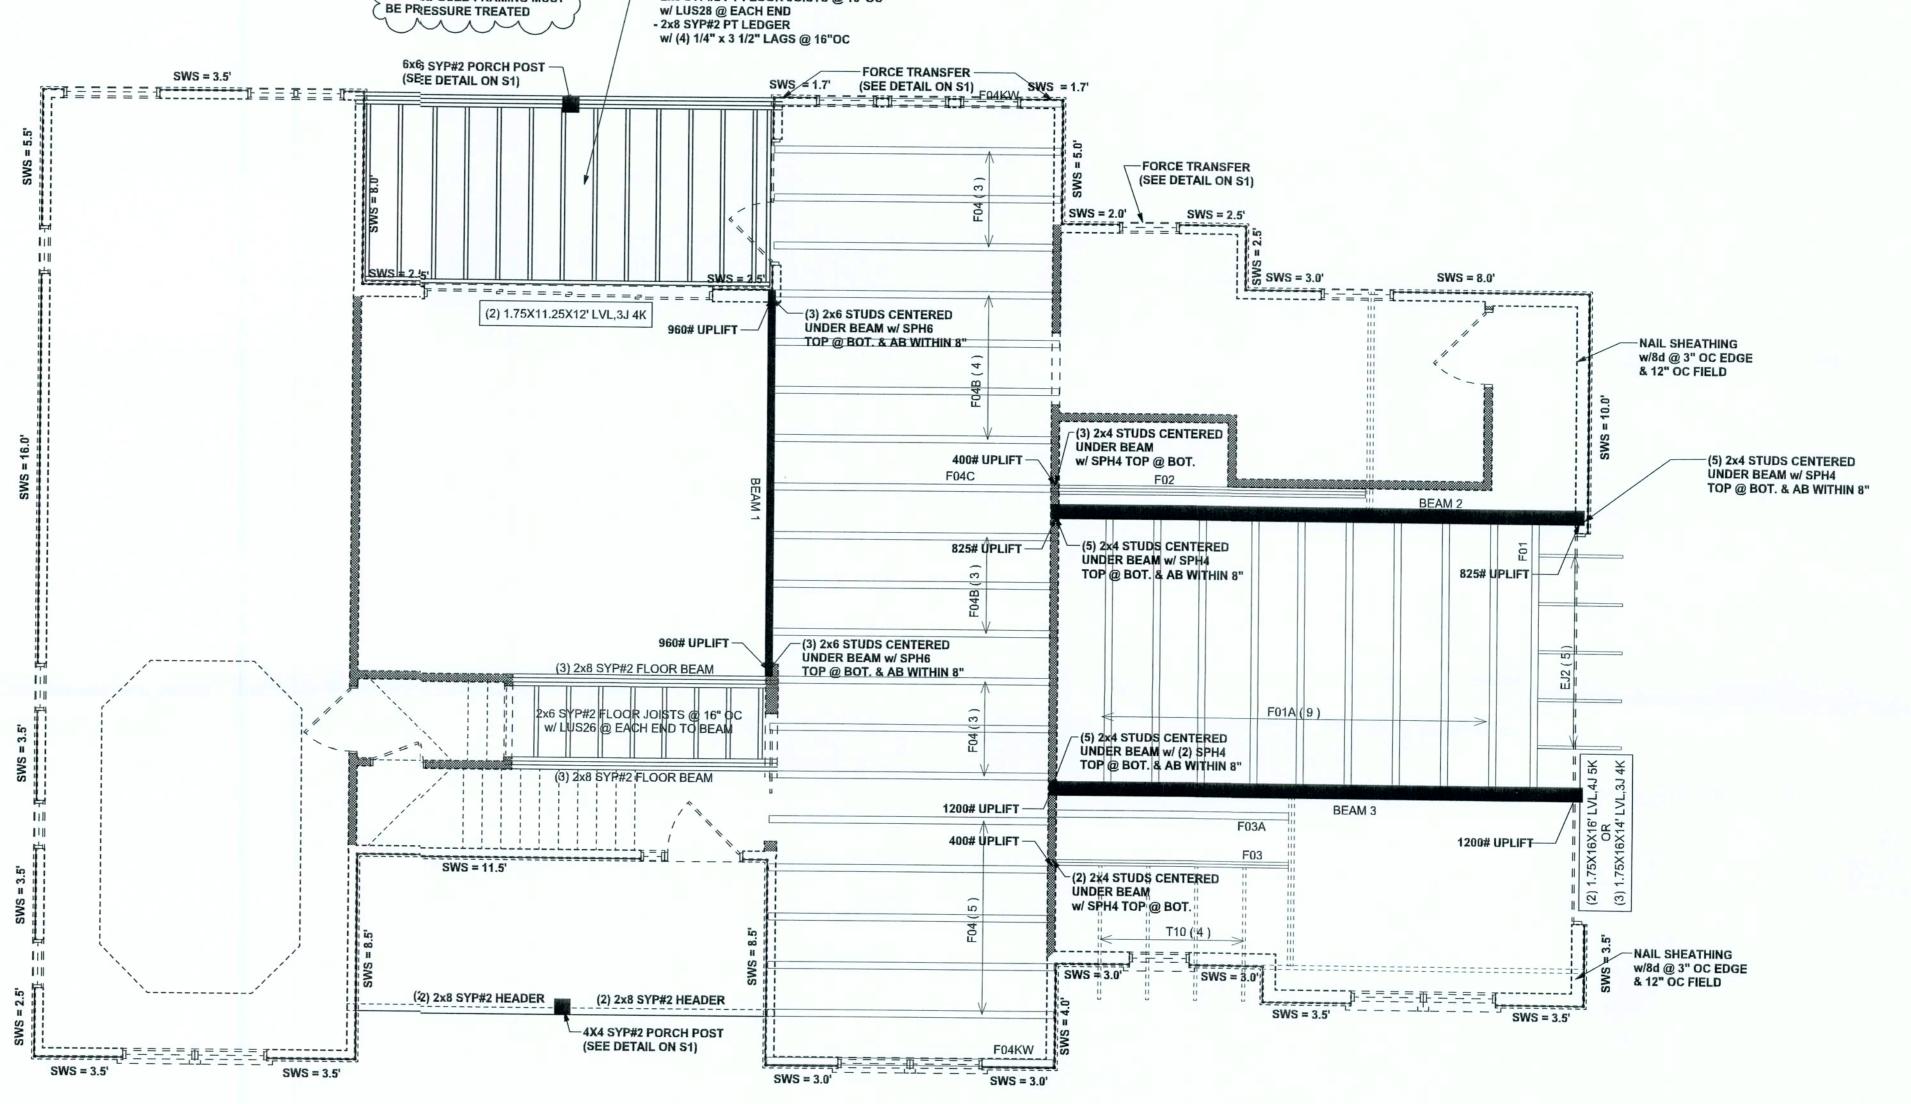

STRUCTURAL FLOOR PLAN

STRUCTURAL PLAN NOTES

SN-1 ALL LOAD BEARING FRAME WALL & PORCH HEADERS SHALL BE A MINIMUM OF (2) 2X10 SYP#2 (U.N.O.)

N-2 ALL LOAD BEARING FRAME WALL HEADERS SHALL HAVE (1) JACK STUD & (1) KING STUD EACH SIDE (U.N.O.)

SN-3
DIMENSIONS ON STRUCTURAL SHEETS
ARE NOT EXACT. REFER TO ARCHITECTURAL
FLOOR PLAN FOR ACTUAL DIMENSIONS

PERMANENT TRUSS BRACING IS TO BE INSTALLED AT LOCATIONS AS SHOWN ON THE SEALED TRUSS DRAWINGS.

SN-4

LATERAL BRACING IS TO BE RESTRAINED PER BCSI1-03, BCSI-B1, BCSI-B2, & BCSI-B3, BCSI-B1, BCSI-B2, & BCSI-B3, ARE FURNISHED BY THE TRUSS SUPPLIER, WITH THE SEALED TRUSS PACKAGE

WALL LEGEND

 \bigcirc

ALL EXPOSED FRAMING MUST

PORCH FRAMING:

- (3) 2x8 SYP#2 PT HEADER

- 2x8 SYP#2 PT FLOOR JOISTS @ 16"OC

| SWS = 0.0' | 1ST FLOOR EXTERIOR WALL |
|------------|--|
| SWS = 0.0' | 2ND FLOOR EXTERIOR |
| IBW | 1ST FLOOR INTERIOR BEARING WALLS SEE DETAILS ON SHEET S-1 |
| IBW | 2ND FLOOR INTERIOR BEARING WALLS SEE DETAILS ON SHEET S-1 |

1ST FLOOR TOTAL SHEAR WALL

 SWS = 0.0' INDICATES SHEAR WALL SEGMENTS

 TRANSVERSE
 LONGITUDINAL

 ACTUAL
 39285 LB
 28296 LB

 REQUIRED
 26684 LB
 18560 LB

WINDLOAD ENGINEER: Mark Disosway, PE No.53915, POB 868, Lake City, FL 32056, 386-754-5419

DIMENSIONS: Stated dimensions supercede scaled dimensions. Refer all questions to Mark Disosway, P.E. for resolution. Do not proceed without clarification.


COPYRIGHTS AND PROPERTY RIGHTS:
Mark Disosway, P.E. hereby expressly reserves
its common law copyrights and property right in
these instruments of service. This document is
not to be reproduced, altered or copied in any
form or manner without first the express written
permission and consent of Mark Disosway.

CERTIFICATION: I hereby certify that I have

CERTIFICATION: I hereby certify that I have examined this plan, and that the applicable portions of the plan, relating to wind engineering comply with section R301.2.1, florida building code residential 2004, to the best of my knowledge.

LIMITATION: This design is valid for one

LIMITATION: This design is valid for building, at specified location.

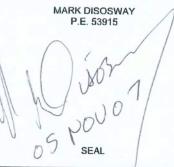

ZAC COOK RESIDENCE

ADDRESS: Rose Creek Cove S/D Columbia County, Florida

Mark Disosway P.E.
P.O. Box 868
Lake City, Florida 32025
Phone: (386) 754 - 5419
Fax: (386) 269 - 4871
windloadengineer@bellsouth.net
PRINTED DATE:

November 05, 2007

DRAWN BY: CHECKED BY:
Evan Beamsley

DESIGNED BY:

Evan Beamsley

FINALES DATE: Oct. 17, 2007 JOB NUMBER: 708211

S3
OF 8 SHEETS