

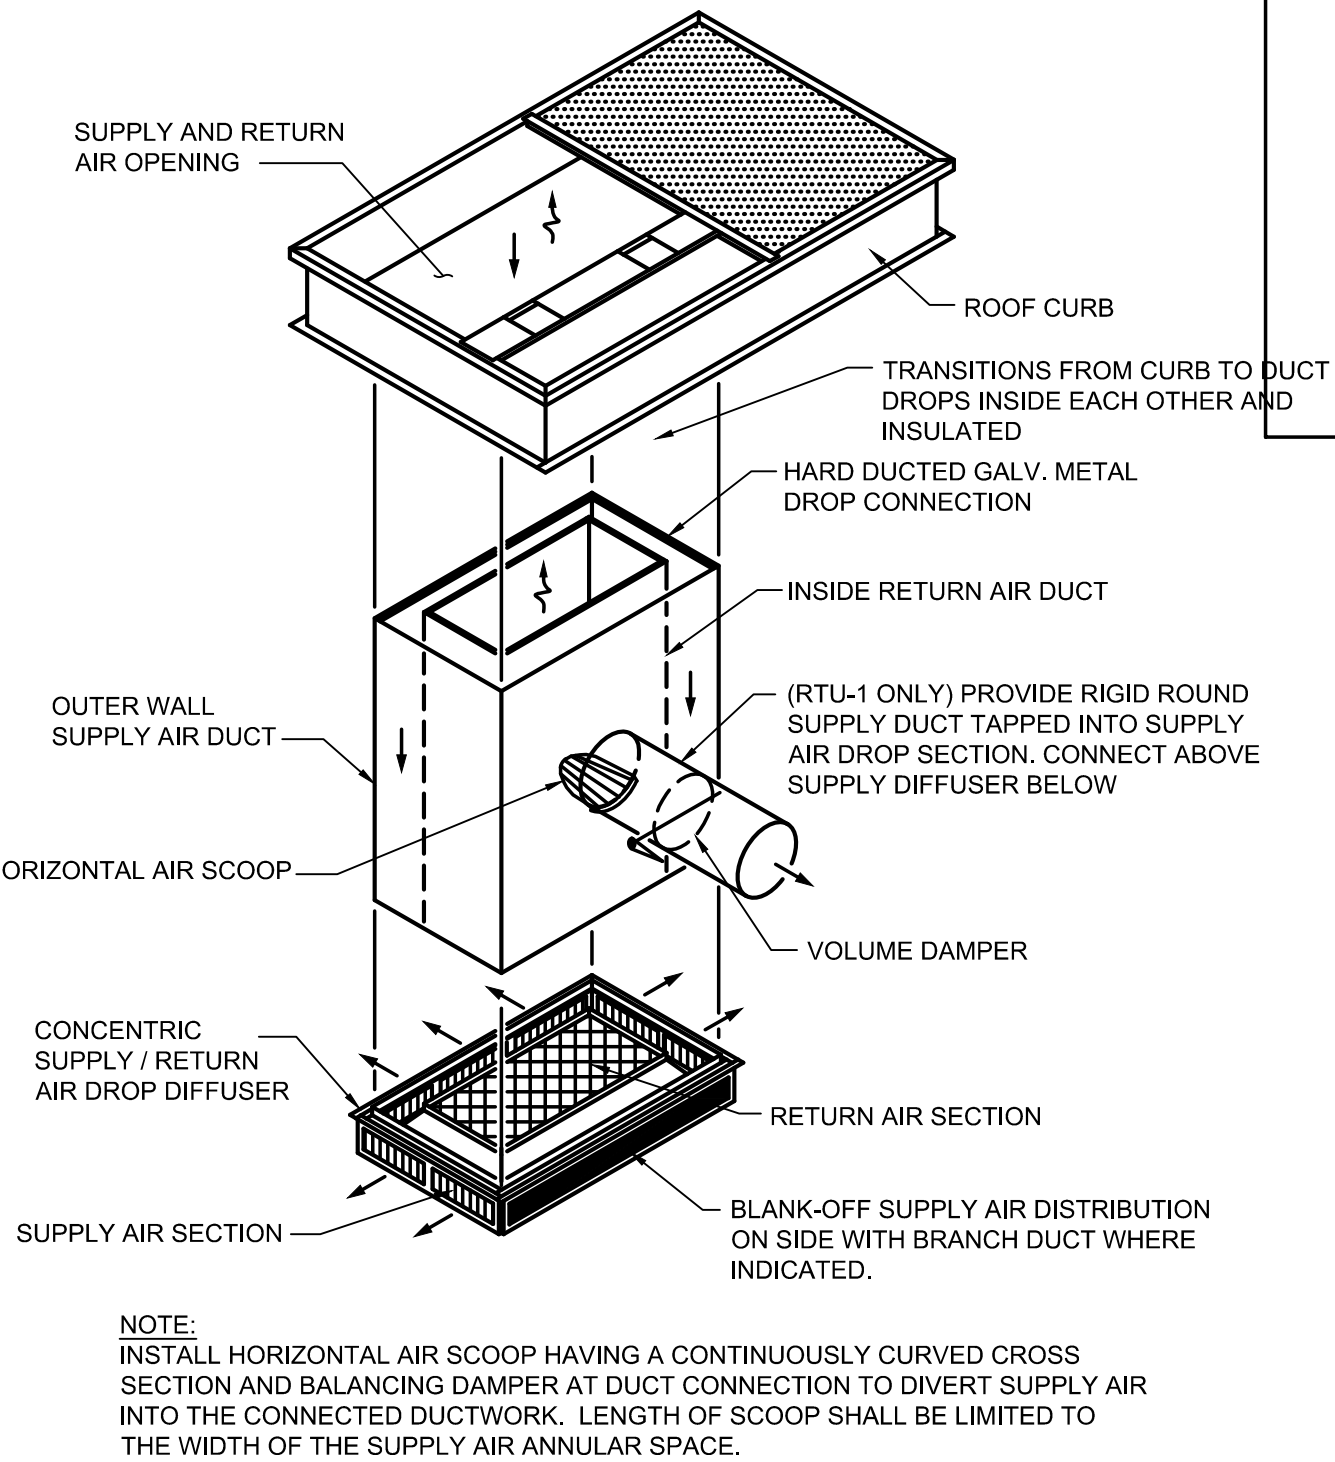


1 MECHANICAL PLAN
M1 SCALE: 1/8" = 1'-0"

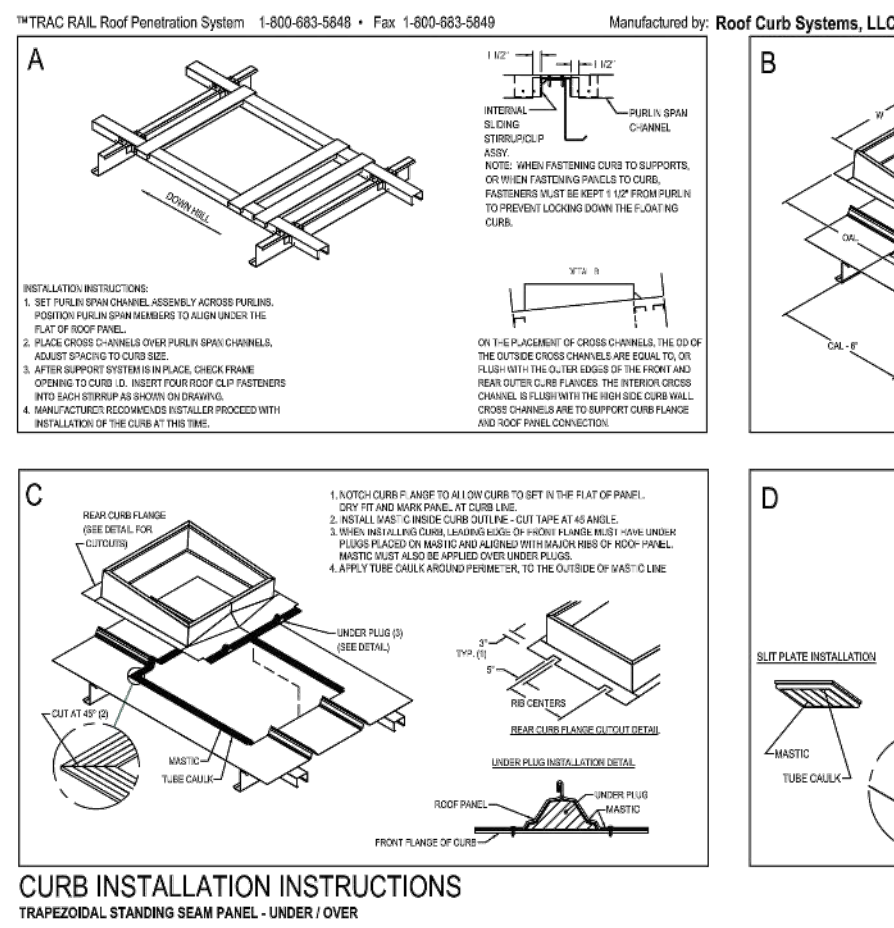

2 TYPICAL SUPPLY DROP WITH
BRANCH CONNECTION
M1 SCALE: N.T.S.

3 EMS HVAC WIRING DETAIL
M1 SCALE: N.T.S.

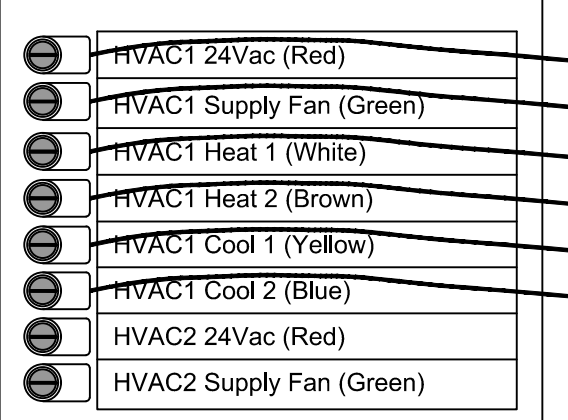


4 ROOF CURB SYSTEMS, LLC
M1 SCALE: N.T.S.

VENTILATION REQUIREMENTS							
ROOM NUMBER	ROOM NAME	NET AREA (SF)	PEOPLE PER 1,000 sq. ft.	NO. OF PEOPLE	CFM PER PERSON	CFM PER SOFT	CALCULATED OSA CFM
100	BREAK ROOM	72	(ACTUAL)	1	5	0.06	9
101	OFFICE	70	5	1	5	0.06	9
102	SALES AREA	5,649	15	85	7.5	0.12	1,315
103	RECEIVING AREA	965	-	4	-	0.12	120
104	MEN'S RESTROOM	78	-	-	70 PER TOILET	-	70
105	WOMEN'S RESTROOM	78	-	-	70 PER TOILET	-	70
				TOTAL AMOUNT OF OSA PROVIDED:		1,240	

TABLE NOTES: BASED ON 2017 FBC MECHANICAL - TABLE 403.3.1.1, INCLUDING FOOTNOTE 'W'.

AIR BALANCE ANALYSIS						
MARK	SUPPLY AIR	OSA INTAKE	RETURN AIR	EXHAUST AIR	BLDG. PRESSURE	
RTU-1	5,000	730	4,270	-	-	
RTU-2	5,000	730	4,270	-	-	
EF-1	-	-	-	110	-110	
EF-2	-	-	-	110	-110	
-	-	-	-	-	-	
TOTALS:	10,000	1,460	8,540	220	+1,240	

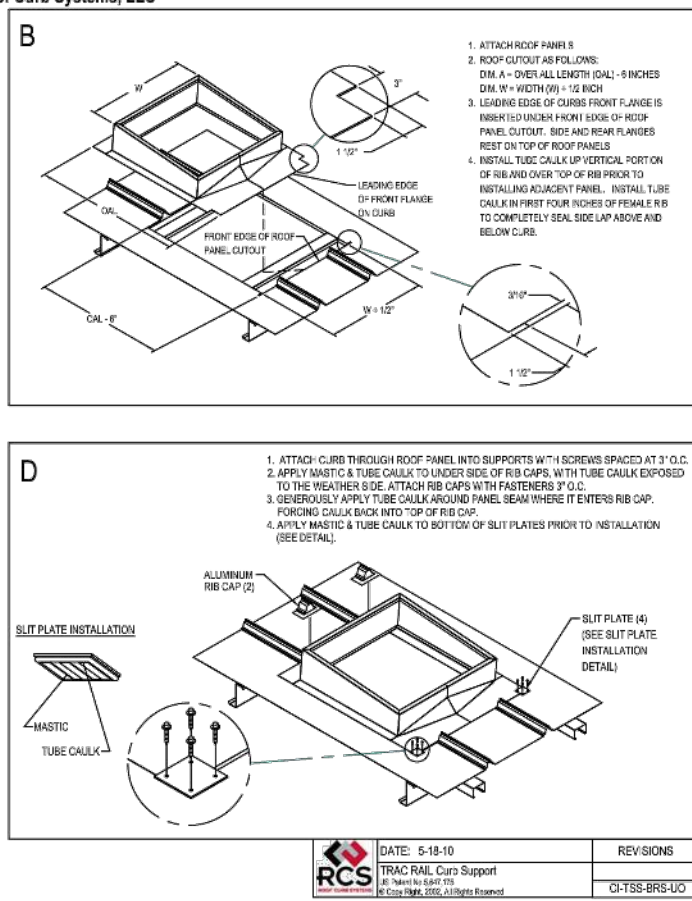

WIND LOAD CODE COMPLIANCE NOTE:
CURB SHOWN FOR GENERAL INSTALLATION INTENT.
CURB SHALL BE SECURED TO MEET LOCAL WIND LOAD
AS DETAILED ON METAL BUILDING STRUCTURAL PLANS
AND DETAILS FOR TIE-DOWN OF RTU TO ROOF CURB AND
ROOF CURB TO ROOF STRUCTURE.

AIR CONDITIONING UNIT SCHEDULE	
MARK	RTU - 1 and RTU-2
AREA	RETAIL SPACE
BTUH SENSIBLE	107,000
BTUH TOTAL	145,000 (12.5-TONS)
ENTERING DB / WB	77.7 / 65.3
AMBIENT TEMP.	95° F
SUPPLY CFM	5,000
EXTERNAL SP.	0.8
OSA CFM	REFER TO PLANS
FAN H.P.	3.7
HEAT Kw	31.8
VOLTAGE / PHASE	208 / 3
MCA	128
FUSE SIZE	150
EER (IEER)	11.0(12.4)
REFRIGERANT	R-410A
MODEL NO.	50TC-D14
MANUFACTURER	CARRIER
UNIT WEIGHT	1,500 lbs (max - confirm by vendor)

NOTES ON ACCESSORIES REQUIRED WITH UNITS:

- PROVIDE FILTER RACK w/2" 30-35% FILTERS. REPLACE AT END OF JOB AND PROVIDE (2) ADDITIONAL SETS OF SPARE FILTERS TO OWNER.
- PROVIDE SOLID-STATE HEAD PRESSURE CONTROL ON CONDENSER FAN FOR LOW AMBIENT CONTROL.
- PROVIDE 5-MINUTE SOLID STATE DELAY CONTROL TO PREVENT COMPRESSOR FROM SHORT CYCLING.
- INSTALL UNIT PER MANUFACTURER'S SPECIFICATIONS AND GUIDELINES.
- PROVIDE UNIT WITH ELECTRIC HEAT AND SINGLE POINT CONNECTION.
- UNIT DISCONNECT AND CONVENIENCE OUTLET PROVIDED BY DIV-16 (ELECTRICIAN).
- PROVIDE FACTORY MOUNTED OUTSIDE AIR HOOD WITH AUTOMATIC DAMPER, INCLUDING ECONOMIZER DAMPER WITH BAROMETRIC RELIEF AND DUAL ENTHALPY SENSOR WITH CONTROLS.
- PROVIDE UNIT WITH SIDE - DISCHARGE SUPPLY/RETURN DUCT CONNECTIONS.
- PROVIDE SIDE CONNECTIONS.
- PROVIDE COATED COILS ON CONDENSER FOR SALT WATER CORROSION PROTECTION.
- PROVIDE AS MSAV MULTI-STAGE AIR VOLUME W/ V.F.D. AND BELT DRIVE KIT AS REQUIRED.

MECHANICAL KEYED NOTES:	
①	RTU-1 AND RTU-2. PROVIDE AND INSTALL NEW PACKAGE ROOF-TOP UNIT. SEE SCHEDULE FOR UNIT INFORMATION.
②	SMOKE DETECTOR TO BE INSTALLED IN SUPPLY AIR DUCTWORK FOR ROOF-TOP UNITS. FIELD COORDINATE WITH FIRE ALARM SYSTEM USED AND LOCAL CODES.
③	INSTALL CONCENTRIC DIFFUSER KIT BY YORK TO FIT CARRIER UNITS. INCLUDE FACTORY INSTALLED TRANSITION ADAPTER AT RTU. COORDINATE WITH LIGHT FIXTURES.
④	SUPPLY REGISTER MOUNTED ON DUCTWORK. BALANCE AT 4,000 cfm EACH.
⑤	EXHAUST FAN TO BE MOUNTED ON CEILING w/DUCTWORK ROUTED TO SIDEWALL. PROVIDE STORM PROOF WALL CAP w/BACKDRAFT DAMPER (TYP.).
⑥	8"Ø EXHAUST DUCT TO WALL CAP.
⑦	WALL CAP w/BACKDRAFT DAMPER.
⑧	8"Ø DUCT (w/DAMPERS) SPLIT TO TWO 4"Ø DUCTS.
⑨	FIRE DAMPER AT WALL (SEE DETAILS M2)

SYMBOL LEGEND	
⊠	EXHAUST FAN
⊠	SUPPLY AIR DIFFUSER
⊙	TEMPERATURE SENSOR
↺	RETURN/EXHAUST AIRFLOW
↻	SUPPLY AIRFLOW
—	VOLUME DAMPER
—CD	CONDENSATE PIPE
—FD	FIRE DAMPER (FD)

AIR DEVICE SCHEDULE									
GENERAL					CONSTRUCTION				
MARK	TYPE	FUNCTION	FRAME SIZE	PATTERN	MATERIAL	FINISH	MFG.	MODEL	NOTES
CD	CEILING DIFFUSER	SUPPLY	12x12	LOUVERED FACE	ALUMINUM	WHITE	PRICE	AMD	①
SD	SIDEWALL DIFFUSER	SUPPLY	SEE PLANS	LOUVERED FACE	STEEL	WHITE	PRICE	520	①
SWR	SIDEWALL GRILLE	RETURN	SEE PLANS	BLADES	STEEL	WHITE	PRICE	530	①

NOTE: ① PROVIDE WITH OPPOSED BLADE DAMPER.

EXHAUST FAN SCHEDULE												
UNIT NO.	SERVICE	LOCATION	CFM	E.S.P. (IN W.G.)	ELECTRICAL DATA			R.P.M. HI/LO	SONES	DRIVE	MANUFACTURER MODEL NUMBER	REMARKS
					WATTS	VOLTS	PHASE					
EF-1	TOILET	CEILING	110	.125	156	120	1	-	4.0	DIRECT	NUTONE #672R	1, 2, 3, 4, 5
EF-2	TOILET	CEILING	110	.125	156	120	1	-	4.0	DIRECT	NUTONE #672R	1, 2, 3, 4, 5
-	-	-	-	-	-	-	-	-	-	-	-	-
REMARKS:												
1. PROVIDE UNIT MOUNTED DISCONNECT												
2. PROVIDE BACKDRAFT DAMPER & WALL CAP TO SERVE BOTH FANS												
3. PROVIDE SPEED CONTROLLER												
4. INTERLOCK FAN WITH LIGHT SWITCH BY ELECTRICIAN												
5. FANS TO BE U.L. LISTED & AMCA CERTIFIED.												

NOTES AND SPECIFICATIONS

- ALL MECHANICAL WORK SHALL BE DONE IN ACCORDANCE WITH THE 2020 FLORIDA BUILDING CODES, NFPA-90A, ALONG WITH ALL LOCAL LAWS AND ORDINANCES AND IN A MANNER SATISFACTORY TO THE OWNER AND A LOCAL AUTHORITY HAVING JURISDICTION. IT SHALL BE THE RESPONSIBILITY OF THE CONTRACTOR TO OBTAIN ALL REQUIRED PERMITS, INSPECTIONS AND PAY ALL APPLICABLE FEES.
- CARRIER PACKAGED HVAC SYSTEMS ARE REQUIRED (NO SUBSTITUTIONS ALLOWED). ALL HVAC EQUIPMENT SHALL BE INSTALLED IN STRICT ACCORDANCE WITH MANUFACTURERS WRITTEN INSTALLATION GUIDE. CONTACT HASAN KHALIL AT CARRIER CORPATION NAT'L ACCOUNTS AT (315) 432-7655 OR EMAIL AT HASAN.KHALIL@CARRIER.COM.
- PROVIDE CONCENTRIC DIFFUSER KIT AS SPECIFIED BY DOLLAR GENERAL NATIONAL ACCOUNTS HVAC MANUFACTURERS. (NO EXCEPTIONS PERMITTED). CONCENTRIC DIFFUSER KIT SHALL BE INSTALLED IN STRICT ACCORDANCE WITH MANUFACTURERS INSTALLATION INSTRUCTIONS. CONCENTRIC DIFFUSER SHALL BE HARD DUCTED FROM HVAC UNIT. THE USE OF FLEXIBLE DUCT DROPS ARE NOT ALLOWED, NO EXCEPTIONS.
- ALL CONDENSATE TO BE SCHEDULE 40 PVC WITH PIPE SUPPORTS AT 4-FEET INTERVALS AND SUPPORTS CLIPPED DOWN TO STANDING SEAMS ON METAL ROOF SYSTEM (SEE DETAILS).
- SMOKE DETECTORS ARE REQUIRED FOR EACH HVAC UNIT. HVAC CONTRACTOR TO INSTALL IN SUPPLY DUCT DROPS. DETECTORS TO BE FURNISHED AND WIRED BY OTHERS (REFER TO ELECTRICAL PLANS). VERIFY CURRENT ADOPTED STATE AND LOCAL CODE REQUIREMENTS FOR INSTALLATION AND MOUNTING LOCATION OF SMOKE DETECTOR.
- COORDINATE WITH METAL BUILDING VENDOR ON PROVIDING ROOF CURBS FOR RTU'S. REFER TO SHEET S3, FOR GENERAL NOTES AND DETAILS FOR ROOF CURB INFORMATION (SHOWN ON M1 FOR REFERENCE). CURB TO BE BY ROOF CURB SYSTEMS, LLC. CONTACT GC FOR METAL BUILDING VENDOR AND INCLUDE COST OF CURBS IN PRICE.
- ALL SUPPLY AND EXHAUST AIR DUCTWORK SHALL BE CONSTRUCTED OF RIGID GALVANIZED SHEET METAL AND BE FABRICATED ACCORDING TO THE LATEST EDITION OF THE SMACNA HVAC DUCT CONSTRUCTION STANDARDS FOR METAL AND FLEXIBLE DUCTWORK. SUPPLY, RETURN AND POSITIVE PRESSURE EXHAUST DUCTWORK SHALL BE SEALED IN ACCORDANCE WITH SMACNA SEAL CLASS C. INSULATE ALL SUPPLY AND RETURN DUCT DROPS TO CONCENTRIC DIFFUSERS WITH FIBERGLASS RIGID BOARD ON EXTERIOR (R-4.2) THAT IS ASTM-E84 COMPLIANT. INSULATE ROUND SUPPLY DUCT FOR OFFICE AREA WITH EXTERNAL FIBERGLASS DUCT WRAP (R-4.2) THAT IS UL-181 COMPLIANT.
- TESTING OF HVAC UNITS THRU EMS PANEL IS ACCOMPLISHED BY WARMING UP OR COOLING DOWN A SPACE TEMPERATURE SENSOR AND WATCH THE FAN, HEAT AND COOL STAGES CYCLE ON AND OFF. THIS REQUIRES TWO PEOPLE AT ALL TIMES, ONE TO WATCH THE SCREEN AND THE OTHER TO WATCH OPERATION OF THE HVAC UNIT. WHEN COMPLETE, PRESS THE HOME BUTTON TO RETURN TO THE MAIN SCREEN.
- COORDINATE HVAC SENSORS LOCATIONS WITH SHEET EMS1. LOCATE SPACE TEMPERATURE SENSORS AT 8'-0" A.F.F.
- POWER TO HVAC UNITS LISTED IN PREFERENCE ORDER.
- PROVIDE CEILING MOUNTED EXHAUST FAN FOR RESTROOMS. INTERLOCK WITH RESTROOM LIGHTS. EXHAUST FAN SHALL BE VENTED THRU SIDE WALL, NOT THRU THE ROOF.
- CONCENTRIC DIFFUSERS, AVAILABLE THROUGH YORK, CAN BE USED ON ALL VENDOR'S EQUIPMENT. CONTACT YORK NATIONAL PRICING FOR INFORMATION. LOCATE THE BOTTOM OF DIFFUSER AT 12'-0" AFF. CONTACT NATIONAL ACCOUNTS AT 1-800-481-9738 OR EMAIL YORK-DOLLARGENERAL-BE@JCI.COM.

SMOKE DETECTOR NOTES:	
1.	THE DUCT SMOKE DETECTORS SHALL BE INSTALLED TO STOP THE FAN IN THE HVAC DUCT SYSTEM OVER 2,000cfm (RTU-1 AND RTU-2)
2.	DETECTORS WITH ALARMS TO BE FURNISHED AND WIRED BY OTHERS. REFER TO ELECTRICAL PLAN # E1 FOR SPECIFICATIONS OF DETECTORS. COORDINATE WITH ELECTRICIAN FOR FINAL LOCATIONS OF DETECTORS IN SUPPLY DUCT DROPS PER CODE.
3.	SMOKE DETECTORS SHALL BE INSTALLED IN ACCORDANCE WITH FBC 2020 7th EDITION OF MECHANICAL CODE, SECTION 508.

EQUIPMENT LABEL SPECIFICATIONS:	
1.	ALL HVAC EQUIPMENT SHALL BE FURNISHED WITH BLACK LAMINATED PLASTIC LABEL w/WHITE ENGRAVED LETTERING AND FASTENED MECHANICALLY TO THE EQUIPMENT.
2.	LABEL SHALL HAVE THE FOLLOWING INFORMATION w/1/2" LETTERING: EQUIPMENT # SUITE/SPACE #

SEQUENCE OF OPERATION (A/C UNITS)	
A.	SUPPLY FANS: THE EVAPORATOR FAN WILL RUN CONTINUOUSLY DURING OCCUPIED HOURS, AND CYCLE ON/OFF WITH COOLING/HEATING WHEN IN UN-OCCUPIED MODE, AS PROGRAMMED.
B.	OUTSIDE AIR DAMPER (RTU'S): OPEN WHEN EVAPORATOR RUNS (SEE ITEM "A" ABOVE)
C.	COOLING COIL: WHEN SPACE AIR TEMP IS ABOVE SETPOINT (75F OCCUPIED/80F UNOCCUPIED) THE COMPRESSOR SYSTEM SHALL ENERGIZE IN STAGES TO MAINTAIN SPACE SETPOINT.
D.	HEATING COIL: WHEN SPACE AIR TEMP IS BELOW SETPOINT (68F OCCUPIED/60F UNOCCUPIED) THE ELECTRIC HEATER WILL ENERGIZE IN STAGES TO MAINTAIN HEATING SPACE SETPOINT.

SEQUENCE OF OPERATION (EXHAUST FANS)	
A.	RESTROOM FAN: FAN WILL START AND RUN FULL SPEED WHEN OCCUPANCY SENSOR IS TRIGGERED.

THIS ITEM HAS BEEN ELECTRONICALLY SIGNED & SEALED ON 03/01/2021 BY MATTHEW D. LEWIS, P.E., USING A DIGITAL SIGNATURE.

Digitally signed by Matthew D. Lewis, DN: cn=Matthew D. Lewis, o=Dollar General, ou=Engineering, email=matthew.d.lewis@dollar-general.com, c=US, Reason: I have signed this document with my digital signature.

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Date: 2021-03-01 10:00:00

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AR#4452

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LICENSE # CAC-1315449

DOLLAR GENERAL

SR 19 & CR 242
LAKE CITY, FL 32024

STORE #180
2019 PROTOTYPE - PLAN DGH-D - 9,100 SQ. FT.

DRAWING DATE / DRAWN BY:
03/01/2021 - JEM

REVISION DATE / REVISION BY:

PROJECT NUMBER:
4000.213

DRAWING TITLE:
MECHANICAL PLAN

SHEET NO.

M1

Foreword

This publication details the installation requirements for dynamic application fire dampers as manufactured by Miami Tech Inc. Use of this manual for systems or products not manufactured or supplied by Miami Tech Inc shall not be applicable.

All products covered by this manual have been tested in accordance with UL555 and are authorized to bear the UL classification mark for fire dampers. Specific Fire Damper model numbers and their corresponding UL file numbers may be found in UL's Fire Resistance Directory. Miami Tech Inc. Fire Dampers have meet current UL requirements for Dynamic Curtain Style Fire Dampers July 2002.

For specific fire damper location requirements, duct construction and connection or installation practices, refer to the following codes or standards:

NFPA Publications:

NFPA 90A - Standard for the Installation of Air-Conditioning and Ventilation Systems

UL Publications:

UL555 - Standard for Safety, Fire Dampers, Dynamic Dampers 7/2002.


SMACNA Publications:

Fire, Smoke and Radiation Damper Installation Guide for HVAC Systems Guide
HVAC Duct Construction Standards - Metal and Flexible


The Installation Instructions found within this manual have been specifically drawn and detailed to meet the requirements of UL555. Some jurisdictions may require additional or different installation methods; therefore, consult with the authority having jurisdiction for specific differences. For these cases, the requirements defined by the authority having jurisdiction will take precedence over the documents contained herein.

1/2003

Model 151A • 1.5 Hour Single Section Dynamic Fire Damper

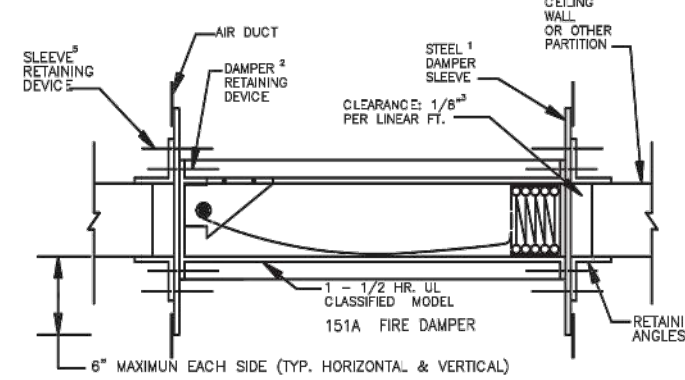HORIZONTAL MOUNTING
(Model 151A)

Fusible Link - 165°F

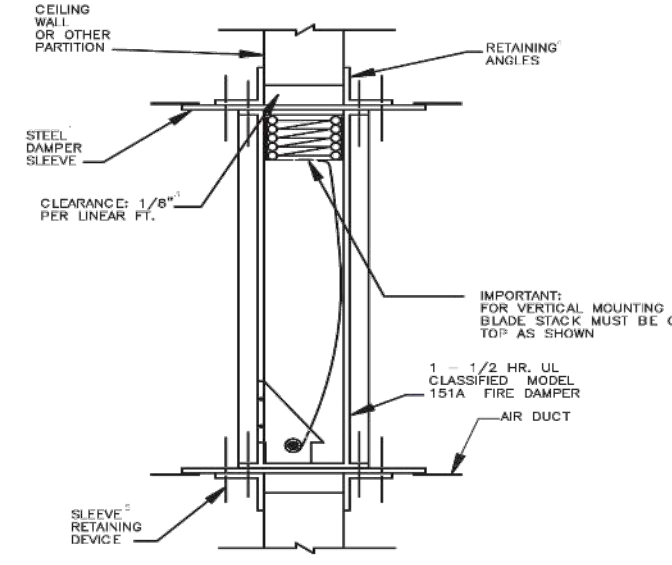
VERTICAL MOUNTING
(Model 151A)

NOTES:

1. Sleeve shall be of the same or heavier gauge as the duct to which it is attached. Gauges shall conform to SMACNA or ASHRAE Duct Standards. When the following duct-sleeve connections are used, minimum gauge of the sleeve shall be 16 gauge on dampers not exceeding 24" wide x 24" high and 14 gauge on larger dampers: (a) angle reinforced standing seam, (b) angle reinforced pocket lock, (c) companion angle, or (d) metal fasteners spaced approximately 16" on center. Refer to the latest edition of UL 555 for connections which may be used in all systems.
2. Damper is secured to sleeve by the use of either 1/4" diameter steel nuts and bolts, No. 10 sheetmetal screws, 1/4" diameter steel rivets, or 1/2" long welds...all of which must be 6" on center and a maximum of 1 3/4" from the ends.
3. Fire dampers shall have clearance of 1/8" per linear foot on width and height. The unit (damper and sleeve) may rest on the bottom of the opening and need not be centered.
4. Retaining angles shall be a minimum of 1 1/2" x 1 1/2" x 16 gauge steel. Angles increase in size proportionally, so that there will be a minimum of 1" overlap on the partition, and angles must also cover corners of opening.
5. The sleeve is retained in the partition opening by the use of either 1/4" diameter steel nuts and bolts, No. 10 sheetmetal screws, 1/4" diameter steel pop rivets or 1/2" long welds...all of which must be 6" on center and no more than 2" from the ends. Devices are to attach angle to sleeve only.
6. This installation is for dampers which are to be installed in masonry walls only. See Installation for Alternate Framing Methods on page 5, for wood stud and metal stud partition.
7. Connecting ducts shall be terminated at the sleeve or transition collar where a draw-band type breakaway joint is used.
8. Maximum duct size of single section Model 151A unit is 24" wide x 24" high.

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Model 150 & 151 • Alternate Framing Methods

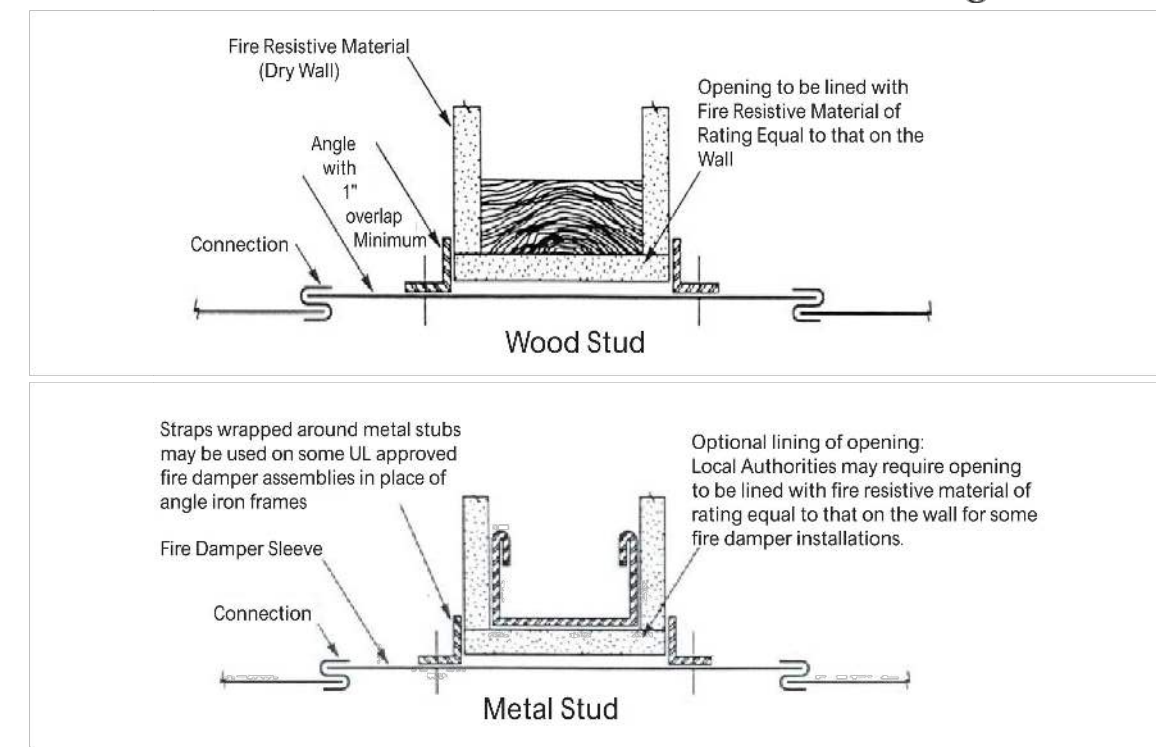

NOTES:

1. Thickness and type of fire resistive material may vary with the jurisdiction. Specific framing requirements of openings should be provided in the architectural and structural drawings that are submitted for building permits.
2. Sleeve shall be 14 gauge when the following duct-sleeve connection is: (a) angle reinforced standing seam, (b) angle reinforced pocket, (c) companion angles, (d) metal fasteners spaced approximately 16" on center. Refer to latest edition of UL 555 for connections with may be used in all systems. Gauges shall conform to SMACNA or ASHRAE Duct Standards.
3. Damper is secured to sleeve by the use of either 1/4" diameter steel nuts and bolts, No. 10 sheetmetal screws, 1/4" diameter steel rivets, or 1/2" long welds...all of which must be 6" on center and a maximum of 1 3/4" from the ends.
4. Fire dampers shall have clearance of 1/8" per linear foot on width and height. The unit (damper and sleeve) may rest on the bottom of the opening and need not be centered.
5. Retaining angles shall be a minimum of 1 1/2" x 1 1/2" x 16 gauge steel. Angles increase in size proportionally, so that there will be a minimum of 1" overlap on the partition, and angles must also cover corners of opening.
6. The sleeve is retained in the partition opening by the use of either 1/4" diameter steel nuts and bolts, No. 10 sheetmetal screws, 1/4" diameter steel pop rivets or 1/2" long welds...all of which must be 6" on center and no more than 2" from the ends. Devices are to attach angle to sleeve only.
7. For Horizontal Mount Dampers, the assembly is formed by using a full length 1/8" by 5" wide mullion plate with 1/4" diameter steel nuts and bolts, spaced 6" on center and a maximum of 3/4" from corners attaching frames to mullion plate.
8. For Vertical Mount Dampers, the damper frames are butted together and fastened with either No. 10 x 3/4" long sheetmetal screws, 1/4" diameter steel rivets, 1/4" diameter steel nuts and bolts, or 1/2" long welds all of which must be spaced at 4" on center and maximum of 3/4" from corners of dampers.
9. Connecting ducts shall be terminated at the sleeve.
10. Maximum duct size of single section vertical only unit is 24" wide x 24" high.

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METAL OR WOOD STUD FRAMING FOR FIRE DAMPERS
IN WALLBOARD PARTITIONS

NOTE: Gypsum Wallboard screwed to all stud and runner flanges. 12" O.C. maximum, surrounding opening

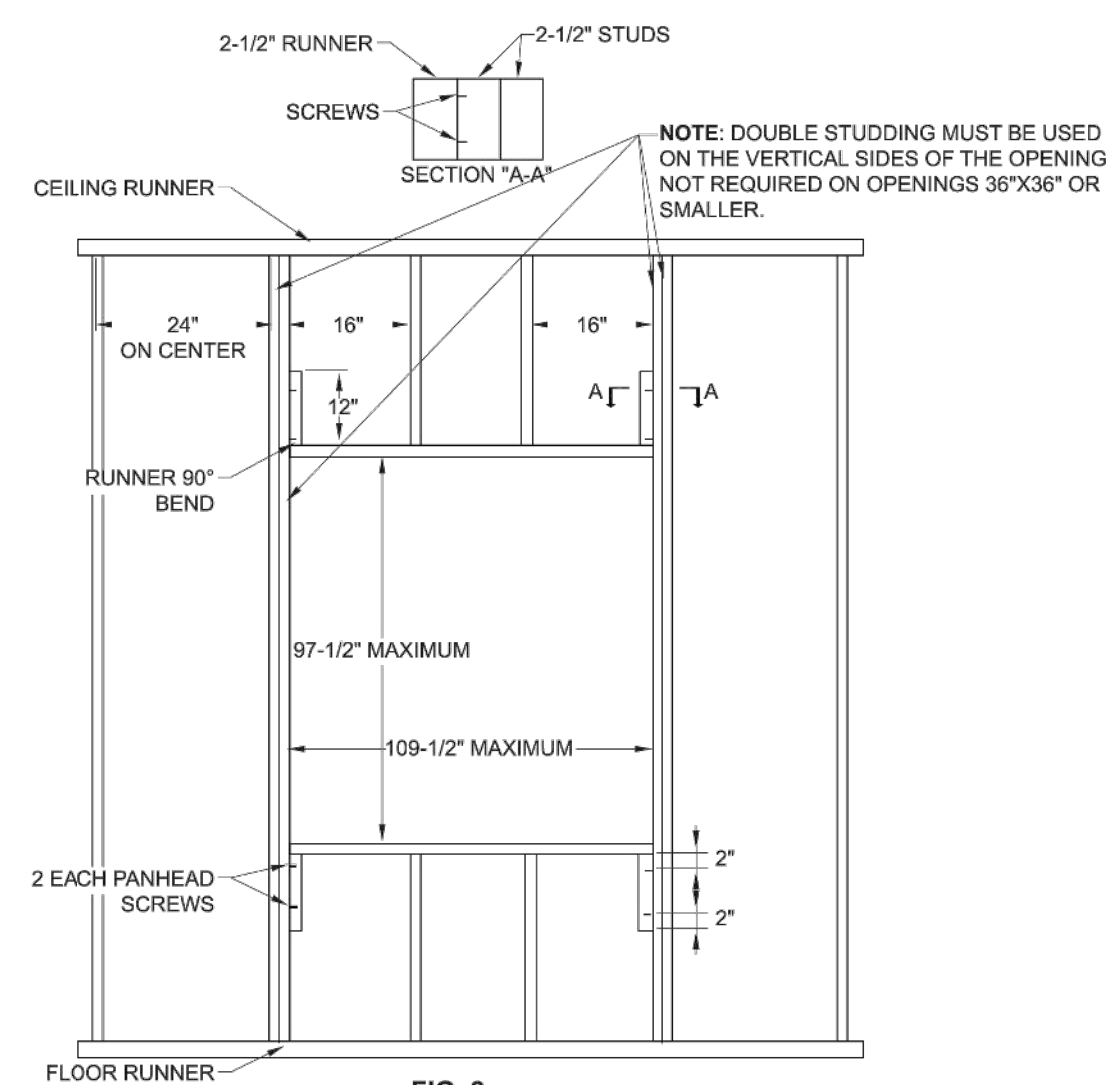
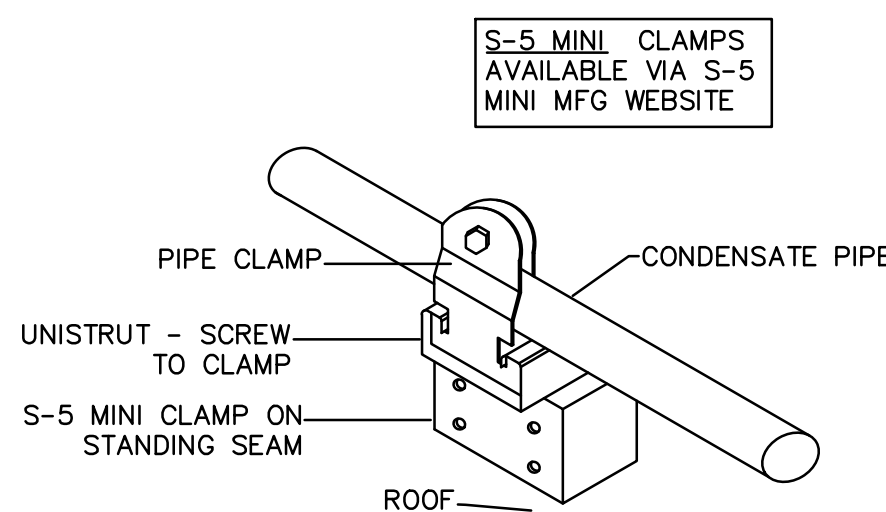
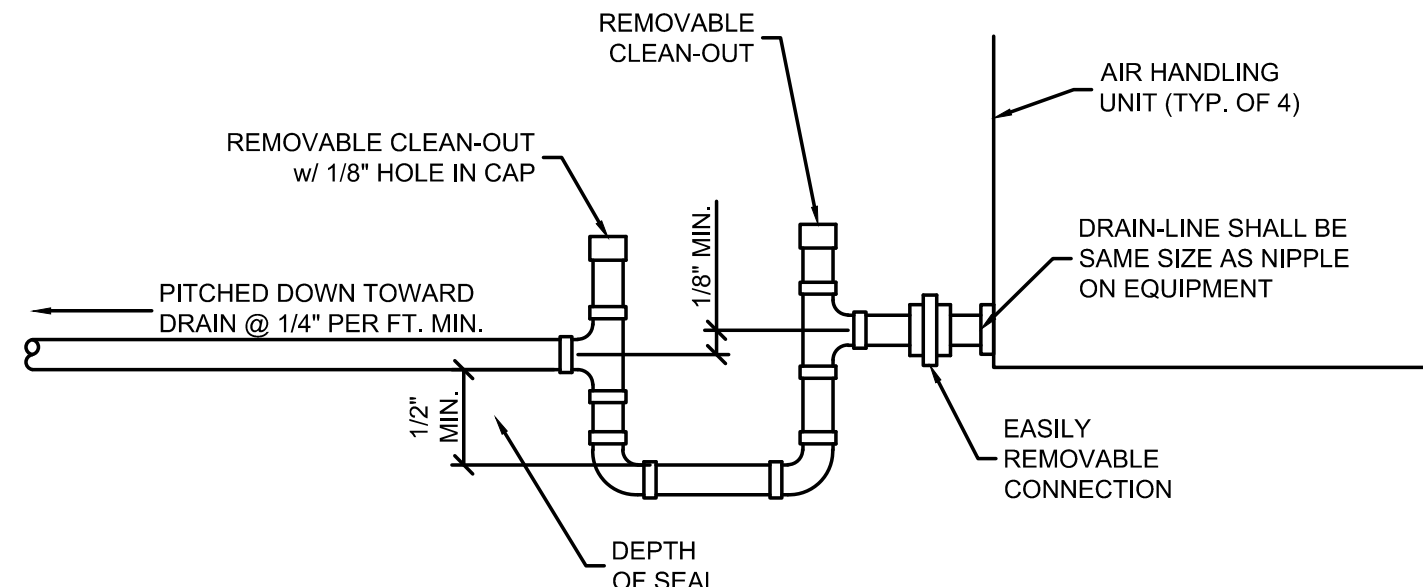
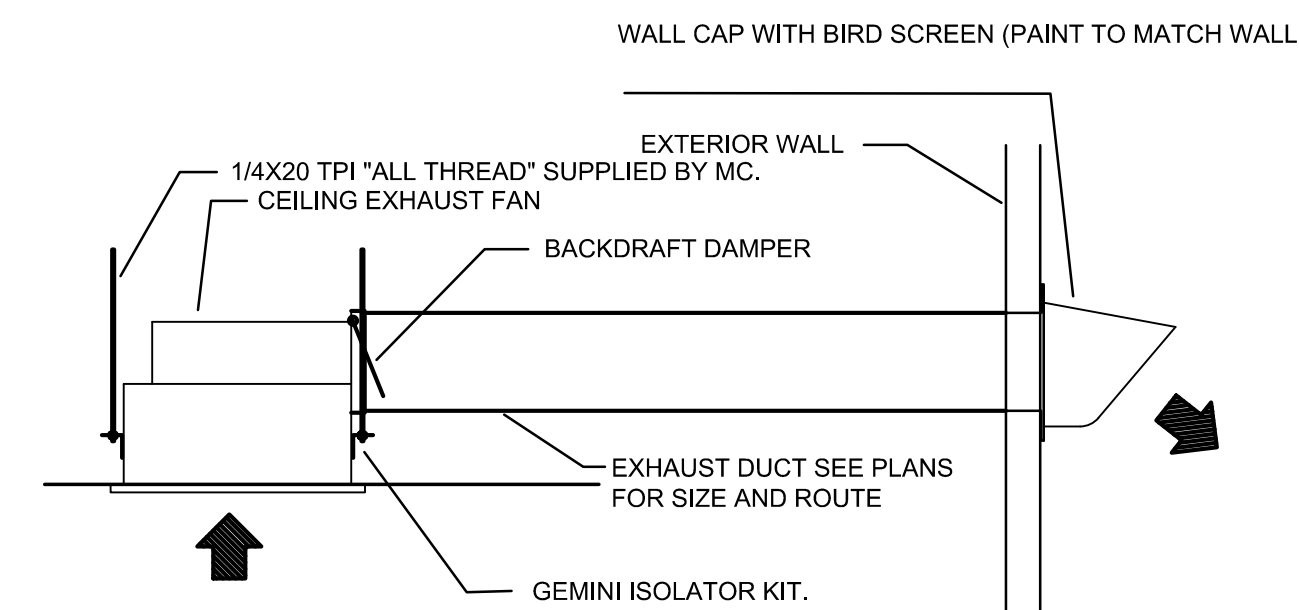


FIG. 3


MODEL	Single Section				Multiple Section			
	Vertical		Horizontal		Vertical		Horizontal	
	Max. Width	Max. Height	Max. Width	Max. Height	Max. Width	Max. Height	Max. Width	Max. Height
MFD	60	60	40	40	120	120	80	40
MFD3	48	48	40	40	-	-	80	40
MDFD	36	36	18	18	-	-	36	36
MDFD3	36	36	18	18	-	-	36	36
MFD3	48	48	48	48	-	-	-	-
MFD3	48	48	48	48	-	-	-	-
MDFD3	36	36	18	18	-	-	36	36
MDFD3	36	36	18	18	-	-	36	36
MFDUS	48	48	-	-	-	-	-	-
MFDUS3	48	48	-	-	-	-	-	-

NOTE: For maximum single section sizes refer to maximum size table. For openings larger than given for single section, multiple dampers are required. For openings larger than given in multiple sections a 12" wide brick or reinforced mullion must be provided between adjacent assemblies.

1
M2
S-5 MINI ROOF CONDENSATE PIPE SUPPORT (METAL BUILDING)
SCALE: N.T.S.3
M2
CONDENSATE TRAP
SCALE: N.T.S.2
M2
CEILING FAN TO WALL CAP
SCALE: N.T.S.


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Reason: I am the signer of this document.
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PROFESSIONAL ENGINEER

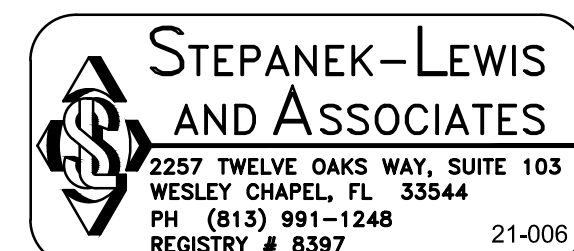

MATTHEW D. LEWIS, P.E. FL LIC#56189

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DOLLAR GENERAL

SR 19 & CR 242
LAKE CITY, FL 32024

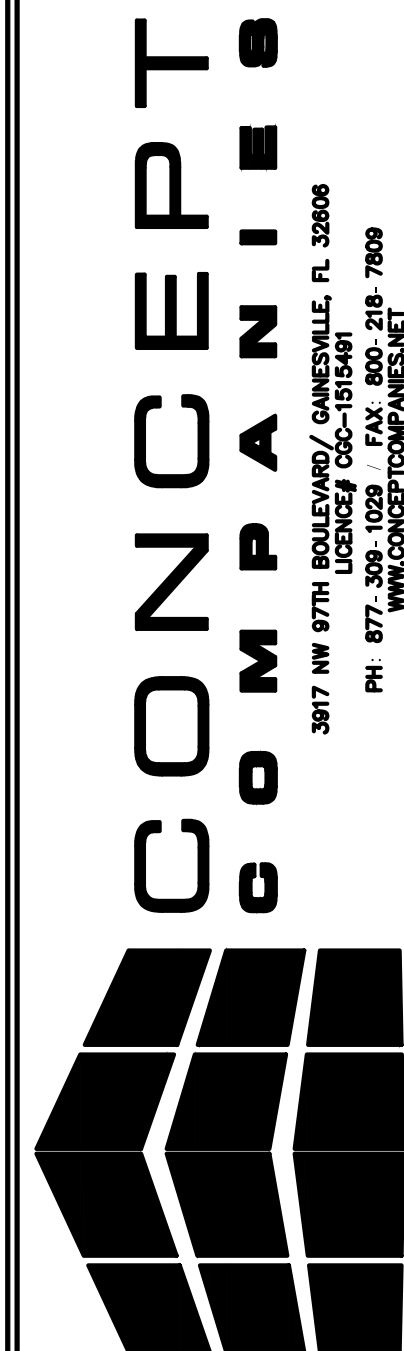STORE #18D
2019 PROTOTYPE - PLAN DGH-D - 9,100 SQ. FT.

DRAWING DATE / DRAWN BY:

03/01/2021 - JEM

REVISION DATE / REVISED BY:

PROJECT NUMBER:


4000.213

DRAWING TITLE:


FIRE DAMPER DETAILS

SHEET NO.


M2

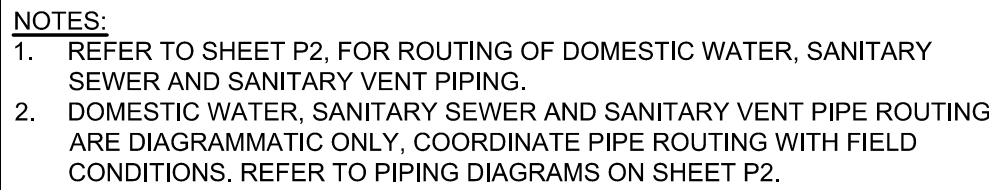


1 PLUMBING PLAN
P1 SCALE: 1/8" = 1'-0" NORTH

<p>JAMES BLYTHE REGISTERED ARCHITECT RA LEED AP BD+C 3324 W. UNIVERSITY AVE PMB#151 GAINESVILLE, FL 32607 AR94452</p>			
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<p>DOLLAR GENERAL®</p>		<p>SR 19 & CR 242 LAKE CITY, FL 32024 STORE #7BD 2019 PROTOTYPE - PLAN DGP-D - 9,100 SQ. FT.</p>	
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<p>PROJECT NUMBER: 4000.213</p>			
<p>DRAWING TITLE: PLUMBING PLAN</p>			
<p>SHEET NO. P1</p>			

1 NOT USED
P2 SCALE: N.T.S.

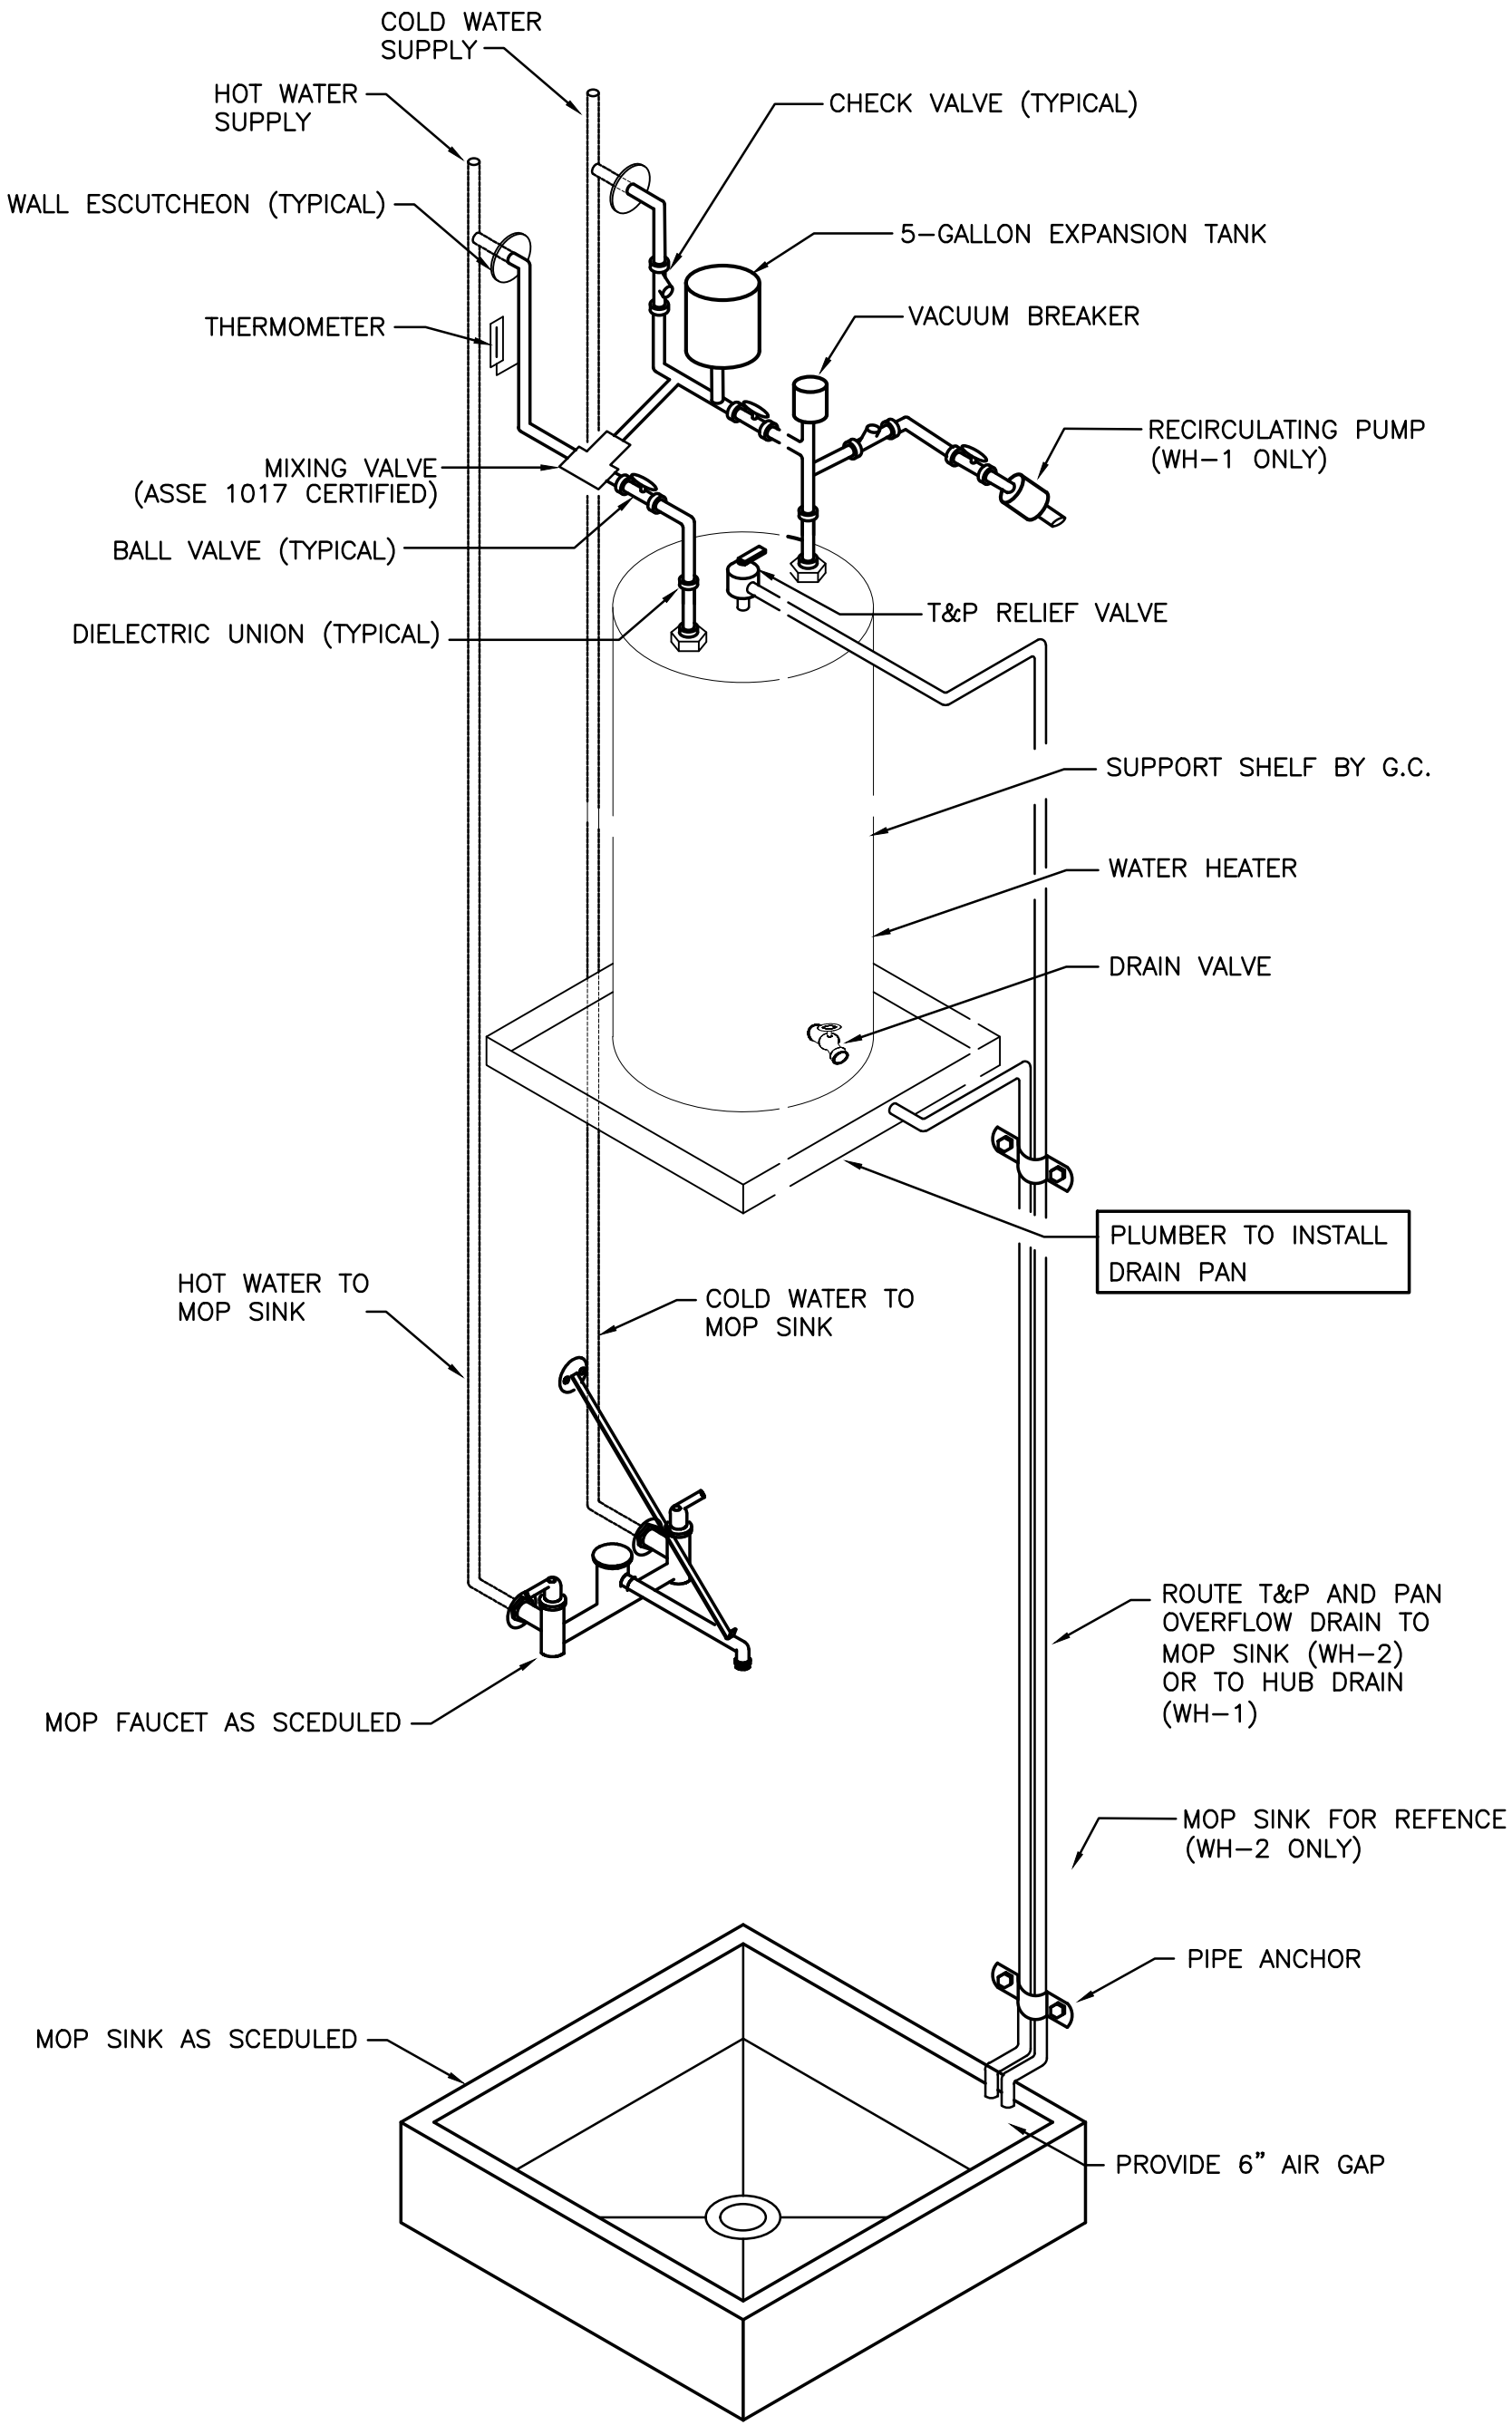


2 WATER HEATER DETAIL
P2 SCALE: N.T.S.

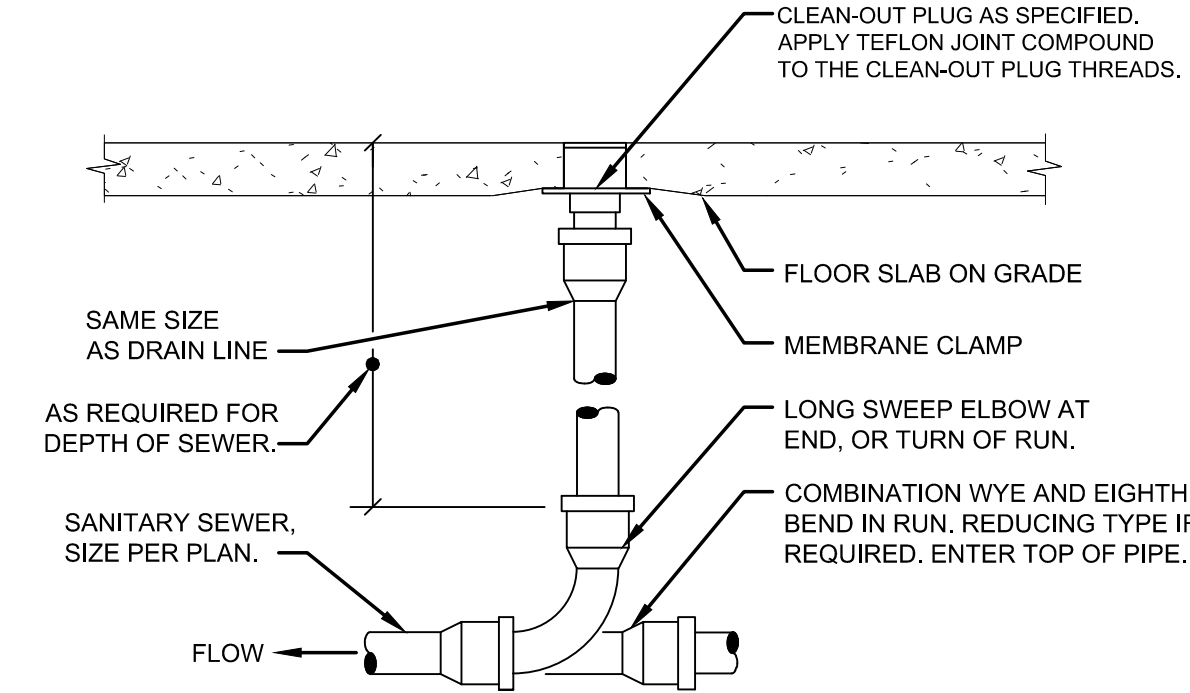


- NOTES:
- REFER TO SCHEDULE FOR ADDITIONAL INFORMATION. LOCATE FLOOR CLEAN-OUT AT END OF RUN, TURNS OF PIPE GREATER THAN 45°, 50' INTERVALS ON STRAIGHT RUNS, AND/OR WHERE SHOWN ON PLANS & RISERS. PROVIDE BACKFILL AS REQUIRED. LOCATE CLEAN-OUT WHERE THERE IS 18" CLEAR AROUND. FOR ACCESSIBILITY, COORDINATE WITH LOCAL CODES AND AUTHORITY HAVING JURISDICTION FOR ANY ADDITIONAL REQUIREMENTS.
 - PROVIDE FLOOR CLEAN-OUT WITH ADJUSTABLE COVER. CLEAN-OUT COVER SHALL BE SUITABLE FOR RESPECTIVE FLOOR COVERING (RECESSED FOR TILE, SCORiated FOR UNFINISHED FLOORS, ETC.). CLEAN THE TOP OF EXPOSED FLOOR CLEAN-OUT AFTER INSTALLATION.

3 FLOOR CLEANOUT
P2 SCALE: N.T.S.

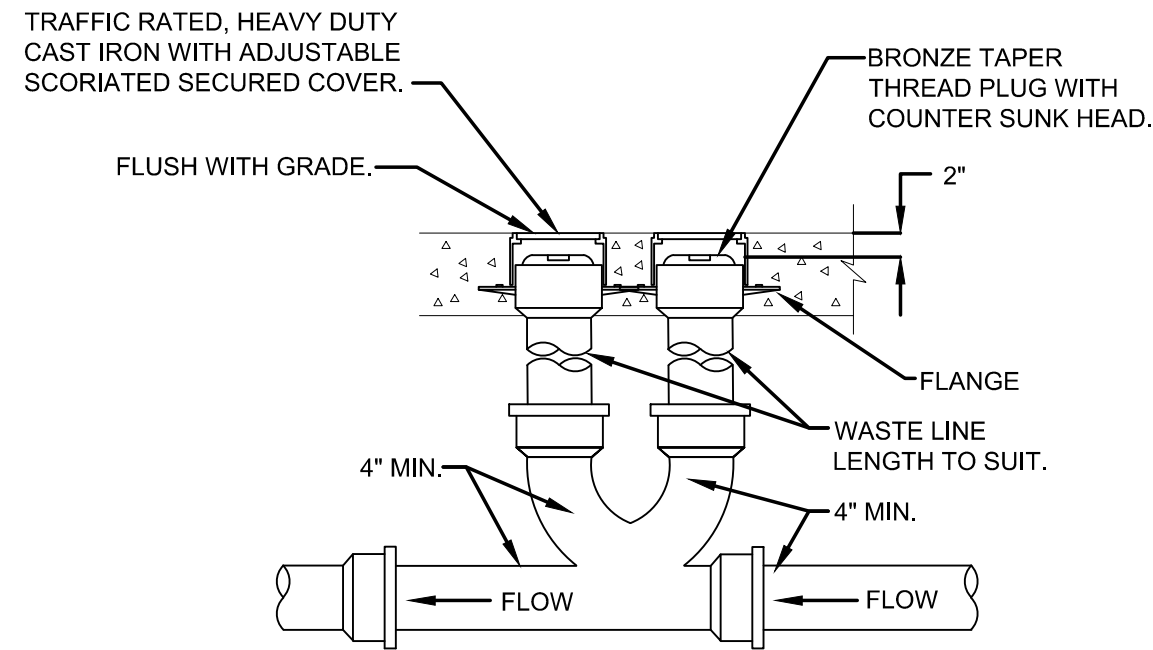


- NOTES:
- CLEAN-OUT SHALL BE TRAFFIC RATED.
 - ECO-1 SHALL BE INSTALLED WITHIN 5'-0" OF THE BUILDING EXTERIOR.

4 2-WAY YARD CLEANOUT
P2 SCALE: N.T.S.

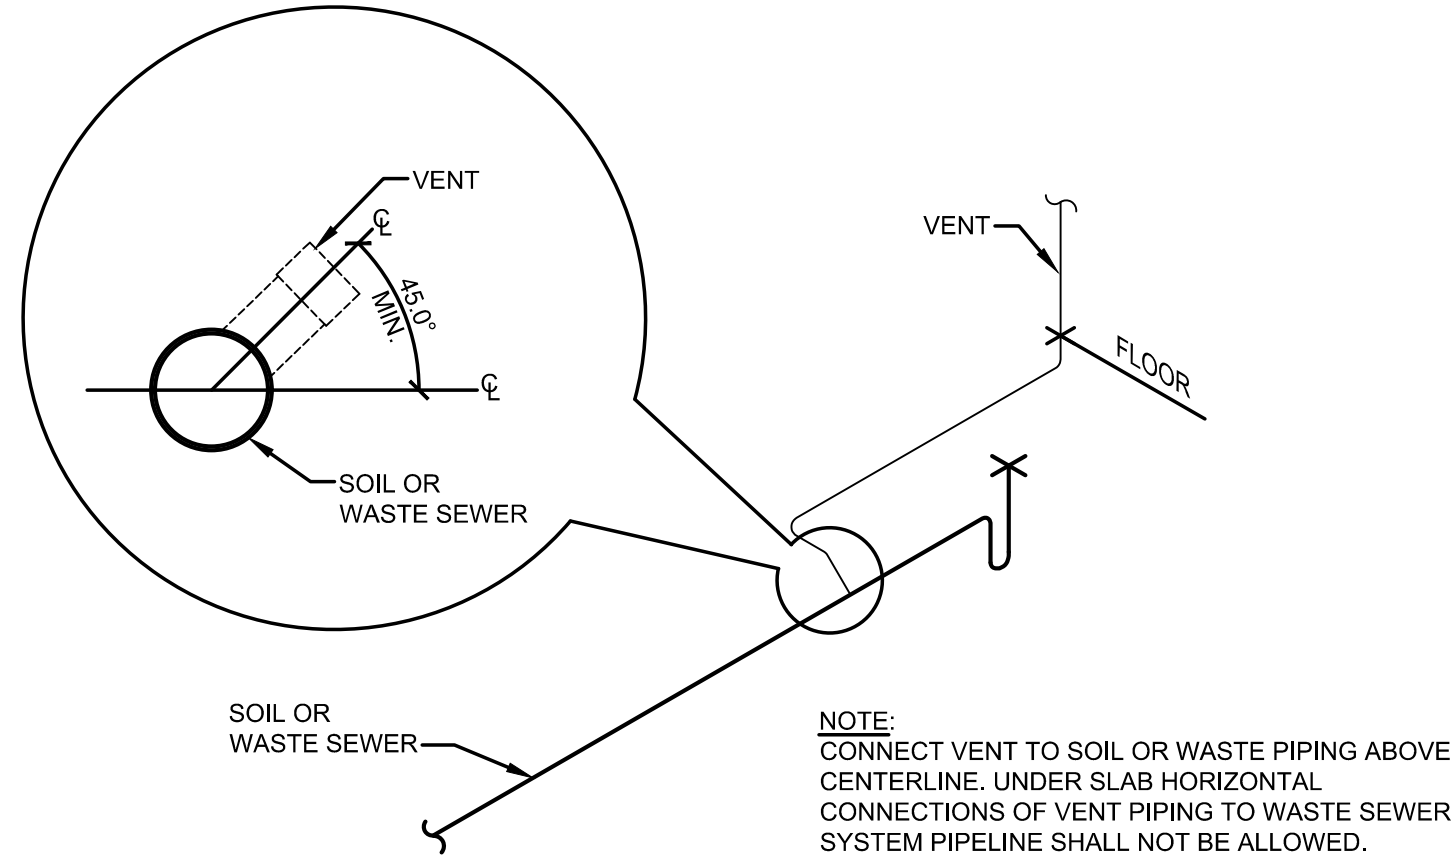


5 VENT PIPE INSTALLATION
P2 SCALE: N.T.S.

MATERIALS	
1. DRAIN, WASTE AND VENT	
A. SCHEDULE 40 AND 80 PVC OR ABS PIPING WITH DWV PATTERN FITTINGS TO BE USED UNLESS OTHERWISE REQUIRED BY LOCAL CODE.	
2. HOT AND COLD WATER	
A. ABOVE GRADE:	
a) TYPE "L" COPPER TUBING, HARD TEMPER, COLD DRAWN WITH WROUGHT COPPER LEAD FREE SWEAT FITTINGS. CONNECTIONS TO FIXTURES AND EQUIPMENT SHALL BE MADE WITH 85% RED BRASS IPS SIZE PIPE OR COMPRESSION ANGLE STOPS. PROVIDE DIELECTRIC UNIONS WHERE CONNECTING PIPING OF DISSIMILAR MATERIALS. NOTE: INSULATE ALL HOT WATER PIPING WITH 1" THICK ARMAFLEX PIPE KITS (FLEXIBLE UNICELLULAR).	
B. BELOW GRADE:	
b) TYPE "K" COPPER TUBING, HARD OR SOFT TEMPER, WITH WROUGHT COPPER LEAD FREE SWEAT FITTINGS. NOTE: NO FITTINGS SHALL BE PERMITTED BELOW GRADE INSIDE BUILDING.	

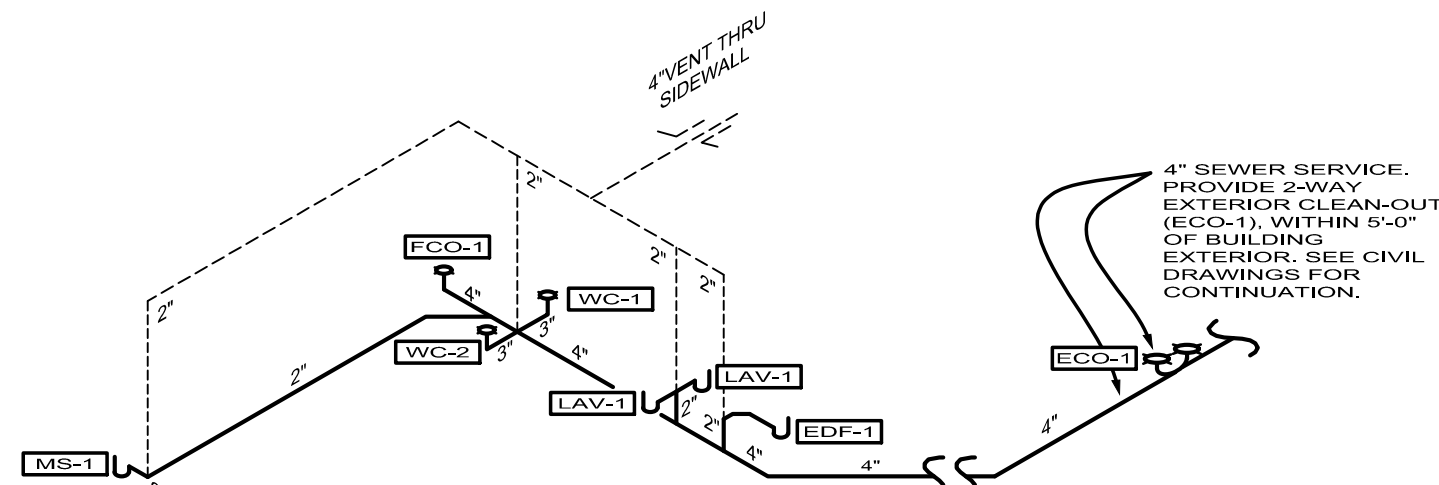

- SANITARY SEWER NOTES:
- EW-1 TO DRAIN INTO MOP SINK (MS-1)
 - REFER TO SHEET P1 FOR ADDITIONAL INFORMATION.

7 SANITARY & VENT ISO
P2 SCALE: N.T.S. 13-DFU

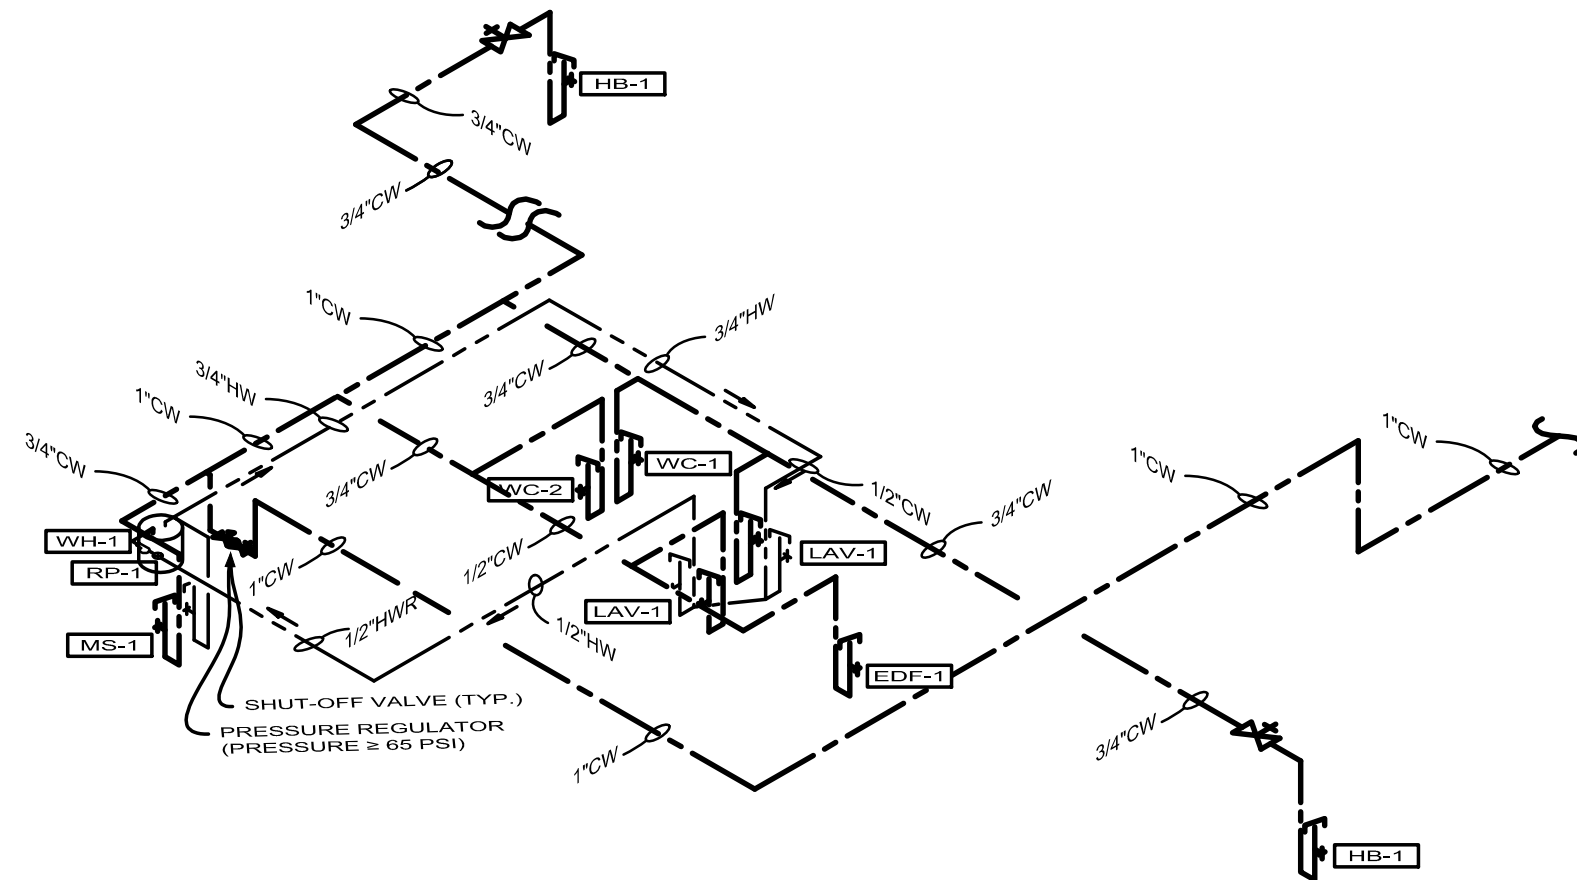

- DOMESTIC WATER NOTES:
- REFER TO CIVIL DRAWINGS FOR EXACT LOCATION OF CONNECTION POINT TO EXISTING DOMESTIC WATER PIPING.
 - PRESSURE REGULATOR TO BE ≥ 65 PSI.

8 DOMESTIC WATER ISO
P2 SCALE: N.T.S. 16-WSFU

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