DATE 03/13/2008 Columbia Coun This Permit Must Be Prominently						PERMIT 000026842
APPLICANT	WILLIAM	I HARPER		PHONE	623-3873	
ADDRESS	119	SW HOBBY PLACE		LAKE CITY		FL 32024
OWNER	WANDA	& EARL GREEN		PHONE	697-4652	_
ADDRESS	4685	NE GUMSWAMP R	D	LAKE CITY		FL 32055
CONTRACTO	R WIL	LIAM HARPER		PHONE	623-3837	
LOCATION OF	PROPER'	TY 90 EAST, I	MCCLOSKY RD, R	GUM SWAMP RD, G	O .5 MILES	
		ON THE L	EFT			
TYPE DEVELO	DPMENT	MODULAR, UTIL	JTY E	STIMATED COST OF	CONSTRUCTIO	N 0.00
HEATED FLOO	OR AREA	102	TOTAL AR	EA	HEIGHT	STORIES
FOUNDATION	I	WALL	s	ROOF PITCH	-	FLOOR
LAND USE & 2	ZONING	A-2			AX. HEIGHT	35
			TONIT 20 00	•		***
Minimum Set B	5.		-) REAR	25.00	SIDE 25,00
NO. EX.D.U.	1	FLOOD ZONE	XPS	DEVELOPMENT PE	RMIT NO.	
PARCEL ID	13-3S-17-	04947-000	SUBDIVISIO	ON		
LOT	BLOCK	PHASE _	UNIT	то	TAL ACRES _	1.00
	ection REPLACI	08-0227-E Septic Tank Number	NG, FLOOR ONE FO	ing checked by A	Applicant/Own JH pproved for Issu D,	<u>N</u>
REPLACING D	WELLING	EXEPT FROM IMPAC	CT FEES		Check # or	Cash NO CHARGE
Temporary Power	er	FOR BU		NG DEPARTMEN		(footer/Slab)
		date/app. by	-	date/app. by		date/app. by
Under slab rough	h-in plumb				Sheathi	ng/Nailing
Framing		date/app		date/app. by		date/app. by
	date/app		Rough-in plumbing a	above slab and below wo	ood floor	data/ann hu
Electrical rough			Heat & Air Duct			date/app. by
		date/app. by	- Treat & All Buck	date/app. by	Peri. beam (Li	date/app. by
Permanent power			C.O. Final		Culvert _	
M/II 6'- J 1		e/app. by		date/app. by		date/app. by
M/H ue downs, b	olocking, el	ectricity and plumbing	date/ap	p. by	Pool	
Reconnection			Pump pole	Utility I		date/app. by
M/H Pole	dapp. by	ate/app. by Trave	el Trailer	e/app. by	date/app Re-roof	
date	app. by			date/app. by		date/app. by

FLOOD DEVELOPMENT FEE \$ _____ FLOOD ZONE FEE \$ _____ CULVERT FEE \$ _____ TOTAL FEE _____ 0.00

INSPECTORS OFFICE _____ CLERKS OFFICE

0.00

FIRE FEE \$ 0.00

SURCHARGE FEE \$

WASTE FEE \$

0.00

CERTIFICATION FEE \$

ZONING CERT. FEE \$

BUILDING PERMIT FEE \$

0.00

MISC. FEES \$

0.00

NOTICE: IN ADDITION TO THE REQUIREMENTS OF THIS PERMIT, THERE MAY BE ADDITIONAL RESTRICTIONS APPLICABLE TO THIS PROPERTY THAT MAY BE FOUND IN THE PUBLIC RECORDS OF THIS COUNTY. AND THERE MAY BE ADDITIONAL PERMITS REQUIRED FROM OTHER GOVERNMENTAL ENTITIES SUCH AS WATER MANAGEMENT DISTRICTS, STATE AGENCIES, OR FEDERAL AGENCIES.

"WARNING TO OWNER: YOUR FAILURE TO RECORD A NOTICE OF COMMENCEMENT MAY RESULT IN YOUR PAYING TWICE FOR IMPROVEMENTS TO YOUR PROPERTY. IF YOU INTEND TO OBTAIN FINANCING, CONSULT WITH YOUR LENDER OR AN ATTORNEY BEFORE RECORDING YOUR NOTICE OF COMMENCEMENT."

EVERY PERMIT ISSUED SHALL BECOME INVALID UNLESS THE WORK AUTHORIZED BY SUCH PERMIT IS COMMENCED WITHIN 180 DAYS AFTER ITS ISSUANCE, OR IF THE WORK AUTHORIZED BY SUCH PERMIT IS SUSPENDED OR ABANDONED FOR A PERIOD OF 180 DAYS AFTER THE TIME THE WORK IS COMMENCED. A VALID PERMIT RECIEVES AN APPROVED INSPECTION EVERY 180 DAYS. WORK SHALL BE CONSIDERED TO BE IN ACTIVE PROGESS WHEN THE PERMIT HAS RECIEVED AN APPROVED INSPECTION WITHIN 180 DAYS.

Columbia County Building Permit Application

For Office Use Only Application # 0803-20 Date Received 3/10/08 By CH Permit # 26842
Zoning Official BLK Date 13.03.08 Flood Zone X 5010/FEMA Map # N/A Zoning A-2
Land Use A-2 Elevation N/A MFE River N/A Plans Examiner OK 7111 Date 3-11-08
Comments Burn Out, Section 2.3.1 legal Non-conformy Let of Record
NOC EH Deed or PA Site Plan State Road Info Parent Parcel #
□ Dev Permit # □ In Floodway □ Letter of Authorization from Contractor
□ Unincorporated area □ Incorporated area □ Town of Fort White □ Town of Fort White Compliance letter
Septic Permit No. 08-0227E Fax 386-752-2571
Name Authorized Person Signing Permit WILLIAM L. HARPER Phone 386-623-3873
Address 119 SW HOBBY PL. LAKE CITY FL. 32024
Owners Name WANDR J. CREEN FEarl Green Phone 697-4652
911 Address 4685 NE GUMSWAMPRD, LAKE CITY 32055
Contractors Name WILLIAM L. HARPER Phone 386-623-3873
Address 119 SW HOBBY PL. LAKE CIT
Fee Simple Owner Name & Address vla
Bonding Co. Name & Address
Architect/Engineer Name & Address CHRTIS KEED 9268 CR TID MUE OAK, FLI 32060
Mortgage Lenders Name & Address FIRST FROHRAL 4705 W. US HUY 90 LAKE CITY FL. 32056
Circle the correct power company —FL Power & Light — Clay Elec. — Suwannee Valley Elec. — Progress Energy
13-35-17
Property ID Number RO 4947 - 000 Estimated Cost of Construction 500,000,00
Subdivision NameLot Block Unit Phase
Driving Directions GO HWY 90 FAST TO MCCLOSKY RD (OLD STILLIRD.) TURN LEFT,
GO MGOSKY TO GUM SWAMP AD. TURN RIGHT, PROPERTY APPROX. 5 MILE
ON LEFT Number of Existing Dwellings on Property O
Construction of MODULAR HOME Total Acreage 100 ± Lot Size / ac
Do you need a - <u>Culvert Permit</u> or <u>Culvert Waiver</u> or <u>Have an Existing Drive</u>) Total Building Height(6 1
Actual Distance of Structure from Property Lines - Front 52' Side 95' Side 65 Rear 115
Number of Stories Heated Floor Area 1611 59ft Total Floor Area 1813 Roof Pitch 5/12
Application is hereby made to obtain a permit to do work and installations as indicated. I certify that no work or installation has commenced prior to the issuance of a permit and that all work be performed to meet the standards

of all laws regulating construction in this jurisdiction.

WARNING TO OWNER: YOUR FAILURE TO RECORD A NOTICE OF COMMENCMENT MAY RESULT IN YOU PAYING TWICE FOR IMPROVEMENTS TO YOUR PROPERTY. A NOTICE OF COMMENCEMENT MUST BE RECORDED AND POSTED ON THE JOB SITE BEFORE THE FIRST INSPECTION. IF YOU INTEND TO OBTAIN FINANCING, CONSULT WITH YOUR LENDER OR ATTORNEY BEFORE RECORDING YOUR NOTICE OF COMMENCEMENT.

FLORIDA'S CONSTRUCTION LIEN LAW: Protect Yourself and Your Investment

According to Florida Law, those who work on your property or provide materials, and are not paid-in-full, have a right to enforce their claim for payment against your property. This claim is known as a construction lien. If your contractor fails to pay subcontractors or material suppliers or neglects to make other legally required payments, the people who are owed money may look to your property for payment, even if you have paid your contractor in full. This means if a lien is filed against your property, it could be sold against your will to pay for labor, materials or other services which your contractor may have failed to pay.

NOTICE OF RESPONSIBILITY TO BUILDING PERMITEE:

YOU ARE HEREBY NOTIFIED as the recipient of a building permit from Columbia County, Florida, you will be held responsible to the County for any damage to sidewalks and/or road curbs and gutters, concrete features and structures, together with damage to drainage facilities, removal of sod, major changes to lot grades that result in ponding of water, or other damage to roadway and other public infrastructure facilities caused by you or your contractor, subcontractors, agents or representatives in the construction and/or improvement of the building and lot for which this permit is issued. No certificate of occupancy will be issued until all corrective work to these public infrastructures and facilities has been corrected.

OWNERS CERTIFICATION: I hereby certify that all the foregoing information is accurate and all work will be

done in compliance with all applicable laws and regulating construction and zoning. I further understand the above written responsibilities in Columbia County for obtaining this Building Permit.

CONTRACTORS AFFIDAVIT: By my signature I understand and agree that I have informed and provided this written statement to the owner of all the above written responsibilities in Columbia County for obtaining this Building Permit.

Contractor's License Number RESSURITY Columbia County Competency Card Number Contractor and subscribed before me this 7 day of March 2008

Personally known or Produced Identification

SEAL:

WILLIAMP, CREWS

WILLIAMP, CREWS

MY COMMISSION # DD 703246 EXPIRES: August 8, 2011 Bonded Thru Budget Notary Services



STATE OF FLORIDA DEPARTMENT OF HEALTH

APPLICATION FOR ONSITE SEWAGE DISPOSAL SYSTEM CONSTRUCTION PERMIT

	Permit Application Num	nber 08-00016
	PART II - SITE PLAN	
Scale: Each block represen	nts 5 feet and 1 inch = 50 feet.	
	Gum Swamp Rd	+++++++++
		<u> </u>
		<u> </u>
		
		4X 111111
		+++++++++++++++++++++++++++++++++++++
	- - - - - - - - - - - - - -	
Notes:		
		, , , , , , , , , , , , , , , , , , , ,
AL AL		¥
	C 0 1 -	
Site Plan submitted by:	Carl New P	owner
Plan Approved		Date 3/11/08
_	Not Approved	Date
By_Mn	0 h Columbia	County Health Departmer
		sing i residi beparaner

ALL CHANGES MUST BE APPROVED BY THE COUNTY HEALTH DEPARTMENT

Prepared by & Return to: /Matthew D. Rocco Sierra Title, LLC 619 SW Baya Drive, Suite 102 Lake City, Florida 32025

File Number: 08-0061

General Warranty Deed

Made this February 25, 2008 A.D. By Earl Green, Jr. and Wanda Jean Green, his wife, whose post office address is: 4685 NE Gum Swamp Rd., Lake City, FL 32055, hereinafter called the grantor, to Wanda J. Green, a married woman, whose post office address is: 4685 NE Gum Swamp Rd., Lake City, Florida 32055, hereinafter called the grantee:

(Whenever used herein the term "grantor" and "grantee" include all the parties to this instrument and the heirs, legal representatives and assigns of individuals, and the successors and assigns of corporations)

Witnesseth, that the grantor, for and in consideration of the sum of Ten Dollars, (\$10.00) and other valuable considerations, receipt whereof is hereby acknowledged, hereby grants, bargains, sells, aliens, remises, releases, conveys and confirms unto the grantee, all that certain land situate in Columbia County, Florida, viz:

See Attached Schedule "A"

Parcel ID Number: R04947-000

Signed, sealed and delivered in our presence:

Together with all the tenements, hereditaments and appurtenances thereto belonging or in anywise appertaining.

To Have and to Hold, the same in fee simple forever.

And the grantor hereby covenants with said grantee that the grantor is lawfully seized of said land in fee simple; that the grantor has good right and lawful authority to sell and convey said land; that the grantor hereby fully warrants the title to said land and will defend the same against the lawful claims of all persons whomsoever; and that said land is free of all encumbrances except taxes accruing subsequent to December 31, 2007.

In Witness Whereof, the said grantor has signed and sealed these presents the day and year first above written.

	Eapl Green, Jr. (Seal)
Witness Printed Name Matthew D. Rocco	Address:
Melisda Weaver	Wanda Jean Green (Seal)
Witness Printed Name	Address:
State of Florida County of Columbia	a a
The foregoing instrument was acknowledged before me this wife, who is/are personally known to me or who has produced the control of the contr	s 25th day of February, 2008, by Earl Green, Jr. and Wanda Jean Green, his cod <u>Employee</u> ID <u>Card</u> who photo + FLD as identification.
	Notary Public Print Name:
Notary Public State of Flo Matthew Rocco My Commission D05783 Expires 09/17/2010	Expires:

Prepared by & Return to: Matthew D. Rocco Sierra Title, LLC 619 SW Baya Drive, Suite 102 Lake City, Florida 32025

File Number; 08-0061

"Schedule A"

Section 13, Township 3 South, Range 17 East: Commence at the Southwest corner of the NE 1/4 of the NW 1/4 of said section, and run thence North 87 degrees 18 minutes East along the South line of the NE 1/4 of the NW 1/4, 161.84 feet to the Easterly line of State Road No. S-250; thence North 46 degrees, 13 minutes East, along the Easterly line of State Road S-250, 1020.72 feet to a point of curve; thence North 43 degrees, 47 minutes West, on a perpendicular, 100.00 feet to the Westerly line of State Road S-250; thence South 46 degrees 13 minutes West, 39.65 feet along the Westerly line of State Road S-250, for a Point of Beginning; thence North 43 degrees 47 minutes West, 210.00 feet; thence South 48 degrees 00 minutes West, 212.50 feet; thence South 43 degrees 47 minutes East, 210.00 feet; thence North 46 degrees 13 minutes East, along the Westerly line of State Road S-250, 212.50 feet to the Point of Beginning.

Columbia County Property Appraiser

DB Last Updated: 1/15/2008

Parcel: 13-3S-17-04947-000 HX

2008 Proposed Values

Tax Record

Property Card

Interactive GIS Map

Search Result: 1 of 3 Next >>

Print

Owner & Property Info

Owner's Name	GREEN EARL	JR & WANDA JEAN				
Site Address	GUM SWAMP	GUM SWAMP				
Mailing Address	4685 NE GUM SWAMP RD LAKE CITY, FL 32055					
Use Desc. (code)	MOBILE HOM (000200)					
Neighborhood	1317.00	Tax District	3			
UD Codes	MKTA04	Market Area	04			
Total Land Area	1.000 ACRES					
Description	COMM SW COR OF NE1/4 OF NW1/4, RUN E 161.84 FT TO E R/W CR-250, RUN NE ALON G R/W 1020.72 FT, NW 100 FT TO W R/W, SW 39.65 FT FOR POB, RUN NW 210 FT, SW 212.5 FT, SE FT, NE 212.5 FT TO POB, ORB 394-166.					

GIS Aerial



Property & Assessment Values

Mkt Land Value	cnt: (2)	\$16,000.00
Ag Land Value	cnt: (0)	\$0.00
Building Value	cnt: (1)	\$47,360.00
XFOB Value	cnt: (2)	\$500.00
Total Appraised Value		\$63,860.00

756-1175, 867-1332,

731-909, DC 753-1740, 754-1602, 756-1175,

Just Value		\$63,860.00
Class Value		\$0.00
Assessed Value		\$50,516.00
Exempt Value	(code: HX)	\$25,000.00
Total Taxable Value		\$25,516.00

Sales History

Sale Date	Book/Page	Inst. Type	Sale VImp	Sale Qual	Sale RCode	Sale Price
10/14/1998	867/1332	WD	I	U	01	\$0.00
12/6/1991	754/1602	WD	V	U	12	\$4,500.00
2/1/1986	585/232	WD	V	U	01	\$4,300.00

Building Characteristics

Bldg Item	Bldg Desc	Year Blt	Ext. Walls	Heated S.F.	Actual S.F.	Bldg Value
1	SFR MANUF (000200)	1999	Vinyl Side (31)	1404	1644	\$47,360.00
	Note: All S.F. calculation	ns are base	d on exterior buil	dina dimension	ıs	

Extra Features & Out Buildings

Code	Desc	Year Blt	Value	Units	Dims	Condition (% Good)
0296	SHED METAL	1993	\$400.00	1.000	0 x 0 x 0	(.00)

0040	BARN,POLE	2005	\$100.00		0 x 0 x 0	(.00))
Land Break	down						
Lnd Code	Desc		Units	Ad	ljustments	Eff Rate	Lnd Value
000200	MBL HM (MKT)	1	1.000 AC		.00/1.00/1.00	\$14,000.00	\$14,000.00
009945	WELL/SEPT (MKT)	1.000	UT - (.000AC)	1.00/1	.00/1.00/1.00	\$2,000.00	\$2,000.00
Columbia Co	unty Property Apprai	ser				DB Last Updat	ed: 1/15/2008
			1 0	of 3	Next >>		

Disclaimer

This information was derived from data which was compiled by the Columbia County Property Appraiser's Office solely for the government purpose of property assessment. The information shown is a **work in progress** and should not be relied upon by anyone as a determination of the ownership of property or market value. No warranties, expressed or implied, are provided for the accuracy of the data herein, it's use, or it's interpretation. Although it is periodically updated, this information may not reflect the data currently on file in the Property Appraiser's Office. The assessed values are **NOT CERTIFIED** values and therefore are subject to change before finalized for ad-valorem assessment purposes.

Notice:

Under Florida Law, e-mail addresses are public record. If you do not want your e-mail address released in response to a public-records request, do not send electronic mail to this entity. Instead contact this office by phone or in writing.

Scroll to Top

Site powered by: Grizzly Logic, Inc.© Copyright 2001

Web Site Copyright @ 2000 Columbia County. All rights reserved.

THIS INSTRUMEN
FIRST FEDERAL S
4706 WEST U.S. H
P.O. BOX 2029
LAKE CITY, FLOR

THIS INSTRUMENT WAS PREPARED BY:
FIRST FEDERAL SAVINGS BANK OF FLORIDA
4706 WEST U.S. HIGHWAY 90
P.O. BOX 2029
LAKE CITY, FLORIDA 32056

PERMIT NO._____

Inst:200812004266 Date:3/3/2008 Time:10:33 AM _DC,P.DeWitt Cason,Columbia County Page 1 of 2

	NOTICE OF COMMENCEMENT
STAT	TY OF Columbia
in acc	e undersigned hereby gives notice that improvement will be made to certain real property, and ordance with Chapter 713, Florida Statutes, the following information is provided in this Notice mencement.
1.	Description of property: See Exhibit A
2.	General description of improvement: Construction of Dwelling
3.	Owner information: a. Name and address: Wanda J. Green, 386 SE Llewellyn Ale., Lake City, FC 32025
	b. Interest in property: <u>Fee Simple</u>
	c. Name and address of fee simple title holder (if other than Owner): NONE
4.	Contractor (name and address): Royaus Mohile Homes
5.	Surety: a. Name and address:X A
	b. Amount of bond:
6.	Lender: FIRST FEDERAL SAVINGS BANK OF FLORIDA 4705 WEST U.S. HIGHWAY 90 P. O. BOX 2029 LAKE CITY, FLORIDA 32056
7.	Persons within the State of Florida designated by Owner upon whom notices or other document may be served as provided by Section 713.13 (1) (a) 7., Florida Statutes: NONE
8.	In addition to himself, Owner designates <u>PAULA HACKER of FIRST FEDERAL SAVINGS</u> <u>BANK OF FLORIDA</u> , 4705 West U.S. <u>Highway 90 / P. O. Box 2029</u> , <u>Lake City</u> , <u>Florida 32056</u> to receive a copy of the Lienor's Notice as provided in Section 713.13 (1) (b), Florida Statutes.
9.	Expiration date of notice of commencement (the expiration date is 1 year from the date of recording unless a different date is specified). Borrower Name
	Earl Livery Some
200%	e foregoing instrument was acknowledged before me this 25th day of February, by Wanda T. Green, who is personally known to me or who
has pr	oduced driver's license for identification. Notary Public State of Florida
	My Commission DD578349 Expires 09/17/2010 Notary Public My Commission Expires:

File No. 08-0061/Green

Exhibit A Legal Description

Section 13, Township 3 South, Range 17 East: Commence at the Southwest corner of the NE 1/4 of the NW 1/4 of said section, and run thence North 87 degrees 18 minutes East along the South line of the NE 1/4 of the NW 1/4, 161.84 feet to the Easterly line of State Road No. S-250; thence North 46 degrees, 13 minutes East, along the Easterly line of State Road S-250, 1020.72 feet to a point of curve; thence North 43 degrees, 47 minutes West, on a perpendicular, 100.00 feet to the Westerly line of State Road S-250; thence South 46 degrees 13 minutes West, 39.65 feet along the Westerly line of State Road S-250, for a Point of Beginning; thence North 43 degrees 47 minutes West, 210.00 feet; thence South 48 degrees 00 minutes West, 212.50 feet; thence South 43 degrees 47 minutes East, 210.00 feet; thence North 46 degrees 13 minutes East, along the Westerly line of State Road S-250, 212.50 feet to the Point of Beginning.

OWNER/AGENT:

DATE:

FLORIDA ENERGY EFFICIENCY CODE FOR BUILDING CONSTRUCTION

Florida Department of Community Affairs
Residential Whole Building Performance Method A

Project Name: 1447-5465F Address: City, State: , FL Owner: HORTON HOMES	Builder: HORTON Permitting Office: 6/wbia Ce Permit Number: 26842 Jurisdiction Number:
Climate Zone: North	221000
1. New construction or existing 2. Single family or multi-family 3. Number of units, if multi-family 4. Number of Bedrooms 5. Is this a worst case? 6. Conditioned floor area (ft²) 7. Glass type¹ and area: (Label reqd. by 13-104.4.5 if not default) a. U-factor:	12. Cooling systems a. Central Unit b. N/A c. N/A 13. Heating systems a. Electric Heat Pump b. N/A c. N/A 14. Hot water systems a. Electric Resistance b. N/A c. Conservation credits (HR-Heat recovery, Solar DHP-Dedicated heat pump) 15. HVAC credits (CF-Ceiling fan, CV-Cross ventilation, HF-Whole house fan,
a. Sup: Unc. Ret: Unc. AH(Sealed):OutdoorsSup. R=6.0, 225.0 ft b. N/A	PT-Programmable Thermostat, MZ-C-Multizone cooling, MZ-H-Multizone heating)
Glass/Floor Area: () 15	points: 20550 points: 22908 PASS
I hereby certify that the plans and specifications covered by this calculation are in compliance with the Florida Energy Code. PREPARED BY: DATE: I hereby certify that the building as designed, is in compliance with the Florida Energy Code.	Review of the plans and specifications covered by this calculation indicates compliance with the Florida Energy Code. Before construction is completed this building will be inspected for compliance with Section 553.908 Florida Statutes.

1 Predominant glass type. For actual glass type and areas, see Summer & Winter Glass output on pages 2&4.

SEE MANUFACTURER'S CONGRESS (Version: FLRCSB v4.5.2)

WITH FLORIDA DCA.

Modular Building Plans Examiner

BUILDING OFFICIAL: Date AN 2 1

DATE:

Summary Energy Code Results

Residential Whole Building Performance Method A

HORTON HOMES

, FL

Project Title: 1447-5465F

Class 3 Rating Registration No. 0 Climate: North

2/14/2008

at a	Building	g Loads	
В	ase	As	s-Built
Summer:	19854 points	Summer:	23109 points
Winter:	15435 points	Winter:	10528 points
Hot Water:	ater: 7273 points Hot Water: 7273 points		7273 points
Total:	42561 points	Total:	40910 points

	Energ	y Use	1
I	Base	As	s-Built
Cooling:	6453 points	Cooling:	6915 points
Heating:	8551 points	Heating:	5554 points
Hot Water:	7905 points	Hot Water:	8081 points
Total:	22908 points	Total:	20550 points

PASS

e-Ratio: 0.90

FLORIDA ENERGY EFFICIENCY CODE FOR BUILDING CONSTRUCTION

Florida Department of Community Affairs Residential Whole Building Performance Method A

Project	Resource and the state of the s	Builder: HORTON
Address		Permitting Office:
City, St		Permit Number:
Owner:		Jurisdiction Number:
Climate	Zone: South	
2. Sing 3. Num 4. Num 5. Is th 6. Conn 7. Glas a. U-fa (or b. SHO (or 8. Floo a. Rais b. N/A c. N/A 9. Wall	construction or existing le family or multi-family liber of units, if multi-family liber of Bedrooms lis a worst case? Stype 1 and area: (Label reqd. by 13-104.4.5 if not default) lictor: Description Area Single or Double DEFAULT) Sic: Clear or Tint DEFAULT) Tob. (SHGC=0.4) 238.1 ft² Types led Wood, Stem Wall R=22.0, 1833.2ft² Itypes led Wood, Exterior R=15.0, 1280.0 ft² In grypes In	12. Cooling systems a. Central Unit Cap: 42.0 kBtu/hr SEER: 13.00 b. N/A c. N/A 13. Heating systems a. Electric Heat Pump Cap: 42.0 kBtu/hr HSPF: 7.80 b. N/A c. N/A 14. Hot water systems a. Electric Resistance Cap: 50.0 gallons EF: 0.90 b. N/A c. Conservation credits (HR-Heat recovery, Solar DHP-Dedicated heat pump) 15. HVAC credits (CF-Ceiling fan, CV-Cross ventilation,
c. N/A 11. Duct a. Sup: b. N/A	_	HF-Whole house fan, PT-Programmable Thermostat, MZ-C-Multizone cooling, MZ-H-Multizone heating)
	Glass/Floor Area: 0.15 Total as-built Total base	points: 21186 points: 21776 PASS

	ompliance with the Florida Energy
Code.	1)(1/2
PREPARED BY: _	NOD YES
DATE:	1 2008
I hereby certify that this with the Florida Energy	a building, as designed, is in compliance Code.
OWNER/AGENT:	

DATE:

Review of the plans and specifications covered by this calculation indicates compliance with the Florida Energy Code. Before construction is completed this building will be inspected for compliance with Section 553.908 Florida Statutes.

BUILDING OFFICIAL:

SEE MANUFACTI IREP'S CONFIDENCE FOR Version: EL POSP (4.5.0) WITH FLORIDA DCA

Summary Energy Code Results

Residential Whole Building Performance Method A

HORTON HOMES

, FL

Project Title: 1447-5465F

Class 3 Rating Registration No. 0 Climate: South

2/14/2008

	Building	g Loads	
В	ase	As	s-Built
Summer:	43515 points	Summer:	45173 points
Winter:	1471 points	Winter:	1066 points
Hot Water:			6273 points
Total:	51259 points	Total:	52512 points

P	Energ	y Use	
E	Base	As	s-Built
Cooling:	14142 points	Cooling:	13648 points
Heating:	815 points	Heating:	567 points
Hot Water:	6819 points	Hot Water:	6971 points
Total:	21776 points	Total:	21186 points

PASS

e-Ratio: 0.97

EnergyGauge®(Version: FLRCSB v4.5)

HORTON

Project Name:

OWNER/AGENT: _

DATE:

1447-5465F

FLORIDA ENERGY EFFICIENCY CODE FOR BUILDING CONSTRUCTION

Florida Department of Community Affairs
Residential Whole Building Performance Method A

Builder:

12. Cooling systems a. Central Unit Cap: 42.0 kBtu/hr SEER: 13.00 b. N/A
c. N/A 13. Heating systems a. Electric Heat Pump b. N/A c. N/A 14. Hot water systems a. Electric Resistance b. N/A c. Conservation credits (HR-Heat recovery, Solar DHP-Dedicated heat pump) 15. HVAC credits (CF-Ceiling fan, CV-Cross ventilation, HF-Whole house fan, PT-Programmable Thermostat, MZ-C-Multizone cooling, MZ-H-Multizone heating)
Review of the plans and specifications covered by this calculation indicates compliance with the Florida Energy Code. Before construction is completed this building will be inspected for

1 Predominant glass type. For actual glass type and areas, see Summer & Winter Glass output on pages 2&4.

SEE MANUFACTURER'S CONTRACT (Version: FLRCSB v4.5.2)
WITH FLORIDA DCA.

Modular Building Plans Examiner

BUILDING OFFICIAL: Date AN 2 1 2008

DATE:

Summary Energy Code Results

Residential Whole Building Performance Method A

HORTON HOMES

, FL

Project Title: 1447-5465F

Class 3 Rating Registration No. 0 Climate: Central

2/14/2008

	Building	g Loads	.5
В	ase	As	s-Built
Summer:	29978 points	Summer:	31774 points
Winter:	5721 points	Winter:	4496 points
Hot Water:	Hot Water: 6790 points Hot Water: 6790 points		6790 points
Total:	42489 points	Total:	43059 points

	Energ	y Use	
· ·	Base	As	s-Built
Cooling:	9743 points	Cooling:	9506 points
Heating:	3170 points	Heating:	2420 points
Hot Water:	7380 points	Hot Water: 7544 points	
Total:	20292 points	Total:	19470 points

PASS

e-Ratio: 0.96

EnergyGauge®(Version: FLRCSB v4.5)

178:

SHEET

0001

JD FIELD B

EFE

0

SECTION 13, TOWNSHIP 3 SOUTH, RANGE 17 EAST COLUMBIA COUNTY, FLORIDA

IN

DESCRIPTION: (ORB. 867, PG. 1333)


SECTION 13, TOWNSHIP 3 SOUTH, RANGE 17 EAST: COMMENCE AT THE SOUTHWEST CORNER OF THE NE 1/4 OF NW 1/4 OF SAID SECTION, AND RUN THENCE N 87'18' E ALONG THE SOUTH LINE OF NE 1/4 OF NW 1/4, 161.84 FEET TO THE EASTERLY LINE OF STATE ROAD NO. S-250, THENCE N 46'13' E, ALONG THE EASTERLY LINE OF STATE ROAD S-250, 1020.72 FEET TO A POINT OF CURVE, THENCE N 43'47' W, ON A PFRPENDICULAR, 100.00 FEET TO THE WESTERLY LINE OF STATE ROAD S-250, THENCE S 46'13' W, 39.65 FEET ALONG THE WESTERLY LINE OF STATE ROAD S-250, FOR A POINT OF BEGINNING, THENCE N 43'47' W, 210.00 FEET, THENCE S 48'00' W, 212.50 FEET, THENCE S 43'47' E, 210.00 FEET, THENCE N 46'13' E, ALONG THE WESTERLY LINE OF STATE ROAD S-250, 212.50 FEET TO THE POINT OF BEGINNING. CONTAINING 1 ACRE, MORE OR LESS.


RETAINING 20 FT. RIGHT OF WAY ON EAST END OF ACRE.

NOTES:

- 1. BEARINGS ARE BASED ON THE WESTERLY LINE OF NE GUM SWAMP ROAD (STATE ROAD NO. S-250), BEING N 46'13'00" E.
- 2. SUBJECT PROPERTY LIES IN ZONE "X", AN AREA OUTSIDE OF THE 500-YEAR FLOOD PLAIN PER FLOOD INSURANCE RATE MAP COMMUNITY PANEL NO. 120070 0150 B. LAST REVISION DATE JAPTUARY 6, 1988. FLOOD ZONE LINES, IF ANY, ARE SCALED FROM FLOOD INSURANCE RATE MAPS, PROVIDED BY FEMA.
- 3. ONLY THOSE VISIBLE INTERIOR IMPROVEMENTS AND IMPROVEMENTS PERTINENT TO THE SUBJECT PROPERTY HAVE BEEN LOCATED AS SHOWN HEREON. EXCEPTION IS MADE HEREON TO UNDERGROUND FACILITIES AND OTHER IMPROVEMENTS



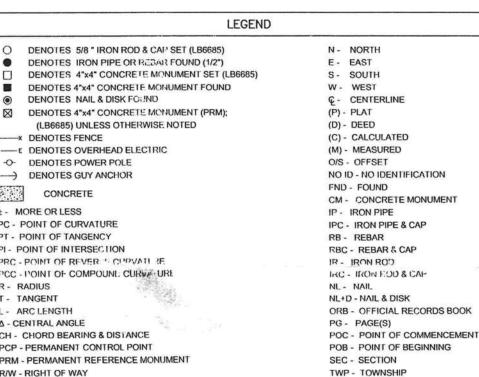

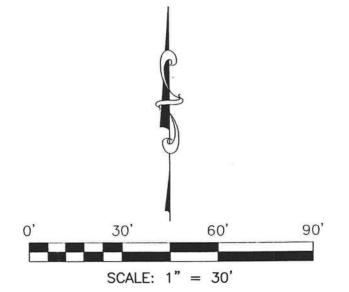


SURVEY FOR: EARL GREEN Jr. WANDA JEAN GREEN COUNTRYWIDE HOME LOANS, INC. SIERRA TITLE LLC TICOR TITLE INSURANCE COMPANY


3-20-07 DATE OF CERTIFICATE

03-05-07 DATE OF FIELD SURVEY

PROFESSIONAL SURVEYOR AND MAPPER FLORIDA CERTIFICATE NO. 6449

SURVEY VALID ONLY OF FIELD SURVEY SHOWN HEREON. NOT VALID WITHOUT THE SIGNATURE AND THE ORIGINAL RAISED SEAL OF A FLORIDA LICENSED SURVEYOR AND MAPPER. FLORIDA CERTIFICATE OF AUTHORIZATION NO. 6685.

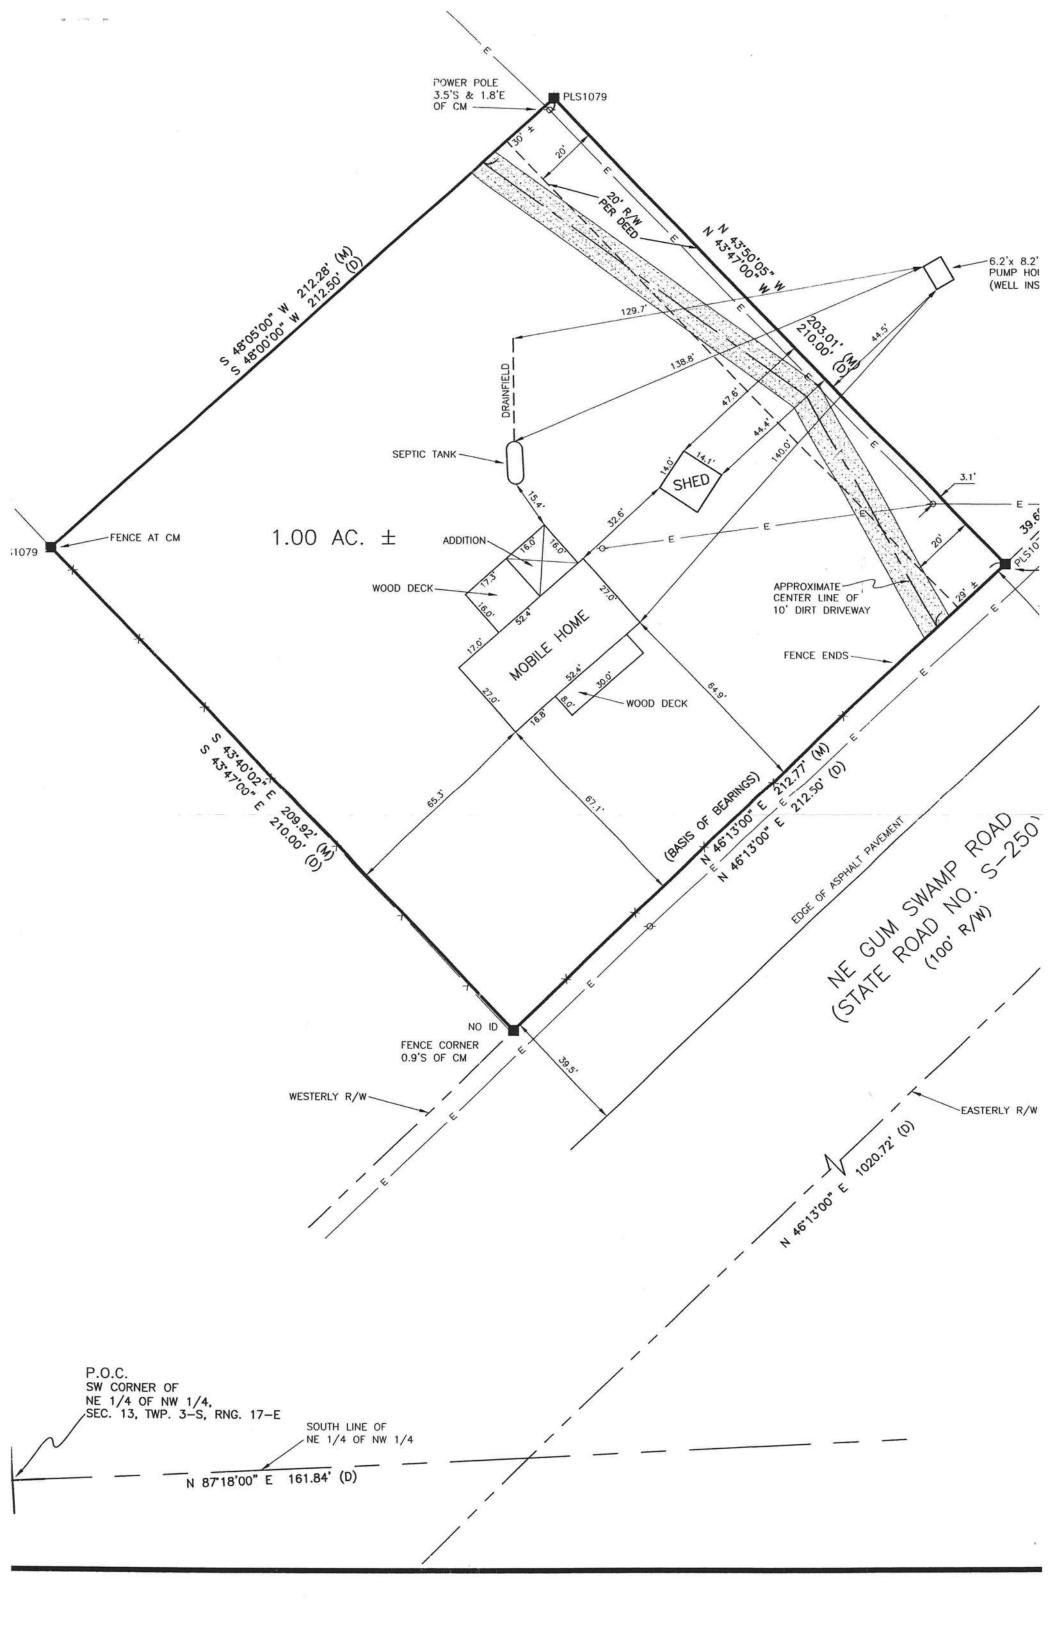

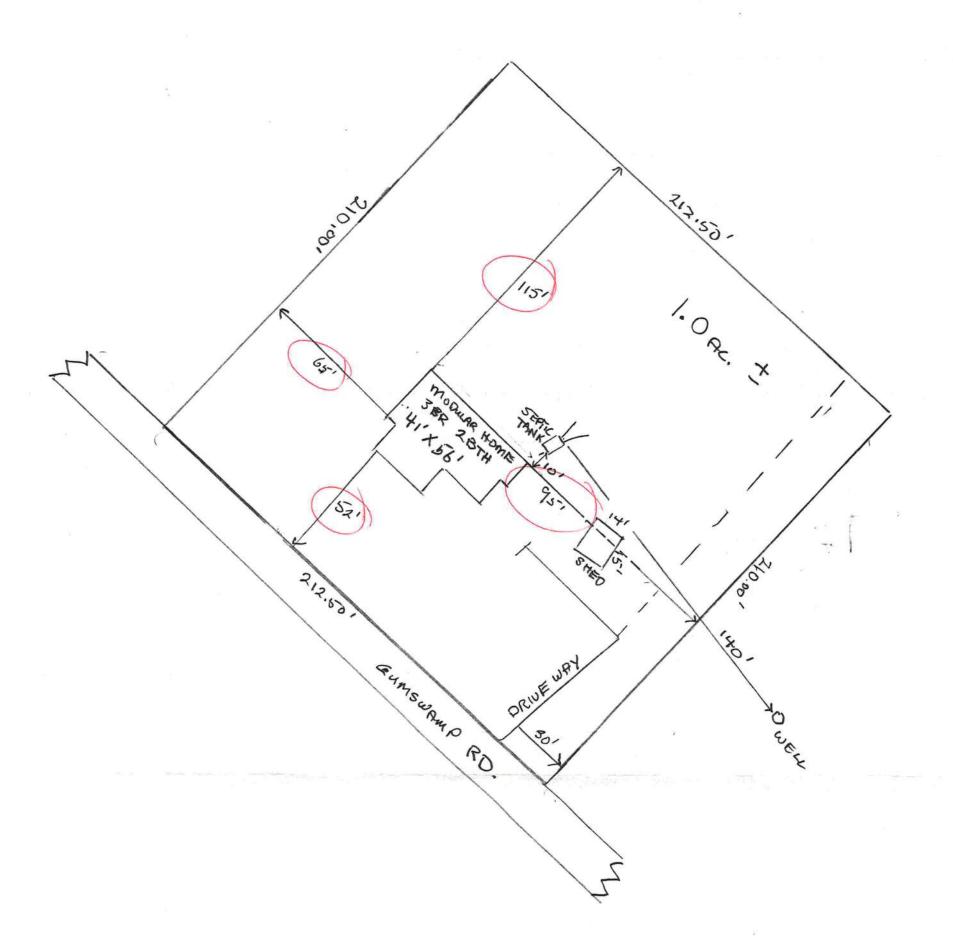

CONTRACTOR! WILLIAM L. HARPER
PARCEL ID. #! RO49+7-000
SCALE! I" > 40'

SIE

Z

NOTE THAT THIS LIST DOES NOT NECESSARILY LIMIT THE TIEMS OF WORK AND MATERIALS THAT MAY BE REQUIRED FOR A COMPLETE INSTITULATION, ALL STIE RELATED TIEMS ARE SUBJECT TO LOCAL JURISDICTION JAPRODIAL.

1. THE COMPLETE FOUNDATION SUPPORT AND TIE DOWN STIEM.

2. RAMPS, STAIRS AND GENERAL ACCESS TO THE BUILDING.

3. PORTABLE PRE CONVOLUSINER(S).

4. BUILDING DRAMPS, CLEANOUTS, AND HOOK-UP TO FRONT PORCH, STEPS COMPLETED ON SITE BY OTHERS. 1813 SQUARE FEET HRE BLOCKING WATERM, SWALL

BE FIRE SAFING RISLATION AND / OR U/L LISTED FIRE
CAULK FOR GAPS OF 1/2" WIDTH AND LESS

FOR LARGER GAPS FIRE SAFIG INSLILATION
SWALL BE SUPPORTED ON NON-COMBUSTBLE SUPPORTS,
SUCH AS BETAL PLASHING,
1, CROSS-OVER DUCT (HVAC)
4. PERMIETER DUCT (LAYOUT (HVAC)
4. PERMIETER OUT (LAYOUT (HVAC) THE FOLLOWING TEAS HATE NOT BEEN COMPLETED BY THE WANDFACTURER, WAS NOT BEEN RESPECTED BY HAY, NO ARE NOT CERTIFIED BY THE WOODLAR, USEL. NOTE THAT THISS LIST GOES NOT CECESSARILY DIAIT THE TEAS OF WARK AND ANTERNALS THAT MAY BE REQUIRED TOR A COMPLETE INSTITUTATION, AUSTREAST, COMPLETE DESCRIPTION APPROVAL. CODE COMPLIANCE MUST BE DETENAINED AT THE COMPLIANCE MUST BE DETENAINED AT THE FLODIS R-22
EXPOSED AIR DUCT VORK, R-8
EXPOSED AIR DUCT VORK, R-8
UPPLY DUCTS IN UNCONDITIONED ATTICS OR OUTSIDE
THE BUILDING ARE INSULATED TO R-8
UCTS IN FLORE TRUSSES SHALL BE INSULATED
O A MINIMUM DF R-6.
O BOUBLE PANE OR STORM TYPE. MAN BLECTRICAL PANEL AND SUB-FEEDERS (MULTI-UNITS ONLY).

NECTION OF ELECTRICAL CIRCUITS CROSSING OVER MODULE

NE LINE(S) - (MULTI-UNITS ONLY).

JUTURAL AND ASSINEITO MIERCONNECTIONS BETWEEN

LUES (MULTI-UNITS ONLY). ILOORS FL—1

MALLS AND OPENINGS TO—1

CORNER BRACING AND PARTITIONS CWB—1

BEAMS AND CATHEDRAL BC—1

EXTERIOR SYSTEMS EXS—1

CROSS SECTIONS CS—2 NITION LOCAL INSPECTIONS DEPARTMENT INSPECTIONS FOR THIS MODULAR WITH ME NICLUDED BY ATTACHMENT PLANS. ANY PLAYS SET WHICH DOES NOT RICLIDE MI ATTACHMENT INSTALLATION INSTRUCTIONS." ARE INCOMPLETE. SHEAR WALL DESIGNATION
INIMUM INSULATION VALUES:
DDF: R-38 S , STORM SHUTTERS. OF FLOOR WIND PROTECTION (IF APPLICABLE) WALL FINISH AND SOFTIT MATERIAL UNES, FIRESTOPPING . OCKING AT MATELINE AND AIR INFILTRATION O SHALL BE INSTALLED BETWEEN SERVICE HOOK-UP (INCLUDING FEEDERS) TO URAL DRAWING REFERENCE MC376FG(BURTON) THE 41X56 SHEAR WALL LOCATION BY LICENSED DESIGNER (DESIGNED BY OTHERS). FLORIDA STATE NOTE: HVAC LOAD IS ASSUMED. IF ACTUAL HVAC LOAD EXCEEDS LOAD SHOWN THE ELECTRICAL PANEL SIZING MUST BE RE-EVALUATED ELECTRICAL SCHEDUL 18 SMOKE DETECTORS 120 14/2 AFC 2004 FLORIDA RESIDENTIAL BUILDING CODE 2005, 2006, 2007 Supplement HAVE COMPRESSER SIZED PER MER. SPECS 200 2005 NATIONAL ELECTRICAL CODE OORPLAN MAY BE MIRRORED ELECTRICAL AMP 240 60 A (2P) 240 6/2 W/#BGR 4 - 2 SE PANEL 2004 FLORIDA RESIDENTIAL BUILDING CODE OVEN AT 3.4 KW.(NAMEPIATE) .. MECHANICAL 005,2006,2007 Supplement 7/12 SHOWN PANEL SIZING CODE SUMMARY: 2004 FLORIDA RESIDENTIAL BUILDING CODE 2005,2006,2007 Supplement PLUMBING 2x6 SPF #2 BETWEEN OVE NSTALL (3) 0.148" × X 3" EACH END OF BLOCK TO (2004 FLORIDA ENERGY EFFICIENCY CODE FOR BUILDING CONSTRUCTION 2005,2006,2007 10.0 KM BUERGY FIRE PREVENTION SAFETY CODE FIRE PREVENTION R/A SYSTEMS
BATH CABINETS (TYPICAL LAYOUT ON FLOORPLAN)
KITCHEN CABINETS (TYPICAL LAYOUT ON FLOORPLAN)
COUNTERFORS (BATH AND OR KITCHEN)
APPLIANCES
EXTERIOR SIDINGS
NITERIOR DOORS
FREPLACE WINDOWS-45 SQ.FT.
PATIO DOOR (SLIDING OR HINGED)-40 SQ.FT. GLAZED AREA
PATIO DOOR MAY REPLACE WINDOWS OR DOOR
PATIO DOOR MAY INSTALLED IN ADDITION
EXTERIOR DOOR SEE—THRUS (INTERIOR)(NON SHEARWALLS ONLY) PLAN MAY BE MIRRORED PIREPLACE 2X6 EXTERIOR WALLS ATIO DOOR (SLIDING OR HINGED) XTERIOR DOOR LUMBING FIXTURES UCT SYSTEMS DPTIONAL ITEMS WHICH MAY BE ADDED TO THE FLOORPLAN EMS LISTED BELOW MAY BE OMITTED ND INSTALLED ON SITE BY OTHERS UBJECT TO LOCAL JURISDICTION AND INSPECTION SFT. FIRE SEPARATION EN CABINETS
RA RECEPTACLES
ESSED FLOURESCENT LIGHTS THE PROPERTY OF THE STRUCTURE AND THE STRUCTURE THE SHETTY WALL: (WINDOWS, DOORS)
ZONE 4 - 40.0 PSF
ZONE 5 - 40.2 PSF WHO LOW: (3 SEC CUSTS)

1. 130 MPH WHO SPEED.

2. In = 1.0

WHO BEOFERS CATEGORY, DICLOSED

3. C

WHO DEPOSINE CATEGORY, DICLOSED

4. OOM = 0.18

MTEMAL PRESSURE COEFFICIENT,

5. D.W.P. FOR C/C

PSF FLOOR LIVE LOAD:
1. 1st Floor 40 PSF.
ROOF LIVE LOAD:
2. 20 PSF.
WIND LOAD:
1. 130 MPH
WHY
2. by = 1.0 ROOF ONESHANG (EA10)

ZONE 2 - 68.0PSF
ZONE 3 - 115.3 PSF
ZONE 3 - 115.3 PSF
ZONE 3 - 115.3 PSF FLORIDA STRUCTURAL LOAD LIMITATIONS: THE MULE THE MODEL OF THE BILLION OF METS ALL REQUIRED TO ANY THE METS AND THE METS ARE LIMITED TO AN DOCUMENT HOME IN THE MEN AGE (8" DALL) OF 32" POLLEGAT OF MODEL PAIRE. * ROOF COMPONENT & CLUDDING LOAD,(EXCOPSF)
ZONE 1 - 32.7 PSF
ZONE 2 - 64.5 PSF
ZONE 3 - 64.5 PSF X Z EXPOSURE C. 2004 FLORIDA RESIDENTIAL BUILDING CODE 層 2004 FBC CHAP 11 2004 FLORIDA ACCESSIBILITY CODE **ACCESSIBILITY** PLUMBING NOTES: FPC

1. ALL PLUMBING FIXTURES SHALL HAVE SEPARATE SHUT-OFF VALVES.

2. WATER HEATER SHALL HAVE SAFETY PAN WITH 1 NICH DRAIN TO EXTERIOR,

1. & P RELIEF VALVE WITH DRAIN TO EXTERIOR, AND A SHUT OFF VALVE WITHIN

3. FET ON A COLD WATER SUPPLY LINE.

3. WATER PIPES INSTALLED IN A WALL EXPOSED TO THE EXTERIOR SHALL BE LOCATED ON THE HEATER SIDE OF THE WALL INSULATION. WATER PIPING INSTALLED IN A UNCONDITIONED ATTO SHALL BE INSULATED WITH AN INSULATION OF R-6.5 MINIMUM.

4. DWY SYSTEM SHALL BE ETHER ABS OR PVC - DWV.

5. WATER SUPPLY LINES SHALL BE PEX, CPC, OR COPPER; WHEN PEX SUPPLY LINES SHALL BE PEX PIPE SHALL BE INSTALLED IN ACCORDANCE WITH THE MANUFACTURERS LIMITATIONS AND INSTRUCTIONS.

6. BUILDING DRAIN AND CLEANOUTS ARE DESIGNED AND SITE INSTALLED BY OTHERS,

SUBJECT TO LOCAL JURISDICTION APPROVAL.

7. THE ACCESS EPANATED LIMITED AND SITE INSTALLED BY OTHERS,

SUBJECT TO LOCAL JURISDICTION APPROVAL. A WEC 410-8(0).

3. WHEN WATER HEATERS ARE INSTALLED THEY SHALL BE PROVIDED WITH READILY ACCESSIBLE DISCONNECTS ADJACENT OTHE WATER HEATERS SERVED. THE BRANCH CIRCUIT SINTHON OR CRICUIT BREAKER SHALL BE PERMITTED TO SERVE AS THE DISCONNECTING MEANS ONLY WHERE THE SWITCH OR CIRCUIT BREAKER IS WITH SOLIT FARD. THE WATER HEATER OR IS CAPABLE OF BEING LOCKED IN THE OPEN POSTITION. HE WATER HEATER OR IS CAPABLE OF BEING LOCKED AND THE BEQUIPMENT SAVED TO THE EQUIPMENT SERVED. A UNIT SWITCH WITH A MARKED TOP FORTON HAT IS A WALL BE PROMITED AS THE DISCONNECTIS ALL MEANS WHERE CHIEF DISCONNECTING WEAKS ARE ALSO PROVIDED BY A PROPOSED AND SIRBED AS BEING IN COMPULATION.

5. PRICE TO DEBROAZING THE ELECTRICAL SYSTEM THE INTERPUTING RATING OF THE MAN REPEAKER WUST BE DESIGNED AND VERTIED AS BEING IN COMPULATION. THE MAN REPARCE AND SHOULE MATING LIVES SHALL BE SITE CONNECTION HIT APPROVED ACCESSIBLE AND FEDERS ARE DESIGNED BY OTHERS, SITE ALL OUTLETS LOCATED WITH A PROVED ACCESSIBLE AND RECTION HEREO.

6. ALL OUTLETS LOCATED WITHIN 6 FEET OF A SINK OR BASIN SHALL BE EQUIPPED WITH GROUP SHALL BE WRED SO THAT THE OPERATION OF ANY ONE SMOKE DETECTOR WILL CAUSE SMULT AND SITE OF THE METALE OF THE SITE 7. TUB ACCESS PROVIDED UNDER HOME, UNLESS OTHERWISE NOTED.

8. SHOWER STALLS SHALL BE COVERED WITH NON-ABSORBENT MATERIAL TO A HEIGHT OF 72 INCHES ABOVE FINISH FLOOR.

9. SHOWERS SHALL BE CONTROLLED BY AN APPROVED MIXING VALVE WITH A MAXIMUM WATER OUTLET TEMPERATURE OF 120°F. (48,8°C)

10. THERMAL EXPANSION DIVICE IF REGUIRD BY THE WATER HEATER MANUFACTURER IS DEIGNED & SITE INSTALLED BY OTHERS.

11. ATMATER HAMMER ARRESTICE SHALL BE INSTALLED WHERE OUTLES OF SHALL BE INSTALLED IN ACCORDANCE WITH MANUFACTURERS SPECIFICATIONS.

11. ATMATER HAMMER ARRESTICE SHALL BE INSTALLED WATER SUPPLY AND SEWER MECHANICAL NOTES: INTERIOR DOORS SHALL BE UNDERCUT 1.5 INCHES ABOVE FINISHED FLOOR FOR AIR RETURN AND/OR AS NOTED ON FLOOR PLAN.
FOR AIR RETURN AND/OR AS NOTED DOORS SHALL BE LIMITED TO .O! INCH WX. (2.5 PASCALS) OR LESS.
TO .O! INCH WX. (2.5 PASCALS) OR LESS.
RESTROOM VENT FANS SHALL PROVIDE 50 CFM MINIMUM OF VENTILATION.

VENT FANS SHALL BE DUCTED TO THE EXTERIOR AND TERMINATE AT AN ALL SUPPLY AIR REGISTERS ARE ADJUSTABLE, EXCEPT WHERE SPECIFIED. APPROPRIATE AND EQUIPMENT SHALL BE GROUNDED IN ACCORDANCE WITH THE APPROPRIATE RATIOLES OF THE MATIONAL ELECTRICAL CODE (NEC).

20 WIEN UGHT PIXTURES ARE INSTIALED IN CLOSEST FIFTY SHALL BE SURFACE NOUNTED OR RECESSED. INCAMOESCHY FIXTURES SHALL HAVE COMPLETELY PROCESSED INCAMOESCHY FIXTURES SHALL HAVE A MINIMAM CLEARANCE OF 12 INCHES AND ALL OTHER FIXTURES SHALL HAVE A MINIMAM CLEARANCE OF 12 INCHES AND ALL OTHER FIXTURES SHALL HAVE A MINIMAM CLEARANCE OTHER FIXTURES SHALL HAVE A MINIMAM CLEARANCE OTHER FIXTURES SHALL HAVE A MINIMAM CLEARANCE OTHER FIXTURES SHALL HAVE OTHER FIXTURES SHALL HAVE OTHER FIXTURES SHALL HAVE OTHER FIXTU VENT FANS SHALL BE DUCTED TO THE EXTERIOR AND TERMINATE AT APPROVED VENT CAP.
HYAC EQUIPMENT SHALL BE EQUIPPED WITH OUTSIDE FRESH AIR NTAKES TO PROVIDE 20 CPM PER PERSON. ALL BRANCH CIRCUITS SUPPLYING 15 AND 20 AMPERE OUTLETS IN I PROTECTED BY AN ARC- FAULT CIRCUIT INTERRUPTER IN ACCORDAN 210.12 , 2005 NEC. ALL RECEPTACLES INSTALLED IN WET LOCATIONS (EXTERIOR) SHALL BE IN WEATHER PROOF (WP) ENGLOSURES, THE INTEGRITY OF WHICH IS NOT AFFECTED WHEN AN ATTACHMENT PLUG CAP IS INSERTED OR REMOVED. 14, NOTE:
"STRUCTURE HAS BEEN DESIGNED FOR INSTALLATION ON STIE — BUILT 13. NOTE:
COMPLETION OF THIS BUILDING TO BE
IN COMPLIANCE WITH ALL STATE AND LOCAL
DESIGN CODES, ALL WORK TO BE COMPLETED ELECTRICAL NOTES: 10. DATA PLATE LOCATION IN OR AT PANEL BOX LOCATION
11. RAISED SCALED PLANS ARE ON FILE WITH THE THIRD PARTY (HI
12. PLAN REARY NO. INSPECTION. REQUIRED BY CHAPTER 633 F.S.,
COCAL TREE SAPEY NESECTION. GENERAL NOTES: PERMANENT FOUNDATION AND IS NOT INTENDED TO BE MOVED, ONCE SO BY A LOCAL BUILDING OFFICIAL BY A LICENSED CONTRACTOR AND INSPECTED ALL GLAZING WITHIN 24 INCH ARC OF DOORS, ITHAN 80 INCHES ABOVE THE FLOOR, AND ALL SAFETY, TEMPERED OR ACTYLIC PLASTIC SHEET OOR DESIGN LIVE LOAD — 40 PSF.
AXIMAN WHO SPEED — 130 MPH (3 SEC 045TS)
COLPANCY IS RESIDENTIAL (F.-2)
COLPANT LOAD IS BASED ON 1 PERSON PER 200 SQUARE FEET
ONSTRUCTION IS TYPE VB. UNPROTECTED. L MATERIALS USE IN THIS CONSTRUCTION OF THE BUILDING ORIDA BUILDING COMMISSION CHAPTER 9B-72 RULES SHALL PROVAL JUANS , GLASS, DOORS, SHALL COMPLY WITH AAMA / NWW -FBC FMC/FGC GLAZING IN DOO BEDROOM ARE NCE WITH SECTION WHICH ARE COVERED BY THAVE CURRENT FLORIDA P OTHERWISE ORS SHALL BE TO BE HANDLED BY THE PRODUCT FEB 2 1 2008 ROBERT E. GREGG REGISTERED ARCHITECT 630 CHESTNUT STREET CLEARWATER, FL 33759 Ph,727-796-8774 Fax727-791-6942 archireg@aol.com Approved By SCOTT & FRANCIS HWC MODULAR MODULAR DES: SEE NOTES LABELS: FL Modular Building Plans Examiner Florida License No. SMP-42 HILBORN, WERNER, CHRIER & ASSOCIATES 1827 SOUTH WARTLE AVE. CLEARWATER, FL 33788 DWG# :1447-5465F DRAWN BY: R.E.G. ORTON SCALE: AS NOTED THE 41X56

MC376FG(BURTON)

APPROVED FEB 2 1 2008

DATE

REV:

DWG. #:

MOMES, INC.

OVER SHEET (FLORIDA APPROVAL)

02-12-08

OF 15

APPLIANCE WATER HEATER INSTANTANEOUS WATER HEATER SHOWER UNITS TUB/ SHOWER KITCHEN SINK FAUCET AVATORY PLUMBING CRANE CRANE ENEX MOEN EEMAX VARIOUS MANUFACTURER FIXTURE SCHEDULE WARRIOR RESIDENTIAL COMMERCIAL SINGLE PIECE DOUBLE BOWL SINGLE PIECE LAVATORY FAUCET PORCELAIN CRANE 3 TO CRANE 8 ENEX 1 TO ENEX 3 CRANE 1 TO CRANE 2 MOEN I TO MOEN DIVISION 15 MECHANICAL PLUMBING PAGE. BOOT 21 TO BOOT 2 2 EEMAX 1 TO EEMAX 2 SPECIFICATIONS

MECHANICAL FIXTURE SCHEDULE

CRANE 9 TO CRANE 15

WHIRLPOOLS/TUBS

CRANE

APPLIANCE	MANUFACTURER	MODEL	SPECIFICATIONS
FURNACE	INTERTHEM	GAS	INTERTHEM GAS Ø THROUGH INTERTHEM GAS 72
FURNACE	INTERTHEM	ELECTRIC	INTERTHEM ELECTRIC @ THROUGH INTERTHEM ELECTRIC 72
EXHAUST FAN	VENTLINE	RANGE	VENT 1 THROUGH VENT 12
EXHAUST FAN	VENTLINE	BATH	VENT 13 THROUGH VENT 17
EXHAUST FAN	VENTLINE	ATTIC	VENT 18
Ţ			

ELECTRICAL FIXTURE SCHEDULE

SIMKAR I THROUGH SIMKAR 63		SIMKAR CORPORATION VARIOUS	LIGHT FIXTURES
CAPITAL 1 THROUGH CAPITAL 130	VARIOUS	CAPITAL	LIGHT FIXTURES
DC 15 THROUGH DC 18	VARIOUS	THOMAS & BATTS	J-BOXES
DC 14	GFCI	USI ELECTRICAL	RECEPTACLES
DC 13	120 V / AC	USI ELECTRICAL	SMOKE DETECTORS
DC 10 THROUGH DC 12/ DC 19 THROUGH DC 20	SELF- CONTAINED	WIRE CON	WIRING DEVICES
DC 7 THROUGH DC 9	VARIOUS	GB	ELECTRICAL FITTING GB
DC 5 THROUGH DC 6	FLUOESCENT	SIMKAR CORPORATION FLUOESCENT	LIGHT FIXTURES
DC 4	DUPLEX GRADE SWITCHES	EAGLE	SNAP SWITCHES
DC 3	STRANDARD GRADE SWITCHES	EAGLE	SNAP SWITCHES
DC 1 THROUGH DC 2	MAIN BREAKER	SIEMENS	LOAD CENTER
SPECIFICATIONS	MODEL	MANUFACTURER	FIXTORE

DOORS SCHEDULE

WINDOW SCHEDULE

SIZE 16"x80"x1-3/8"

DESCRIPTION 6-PANEL HOLLOW CORE

6-PANEL HOLLOW CORE

36, 32"

36"x80"x1-3/8" 48"x80"x1-3/8"

6-PANEL HOLLOW CORE 6-PANEL HOLLOW CORE 6-PANEL HOLLOW CORE

> (2) 2x4 SPF#2 (2) 2x4 SPF#2 (2) 2x4 SPF#2

> > 3040 S.G. 3027 3053

LOUVERED BIFOLD

30"x80"x1-3/8" 28"x80"x1-3/8" 24"x80"x1-3/8"

32"x80"x1-3/8"

60"x80"x1-3/8"

22"x78"x1"

LOUVERED BIFOLD
LOUVERED METAL DOOR

(2) 2x4 SPF#2 (2) 2x6 SPF#2 (2) 2x6 SPF#2 (2) 2x4 SPF#2 (2) 2x4 SPF#2 (2) 2x4 SPF#2

42" X 42" 30" × 66" 36" × 60" 30" × 40" 30" x 53" 30" x 27"

SINGLE HUNG BLOCK SAFETY GLAZED

(2) 2x4 SPF#2

(2) 2x4 SPF#2 12.20 sq.ft. (2) 2x4 SPF#2 6.28 sq.ft. (2) 2x4 SPF#2 11.16 sq.ft.

6.16 sq.ft. 6.14 sq.ft.

SAFETY GLAZED

SINGLE HUNG SINGLE HUNG

> (2) 2x4 SPF#2 HEADERS

> > GLAZED AREA VENT AREA

NOTES

(2) 2x4 SPF#2 8.9 sq.ft. (2) 2x4 SPF#2 4.55 sq.ft.

5.0 sq.ft.

ALL COLUMN STUDS SHALL GLUE/MAILED TOGETHER, PVA GLUE WITH 100% COVERAGE. SHALL BE USED.

6.28 sq.ft.

3.14 sq.ft. 2.28 sq.ft.

3. COLUMN STUDS SHALL NOT BE NOTCHED OR BORED

DOOR SIZES SHOWN IN DOORS ARE IN INCHES AND REFLECT DOOR OPENING

STRAPPING REQUIREMENT AT COLUMNS, REF. FLOORPLAN

DESCRIPTION

72"x80"x1-3/8"

(2) 2x10 SYP#2 (2) 2×10 SYP#2

##- KINRO SERIES 9750 WINDOWS WITH INSULATED CLAZING (U=.35max)
GENERAL NOTES. ALL WINDOWS TO BE SINGLE HUNG W/ INSULATED GLAZING (U=.35) ALL EGRESS
WINDOWS MUST COMPLY WITH IRC SECT. R 310. ALL WINDOWS SHALL BE DESIGN PRESSURE 50.
SHCC=1.0

EXPOSURE "C" MODULAR CONSTRUCTION COMPLYING HORTON HOMES, INC. ASCE 7-02 OR ASCE 7-05, 130 MPH, WITH ASCE 7-98 OR TYPICAL CONSTRUCTION DETAILS FOR

DWG. NO.
-L-1
쮸-1
BC-1
₩-1
TF-2
EXS-1
CHS-1
PFS-1
ED-1
OD-1
SW-1

STANDARD CONSTRUCTION DETAILS REFER TO APPROVED PLANS FOR ANY INFORMATION NOT COVERED IN THESE DRAWNGS.



MODULAR DDES: SEE NOTES LABELS: FL

HEBORN, WEIGHER, CARTER & ASSOCIATES 1827 SOUTH MATTILE AVE. CLEARMATER, FL 33756 DWG# :1447-5465F ORTON LIOMES, INC.

DRAWN BY: R.E.G. SCALE: AS NOTED DATE 02-12-08 REV: 2 OF 15 DWG. #: PLUMB, MECH, ELEC SCHEDULES




THE 41X56


MC376FG(BURTON)


HWG





SEAL: FL

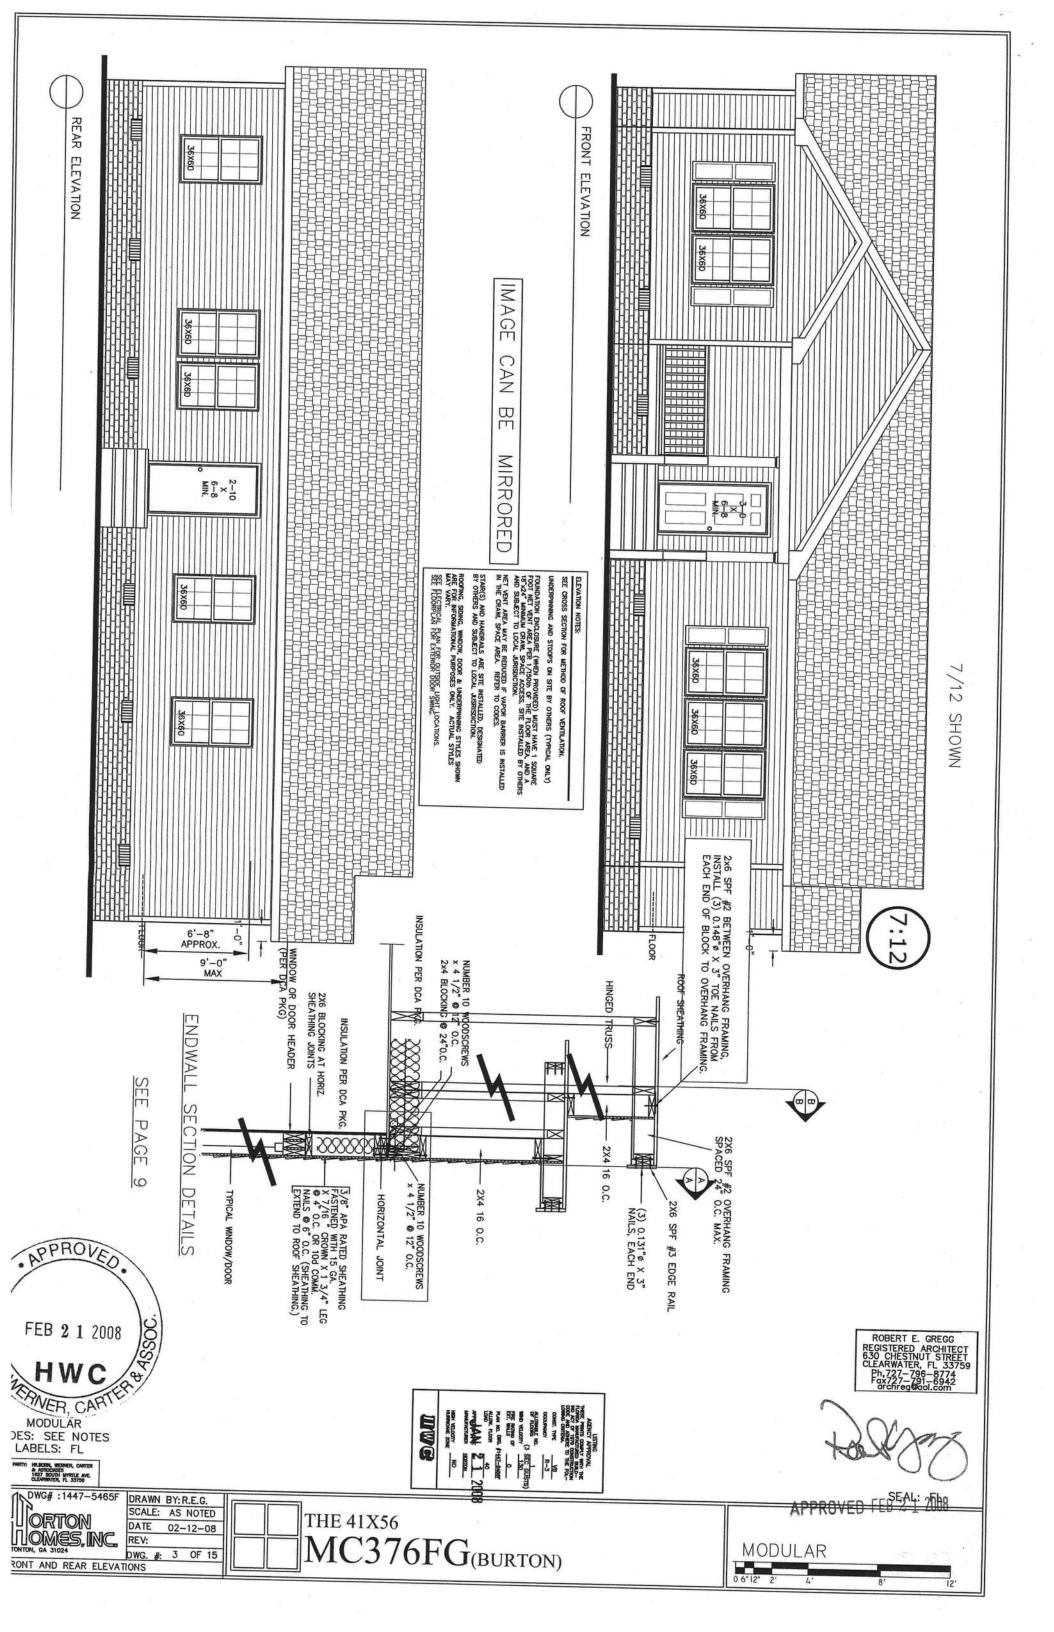


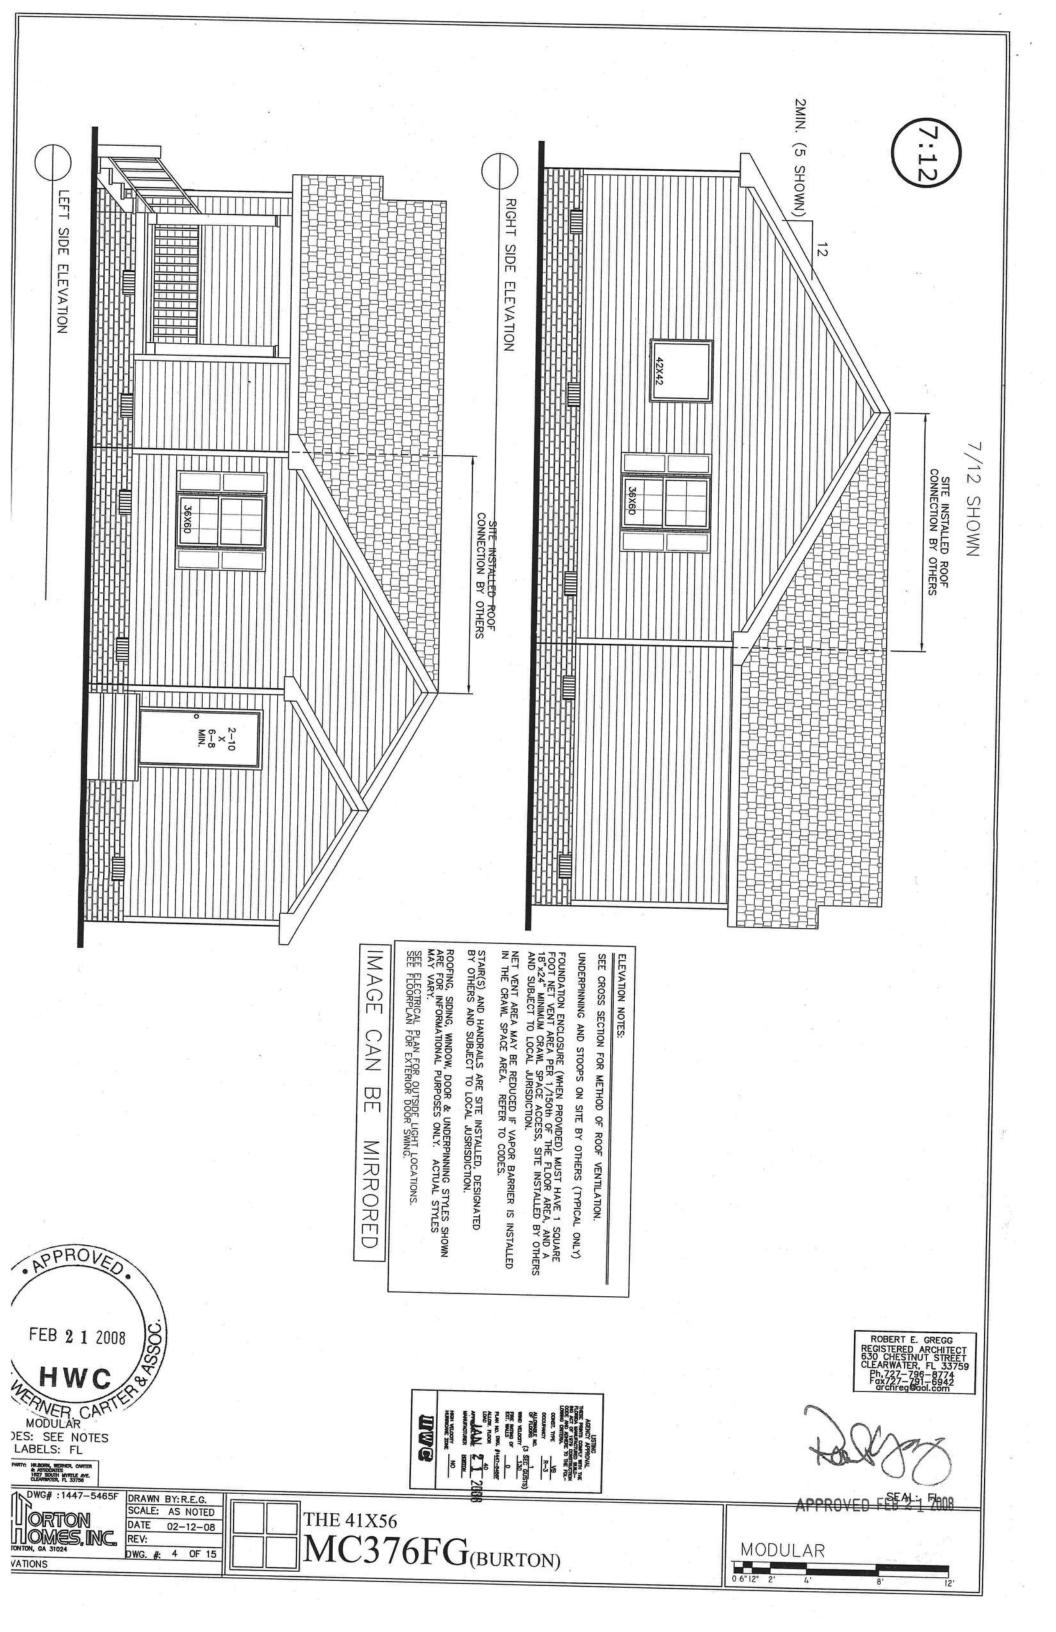


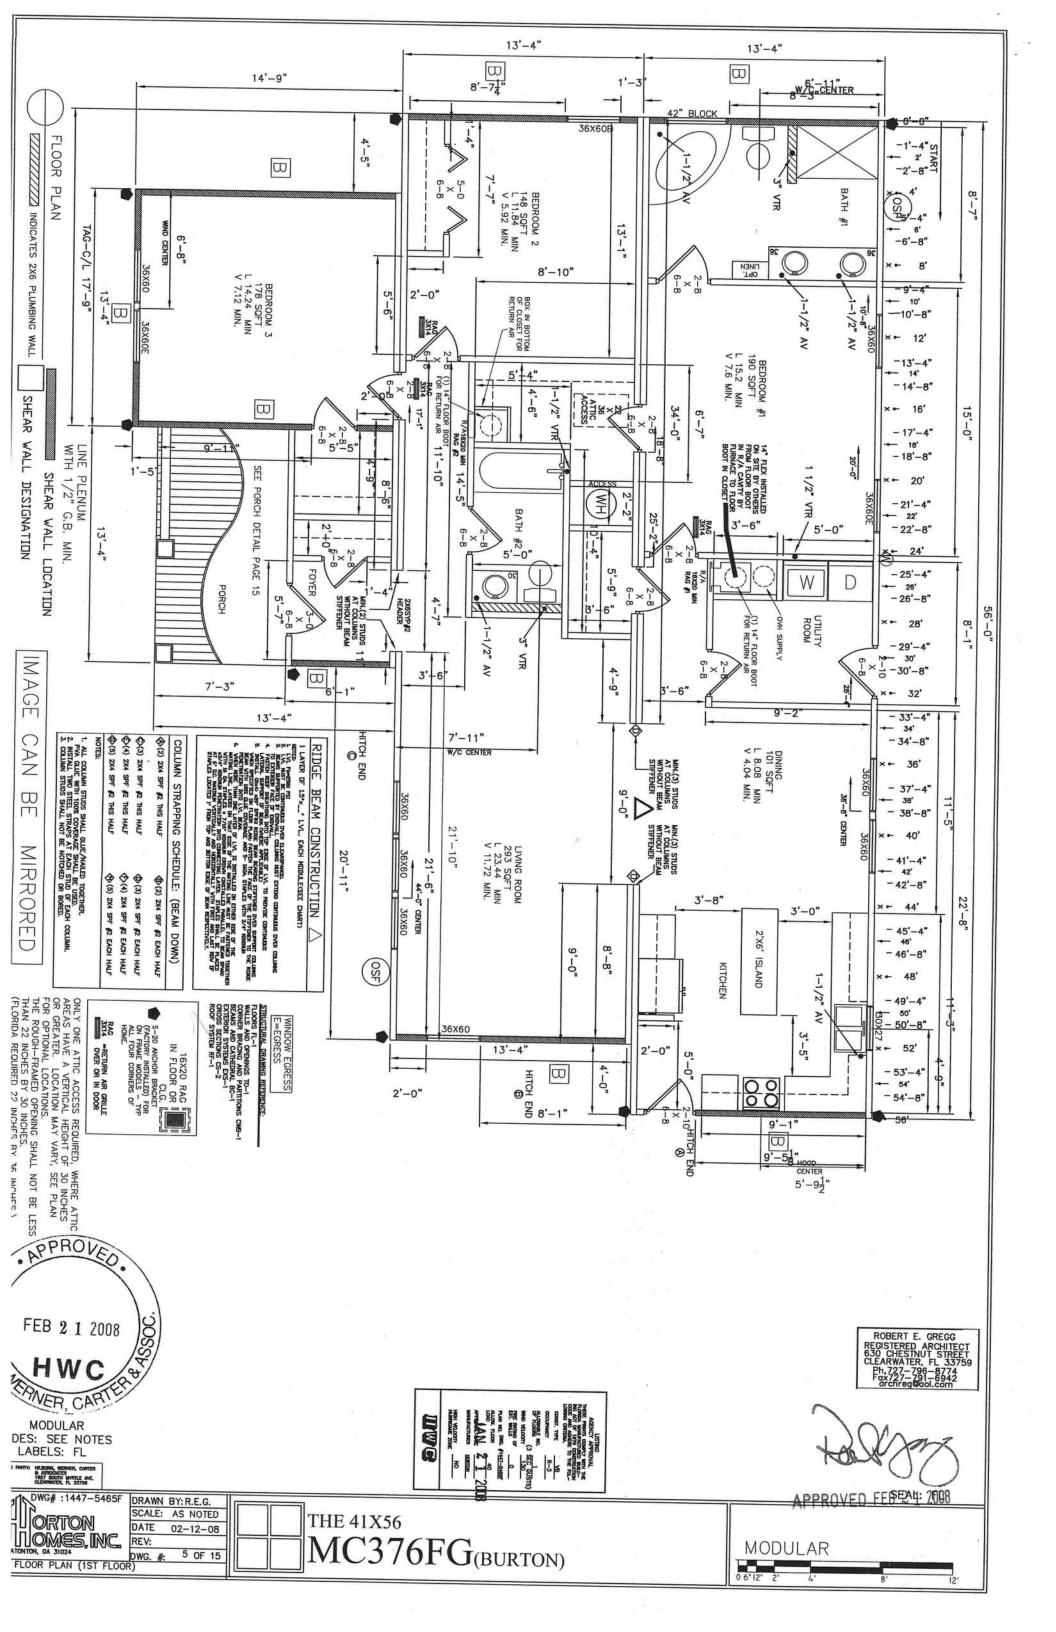


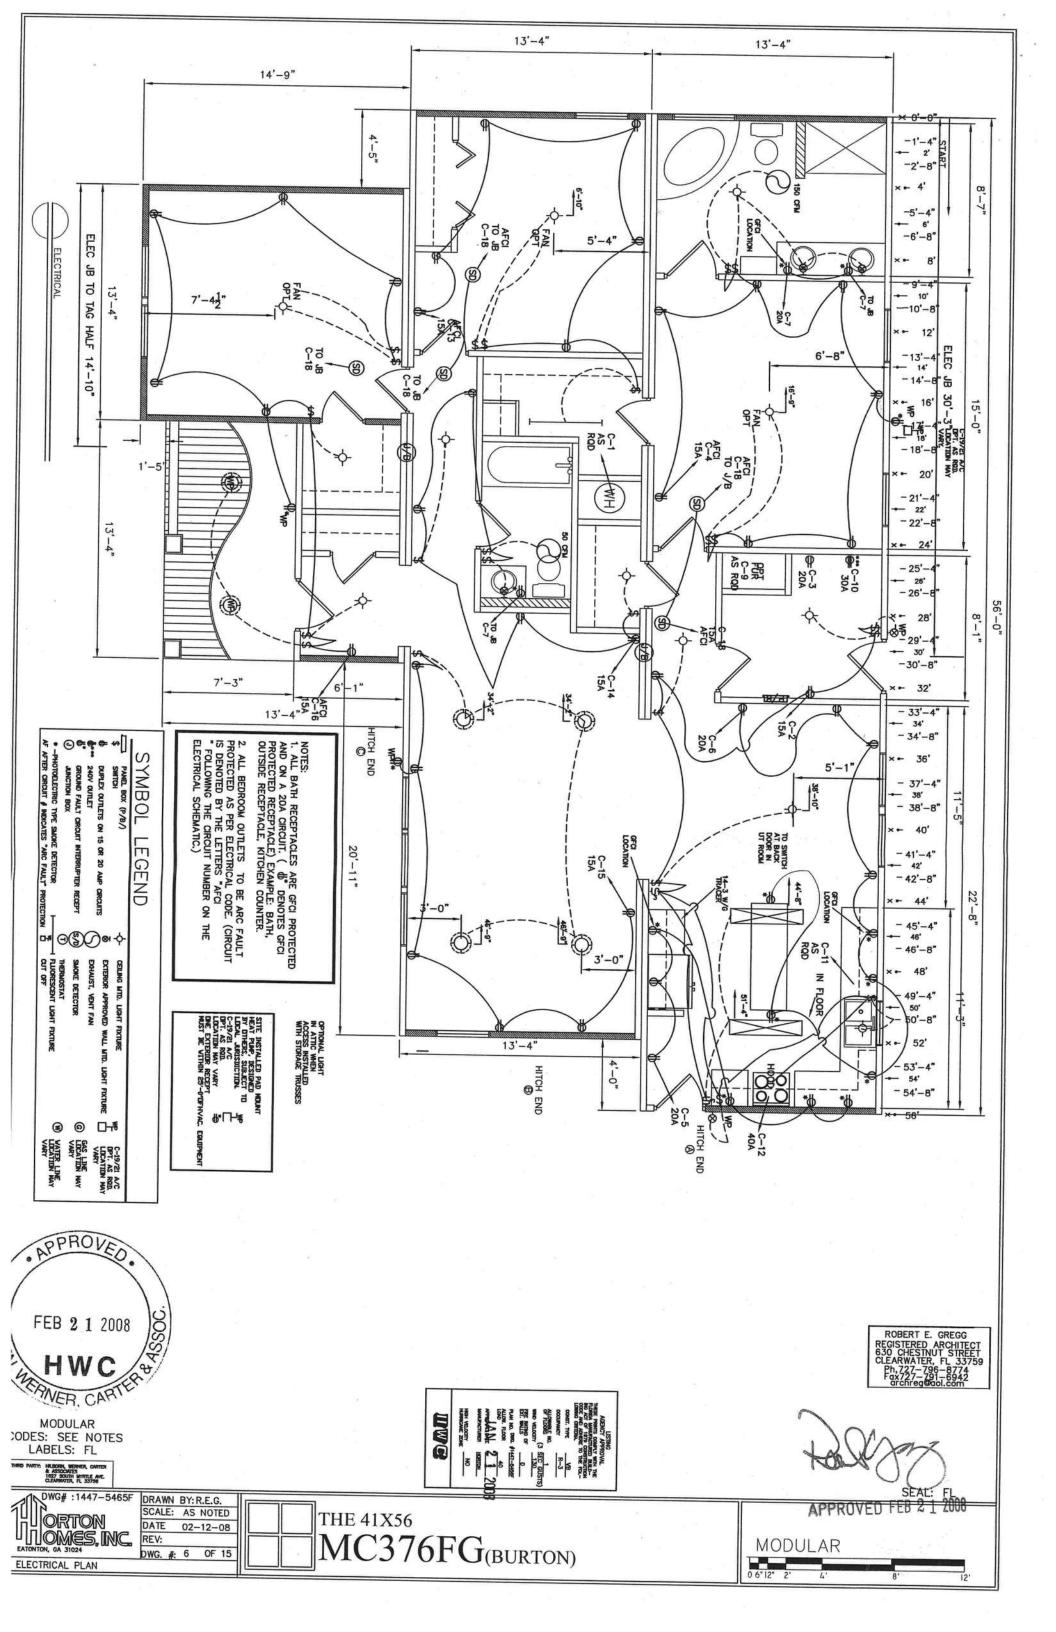


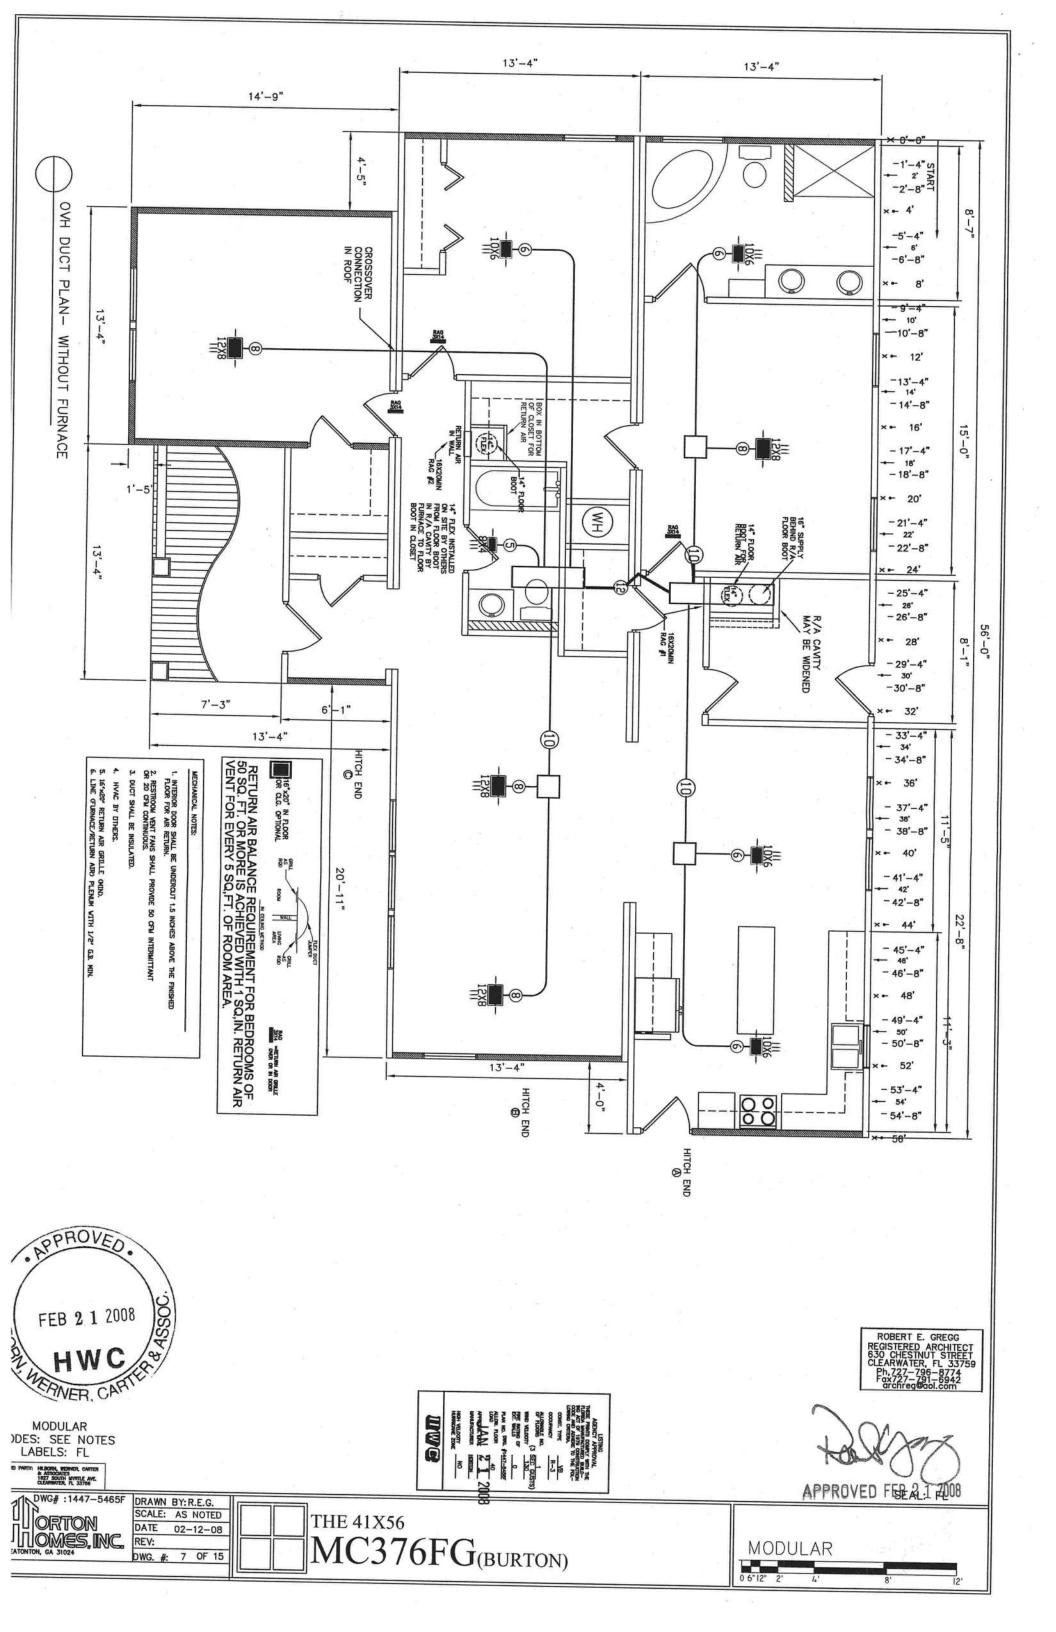


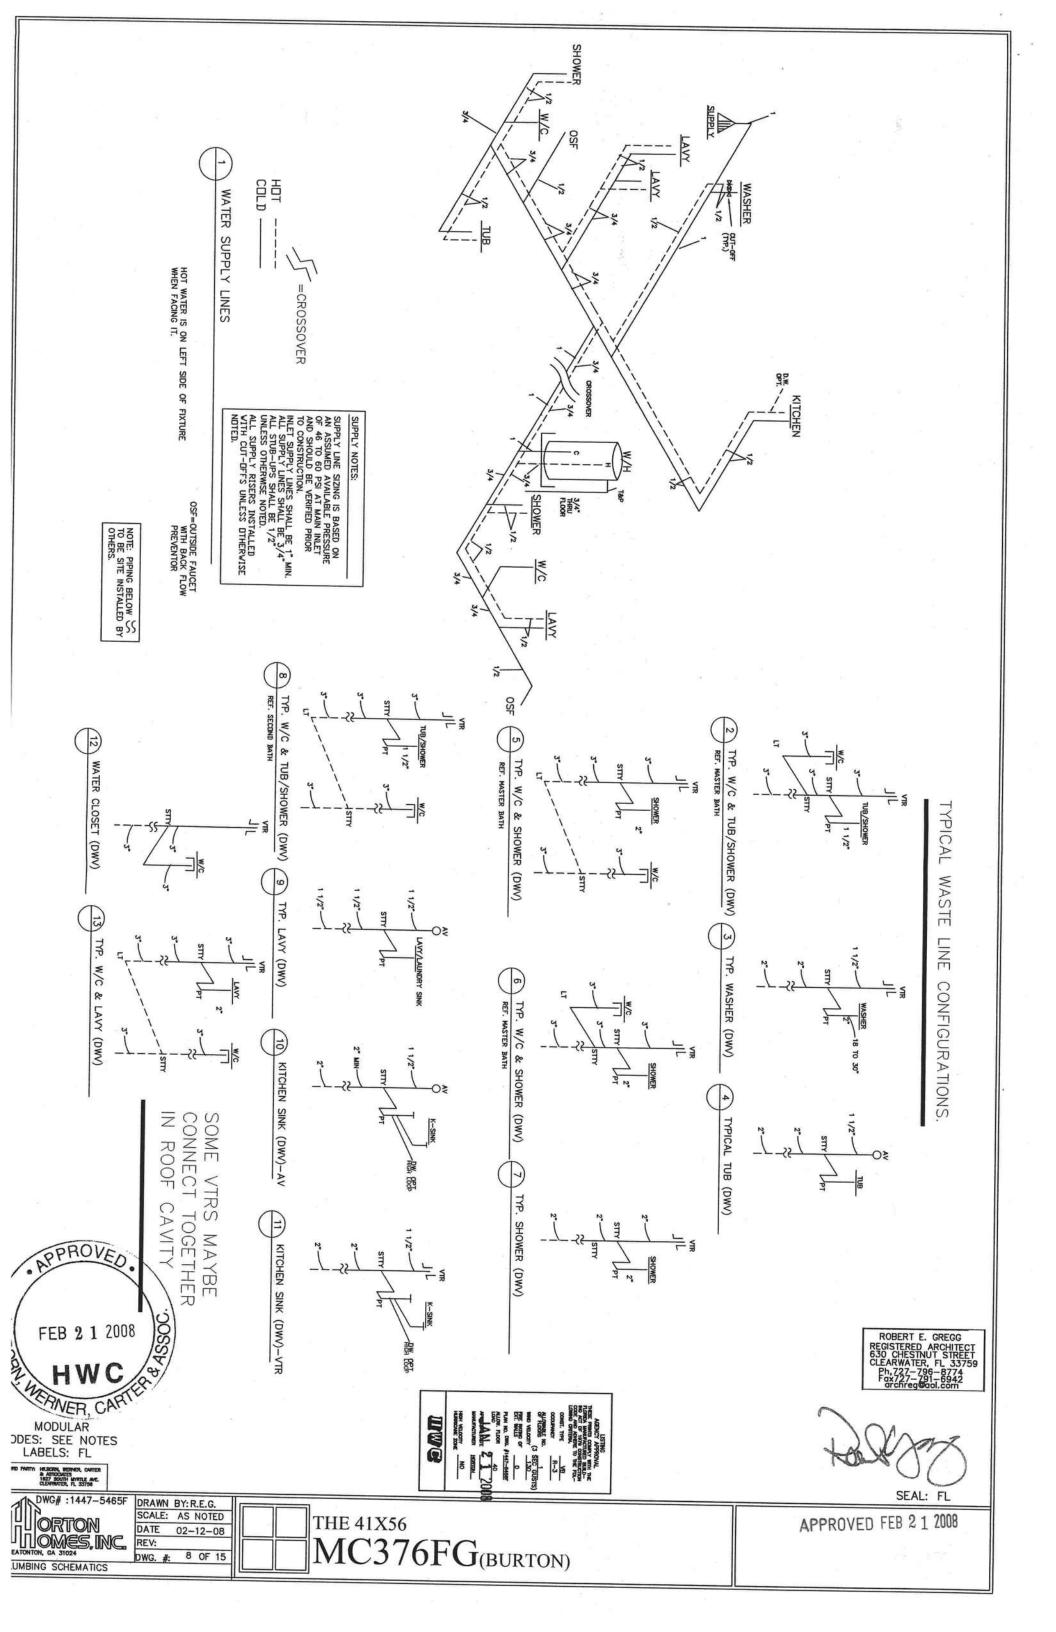


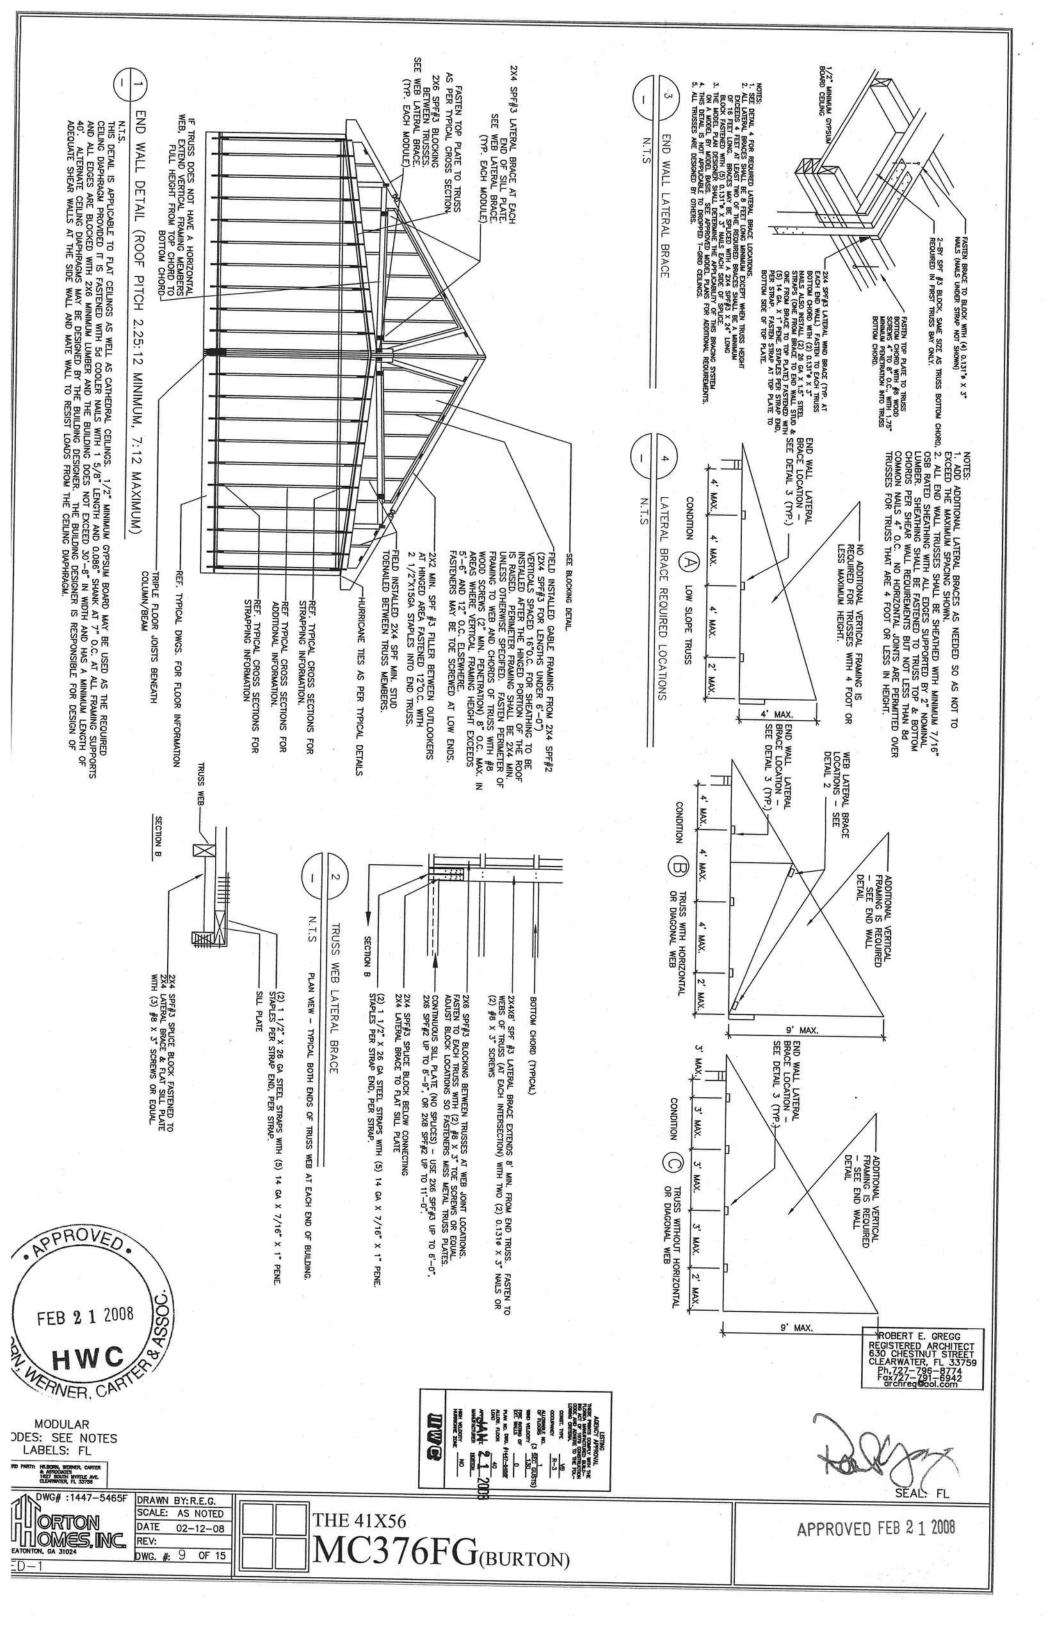


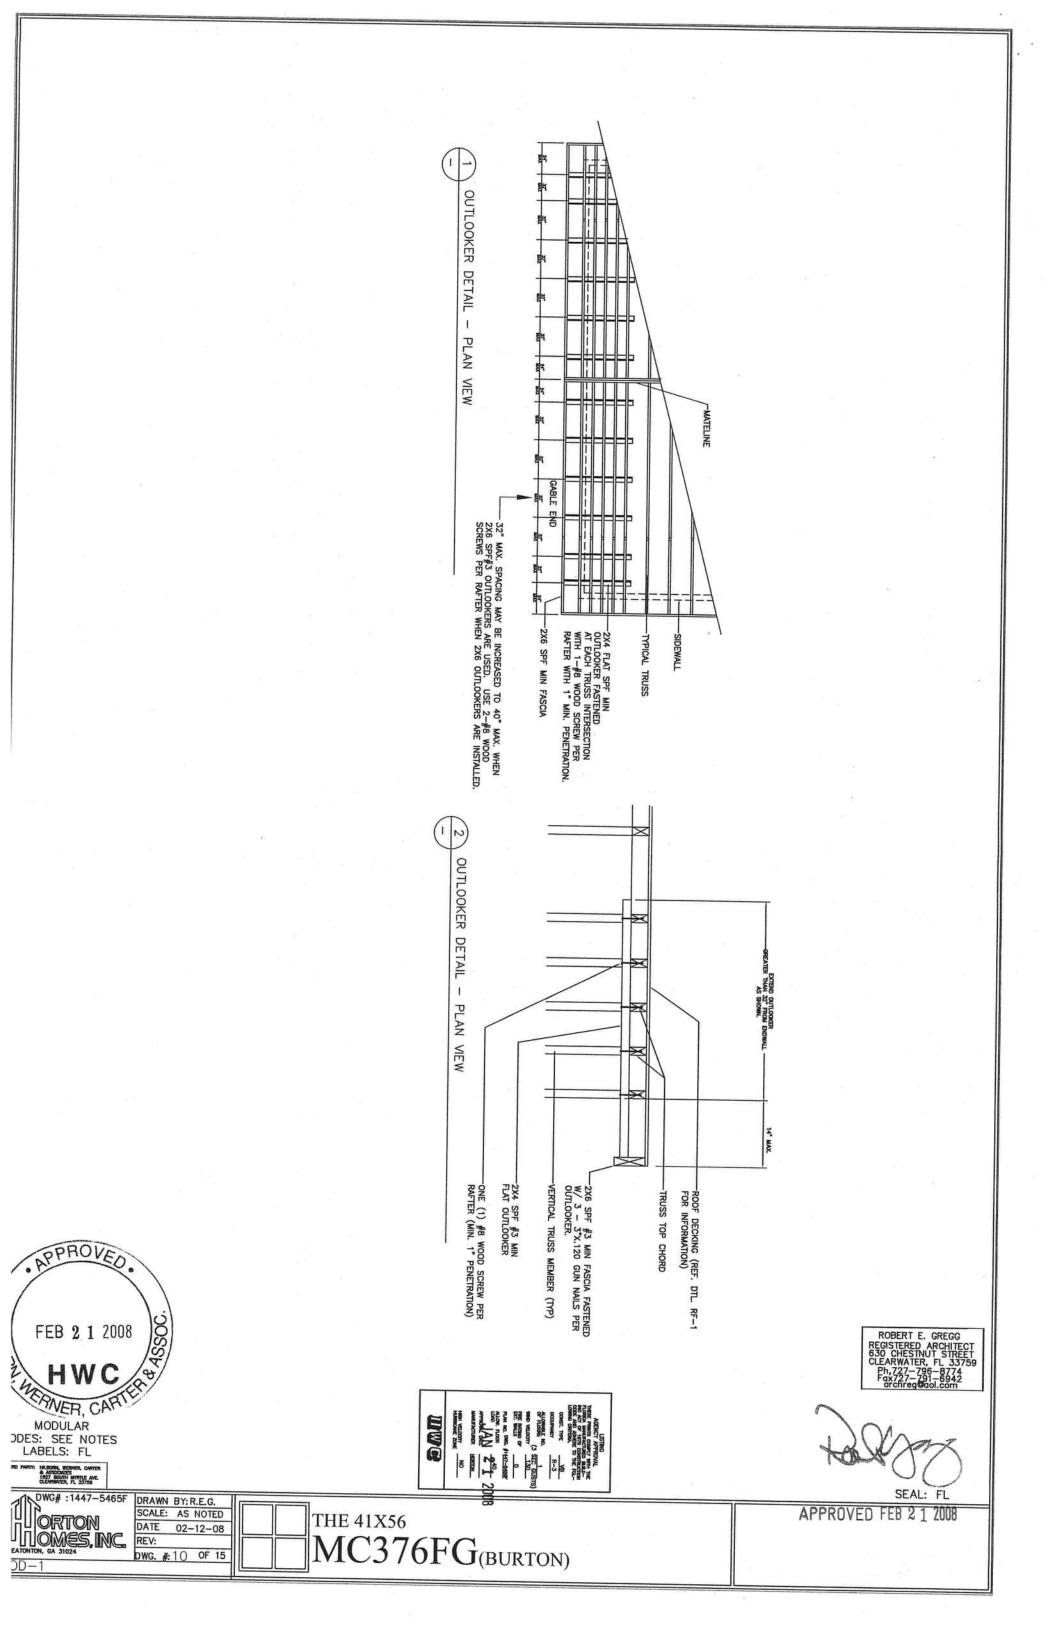


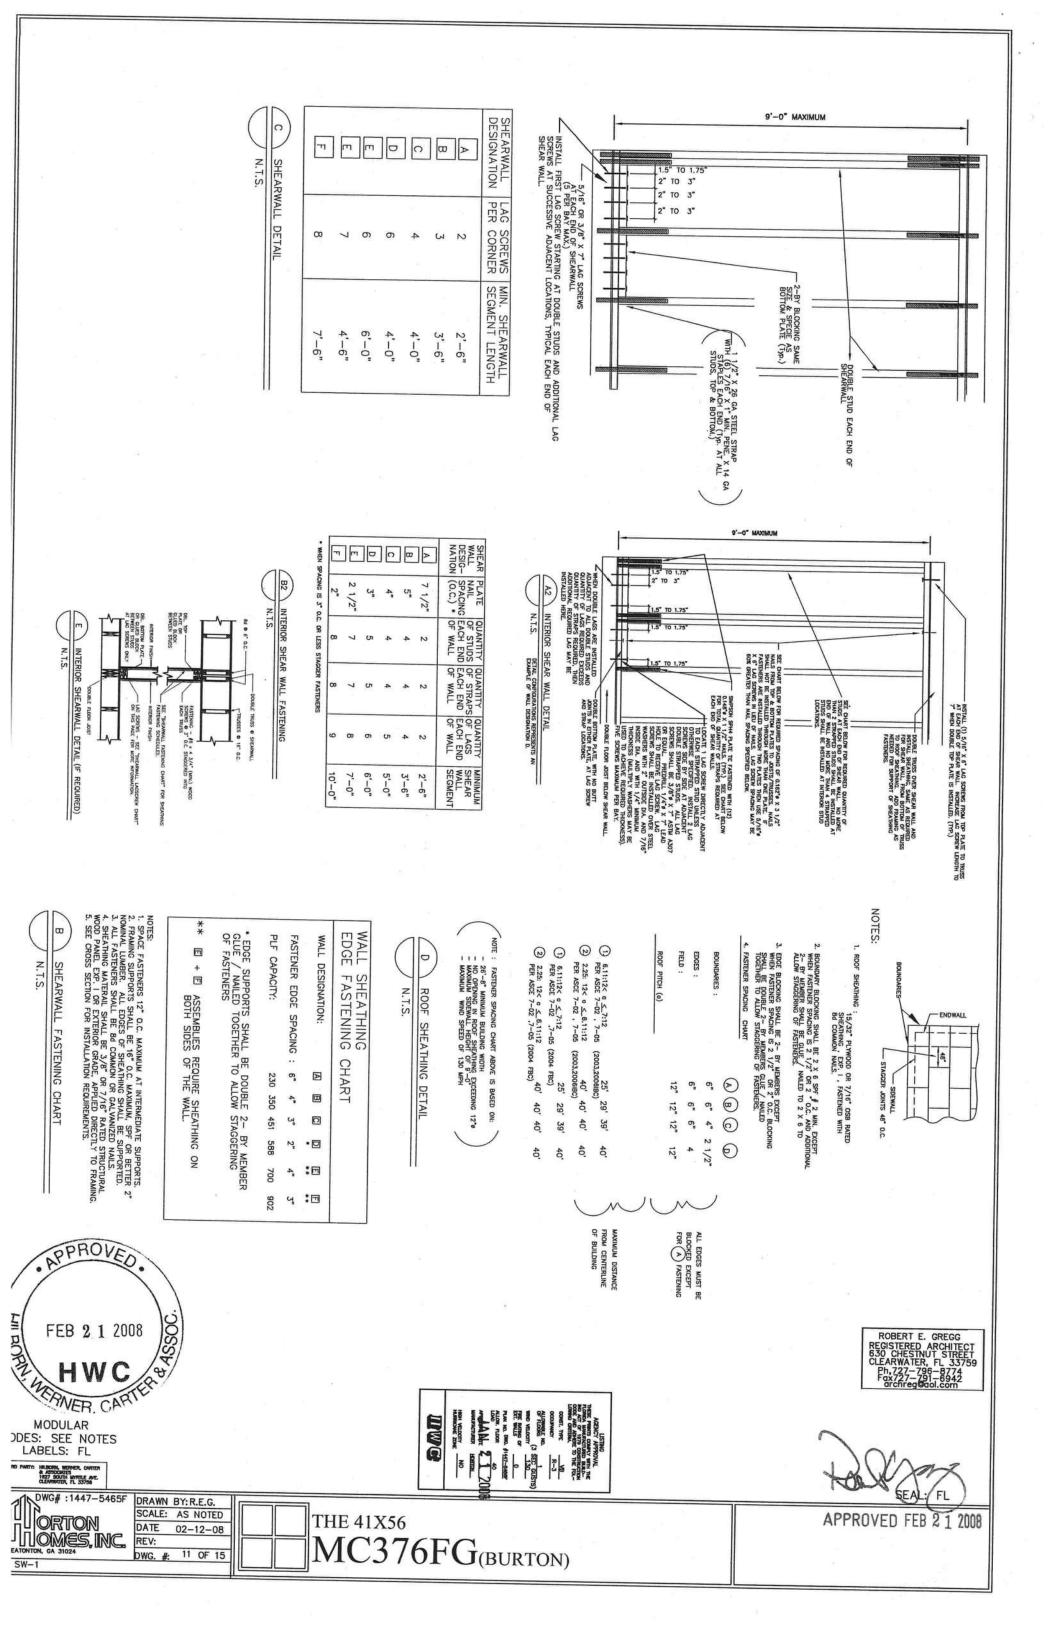


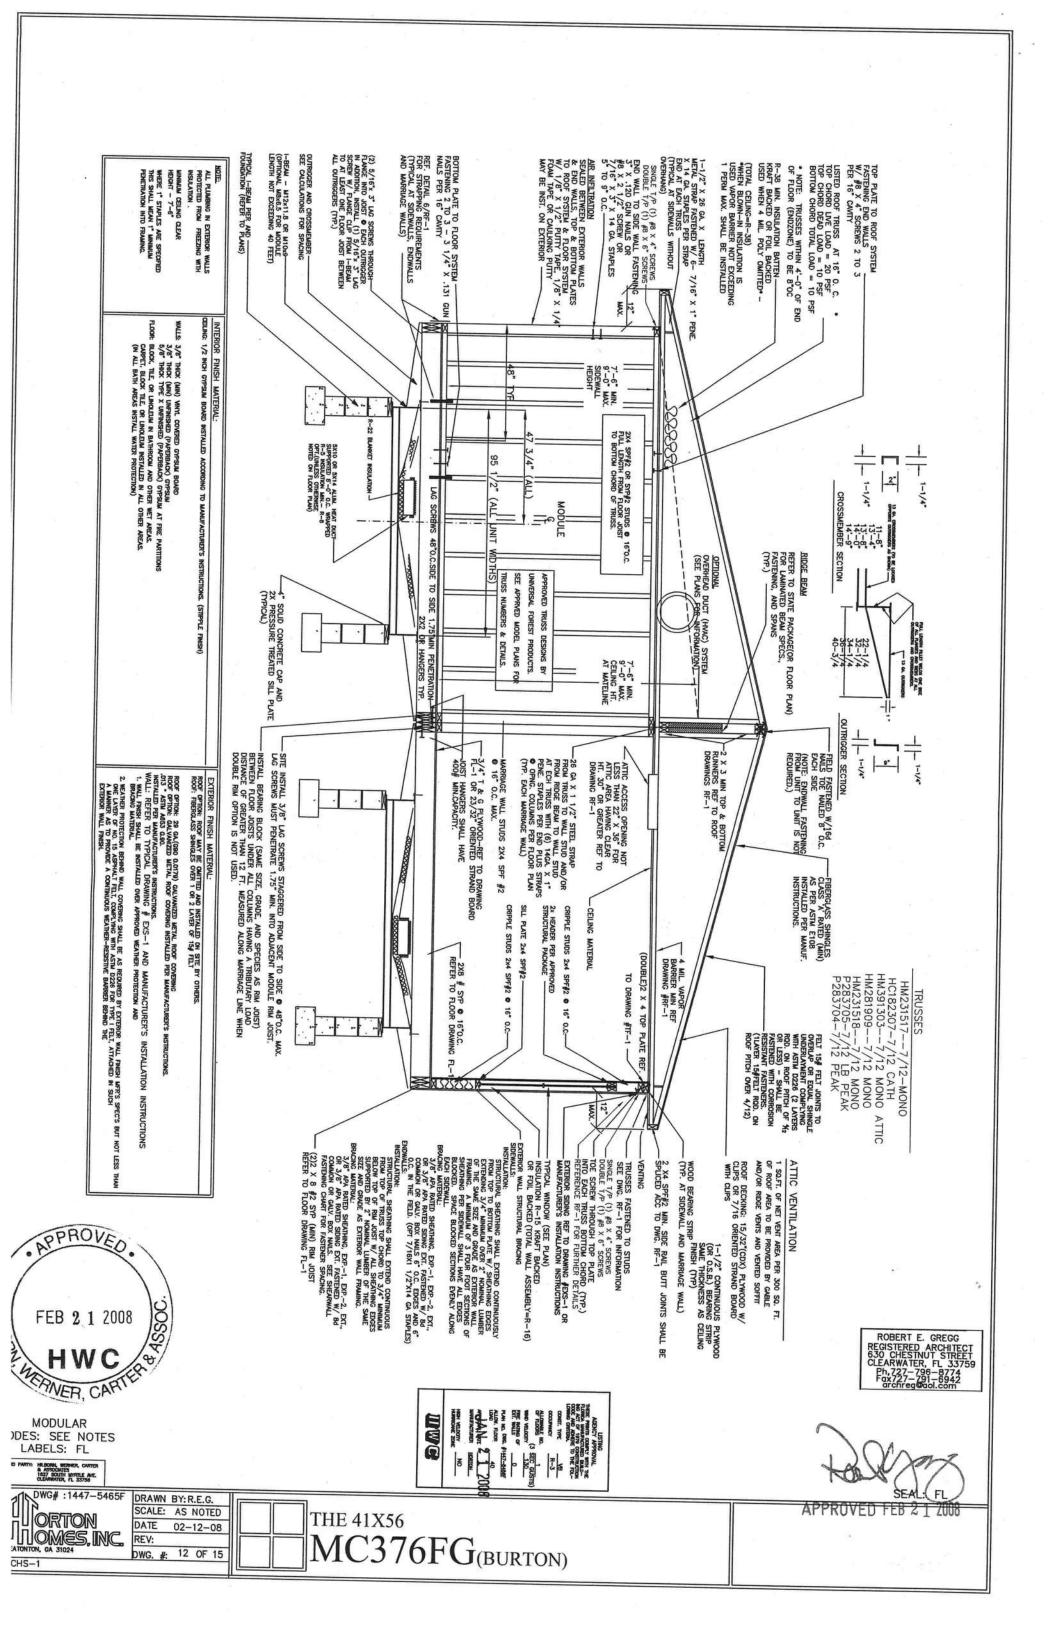

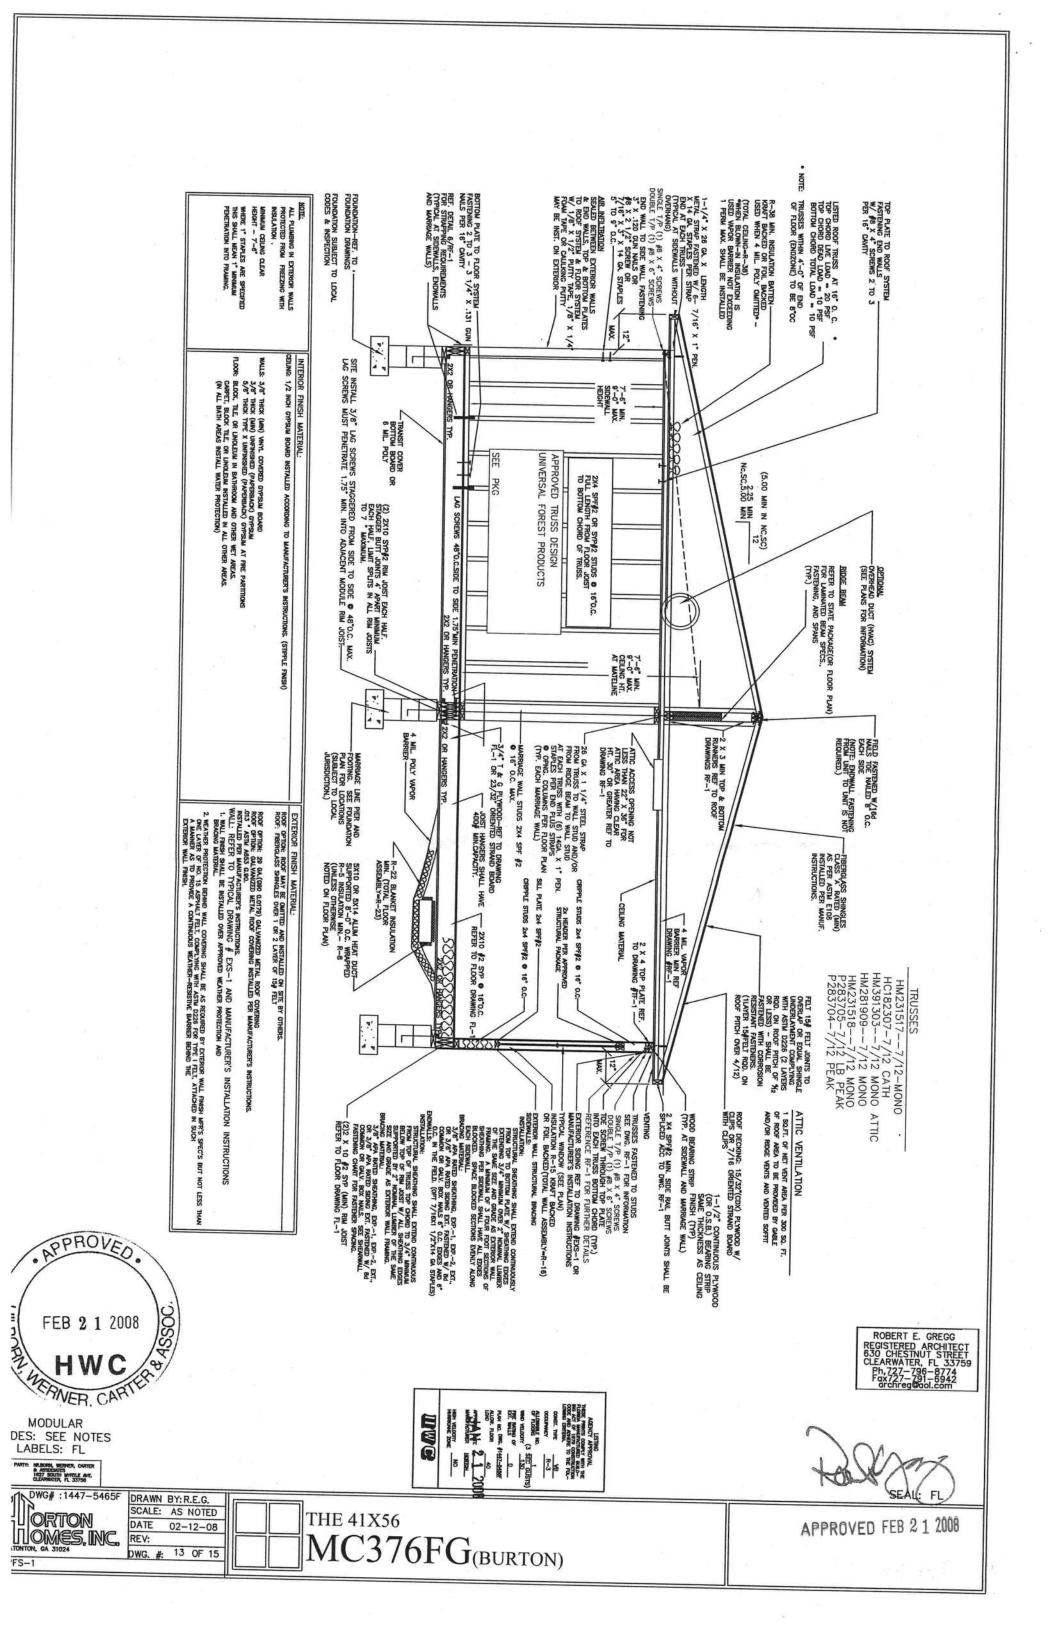

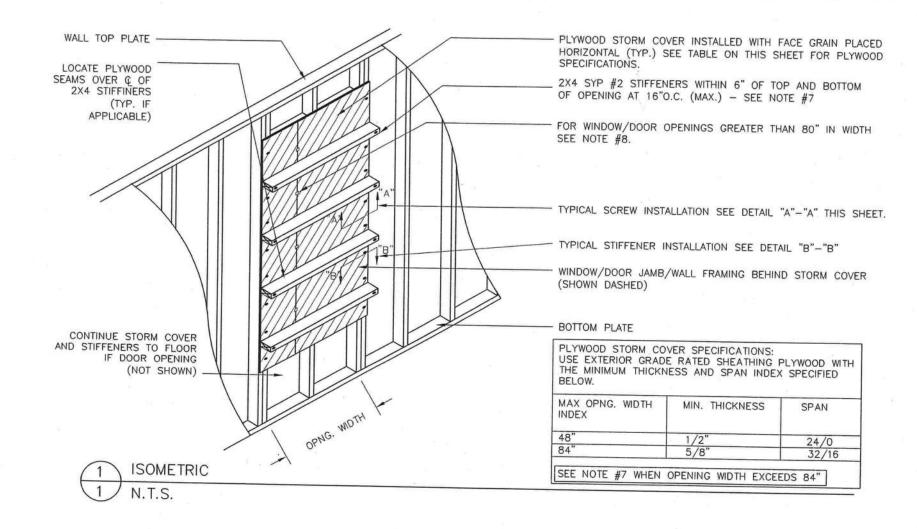

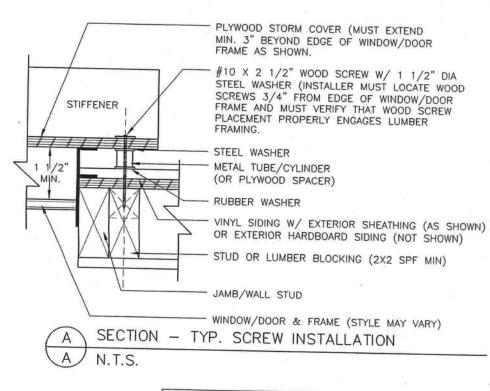

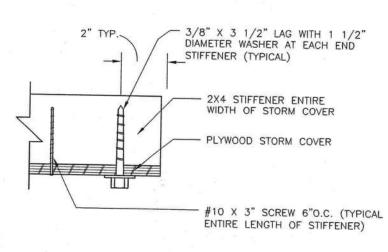

SECTION N.T.S.

GENERAL NOTES:

1. INSTALLER MUST REMOVE ALL DECORATIVE SHUTTERS FROM WINDOWS AND DOORS PRIOR TO INSTALLING THE STORM COVERS SPECIFIED ON THIS DRAWING.

2. WHEN HURRICANE OR SEVERE WIND STORMS APPROACH, THE WINDOW AND DOOR PROTECTION COVERS SPECIFIED ON THIS DRAWING SHOULD BE INSTALLED.

3. IMMEDIATELY AFTER INSTALLING THESE COVERS THE BUILDING MUST BE VACATED AND/OR NO OCCUPANTS SHOULD REMAIN IN THE STRUCTURE.

4. NOTE: THIS STORM PROTECTION SYSTEM DOES NOT PERMIT EGRESS FROM THE BUILDING UNDER FIRE OF OTHER EMERGENCY CONDITIONS. 5. AS SOON AS THE STORM HAS SUBSIDED, ALL STORM PROTECTION MUST BE IMMEDIATELY REMOVED BEFORE OCCUPANCY OF THE BUILDING IS PERMITTED.

6. ALL WOOD SCREW HOLES RESULTING FROM STORM COVER INSTALLATION MUST BE FILLED WITH GOOD QUALITY EXTERIOR GRADE CAULK.

7. WHEN OPENING WIDTH EXCEEDS 84" (UP TO A MAXIMUM OF 120") USE 2X6 SYP #2 STIFFENERS AND USE 3/4" PLYWOOD WITH A SPAN INDEX OF 48/24. ALL OTHER INSTALLATION SPECIFICATIONS REMAIN UNCHANGED.


8. FOR OPENINGS WIDER THAN 80", LOCATE STORM COVER BUTT JOINT WITHIN 30" OF VERTICAL STUDS AND INSTALL "H" CLIPS BETWEEN LUMBER STIFFENERS AS SHOWN.



MODULAR DES: SEE NOTES LABELS: FL

HILBORN, WERNER, CARTER & ASSOCIATES 1827 SOUTH MINTILE AVE. CLEARMAIER, FL 33756 DWG# :1447-5465F ORTON

DRAWN BY: R.E.G. SCALE: AS NOTED DATE 02-12-08 REV: DWG. #: 14 OF 15 MNDOW/DOOR STORM DOOR PROTECTION

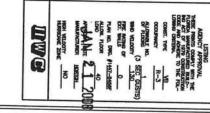



ROBERT E. GREGG REGISTERED ARCHITECT 630 CHESTNUT STREET CLEARWATER, FL 33759 Ph,727-796-8774 Fax727-791-6942 archreg@ool.com



THE 41X56 MC376FG(BURTON)

APPROVED FEB 2 1 2008

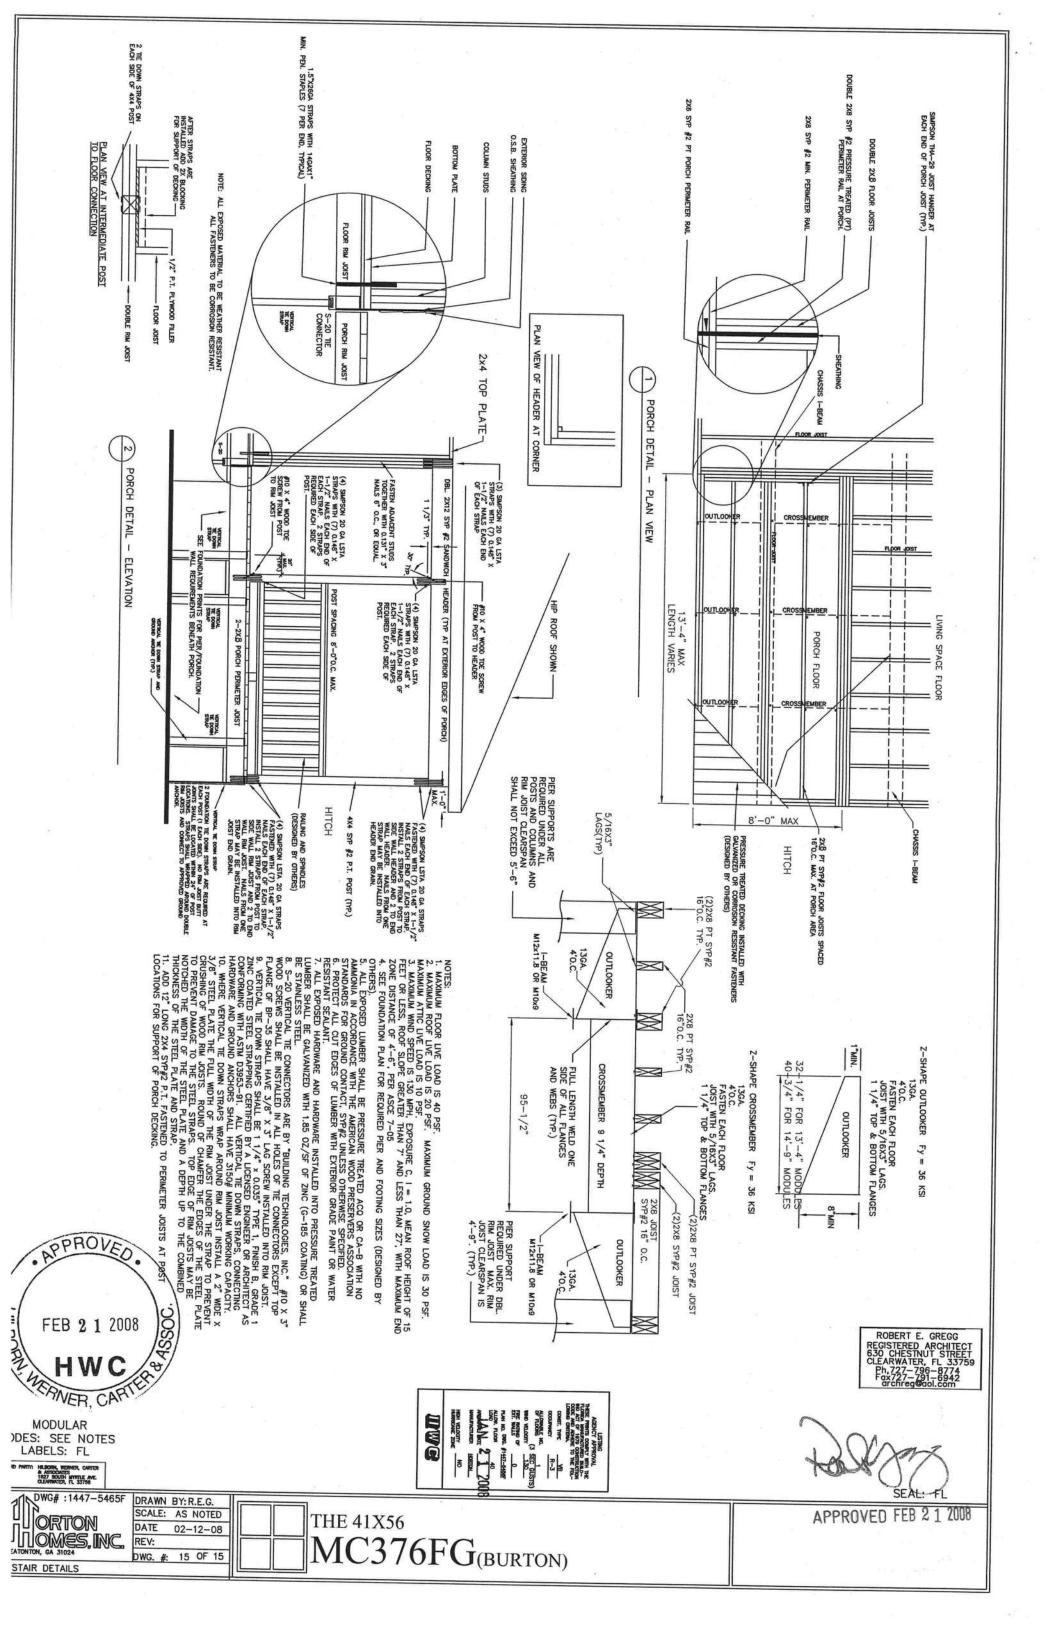

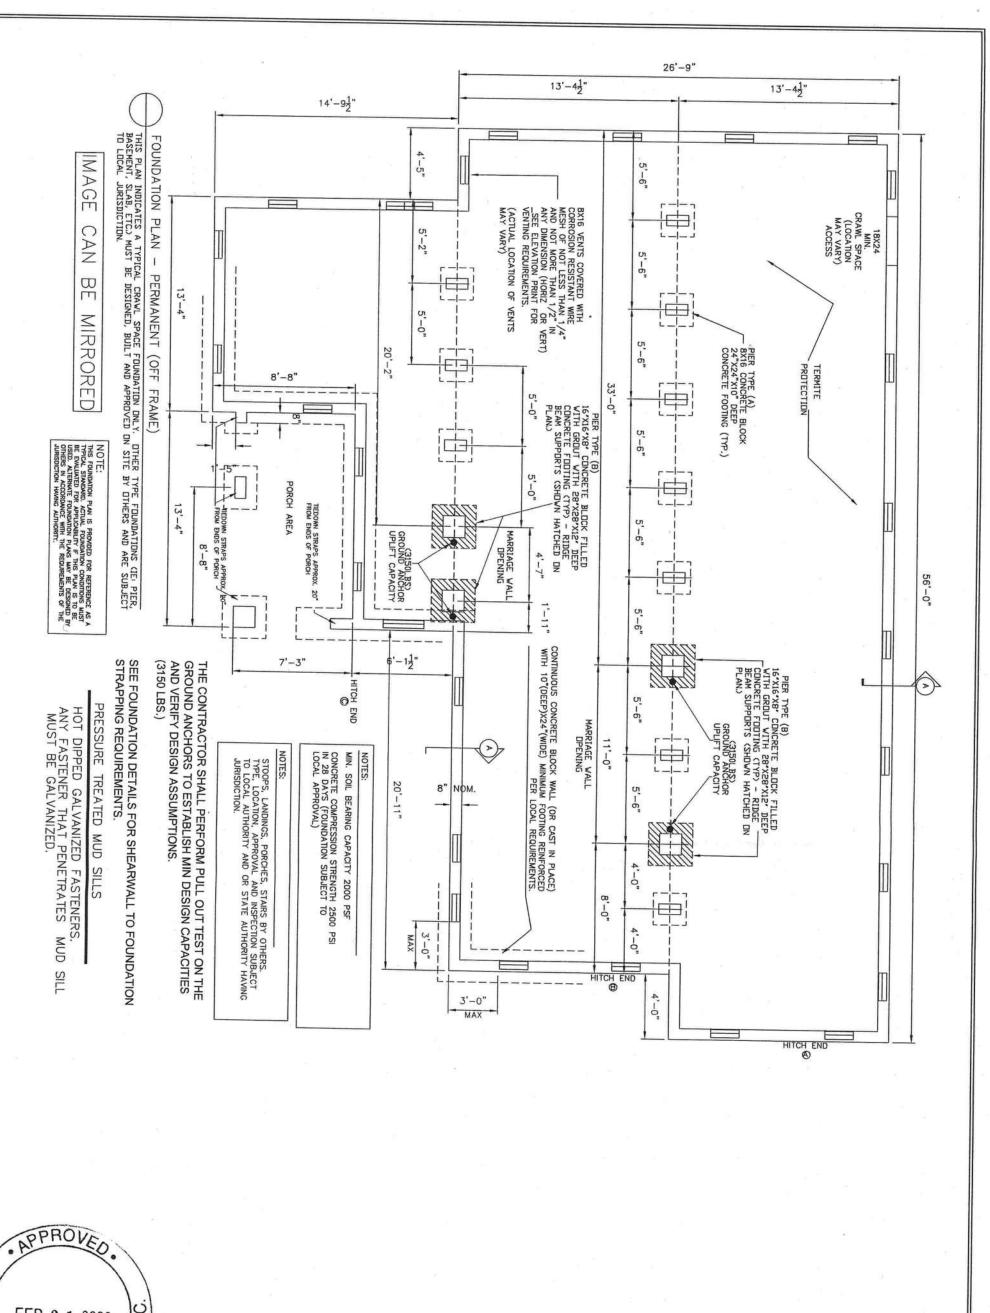




MODULAR DES: SEE NOTES LABELS: FL

HR.SORN, WERNER, CARTER & ASSOCIATES 1827 SOUTH WITKILE AVE. CLEARWRIER, FL 33756 DWG# :1447-5465F ORTON MOMES, INC.


DRAWN BY: R.E.G. SCALE: AS NOTED DATE 02-12-08 REV: DWG. #: OFF FRAME FOUNDATION PLAN


THE 41X56 MC376FG(BURTON)




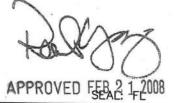




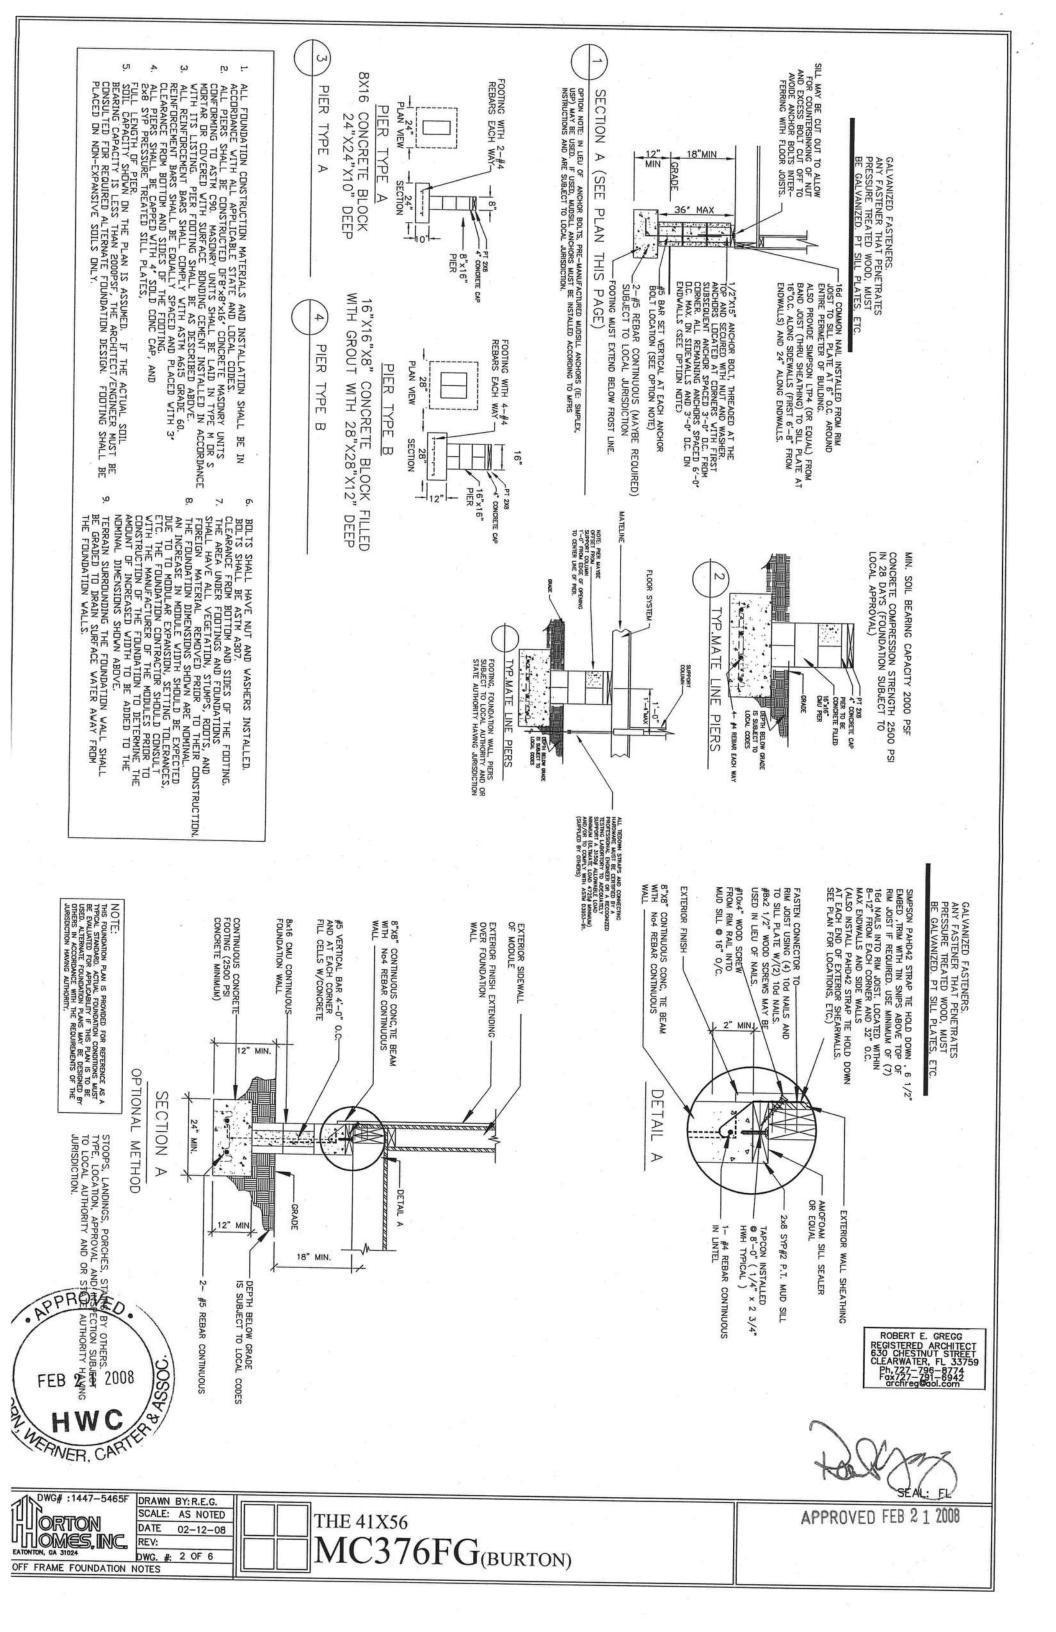

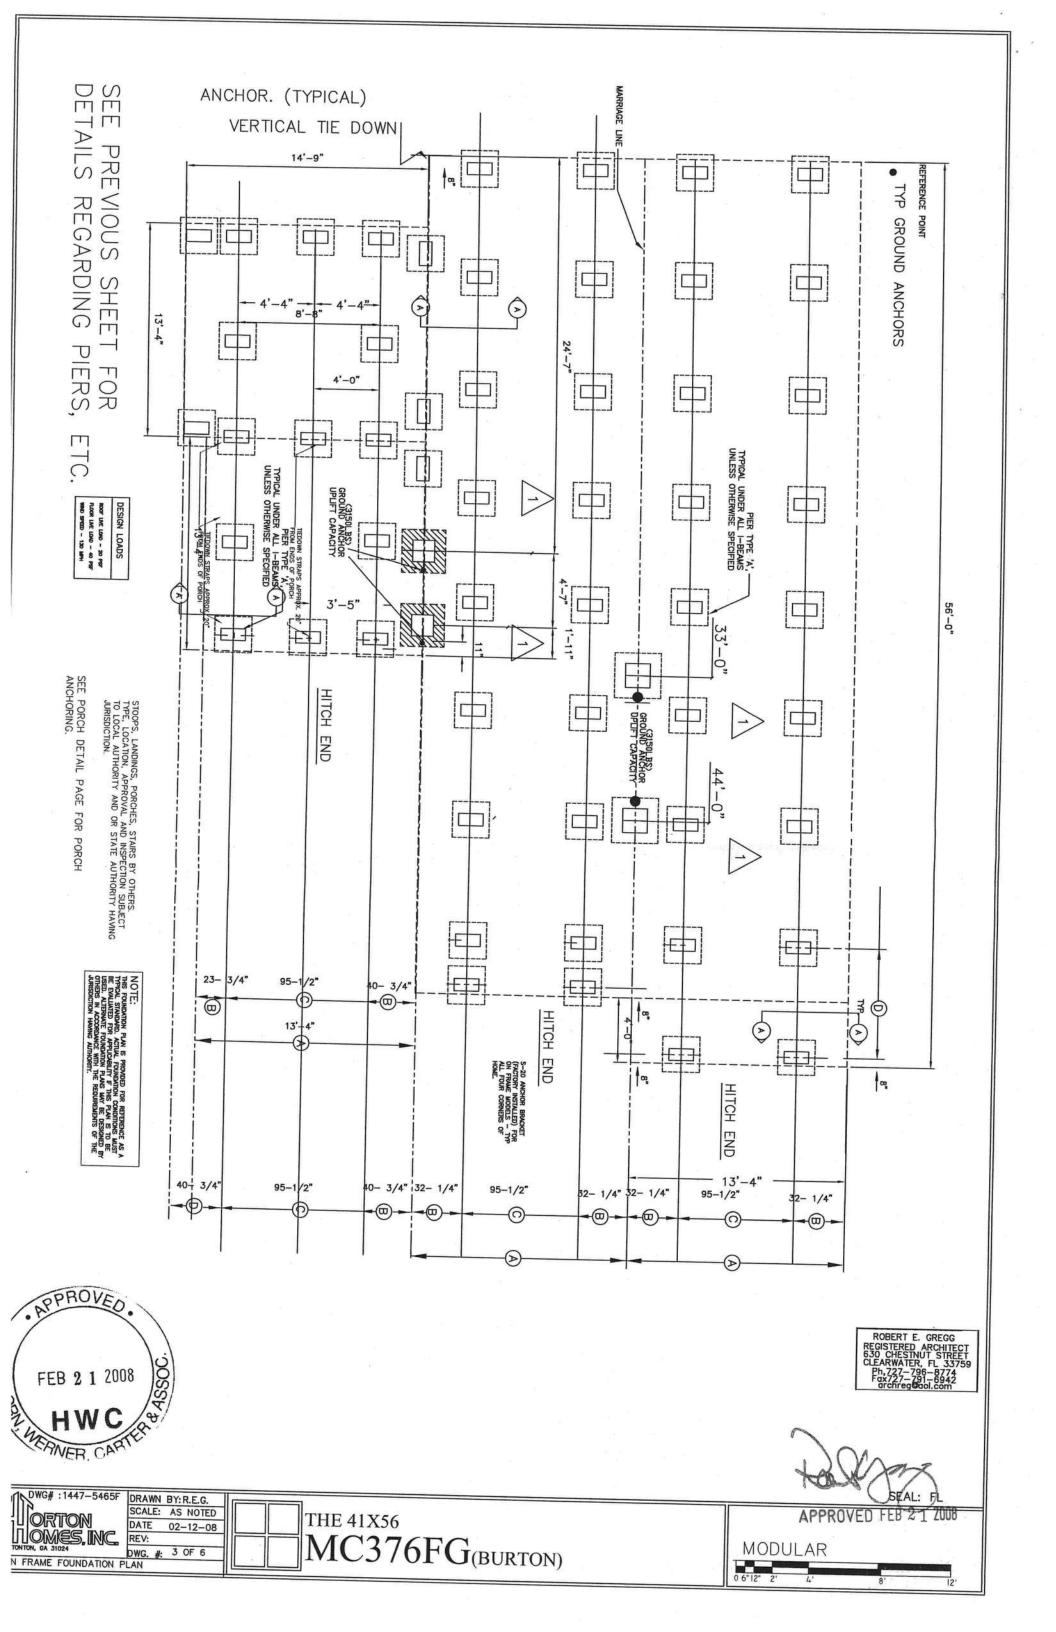

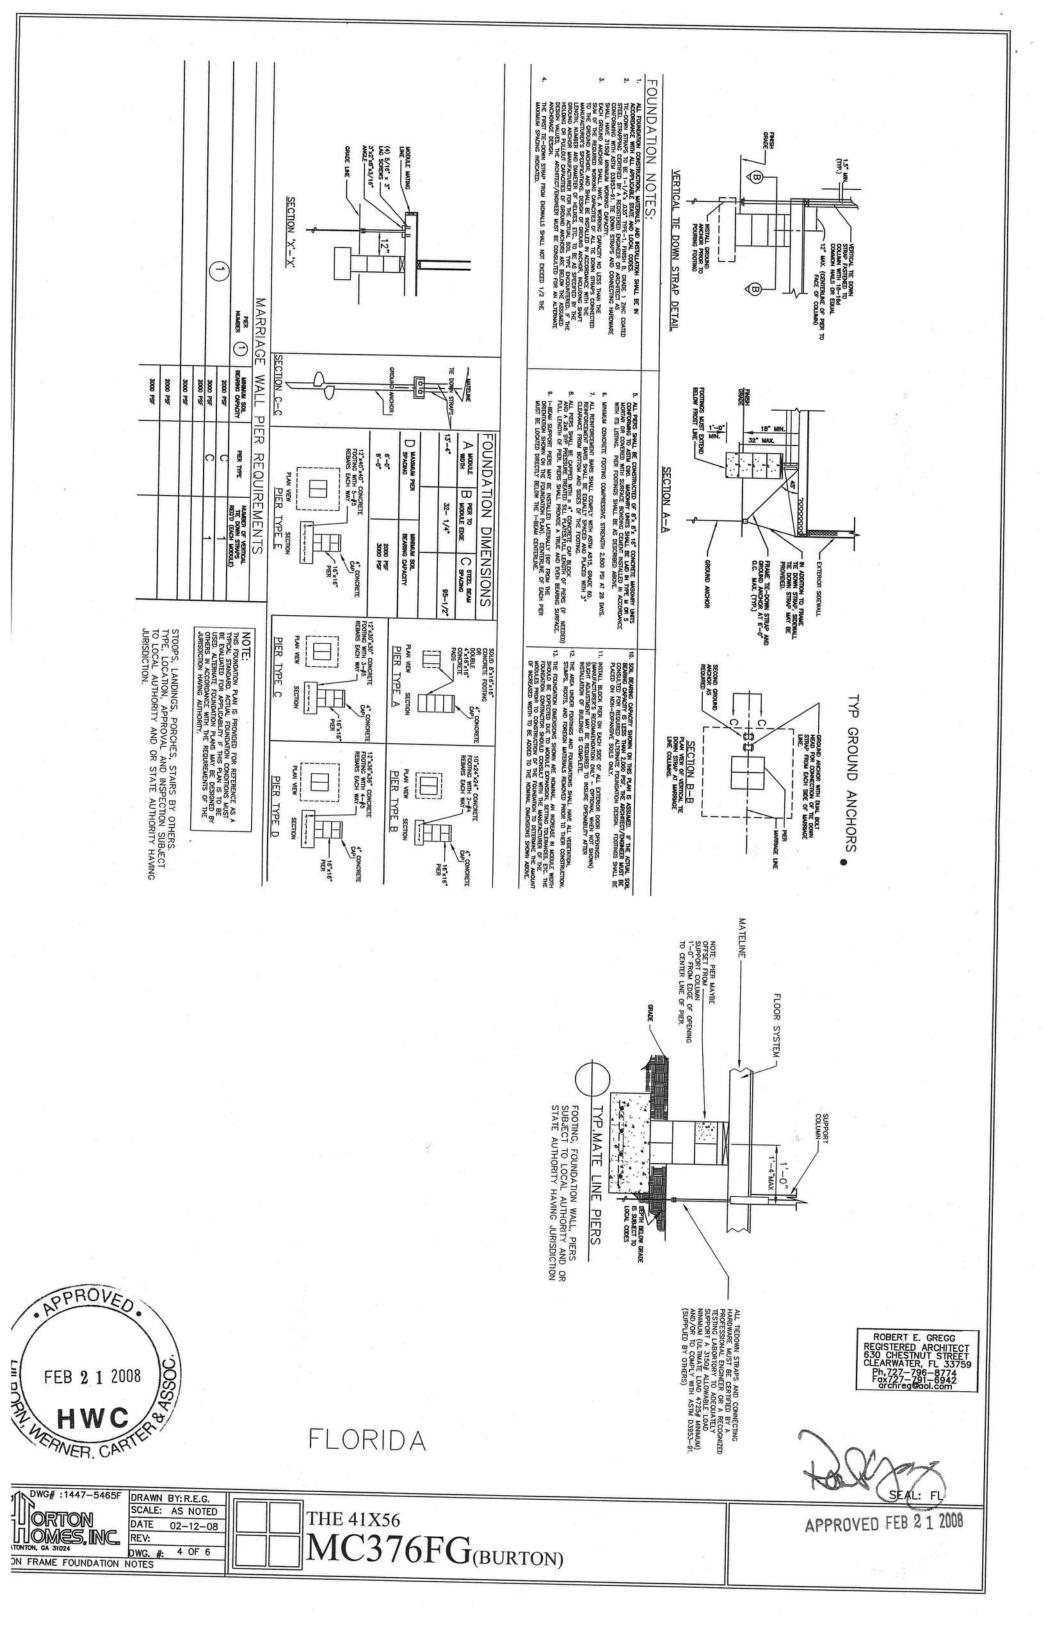

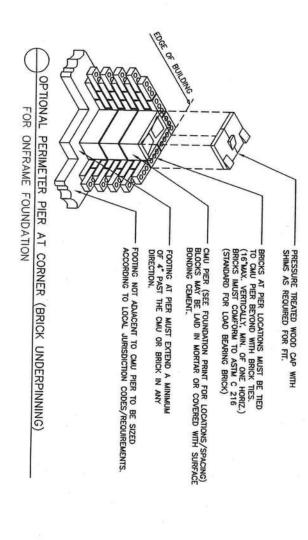

FOR ONFRAME FOUNDATION

ALL PIERS SHALL BE CAPPED WITH & 4" CONCRETE CAP BLOCK AND A 2x8 SYP PRESSURE TREATED SILL PLATES,FULL LENGTH OF PIERS FULL LENGTH OF PIER. PIERS SHALL PROVIDE A TRUE AND EVEN BEARING SURFACE. BRICKS AT PIER LOCATIONS MUST BE TIED
TO CMU PIER BEYOND WITH BRICK TIES.

(16 MAX. VERTICALLY, MIN. OF ONE HOREZ.)
BRICKS MUST COMPOR TO ASTM C 216

(STANDARD FOR LOAD BEARING BRICK)

CMU PIER (SEE FOUNDATION PRINT FOR LOCATIONS/SPACING)
BLOCKS MAY BE LAID IN MORTAR OR COVERED WITH SURFACE
BONDING AT PIER MUST EXTEND A MINIMUM
OF 4" PAST THE CMU OR BRICK IN ANY
DIRECTION.

FOOTING NOT ADJACENT TO CMU PIER TO BE SIZED
ACCORDING TO LOCAL JURISDICTION CODES/REQUIREMENTS.

ALL PIERS SHALL BE CAPPED WITH a 4" CONCRETE CAP BLOCK
AND A 2x8 SYP PRESSURE TREATED SILL PLATES, FULL LENGTH OF PIERS (IF NEEDED)
FULL LENGTH OF PIER, PIERS SHALL PROVIDE A TRUE AND EVEN BEARING SURFACE.

PRESSURE TREATED WOOD CAP WITH SHIMS AS REQUIRED FOR FIT.



ROBERT E. GREGG REGISTERED ARCHITECT 630 CHESINUT STREET CLEARWATER, FL 33759 Ph,727-796-8774 FGX77-791-6942

HO SEAL: EL

OPTIONAL PERIMETER PIER AT CORNER(BRICK UNDERPINNING)

DWG#:1447-5465F
ORTON
LOMES, INC.
ATONTON, GA 31024


DRAWN BY: R.E.G.
SCALE: AS NOTED
DATE 02-12-08
REV:
DWG. #: 5 OF 6

.G. DTED -08

THE 41X56

MC376FG(BURTON)

APPROVED FEB 2 1 2008

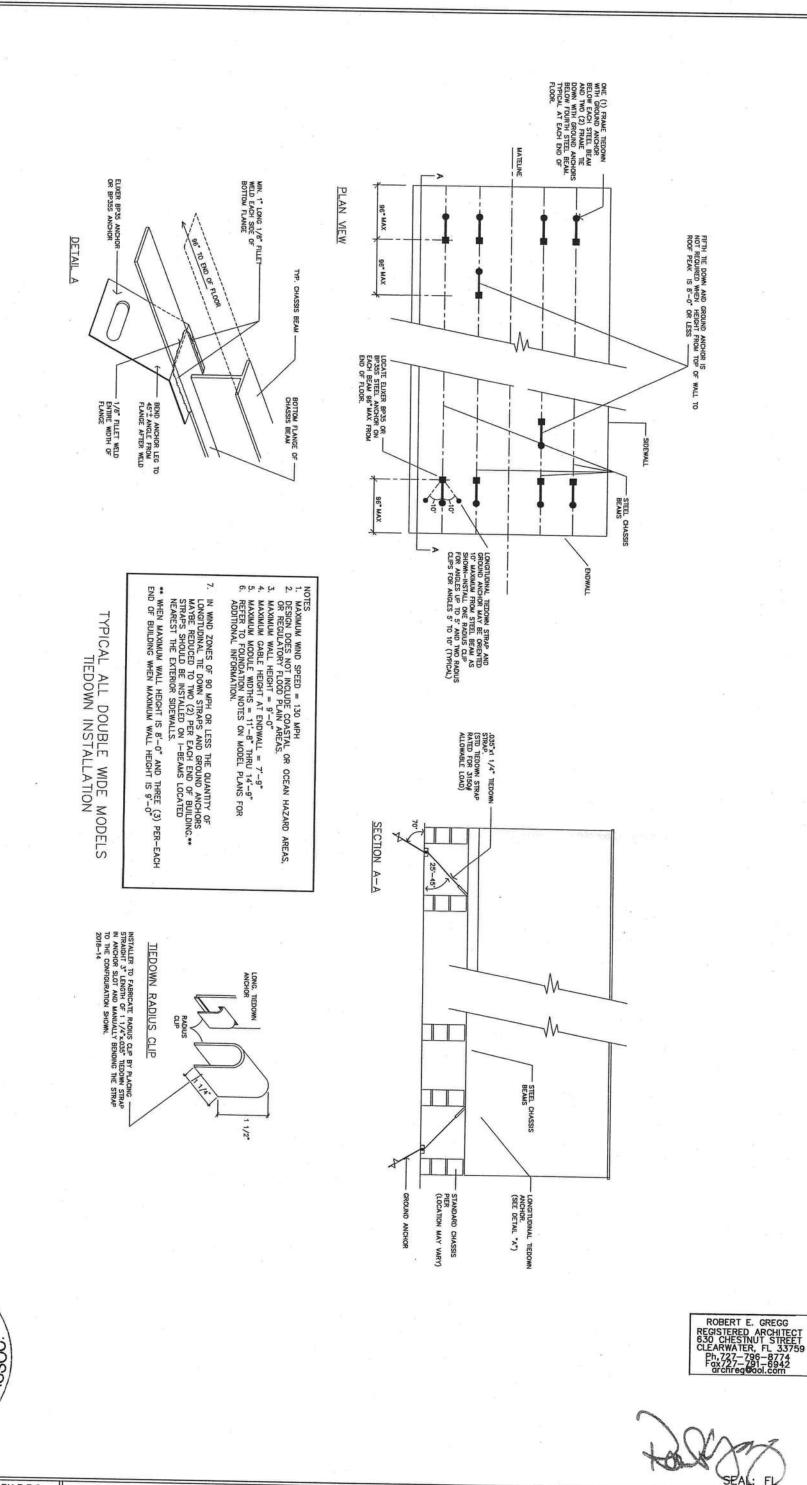

DWG#:1447-5465F DRAWN
SCALE:
DATE
REV:
DWG. #:
LONGITUDINAL FRAME TIE-DOWN

LI BORN

APPROVEO

FEB 2 1 2008

DRAWN BY: R.E.G.
SCALE: AS NOTED
DATE 02-12-08
REV:
DWG. #: 6 OF 6

THE 41X56

MC376FG(BURTON)

APPROVED FEB 2 1 2008



OCCUPANCY

COLUMBIA COUNTY, FLORIDA

partment of Building and Zonir

and premises at the below named location, and certifies that the work has been completed in accordance with the Columbia County Building Code. This Certificate of Occupancy is issued to the below named permit holder for the building

Parcel Number 13-3S-17-04947-000

Building permit No. 000026842

Use Classification MODULAR, UTILITY

Waste: 83.75

Fire:

32.10

Owner of Building WANDA & EARL GREEN

Permit Holder WILLIAM HARPER

Total: 115.85

Location: 4685 NE GUM SWAMP RD, LAKE CITY, FL

Date: 05/02/2008

10

Building Inspector

POST IN A CONSPICUOUS PLACE (Business Places Only)