





F9 STEM WALL FOOTING SCALE: 1/2" = 1'-0"

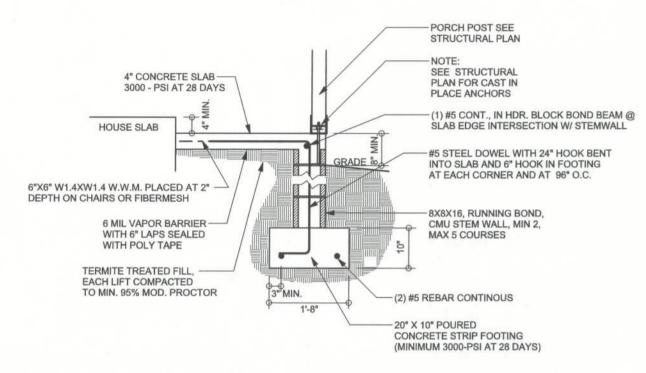

ALT. STEM WALL PORCH FOOTING SCALE: 1/2" = 1'-0"

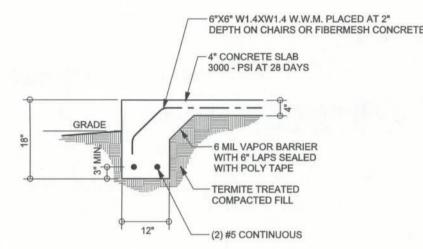

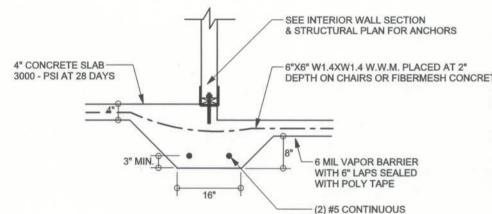

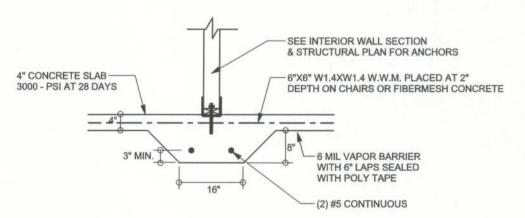


INTERIOR BEARING FOOTING SCALE: 1/2" = 1'-0"

TALL STEM WALL TABLE


The table assumes 60 ksi reinforcing bars with 6" hook in the footing and bent 24" into the reinforced slab at the top. The vertical steel is to be placed toward the tension side of the CMU wall (away from the soil pressure, within 2" of the exterior side of the wall). If the wall is over 8' high, add Durowall ladder reinforcement at 16"OC vertically or a horizontal bond beam with 1#5 continuous at mid height. For higher parts of the wall 12" CMU may be used with reinforcement as shown in the table below.

| STEMWALL HEIGHT (FEET) | UNBALANCED BACKFILL HEIGHT | VERTICAL REINFORCEMENT FOR 8" CMU STEMWALL (INCHES O.C.) | | | VERTICAL REINFORCEMENT FOR 12" CMU STEMWALL (INCHES O.C.) | | |
|------------------------------|----------------------------------|--|----|----|---|----|----|
| | | #5 | #7 | #8 | #5 | #7 | #8 |
| 3.3 | 3.0 | 96 | 96 | 96 | 96 | 96 | 96 |
| 4.0 | 3.7 | 96 | 96 | 96 | 96 | 96 | 96 |
| 4.7 | 4.3 | 88 | 96 | 96 | 96 | 96 | 96 |
| 5.3 | 5.0 | 56 | 96 | 96 | 96 | 96 | 96 |
| 6.0 | 5.7 | 40 | 80 | 96 | 80 | 96 | 96 |
| 6.7 | 6.3 | 32 | 56 | 80 | 56 | 96 | 96 |
| 7.3 | 7.0 | 24 | 40 | 56 | 40 | 80 | 96 |
| 8.0 | 7.7 | 16 | 32 | 48 | 32 | 64 | 80 |
| 8.7 | 8.3 | 8 | 24 | 32 | 24 | 48 | 64 |
| 9.3 | 9.0 | 8 | 16 | 24 | 16 | 40 | 48 |

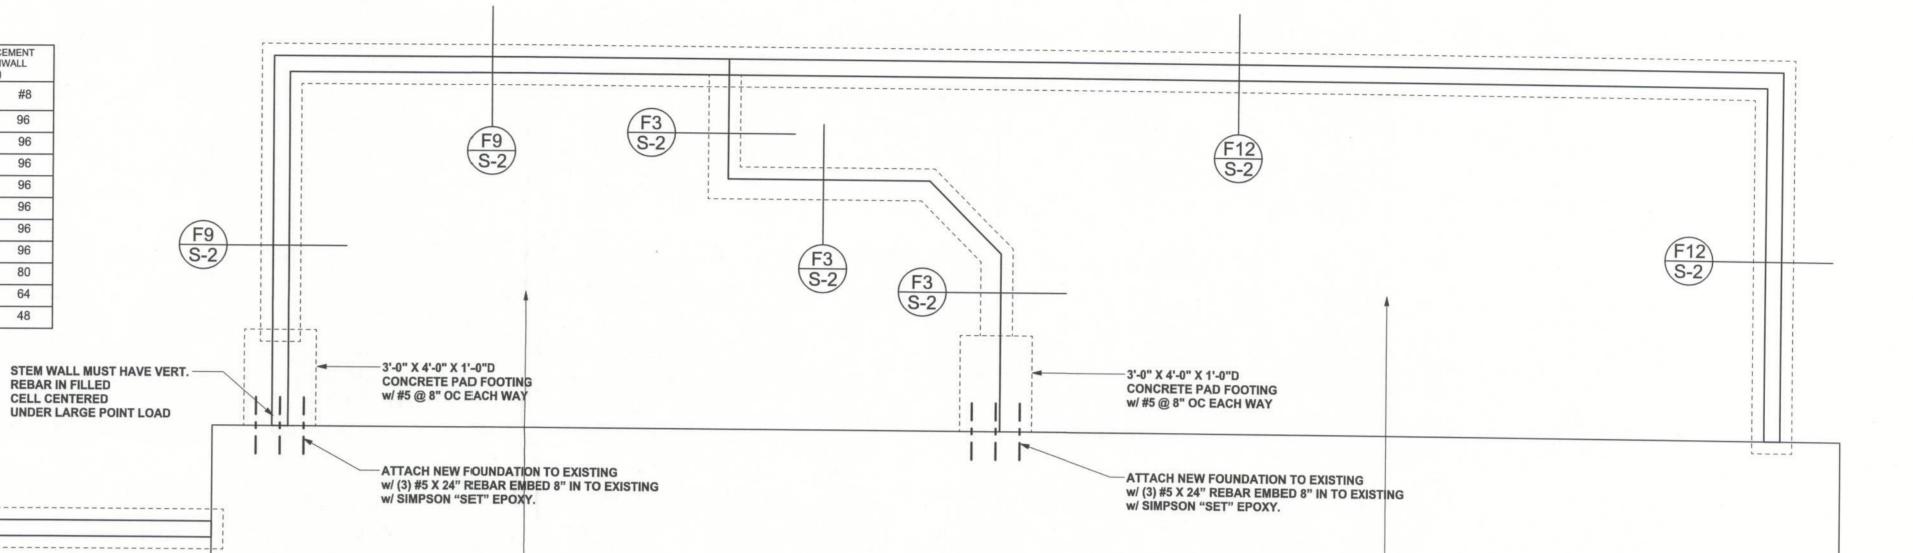


-4" CONCRETE FLOOR SLAB REINFORCED WITH-6X6-1.4/1.4 WELDED WIRE MESH PLACED ON CHAIRS AT 1 1/2" DEPTH OR FIBER MESH CONCRETE, 6-MIL POLY VAPOR BARRIER WITH 6" LAPS SEALED WITH


POLY TAPE OVER TERMITE-TREATED AND COMPACTED FILL

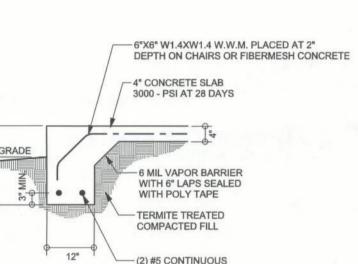




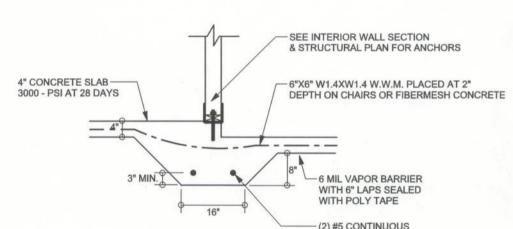



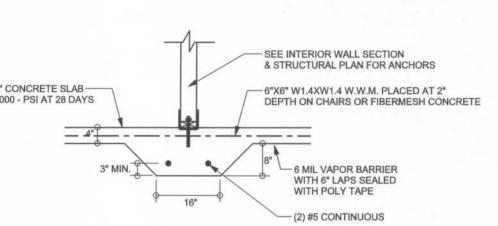

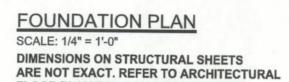

FLOOR PLAN FOR ACTUAL DIMENSIONS


WINDLOAD ENGINEER: Mark Disosway, PE No.53915, POB 868, Lake City, FL 32056, 386-754-5419 Stated dimensions supercede scaled

REVISIONS

dimensions. Refer all questions to Mark Disosway, P.E. for resolution. Do not proceed without clarification. COPYRIGHTS AND PROPERTY RIGHTS: Mark Disosway, P.E. hereby expressly reserves its common law copyrights and property right in these instruments of service. This document is

not to be reproduced, altered or copied in any form or manner without first the express writter permission and consent of Mark Disosway. CERTIFICATION: I hereby certify that I have examined this plan, and that the applicable portions of the plan, relating to wind engineering comply with section R301.2.1, florida building code residential 2007, to the best of my

LIMITATION: This design is valid for one building, at specified location.

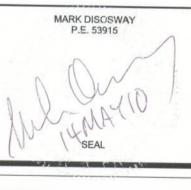

Stephen & Maria Pellicer

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PRINTED DATE: May 14, 2010 DRAWN BY: STRUCTURAL BY

FINALS DATE: 14May10

> JOB NUMBER: 1005008 DRAWING NUMBER

David Disosway

S-2 OF 3 SHEETS