

LEGEND	
SYMB	DESCRIPTION
	BUZZER (TORK TA725) WITH TRANSFORMER (TORK TA592)
	COMMERCIAL GRADE PUSH BUTTON
	125V NEMA 5-15R DUPLEX
	125V NEMA 5-15R QUAD
	125/250V NEMA L14-15-R 4-PRONG TWIST-LOCK
	DISCONNECT
	BLACK MAGIC POWER POLE
	PHONE JACK AT REGISTER
	RJ-11, RJ-45 DATA JACK, PHONE COMBO AT OFFICE
A/23	PANEL/CIRCUIT NUMBER
\$	20 AMP TOGGLE SWITCH
\$m	PROVIDE OCCUPANCY LIGHT SENSOR (LEVITON ODS10-IDW)
NL	NIGHT LIGHT CIRCUIT

ELECTRICAL SPECIFICATIONS

- ALL WIRING SHALL BE CONTAINED IN CONDUIT OF PROPER SIZE.
- ALL WIRING SHALL CONFORM TO LOCAL, STATE AND FEDERAL CODES.
- SERVICE IS TO BE A MINIMUM 400 AMP, 3 PHASE (PREFERRED), 600 AMP, 1 PHASE OR LARGER IF REQUIRED BY CODE OR ELECTRICAL LOAD.
- REQUIRED CUSTOM BUILT POWER POLE ASSEMBLIES AVAILABLE FROM D&P CUSTOM LIGHTS & PRODUCTS INC., PHONE: (800) 251-2200 OR (615) 350-7800, 7111 COCKRILL BEND INDUSTRIAL ROAD, NASHVILLE, TN 37209. SEE E3.1.
- EXTERIOR EXPOSED PHONE LINES TO BE INSTALLED IN RIGID CONDUIT. PROVIDE EMERSON 3/4" X 5-FT. METALLIC CABLE U-GUARD #755, OR EQUAL.
- ELECTRICAL PANEL TO BE LABELED CORRECTLY WITH LEGIBLE PRINT.
- LOW VOLTAGE VENDOR TO PROVIDE AND INSTALL ONE (1) 24 GA, 4 TWISTED-PAIR, CATEGORY-FIVE (CAT5) DATA CABLE WITH MODULAR COMBO RJ-11/RJ-45 JACK AT MANAGER'S OFFICE. CABLE TO BE RUN FROM JACK TO DATA HUB LOCATION WITH 6'-0" LEFT COILED FOR INSTALLATION TO DATA HUB. A RJ-45 MALE FITTING SHOULD BE CRIMPED ON THIS END. DOLLAR GENERAL STORE OPENING TEAM WILL MAKE FINAL CONNECTION INTO THE DATA HUB.
- PROVIDE 1 1/2" EMT CONDUIT TO ACT AS ACCESS SLEEVE TO ALLOW PHONE COMPANY TO TERMINATE AT DMARC. CONTRACTOR TO PROVIDE AND INSTALL PHONE WIRING & RJ-11 PHONE JACK FOR COMPLETED WORKING SYSTEM PRIOR TO PHONE COMPANY FINAL HOOK UP.
- ALL 120 VOLT OUTDOOR RECEPTACLES TO HAVE "WET LOCATION - IN USE" COVERS.
- ALL CONDUCTORS TO BE COPPER, #12 AWG MINIMUM SIZE, OR AS REQUIRED BY LOAD AND OVER CURRENT PROTECTION.
- SEE EMS SHEETS EMS1 AND EMS2 FOR ENERGY MANAGEMENT SYMBOLS AND INFORMATION.
- ELECTRICIAN TO PROVIDE 1 1/2" CONDUIT WITH PULL STRINGS FOR SATELLITE LOCATION.
- ALL POWER AND DATA TO BE ROUTED OVERHEAD, UNDER SLAB NOT ALLOWED.
- WITHIN 30 DAYS OF SYSTEM ACCEPTANCE, RECORD DRAWINGS OF THE INSTALLATION SHALL BE PROVIDED TO THE BUILDING OWNER, INCLUDING:
 - A SINGLE-LINE DIAGRAM OF THE BUILDING ELECTRICAL DISTRIBUTION SYSTEM.
 - FLOOR PLANS INDICATING LOCATION AND AREA SERVED FOR ALL DISTRIBUTION.
 - OPERATING AND MAINTENANCE MANUALS SHALL BE PROVIDED TO THE BUILDING OWNER, AND SHALL INCLUDE THE FOLLOWING AT A MINIMUM:
 - SUBMITTAL DATA STATING EQUIPMENT RATING AND SELECTED OPTIONS FOR EACH PIECE OF EQUIPMENT REQUIRING MAINTENANCE, EACH PIECE OF LIGHTING EQUIPMENT, AND ALL LIGHTING CONTROLS.
 - OPERATIONS MANUALS AND MAINTENANCE MANUALS FOR EACH PIECE OF EQUIPMENT REQUIRING MAINTENANCE AND EACH PIECE OF LIGHTING EQUIPMENT. REQUIRED ROUTINE MAINTENANCE, CLEANING, AND RELAMPING ACTIONS SHALL BE CLEARLY IDENTIFIED.
 - A NARRATIVE OF HOW EACH SYSTEM IS INTENDED TO OPERATE, INCLUDING RECOMMENDED SETPOINTS.
 - A SCHEDULE FOR INSPECTING AND RECALIBRATING ALL LIGHTING CONTROLS.
 - NAMES AND ADDRESSES OF AT LEAST ONE QUALIFIED SERVICE AGENCY.
 - A REGISTERED DESIGN PROFESSIONAL SHALL PROVIDE EVIDENCE THAT THE LIGHTING CONTROL SYSTEMS HAVE BEEN TESTED IN ACCORDANCE WITH FBC C408.3.1.1-3.1.3. DOCUMENTATION SHALL BE PROVIDED TO THE BUILDING OWNER OR AUTHORIZED AGENT WITHIN 90 DAYS OF RECEIPT OF THE CERTIFICATE OF OCCUPANCY. REPORT SHALL INCLUDE THE FOLLOWING:
 - RESULTS OF FUNCTIONAL PERFORMANCE TESTS.
 - DISPOSITION OF DEFICIENCIES FOUND DURING TESTING, INCLUDING DETAILS OF CORRECTIVE MEASURES USED OR PROPOSED.

ELECTRICAL KEYED NOTES

- CONTROL STATION FOR STAND ALONE DUCT DETECTOR, ONE FOR EACH DEVICE. SEE KEY NOTE 5 ON THIS SHEET. SIMPLEX #4098-9842 IS SPECIFIED. WITH PIEZO AND LED INDICATOR
- MECHANICAL THERMOSTAT AT 8'-0" A.F.F.
- LOCATIONS SHOWN FOR MECHANICAL UNITS ARE ONLY APPROXIMATE. CONTRACTOR MUST CONSULT MECHANICAL OR STRUCTURAL DRAWINGS TO DETERMINE ACTUAL UNIT LOCATIONS. PROVIDE 1/2" C. PENETRATION THRU ROOF WITHIN FOOTPRINT OF UNIT FOR USE WITH CONTROL WIRING TO UNIT BY OTHERS. PROVIDE PROPER WATERSEAL. (TYPICAL)
- COORDINATE CONVENIENCE OUTLET LOCATION WITH MECHANICAL.
- PHOTOELECTRIC DUCT DETECTOR WITH HOUSING. TIE TO LED READOUT RECESSED IN DUCT. STAND ALONE DEVICE, 120V. SIMPLEX #4098-9887 IS SPECIFIED WITH 4098-9842 CONTROL STATION. PROVIDE ONE DEVICE PER UNIT. MOUNT DEVICE IN SUPPLY AIR DUCTWORK. DEVICE SHALL BE PROVIDED AND WIRED TO THE CONTROL STATION BY THE ELECTRICAL CONTRACTOR. HIRE THE MECHANICAL CONTRACTOR FOR INSTALLATION IN DUCTWORK & CONNECTION TO SHUTDOWN CONTROLS. ELECTRICAL CONTRACTOR SHALL PROVIDE ALL REQUIRED RELAYS AND 120V POWER. DO NOT POWER DUCT DETECTORS FROM HVAC UNIT LOW VOLTAGE. SUBMIT SHOP DRAWINGS FOR APPROVAL. PLACE ANY REQUIRED LABELING ON CEILING TILE DIRECTLY BELOW UNIT. RUN CONDUIT & WIRE UNDERGROUND FROM UNIT TO INSIDE OF SPACE.
- THREE 2 AWG THWN CU & ONE 8 AWG CU GND IN 1-1/4" C. PROVIDE 100A/3P, NEMA 3R DISCONNECT. MOUNT DISCONNECT SWITCH AT UNIT. ALL DISCONNECTS TO BE HEAVY DUTY. FUSES TO BE RV-5 TYPE. BUSSMANN FRN-R-(AMP) IS SPECIFIED. SEE EQUIPMENT SCHEDULE ON E3.
- PROVIDE 208V, 1 PHASE CONNECTION TO A J-BOX AT 100" AFF WITH (3)#12 CU. & #12 GROUND IN 3/4" C. REFRIGERATION CONTRACTOR TO PROVIDE AND INSTALL 30A/2NF DISCONNECT SWITCH AND WIRE FROM DISCONNECT SWITCH TO EQUIPMENT CONNECTIONS.
- PROVIDE 208V, 1 PHASE CONNECTION TO A J-BOX AT 100" AFF WITH (3)#8 CU. & #10 GROUND IN 1" C. REFRIGERATION CONTRACTOR TO PROVIDE AND INSTALL 60A/2NF DISCONNECT SWITCH AND WIRE FROM DISCONNECT SWITCH TO EQUIPMENT CONNECTIONS.
- PROVIDE 208V, 1 PHASE CONNECTION TO A J-BOX AT 100" AFF WITH (3)#10 CU. & #10 GROUND IN 3/4" C. REFRIGERATION CONTRACTOR TO PROVIDE AND INSTALL 30A/2NF DISCONNECT SWITCH AND WIRE FROM DISCONNECT SWITCH TO EQUIPMENT CONNECTIONS.
- MOUNT J-BOX 11" FROM THE RIGHT SIDE OF EACH UNIT. CONFIRM EXACT LOCATION WITH REFRIGERATION VENDOR PRIOR TO WORK (TYPICAL).
- SO WHITE ELECTRICAL CORD IS NEEDED. SEE SHEET A1, NOTE 26.
- CONFIRM THE FINAL NUMBER AND LOCATION OF OUTLETS IN SALES AREA WITH THE FINAL DG FUTURE PLAN.

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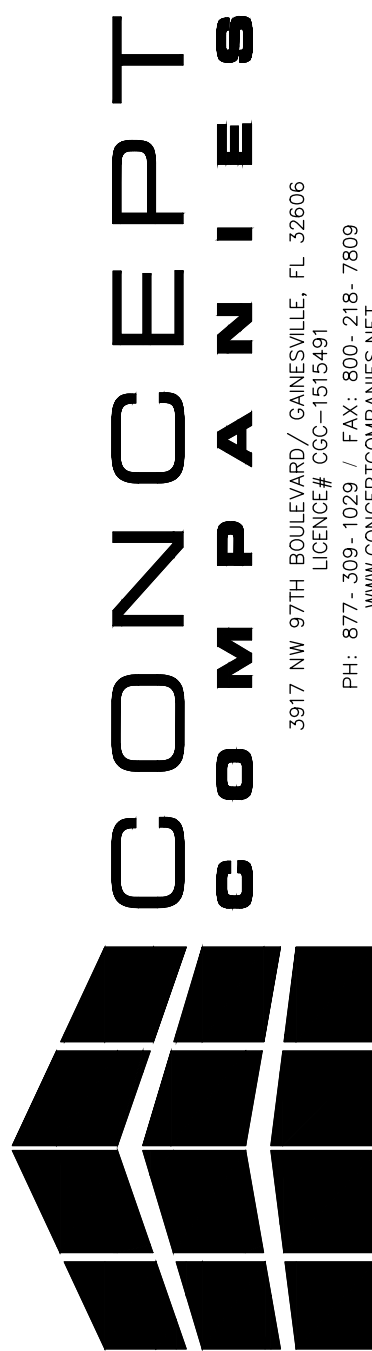


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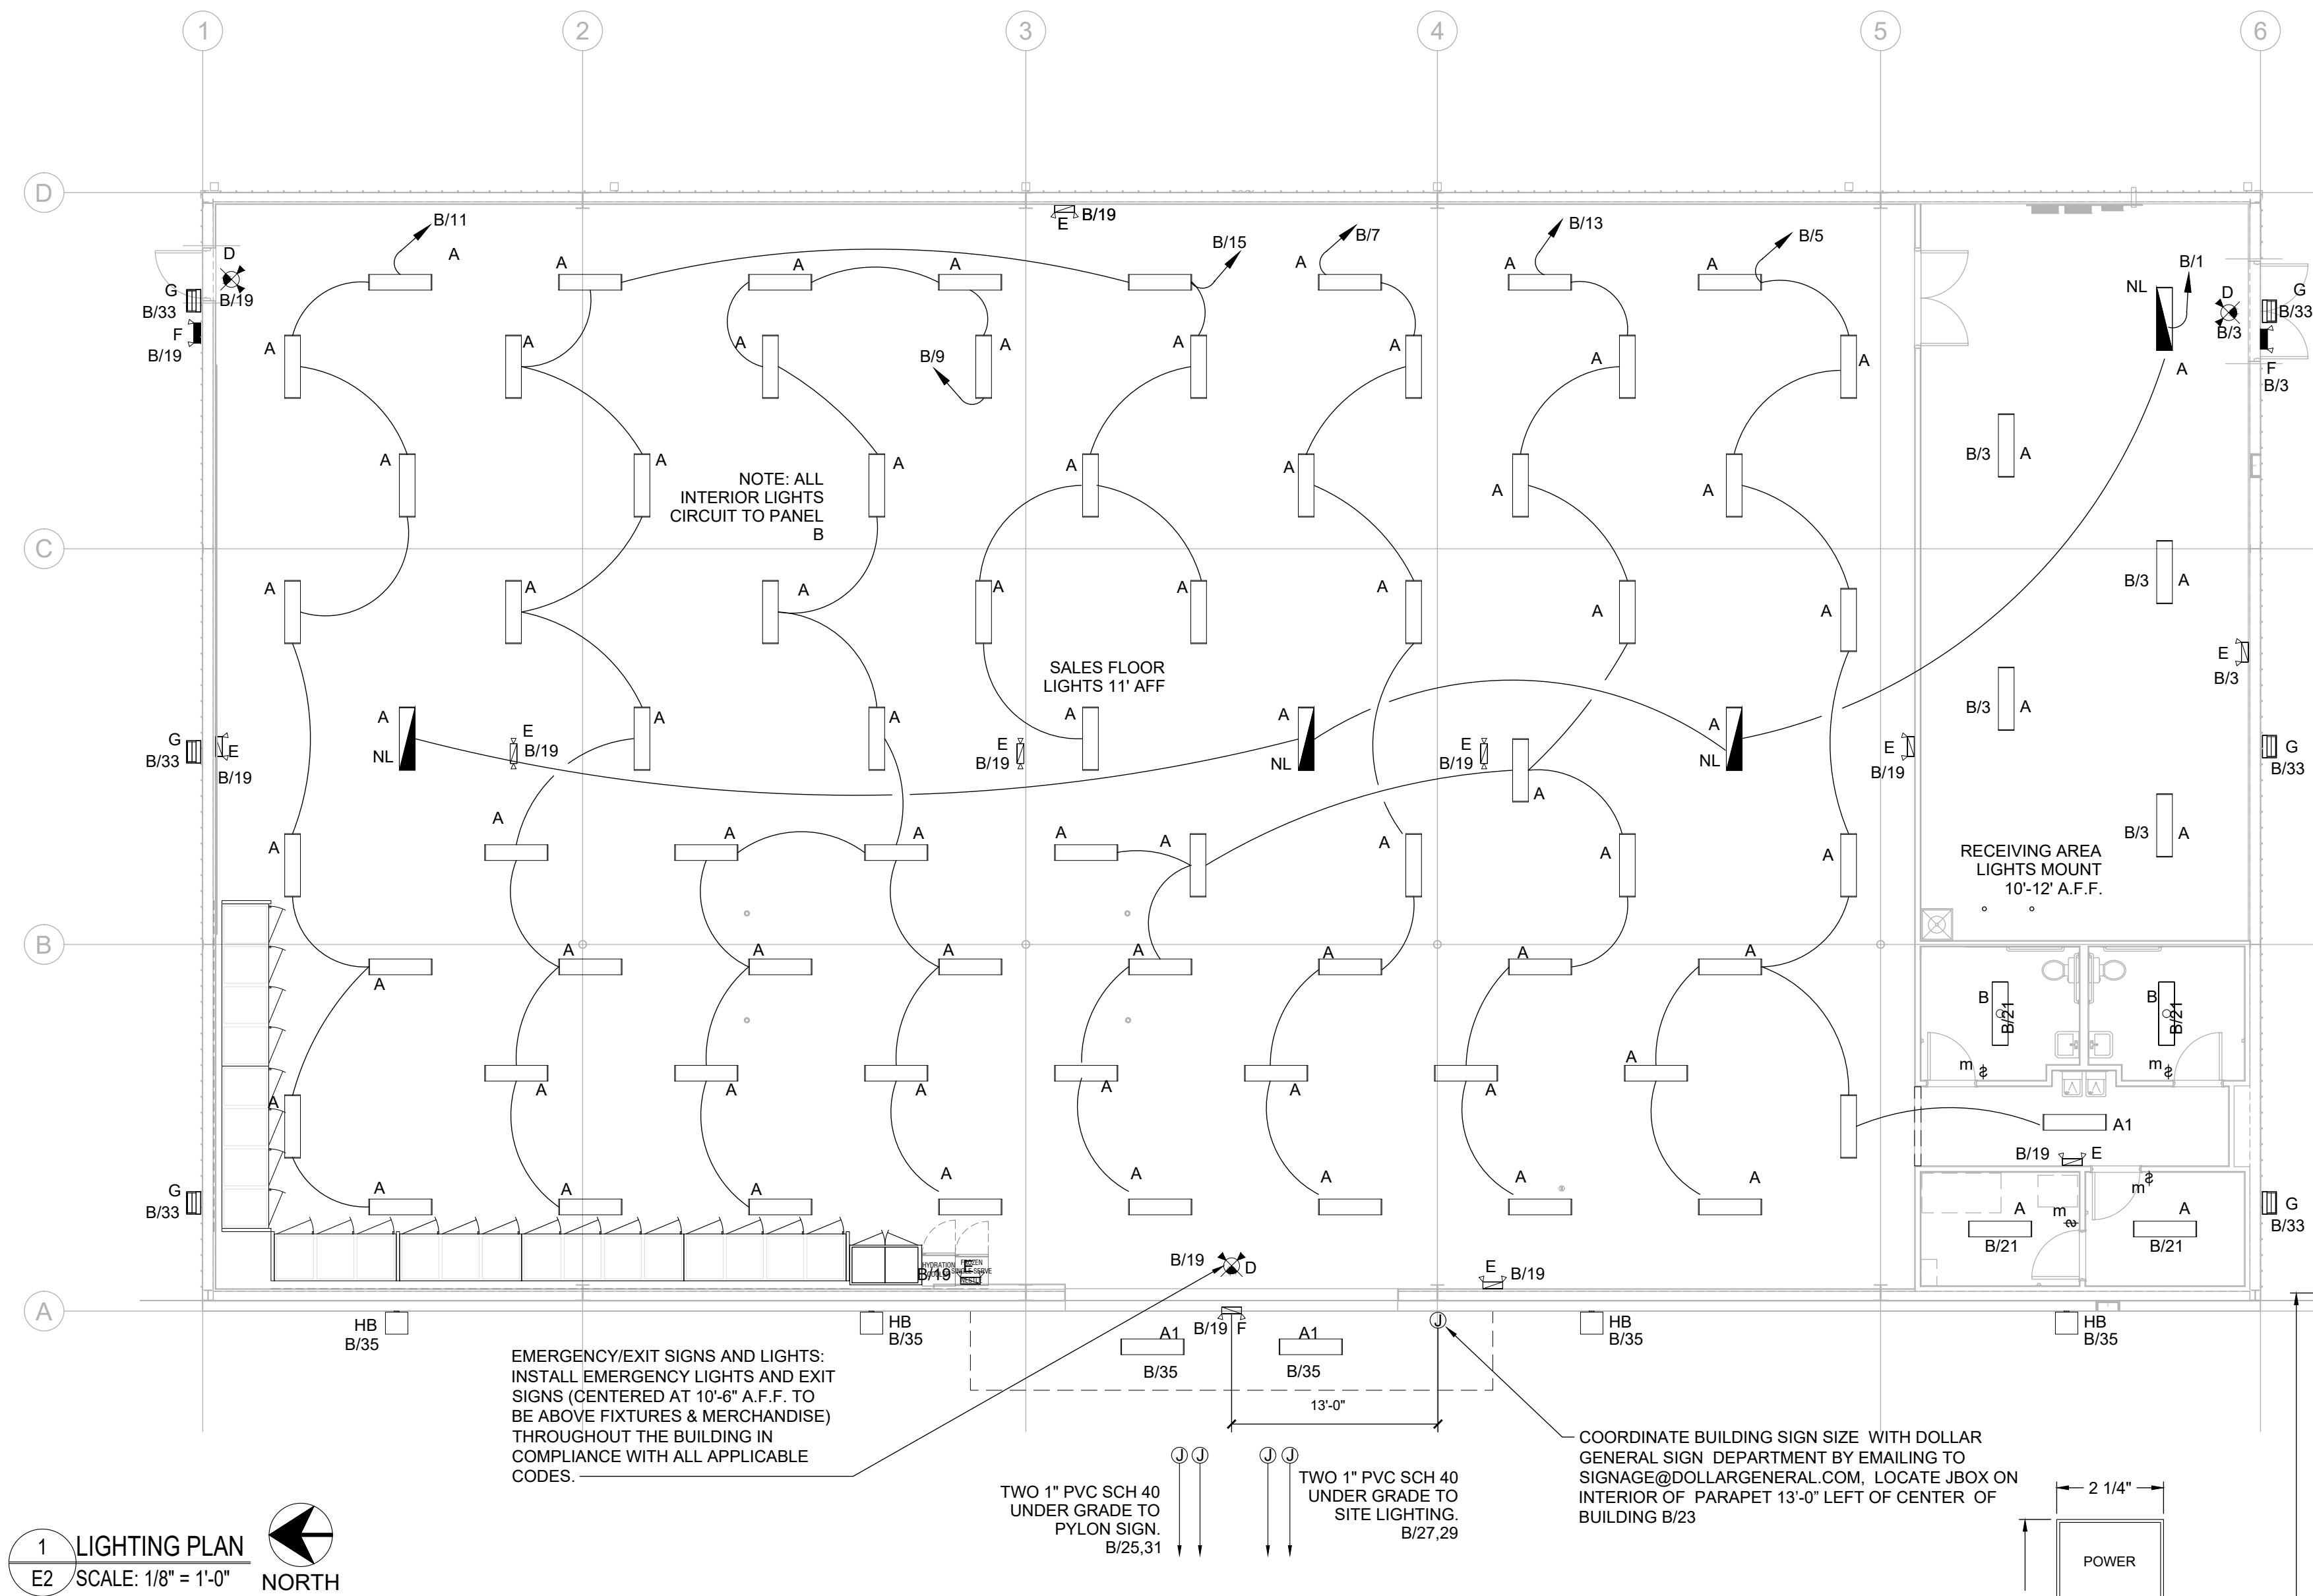


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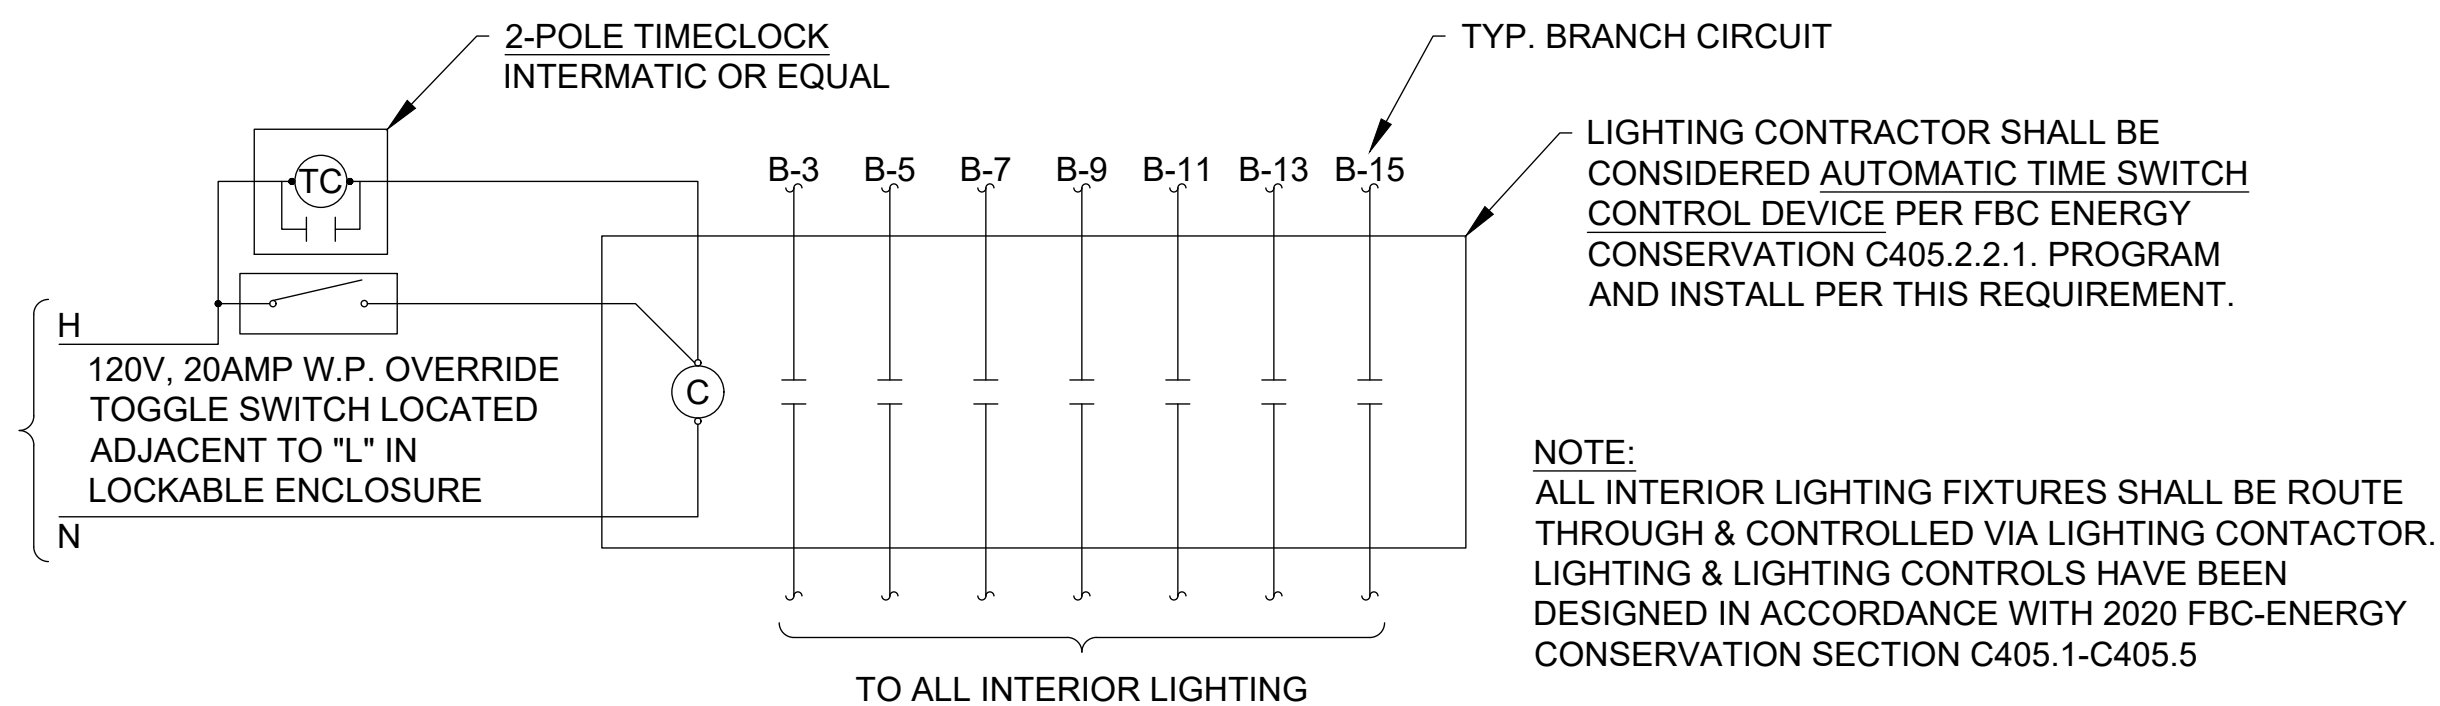


DRAWING DATE / DRAWN BY: 1/12/2021 - KWH
REVISION DATE / REVISED BY:
PROJECT NUMBER: 4000.207
DRAWING TITLE: POWER PLAN
SHEET NO.

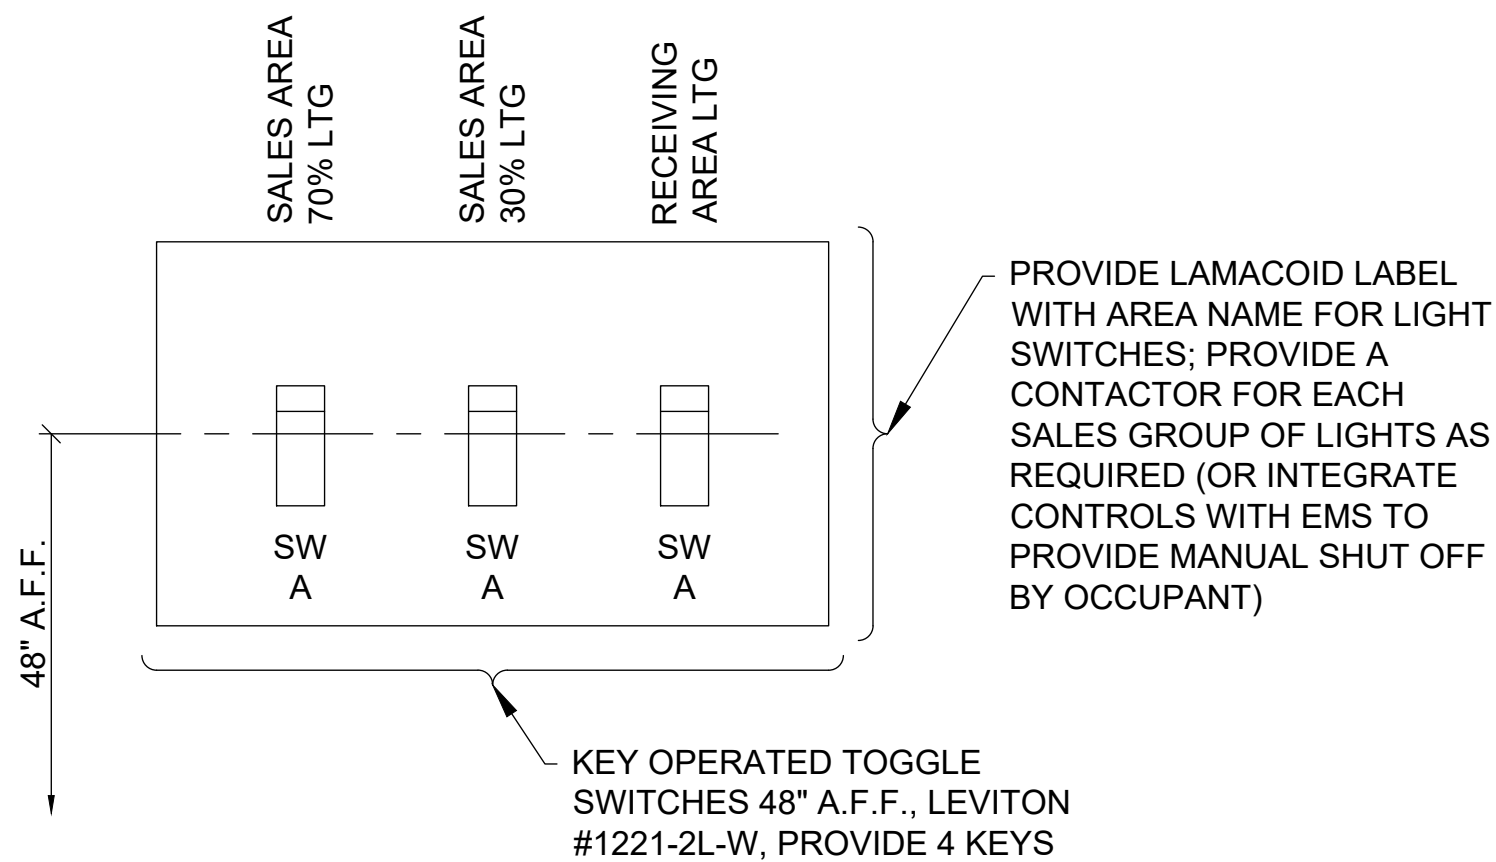
E1






1 LIGHTING PLAN
E2 SCALE: 1/8" = 1'-0" NORTH




4 INTERIOR LIGHTING CONTROL DIAGRAM "LC-1"
E2 SCALE: N.T.S.



5 SWITCH BANK DETAIL
E2 SCALE: N.T.S.

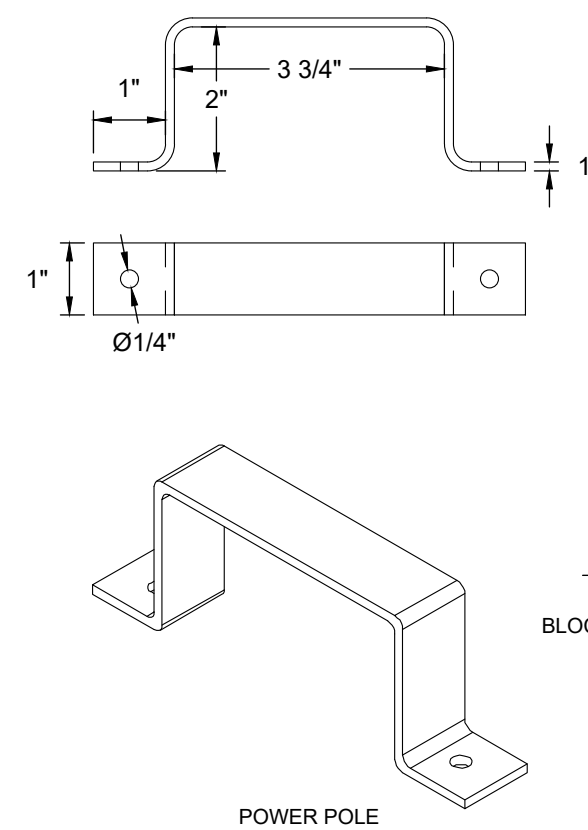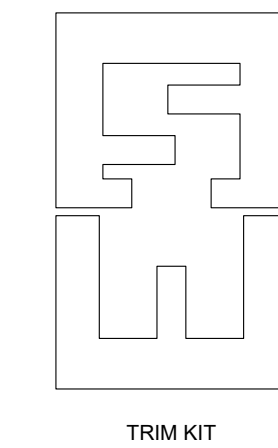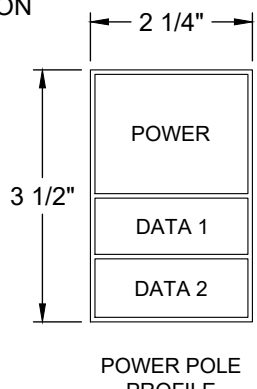

3 REGISTER POWER POLE
E2 SCALE: N.T.S.

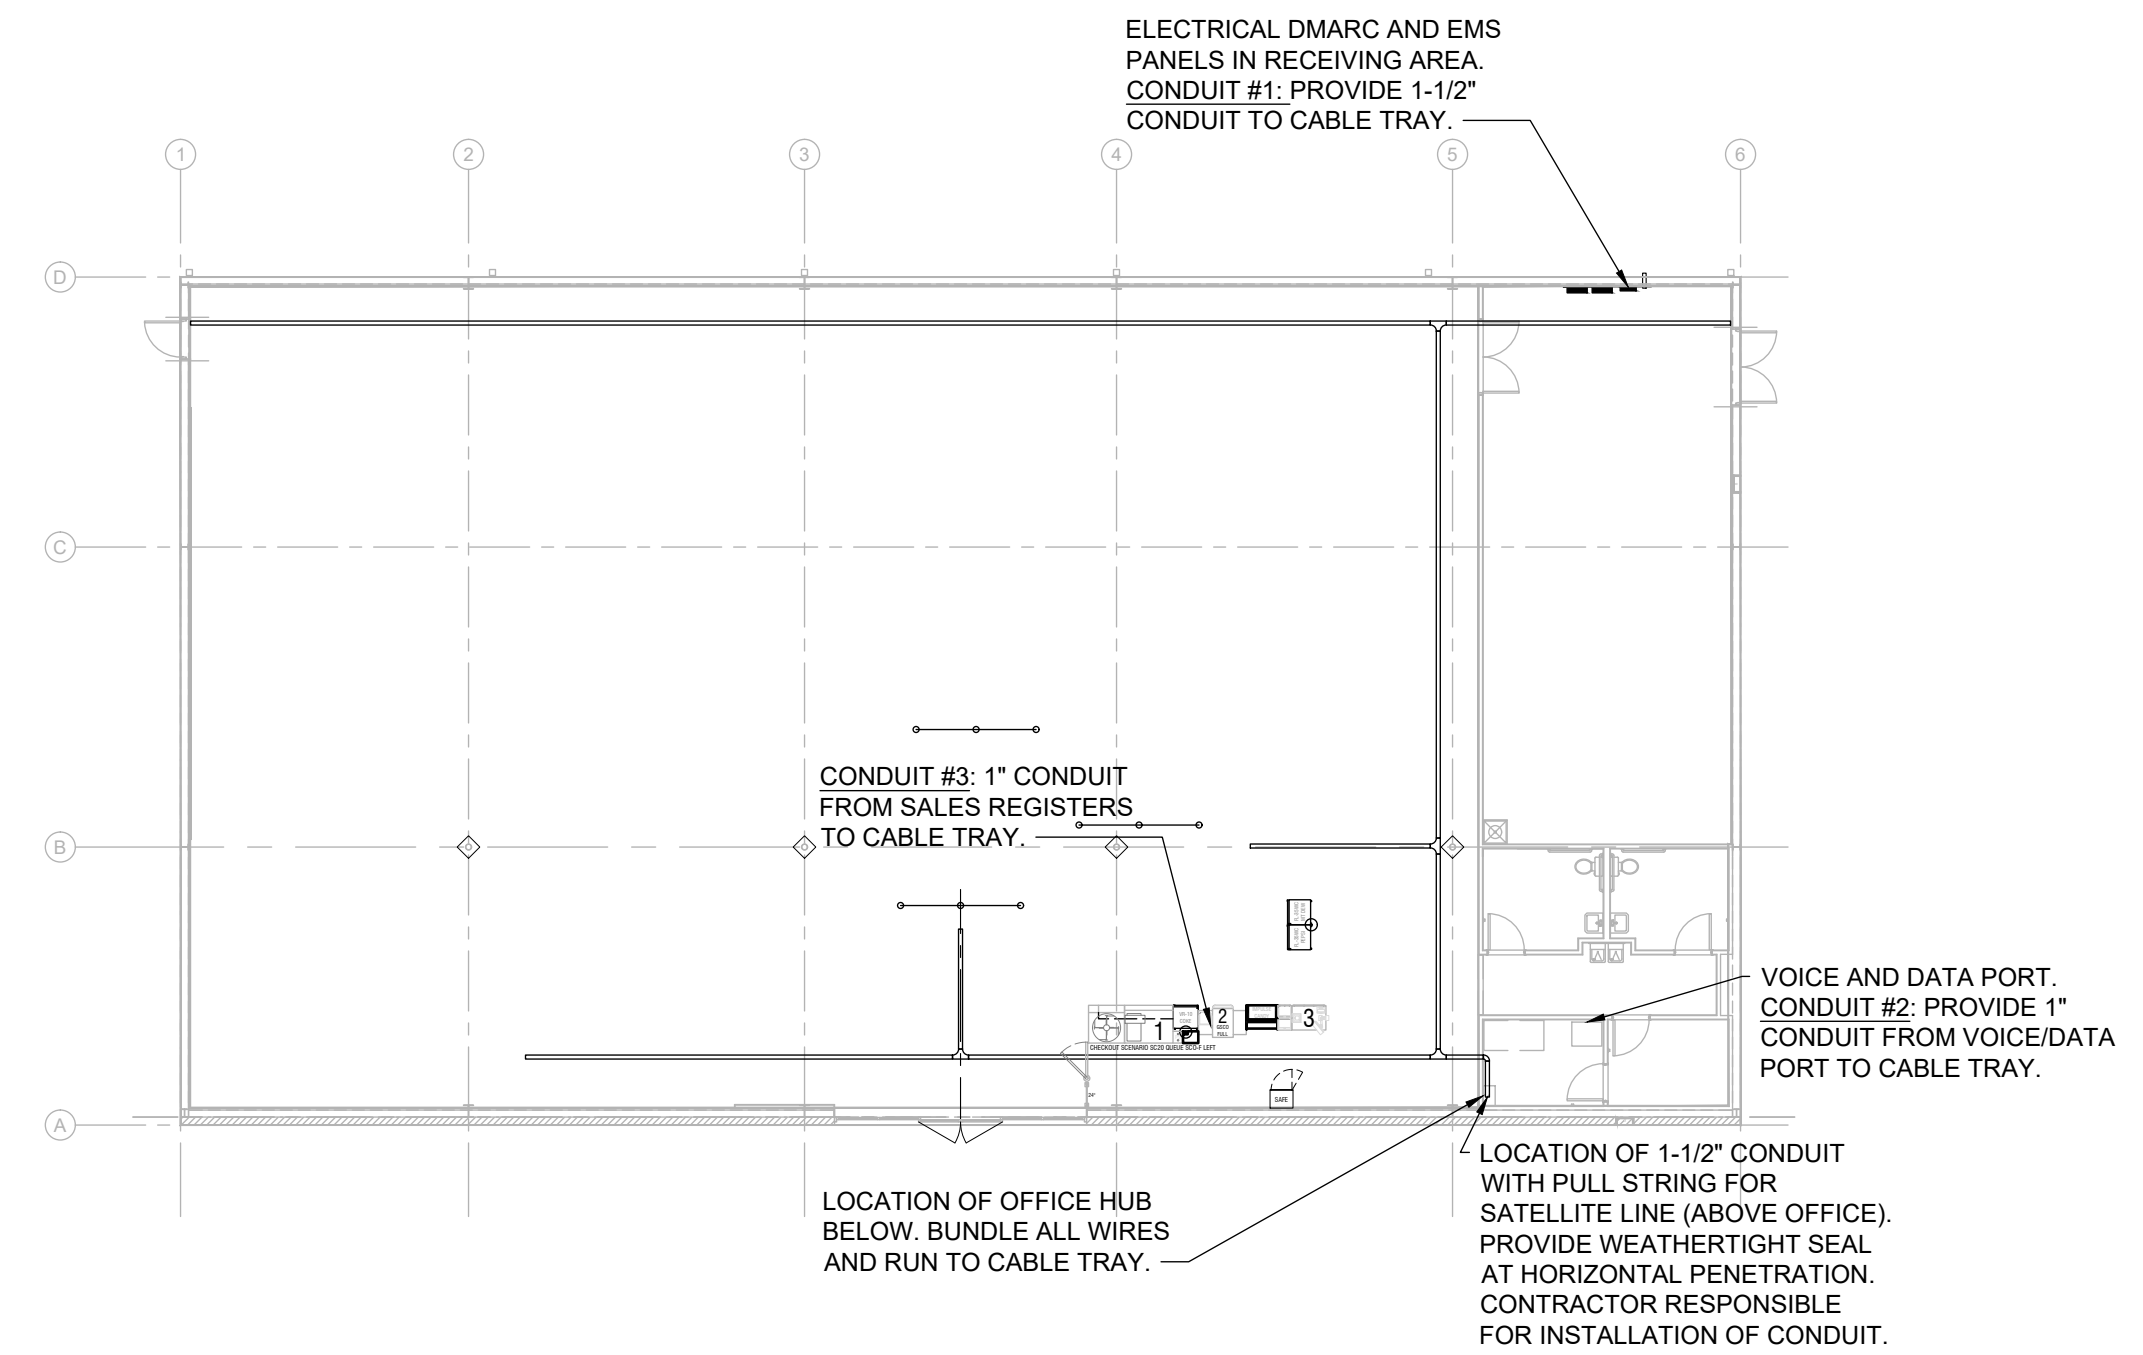

2 CABLE TRAY & CONDUIT DIAGRAM
E2 SCALE: N.T.S.

LEDS LIGHT FIXTURE SCHEDULE					
SYMBOL	TYPE	MANF.	PART #	DESCRIPTION	W
	A	LEDS	ST5000	4' LED FIXTURE AERIAL MOUNT INCLUDES (2) 8 FT CABLES	33
	A-NL	ETI	54583361	4' BBU COMPATIBLE LED FIXTURE	45
	A1	ETI	54573161	4' LED FIXTURE SURFACE MOUNT	45
	B	LEDS	ST2000	2' LED FIXTURE SURFACE MOUNT	20
	C	ETI	55301101	LED EXIT SIGN	-
	D	LEDS	EM2505	LED EXIT SIGN / EMERGENCY LIGHT COMBO WITH (2) HEADS	-
	E	LEDS	EL2500	LED EMERGENCY LIGHT WITH (2) HEADS	-
	F2	LEDS	EL2502	LED EGRESS EMERGENCY LIGHT WITH (2) HEADS	-
	G	LEDS	WP4250	LED WALL PACK	36
	HB	LEDS	AL1210	LED AREA LIGHT MOUNTED ON WALL	174
	HP/U	LEDS	AL1210/LEDS-POLE-DM490	LED AREA LIGHT ON 25' POLE & CONCRETE POLE BASE PER DETAIL	150

NOTE: REFER TO SHEET "T01" FOR NATIONAL ACCOUNT VENDORS LIST

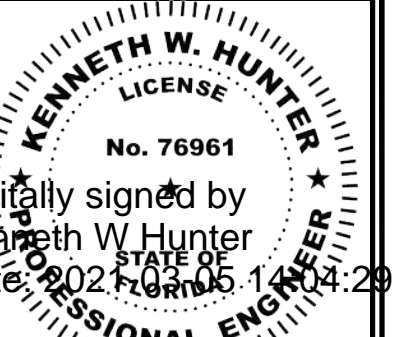
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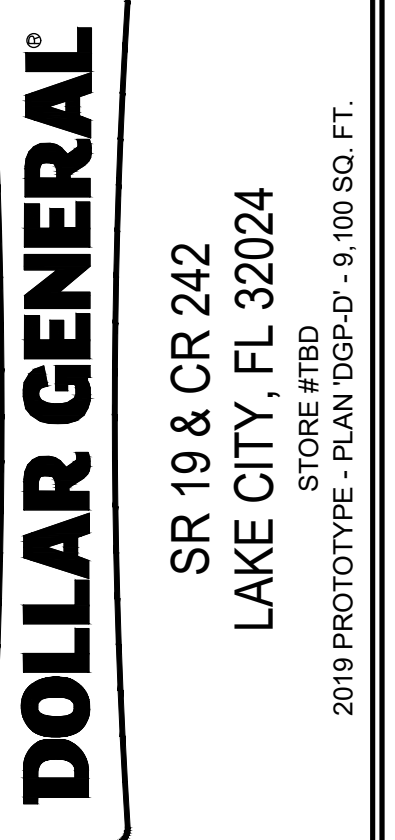
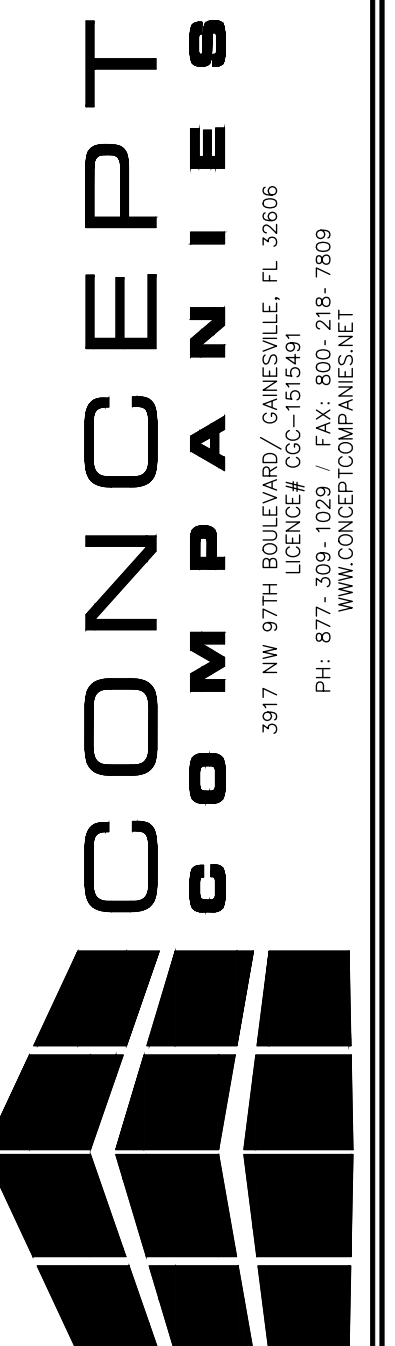


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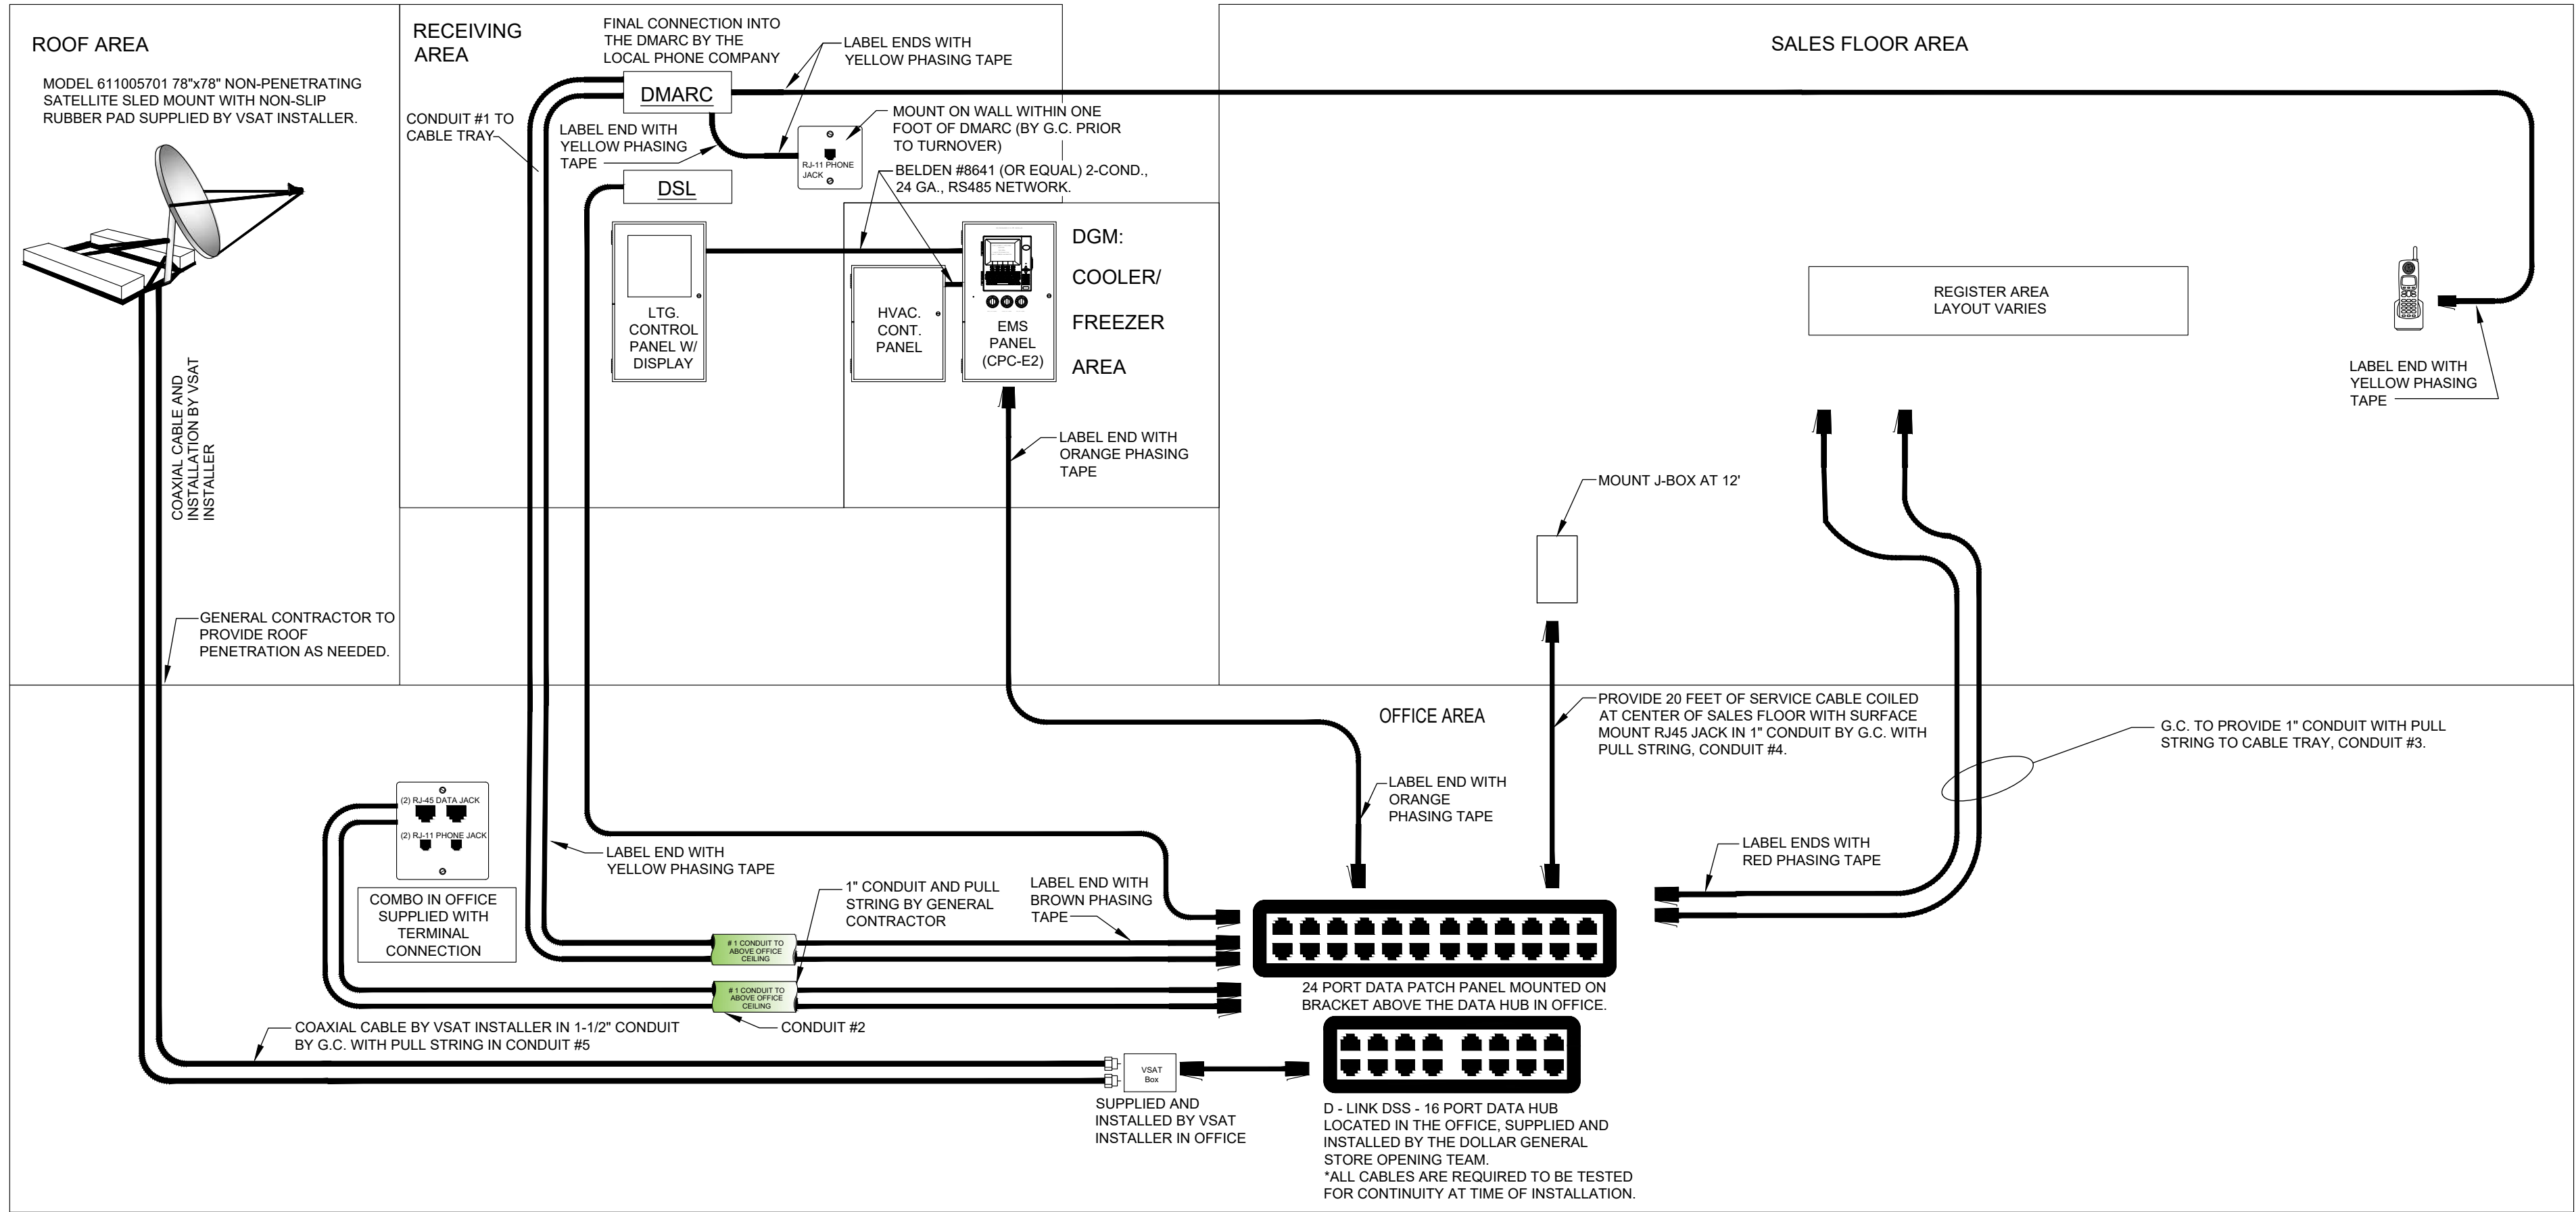


DRAWING DATE: / DRAWN BY:
3/5/2021 - KWH
REVISION DATE: / REVISED BY:
PROJECT NUMBER:
4000.213
DRAWING TITLE:
LIGHTING PLAN
SHEET NO.

E2

NOTES	MOUNT: SURFACE						120/208						3-PHASE, 4W						PANEL A						CAPACITY: 400A						INT CAP: 200KA						NOTES	
	LOCATION: BACK OF BLDG.						LUGS:						MCB						DEMAND LOAD: 275A						AV. FAULT: 40 KA													
	CKT	LTG	REC	HVAC	MISC	NP	DESCRIPTION	AMP	POLE	Φ	AMP	POLE	DESCRIPTION	LTG	REC	HVAC	MISC	NP	CKT																			
	1			12.3			RTU 1	150	3		A	20	1	AUTOMATIC DOOR				0.1		2						0.4										C		
	3			12.3						B	20	1	PHONE BOARD/BUZZER								0.4		4						0.4									C
	5			12.3						C	20	1	ENERGY MANAGEMENT								0.2		6						0.2									C
	7			12.3			RTU 2	150	3		A	20	1	COOLER				0.7		8						0.7										C		
	9			12.3						B	20	1	OUTDOOR HVAC REC							0.4		10						0.4										C
	11			12.3						C	20	1	OUTDOOR DRINK VEND							0.2		12						0.2										
	13						SPARE	20	1	A	20	2	FREEZER					1.0		14						1.0										C		
	15						SPARE	20	1	B	20	2						1.0		16						1.0										C		
	17						SPARE	20	1	C	20	1	INTERFACE EQUIP					0.5		18						0.5											C	
C	19				1.7		SPARE	20	1	A	20	1	VSAT SATE HUB EQUIP					0.5		20						0.5											C	
C	21				1.7		WATER HEATER	20	1	B	20	1	CCTV EQUIP					1.0		22						1.0											C	
C	23				0.2		DRINKING FOUNTAIN	20	1	C	20	1	SECURITY REC					0.2		24						0.2											C	
C	25			0.2			OUTDOOR ICE REC	20	1	A	20	1	OFFICE REC					0.9		26						0.9											C	
C	27				1.3		COOLER	15	2	C	20	2	BREAK ROOM REC					0.5		28						0.5											C	
C	29				1.3													1.7		30						1.7											C	
C	31				1.3		COOLER	15	2	A	20	2	PRODUCE COOLER					1.7		32						1.7											C	
C	33				1.3						B	20	1	ICE CREAM FREEZER				0.2		34						0.2											C	
C	35				1.3		COOLER	15	2	C	20	1	GATORADE					0.8		36						0.8											C	
C	37				1.3						A	20	1	SPARE						38																	C	
C	39				1.6		SODA COOLERS	20	1	B	20	1	SPARE							40																	C	
C	41						SPARE	20	1	C	20	1	SPARE							42																	C	
NOTES:																																						
A. AIC RATING: SERIES RATED AT 200,000 AMPS WITH BUSSMANN JNN FUSES.																																						
B. BREAKERS FOR HVAC UNITS SHALL BE SIZED PER MANUFACTURER REQUIREMENTS.																																						
C. BREAKER LOCK.																																						
D. ISOLATED GROUND BUS.																																						

NOTES	MOUNT: SURFACE						120/208		3-PHASE, 4W		PANEL B				CAPACITY: 200A						INT CAP: 200KA						NOTES				
	LOCATION: BACK OF BLDG.						LUGS:				MCB		DEMAND LOAD: 146A						AV. FAULT: 40KA												
	CKT	LTG	REC	HVAC	MISC	NP	DESCRIPTION	AMP	POLE	Φ	AMP	POLE	DESCRIPTION	LTG	REC	HVAC	MISC	NP	CKT												
B,C	1	0.2					NIGHT LTS	20	1	A	20	1	PWR TERM BROWN					1.2		2	C										
B,C	3	0.2					RECEIVING LTS	20	1	B	20	1	PWR TERM BROWN					1.2		4	C										
B	5	0.5					70% SALES LTS	20	1	C	20	1	PWR TERM GREEN					1.2		6	C										
B	7	0.5					70% SALES LTS	20	1	A	20	1	PWR TERM GREEN					1.2		8	C										
B	9	0.8					70% SALES LTS	20	1	B	20	1	PWR TERM GREEN					1.6		10	C										
B	11	0.4					70% SALES LTS	20	1	C	20	1	PWR TERM GREEN					1.6		12	C										
B	13	0.3					30% SALES LTS	20	1	A	20	1	COOLER					0.7		14	C										
B	15	0.5					30% SALES LTS	20	1	B	20	2	FREEZER					1.0		16	C										
	17						SPARE	20	1	C	20	2						0.6		18	C										
C	19	0.1					EMERGENCY/EXIT LTS	20	1	A	20	1	DRINK COOLERS					1.6		20											
C	21	0.2		0.1			BREAK/OFFICE LTS/EF'S	20	1	B	40	2	FREEZER					3.9		22											
B	23	1.2					BUILDING SIGN	20	1	C	40	2						3.9		24	C										
B	25	0.9					PYLON SIGN	20	1	A	40	2	FREEZER					3.2		26											
B	27	0.4					SITE LIGHTING	20	1	B	40	2						3.2		28	C										
B	29	0.4					SITE LIGHTING	20	1	C	40	2	FREEZER					3.2		30	C										
B	31	0.9					PYLON SIGN	20	1	A	40	2						3.2		32	C										
B	33	0.2					EXTERIOR LTS	20	1	B	20	1	SODA COOLERS					1.6		34	C										
B	35	0.9					FRNT WALL/CANPY LGT	20	1	C	25	2	FREEZER					2.6		36											
	37						SPARE	20	1	A								2.6		38	C										
	39						SPARE	20	1	B								1.3		40											
	41						SPARE	20	1	C	15	2	COOLER					1.3		42	C										
																				DEMAND FORMULA				TOTAL LOAD							
PHASE BALANCE			LOAD TYPE			CONNECTED		DEMAND		DEMAND FORMULA										CONNECTED		DEMAND									
Φ	LOAD	%	RECEPTACLE			8.6 KVA		10.7 KVA		LOAD X 125% NEC 210.19 CONTINUOUS										50.5 KVA		52.7 KVA									
A	16.6 KVA	33%	HVAC			0.1 KVA		0.0 KVA		10KVA + 50% REMAINDER NEC 220.44										140.3A		146.1A									
B	16.2 KVA	32%	MISC			41.9 KVA		41.9 KVA		LOAD X 80% (USED MCA IN CALCULATION)																					
C	17.7 KVA	35%	NP			0.0 KVA		0.0 KVA		LOAD X 100% NEC 210.19 NON-CONT.												FILENAME:									
																				0 NONCOINCIDENTAL LOADS NEC 220.60				#VALUE!							
NOTES:																															
A. AIC RATING: SERIES RATED AT 200,000 AMPS WITH BUSSMANN J2N FUSES.																															
B. ROUTING TO THE EMS PANEL.																															
C. BREAKER LOCK.																															
D. ISOLATED GROUND BUS.																															



CONDUIT NUMBER	START	END	SIZE	CONDUIT RESPONSIBILITY	*CABLING RESPONSIBILITY
1	RECEIVING AREA	CABLE TRAY	1-1/2"	GENERAL CONTRACTOR	LOW VOLTAGE VENDOR
2	OFFICE VOICE / DATA PORT	OFFICE (HUB)	1"	GENERAL CONTRACTOR	LOW VOLTAGE VENDOR
3	OFFICE (HUB)	CABLE TRAY	1"	GENERAL CONTRACTOR	LOW VOLTAGE VENDOR
4	CENTER OF SALES FLOOR CONNECTION	OFFICE (HUB)	1"	GENERAL CONTRACTOR	LOW VOLTAGE VENDOR
5	SATELITE	OFFICE (HUB)	1-1/2"	GENERAL CONTRACTOR	LOW VOLTAGE VENDOR

*UNLESS OTHERWISE NOTED, ALL RESPONSIBILITIES SHOULD FOLLOW THIS CHART.

ALL CABLES AT THE OFFICE WILL NEED TO BE WRAPPED IN PHASING TAPE CONSISTENT WITH THE FOLLOWING COLORS:


RED TAPE CASH REGISTER DATA
BLUE TAPE ELEC. EMS DATA
BROWN TAPE OFFICE DATA
ORANGE TAPE COOLER/FREEZER EMS DATA
YELLOW TAPE PHONE CABLE TO DMARC

Wire Symbols
RJ-45: 24 GA., 4 TWISTED PAIR, CATEGORY-FIVE (CAT 5) DATA CABLE WITH MODULAR RJ-45 END.
RJ-11: 24 GA., 4 TWISTED PAIR, CATEGORY-FIVE (CAT 5) DATA CABLE WITH MODULAR RJ-11 END. USE ONLY THE BLUE & WHITE AND SOLID BLUE WIRES. ALL OTHER WIRES TO BE FOLDED BACK AND TAPED TO THE CABLE.
COAXIAL CABLE WITH RF CONNECTOR

NOTES:
A. WHEN LOW VOLTAGE PERMITS ARE REQUIRED, THE GC/DEVELOPER/LLD IS RESPONSIBLE FOR OBTAINING ALL LOW VOLTAGE PERMITS.
B. LOW VOLTAGE VENDOR RESPONSIBLE FOR ALL WIRE MANAGEMENT IN CABLE TRAY.
C. GC TO PROVIDE AND INSTALL CABLE TRAY AND ALL CONDUIT.

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1 EMS/LOW VOLTAGE PLAN
EMS1 SCALE: N.T.S.

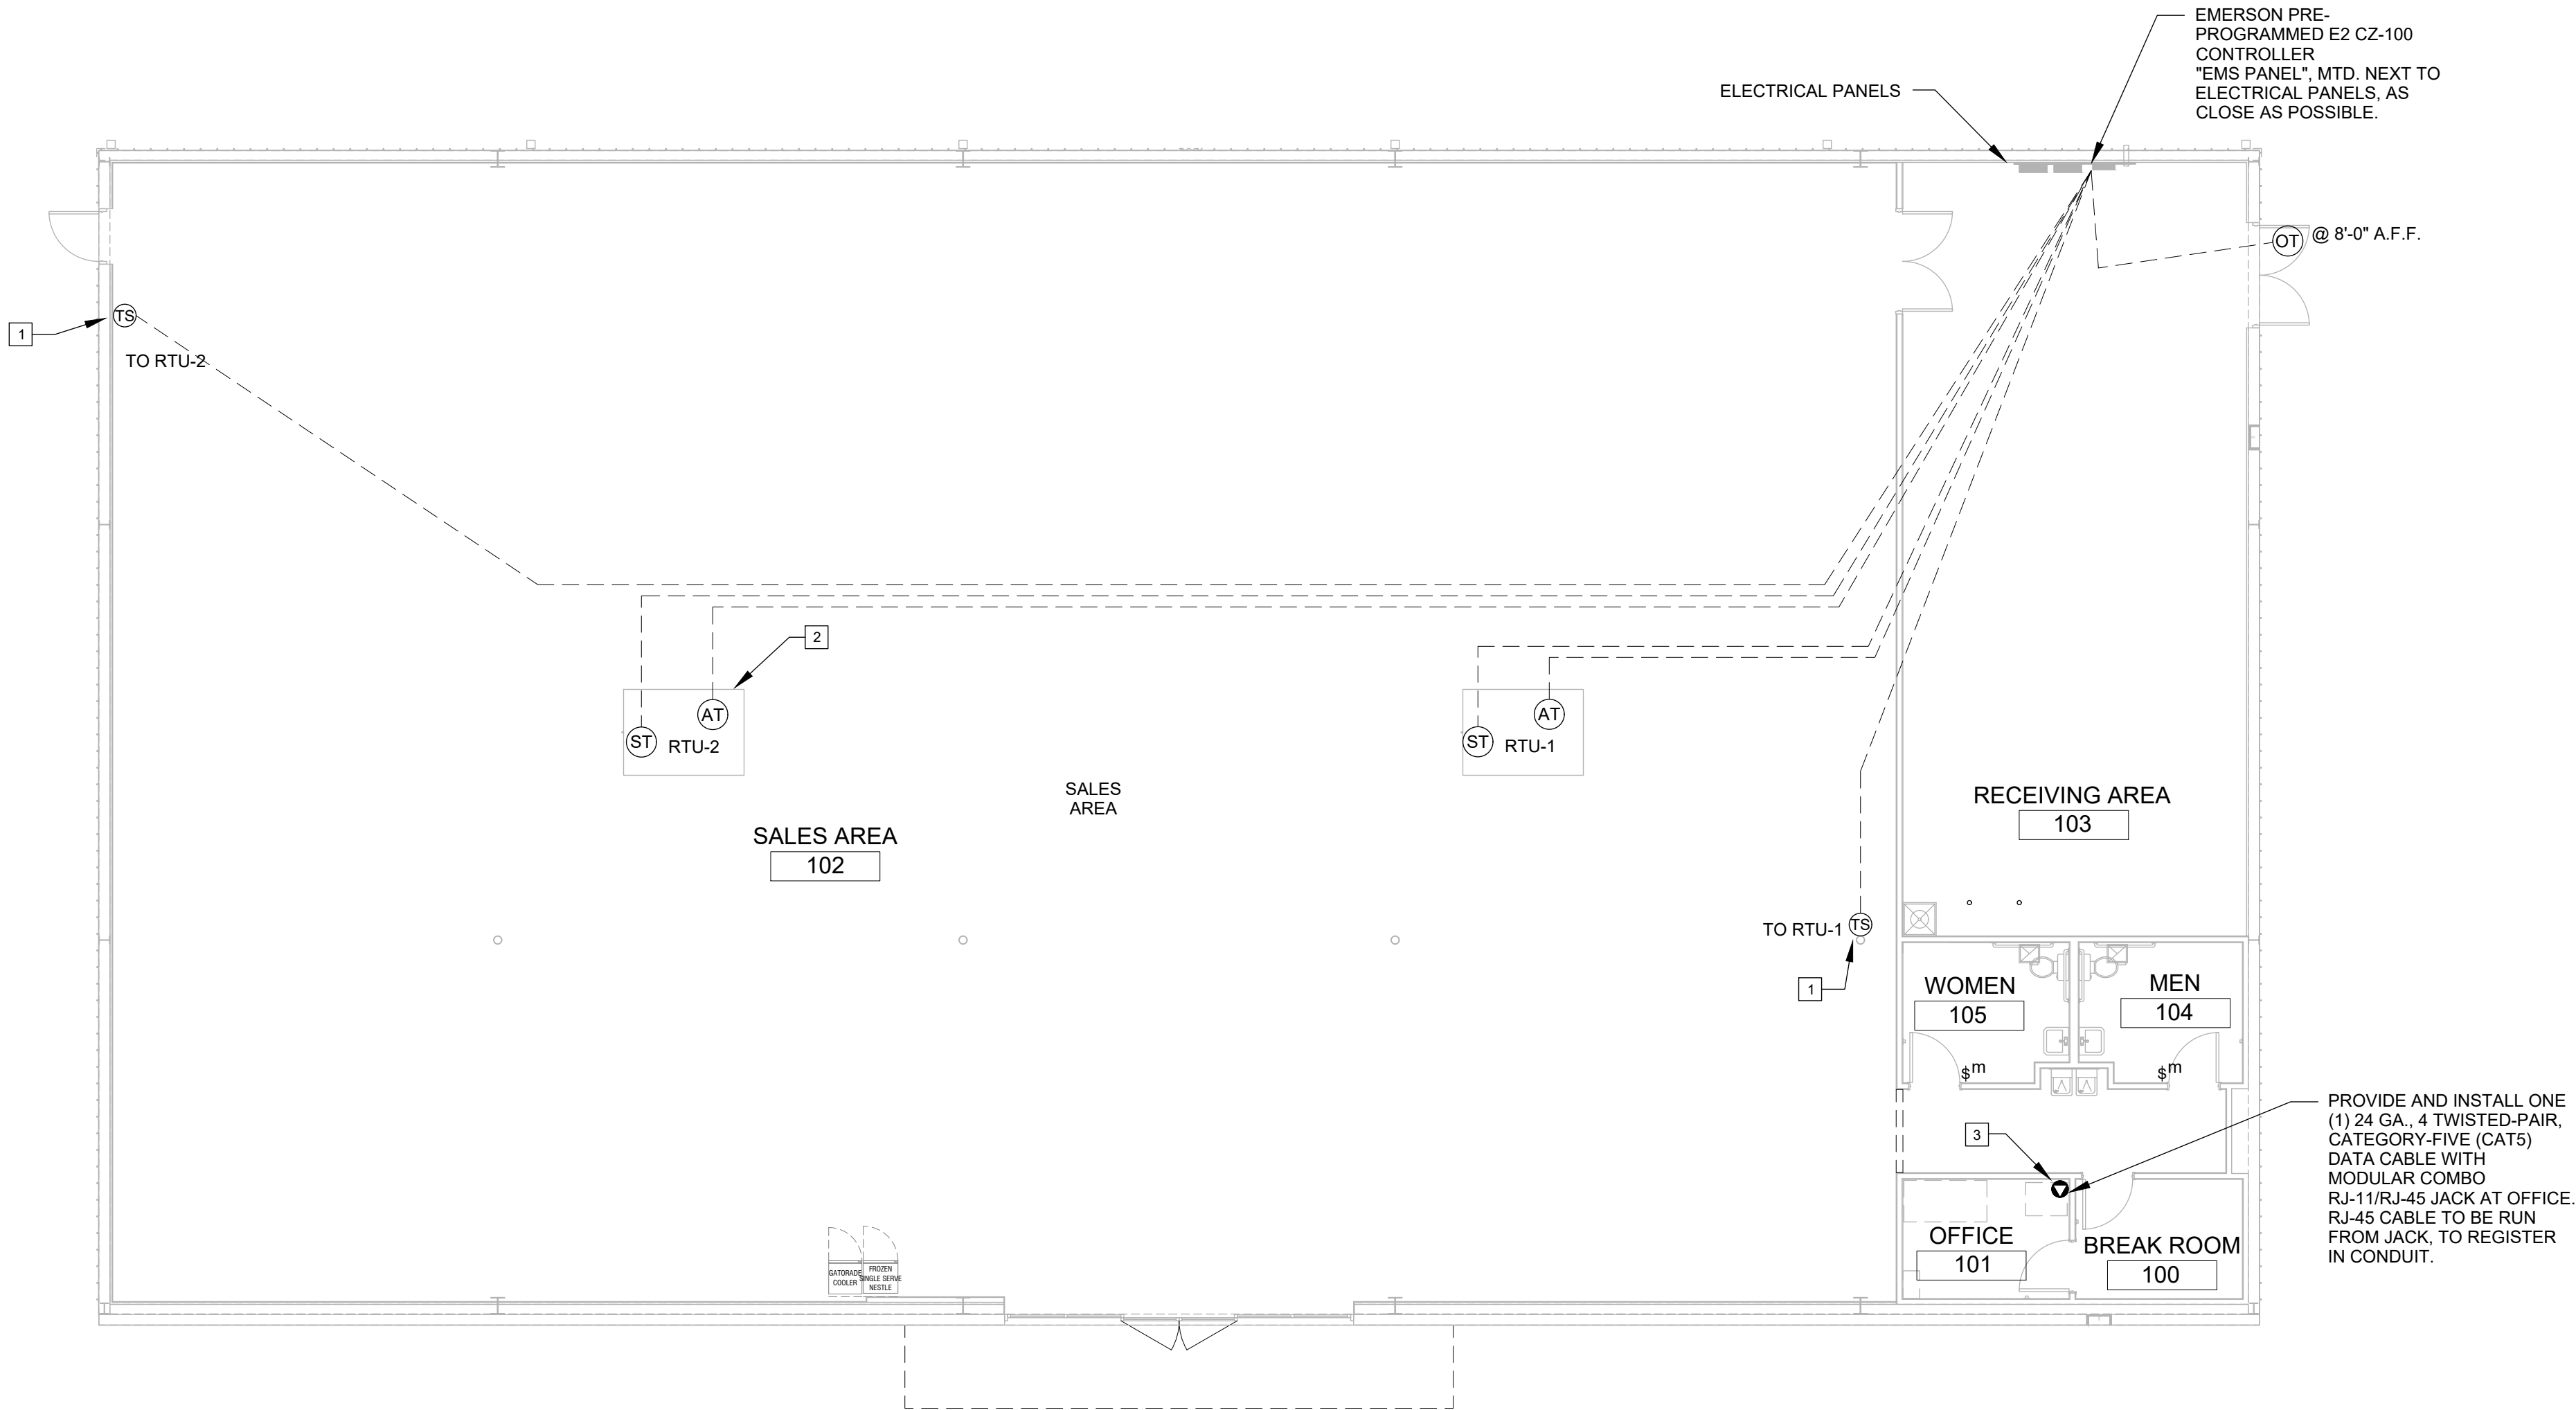

GENERAL NOTES

- REFER TO E1 FOR GENERAL CONTRACTOR RESPONSIBILITIES. E.C. MAY USE CABLE TRAY FOR LOW VOLTAGE CABLES, SEE 2/E2.
- RUN CONDUIT FROM SENSORS TO BOTTOM OF STRUCTURE.
- REFRIGERATION UNITS TO BE CONNECTED TO EMS PANEL BY DOLLAR GENERAL REFRIGERATION CONTRACTOR.

SENSOR PLAN KEYED NOTES

- ALWAYS INSTALL THERMOSTATS 8'-0" A.F.F. THE EXACT MOUNTING LOCATION OF THE THERMOSTAT "TS" MAY VARY DEPENDING ON THE STORE LAYOUT AND DUCT CONFIGURATION. REFER TO SITE SPECIFIC MECHANICAL DRAWINGS FOR HVAC ZONED THERMOSTAT MOUNTING LOCATIONS. IF THERMOSTATS ARE MOUNTED ON EXTERIOR WALLS DUE TO DUCT CONFIGURATION, THEY ARE THEN TO BE INSULATED TO PREVENT AIR INFILTRATION. IF ADDITIONAL HVAC UNITS ARE USED, ADD ADDITIONAL THERMOSTATS "TS".
- ADD ADDITIONAL HVAC UNIT WHEN REQUIRED.
- PHONE LINE #1 - TWO RJ-11 PORTS. ONE (1) LOCATED IN OFFICE W/RJ-45 DATA JACK COMBO AND ONE (1) AT REGISTER. 24 GA. CAT 5, 4-PAIR TWISTED WIRE ONLY. USE BLUE AND BLUE & WHITE WIRES. HOOK TO LINE #1 TERMINAL IN RJ-11 JACK EACH PHONE JACK TO HAVE DEDICATED. SEPARATE HOME RUN TO DMARC. LABEL AS "PHONE" AT THE DESTINATION AND AT DMARC. PHONE COMPANY PROVIDES FINAL HOOK UP TO DMARC ONLY. PHONE LINE #2 - RJ-11 PHONE JACK SUPPLIED AND WIRED BY CONTRACTOR.

DEVICE SCHEDULE

SYMB	DESCRIPTION	CABLE TYPE	SUPPLIER	INSTALLER	NOTES
AT	AHU TERMINAL STRIP	8C T-STAT CABLE	EMS SUPPLIER	GENERAL CONTRACTOR	(1) PER HVAC UNIT
OT	OUTDOOR AIR TEMP (501-1122) MOUNTED 8'-0" A.F.F.	BELDEN 8761 OR EQUIVALENT (22AWG, 2C, STRANDED, SHIELDED)	EMS SUPPLIER	GENERAL CONTRACTOR	(1) PER RECEIVING ENTRY
ST	SUPPLY TEMP (201-0041) IN SUPPLY DUCT	BELDEN 8761 OR EQUIVALENT (22AWG, 2C, STRANDED, SHIELDED)	EMS SUPPLIER	GENERAL CONTRACTOR	(1) PER HVAC UNIT
TS	TOUCHSCREEN THERMOSTAT (810-1600) 8'-0" A.F.F.	8C T-STAT CABLE	EMS SUPPLIER	GENERAL CONTRACTOR	(1) PER HVAC UNIT ZONE
o	RJ-11/RJ-45 DATA JACK PHONE COMBO	CAT-5 DATA CABLE (24AWG, 4 TWISTED PAIR)	GENERAL CONTRACTOR	GENERAL CONTRACTOR	(1) AT OFFICE COMPUTER CART
\$m	MOTION SENSOR SWITCH	LEVITON EZ-FIND ODS-10-IDW	GENERAL CONTRACTOR	GENERAL CONTRACTOR	(1) PER RESTROOM (1) PER BREAK ROOM (1) PER OFFICE

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FOR REFERENCE ONLY



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DRAWING DATE: / DRAWN BY:
3/5/2021 - KWH


REVISION DATE: / REVISED BY:

PROJECT NUMBER:
4000.213

DRAWING TITLE:
EMS/LOW VOLTAGE


SHEET NO.

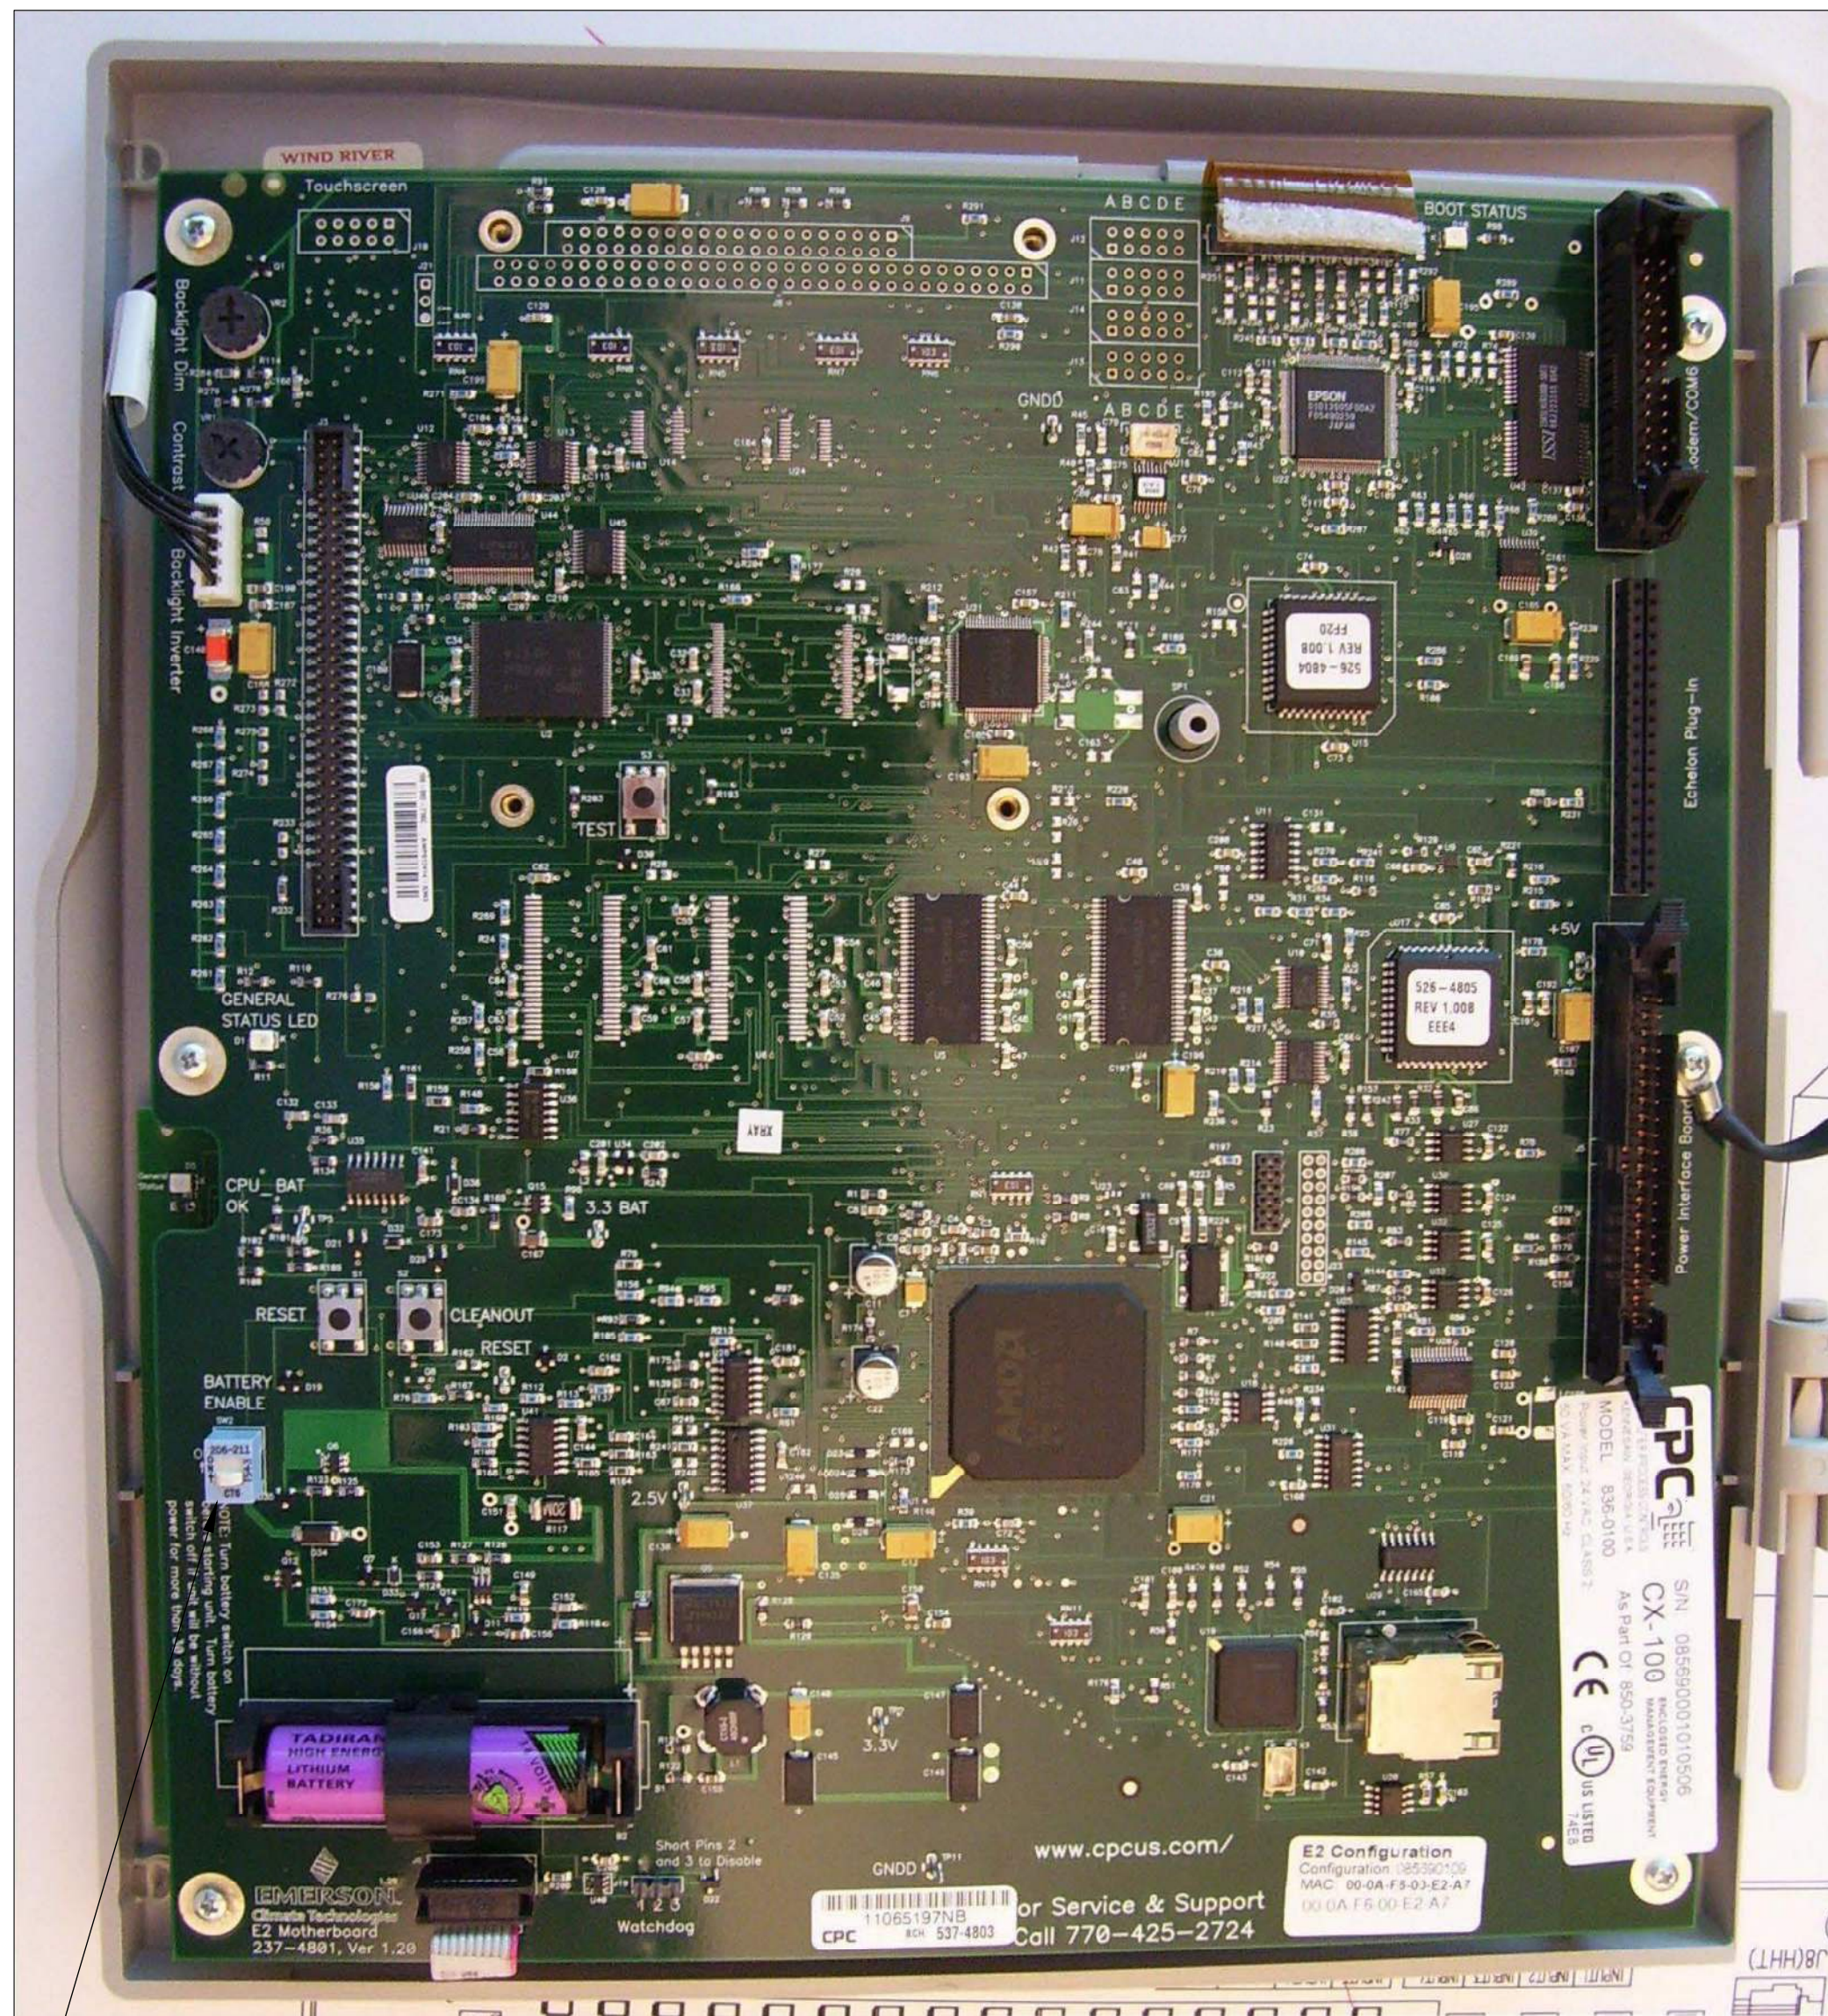EMS1




GENERAL CONTRACTOR TO ENSURE THAT THE BATTERY IS SWITCHED TO THE "ON" POSITION

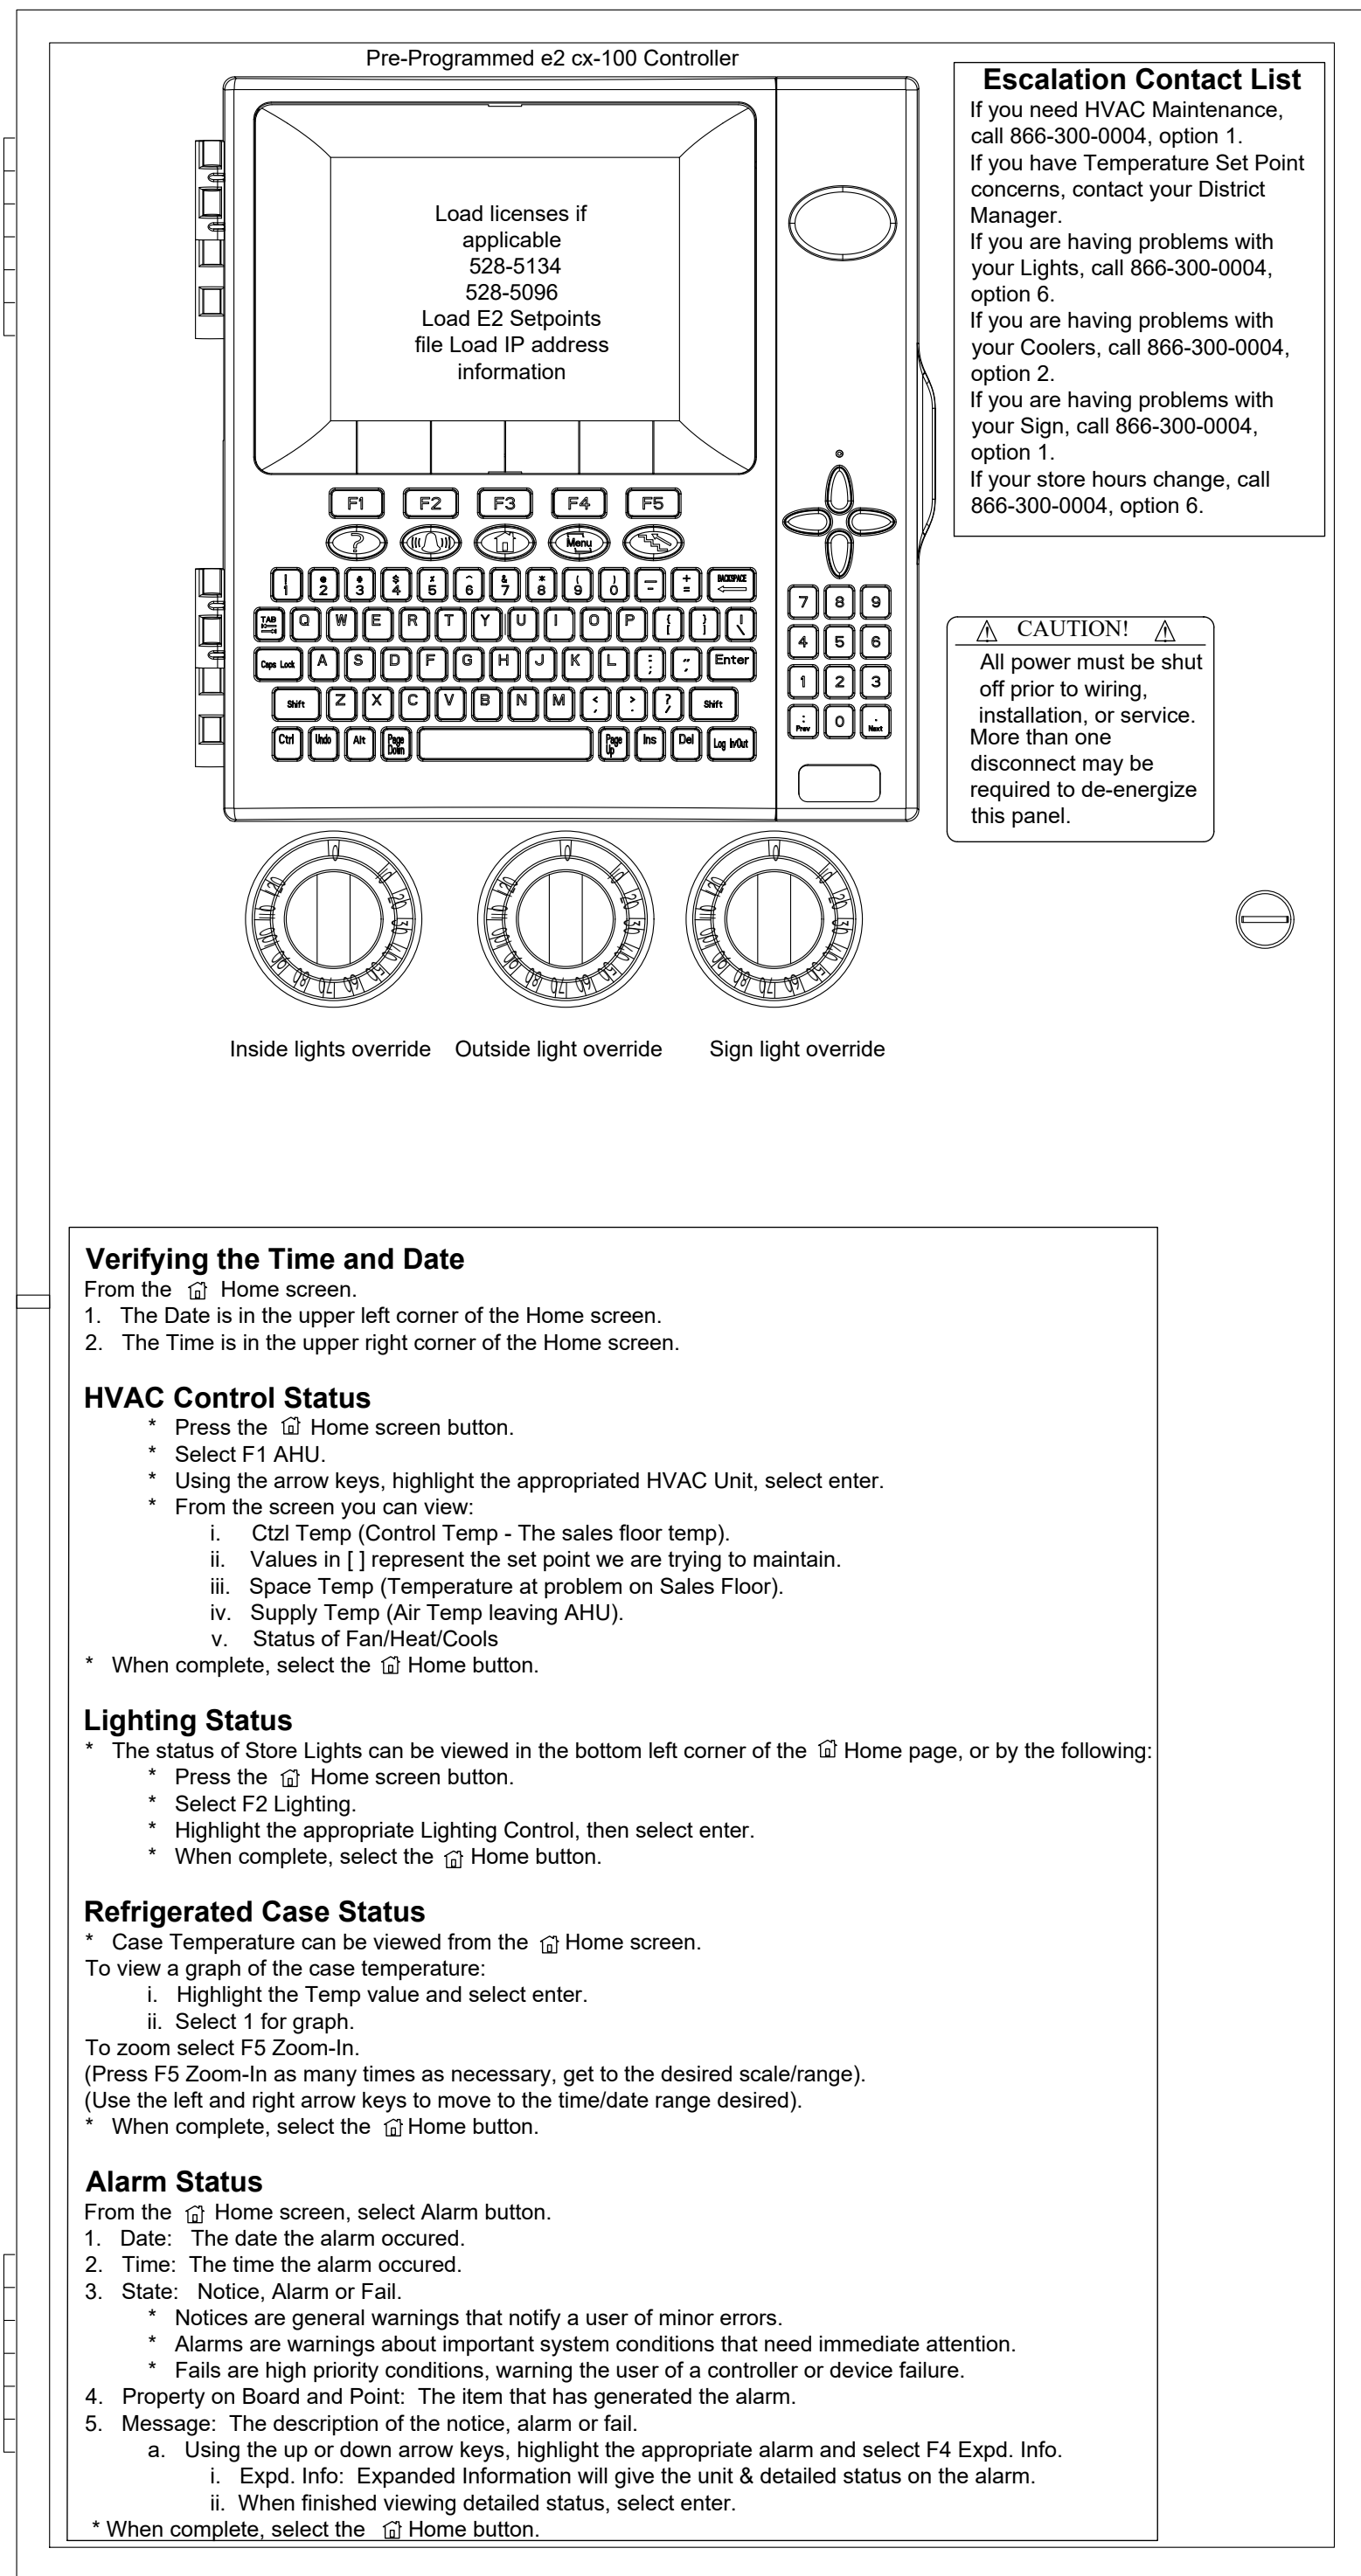1 CPU TERMINAL DIAGRAM
EMS2 SCALE: N.T.S.



NOTE:
EMS SYSTEM SHOULD BE TESTED FOR HVAC OPERATION, INTERIOR LIGHTING, EXTERIOR LIGHTING AND SIGN LIGHTING PRIOR TO CONTRACTOR'S ELECTRICAL POSSESSION DATE. USE OUTSIDE LIGHT AND SIGN LIGHT OVERRIDE FOR EXTERIOR TESTING.

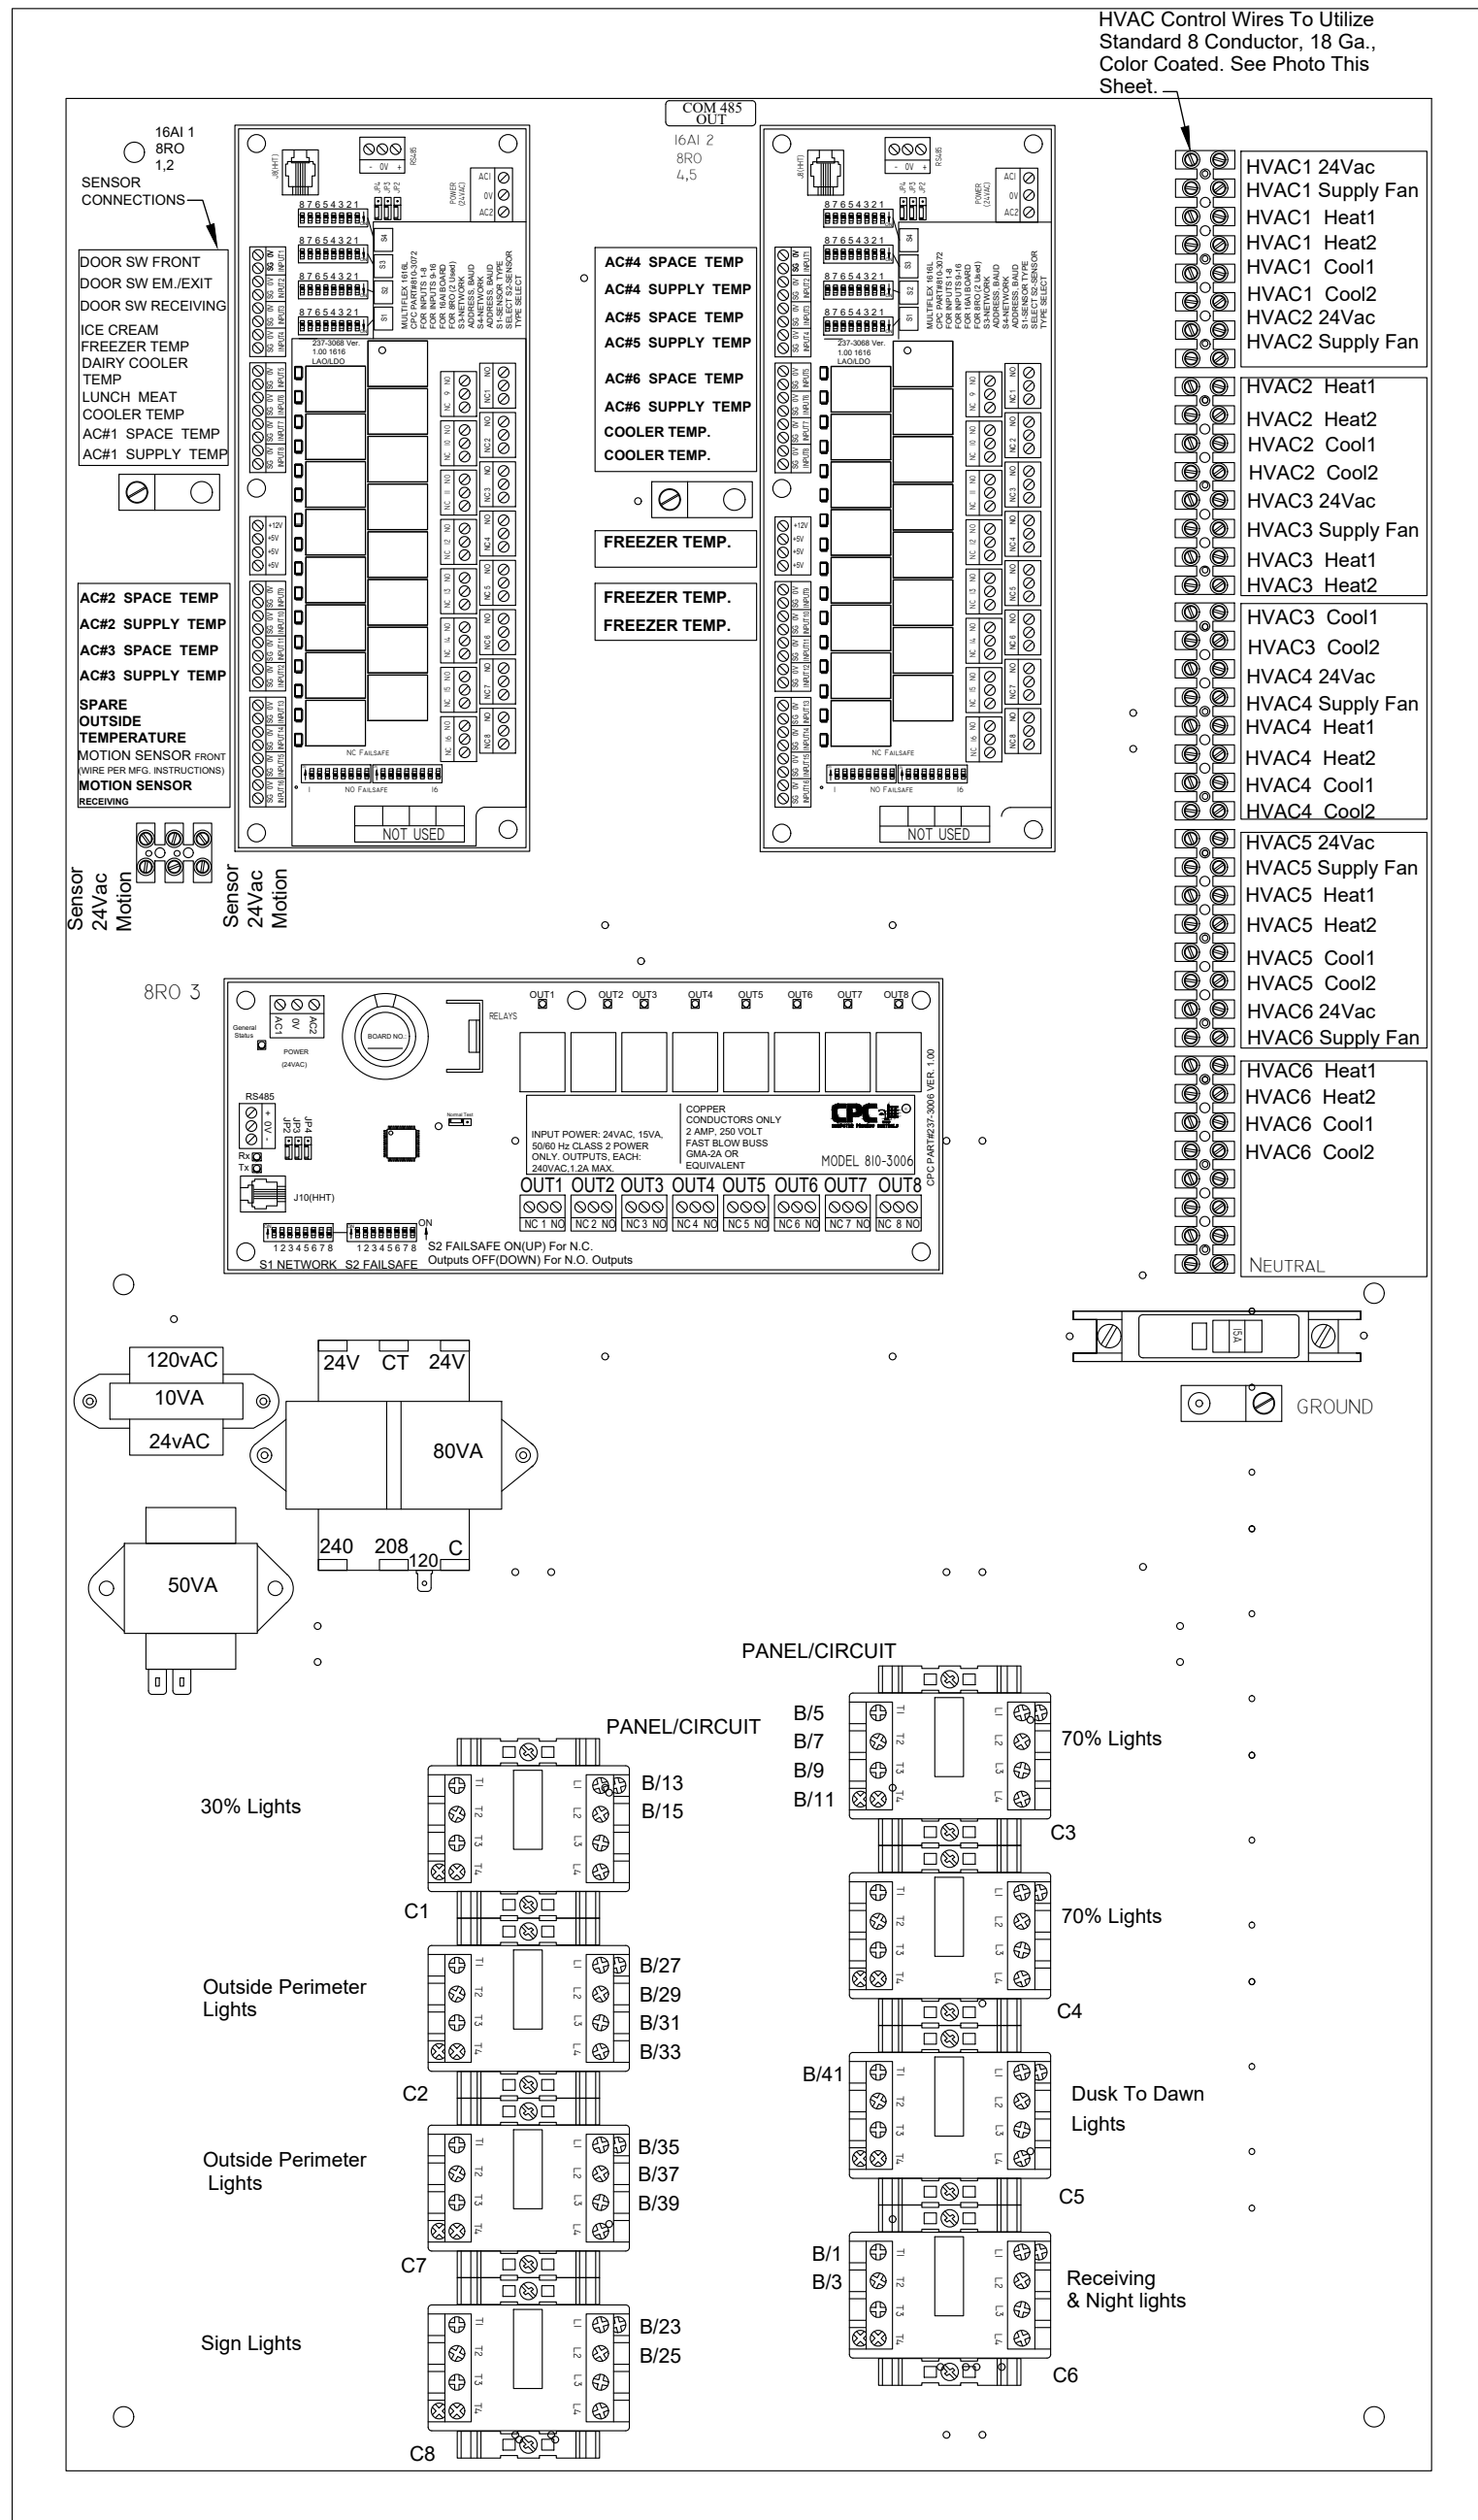2 PROGRAMMER CONTROLLER
EMS2 SCALE: N.T.S.



3 CONTROL WIRING DIAGRAM
EMS2 SCALE: N.T.S.

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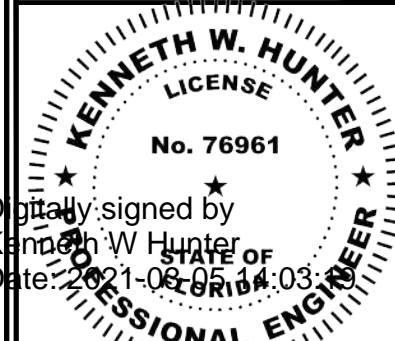


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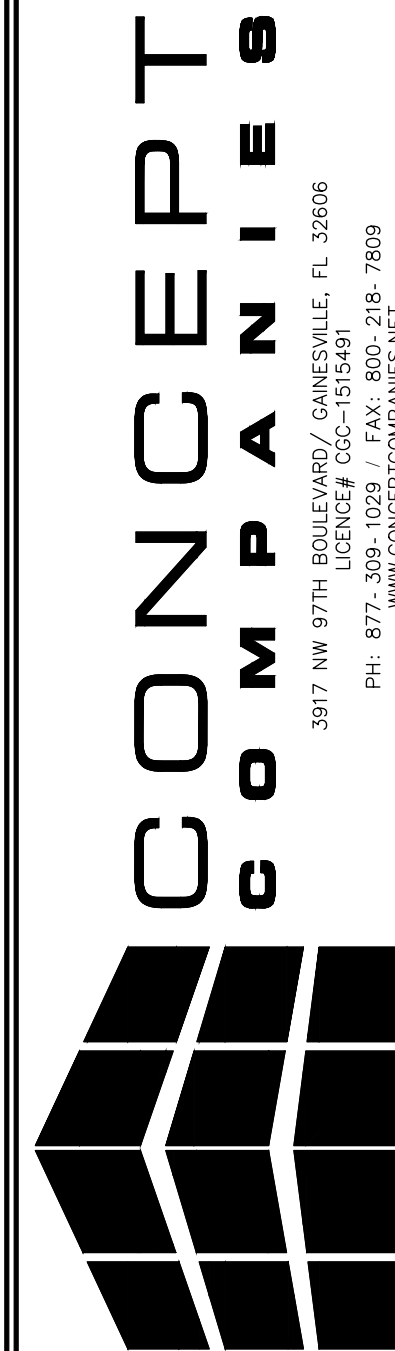
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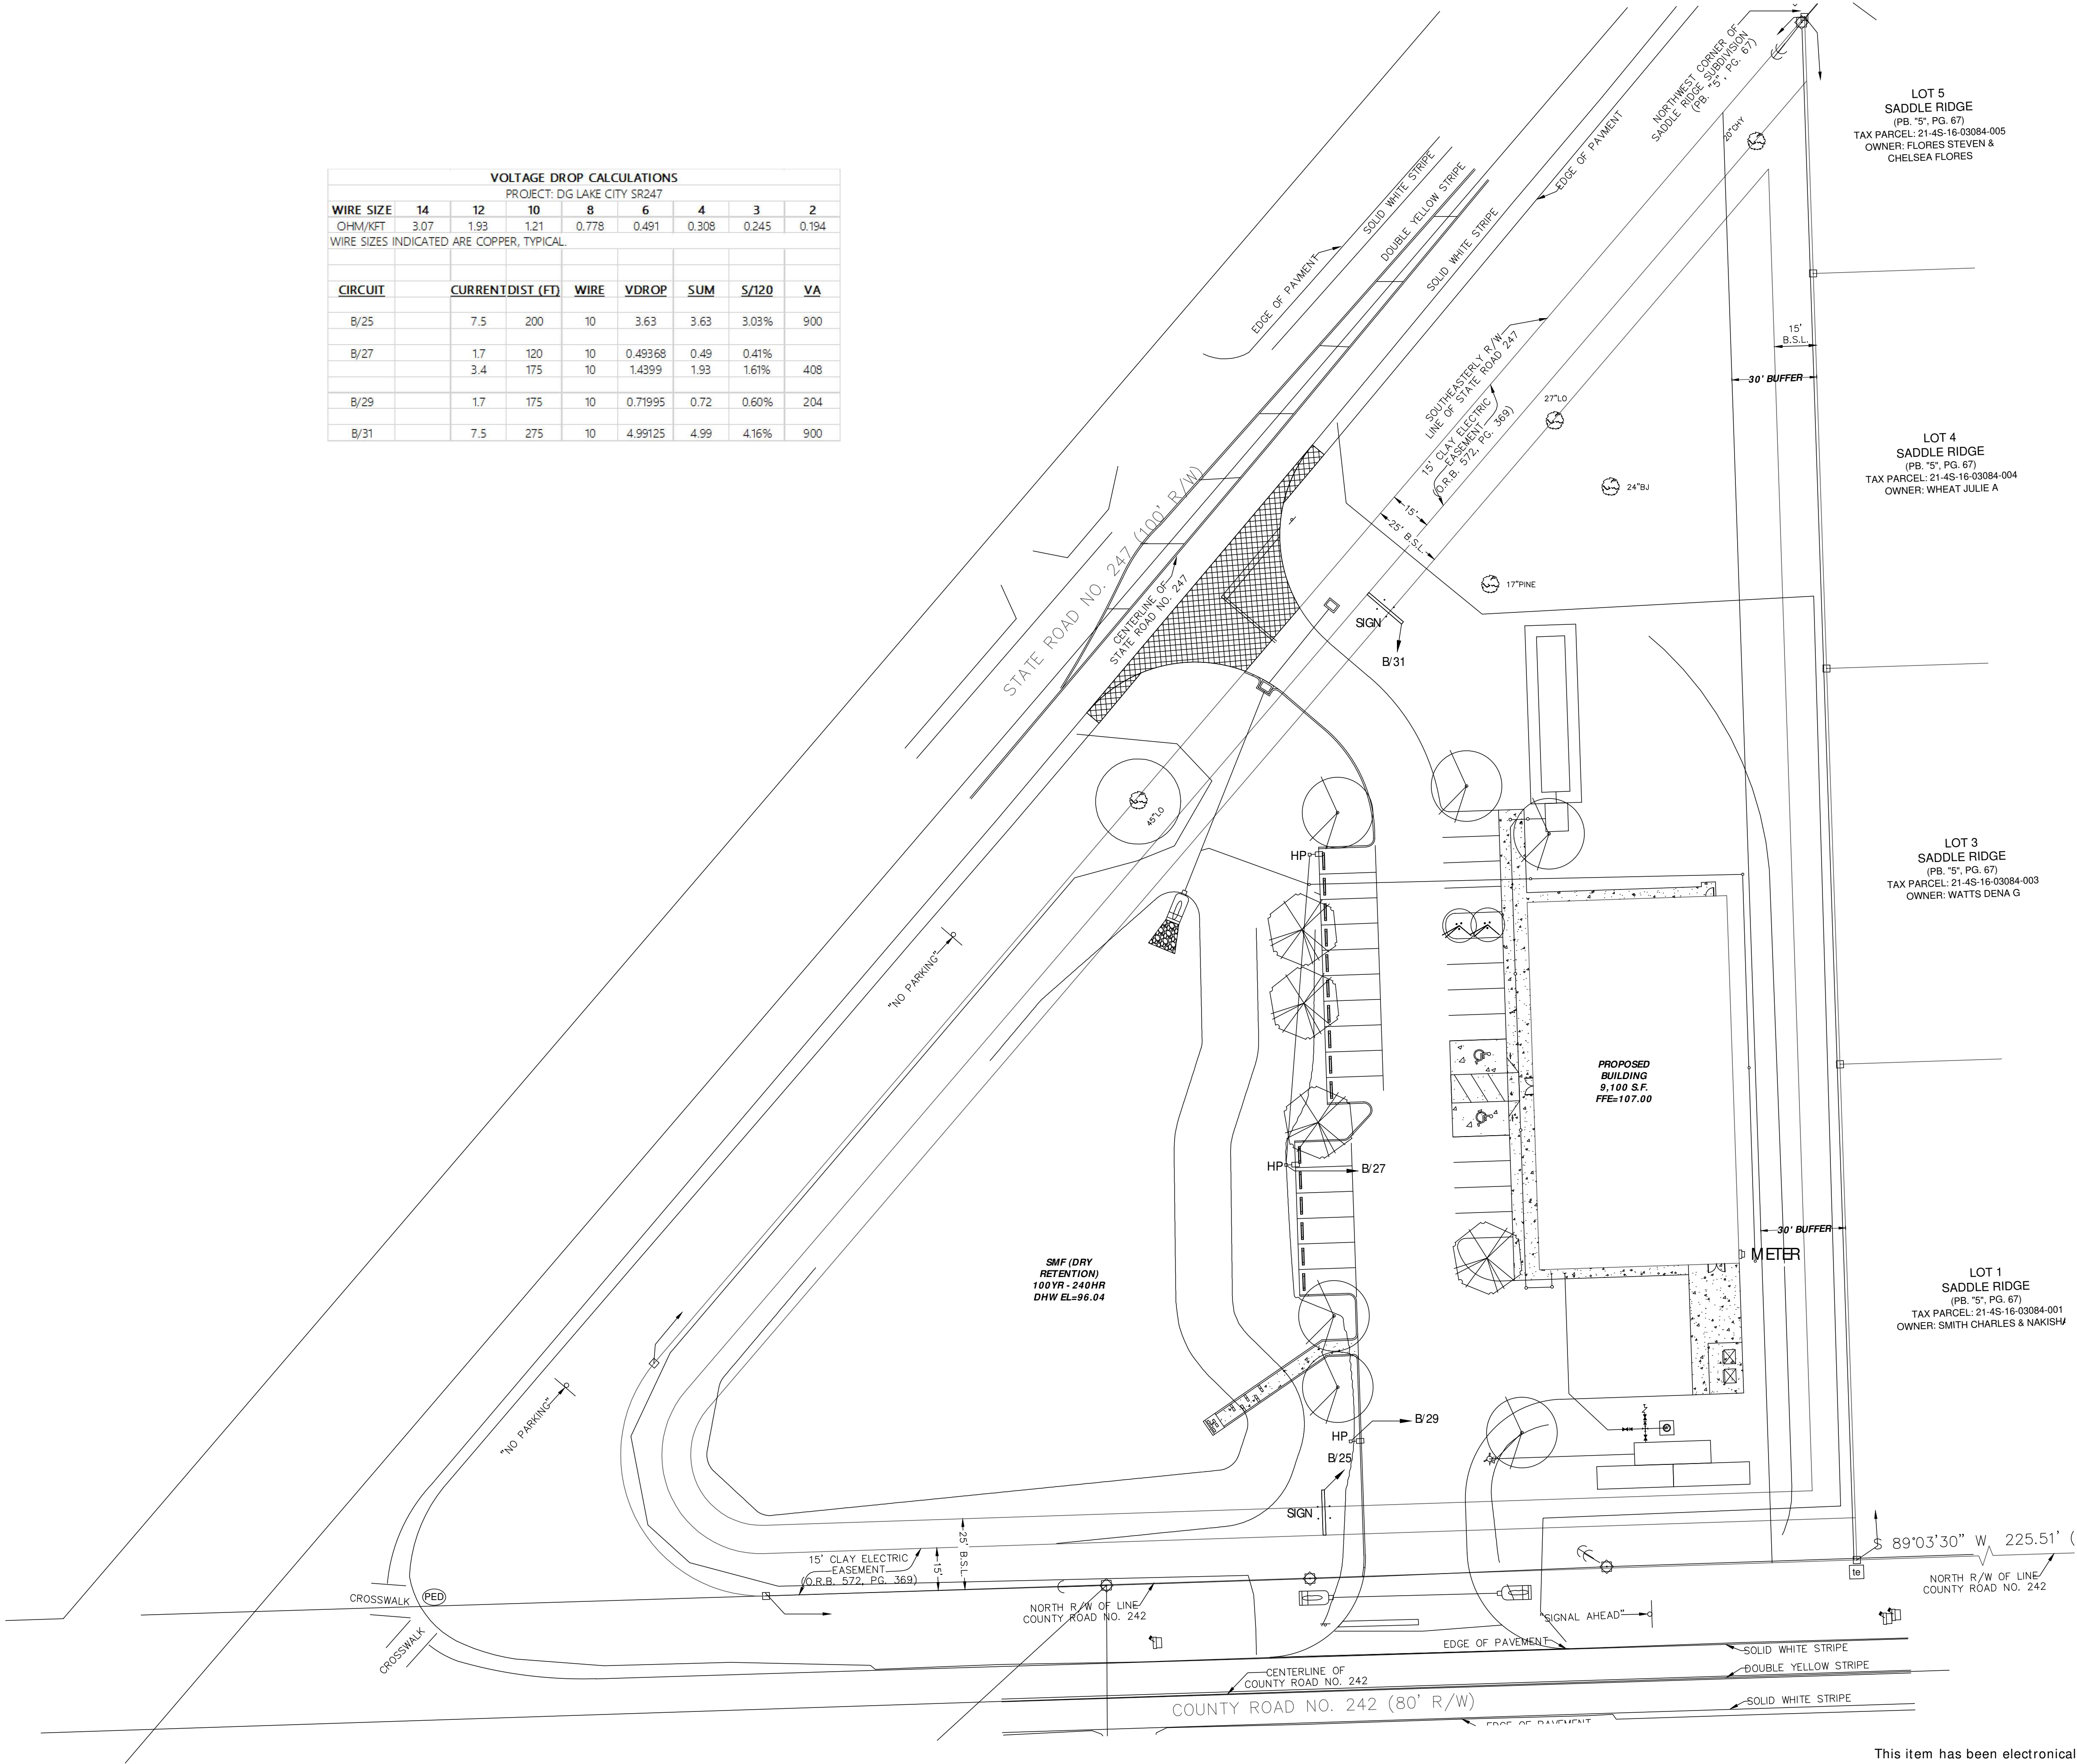
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LAKE CITY, FL 32024

STORE #180
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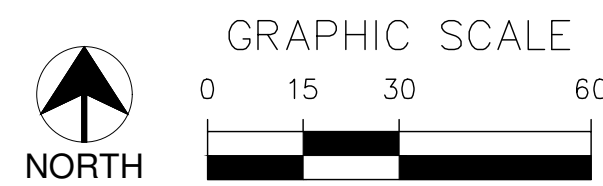
DRAWING DATE / DRAWN BY:
3/5/2021 - KWH
REVISION DATE / REVISED BY:
PROJECT NUMBER:
4000.213
DRAWING TITLE:
EMS PANEL CONTROLS
SHEET NO.

EMS2

VOLTAGE DROP CALCULATIONS								
PROJECT: DG LAKE CITY SR247								
WIRE SIZE	14	12	10	8	6	4	3	2
OHM/KFT	3.07	1.93	1.21	0.778	0.491	0.308	0.245	0.194
WIRE SIZES INDICATED ARE COPPER, TYPICAL.								
CIRCUIT	CURRENT	DIST (FT)	WIRE	VDROP	SUM	S/120	VA	
B/25		7.5	200	10	3.63	3.63	3.03%	900
B/27	1.7	120	10	0.49368	0.49	0.41%	408	
	3.4	175	10	1.4399	1.93	1.61%		
B/29	1.7	175	10	0.71995	0.72	0.60%	204	
B/31		7.5	275	10	4.99125	4.99	4.16%	900



SITE ELECTRICAL PLAN
SCALE 1" = 30'-0"



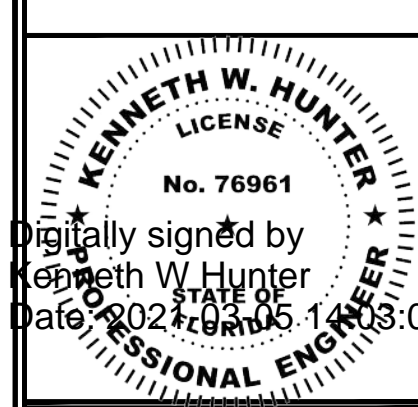
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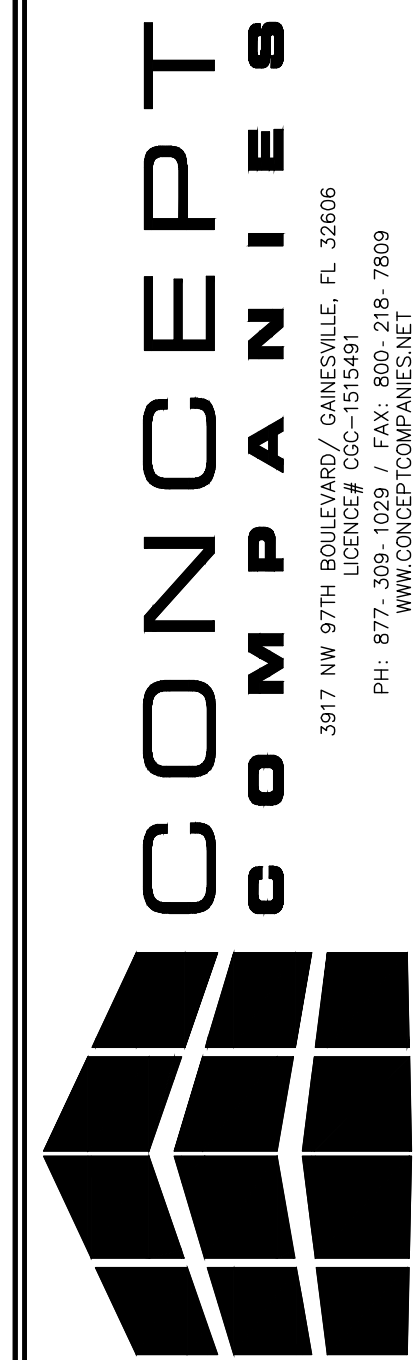


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REVISION DATE / REVISED BY:
PROJECT NUMBER:
4000.213
DRAWING TITLE:
ELECTRICAL SITE PLAN
SHEET NO.

ES1