

#### SCOPE OF WORK:

TO INSTALL A ROOF MOUNTED SOLAR PHOTOVOLTAIC SYSTEM AT THE OWNER RESIDENCE LOCATED AT 291 NORTHWEST SCOTT GLEN, LAKE CITY, FL 32055.

SYSTEM DC RATING: 6.80 KWDC SYSTEM AC RATING: 4.94 KWAC

#### **GENERAL NOTES:**

- THESE CONSTRUCTION DOCUMENTS HAVE BEEN BASED ON FIELD INSPECTIONS AND OTHER INFORMATION AVAILABLE AT THE TIME. ACTUAL FIELD CONDITIONS MAY REQUIRE MODIFICATIONS IN CONSTRUCTION DETAILS.
- CONTRACTOR HAS THE FULL RESPONSIBILITY TO CHECK AND VERIFY ALL DIMENSIONS AND EXISTING CONDITIONS. ANY DISCREPANCIES SHALL BE REPORTED TO THE ENGINEER BEFORE PROCEEDING WITH THE WORK. ANY WORK STARTED BEFORE CONSULTATION AND ACCEPTANCE BY THE ENGINEER SHALL BE THE SOLE RESPONSIBILITY OF THE CONTRACTOR AND SHALL BE SUBJECT TO CORRECTION BY THEM WITHOUT ADDITIONAL COMPENSATION.
- THE CONTRACTOR SHALL BE HELD RESPONSIBLE FOR THE PROPER INSTALLATION AND COMPLETION OF THE WORK WITH APPROVED MATERIALS.
- THE EQUIPMENT AND ALL ASSOCIATED WIRING AND INTERCONNECTION SHALL BE INSTALLED ONLY BY QUALIFIED PEOPLE. A QUALIFIED PERSON IS ONE WHO HAS SKILLS AND KNOWLEDGE RELATED TO THE CONSTRUCTION AND OPERATION OF THE ELECTRICAL EQUIPMENT AND INSTALLATIONS AND HAS RECEIVED SAFETY TRAINING TO RECOGNIZE AND AVOID THE HAZARDS INVOLVED. (NEC 690.4(C), NEC 2017).
- NEW CONDUIT ROUTING SHOWN IS ESSENTIALLY SCHEMATIC. CONTRACTOR SHALL LAY OUT RUNS TO SUIT FIELD CONDITIONS AND THE COORDINATION REQUIREMENTS OF OTHER TRADES.
- ARRAY WIRING SHOULD NOT BE READILY ACCESSIBLE EXCEPT TO QUALIFIED PERSONNEL.
- THE AC DISCONNECT MUST BE ACCESSIBLE TO QUALIFIED UTILITY PERSONNEL, BE LOCKABLE, AND BE A VISIBLE-BREAK SWITCH.



SHEET INDEX						
CS-0	COVER SHEET & BOM					
E-1	STRING LAYOUT & SIGNAGE					
E-2	ELECTRICAL DIAGRAM & CALCS.					
E-3+	EQUIPMENT SPECIFICATIONS					

GOVERNING CODES					
2017 NEC					
2018 NFPA / 2020 FFPC					
2020 FBC					
2018 IRC					
ALITHODITY HAVING HIDIODICTION (ALL), COLINTY OF COLUMBIA					

AUTHORITY HAVING JURISDICTION (AHJ): COUNTY OF COLUMBIA UTILITY COMPANY: FPL

BILL OF MATERIALS						
EQUIPMENT	QTY	DESCRIPTION				
SOLAR PV MODULE	17	Q CELLS Q.PEAK DUO BLK ML-G10+ 400				
MICROINVERTER	17	ENPHASE IQ8PLUS-72-2-US				
JUNCTION BOX	1	JUNCTION BOX, NEMA 3R, UL LISTED				
COMBINER BOX	1	ENPHASE IQ COMBINER 4/4C W/ IQ ENVOY (X-IQ-AM1-240-4)				
AC DISCONNECT	1	60A NON-FUSED AC DISCONNECT, 240V, NEMA 3R, UL LISTED				
POWER PERFECT BOX	1	(ES1PN), 120V/240V, NEMA 3X				
	•					



ATLANTIC KEY ENERGY LLC 12600 CHALLENGER PARKWAY

SUITE 200 ORLANDO, FL 32826 1 (407) 988-0273



E N G PROJECT # P-0069816 SCOTT KAYLA ROTH RESIDENCE 냅 **NORTHWEST** LAKE CITY, 291

SIGNATURE WITH SEAL

REVISIONS DESCRIPTION DATE REV

04/06/2023

SHEET NAME

**COVER SHEET & BOM** 

> SHEET NUMBER CS-0


THIS ITEM HAS BEEN DIGITALLY SIGNED AND SEALED BY OMAR TIRADO ON THE DATE ADJACENT TO THE SEAL. PRINTED COPIES OF THIS DOCUMENT ARE NOT VCONSIDERED SIGNED AND SEAL AND THE SIGNATURE MUST BE VERIFIED ON ANY ELECTRONIC COPIES

SONAL

2023.04.06

18:08:46 -04'00'



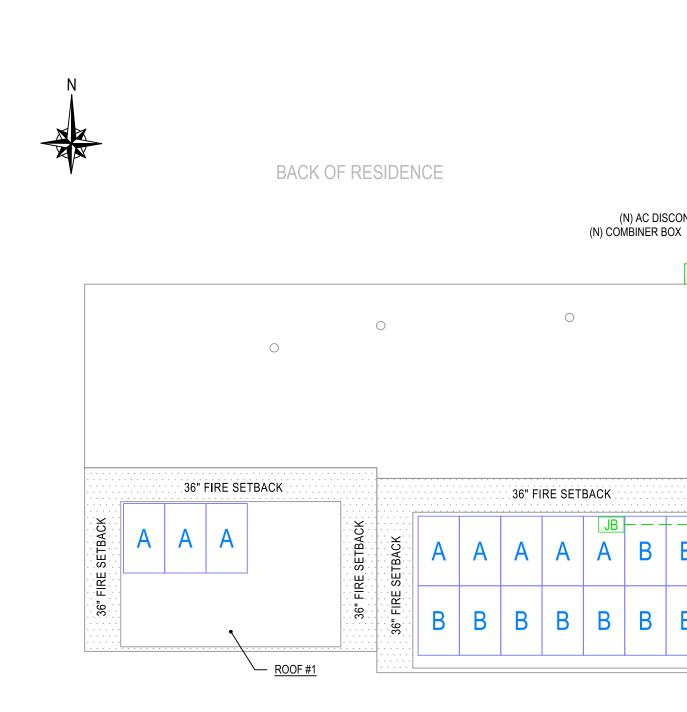

(N) AC DISCONNECT

B

B

B

В

CB


ACD

SETBACK

36" FIRE

THIS ITEM HAS BEEN DIGITALLY SIGNED AND SEALED BY OMAR TIRADO ON THE DATE ADJACENT TO THE SEAL. PRINTED COPIES OF THIS DOCUMENT ARE NOT CONSIDERED SIGNED AND SEAL, AND THE SIGNATURE MUST BE VERIFIED ON ANY ELECTRONIC COPIES

FRONT OF RESIDENCE

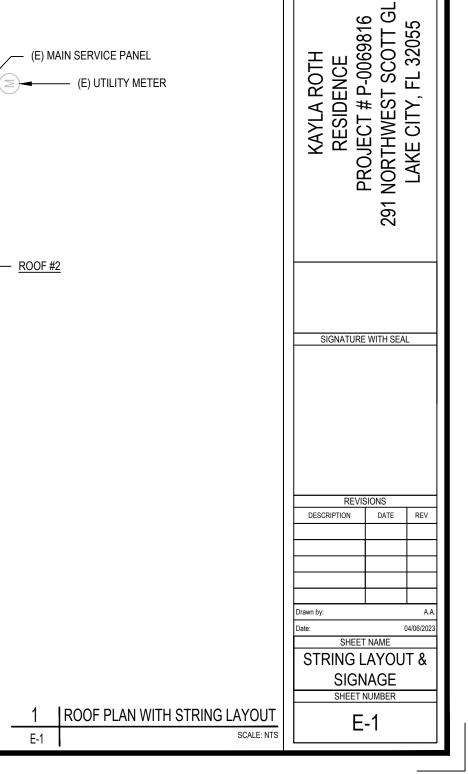

ATLANTIC KEY ENERGY LLC

12600 CHALLENGER PARKWAY

SUITE 200

ORLANDO, FL 32826 1 (407) 988-0273

Ë

ID	INITIAL CONDUCTOR LOCATION	FINAL CONDUCTOR LOCATION	MIN. CONDUCTOR (AWG)		. DIA CONDUIT SIZE (IN.)	# OF PARALLEL CIRCUITS	CURRENT-CARRYING CONDUCTORS IN CONDUIT	OCPD (A)		MIN. EGC SIZE (AWG)	TEMP. FAC		CONDUIT FILL FACTOR	CONT. CURRENT (A)	MAX. CURRENT (A)	BASE AMP. (A)	DERATED AMP. (A)	TERM. AMP. RATING (A)	LENGTH (FT)	VOLTAGE DROP (%)
1	STRING A	JUNCTION BOX	12 Q CAB	.E	N/A	1	2	N/A	6	BARE COPPER	0.76	55°C	N/A	9.68	12.10	30	N/A	N/A	40.00	0.64
2	STRING B	JUNCTION BOX	12 Q CAB	.E	N/A	1	2	N/A	6	BARE COPPER	0.76	55°C	N/A	10.89	13.61	30	N/A	N/A	35.00	0.63
3	JUNCTION BOX	COMBINER BOX	10 THWN-2 C	PPER 0.7	0.75 LTNM	2	4	20	10	THWN-2 COPPER	0.76	55°C	0.8	10.89	13.61	40	24.3	35	38.00	0.43
4	COMBINER BOX	AC DISCONNECT	10 THWN-2 C	PPER 0.7	0.75 LTNM	1	3	N/A	10	THWN-2 COPPER	0.96	34°C	1	20.57	25.71	40	38.4	35	5.00	0.11
5	AC DISCONNECT	MSP	10 THWN-2 C	PPER 0.7	0.75 LTNM	1	3	30	10	THWN-2 COPPER	0.96	34°C	1	20.57	25.71	40	38.4	35	5.00	0.11



ATLANTIC KEY ENERGY LLC 12600 CHALLENGER PARKWAY SUITE 200 ORLANDO, FL 32826 1 (407) 988-0273



PROJECT # P-0069816 11 NORTHWEST SCOTT GLEN LAKE CITY, FL 32055 KAYLA ROTH RESIDENCE 291


SIGNATURE WITH SEAL

REVI	SIONS				
DESCRIPTION	DATE	REV			
awn by: A.A.					
te: 04/06/2023					

SHEET NAME

ELECTRICAL LINE DIAGRAM & CALCS. SHEET NUMBER

E-2

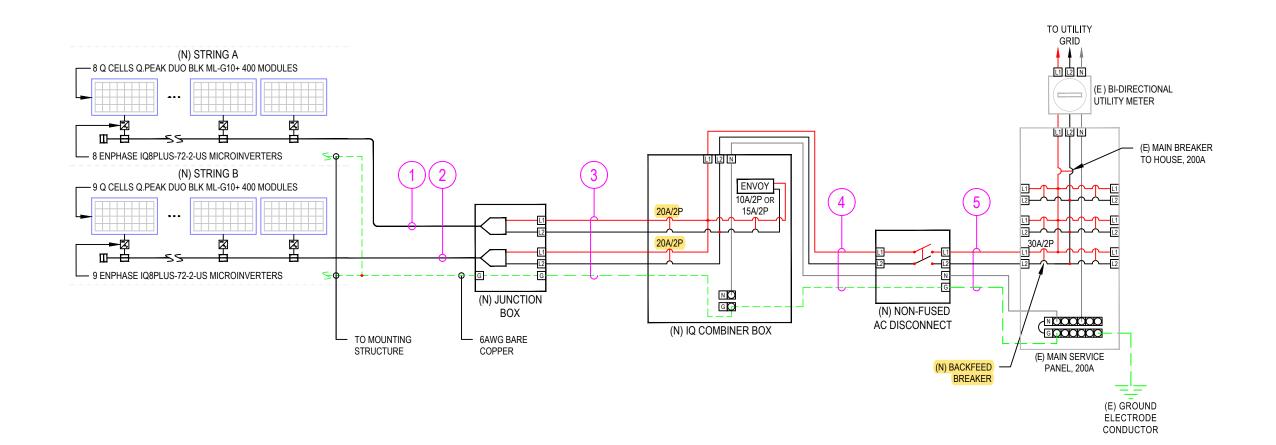

THIS ITEM HAS BEEN DIGITALLY SIGNED AND SEALED BY OMAR TIRADO ON THE DATE ADJACENT TO THE SEAL. PRINTED COPIES OF THIS DOCUMENT ARE NOT CONSIDERED SIGNED AND SEAL, AND THE SIGNATURE MUST BE VERIFIED ON ANY ELECTRONIC COPIES

| ELECTRICAL LINE DIAGRAM E-2

NOTE:
1. LTNM OR EQUIVALENT TYPE CONDUIT (E) - EXISTING (N) - NEW

DESIGN TEMPERATURE SPECIFICATIONS	3
RECORD LOW TEMP	-5°C
AMBIENT TEMP. (HIGH TEMP. 2%)	34°C
CONDUIT HEIGHT	1.0"
CONDUCTOR TEMP. RATE (ROOF)	55°C

**LEGEND** 

ARRAY DESCRIPTION						
ROOF	# OF MODULES	AZIMUTH	TILT	TRUSS SIZE	TRUSS SPACING	ROOF MATERIAL
#1	3	180	5/12 (22.62°)	2X4	24"O.C.	CORRUGATED METAL
#2	14	180	5/12 (22.62°)	2X4	24"O.C.	CORRUGATED METAL

**BACK OF RESIDENCE** 



DESIGN SPECIFICATION					
RISK CATEGORY	II				
CONSTRUCTION	SFD				
ZONING	RESIDENTIAL				
SNOW LOAD (ASCE 7-16)	0 PSF				
EXPOSURE CATEGORY	В				
WIND SPEED (ASCE 7-16)	120 MPH				



THIS ITEM HAS BEEN DIGITALLY SIGNED AND SEALED BY OMAR TIRADO ON THE DATE ADJACENT TO THE SEAL. PRINTED COPIES OF THIS DOCUMENT ARE NOT CONSIDERED SIGNED AND SEAL, AND THE SIGNATURE MUST BE VERIFIED ON ANY ELECTRONIC COPIES

#### **ROOF'S GENERAL NOTES**

- 1- CONTRACTOR/INSTALLER TO VERIFY ROOF CONDITIONS FOR PROPPER INSTALLATION OF THE PV SYSTEM.
- 2- CONTRACTOR/INSTALLER TO NOTIFY THE OWNER IMMEDIATELY OF ANY ROOF DEFICIENCIES AND/OR REPAIR REQUIRED TO INSTALL THE PV SYSTEM.


  3- EOR DOES NOT ASSUME ANY RESPONSIBILITY FOR THE INSTALLATION OF ANY PV SYSTEM ON
- DEFICIENT ROOFS. 4- CONTRACTOR/INSTALLER ASSUMES ALL RESPONSIBILITY TO INSTALL AS PER MANUFACTURER STANDARS.

#### ROOF INSPECTION NOTES

PV MODULES IN LAYOUTS IS CONSIDERED NON-EXPOSED AFTER COMPLYING WITH THE

- FOLLOWING STATEMENTS BASED ON ASCE 7-16:

  NO INDIVIDUAL PV MODULE IS MORE THAN 0.5 (MEAN ROOF HEIGHT) AWAY FROM ROOF
- NO INDIVIDUAL PV MODULE IS MORE THAN 4FT AWAY FROM ROOF EDGE OR ANOTHER
- INDIVIDUAL PV MODULE IS MORE THAN 1.5 (MODULE LENGTH) AWAY FROM CLOSEST

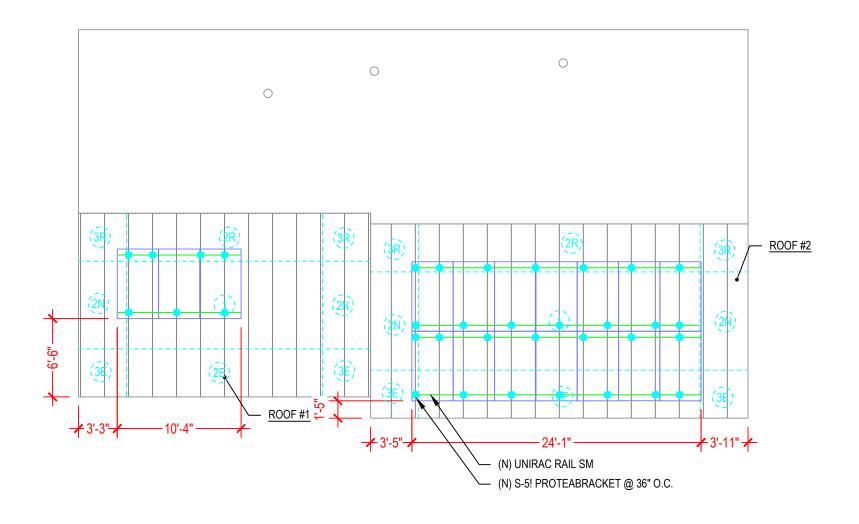

FRONT OF RESIDENCE

**LEGEND** (E) - EXISTING

(N) - NEW

ROOF PLAN AND MODULES

SCALE: NTS

ATLANTIC KEY ENERGY LLC 12600 CHALLENGER PARKWAY SUITE 200 ORLANDO, FL 32826 1 (407) 988-0273 PROJECT # P-0069816 1 NORTHWEST SCOTT GLEN LAKE CITY, FL 32055 KAYLA ROTH RESIDENCE 291 SIGNATURE WITH SEAL REVISIONS DESCRIPTION DATE REV

SHEET NAME

ROOF PLAN AND **MODULES** 

SHEET NUMBER


04/06/2023

S-0

# Q.PEAK DUO BLK ML-G10+ SERIES

#### ■ Mechanical Specification

Format	74.0 in × 413 in × 1.26 in (including frame) (1879 mm × 1045 mm × 32 mm)
Weight	48.5 lbs (22.0 kg)
Front Cover	0:13 in (3.2 mm) thermally pre-stressed glass with anti-reflection technology
Back Cover	Composite film
Frame	Black anodised aluminium
Cell	6 × 22 monocrystalline QLANTUM solar half cells
Junction box	2.09-3.98 in × 1.26-2.36 in × 0.59-0.71 in (53-401 inm × 32-60 mm × 15-18 mm), IP67, with bypass diodes
Cable	4 mm² Solar cable; (+) ≥49.2 in (1250 mm), (-) ≥49.2 in (1250 mm)
Connector	Staubii MC4; IP68

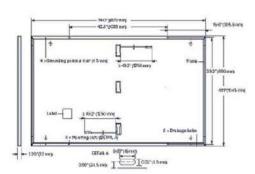

#### ■ Electrical Characteristics

P	OWER CLASS			385	390	395	400	405
М	NIMUM PERFORMANCE AT STANDARD	TEST CONDITIONS, ST	C! (POWER TOLERA)	NCE+5W/-OW)				
	Power at MPP <sup>4</sup>	Prov	[W]	385	390	395	400	405
**	Short Circuit Current <sup>1</sup>	l <sub>sc</sub>	(A)	11.04	11.07	11.10	11.14	11.17
mu	Open Circuit Voltage <sup>1</sup>	Voc	(V)	45.19	45.23	45.27	45.3	45.34
in the	Current at MPP	I <sub>spe</sub>	[A]	10.59	10,65	10.71	10.77	10,83
2	Voltage at MPP	Vser	[V]	36,36	36.62	36,88	37,13	37.39
	Efficiency <sup>1</sup>	n	[96]	≥19.6	≥19.9	≥20.1	≥20.4	≥20.6

#### MINIMUM PERFORMANCE AT NORMAL OPERATING CONDITIONS, NIMOT?

	Power at MPP	Page	[W]	288.8	292.6	296.3	3001	303.8
E	Short Circuit Current	l <sub>sc</sub>	[A]	8,90	8.92	8.95	8.97	9.00
Ĕ	Open Circuit Voltage	Voc	(V)	42.62	42.65	42.69	42.72	42.76
Ž	Current at MPP	lupp	[A]	8.35	8.41	8.46	8.51	8.57
	Voltage at MPP	V <sub>MP</sub>	[V]	34.59	34.81	35,03	35.25	35.46

PERFORMANCE AT LOW IRRADIANCE

#### **Qcells PERFORMANCE WARRANTY**

At least 56 % of nominal power during first year. Thereafter max 0.5% degradation per year. At least 93.5% of nominal power up to 10 years. At least 66 % of nominal power up to 25 years.

All data within measurement tolerances. Full warrantes in accordance with the warranty terms of the Qceils sales organisation of your respective country.

"Standard terms of guarantee for the 5 PV companies with the
highest production capacity in 2021 (February 2021)

TEMPERATURE COEFFICIENTS							
Temperature Coefficient of I <sub>sc</sub>	a	[%/K]	+0.04	Temperature Coefficient of V <sub>∞</sub>	β	[%/14]	-0.27
Temperature Coefficient of P	v	[%/K]	-0.34	Naminal Module Operating Temperature	NMOT	(°F)	109±5.4

#### ■ Properties for System Design

Maximum System Voltage	Vovs	[N]	1000 (IEC)/1000 (UL)	PV module classification	Class II
Maximum Series Fuse Rating		[A DC]	20	Fire Rating based on ANSI/UL 61730	TYPE 2
Max. Design Load, Push/Pull <sup>2</sup>		[lbs/ff <sup>2</sup> ]	75 (3600 Pa) / 55 (2660 Pa)	Permitted Medule Temperature	-40°F up to +185°F
Max Test Load, Push/Pull <sup>3</sup> [ibs/ft <sup>2</sup> ]		113 (5400 Pa) / 84 (4000 Pa)	on Cantinuous Duty	(~40°C up to +85°C)	

<sup>\*</sup>See Installation Manual

#### ■ Qualifications and Certificates

UL 61790, CE-compliant, Quality Controlled PV - TOV Rheinland, IEC 61215/2016, IEC 61730, 2016, U.S. Parent No. 9:893,215 (solar cells).







# *<u>ocells</u>*

#### IQ8 Series Microinverters

INPUT DATA (DC)		108-60-2-US	108PLUS-72-2-US	108M-72-2-US	108A-72-2-US	198H-240-72-2-US	108H-208-72-2-US*	
Commonly used module pairings <sup>2</sup>	W	235 - 350	235 - 440	260 - 460	295 - 500	320 - 540+	295 - 500+	
Module compatibility		60-cell/120 half-cell	19	60-cell/120 half-cell, 6	66-cell/132 half-cell :	and 72-cell/144 half-ce	ell	
MPPT voltage range	У	27 - 37	29 - 45	33-45	36 - 45	38 - 45	38 - 45	
Operating range	y	25 - 48			25 - 58			
Min/max start voltage	٧	30 / 48			30 / 58			
Max input DC voltage	٧	50			60			
Max DC current <sup>3</sup> [module lsc]	A		15					
Overvoltage class DC port			Ī					
DC port backfeed current	mA				5			
PV array configuration		Ixi Ungrounded	array; No additional D	C side protection requ	iired; AC side protect	ion requires max 20A p	er branch circuit	
OUTPUT DATA (AC)		108-60-2-05	IQBPLUS-72-2-US	108M-72-2-US	108A-72-2-US	108H-240-72-2-US	108H-208-72-2-US <sup>1</sup>	
Peak output power	VA	245	300	330	366	384	366	
Max continuous output power	VA	240	290	325	349	380	360	
Nominal (L-L) voltage/range4	y			240 / 211 - 264			208 / 183 - 250	
Max continuous output current	Α	1.0	1.21	1.35	1.45	1.58	1.73	
Nominal frequency	Hz			6	50			
Extended frequency range	Hz			50	- 68			
AC short circuit fault current over 3 cycles	Arms			2			4.4	
Max units per 20 A (L-L) branch circui	t <sup>5</sup>	16	13	11	11	10	9	
Total harmonic distortion				</td <td>5%</td> <td></td> <td></td>	5%			
Overvoltage class AC port				i	п			
AC port backfeed current	mA			3	60			
Power factor setting				1	o			
Grid-tied power factor (adjustable)				0.85 leading	- 0.85 lagging			
Peak efficiency	%	97.5	97.6	97.6	97.6	97.6	97.4	
CEC weighted efficiency	%	97	97	97	97.5	97	97	
Night-time power consumption	mW			6	10			
MECHANICAL DATA		W.						
Ambient temperature range				-40°C to +60°C	(-40°F to +140°F)			
Relative humidity range				4% to 100%	(condensing)			
DC Connector type				M	C4			
Dimensions (HxWxD)				212 mm (8.3°°) x 175 mn	n (6.9°°) x 30.2 mm (1.2	2")		
Weight				1.08 kg (	2.38 lbs)			
Cooling				Natural conve	ction – no fans			
Approved for wet locations				γ	es			
Pollution degree				PI	D3			
Enclosure		Class II double-insulated, corrosion resistant polymeric enclosure						
Environ, category / UV exposure ratin	g			<b>NEMA</b> Туре	6 / outdoor			
COMPLIANCE								
		CA Rule 21 (UL 1741-:	SA), UL 62109-1, UL17	41/IEEE1547, FCC Part	15 Class B, ICES-000	03 Class B, CAN/CSA-	C22.2 NO. 107.1-01	
Certifications			18 Rule 64-218 Rapid	it Down Equipment and I Shutdown of PV Syste				

(1) The IQBH-208 variant will be operating in grid-tied mode only at 208V AC. (2) No enforced DC/AC ratio. See the compatibility calculator at https://link.enphase.com/module-compatibility (3) Maximum continuous input DC current is 10.6A (4) Nominal voltage range can be extended beyond nominal if required by the utility. (5) Limits may vary. Refer to local requirements to define the number of microinverters per branch in your area.

IQ8SE-DS-0001-01-EN-US-2022-03-17

ATLANTIC KEY ENERGY LLC 12600 CHALLENGER PARKWAY

SUITE 200 ORLANDO, FL 32826 1 (407) 988-0273



PROJECT # P-0069816 1 NORTHWEST SCOTT GLEN LAKE CITY, FL 32055 KAYLA ROTH RESIDENCE 291

SIGNATURE WITH SEAL

REVISIONS DESCRIPTION DATE REV

04/06/2023

SHEET NAME **EQUIPMENT SPECIFICATIONS** 

SHEET NUMBER

E-3

#### Enphase IQ Combiner 4/4C

MODEL NUMBER			
IQ Combiner 4 (X IQ AM1 240-4)	Q Combiner 4 with Enphase  Q Sateway printed circuit board for integrated revenue grade PV production metering (ANSI 012.20 +/-0.5%) and consumption monitoring (+/-2.5%). Includes a silver solar shield to match the IQ Battery system and IQ System Controller 2 and to deflect heat.		
IQ Combiner 4C (X-IQ-AM1-240-4C)	IQ Combiner 4C with Enphase IQ Gateway printed circuit board for integrated revenue grade PV production meter (ANSI C12.20 +/-0.5%) and consumption monitoring (+/-2.5%). Includes Enphase Mobile Connect cellular moden (CELL MODEM-MT-06-SP-05), a plug-and-play industrial-grade cell modern for systems up to 60 microinverters. (Available in the US, Canada, Mexico, Puerto Rico, and the US Virgin Islands, where there is adequate cellular servi the installation area,) includes a silver solar shield to match the IQ Battery and IQ System Controller and to deflec		
ACCESSORIES AND REPLACEMENT PARTS	(not included, order separately)		
Ensemble Communications Kit COMMS-CELLMODEM-M1-06 CELLMODEM-M1-06-SP-05 CELLMODEM-M1-06-AT-05	<ul> <li>Includes COMMS-KIT-01 and CELLMODEM-M1-06-SP-05 with 5-year Sprint data plan for Ensemble sites</li> <li>40 based LTE-M1 cellular modern with 5-year Sprint data plan</li> <li>46 based LTE-M1 cellular modern with 5-year AT&amp;T data plan</li> </ul>		
Circuit Breakers BRK-10A-2-240V BRK-15A-2-240V BRK-20A-2P-240V BRK-15A-2P-240V-B BRK-20A-2P-240V-B	Supports Eaton BR210, BR215, BR220, BR230, BR240, BR250, and BR260 circuit breakers. Circuit breaker, 2 pole, 10A, Eaton BR210 Circuit breaker, 2 pole, 15A, Eaton BR215 Circuit breaker, 2 pole, 20A, Eaton BR220 Circuit breaker, 2 pole, 15A, Eaton BR2158 with hold down kit support Circuit breaker, 2 pole, 20A, Eaton BR2208 with hold down kit support		
EPLC-01	Power line carrier (communication bridge pair), quantity - one pair		
XA-SOLARSHIELD-ES	Replacement solar shield for IQ Combiner 4/4C		
XA-PLUG-120-3	Accessory receptable for Power Line Carrier in 1Q Combiner 4/4C (required for EPLC-01)		
XA-ENV-PCBA-3	Replacement IQ Gateway printed circuit board (PCB) for Combiner 4/4C		
X-IQ-NA-HD-125A	Hold down kit for Eaton circuit breaker with screws.		
ELECTRICAL SPECIFICATIONS			
Rating	Continuous duty		
System voltage	120/240 VAC, 60 Hz		
Eaton BR series bushar rating	125 A		
Max. continuous current rating	65A		
Max. continuous current rating (Input from PV/storage)	64 A		
Max. fuse/circuit rating (output)	90 A		
Branch circuits (solar and/or storage)	Up to four 2-pole Eaton BR series Distributed Generation (DG) breakers only (not included)		
Max. total branch circuit breaker rating (input)	80A of distributed generation / 95A with IQ Gateway breaker included		
Production metering CT	200 A solid core pre-installed and wired to IQ Gateway		
Consumption monitoring CT (CT-200-SPLIT)	A pair of 200 A split core current transformers		
MECHANICAL DATA			
Dimensions (WxHxD)	37.5 x 49.5 x 16.8 cm (14.75" x 19.5" x 6.63"). Height is 21.06" (53.5 cm) with mounting brackets.		
Weight	7.5 kg (16.5 lbs)		
Ambient temperature range	-40° C10 +46° C (-40° to 115° F)		
Cooling	Natural convection, plus heat shield		
Enclosure environmental rating	Outdoor, NRTL-certified, NEMA type 3R, polycarbonate construction		
Wire sizes	20 A to 50 A breaker inputs: 14 to 4 AWG copper conductors 60 A breaker branch input: 4 to 1/0 AWG copper conductors Main fug combined output: 10 to 2/0 AWG copper conductors Neutral and ground: 14 to 1/0 copper conductors Always follow local code requirements for conductor sizing.		
Altitude	To 2000 meters (6,560 feet)		
INTERNET CONNECTION OPTIONS			
Integrated Wi-Fi	802.11b/g/n		
Cellular	CELLMODEM-M1-D6-SP-05, CELLMODEM-M1-06-AT-05 (4G based LTE-M1 cellular modern). Note that an Enphase Mobile Connect cellular modern is required for all Ensemble installations.		
Ethernet	Optional, 802.3, Cat5E (or Cat 6) UTP Ethernet cable (not included)		
COMPLIANCE			
Compliance, Q Combiner	UL 1741, CAN/CSA C22.2 No. 107.1, 47 CFR, Part 15, Class B, ICES 003 Production metering: ANSI C12.20 accuracy class 0.5 (PV production) Consumption metering: accuracy class 2.5		

To learn more about Enphase offerings, visit enphase.com
© 2021 Enphase Energy, All rights reserved, Enphase, the Enphase logo, IQ Combiner 4/4C, and other names are trademarks of Enphase Energy, Inc. Data subject to change. 10-21-2021



12600 CHALLENGER PARKWAY SUITE 200 ORLANDO, FL 32826 1 (407) 988-0273

KAYLA ROTH RESIDENCE PROJECT # P-0069816 291 NORTHWEST SCOTT GLEN LAKE CITY, FL 32055

SIGNATURE WITH SEAL

REVISIONS DESCRIPTION DATE REV

04/06/2023

**⊖** ENPHASE.

SHEET NAME **EQUIPMENT** 

**SPECIFICATIONS** SHEET NUMBER

E-4

# The Right Way!™

## ProteaBracket<sup>™</sup>

A versatile bracket for mounting solar PV to trapezoidal roof profiles

profiles!

trapezoidal

attach solar

5

right

ProteaBracket™ is now made in aluminum. Still the most versatile trapezoidal metal roof attachment solution on the market, the S-5! ProteaBracket just got better!

The bracket features an adjustable attachment base and module attachment options to accommodate different roof profile dimensions and mounting options.

Our pre-applied EPDM gasket with peel and stick adhesive makes installation a snap, ensuring accurate and secure placement the first time.

With no messy sealants, faster installation, and a weather-proof fit, ProteaBracket offers you the most versatile solar attachment solution available.

ProteaBracket\* can be used for rail mounting or "direct-attach" with S-5! PVKIT™

\*When ProteaBracket is used in conjunction with the 5-5! PVKIT,



**NOW AVAILABLE IN ALUMINUM** 



## **Features and Benefits**

- · 34% lighter saves on shipping
- Stronger L-Foot™
- Load-tested for engineered application
- Corrosion-resistant materials
- Adjustable Fits rib profiles up to 3"
- Peel-and-Stick prevents accidental shifting during installation
- · Fully pre-assembled
- 25-year warranty\*

\*See www.S-5.com for details

888-825-3432 | www.S-5.com |

ProteaBracket™ is the perfect solar attachment solution for most trapezoidal rib, exposed-fastened metal roof profiles!

ProteaBracket™ is compatible with common metal roofing materials and comes with a pre-applied EPDM gasket on

Note: All four pre-punched holes must be used to achieve tested strength


For design assistance, ask your distributor, or visit www.S-5.com for the independent lab test data that can be used for load-critical designs and applications. Also, please visit our website for more information including metallurgical compatibilities and specifications.

S-5!° holding strength is unmatched in the industry.


### Multiple Attachment Options:



Side Mount Rail

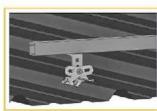


Bottom Mount Rail

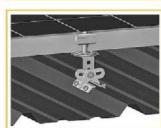

w/S-5! PVKIT™ (rail-less)

ProteaBracket<sup>TN</sup>

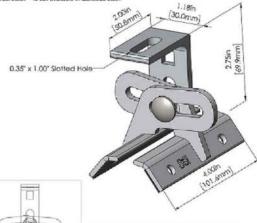

ProteaBracket fits profiles up to 3 inches

No surface preparation needed. (1) Wipe away excess oil and debris. (2) Peel off adhesive release paper. (3) Align and mount bracket directly onto crown of panel. (4) Secure ProteaBracket through pre-punched holes, using piercing-point S-5l screws.



Distributed by

5-5!° Warning! Please use this product responsibly!

Products are protected by multiple U.S. and foreign patents. For published data regarding holding strength, bolt torque, patents, and trademarks, visit the S-SI website at www.S-S.com.

Copyright 2019, Metal Roof Innovations, Ltd. 5-91 products are patent protected. 5-91 aggressively protects its patents, snademarks, and copyrights. Version 07089.

04/06/202 SHEET NAME

ATLANTIC KEY ENERGY LLC 12600 CHALLENGER PARKWAY SUITE 200 ORLANDO, FL 32826

1 (407) 988-0273

EN

PROJECT # P-0069816 NORTHWEST SCOTT GL

291

SIGNATURE WITH SEAL

REVISIONS

DATE

REV

DESCRIPTION

LAKE CITY,

KAYLA ROTH RESIDENCE

**EQUIPMENT SPECIFICATIONS** 

SHEET NUMBER S-1

# SOLARMOUNT



**SOLARMOUNT** defined the standard in solar racking. Features are designed to get installers off the roof faster. Our grounding & bonding process eliminates copper wire and grounding straps to reduce costs. Systems can be configured with standard or light rail to meet your design requirements at the lowest cost possible. The superior aesthetics package provides a streamlined clean edge for enhanced curb appeal, with no special brackets required for installation.











Featuring Google Map Capabilities within U-Builder

# **FAST INSTALLATION. SUPERIOR AESTHETICS**

OPTIMIZED COMPONENTS . VERSATILITY . DESIGN TOOLS . QUALITY PROVIDER

# SOLARMOUNT

# **#UNIRAC**


# **OPTIMIZED COMPONENTS** INTEGRATED BONDING & PRE-ASSEMBLED PARTS

labor time. Our new grounding & bonding process eliminates copper wire and grounding straps or bonding jumpers to reduce costs. Utilize the micromverter mount with a wire

#### ONE PRODUCT - MANY APPLICATIONS

Quickly set modules flush to the roof or at a desired tilt angle. Change module to outperform your projects financial and aesthetic aspirations

Save time by creating a user profile, and recall preferences and projects automatically when you log in. You will enjoy the ability to share projects with customers: there's no

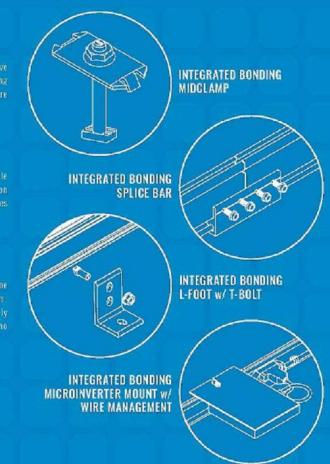



A

## UNIRAC CUSTOMER SERVICE MEANS THE HIGHEST LEVEL OF PRODUCT SUPPORT













#### TECHNICAL SUPPORT

#### CERTIFIED QUALITY PROVIDER

#### **BANKABLE WARRANTY**

Don't leave your project to chance. Unirac has the financial strength to back our products and reduce your risk. Have peace quality. SOLARMOUNT is covered by a twenty five (25) year

PROTECT YOUR REPUTATION WITH QUALITY RACKING SOLUTIONS BACKED BY ENGINEERING EXCELLENCE AND A SUPERIOR SUPPLY CHAIN

ATLANTIC KEY ENERGY LLC 12600 CHALLENGER PARKWAY

SUITE 200 ORLANDO, FL 32826 1 (407) 988-0273



PROJECT # P-0069816 NORTHWEST SCOTT GL KAYLA ROTH RESIDENCE LAKE CITY, FL

SIGNATURE WITH SEAL

REVISIONS DESCRIPTION DATE

> 04/06/202 SHEET NAME

**EQUIPMENT SPECIFICATIONS** 

SHEET NUMBER

S-2