

76'-0" 25'-4"

25'-4"


CONCRETE/MASONRY NOTES:

- 1. VERIFY ALL DETAILS AND DIMENSIONS WITH EXISTING CONDITIONS, ARCHITECTURAL DOCUMENTS AND PROPERLY COORDINATED APPROVED SHOP DRAWINGS.
- 2. EXPANSION AND CONTROL JOINTS ARE TO BE PLACED PER A.C.I. RECOMMENDATIONS. PREPARE A CRACK CONTROL PLAN BASED ON CONSTRUCTION SEQUENCING AND PROPOSED ACTUAL FLOOR AND WALL FINISHES AND SUBMIT TO THE ARCHITECT/ENGINEER FOR APPROVAL PRIOR TO CONSTRUCTION.
- 2.1. NO CONTROL JOINT SHALL INTERSECT AN ADJACENT CONTROL JOINT AT AN ANGLE <90°.
- 2.2. CONTROL JOINTS SHALL ONLY INTERSECT A CURB OR OTHER STRUCTURAL MEMBER AT
- 3. PROVIDE 48 BAR DIAMETER MINIMUM LAP.
- 4. ALL FOOTING BOTTOMS MUST BE PLACED A MINIMUM OF 12" BELOW FINISH GRADE.

TERMITE NOTES:

- 1. A PERMANENT SIGN WHICH IDENTIFIES THE TERMITE TREATMENT PROVIDER AND NEED FOR RE-INSPECTION AND TREATMENT CONTRACT RENEWAL SHALL BE PROVIDED. THE SIGN SHALL BE POSTED NEAR THE WATER HEATER OR ELECTRIC PANEL.
- 2. CONDENSATE AND ROOF DOWN SPOUTS SHALL DISCHARGE 1'-0" AWAY FROM BUILDING SIDE WALLS.
- 3. IRRIGATION/SPRINKLER SYSTEM INCLUDING ALL RISERS AND SPRAY HEADS SHALL NOT BE INSTALLED WITHIN 1'-0" OF THE BUILDING SIDE WALLS.
- 4. TO PROVIDE FOR INSPECTION FOR TERMITE INFESTATION THE DISTANCE BETWEEN WALL COVERING AND FINAL EARTH GRADE SHALL NOT BE LESS THAN 6". EXCEPTION: PAINT OR DECORATIVE CEMENTITIOUS FINISH LESS THAN 5/8" THICK ADHERED DIRECTLY TO THE FOUNDATION WALL.
- 5. INITIAL TREATMENT SHALL BE DONE AFTER ALL EXCAVATION AND BACKFILL IS COMPLETE.
- 6. SOIL DISTRIBUTED AFTER THE INITIAL TREATMENT SHALL BE RE-TREATED INCLUDING SPACES BOXED AND FORMED.
- 7. BOXED AREAS IN CONCRETE FLOORS FOR SUBSEQUENT INSTALLATIONS OF TRAPS, ETC., SHALL BE MADE WITH PERMANENT METAL OR PLASTIC FORMS. PERMANENT FORMS MUST BE THE SIZE AND DEPTH THAT WILL ELIMINATE THE DISTURBANCE OF SOIL AFTER THE INITIAL TREATMENT.
- 8. MINIMUM 6 MIL RETARDER MUST BE INSTALLED TO PROTECT AGAINST RAINFALL DILUTION. IF RAINFALL OCCURS BEFORE VAPOR RETARDER PLACEMENT, PRETREATMENT IS REQUIRED.
- 9. CONCRETE OVER POUR AND MORTAR ALONG THE FOUNDATION PERIMETER MUST BE REMOVED BEFORE EXTERIOR SOIL TREATMENT.
- 10. SOIL TREATMENT MUST BE APPLIED UNDER ALL EXTERIOR CONCRETE OR GRADE WITHIN 1'-0" OF THE STRUCTURE SIDEWALLS.
- 11. AN EXTERIOR VERTICAL CHEMICAL BARRIER MUST BE INSTALLED AFTER CONSTRUCTION IS COMPLETE INCLUDING LANDSCAPING AND IRRIGATION ANY SOIL DISTRIBUTED AFTER THE VERTICAL BARRIER IS APPLIED, SHALL BE RETREATED.
- 12. ALL BUILDING ARE REQUIRED TO HAVE PRE-CONSTRUCTION TREATMENT.
- 13. A CERTIFICATE OF COMPLIANCE MUST BE ISSUED TO THE BUILDING DEPARTMENT BY A LICENSED PEST CONTROL COMPANY BEFORE A CERTIFICATE OF OCCUPANCY WILL BE ISSUED. THE CERTIFICATE OF COMPLIANCE SHALL STATE: "THE BUILDING HAS RECEIVED A COMPLETE TREATMENT FOR THE PREVENTION OF SUBTERRANEAN TERMITES THE TREATMENT IS IN ACCORDANCE WITH THE RULES AND LAWS OF THE FLORIDA DEPARTMENT OF AGRICULTURE AND CONSUMER SERVICES."
- 14. AFTER ALL WORK IS COMPLETED, LOOSE WOOD AND FILL MUST BE REMOVED FROM BELOW AND WITHIN 1'-0" OF THE BUILDING. THIS INCLUDES ALL GRADE STAKES, TUB TRAP BOXES, FORMS, SHORING OR OTHER CELLULOSE CONTAINING MATERIAL.
- 15. NO WOOD, VEGETATION, STUMPS, CARDBOARD, TRASH, ETC., SHALL BE BURIED WITHIN 15'-0" OF ANY BUILDING OR PROPOSED BUILDING.



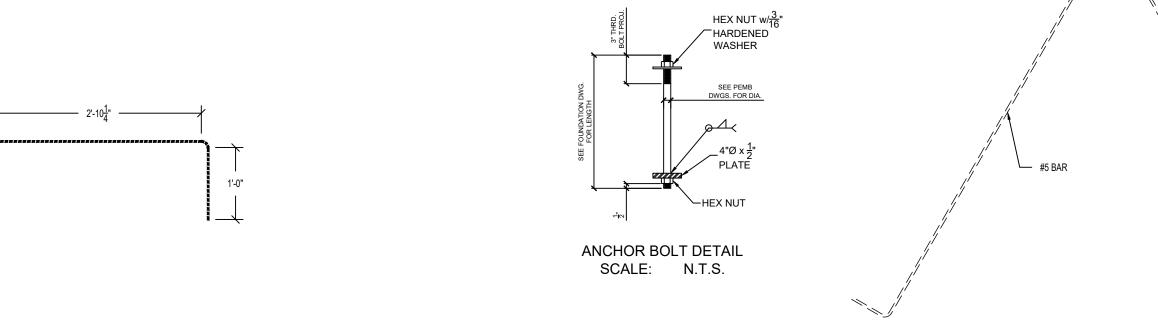


SLAB TIE DETAIL SCALE: $\frac{3}{4}$ " = 1'-0"


HAIRPIN DETAIL SCALE: $\frac{3}{4}$ " = 1'-0"



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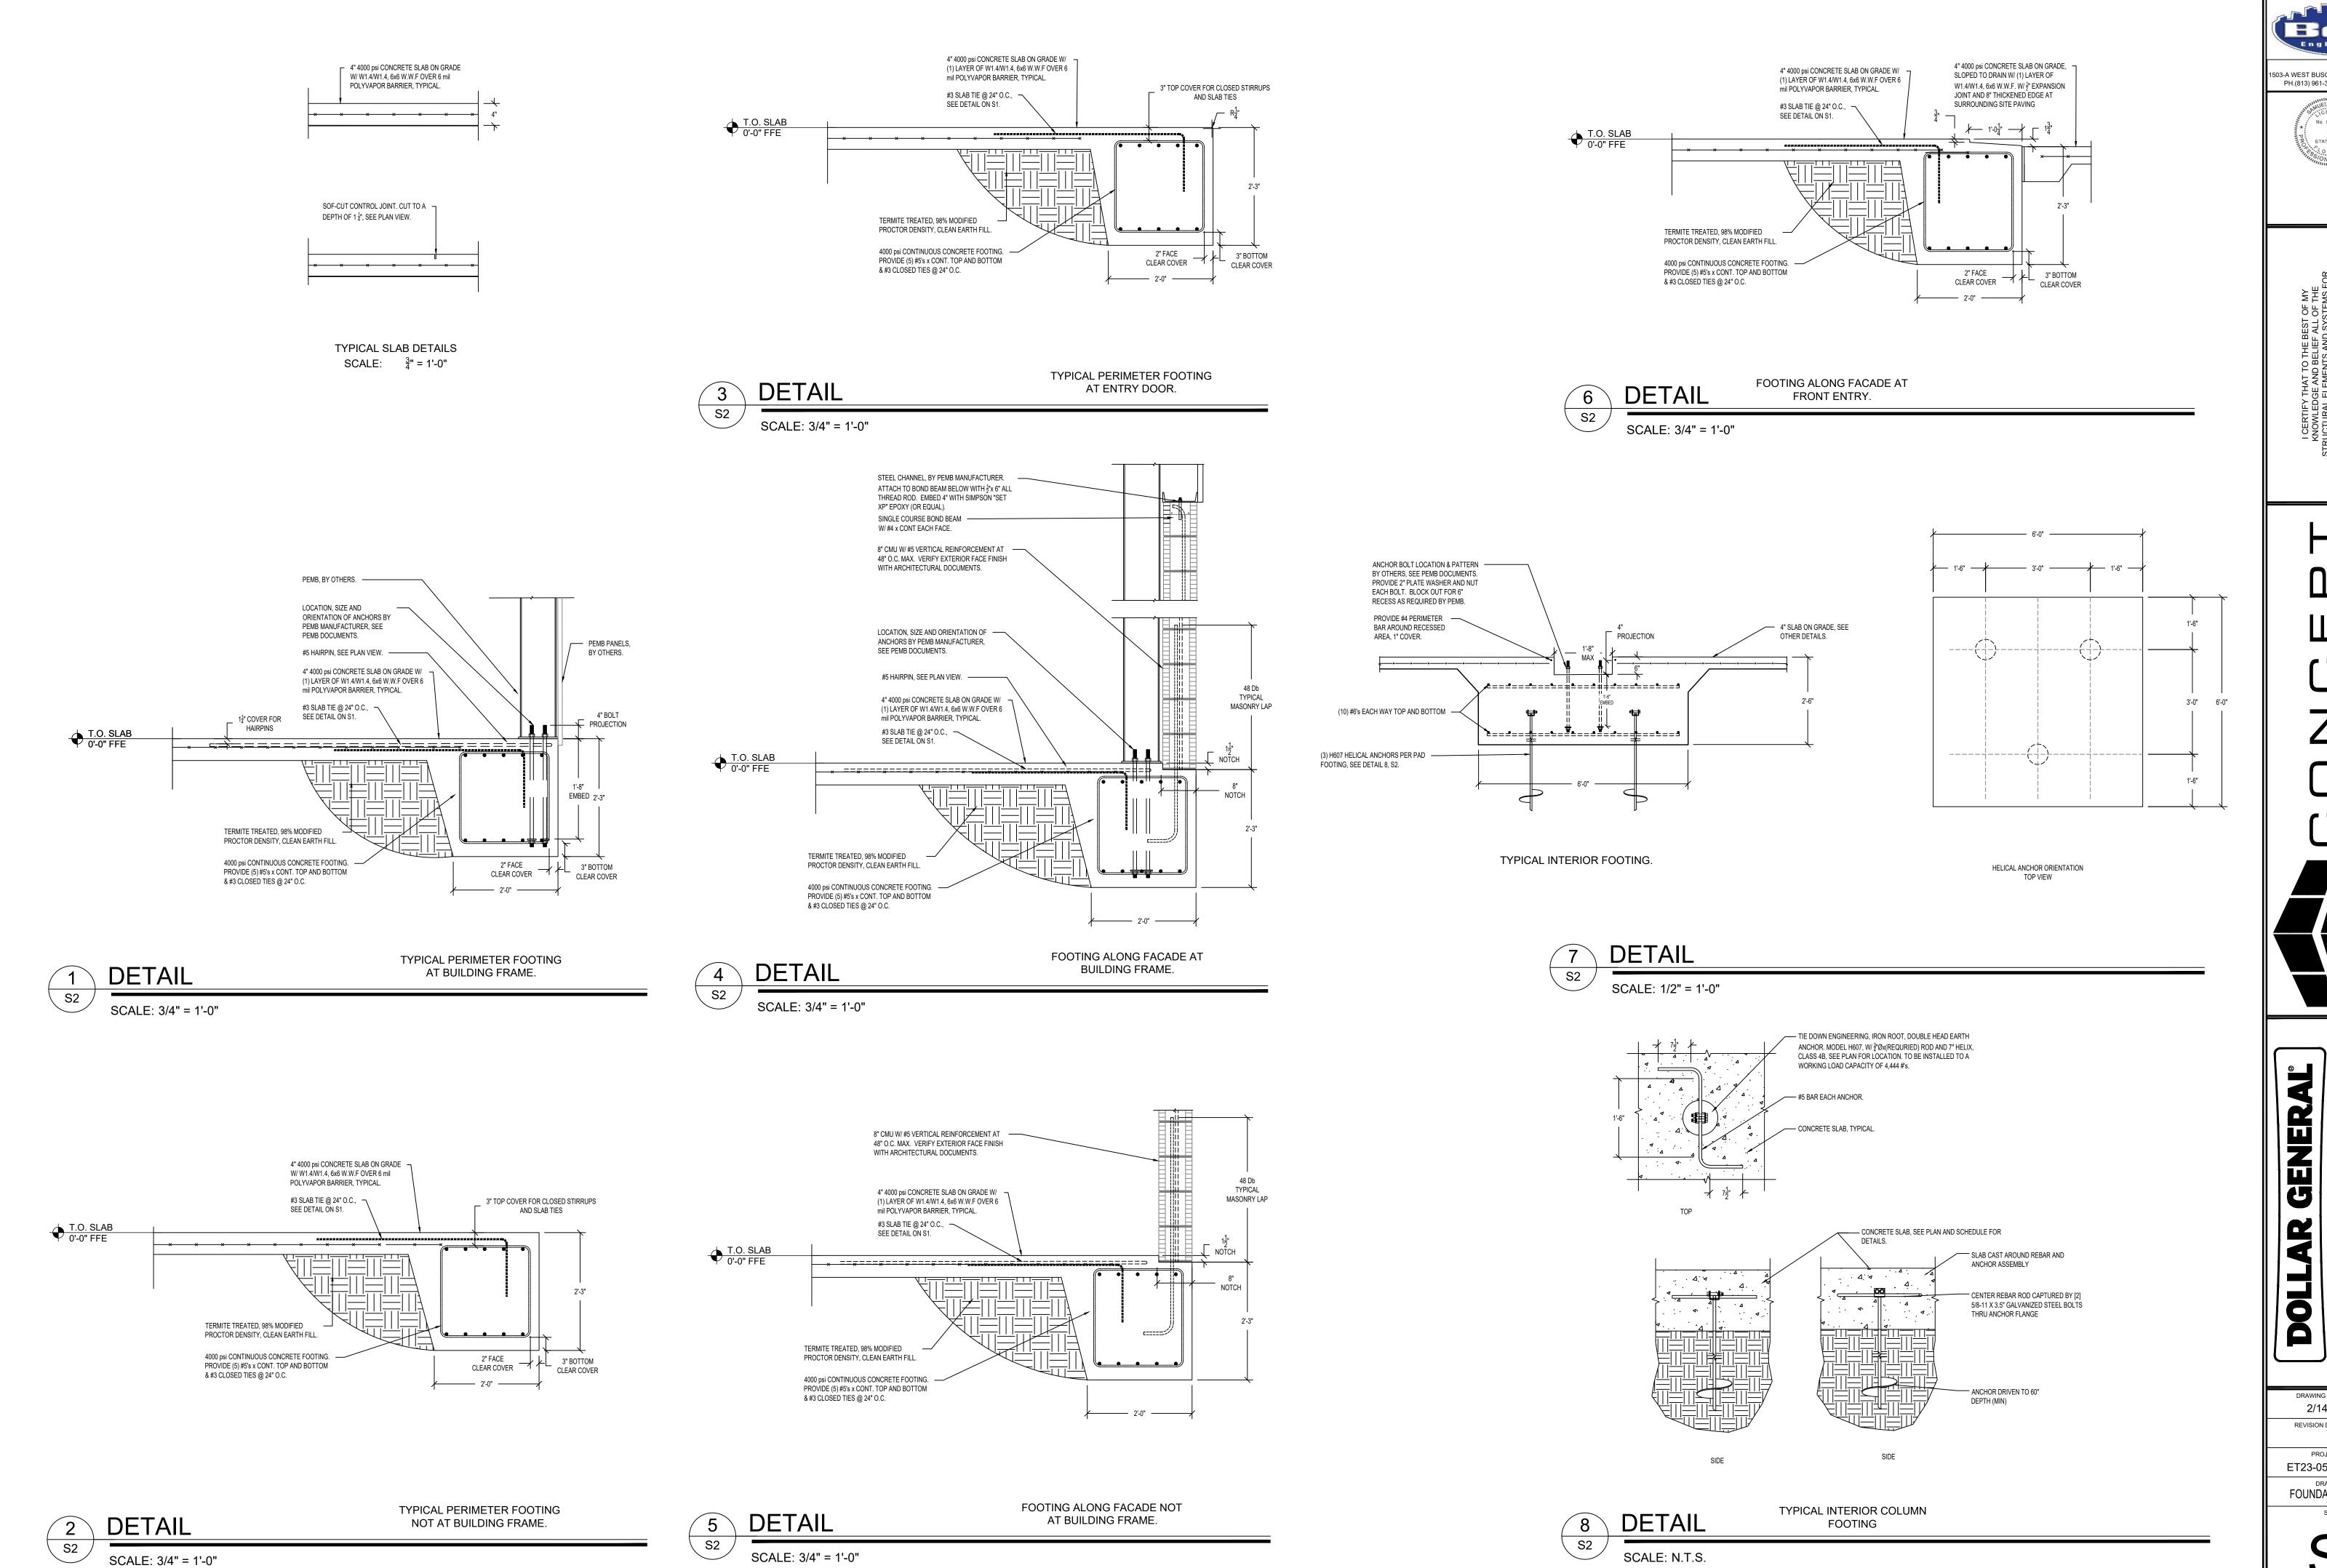
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DRAWING DATE: / DRAWN BY 2/14/24 - VBC REVISION DATE: / REVISED BY:

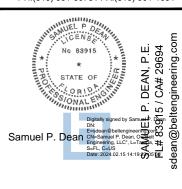PROJECT NUMBER: ET23-0545 / 4000.249 DRAWING TITLE: FOUNDATION PLAN

SHEET NO.

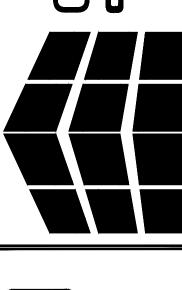

BELLE Engineering

1503-A WEST BUSCH BLVD. / TAMPA, FL 33612 PH.(813) 961-3075 / FX.(813) 961-1031

SAMUEL P. DEAN, P.E. FL# 83915 / CA# 29694

KNOWLEDGE AND BELIEF ALL OF THE KNOWLEDGE AND BELIEF ALL OF THE STRUCTURAL ELEMENTS AND SYSTEMS FOR IIS STRUCTURE HAVE BEEN DESIGNED TO BE A COMPLIANCE WITH THE FLORIDA BUILDING DESITION 2023. ALL OTHER ELEMENTS, SYSTEMS AND ASSEMBLIES ARE THE RESPONSIBILITY OF THE BUILDER.

O M Dr. Su 200 / GAINESVILLE, FL 32607 LICENCE# CGC-1515491 PH: 877-309-1029 / FAX: 800-218-7809

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T.B.D. US HW FORT WHITE, FI

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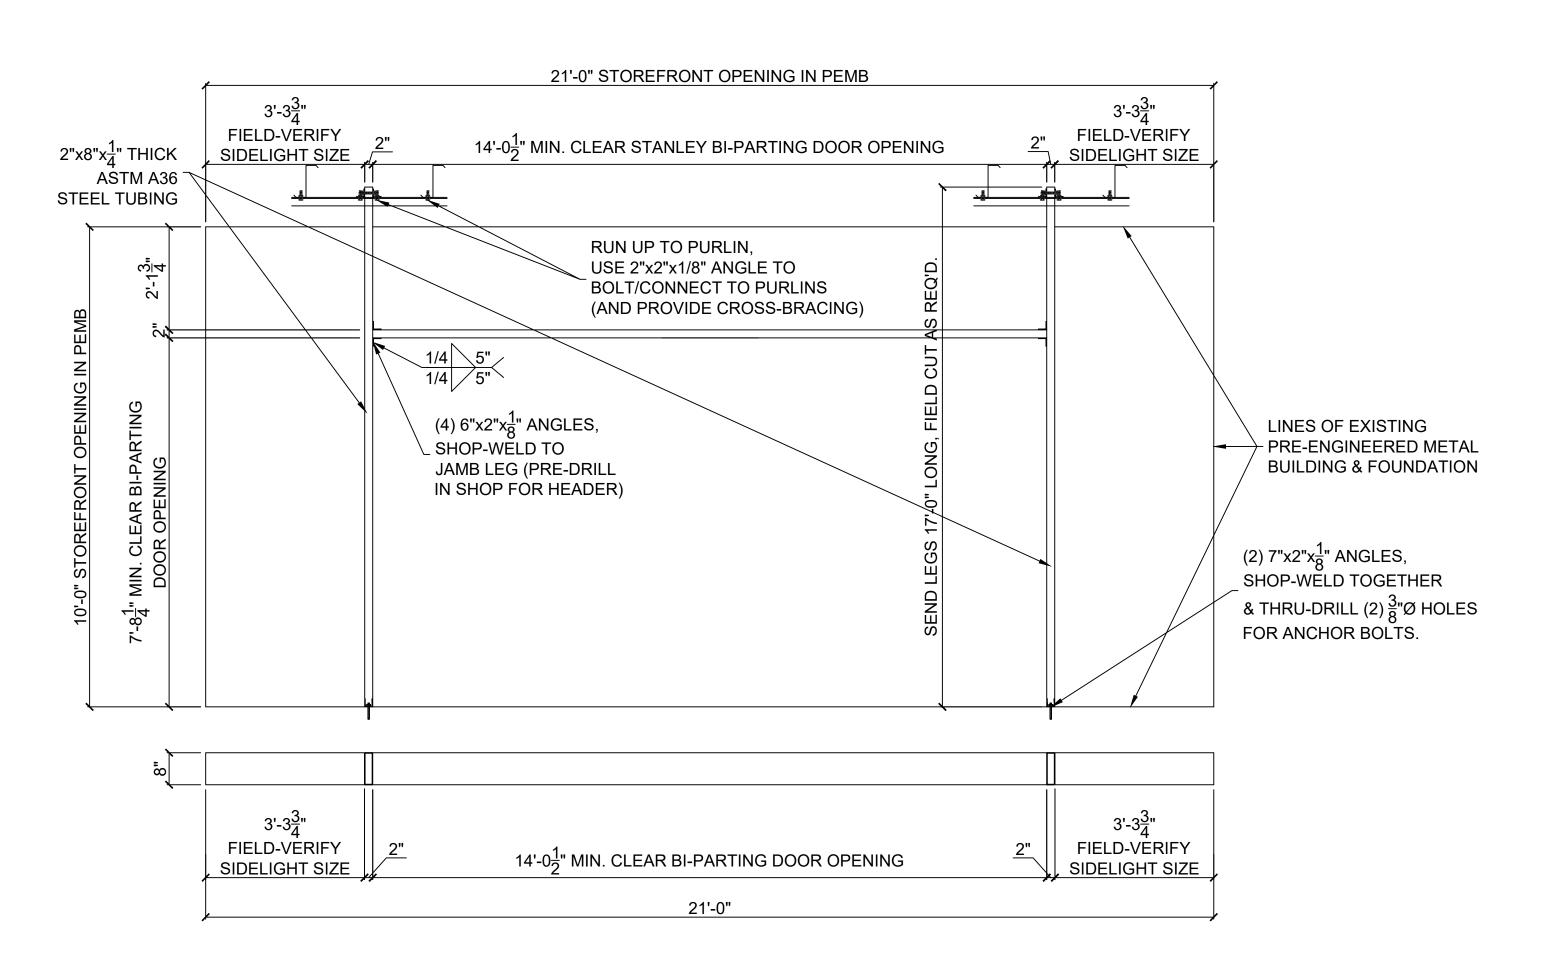
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DRAWING TITLE:
FOUNDATION DETAILS

S2



ADAPTER AS REQ'D., /-INSTALL PER MFG'S **SPECIFICATIONS** ALL EXPOSED CONCRETE TO HAVE RUBBED FINISH LIGHT FIXTURE: AS SELECTED BY OWNER (SEE CIVIL / PHOTOMETRIC DRAWINGS) METAL POLE, HARRIS LIGHT POLE: HARRIS HW-HID-20POLE4R HW-HID-20POLE4R (OR EQUIV., INSTALL PER MANUFACTURERS SPECS) (OR EQUIV.) FLUSH HAND-HOLE AND COVER-PLATE EXTEND, AS SHOWN WHERE SUBJECT TO CAR DAMAGE, EXTEND REBAR AS REQ'D. 1" CHAMFER (ALL AROUND_ TOP EDGE) w/45° ANGLE 3/4"x30"x3" ANCHOR -BOLTS w/NUTS AND WASHERS (TYP. 4) FINISHED GRADE FOR WALKWAY LIGHTING 3/4" CONDUIT (IN CONC.) PROVIDE FOUR (4) EQ.
SPACED #4 REBAR TIES 30"Ø x 54" SONOTUBE w/ A MIN. OF EIGHT (8) #7 EQ. SPACED VERT. FORM BARS (MAINTAIN A MIN. OF 3" CLEARANCE FROM FOOTING SURFACES w/ GROUND CONTACT) UL LISTED GROUNDING UNDISTURBED_ 2'-6" ROD, PER ELECTRICAL ENGINEER SPECS.

LIGHT POLE DESIGN CRITERIA:

BASIS OF DESIGN

ALL CONSTRUCTION IS DESIGNED AS FOLLOWS FLORIDA BUILDING CODE 8th EDITION (2023)

WIND LOADS
ASCE 7-22, 121 MPH WIND (ULT); 94 MPH (NOMINAL)
SIGNS ANALYTICAL METHOD
STRUCTURE CATEGORY II
TERRAIN EXPOSURE "B"
BASIC WIND PRESSURE; q= 30.1 P.S.F.
* TREATED AS SIGNAGE


DETAIL S3


SCALE: 1/2" = 1'-0"


STEEL FRAME AT FRONT ENTRY.


2 DETAIL
S3 SCALE: 1/2" = 1'-0"


LIGHT POLE

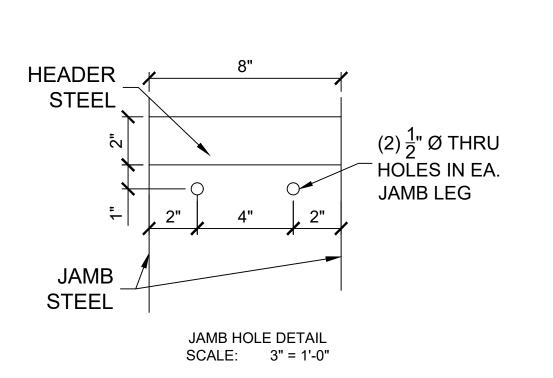

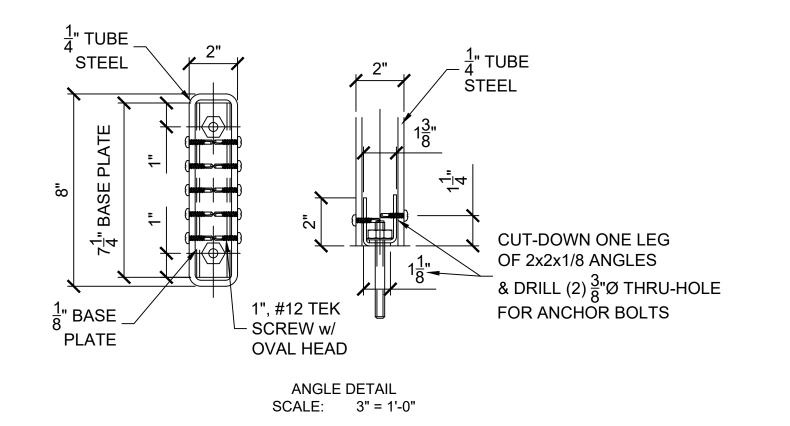

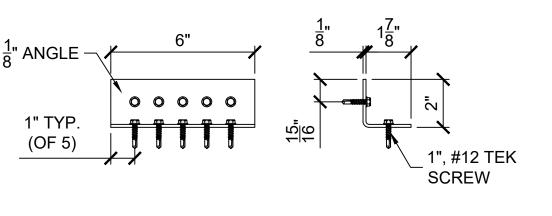

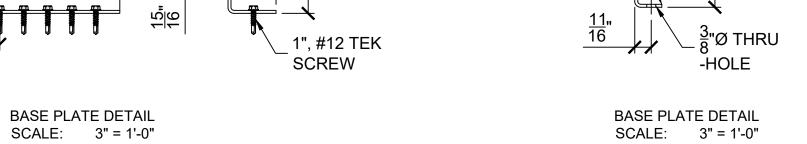


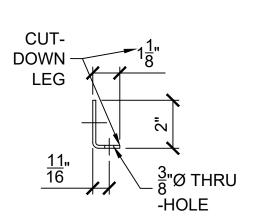

CODE 8TH SYST RES

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DOLLAR GENERAL

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DRAWING TITLE:
STEEL DETAILS

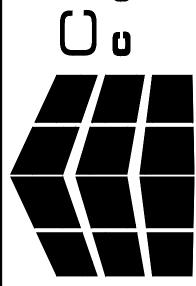S3