



HEADER & STUD PATTERNS

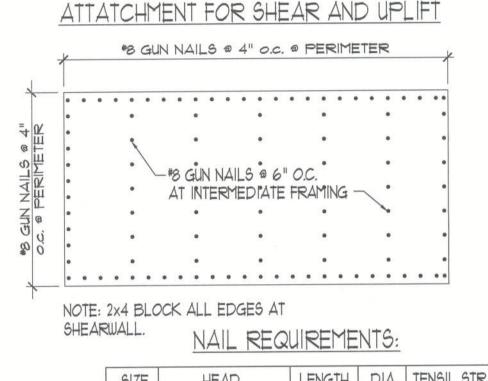


SIZE	ZE HEAD LENGTH D			A. TENSIL STR	
8d	ROUND, MODIFIED 2 1/2" OR T	.131	170,000		
10d	11 11	3"	.148	170,000	
NOTES:	1 NAILS TO BE MF AND TOOL ASSO 2 GUN NAILS SHAL ACCEPTABLE F	OCIATION L BE PER	MITTED	AS AN	

SCALE: N.T.S.

NAILING PATTERNS

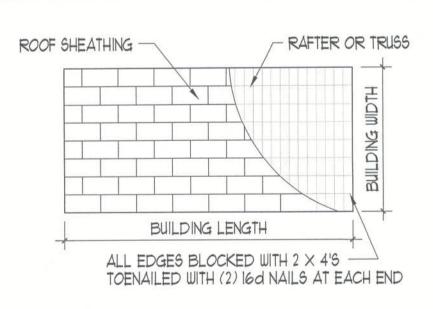


GABLE END & SHEATHING LAYOUT

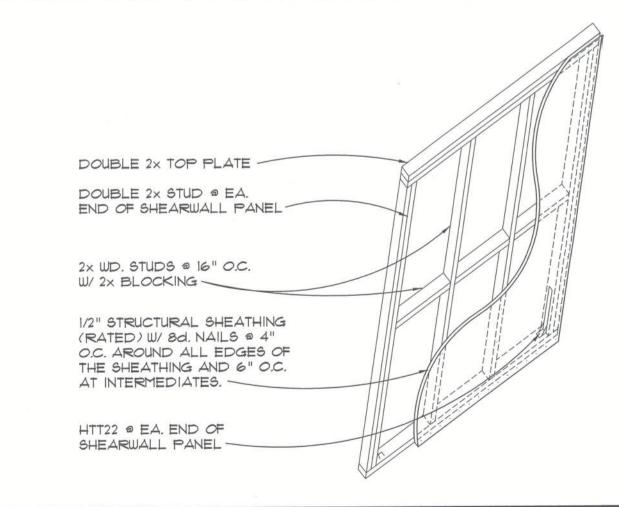

5 Frame Wall Section 9CALE:3/4"=1'-0" (3 9IDE9 ONLY. SEE 4/91.) SHEARWALL PANEL

SOLID BEARING

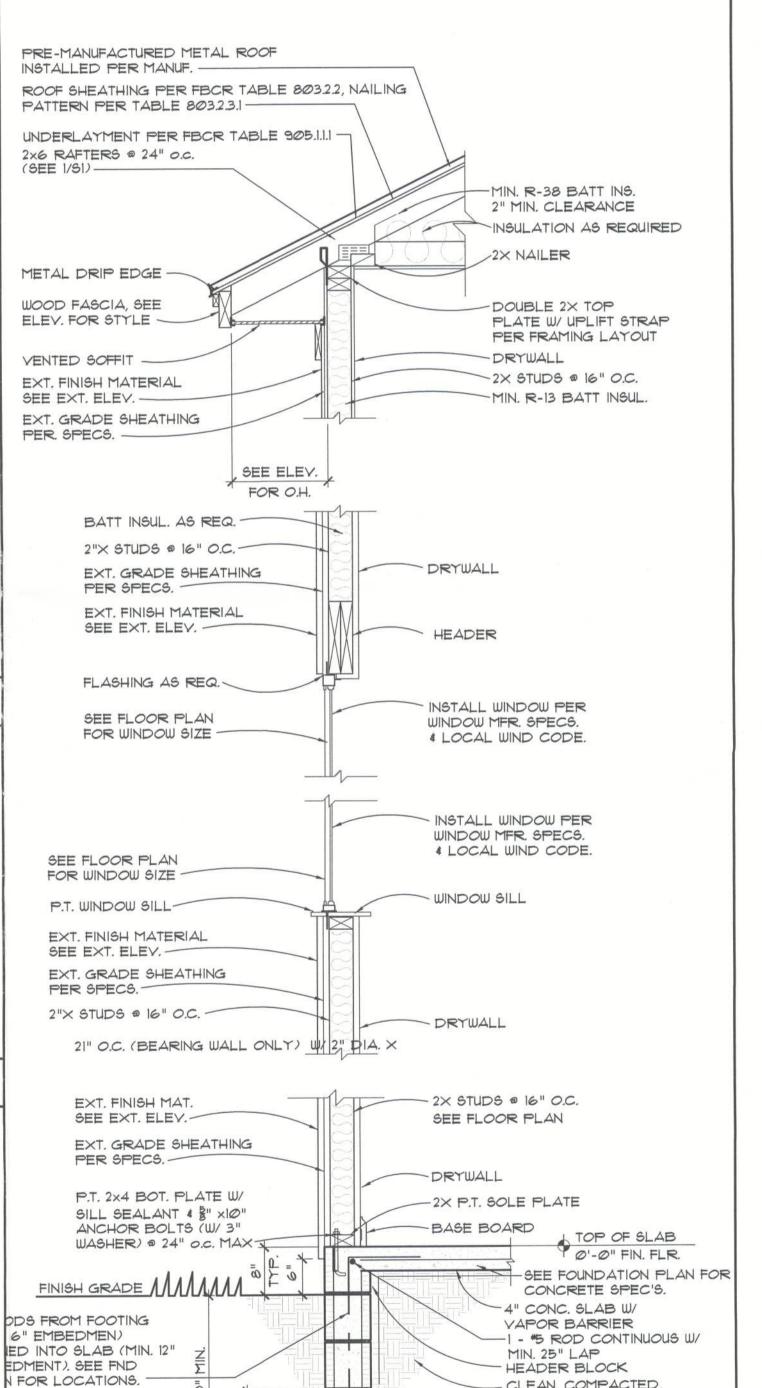


20"


CLEAN, COMPACTED,


25" MIN. OVERLAP


TERMITE TREATED FILL.

- 2-45 RODS CONTINUOUS W/

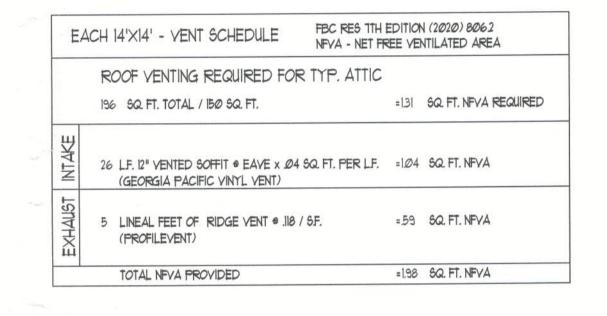

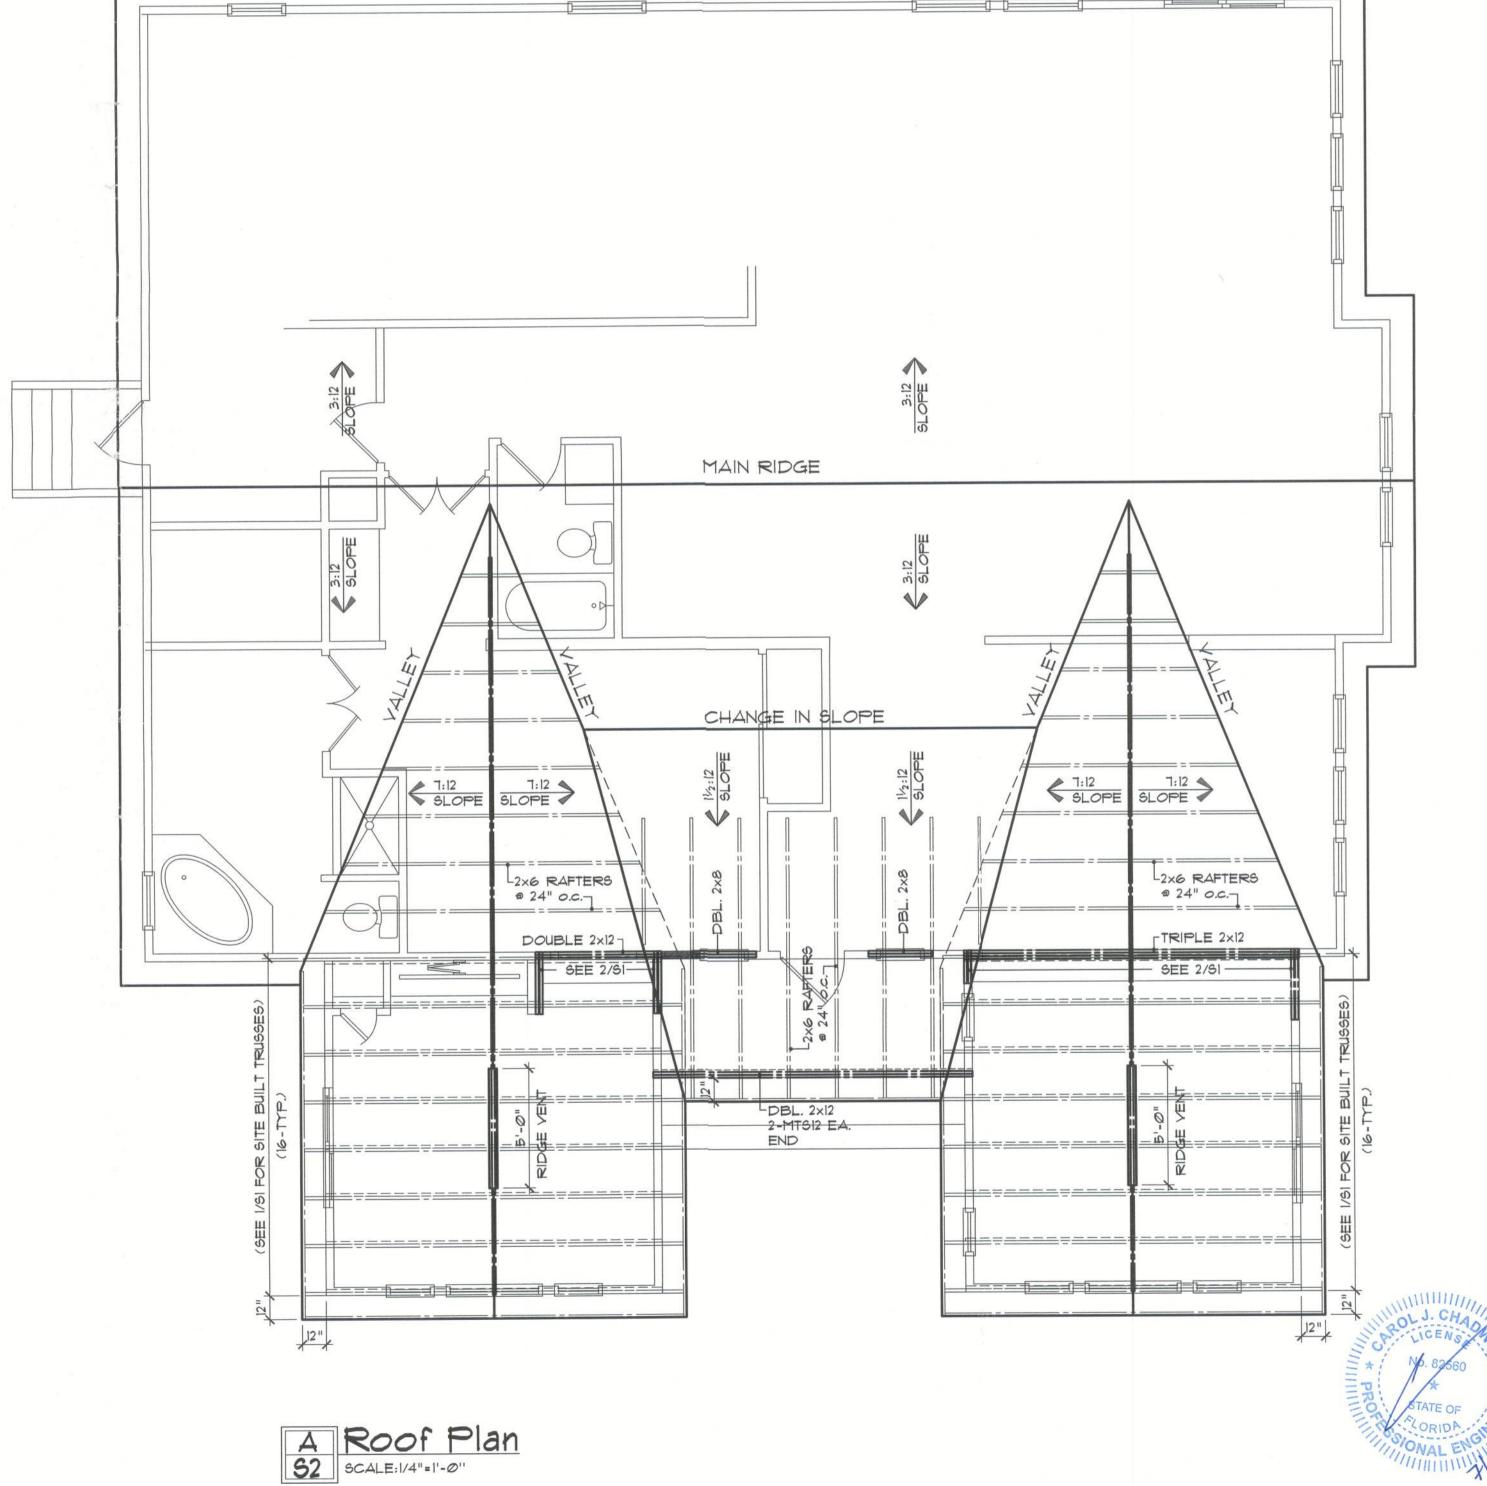

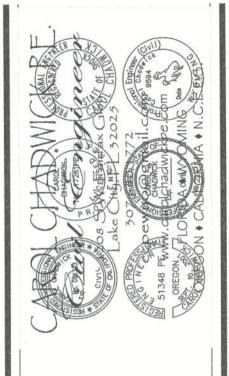


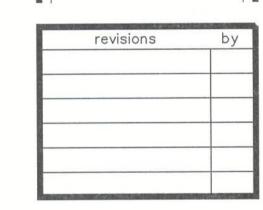





CAROL CHADWICK, PE FLORIDA #82560 LEWIS drawn by checked DA date 07/18/22 scale AS NOTED drawing no.




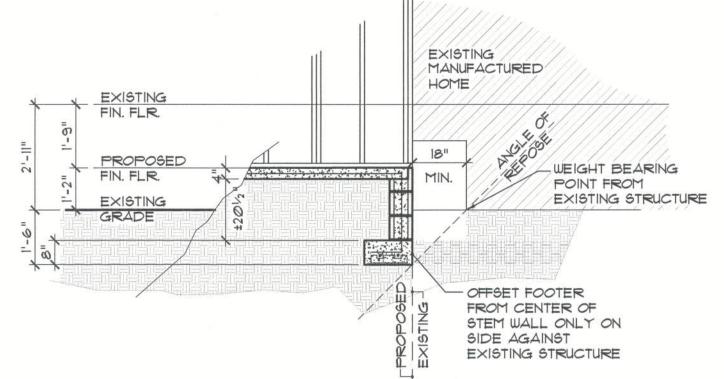




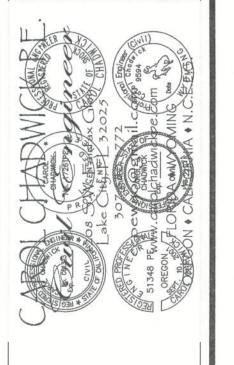

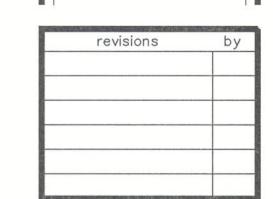


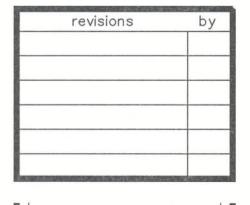

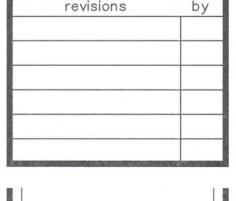



ESZT NET

CAROL CHADWICK, PE FLORIDA #82560 LEWIS drawn by DA checked DA 07/18/22 scale AS NOTED drawing no.

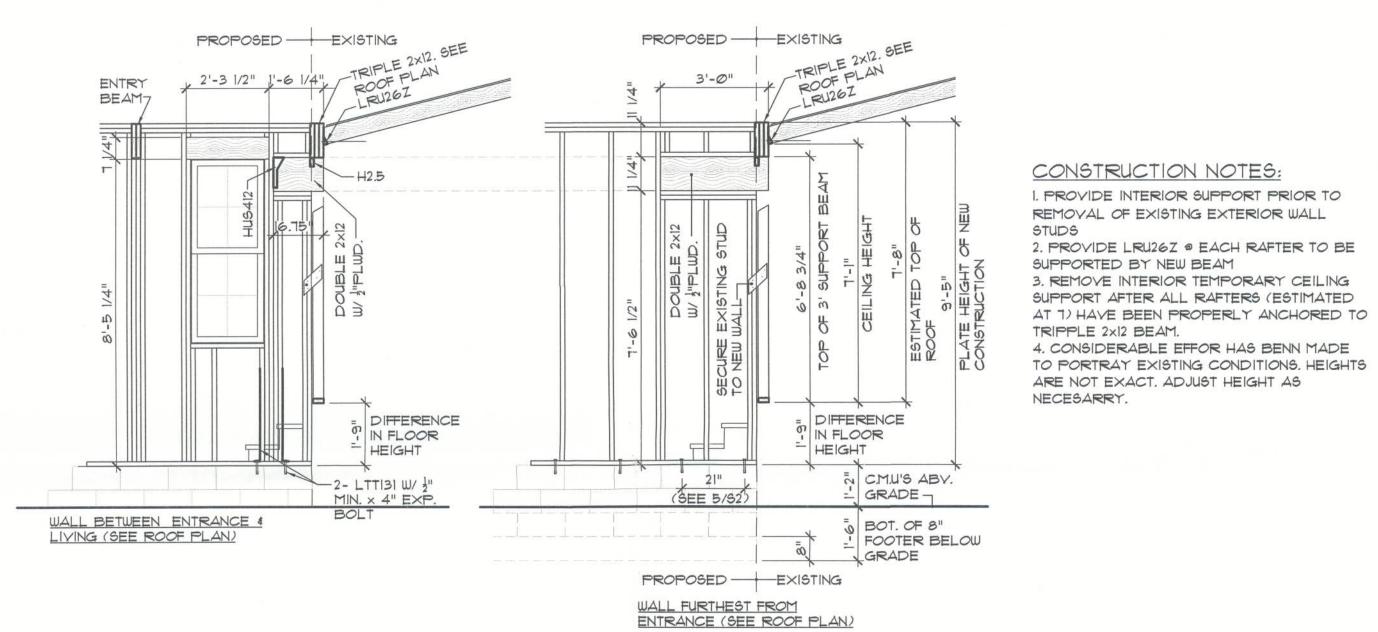




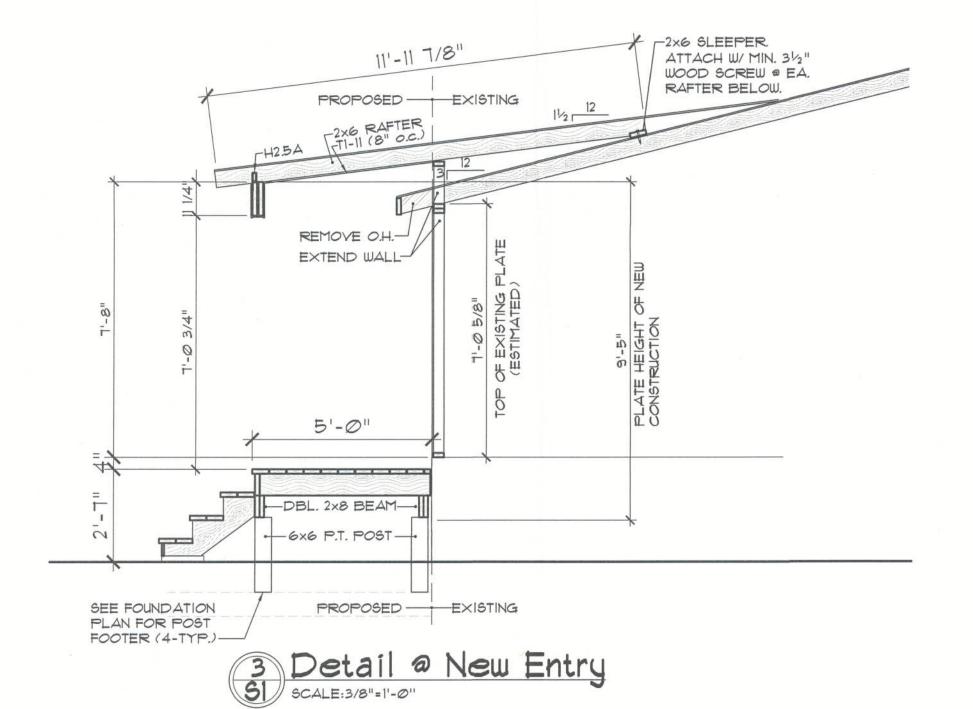

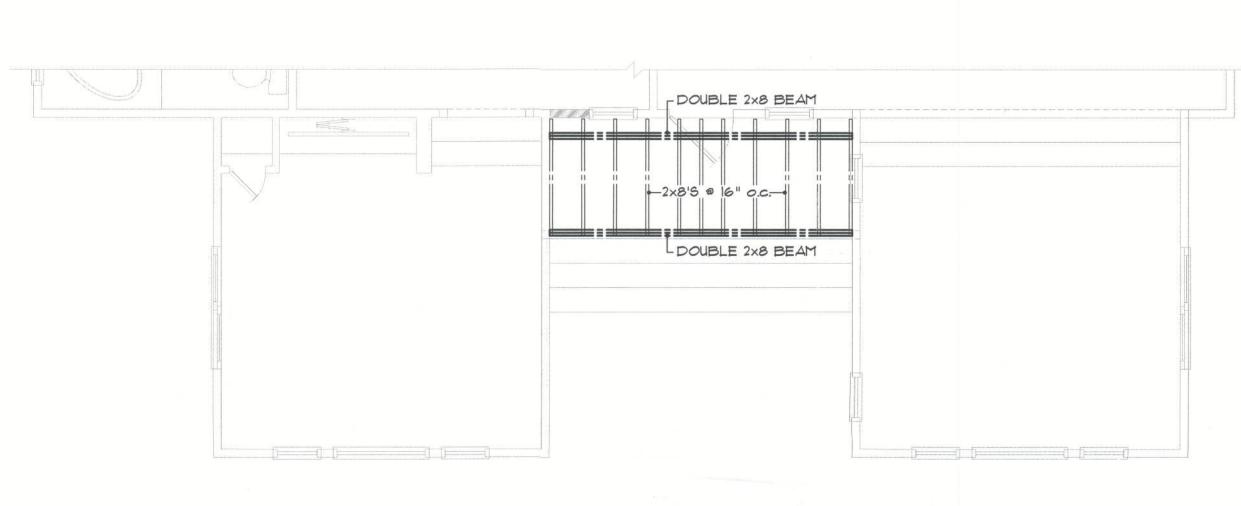



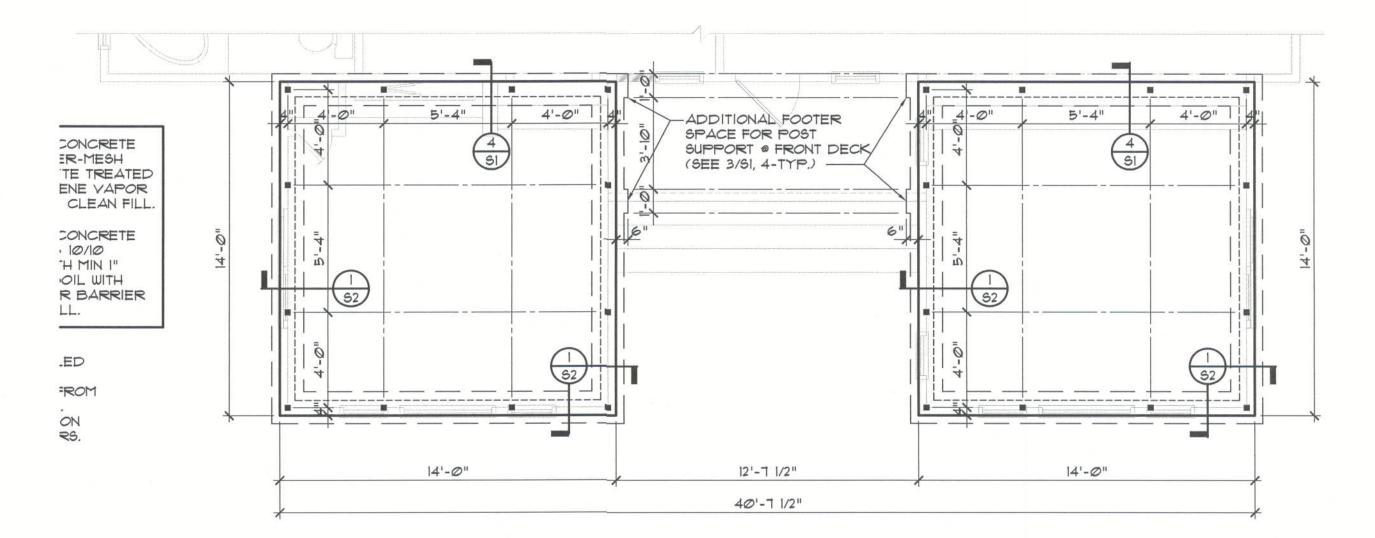

B Foundation Plan SI SCALE:1/4"=1'-0"

CONSTRUCTION NOTE:


CONSIDERABLE EFFORT HAS BENN MADE TO PORTRAY EXISTING CONDITIONS. ADJUST WINDOW HEADER HEIGHTS TO MATCH EXISTING CHANGE IN SLOPE WWW WWW WWW LHARDIEBOARD OR SIMILAR FIBER CEMENT BOARD A Proposed Conditions
SCALE: 1/4"=1'-0" METAL ROOF INSTALLED PER MANUFACTURER — PROPOSED - EXISTING FINISHED FLOOR & EXISTING FINISHED FLOOR ® PROPOSED LINDICATES EXISTING GRADE HARDIEBOARD OR SIMILAR FIBER CEMENT BOARD B Proposed Conditions
A2 SCALE: 1/4"=1'-0" PROPOSED - EXISTING FINISHED FLOOR ® EXISTING FINISHED FLOOR @ PROPOSED_ STEPS NOT SHOWN HARDIEBOARD OR SIMILAR FIBER CEMENT BOARD INDICATES EXISTING GRADE C Proposed Conditions
A2 SCALE:1/4"=1'-0"

revisions

CUSTOM DESIGNS, SPACE PLANNING TENANT BUILD OUTS, ADDITIONS, REMODELS

ADDITE SET ROAD E CITY, FLORIDA THE SZTTZE

job no LEWIS drawn by DA checked DA date 07/18/22 scale AS NOTED drawing no.

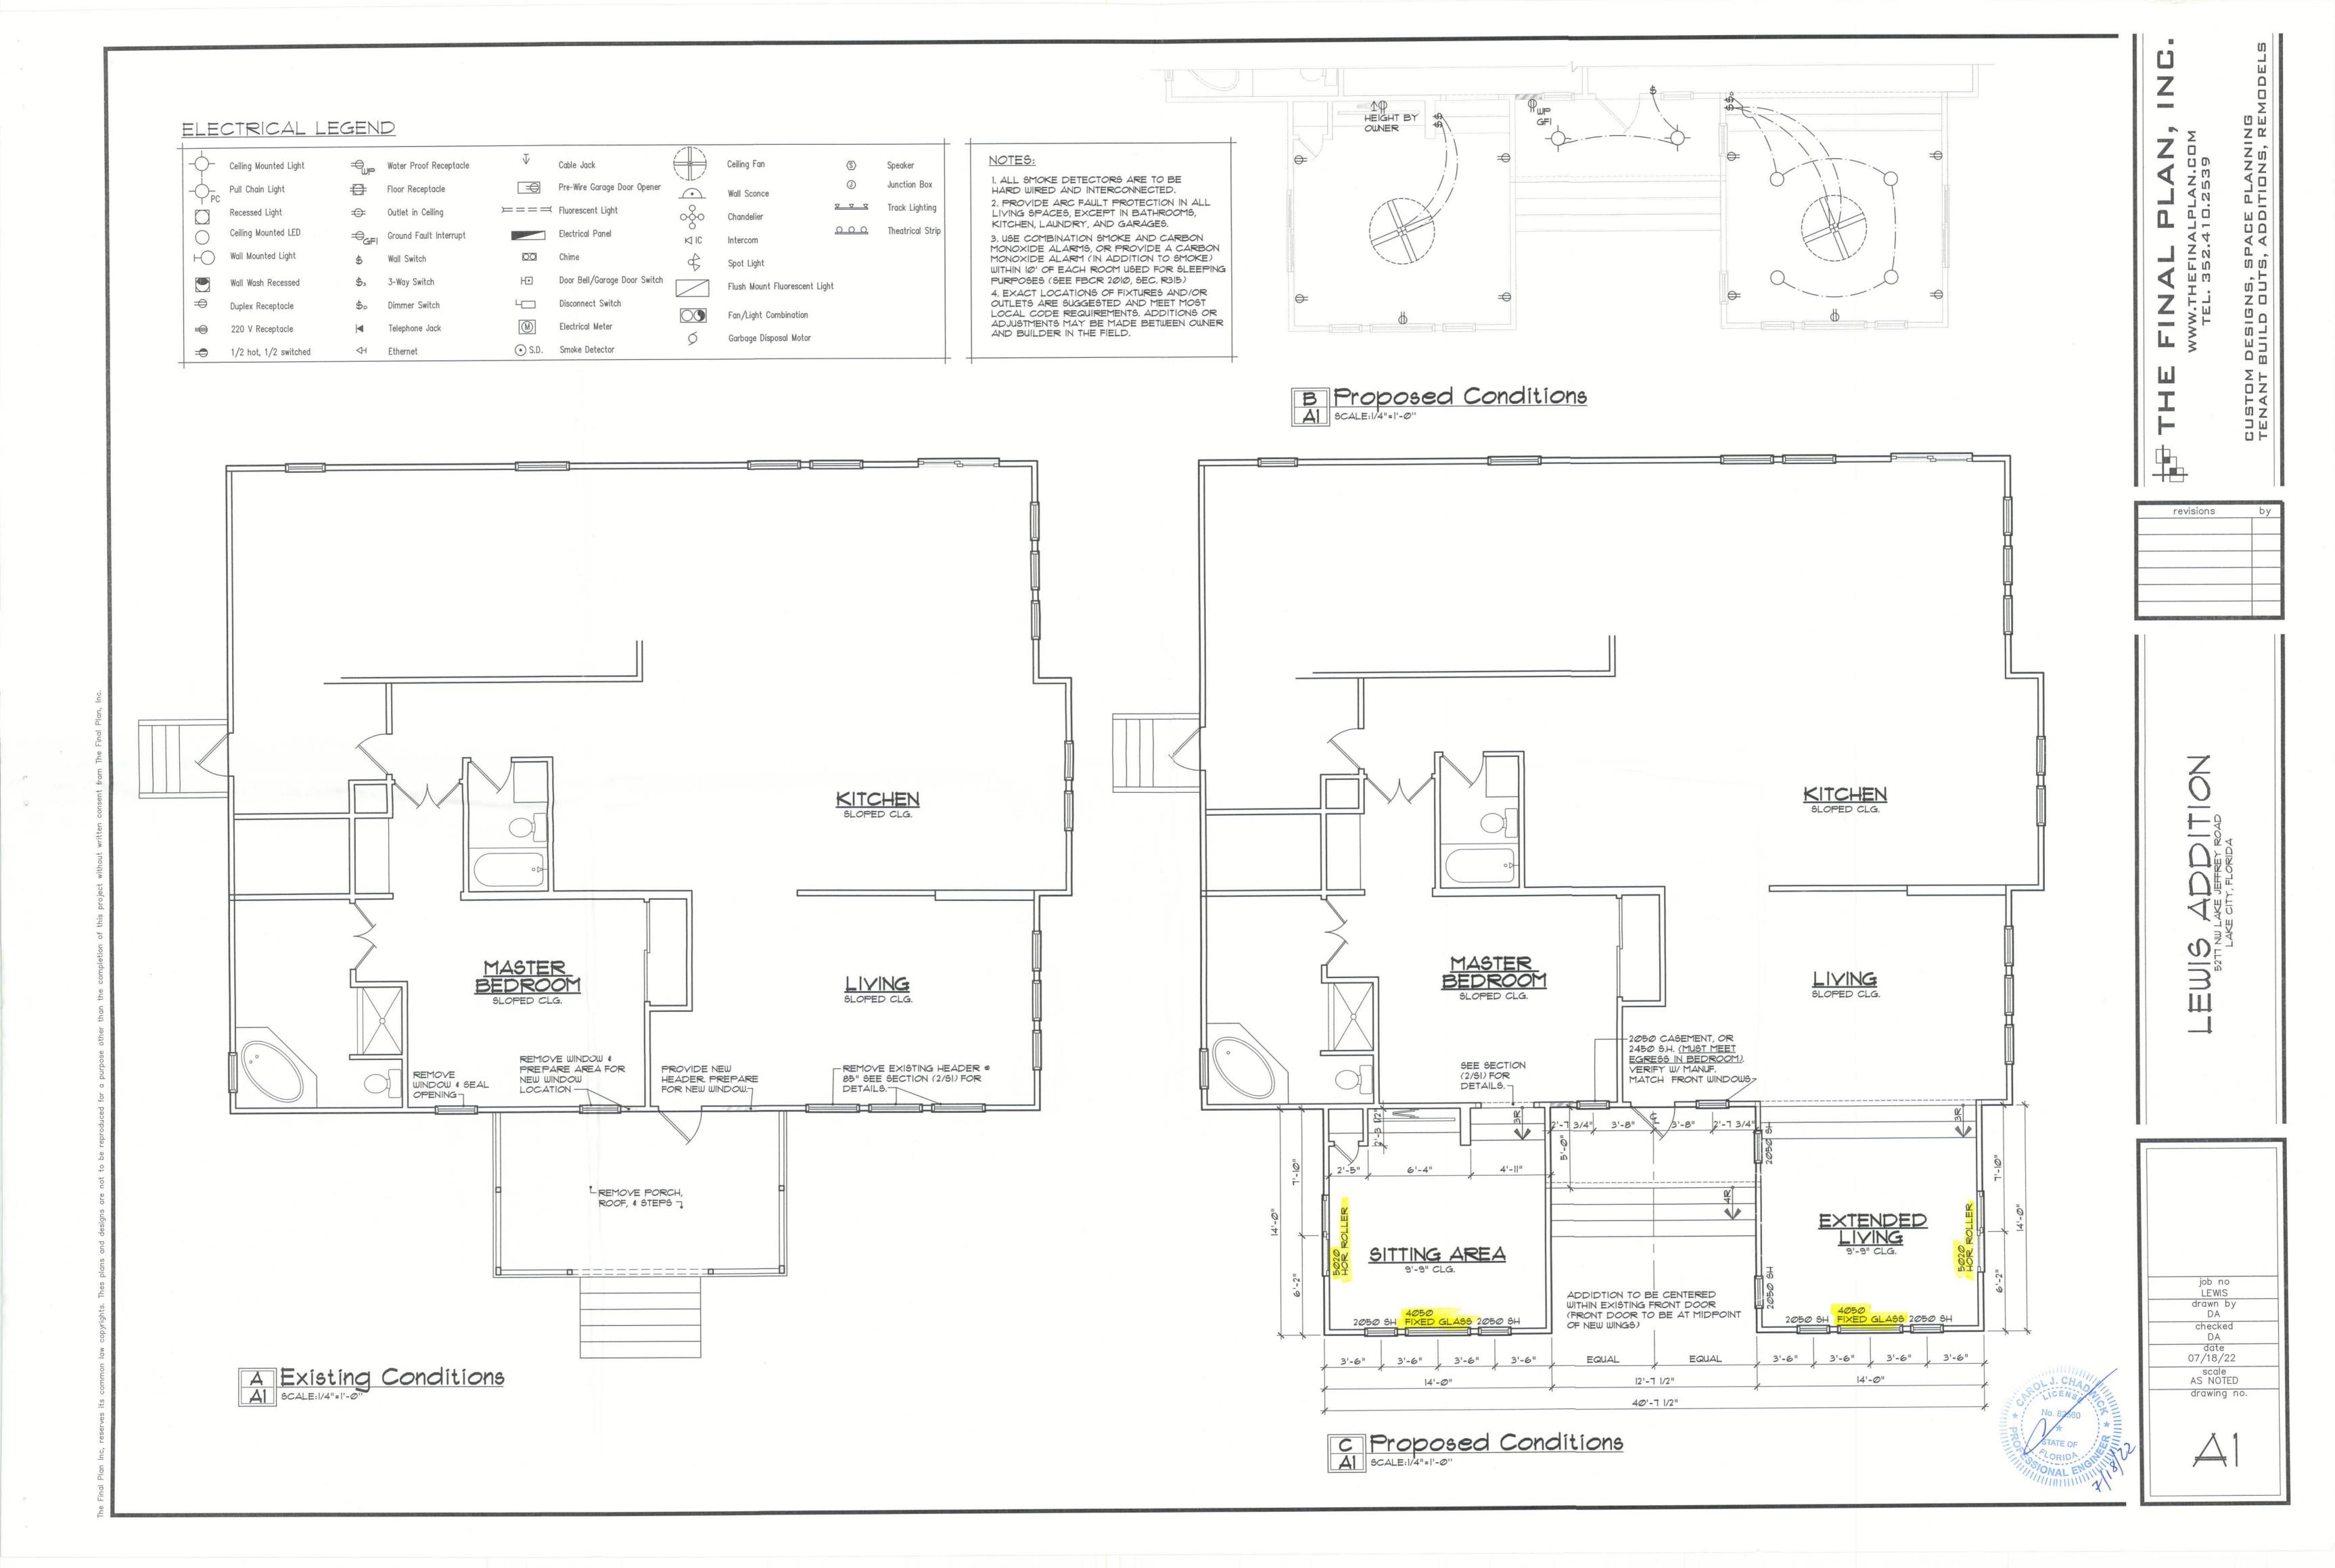

LEWIS RESIDENCE

(ADDITION TO EXISTING STRUCTURE)

5277 NW LAKE JEFFREY ROAD
LAKE CITY, FLOORIDA

ULTIMA	120 MPH		
NOMIN/	93 MPH		
RISK C	ATEGORY	II	
WIND E	XPOSURE	В	
INTERN	AL PRESSURE COEFFICI	+.18,18	
	AREA OF OPENINGS	HGHT. & EXPOSURE.	DESIGN
INTERIOR ZONE	(SQ. FT).	ADJUSTMENT. COEFF.	(PSF)
	Ø TO 1000 1001 TO 200 2001 TO 5000 5001 TO 10000 10001 TO 500	1.0 1.0 1.0 1.0 1.0	15.5, -16.9 14.8, -16.1 13.9, -15.2 13.2, -14.5 11.6, -12.9
0 TO 1000 1000 TO 5000 1000 TO 5000 1000 TO 5000		1.0 1.0 1.0 1.0	15.5, -208 14.8, -19.4 13.9, -17.6 13.2, -16.1 11.6, -12.9

MULTYPLYING BY THE ADJUSTMENT COEFFICIENT.

AND AWAY FROM THE BUILDING SURFACES.

2. PLUS AND MINUS SIGNS SIGNIFY PRESSURES ACTING TOWARD


2020 - FLORIDA BUILDING CODE WIND SPEED CONVERSIONS

| ULITIMATE (3 SEC. GUST) | 110 | 115 | 120 | 130 | 140 | 150 | 160 | 170 | 180 | 190 | 200

85 89 93 101 108 116 124 132 139 147 155

AREA TABULATION		INDEX OF DRAWINGS		
Living:			SHEET NO.	DRAWING TITLE
Existing	2,010	sf		
Addition	392	sf	C1	COVER SHEET
Non Living:	12.5		A1	EXISTING & PROPOSED FLOOR PLAN
Entry	63	sf	A2	ELEVATIONS
•Total Area:	2,465	sf	S1	FOUNDATIONS, DETAILS, & ENTRY
*DETACHED GARAGE NOT ACCOUNTED IN THESE FIGURES		S2	FLOOR FRAMING LEFT & RIGHT ELEVATIONS	



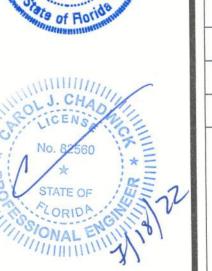



WWW.TF

revisions by

LEWIS ADDITION STATE SETRET ROAD LAKE CITY, FLORIDA

