

SCOPE OF WORK

THE PROJECT CONSIST ON A NEW RESIDENTIAL CABIN BUILDING OF 902 STHE FINISH FLOOR OF THE BUILDING WAS RAISED UP 8'-0" FROM THE ADJACENT GROUND IN ORDER TO MET THE REQUIRED FINISH FLOOR ELEVATION ABOVE THE LOCAL 100 YEAR FLOOD ZONE ELEVATION. THESE CONSTRUCTION DOCUMENTS DO NOT COVER ANY SITEWORK SINCE: A. THE SITE HAS AN EXISTING SEPTIC TANK ALREADY PERMITTED.

B. THE SITE HAS AN EXISTING ELECTRICAL SUPPLY/METER ALREADY PERMITTED.

C. THE SITE HAS AN EXISTING WATER WELL ALREAY PERMITTED.
CONNECTION OF THIS EXISTING UTILITIES TO THE NEW BUILDING IS THE
RESPONSABILITY OF THE OWNER; ALL WORK NEEDS TO MEET FLORIDA
BUILDING CODE 2010 AND LOCAL ORDINANCES.

GENERAL NOTES

 APPLICABLE CODES: FLORIDA BUILDING CODE, RESIDENTIAL 2010 EDITION (WITH CURRENT SUPPLEMENTS)

FLORIDA FIRE PREVENTION CODE, 2007 EDITION OSHA

NATIONAL ELECTRIC CODE (LATEST EDITION)

OCCUPANCY CLASS: RESIDENTIAL, SINGLE FAMILY
 AREAS
 GROSS AREA: 800 SF

4. TYPE OF CONSTRUCTION: V-B
UNPROTECTED, NON-SPRINKLERED

5. ALL MATERIALS USED SHALL BE IN COMPLICACE WITH FBC 2010

6. STRUCTURAL SYSTEMS FOR THIS PROJECT HAVE BEEN DESIGNED AS SPECIFIED IN FLORIDA BUILDING CODE, 2010, CHAPTER 16 AND ASCE 7-10 "MINIMUM DESIGN LOADS FOR BUILDINGS AND OTHER STRUCTURES".

DEAD LOADS (SECTION 1606)

A. ROOF TOP CHORD 15 PSF; BOTTOM CHORD 5 PSF

ROOF LIVE LOADS (SECTION 1607.11)

A. ROOF SLOPE: 4/12 O LESS THAN12/12 = 16 PSF WIND LOADS (SECTION 1609)

ULTIMATE DESIGN WIND SPPED: 125 MPH; DESIGNED: 130 MPH BUILDING RISK CATEGORY: II

WIND EXPOSURE CATEGORY: B
INTERNAL PRESSURE COEFICIENT: +0.18/-0.18

ENCLOSURE CALSIFFICATION: FULLY ENCLOSURE COMPONING AND CLADING DESIGN WIND PRESSURE

WIND SPEED	COMPONENT AREA (SF)	INWARD PRESSURE (SF)	OUTWARD PRESSURE (SF)
130 MPH	10 20 50 100 200 >500	+18.2 +17.5 +16.2 +15.4 +14.8 +13.6	-24.4 -22.9 -20.5 -19.0 -17.5 -15.1

7. PROVIDED WINDOWS AND DOORS SHALL MEET THE WIND PRESSURE OF REQ'D. WIND ZONE; RCA IS NOT RESPONSABLE FOR WINDOW/DOOR DESIGN OR INTALLATION.



IATES, INC.

NG AA 002865

352-377-1751 (0)

D ASSOCIATES
TECTURE-PLANNING
A52-37

E, FORT WHITE, FL 32028

CHARD JORDAN



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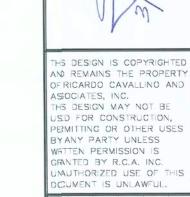
FROJECT: RCA

A1.0

IATE: 1-12-2015




NEW CABIN FOR
RICHARD JORD/
4014 SW WASHINGTON A




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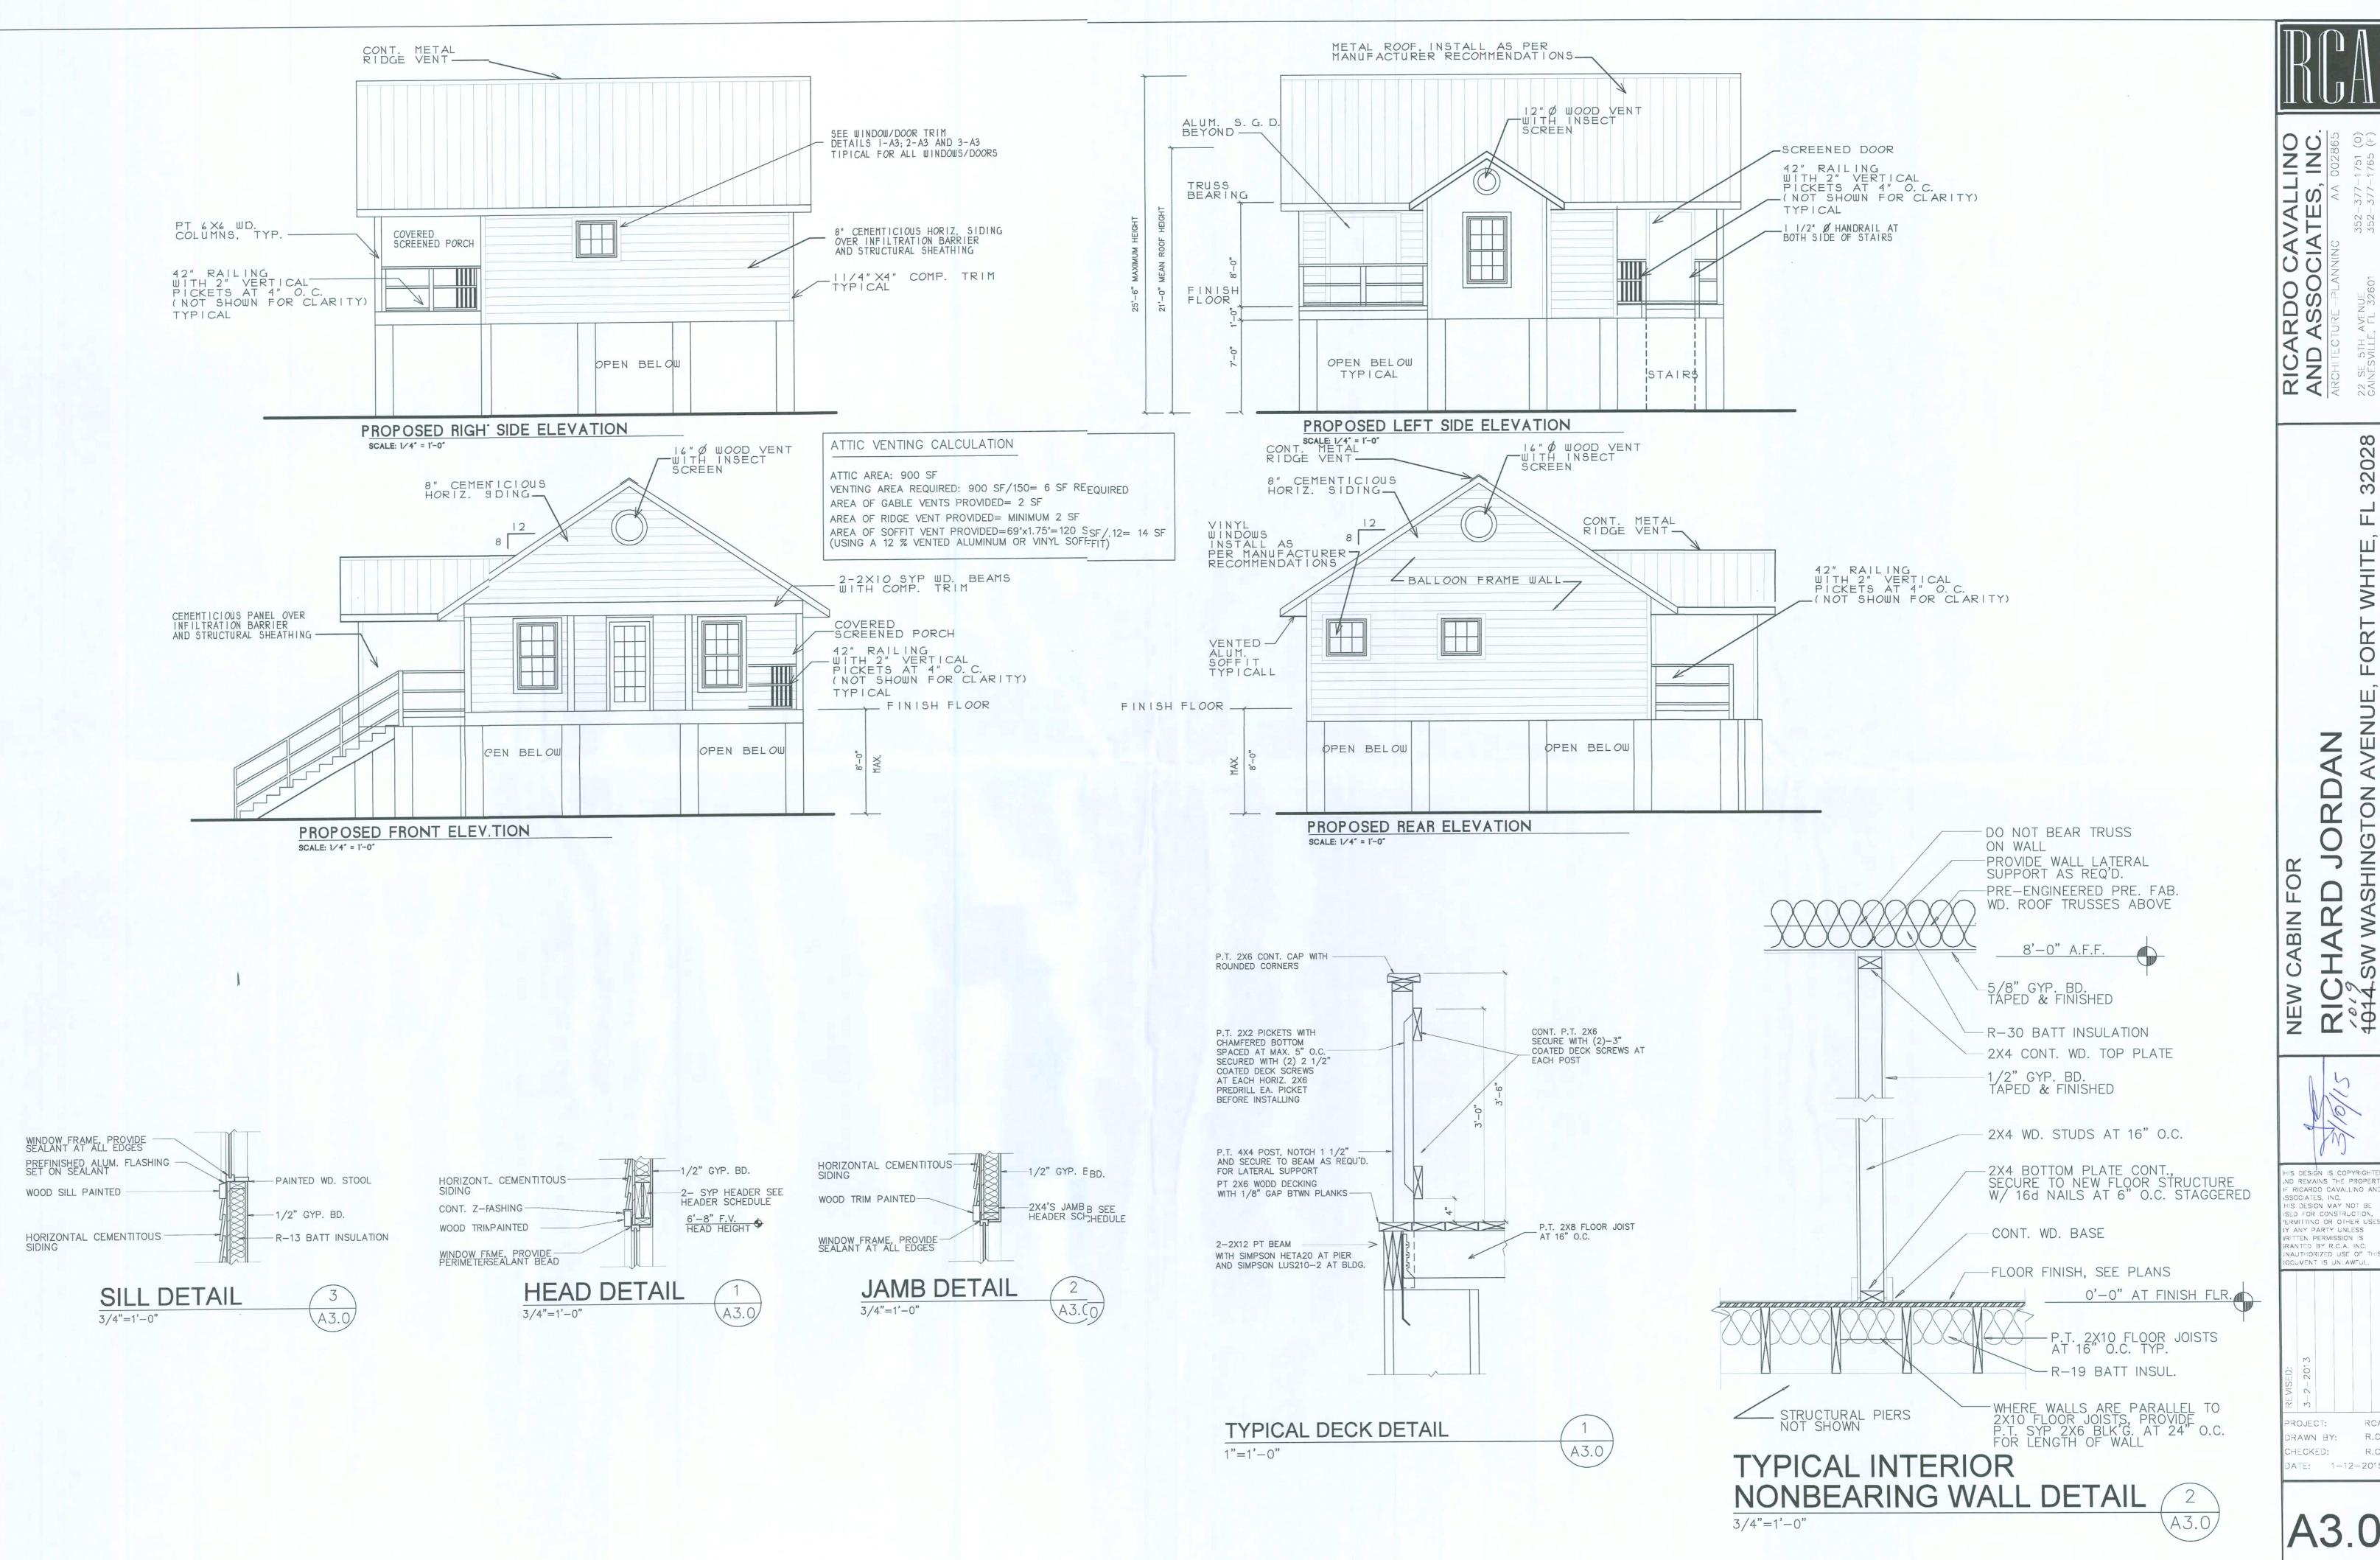
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FLOOR PLAN
SCALE: 1/4" = 1'-0"

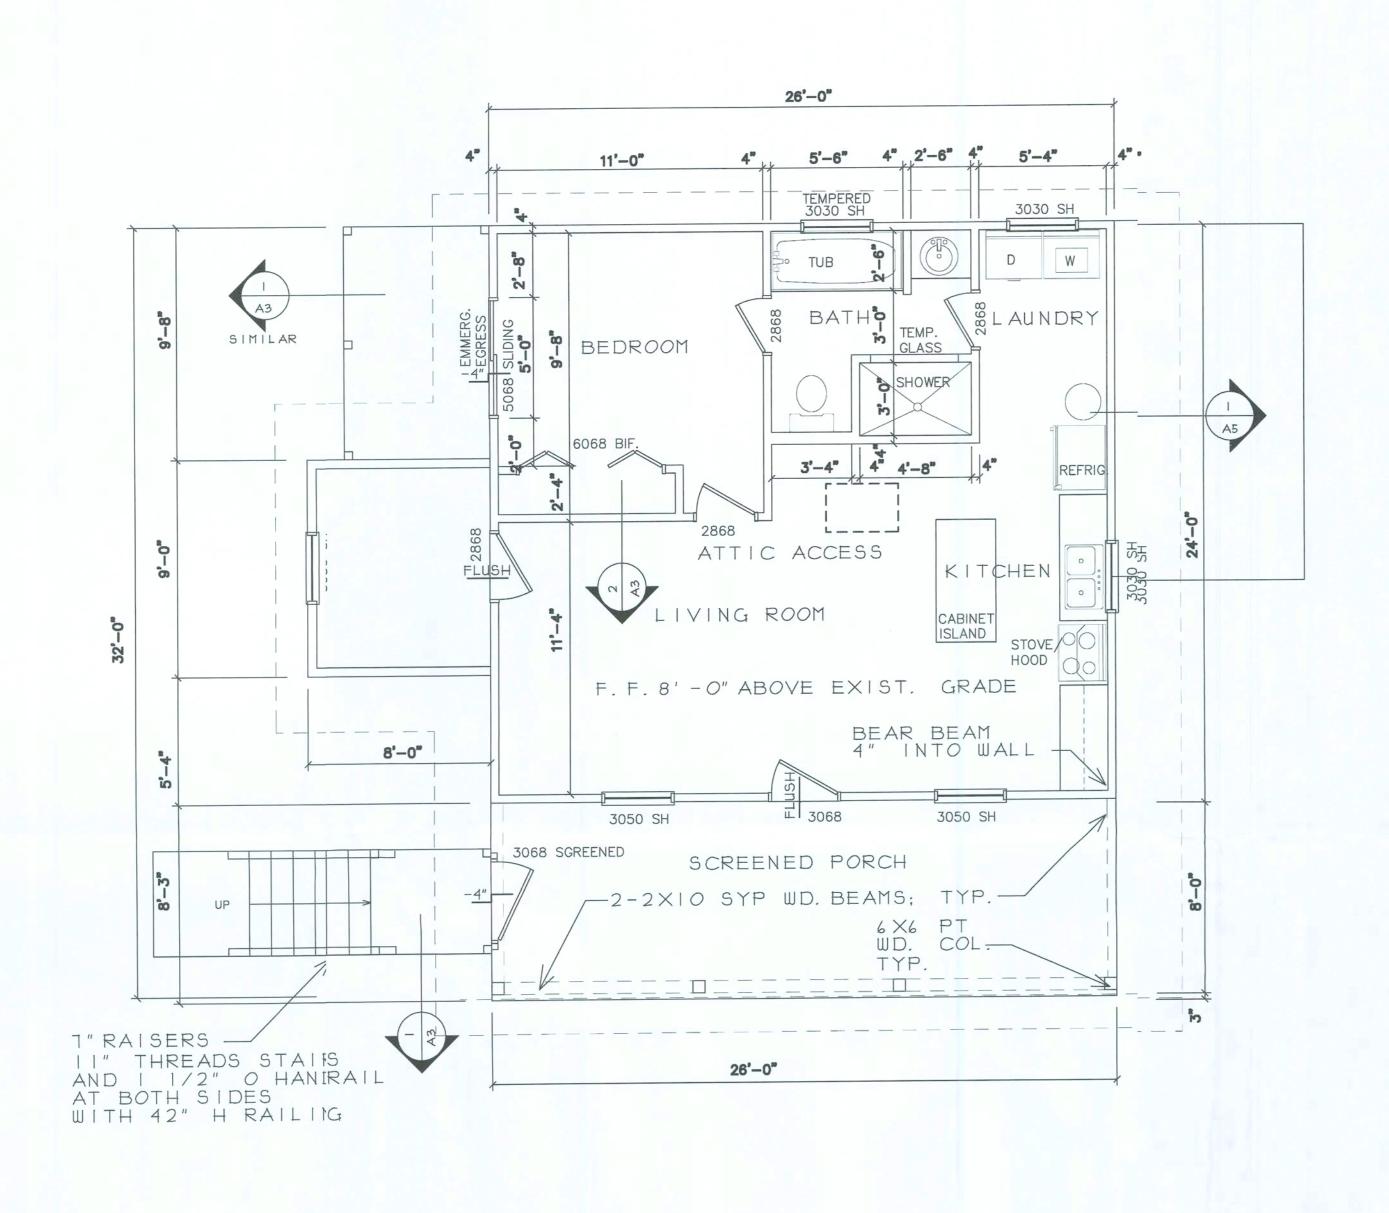

FOUNDATION PLAN
SCALE: 1/4" = 1'-0"

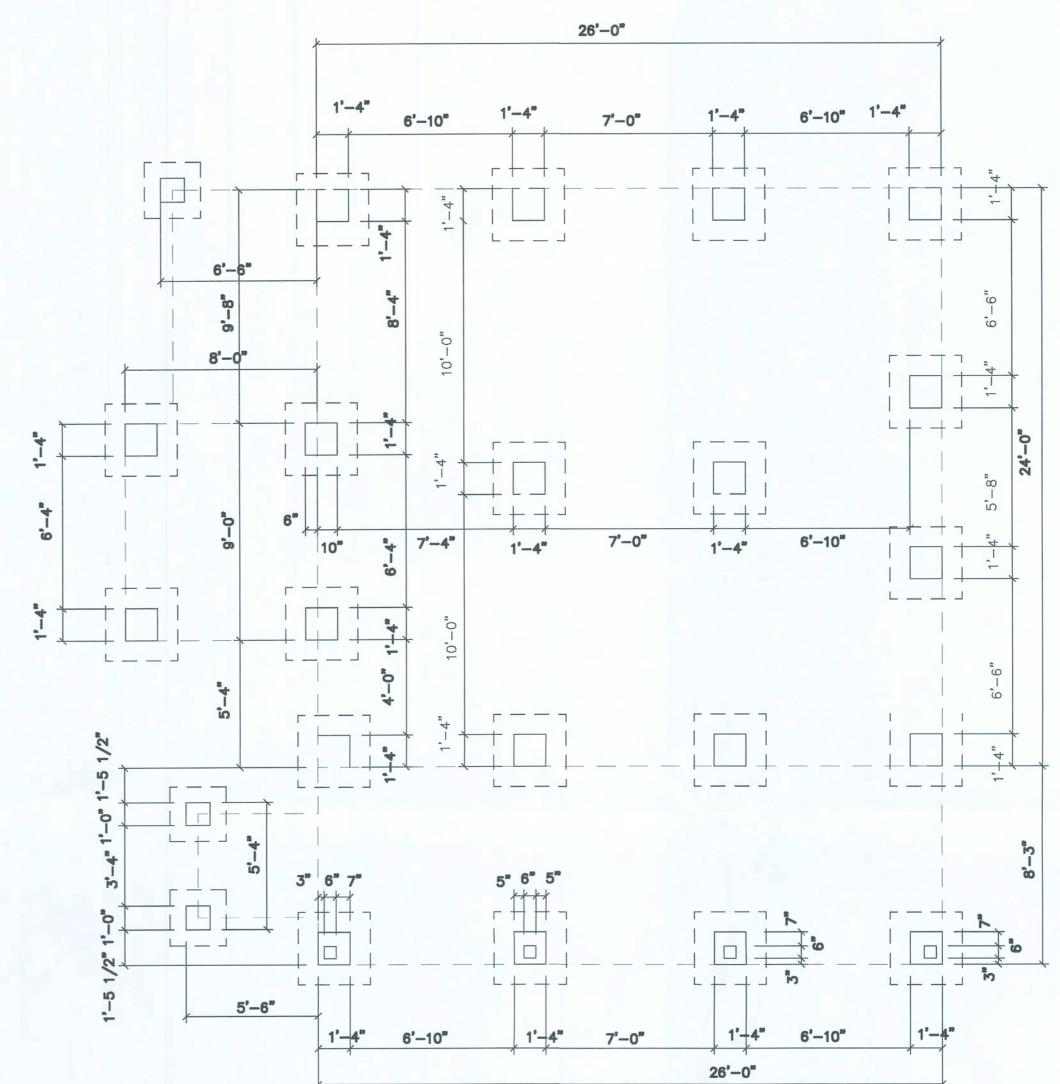

32028

AZ JORD LON SHING HARD

SW

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A3.0

AND ASSOCIATES, INC.

ARCHITECTURE—PLANNING AA 002865

CAS SE 5TH AVENUE

SASSOCIATES (0)

ARCHITECTURE—PLANNING AA 002865

CAN SWILLE, FL 32601

ARCHITECTURE—PLANNING AA 002865

CAN SWILLE, FL 32601

NEW CABIN FOR

RICHARD JORDAN

4014-SW WASHINGTON AVENUE, FORT WHITE, F

32028




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PROJECT:

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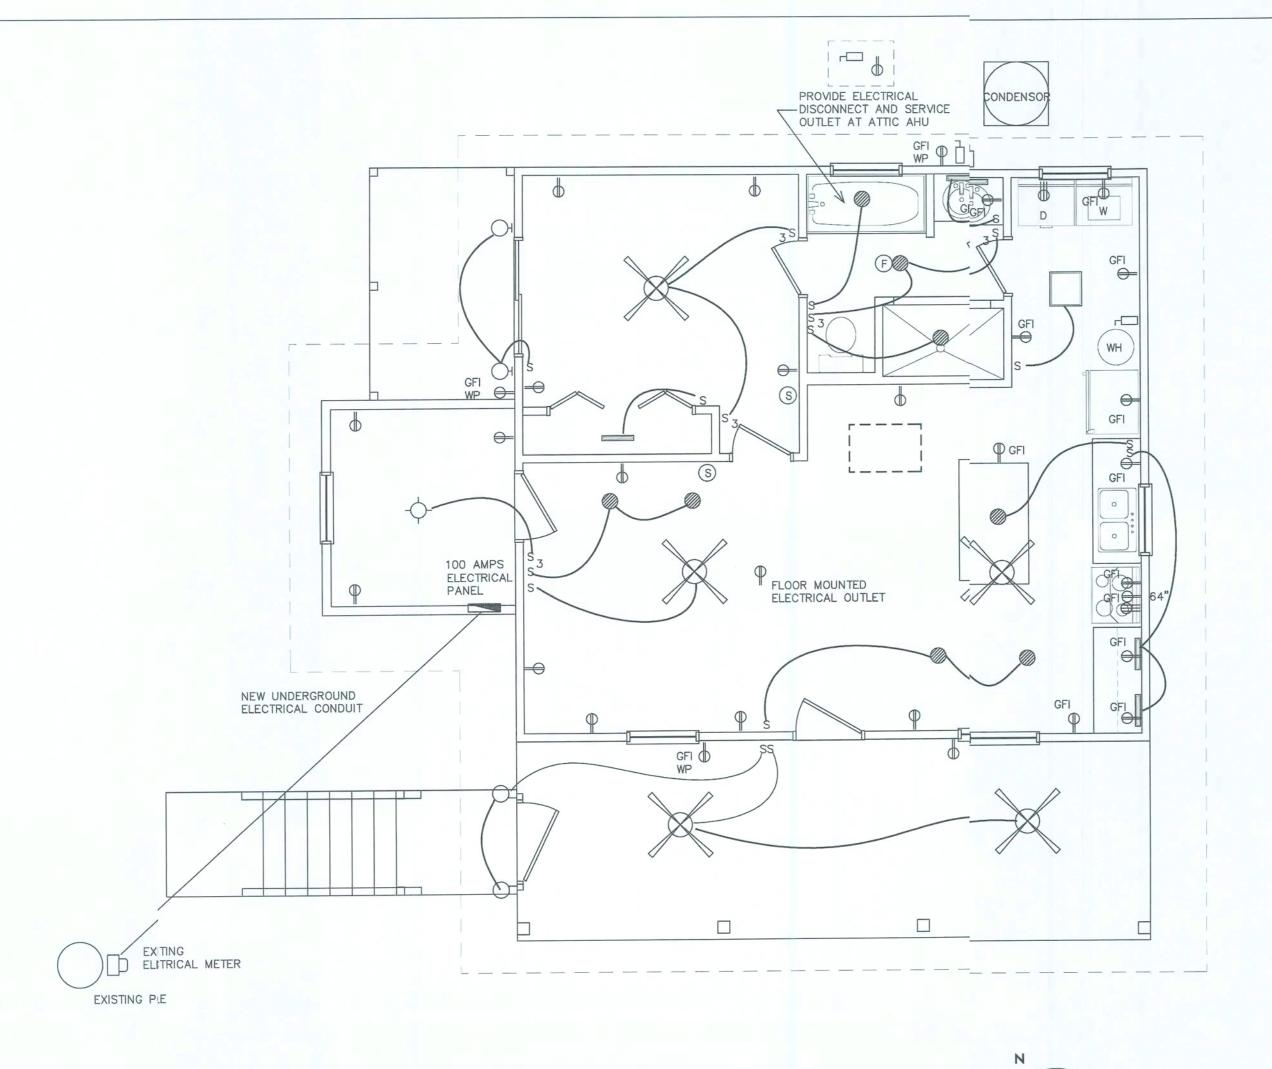
 ALL WORK SHALL COMPLY WITH THE NATIONAL ELECTRIC CODE, LATEST EDITION AND ALL OTHER APPLICABLE LOCAL CODES AND ORDINANCES.

 ALL SMOKE DETECTORS TO BE WIRED TOGETHER TO ACTUATE ALL ALARMS IF ANY ONE UNIT IS ACTIVATED.


3. ALL ELECTRICAL OUTLETS TO BE ARC FAULT OUTLETS — AFCI.

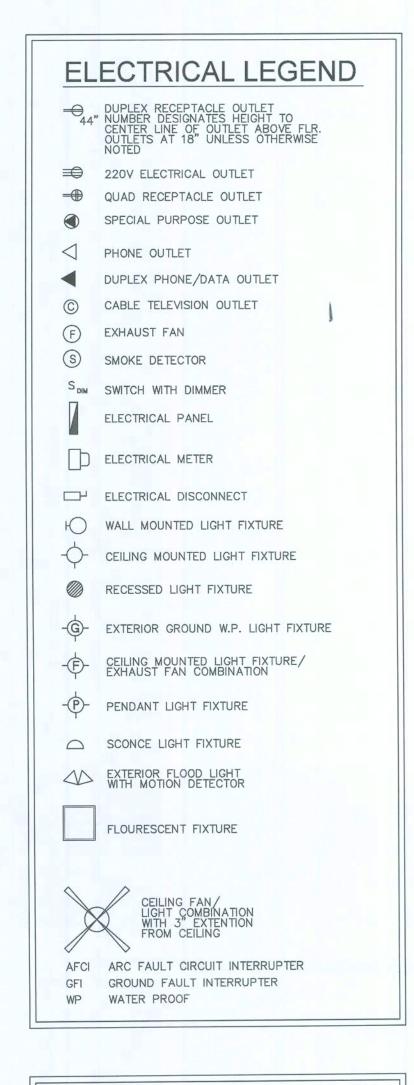3. PROVIDE GFI OUTLETS AT KITCHEN, BATHROOMS, WET AREAS, AND EXTERIOR OUTLETS.


4. OUTLETS SUPPLYING POWER TO THE STOVE, RANGE, A/C, WATER HEATER, DRYER, AND DISH WASHER TO BE WIRED ON SEPARATE DEDICATED CIRCUITS





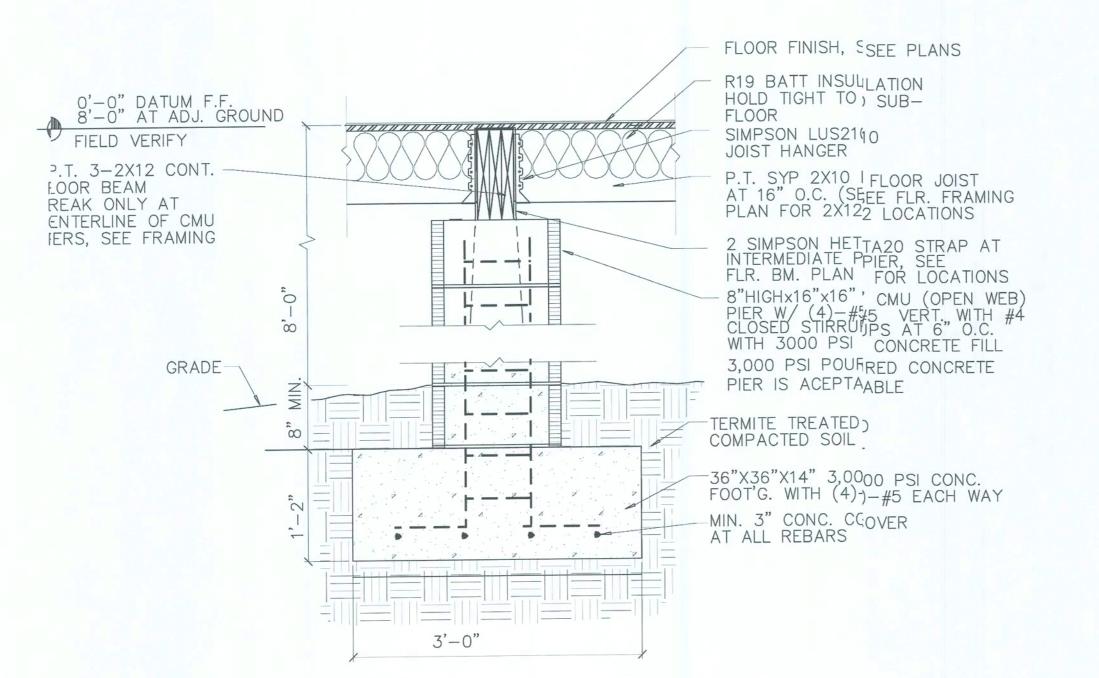



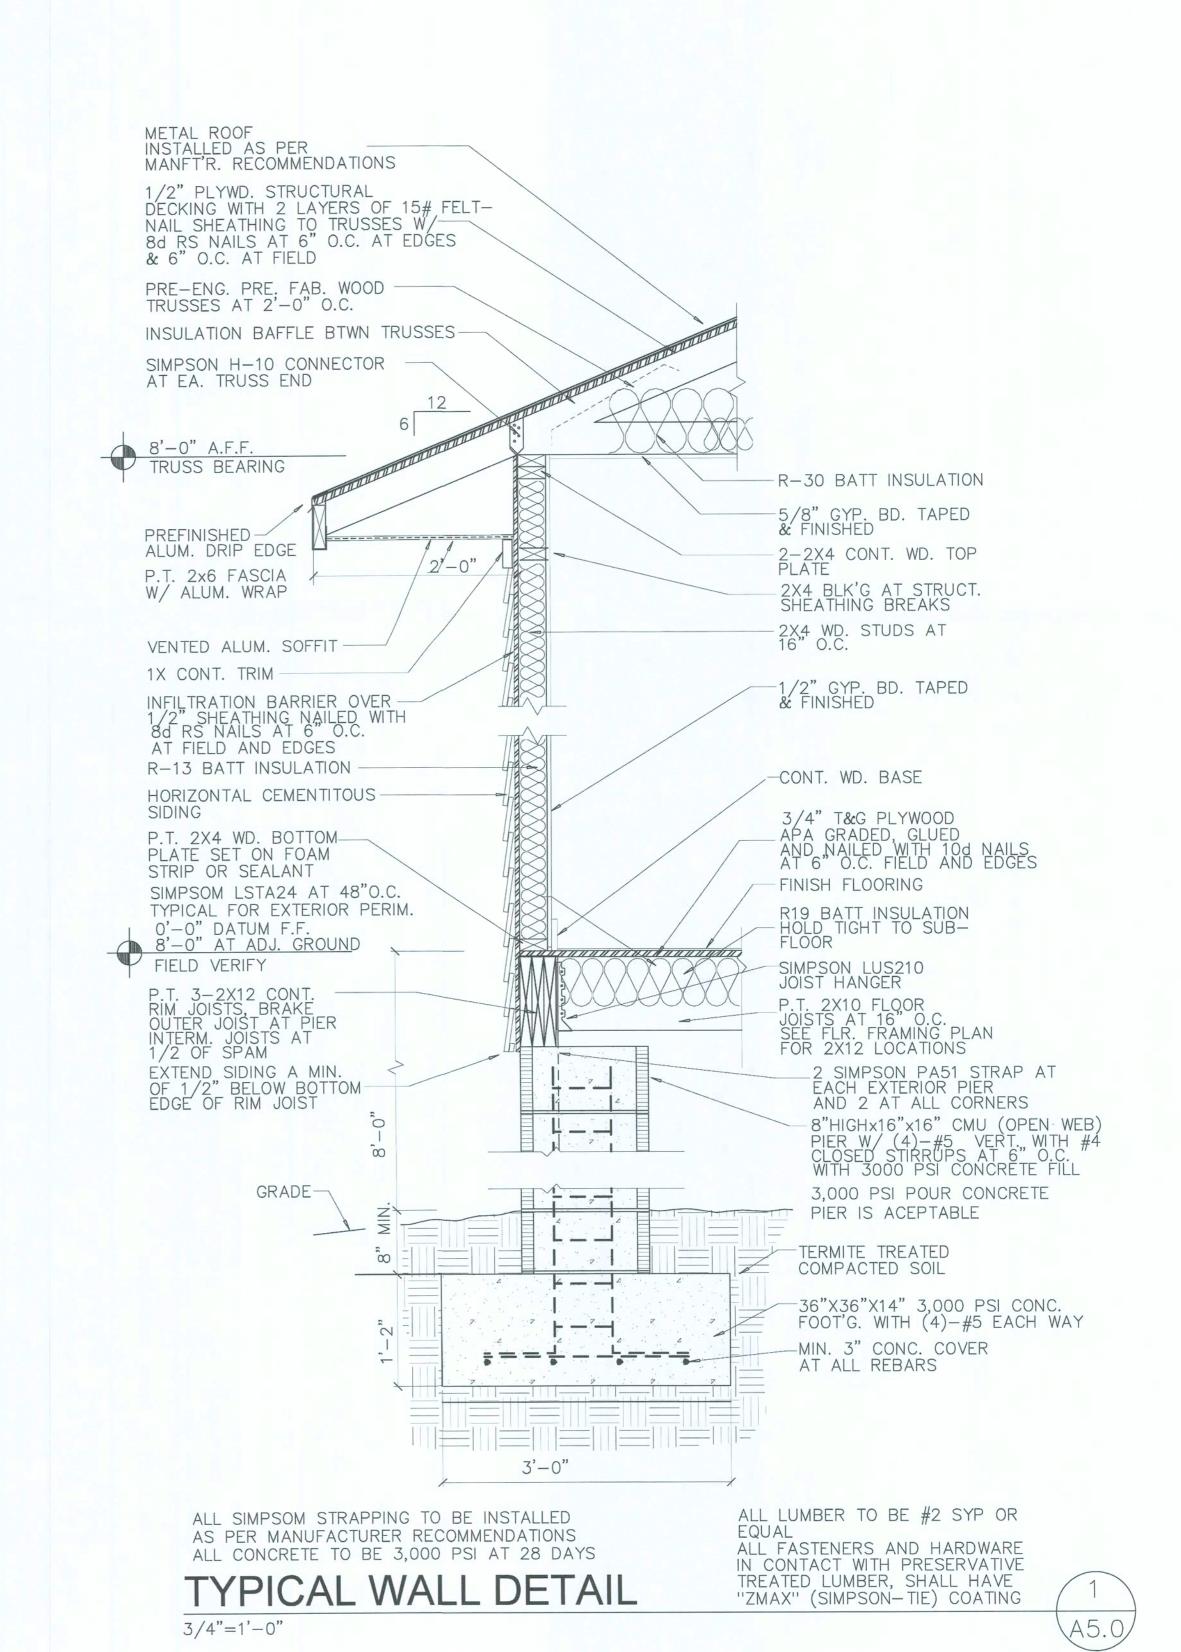



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ND ASSOCIATES,
CHITECTURE—PLANNING AA

WHITE, FL 32028 GAINESVIL

NEW CABIN FOR

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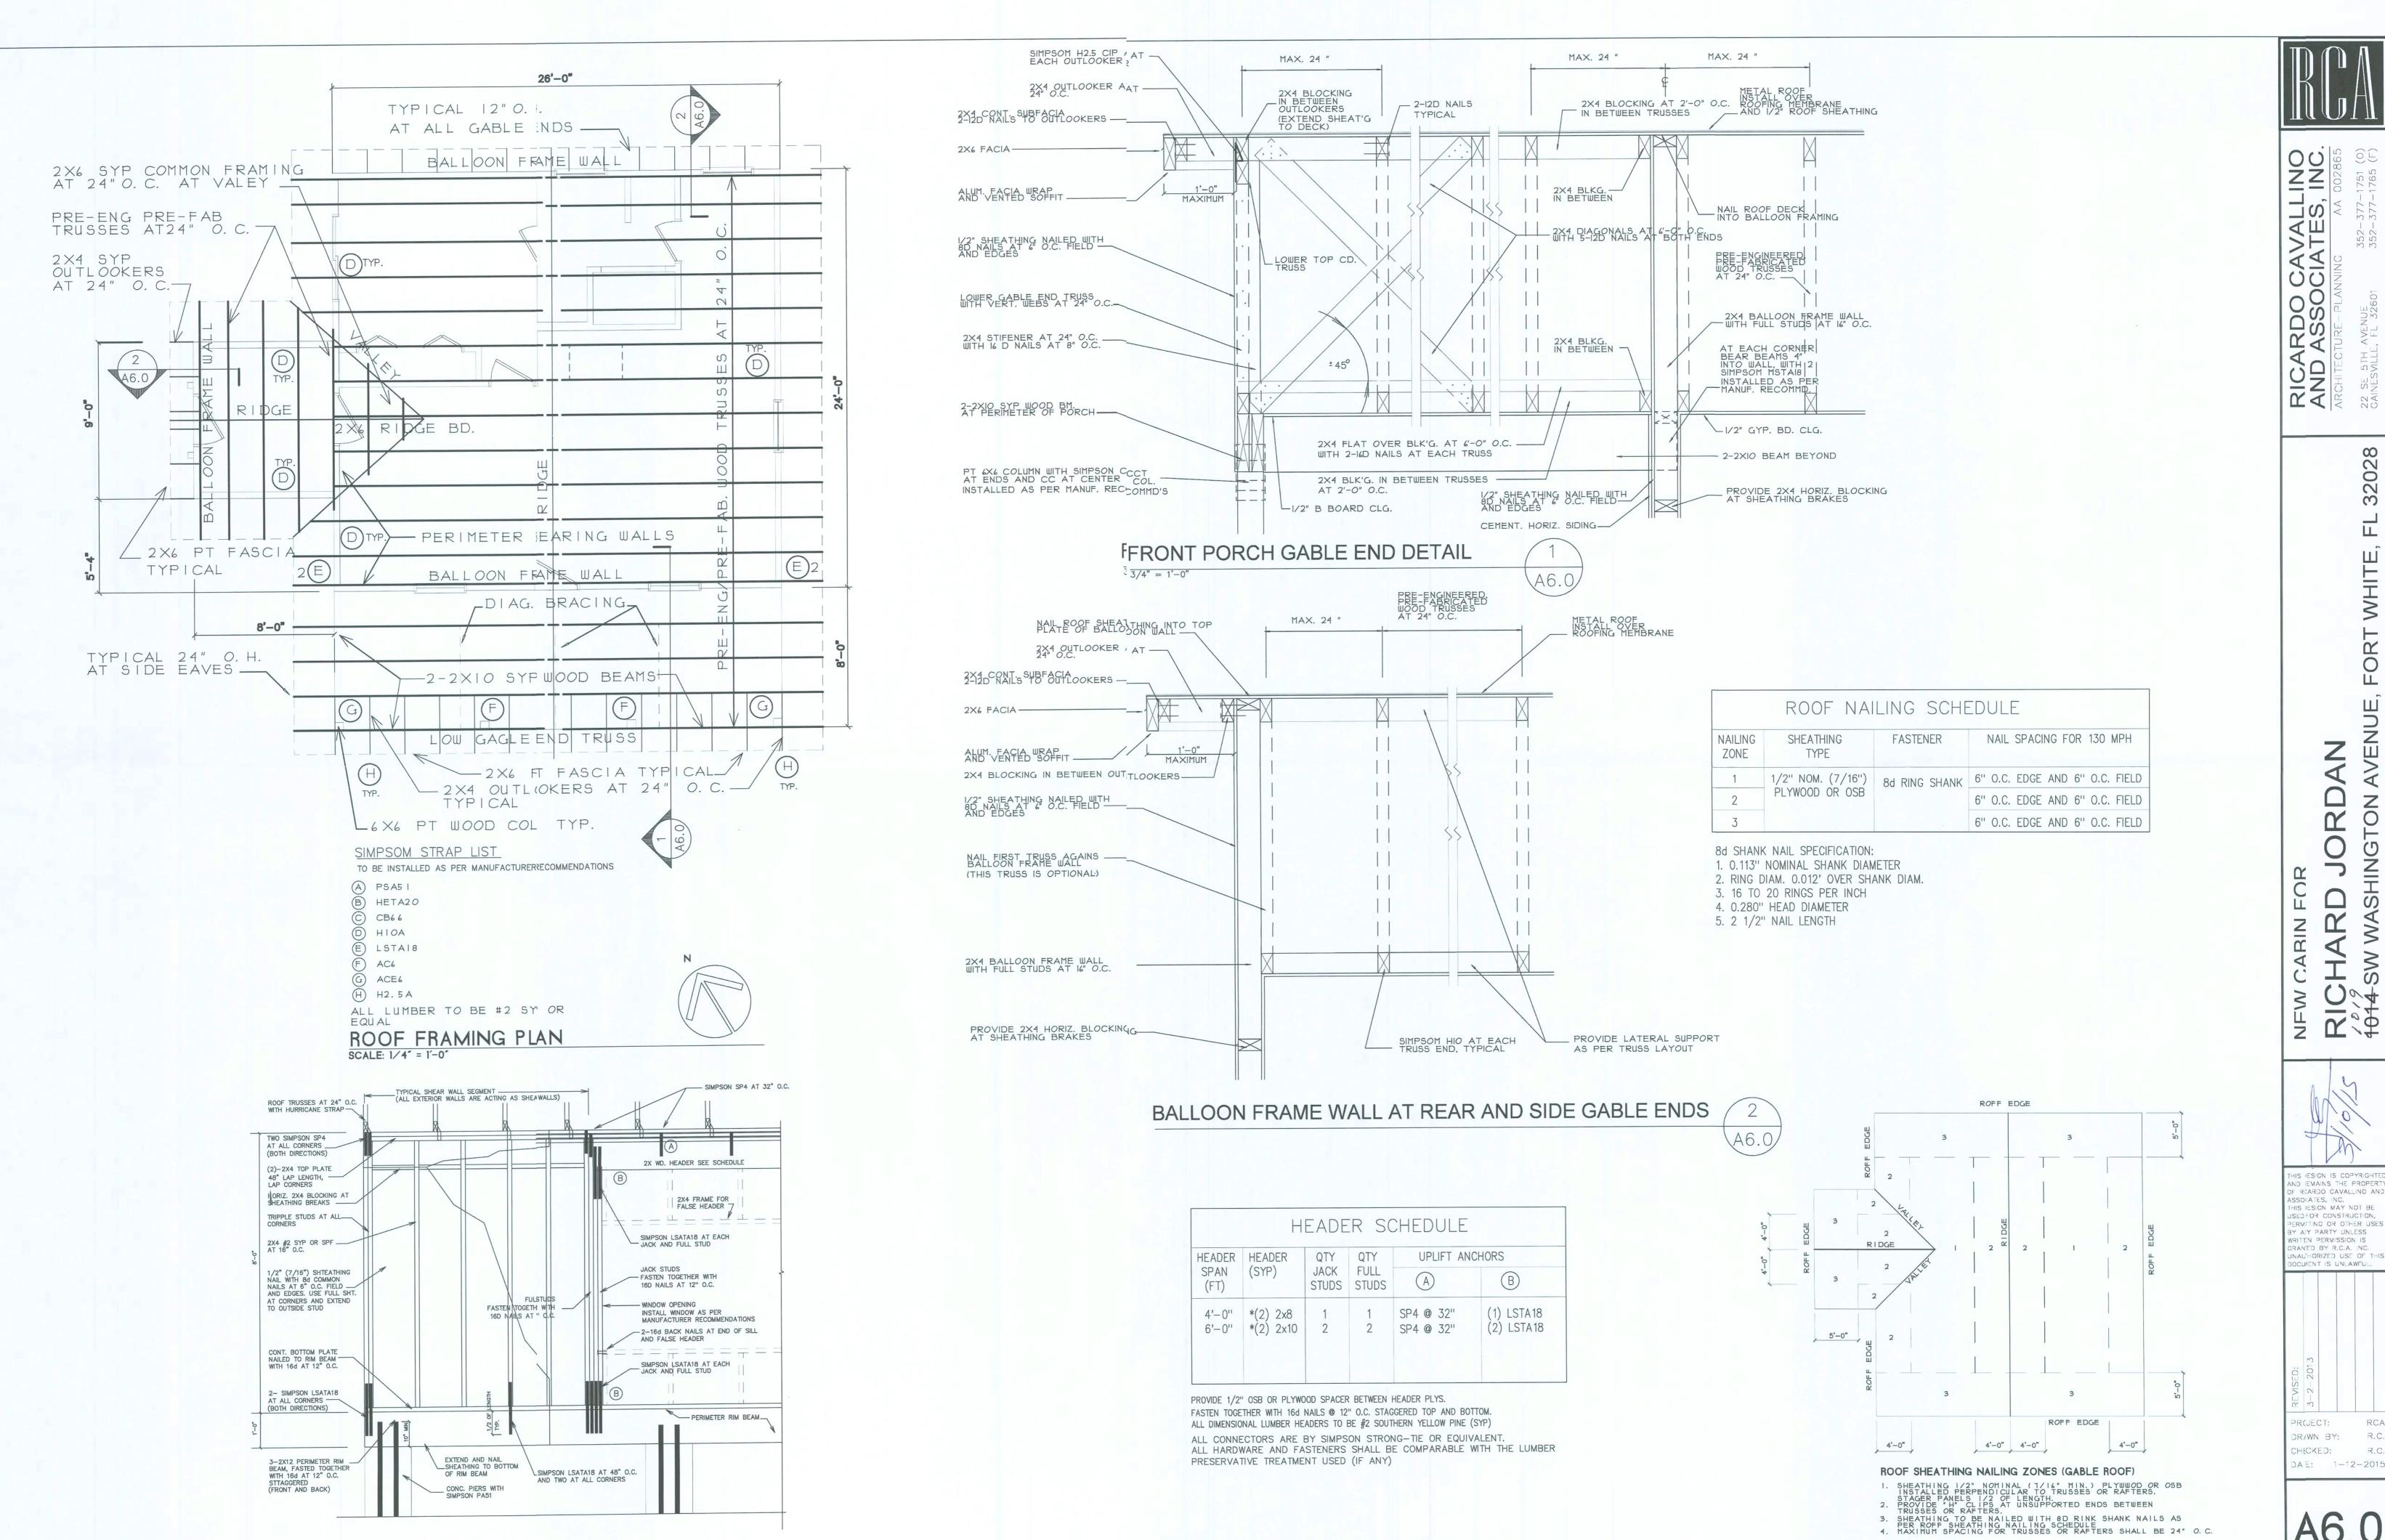
4014.SW WASHINGTON AVENUE, FORT

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3-2-2013

PROJECT: RCA
DRAWN BY: R.C.
CHECKED: R.C.
DATE: 1-12-2015

A5.0



TYPICAL SHEAR WALL SEGMENT, HEADR AND JAMB DETAIL

N.T.S.

A6.0