

Columbia County New Building Permit Application

For Office Use Only Application # 44114 Date Received 12/2 By m6 Permit # 39056
Zoning Official WILH Date 12-3-19 Flood Zone X Land Use Aq Zoning A-3
FEMA Map # Elevation MFE River Plans Examiner 7.C. Date 12-11-19
Comments
NOC FEN Deed of PA Site Plan - State Road Info Well letter 1911 Sheet - Parent Parcel #
Dev Permit # In Floodway Letter of Auth. from Contractor F W Comp. letter
www. Builder Disclosure Statement Land Owner Affidavit Ellisville Water App Fee Paid Sub VF Form
Septic Permit No. X 19-107 or City Water Fax (386) 719-9899
Applicant (Who will sign/pickup the permit) Matthew A. Erkinger St Phone (386) 734-5555
Address 248 SE Nassan St., Lake City, FL 32025
Owners Name Matthew A. SR and Kelly G. Erkinger Phone (386) 754-5555
911 Address 222 SW Jewel Court, Fort White, FL 32038
Contractors Name Erkinger (MAH how) Phone 350 754-5555
Address 248 SE Nassau St. Lake City, FL 32025
Contractor Email Into Gerkingerlomes, com ***Include to get updates on this job.
Fee Simple Owner Name & Address
Bonding Co. Name & Address
Architect/Engineer Name & Address Moore 17.1
Architect/Engineer Name & Address Moore 17.5. Mortgage Lenders Name & Address None 1009 East Avenue 5c, 29841
Circle the correct power company – FL Power & Light – Clay Elec. – Suwannee Valley Elec. – Duke Energy
Property ID Number 07-65-16-03787-001 Estimated Construction Cost 40 K
Subdivision Name Herlong Junction Lot 7 Block Unit Phase
Driving Directions from a Major Road 475. to Herlang Street, Turn Right, Go to
end and bare Left onto Sw Treasure Lane 400, Turn
Left onto SW Jewel Court to the end.
Construction of Metal Building on Slab Commercial OR Residential
Proposed Use/Occupancy Storage Number of Existing Dwellings on Property O
Is the Building Fire Sprinkled? If Yes, blueprints included Or Explain
Circle Proposed - Culvert Permit or Culvert Walver or D.O.T. Permit or Have an Existing Drive
Actual Distance of Structure from Property Lines - Front 290' + Side 448 + Side 175 + Rear 3/3' +
Number of Stories / Heated Floor Area None Total Floor Area 2000 Acreage 10
Zoning Applications applied for (Site & Development Plan, Special Exception, etc.)
12/10- Emailed-know whats pending It Sent Email /2.17.19

Columbia County Building Permit Application

CODE: Florida Building Code 2014 and the 2011 National Electrical Code.

Application is hereby made to obtain a permit to do work and installations as indicated. I certify that no work or installation has commenced prior to the issuance of a permit and that all work be performed to meet the standards of all laws regulating construction in this jurisdiction.

TIME LIMITATIONS OF APPLICATION: An application for a permit for any proposed work shall be deemed to have been abandoned 180 days after the date of filing, unless pursued in good faith or a permit has been issued.

TIME LIMITATIONS OF PERMITS: Every permit issued shall become invalid unless the work authorized by such permit is commenced within 180 days after its issuance, or if the work authorized by such permit is suspended or abandoned for a period of 180 days after the time work is commenced. A valid permit receives an approved inspection every 180 days. Work shall be considered not suspended, abandoned or invalid when the permit has received an approved inspection within 180 days of the previous approved inspection.

FLORIDA'S CONSTRUCTION LIEN LAW: Protect Yourself and Your Investment: According to Florida Law, those who work on your property or provide materials, and are not paid-in-full, have a right to enforce their claim for payment against your property. This claim is known as a construction lien. If your contractor fails to pay subcontractors or material suppliers or neglects to make other legally required payments, the people who are owed money may look to your property for payment, even if you have paid your contractor in full. This means if a lien is filed against your property, it could be sold against your will to pay for labor, materials or other services which your contractor may have failed to pay.

NOTICE OF RESPONSIBILITY TO CONTRACTOR AND AGENT: YOU ARE HEREBY NOTIFIED as the recipient of a building permit from Columbia County, Florida, you will be held responsible to the County for any damage to sidewalks and/or road curbs and gutters, concrete features and structures, together with damage to drainage facilities, removal of sod, major changes to lot grades that result in ponding of water, or other damage to roadway and other public infrastructure facilities caused by you or your contractor, subcontractors, agents or representatives in the construction and/or improvement of the building and lot for which this permit is issued. No certificate of occupancy will be issued until all corrective work to these public infrastructures and facilities has been corrected.

WARNING TO OWNER: YOUR FAILURE TO RECORD A NOTICE OF COMMENCEMENT MAY RESULT IN YOU PAYING TWICE FOR IMPROVEMENTS TO YOUR PROPERTY. A NOTICE OF COMMENCEMENT MUST BE RECORDED AND POSTED ON THE JOB SITE BEFORE THE FIRST INSPECTION. IF YOU INTEND TO OBTAIN FINANCING, CONSULT WITH YOUR LENDER OR ATTORNEY BEFORE RECORDING YOUR NOTICE OF COMMENCEMENT.

OWNERS CERTIFICATION: I CERTIFY THAT ALL THE FOREGOING INFORMATION IS ACCURATE AND THAT ALL WORK WILL BE DONE IN COMPLIANCE WITH ALL APPLICABLE LAWS REGULATING CONSTRUCTION AND ZONING.

NOTICE TO OWNER: There are some properties that may have deed restrictions recorded upon them. These restrictions may limit or prohibit the work applied for in your building permit. You must verify if your property is encumbered by any restrictions or face possible ligigation and or fines.

Print Owners Name

Owners Signature

**Property owners <u>must sign</u> here <u>before</u> any permit will be issued.

**If this is an Owner Builder Permit Application then, ONLY the owner can sign the building permit when it is issued.

<u>CONTRACTORS AFFIDAVIT:</u> By my signature I understand and agree that I have informed and provided this written statement to the owner of all the above written responsibilities in Columbia County for obtaining this Byllding Permit including all application and permit time limitations.

Contractor's Signature

Contractor's License Number <u>CRC /330825</u>
Columbia County

Competency Card Number

Affirmed under penalty of perjury to by the Contractor and subscribed before me this And day of December 20 19.

Personally known_____ or Produced Identification_

SEAL:

State of Florida Notary Signature (For the Contractor)

JULIE D. FLOYD

Notary Public – State of Florida

Commission # GG 165779

My Comm Expires Dec 5, 2021

Bended through National Notary Assn

SUBCONTRACTOR VERIFICATION

44116		Epicine 20	MATHEN	
APPLICATION/PERMIT#	JOB NAME	CICICI SOIL	,100.	

THIS FORM MUST BE SUBMITTED BEFORE A PERMIT WILL BE ISSUED

Columbia County issues combination permits. One permit will cover all trades doing work at the permitted site. It is <u>REQUIRED</u> that we have records of the subcontractors who actually did the trade specific work under the general contractors permit.

NOTE: It shall be the responsibility of the general contractor to make sure that all of the subcontractors are licensed with the Columbia County Building Department.

Use website to confirm licenses: http://www.columbiacountyfla.com/PermitSearch/ContractorSearch.aspx

NOTE: If this should change prior to completion of the project, it is your responsibility to have a corrected form submitted to our office, before that work has begun.

Violations will result in stop work orders and/or fines.

		Need
ELECTRICAL /	Print Name Man Matthews Signature Mills	□ Lic □ Liab
V	Company Name: Mathews Electric	= 0.80 = W/C
76	_	□ EX
CC#		I DE
MECHANICAL/	Print Marge King Con stell Signature Kellan Chagester	Need Lic
A/C	Company Name: Registers Houting Still	I Liab
		_ w/c
cc#1052	License #: CACO412671 Phone #: 990 389286	□ EX
PLUMBING/	Print Name Col, Surve Signature	Need
/ r-/		I Lic I Liab
GAS	Company Name: Phundres	± w/c
cc# <u>1</u> (5	License #: CFC 1427145 Phone #: 786 - 623 -0509	I EX
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CC#	License #: Phone #:	I DE
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50140		Need
SOLAR	Print NameSignature	□ Lic
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STATE SPECIALTY	Company Name:	W/C EX DE Need Lic Liab W/C
STATE SPECIALTY	Company Name:	W/C EX DE Need Lic Liab



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ELECTRICAL	Print NameSignature	Need Luc
	Company Name:	T craft C W/C
CC#	License #: Phone #:] EX
MECHANICAL/	Print Name Signature	Need
A/C	1	I tiz I tiab
	Company Name:	I W/C
CC#	License #:Phone #:	I DE
PLUMBING/	Print Name Signature	Need Li
GAS	Company Name:	□ trac □ 1970
CC#	License #:Phone #:	= ±× D#
ROOFING	Print Name Donald Little Signature	Need Lic
X	Company Name: Don Little Construction & Roofing	/ Liah
CC# 1712	License #: CCC 1330420 Phone #: 386-961-0006	I ex
SHEET METAL	Print Name Danald Little Signature	I DE Need
SHEET INETAL	Company Name: Tubular Building Systems, L.C.	I to I tiab
cc# 2030	License #: CBC 1262211 Phone #: 386 - 961 -0006	D W/C
		I 05
FIRE SYSTEM/	Print NameSignature	<u>Meed</u> I tin
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STATE		Need Need
STATE	Print NameSignature	I to
SPECIALTY	Company Name:	_ w/c
CC#	License # Phone #:	I de
Ref: F.S. 440-103		



Columbia County Property Appraiser Jeff Hampton

Parcel: << 07-6S-16-03787-007 >>

Owner & P	Owner & Property Info	Resu	Result: 3 of 6
	ERKINGER MATTHEW A SR &	No.	
	KELLY G ERKINGER		
C	249 SE SAINT JOHNS STE		
	LAKE CITY, FL 32025		
Site	•		
	(AKA PRCL #7 HERLONG JUNCTION UNREC DESC AS): COMMAT NE COR SEC. RUN W 645.53 FT. S 663.97 FT FOR POR RUN W	TION UNREC DESC A	S): COMM AT
Description		FT, N 653.97 FT TO F	OB. WD 1212-
Area	10 AC	S/T/R 07-6S-16	S-16
Use Code**	VACANT (000000)	Tax District 3	
*The Description	*The Description above is not to be used as the Legal Description for this parcel in any legal	cription for this parcel in a	nv legal

transaction.

**The <u>Use Code</u> is a FL Dept. of Revenue (DOR) code and is not maintained by the Property Appraiser's office. Please contact your city or county Planning & Zoning office for specific zoning information.

Property & As	Property & Assessment Values		
2019 C	2019 Certified Values	2020	2020 Working Values
Mkt Land (1)	\$44,500	\$44,500 Mkt Land (1)	\$44,500
Ag Land (0)	\$0	Ag Land (0)	\$0
Building (o)	\$0	Building (0)	\$0
XFOB (0)	\$0	XFOB (0)	\$0
Just	\$44,500	Just	\$44,500
Class	\$0	Class	\$0
Appraised	\$44,500	Appraised	\$44,500
SOH Cap [?]	\$0	SOH Cap [7]	\$0
Assessed	\$44,500	Assessed	\$44,500
Exempt	\$0	Exempt	\$0
Total	county:\$44,500 city:\$44,500	Total	county:\$44,500 city:\$44,500
Taxable	other:\$44,500	Taxable	other:\$44,500
	school:\$44,500		school:\$44,500

Aerial Viewer Pictometery Google Maps

2020 Working Values updated: 11/27/2019



▼ Sales History



CLYATT WELL DRILLING, INC.

(Established in 1971)
Post Office Box 180
Worthington Springs, Florida 32697
Phone (386)496-2488 *** FAX (386)496-4640

WELL DESCRIPTION

DESCRIPTION DATE
6/14/2017

CUSTOMER NAME AND ADDRESS	DESCRIPTION OF WORK
Erkinger Construction Group 248 SE Nassau Street Lake City, Fl 32025	

DESCRIPTION

Feet 4" Well
1 HP Submersible Pump
Feet 1-1/4" Drop Pipe
Feet 14/3 Submersible Pump Wire
81 Gallon Pressure Tank
4 X 1-1/4 Well Seal
Pressure Relief Valve
Controls and Fittings
Sales Tax @ 7%

The above description is provided to give a brief description of the water well to be constructed by Clyatt Well Drilling, Inc.

Legend


Parcels

Roads

- Roads
- others
- Dirt 🏶
- Interstate
- Main
- Other
- Paved
- Private
- SRWMD Wetlands
- 2018Aerials
- LidarElevations

Columbia County, FLA - Building & Zoning Property Map

Printed: Tue Dec 03 2019 09:51:03 GMT-0500 (Eastern Standard Time)

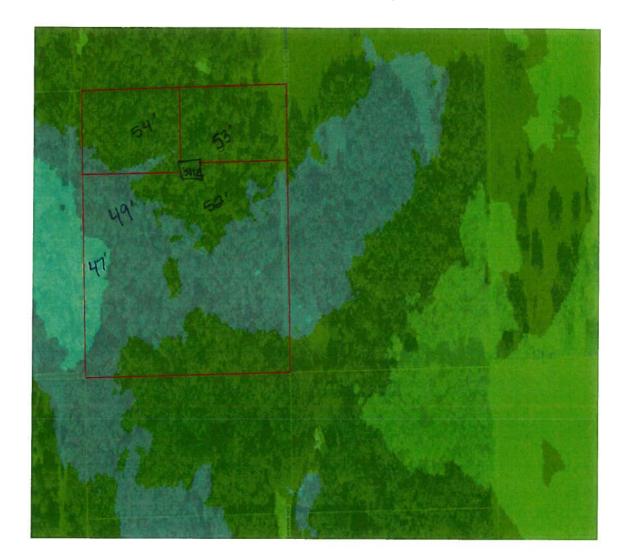

Parcel Information

Parcel No: 07-6S-16-03787-007

Owner: ERKINGER MATTHEW A SR & Subdivision: HERLONG JUNCTION UNR

Lot: 7

Acres: 9.913628 Deed Acres: 10 Ac

District: District 2 Rocky Ford Future Land Uses: Agriculture - 3


Flood Zones:

Official Zoning Atlas: A-3

(8) PLOT PLAN: MATTHEW & KELLY ERKINGER

PARCEL # 07-65-16-03787-007

LOT # 7 HERLONG JUNCTION

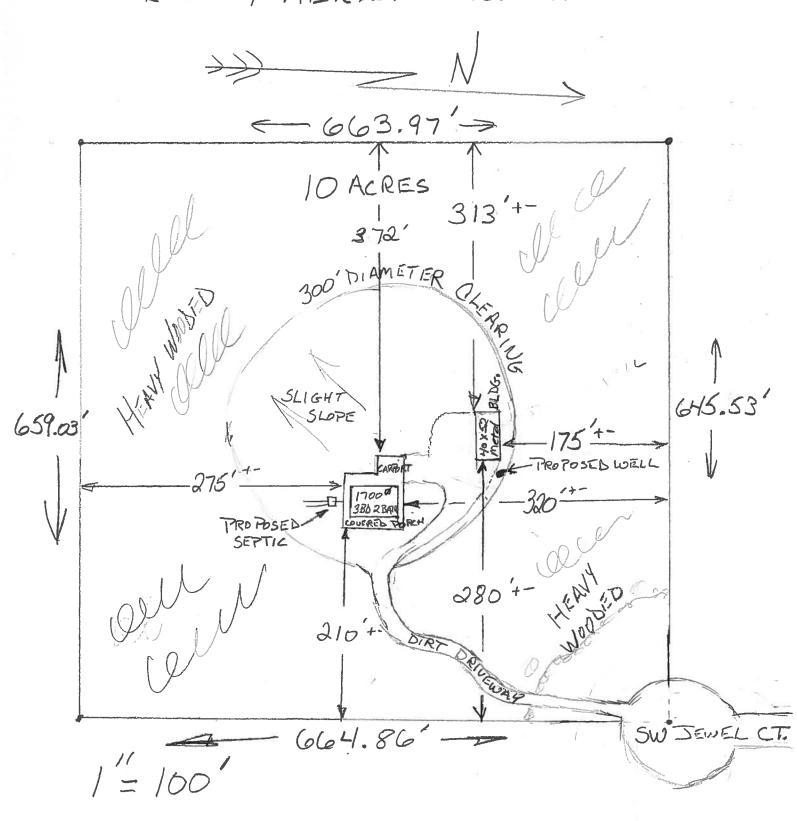



District No. 1 - Ronald Williams District No. 2 - Rocky Ford District No. 3 - Bucky Nash District No. 4 - Tohy Witt District No. 5 - Tim Murphy



Address Assignment and Maintenance Document

To maintain the county wide Addressing Policy you must make application for a 9-1-1 Address at the time you apply for a building permit. The established standards for addressing and posting numbers to all principal buildings, dwellings, businesses and industries are contained in Columbia County Ordinance 2001-9. The addressing system is to enable Emergency Services Agencies to locate you in an emergency, and to assist the United States Postal Service and the public in the timely and efficient provision of services to residents and businesses of Columbia County

Date/Time Issued:

11/25/2019 9:02:12 PM

Address:

222 SW JEWEL Ct

City:

FORT WHITE

State:

FL

Zip Code

32038

Parcel ID

03787-007

REMARKS: Address Verification.

NOTICE: THIS ADDRESS WAS ISSUED BASED ON LOCATION AND ACCESS INFORMATION RECEIVED FROM THE REQUESTER. SHOULD, AT A LATER DATE, THE LOCATION AND/OR ACCESS INFORMATION BE FOUND TO BE IN ERROR OR CHANGED, THIS ADDRESS IS SUBJECT TO CHANGE.

Address Issued By:

Signed:/ Matt Crews

Columbia County GIS/911 Addressing Coordinator

COLUMBIA COUNTY
911 ADDRESSING / GIS DEPARTMENT

263 NW Lake City Ave., Lake City, FL 32055 Telephone: (386) 758-1125 Email: gis@columbiacountyfla.com

NOTICE OF COMMENCEMENT

Tax Parcel Identification Number:

Clerk's Office Stamp

Inst: 201912027958 Date: 12/02/2019 Time: 2:15PM

Page 1 of 1 B: 1400 P: 401, P.DeWitt Cason, Clerk of Court Colm

Bonded through National Notary Assn.

County, By: PT **Deputy Clerk**

THE UNDERSIGNED hereby gives notice that improvements will be made to certain real property, and in accordance with Section 713.13 of the Florida Statutes, the following information is provided in this NOTICE OF COMMENCEMENT.

1. Description of property (legal description): Lot +7 Herlong Junction a) Street (job) Address: 222 SW Jewel Court Fort White, FL 32038
a) Street (job) Address: 222 SW Jewel Court Fort White, FL 32038
2. General description of improvements: Metal Building
3. Owner Information or Lessee information if the Lessee contracted for the improvements:
a) Name and address: Matthew A. Sr and Kelly 6. Eckinger 349 Sr ST. Tohns St. b) Name and address of fee simple titleholder (if other than owner) Lake Cify, FL 32025
b) Name and address of fee simple titleholder (if other than owner) Lake Cify, FL 32025
c) Interest in property
4. Contractor Information
a) Name and address: Erkinger Construction Group 248 SE 19489AU ST b) Telephone No.: (386) 754-5555 Lake (17-, F1 32025
b) Telephone No.: (386) 754-5555 lake (1.4- 51 92075
5. Surety Information (if applicable, a copy of the payment bond is attached):
a) Name and address:
b) Amount of Bond:
c) Telephone No.:
6. Lender
a) Name and address:
b) Phone No.
7. Person within the State of Florida designated by Owner upon whom notices or other documents may be served as provided by Section
a) Name and address: Matthew A. Erfinger 148 SE Nassau St. b) Telephone No.: (396) 754-5555 F Like City, Fh 32025
a) regime dissipations of the state of the s
1) Telephone 10. 1520 154 5300 Like (114, th 32025
8. In addition to himself or herself, Owner designates the following person to receive a copy of the Lienor's Notice as provided in
Section 713.13(I)(b), Florida Statutes:
a) Name:OF
b) Telephone No.:
9. Expiration date of Notice of Commencement (the expiration date will be 1 year from the date of recording unless a different date is specified):
WARNING TO OWNER: ANY PAYMENTS MADE BY THE OWNER AFTER THE EXPIRATION OF THE NOTICE OF
COMMENCEMENT ARE CONSIDERED IMPROPER PAYMENTS UNDER CHAPTER 713, PART I, SECTION 713.13,
FLORIDA STATUTES, AND CAN RESULT IN YOUR PAYING TWICE FOR IMPROVEMENTS TO YOUR PROPERTY; A
NOTICE OF COMMENCEMENT MUST BE RECORDED AND POSTED ON THE JOB SITE BEFORE THE FIRST
INSPECTION. IF YOU INTEND TO OBTAIN FINANCING, CONSULT YOUR LENDER OR AN ATTORNEY BEFORE
COMMENCING WORK OR RECORDING YOUR NOTICE OF COMMENCEMENT.
STATE OF FLORIDA
COUNTY OF COLUMBIA 10. January 4/2/1/4/
Signature of Owner or Lessee, or Owner's or Lessee's Authorized Office/Director/Partner/Manager
Tuls.
Printed Name and Signatory's Title/Office
Printed Name and Signatory's Title/Office
Printed Name and Signatory's Title/Office
Printed Name and Signatory's Title/Office The foregoing instrument was acknowledged before me, a Florida Notary, this
Printed Name and Signatory's Title/Office The foregoing instrument was acknowledged before me, a Florida Notary, this
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Printed Name and Signatory's Title/Office The foregoing instrument was acknowledged before me, a Florida Notary, this





Florida Product Approval Codes

Roll-Up Doors:

Janus International Corporation Model 3652: 14425.1

EXP 12/31/2019

Roof Deck:

Capital Metal Supply Inc. Ag Panel: 20147.1

EXP 07/20/2020


Wall Panel:

Capital Metal Supply Inc. Ag Panel: 20148.1

EXP 07/20/2020

If you have any questions on concern, please contact Donald Little at 386-961-0006 or at tubularbuildingsystems@gmail.com.



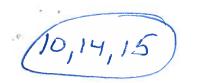



STRUCTURAL DESIGN

ENCLOSED BUILDING EXPOSURE B

MAXIMUM 40'-0" WIDE X 20'-0" EAVE HEIGHT- BOX EAVE FRAME

18 December 2017 Revision 4 M&A Project No. 16022S/16072S/16073S/17301S

Prepared for:

Tubular Building Systems, LLC 631 SE Industrial Circle Lake City, Florida 32025

Prepared by:

Moore and Associates Engineering and Consulting, Inc. 1009 East Avenue North Augusta, SC 29841

> 401 S. Main Street, Suite 200 Mount Airy, NC 27030





					
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MOORE AND	ASSOCIATES	DRAWN BY: JRS	TUB	ULAR BUILDING SYS PE COVER SHEET	TEMS
	CONSULTING, INC.	CHECKED BY: PDH	40'-0"x20'-	0" ENCLOSED BUILD	
	ORE AND ASSOCIATES, INC. THE OR OTHERWISE USE OF THIS DOCUMENT IS MENT THEREUPON MAY BE SUBJECT TO	PROJECT MGR: VSM	DATE: 12-18-17		17301S 3 NO: 16022S
STRICTLY PROHIBITED AND ANY INFRINGE	MENT THEREUPON HAY BE SUBJECT TO	CLIENT: TBS	SHT. 1	DVG. NO: SK-2	REV: 4

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DRAWING INDEX

SHEET 1	PE SEAL COVER SHEET
SHEET 2	DRAWING INDEX
SHEET 3	INSTALLATION NOTES AND SPECIFICATIONS
SHEET 4	TYPICAL SIDE AND END ELEVATIONS
SHEET 5	TYPICAL RAFTER/POST FRAME AND SIDE FRAMING SECTION
SHEET 5A	TYPICAL RAFTER/POST FRAME AND SIDE FRAMING SECTION
SHEET 6	TYPICAL RAFTER/POST CONNECTION DETAILS
SHEET 6A	TYPICAL RAFTER/POST CONNECTION DETAILS
SHEET 7A	BASE RAIL ANCHORAGE OPTIONS FOR LOW AND HIGH WIND SPEED
SHEET 7B	OPTIONAL FOUNDATION ANCHORAGE FOR LOW AND HIGH WIND SPEED
SHEET 8	BOX EAVE RAFTER END WALL AND WALL OPENINGS
SHEET 9	BOX EAVE RAFTER SIDE WALL AND WALL OPENINGS
SHEET 10	BOX EAVE RAFTER WALL OPENING DETAILS
SHEET 11	BOX EAVE RAFTER WALL OPENING DETAILS
SHEET 12	BOX EAVE RAFTER LEAN-TO OPTIONS
SHEET 12A	BOX EAVE RAFTER LEAN-TO OPTIONS AND DETAILS
SHEET 13	BOX EAVE RAFTER VERTICAL ROOF/SIDING OPTION
SHEET 14	BOX EAVE RAFTER VERTICAL ROOF/SIDING OPTION
SHEET 15	OPTIONAL HEADER



UNAUTHORIZED REPRODUCTION, COPYING, OR OTHERVISE USE OF THIS DOCUMENT IS STRICTLY PROHIBITED AND ANY INFRINGEMENT THEREUPON MAY BE SUBJECT TO LEGAL ACTION.	CLIENT: TBS	SHT. 2	DAC NO 2K-5	REV: 4
THIS DOCUMENT IS THE PROPERTY OF MODRE AND ASSOCIATES, INC. THE	PROJECT MGR: VSM	DATE: 12-18-17	SCALE: NTS	JOB NO: 16022S
ENGINEERING AND CONSULTING, INC.	CHECKED BY: PDH	40'-0"x20'-	0" ENCLOSED BU	
MOORE AND ASSOCIATES	DRAWN BY: JRS		JLAR BUILDING	

INSTALLATION NOTES AND SPECIFICATIONS

- 1. DESIGN IS FOR A MAXIMUM 40'-0" WIDE \times 20'-0" EAVE HEIGHT STRUCTURES.
- 2. DESIGN WAS DONE IN ACCORDANCE WITH THE 2014 FLORIDA BUILDING CODE (FBC) 5TH EDITION, 2017 FBC 6TH EDITION, 2012 INTERNATIONAL BUILDING CODE (IBC), AND 2015 IBC (U.N.D.)
- 3. DESIGN LOADS ARE AS FOLLOWS:

A) DEAD LOAD

= 1.5 PSF

B) LIVE LOAD

= 12 PSF

- C) GROUND SNOW LOAD = 10 PSF
- 4. LOW ULTIMATE WIND SPEED 105 TO 140 MPH (NOMINAL WIND SPEED 81 TO 108 MPH): MAXIMUM RAFTER/POST AND END POST SPACING = 5.0 FEET.
- 5. HIGH ULTIMATE WIND SPEED 141 TO 170 MPH (NOMINAL WIND SPEED 109 TO 132 MPH): MAXIMUM RAFTER/POST AND END POST SPACING = 4.0 FEET.
- 6. RISK CATEGORY I.
- 7 WIND EXPOSURE CATEGORY B.
- 8. SPECIFICATIONS APPLICABLE TO 29 GAUGE METAL PANELS FASTENED DIRECTLY TO 2 1/2' x 2 1/2' 14 GAUGE TUBE STEEL (TS) FRAMING MEMBERS. FOR VERTICAL PANELS, 29 GAUGE METAL PANELS SHALL BE FASTENED TO 18 GAUGE HAT CHANNELS (U.N.D.)
- 9. AVERAGE FASTENER SPACING ON-CENTERS ALONG RAFTERS OR PURLINS, AND POSTS, INTERIOR = 9° AND END = 6°, (MAX).
- 10. FASTENERS CONSIST OF #12-14x3/4' SELF-DRILLING FASTENER (SDF), USE CONTROL SEAL WASHER WITH EXTERIOR FASTENERS.
 SPECIFICATIONS APPLICABLE DNLY FOR MEAN ROOF HEIGHT OF 20 FEET OR LESS, AND ROOF SLOPES OF 14° (3:12 PITCH) OR LESS SPACING REQUIREMENTS FOR OTHER ROOF HEIGHTS AND/OR SLOPES MAY VARY.
- 11. GROUND ANCHORS CONSISTING OF #4 REBAR W/WELDED NUT x 30° LONG MAY BE USED FOR LOW WIND SPEEDS ONLY.
- 12. GROUND ANCHORS (SDIL NAILS) CONSIST OF #4 REBAR W/ WELDED NUT x 30° LONG IN SUITABLE SDIL CONDITIONS. OPTIONAL ANCHORAGE MAY BE USED IN SUITABLE SDILS AND MUST BE USED IN UNSUITABLE SDILS AS NOTED. SDIL NAILS ARE NOT ALLOWED FOR HIGH WIND APPLICATION.
- 13. GROUND ANCHORS SHALL BE INSTALLED THROUGH BASE RAIL WITHIN 6° DF EACH RAFTER COLUMN ALONG SIDES AND ENDS
- 14. OPTIONAL BASE RAIL ANCHORAGE MAY BE USED FOR LOW AND AND MUST BE USED FOR HIGH WIND SPEEDS
- 15. WIND FORCES GOVERN OVER SEISMIC FORCES. SEISMIC PARAMETERS ANALYZED ARE:


SDIL SITE CLASS = D RISK CATEGORY I/II/III

R = 3.25


 $I_E = 1.0$ $\vee = C_S W$ S_{DS} = 1.522

 $S_{DI} = 0.839$

ENGRICEDING AND CONCULTANCE DIC	DRAWN BY: JRS CHECKED BY: PDH	1	LAR BUILDING : " ENCLOSED BU	
The second is the second to th	PROJECT MGR: VSM		SCALE: NTS	JOB NO: 16022S

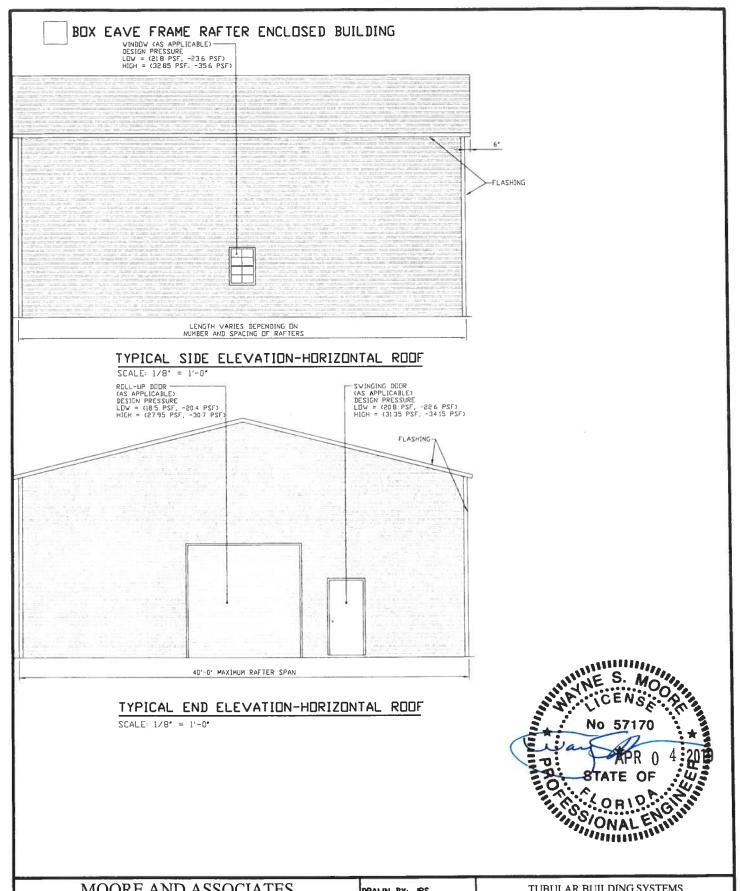


MOORE AND ASSOCIATES	DRAWN BY: JRS		TUBULAR BUILDING SYSTEMS		
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TYPICAL RAFTER/POST FRAME SECTION

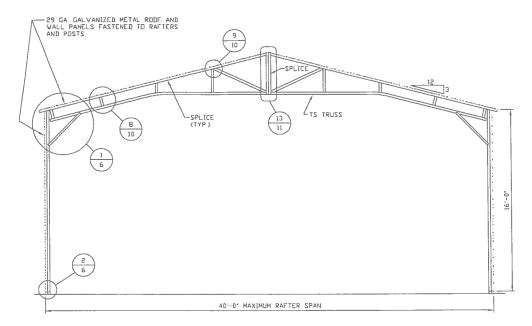
SCALE: 1/8" = 1'-0"



TYPICAL RAFTER/POST SIDE FRAMING SECTION
SCALE: 1/8' = 1'-0'

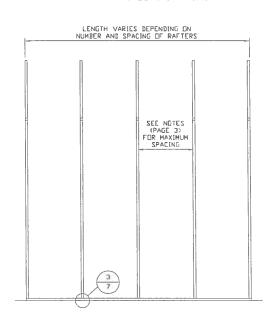


MOORE AND ASSOCIATES	DRAWN BY: JRS TUBULAR BUILDING SYSTE 40'-0"x20'-0" ENCLOSED BUILDING			
ENGINEERING AND CONSULTING, INC.	CHECKED BY: PDH	40-0 120-0		
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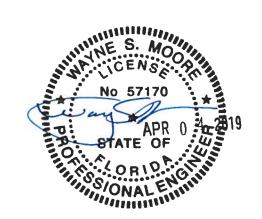
TYPICAL RAFTER/POST FRAME SECTION

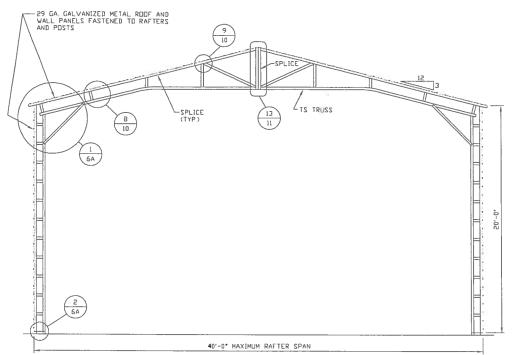SCALE: 1/8" = 1'-0"





TYPICAL RAFTER/POST SIDE FRAMING SECTION

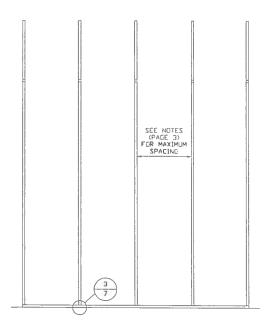SCALE: 1/8" = 1'-0"



MOORE AND ASSOCIATES	DRAWN BY: JRS	TUBU	JLAR BUILDING S	SYSTEMS
ENGINEERING AND CONSULTING, INC.	CHECKED BY: PDH	40'-0"x20'-0	" ENCLOSED BUI	LDING EXP. B
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STRICTLY PROHIBITED AND ANY INFRINGENENT THEREUPON MAY BE SUBJECT TO LEGAL ACTION.	CLIENT: TBS	SHT. 5A	DVG NO SK-2	REV: 4

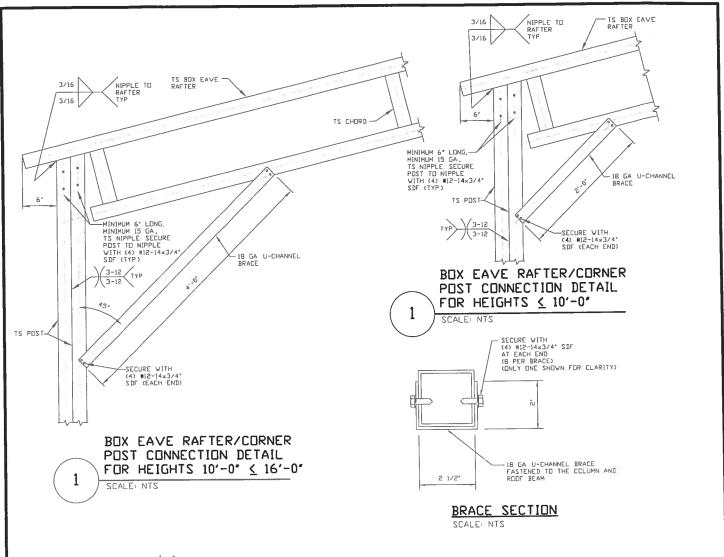


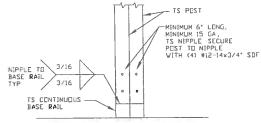


2 POST/BASE RAIL CONNECTION DETAIL



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BASE RAIL ANCHORAGE OPTIONS FOR LOW AND HIGH WIND SPEED

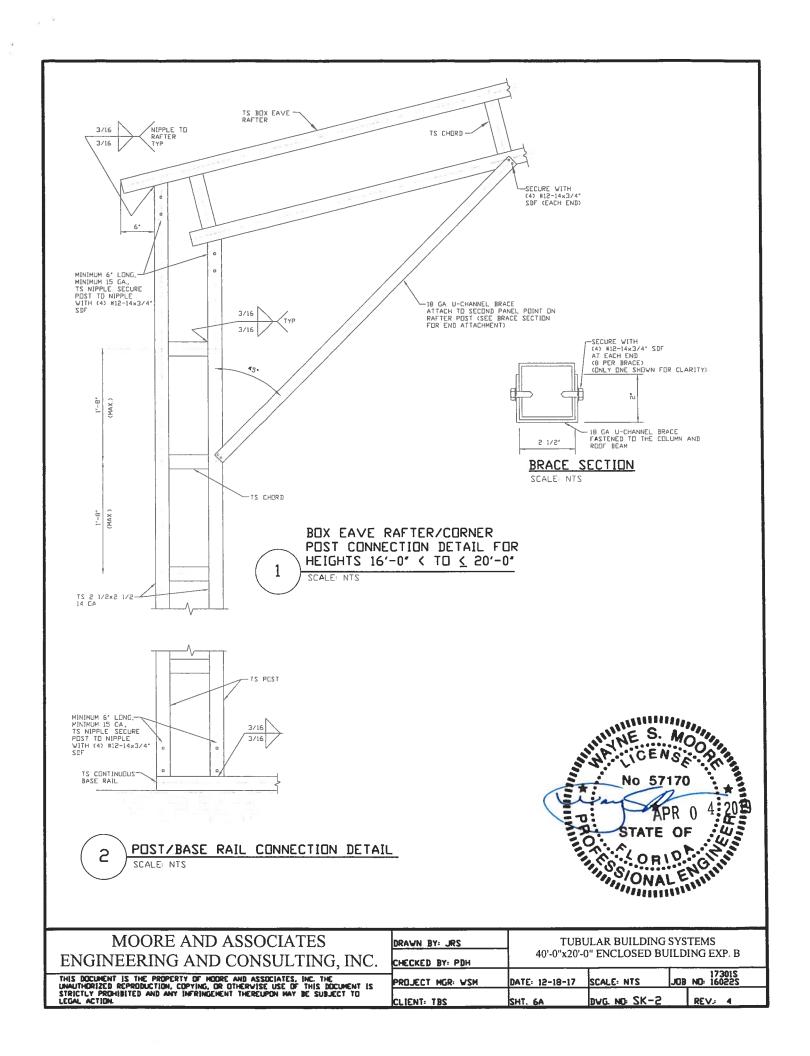

CONCRETE MONOLITHIC SLAB BASE RAIL ANCHURAGE 3A SCALE: NTS (MINIMUM ANCHOR EDGE DISTANCE IS 4") COORDINATE WITH LOCAL CODES/ORD

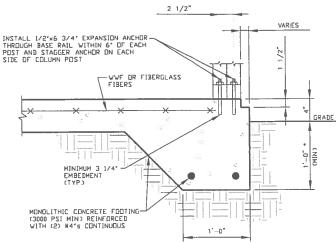GENERAL NOTES

CONCRETE:

CONCRETE SHALL HAVE A MINIMUM SPECIFIED COMPRESSIVE STRENGTH OF 3,000 PSI AT 28 DAYS

COVER OVER REINFORCING STEEL:

FOR FOUNDATIONS, MINIMUM CONCRETE COVER OVER REINFORCING BARS SHALL BE PER ACI-318
3 INCHES IN FOUNDATIONS WHERE THE CONCRETE IS CAST AGAINST AND PERMANENTLY IN CONTACT WITH THE EARTH OR EXPOSED TO THE EARTH OR WEATHER, AND I 1/2 INCHES ELSEWHERE

REINFORCING STEEL:


THE TURNDOWN REINFORCING STEEL SHALL BE ASTM A615 GRADE 60 THE SLAB REINFORCEMENT SHALL BE WELDED WIRE FABRIC MEETING ASTM A185 OR FIBERGLASS FIBER REINFORCEMENT.

REINFORCEMENT MAY BE BENT IN THE SHOP OR THE FIELD PROVIDED:

- 1 REINFORCEMENT IS BENT COLD
 2 THE DIAMETER OF THE BEND, MEASURED ON THE INSIDE OF THE BAR, IS NOT LESS THAN SIX-BAR DIAMETERS
 3 REINFORCEMENT PARTIALLY EMBEDDED IN CONCRETE SHALL NOT
- BE FIELD BENT

HELIX ANCHOR NOTES:

- 1 FOR VERY DENSE AND/OR CEMENTED SANDS, COARSE GRAVEL AND COBBLES, CALICHE, PRELGADED SILTS AND CLAYS USE MINIMUM (2) 4' HELICES WITH MINIMUM 30 INCH EMBEDMENT.
- 2 FOR CORAL USE MINIMUM (2) 4. HELICES WITH MINIMUM 30 INCH EMBEDMENT.
- 3 FOR MEDIUM DENSE COARSE SANDS, SANDY GRAVELS, VERY STIFF SILTS AND CLAYS USE MINIMUM (2) 4' HELICES WITH MINIMUM 30 INCH EMBEDMENT,
- 4 FOR LODSE TO MEDIUM DENSE SANDS, FIRM TO STIFF CLAYS AND SILTS ALLUVIAL FILL USE MINIMUM (2) 6' HELICES WITH MINIMUM 50 INCH EMBEDMENT.
- 5 FOR VERY LODSE TO MEDIUM DENSE SANDS, FIRM TO STIFFER CLAYS AND SILTS, ALLUVIAL FILL USE MINIMUM (2) 8' HELICES WITH MINIMUM 60 INCH EMBEDMENT.

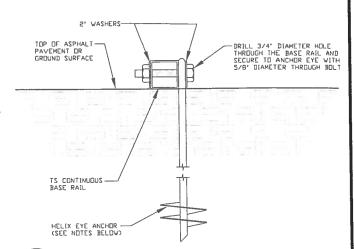


GROUND BASE HELIX ANCHORAGE 3B SCALE: NTS (CAN BE USED FOR ASPHALT)



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OPTIONAL FOUNDATION ANCHORAGE FOR LOW AND HIGH WIND SPEED

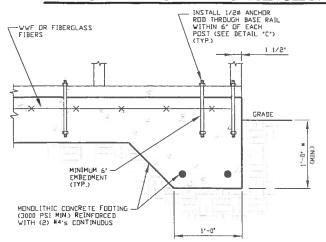

(1A)

CONCRETE MONOLITHIC SLAB BASE RAIL ANCHORAGE

SCALE: NTS (MINIMUM ANCHOR EDGE DISTANCE IS 1 1/2") * COORDINATE WITH LOCAL CODES/ORD

GENERAL NOTES

CONCRETE:

CONCRETE SHALL HAVE A MINIMUM SPECIFIED COMPRESSIVE STRENGTH DF 3,000 PSI AT 28 DAYS.

COVER OVER REINFORCING STEEL:


FOR FOUNDATIONS, MINIMUM CONCRETE COVER OVER REINFORCING BARS SHALL BE PER ACI-318
3 INCHES IN FOUNDATIONS WHERE THE CONCRETE IS CAST AGAINST AND PERMANENTLY IN CONTACT WITH THE EARTH OR EXPOSED TO THE EARTH OR WEATHER, AND 1 1/2 INCHES ELSEWHERE

REINFORCING STEEL:

THE TURNDOWN REINFORCING STEEL SHALL BE ASTM A615 GRADE 60. THE SLAB REINFORCEMENT SHALL BE WELDED WIRE FABRIC MEETING ASTM A185 OR FIBERGLASS FIBER REINFORCEMENT

REINFORCEMENT MAY BE BENT IN THE SHOP OR THE FIELD PROVIDED:


- 1 REINFORCEMENT IS BENT COLD
- 2 THE DIAMETER OF THE BEND, MEASURED ON THE INSIDE OF THE BAR, IS NOT LESS THAN SIX-BAR DIAMETERS
- 3 REINFORCEMENT PARTIALLY EMBEDDED IN CONCRETE SHALL NOT BE FIELD BENT

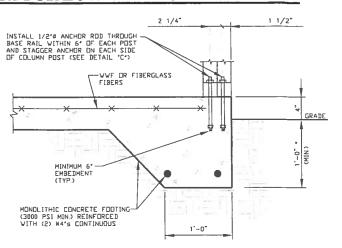

1B

CONCRETE MONOLITHIC SLAB BASE RAIL ANCHORAGE


SCALE: NTS
(MINIMUM ANCHOR EDGE DISTANCE IS 1 1/2*)
* COORDINATE WITH LOCAL CODES/ORD

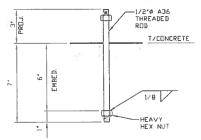

(1C)

ANCHOR ROD THROUGH BASE RAIL DETAIL


SCALE: NTS

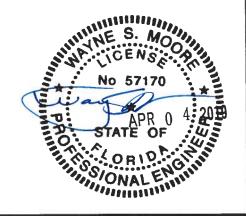


MOORE AND ASSOCIATES	DRAWN BY: JRS		JLAR BUILDING	
ENGINEERING AND CONSULTING, INC.	CHECKED BY: PDH	40'-0"x20'-0" ENCLOSED BUILDING EXP. B		
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TYPICAL BOX EAVE RAFTER END WALL FRAMING SECTION

SCALE: 1/8" = 1'-0"

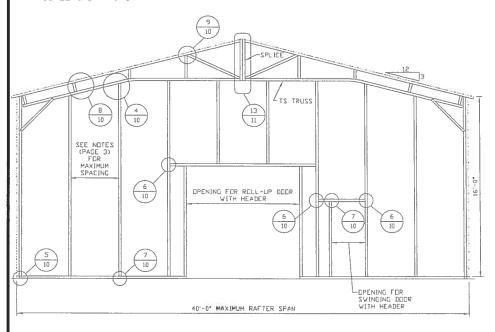


TYPICAL BOX EAVE RAFTER END WALL OPENINGS FRAMING SECTION
SCALE: 1/8' = 1'-0'

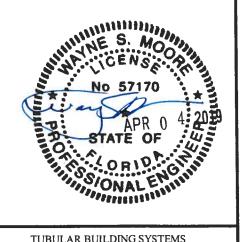

MOORE AND ASSOCIATES	DRAVN BY: JRS		JLAR BUILDING	
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	CLIENT: TBS	SHT. 8	DVG NO SK-2	REV: 4

BOX EAVE RAFTER SIDE WALL AND WALL OPENINGS

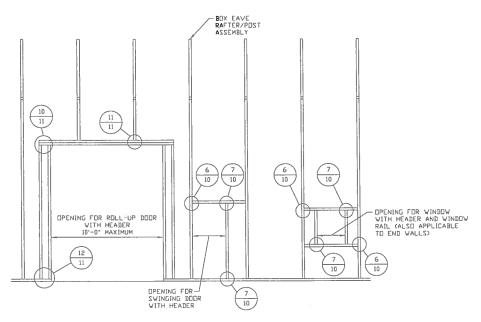


TYPICAL BOX EAVE RAFTER SIDE WALL OPENINGS FRAMING SECTION


SCALE: 1/8' = 1'-0'




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BOX EAVE RAFTER WALL OPENING DETAILS



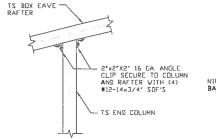

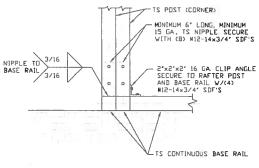

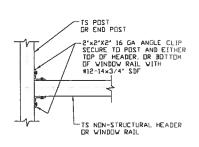
END POST/RAFTER CONNECTION DETAIL

END POST/BASE RAIL CONNECTION DETAIL 5

3/16

TS CHORD

6

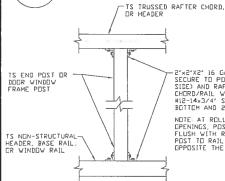

4

-2'x2'X2' 16 GA ANGLE CLIP SECURE TO PDST (EACH SIDE) AND RAFTER CHORD/RAIL WITH #12-14'X3/4' SDF 2 ON BOTTOM AND 2 ON SIDE


NDTE: AT ROLL-UP BOOR OPENINGS, POST SHOULD BE FLUSH WITH RAIL END CLIP POST TO RAIL ONLY ON SIDE OPPOSITE THE OPENING.

TS BDX EAVE-

HEADER OR WINDOW RAIL TO POST CONNECTION DETAIL

TS BOX EAVE-RAFTER

3/16

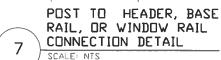

CHORD/RAFTER CONNECTION DETAIL 8 SCALE: NTS

3/16 TRUSS POST AND CORD TO RAFTER CONNECTION DETAIL 9 SCALE NTS

TS CHORD




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CHECKED BY: PDH	40-0 X20-								
PROJECT MGR: WSM	DATE: 12-18-17	DATE: 12-18-17 SCALE: NTS JUB NO: 160225							
CLIENT: TBS	SHT. 10	DVG. NO: SK-2	2	REV: 4					

BOX EAVE RAFTER WALL OPENING DETAILS




DOUBLE HEADER/POST CONNECTION DETAIL

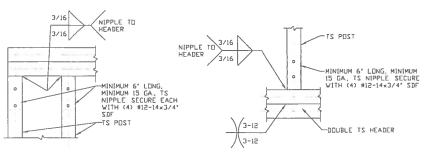SCALE NTS

POST/DOUBLE HEADER
CONNECTION DETAIL
SCALE: NTS


12 POST/BASE RAIL
CONNECTION DETAIL
SCALE: NTS

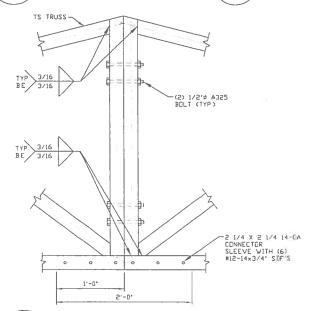



13 SPLICE CONNECTION DETAIL



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LEAN-TO RAFTER TO RAFTER

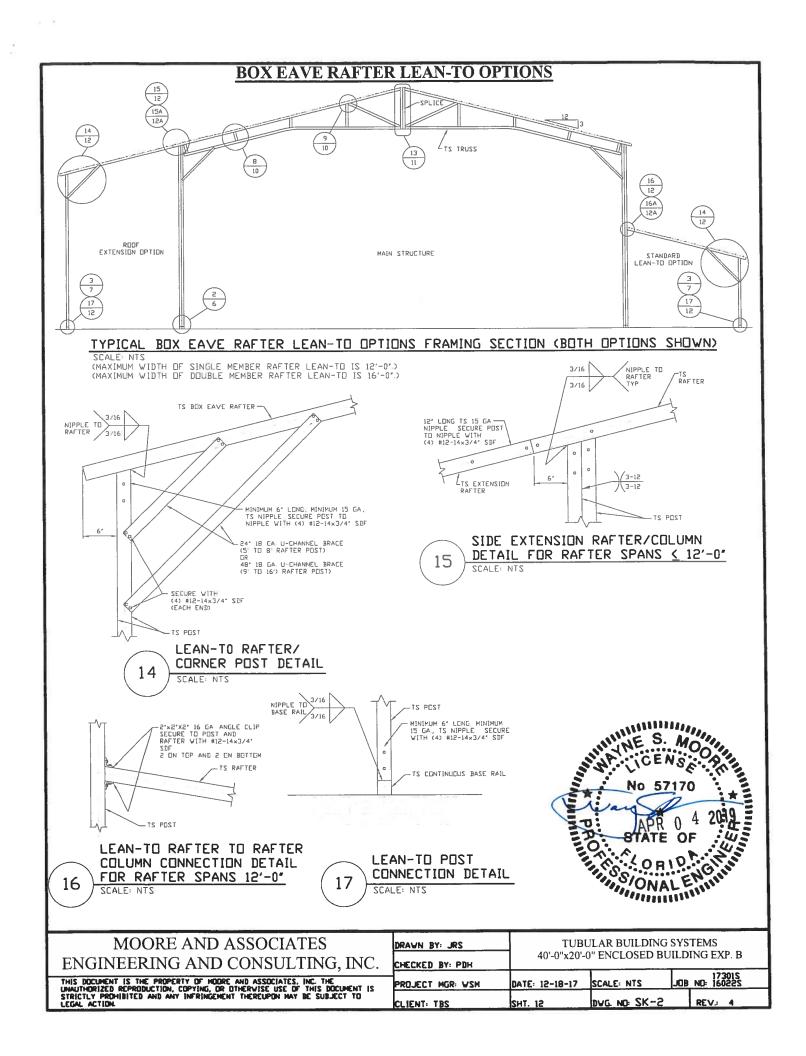SIDE EXTENSION RAFTER/COLUMN DETAIL FOR RAFTER SPANS 12'-0' < L < 16'-0"

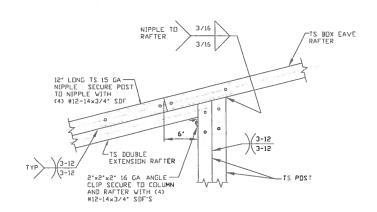(16A)

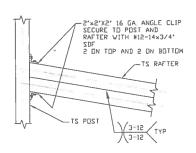COLUMN CONNECTION DETAIL FOR RAFTER SPANS 12'-0" < L < 16'-0" SCALE: NTS

No 57170


No 57170

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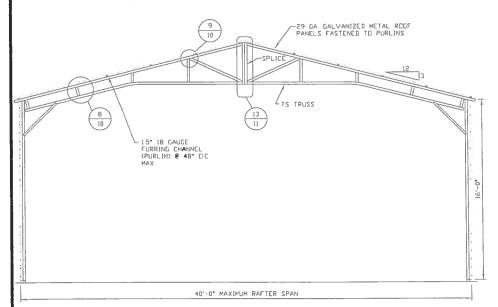
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ENGINEERING AND CONSULTING, INC.	CHECKED BY: PDH	40'-0"x20'-	40'-0"x20'-0" ENCLOSED BUILDING EXP. B		
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BOX EAVE RAFTER VERTICAL ROOF/SIDING OPTION



TYPICAL END ELEVATION VERTICAL ROOF

SCALE: 1/8" = 1'-0"

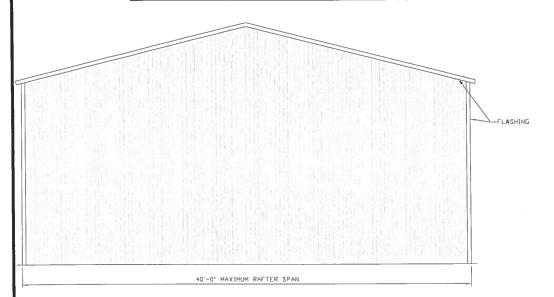


TYPICAL SECTION VERTICAL ROOF OPTION SCALE: 1/8' = 1'-0'




MOORE AND ASSOCIATES ENGINEERING AND CONSULTING, INC.	DRAWN BY: JRS	TUBULAR BUILDING SYSTEMS 40'-0"x20'-0" ENCLOSED BUILDING EXP. B		
		DATE: 12-18-17	SCALE: NTS	JOB NO: 16022S

BOX EAVE RAFTER VERTICAL ROOF/SIDING OPTION

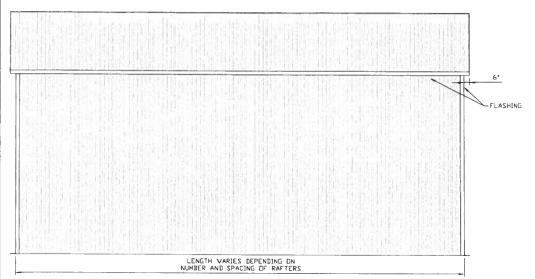

TYPICAL SIDE ELEVATION VERTICAL ROOF/SIDING SCALE: 1/8' = 1'-0'

TYPICAL FRAMING SECTION VERTICAL ROOF/SIDING OPTION

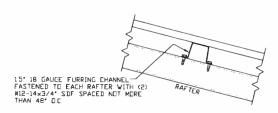


PANEL ATTACHMENT
(ALTERNATE FOR VERTICAL ROOF PANELS)




MOORE AND ASSOCIATES	DRAWN BY: JRS	TUBULAR BUILDING SYSTEMS		
ENGINEERING AND CONSULTING, INC.	CHECKED BY: PDH	40'-0"x20'-0" ENCLOSED BUILDING EXP. B		
	PROJECT MGR: WSM	DATE: 12-18-17	SCALE: NTS	17301S JOB NO: 16022S
STRICTLY PROHIBITED AND ANY INFRINGENENT THEREUPON MAY BE SUBJECT TO LEGAL ACTION.	CLIENT: TBS	SHT. 14	DVG. NO: SK-2	REV. 4

OPTIONAL HEADER

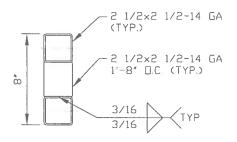

HEADER DETAIL FOR OPENINGS 10'-0" < LENGTH <15'-0"

SCALE: NTS

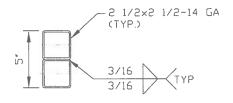


HEADER DETAIL FOR OPENINGS LENGTH ≤10'-0"

SCALE: NTS



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Florida Product Approval Codes

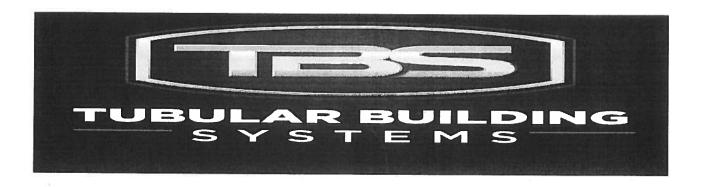Roll-Up Doors:

Janus International Corporation Model 3652: 14425.1

EXP 12/31/2019

Roof Deck:

Capital Metal Supply Inc. Ag Panel: 20147.1


EXP 07/20/2020


Wall Panel:

Capital Metal Supply Inc. Ag Panel: 20148.1

EXP 07/20/2020

If you have any questions on concern, please contact Donald Little at 386-961-0006 or at tubularbuildingsystems@gmail.com.

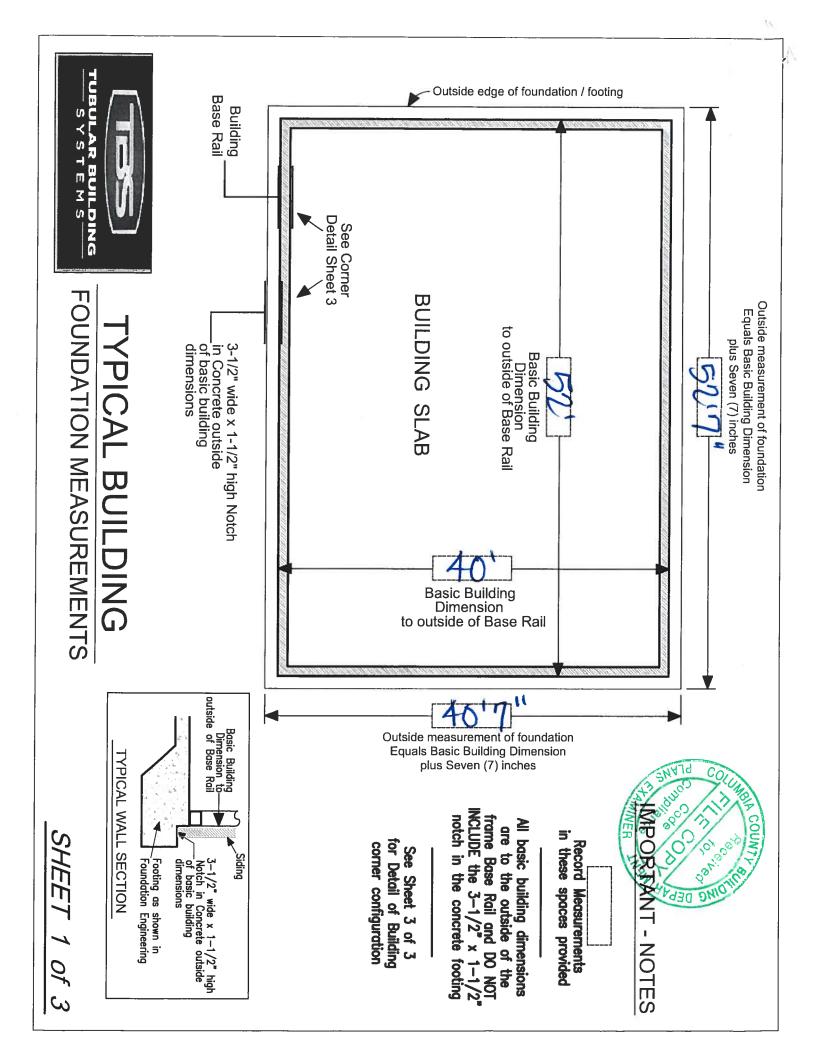

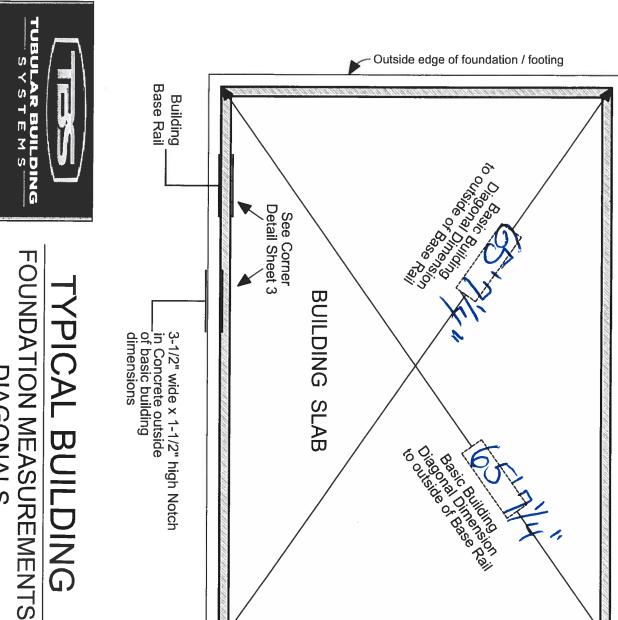


IMPORTANT - NOTES

in these spaces provided Record Measurements


All basic building diagonal dimensions are to the outside corner of the frame Base Rail and DO NOT INCLUDE the 3-1/2" x 1-1/2" notch in the concrete footing

corner configuration for Detail of Building See Sheet 3 of 3

DIAGONALS

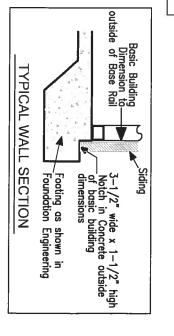

SHEET 2 of 3

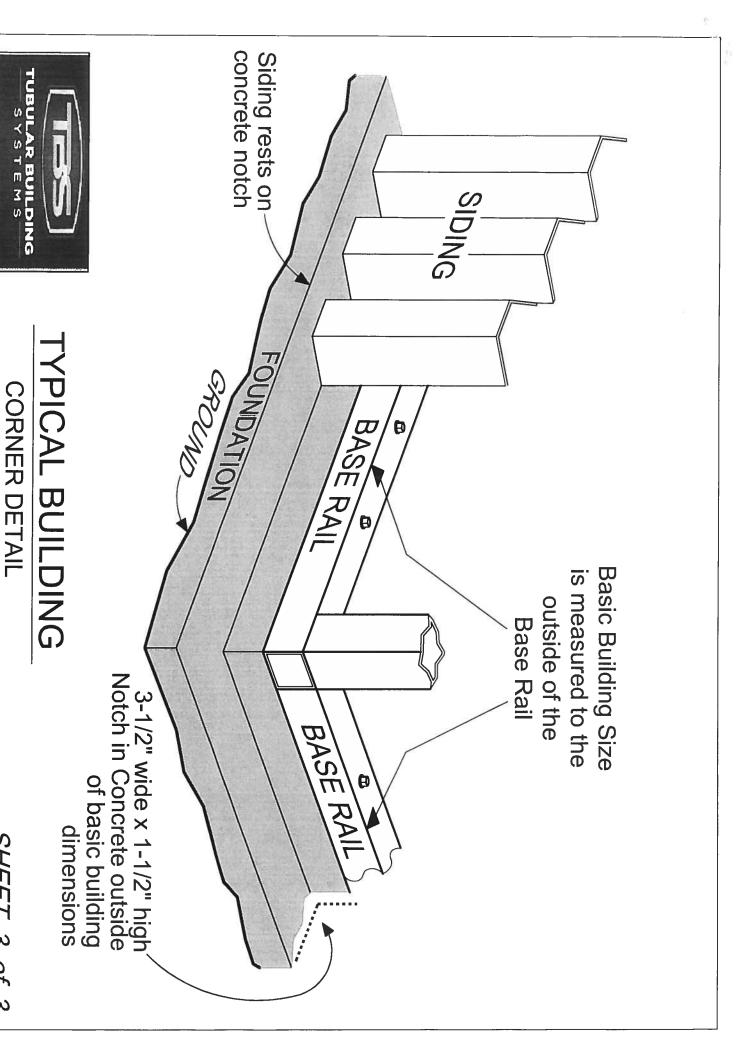

SHEET 3 of 3