GENERAL NOTES:

- 1. STRUCTURE HAS BEEN DESIGNED IN ACCORDANCE WITH THE 2023 FLORIDA BUILDING CODE (FBC).
- 2. ALL MATERIALS AND CONSTRUCTION SHALL BE IN ACCORDANCE WITH THE ABOVE CODES AT THE TIME OF MANUFACTURE.
- 3. DRAWINGS SHALL NOT BE SCALED FOR DIMENSIONS.
- 4. STRUCTURES ARE CLASSIFIED AS "MINOR STORAGE FACILITIES" (RISK CATEGORY I) PER TABLE 1604.5 AND SHOULD NOT BE USED FOR HUMAN HABITATION.
- 5. STRUCTURES ARE DESIGNED FOR LOCATIONS THAT HAVE A 3 SECOND WIND GUST OF 160 MPH FOR RISK CATEGORY I STRUCTURES PER FIGURE 1609.3(4) OF THE 2023 FBC.
- 6. SIDING FASTENERS SHALL NOT BE INSTALLED IN PANEL SIDING GROOVES IN THE FIELD OF THE PANEL OR WHEN THE SIDING GROOVES OCCUR AT CUT EDGES OF THE SIDING PANEL.
- 7. STRUCTURES ARE DESIGNED FOR LOCATIONS THAT ARE NOT IN FLOOD HAZARD AREAS.
- 8. IN ACCORDANCE WITH FBC 1609.1.2, STORAGE SHEDS NOT DESIGNED FOR HUMAN HABITATION WITH A FLOOR AREA OF 720 SQUARE FEET OR LESS ARE NOT REQUIRED TO COMPLY WITH THE MANDATORY WINDBORNE DEBRIS IMPACT STANDARDS OF THE 2023 FBC.
- 9. IN ACCORDANCE WITH FBC 1010.1.1, BUILDINGS THAT ARE 400 SQUARE FEET OR LESS THAT ARE INTENDED FOR USE IN CONJUNCTION WITH ONE- AND TWO- FAMILY RESIDENCES ARE NOT SUBJECT TO THE DOOR HEIGHT AND WIDTH REQUIREMENTS OF THE 2023 FBC.
- 10. ALL ROOF DECKING IS TO BE $\frac{7}{16}$ " OSB, $\frac{15}{32}$ " PLYWOOD, 1/2" PLYWOOD, OR EQUIVALENT. FASTEN ROOF SHEATHING TO ROOF FRAMING WITH 2%" RING SHANK NAILS SPACED AT 6" MAX, UNLESS NOTED OTHERWISE ON SHEET S-1.6.
- 11. ALL SIDING IS TO BE TREATED \(\frac{5}{8} \)" T1-11, \(\frac{3}{8} \)" LP SMARTSIDE PANEL, 1/2" DURATEMP, LAP SIDING, OR 29 GA. METAL SIDING. $\frac{7}{16}$ " OSB WALL SHEATHING IS TO BE INSTALLED ON ALL WALLS USING LAP SIDING.

- 12. ALL FLOOR JOISTS ARE TO BE PRESSURE TREATED SYP #2, OR BETTER.
- 13. ALL UN-TREATED WOOD FRAMING IS TO BE TO BE SPF #2 OR BETTER. UNLESS NOTED OTHERWISE.
- 14. WOOD FRAMING SHALL COMPLY WITH THE ANSI/AWC "NATIONAL DESIGN SPECIFICATION (NDS) FOR WOOD CONSTRUCTION", 2018.
- 15. ALL FLOOR DECKING IS TO BE $\frac{5}{8}$ " TREATED PLYWOOD OR 5/8" PERFORMAX 500 FLOOR SHEATHING. FLOORING CLOSER THAN 18 INCHES TO EXPOSED GROUND SHALL BE OF NATURALLY DURABLE OR PRESERVATIVE- TREATED WOOD IN ACCORDANCE WITH 2304.12.1.1.
- 16. ALL SKIDS ARE TO BE 4x6 PRESSURE TREATED. RATED FOR GROUND CONTACT.
- 17. REFER TO THE SUPPLIED FASTENING SCHEDULE FOR FASTENING BASED ON CONNECTION AND LOCATION OF MEMBERS AS PER THE 2023 FLORIDA BUILDING CODE TABLE 2304.10.1, UNLESS NOTED OTHERWISE.
- 18. ALL EXTERIOR NAILS ARE TO BE ZINC COATED.
- 19. STRUCTURES SHOULD HAVE 30 YEAR RATED ASPHALT SHINGLES CONFORMING TO ASTM D3161 (CLASS F) OR ASTM D7158 (CLASS H) OR 29 GA METAL ROOF PANELS.
- 20. SECTIONS AND DETAILS SHOWN ARE INTENDED TO BE TYPICAL AND SHALL APPLY AT ALL SIMILAR LOCATIONS. UNLESS NOTED OTHERWISE.
- 21. ALL BUILDINGS ARE TO BE ADEQUATELY ANCHORED TO TO RESIST WIND LOADS. ANCHORING OF THE BUILDING IS SUBJECT TO LOCAL JURISDICTION APPROVAL.
- 22. BUILDINGS HAVE NOT BEEN DESIGNED FOR HVHZ REQUIREMENTS AS SET FORTH IN THE 2023 FBC.
- 23. METAL ROOFING AND SIDING SHALL BE 29 GAUGE STEEL CORRUGATED PANELS WITH A MINIMUM OF 3/4" RIBS AT 9 INCHES ON CENTER (Fy = 80 KSI MIN). PANELS SHALL BE GALVANIZED OR PAINTED.

DESIGN CRITERIA: 1. RISK CATEGORY I

2. LIVE LOADS: FLOOR: 40 PSF LOFT: 10 PSF ROOF: 20 PSF

(REDUCIBLE PER FBC 1607.13.2.1)

3 DEAD LOADS: FLOOR: 4 PSF ROOF: 5 PSF WALLS: 3 PSF

4. WIND LOADS ARE BASED ON THE FOLLOWING: Vult = 160 MPH (2023 FBC FIGURE 1609.3(4))

Plans

Reviewed for Code

Compliance

Vasd = 124 MPH RISK CATEGORY I EXPOSURE CATEGORY C INTERNAL PRESSURE COEFFICIENT: $GCpi = \pm 0.18$

COMPONENTS & CLADDING:

EFFECTIVE WIND AREA, Ae = 10 FT² ROOF-ZONE 1 = 22.1, -61.7 PSF ROOF-ZONE 2 = 22.1, -81.6 PSF ROOF-ZONE 3 = 22.1, -107.0 PSF WALL-ZONE 4 = 33.4. -36.3 PSF WALL-ZONE 5 = 33.4, -44.8 PSF

EFFECTIVE WIND AREA, Ae = 50 FT² ROOF-ZONE 1 = 17.5, -41.6 PSF ROOF-ZONE 2 = 17.5, -55.8 PSF ROOF-ZONE 3 = 17.5, -71.5 PSF WALL-ZONE 4 = 29.9, -32.8 PSF WALL-ZONE 5 = 29.9, -37.8 PSF

NOTE: C&C WIND PRESSURES SHOWN MAY BE REDUCED FOR LARGER AREAS AS ALLOWED BY CODE.


5. CONSTRUCTION TYPE: V-B

6. OCCUPANCY GROUP U


ITEMS BY OTHERS:

THE FOLLOWING ITEMS MAY BE SUPPLIED AND INSTALLED BY OTHERS. THESE ITEMS MAY BE SUBJECT TO LOCAL JURISDICTION APPROVAL. WEATHER KING PORTABLE BUILDINGS IS NOT RESPONSIBLE FOR THESE ITEMS.

- 1. THE FOUNDATION AND TIE-DOWN SYSTEM
- 2. RAMPS, STAIRS, AND GENERAL ACCESS
- 3. ELECTRICAL SERVICE HOOKUP

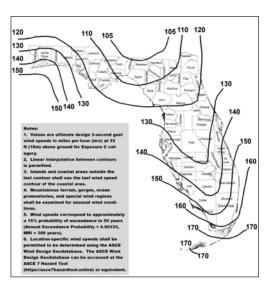

WEATHER KING P.O. BOX 108 PARIS, TN 38242

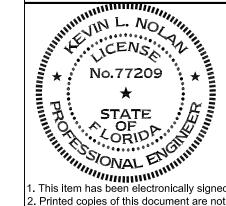

LOFTED BARN--FLORIDA--WIND=160 MPH--FBC 2023



PROJECT NO: 12-12-2023

DRAWN BY: KLN

KLN **REVISION:**

CHECKED BY:

DATE:

SHEET NUMBER


SCALE: NONE

This item has been electronically signed and sealed by Kevin L Nolan, PE on 01/03/2024 using a digital signature.

FASTENING SCHEDULE

DESCRIPTION OF BUILDING ELEMENT	NUMBER AND TYPE OF FASTENER	SPACING AND LOCATION	
ROOF FRAMING			
BLOCKING BETWEEN CEILING JOISTS OR RAFTERS TO TOP PLATE OR OTHER FRAMING.	3 - 8d COMMON (2½" x 0.131") 3 - 10d BOX (3" x 0.128") 3 - 3" x 0.131" NAILS 3 - 3" 14 GAGE STAPLES, ¾6" CROWN 4 - 8d BOX (2½" x 0.113")	EACH END, TOENAIL	
2. BLOCKING BETWEEN RAFTERS NOT AT THE WALL TOP PLATE, TO RAFTER.	2 - 8d COMMON (2½" x 0.131") 2 - 3" x 0.131" NAILS 2 - 3" 14 GAGE STAPLES	EACH END, TOENAIL	
	2 - 16d COMMON (3½" x 0.162") 3 - 3" x 0.131" NAILS 3 - 3" 14 GAGE STAPLES	END NAIL	
COLLAR TIE TO RAFTER	REFERENCE SHEETS S-2.4 AND S-2.5		
RAFTER OR ROOF TRUSS TO TOP PLATE	3 - 10d COMMON (3" x 0.148") 3 - 16d BOX (3½" x 0.135") 4 - 10d BOX (3" x 0.128") 4 - 3" x 0.131" NAILS 4 - 3" 14 GAGE STAPLES, ¾6" CROWN	TOENAIL	
CEILING JOISTS TO TOP PLATE	3 - 8d COMMON (2½" x 0.131") 3 - 10d BOX (3" x 0.128") 3 - 3" x 0.131" NAILS 3 - 3" 14 GAGE STAPLES, 7/16" CROWN 4 - 8d BOX (2½" x 0.113")	EACH JOIST. TOENAIL	
	WALL FRAMING		
	16d COMMON (3½" x 0.162")	24" O.C. FACE NAIL	
STUD TO STUD (NOT AT BRACED WALL PANELS)	10d BOX (3" x 0.128") 3" x 0.131" NAILS 3 - 3" 14 GAGE STAPLES	16" O.C. FACE NAIL	
	16d COMMON (3½" x 0.162")	16" O.C. FACE NAIL	
STUD TO STUD AND ABUTTING STUDS AT INTERSECTING	16d BOX (3½" x 0.135")	12" O.C. FACE NAIL	
WALL CORNERS (AT BRACED WALL PANELS)	3" x 0.131" NAILS 3 - 3" 14 GAGE STAPLES, 7/6" CROWN	12" O.C. FACE NAIL	
CONTINUOUS HEADER TO STUD	4 - 8d COMMON (2½" x 0.131") 4 - 10d BOX (3" x 0.128") 5 - 8d BOX (2½" x 0.113")	TOENAIL	
	16d COMMON (3½" x 0.162")	16" O.C. FACE NAIL	
TOP PLATE TO TOP PLATE	10d BOX (3" x 0.128") 3" x 0.131" NAILS 3" 14 GAGE STAPLES, 7/6" CROWN	12" O.C. FACE NAIL	

DESCRIPTION OF BUILDING ELEMENT	NUMBER AND TYPE OF FASTENER	SPACING AND LOCATION		
	WALL FRAMING (CONT.)			
TOP PLATE TO TOP PLATE, AT END JOINTS	8 - 16d COMMON (3½" x 0.162") 12 - 10d BOX (3" x 0.128") 12 - 3" x 0.131" NAILS 12 - 3" 14 GAGE STAPLES, ½6" CROWN	EACH SIDE OF END JOINT, FACE NAIL (MINIMUM 24" LAP SPLICE LENGTH EACH SIDE OF END JOINT)		
BOTTOM PLATE TO JOIST, RIM JOIST, BAND JOIST, OR BLOCKING (NOT AT BRACED WALL PANELS)	16d COMMON (3½" x 0.162")	16" O.C. FACE NAIL		
	16d BOX (3½" x 0.135") 3" x 0.131" NAILS 3" 14 GAGE STAPLES, ½6" CROWN	12" O.C. FACE NAIL		
BOTTOM PLATE TO JOIST, RIM JOIST, BAND JOIST, OR BLOCKING (AT BRACED WALL PANELS)	2 - 16d COMMON (3½" x 0.162") 3 - 16d BOX (3½" x 0.135") 4 - 3" x 0.131" NAILS 4 - 3" 14 GAGE STAPLES, ¾6" CROWN	16" O.C. FACE NAIL		
STUD TO TOP OR BOTTOM PLATE	4 - 8d COMMON (2½" x 0.131") 4 - 10d BOX (3" x 0.128") 4 - 3" x 0.131" NAILS 4 - 3" 14 GAGE STAPLES, ¾ ₆ " CROWN 4 - 8d BOX (2½" x 0.113")	TOENAIL		
	2 - 16d COMMON (3½" x 0.162") 3 - 10d BOX (3" x 0.128") 3 - 3" x 0.131" NAILS 3 - 3" 14 GAGE STAPLES, ¾6" CROWN	END NAIL		
TOP PLATES, LAPS AT CORNERS AND INTERSECTIONS	2 - 16d COMMON (3½" x 0.162") 3 - 10d BOX (3" x 0.128") 3 - 3" x 0.131" NAILS 3 - 3" 14 GAGE STAPLES, ¾6" CROWN	FACE NAIL		
	FLOOR FRAMING			
JOIST TO SKID	3 - 8d COMMON (2½" x 0.131") 3 - 10d BOX (3" x 0.128") 3 - 3" x 0.131" NAILS 3 - 3" 14 GAGE STAPLES, 7/16" CROWN 4 - 8d BOX (2½" x 0.113")	TOENAIL		
BUILT-UP BEAMS	10d BOX (3" x 0.128") 3" x 0.131" NAILS 3" 14 GAGE STAPLES, 7/6" CROWN	24" O.C. FACE NAIL AT TOP AND BOTTOM STAGGERED ON OPPOSITE SIDES		
	AND: 3 - 10d BOX (3" x 0.128") 3 - 3" x 0.131" NAILS 3 - 3" 14 GAGE STAPLES, %6" CROWN	ENDS AND AT EACH SPLICE, FACE NAIL		
JOIST TO BAND JOIST OR RIM JOIST	3 - 16d COMMON (3½" x 0.162") 4 - 10d BOX (3" x 0.128") 4 - 3" x 0.131" NAILS 4 - 3" 14 GAGE STAPLES, 7/16" CROWN	END NAIL		

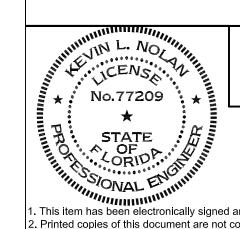

LOFTED BARN--FLORIDA--WIND=160 MPH--FBC 2023



PROJECT NO:

DATE: 12-12-2023

DRAWN BY: KLN

CHECKED BY: KLN

REVISION:

SHEET NUMBER

S-0.1

SCALE: NONE

- 1. This item has been electronically signed and sealed by Kevin L Nolan, PE on 01/03/2024 using a digital signature.
- 2. Printed copies of this document are not considered signed and sealed and the signature must be verified on any electronic copy.

FASTENING SCHEDULE (CONT.)

DESCRIPTION OF BUILDING ELEMENT	NUMBER AND TYPE OF FASTENER	SPA	ACING AND LOCATION
SUBFLOOR AND INTERIOR WALL SHEATHING ^a			
		EDGES (INCHES)	INTERMEDIATE SUPPORTS (INCHES)
	6d COMMON OR DEFORMED (2" x 0.113") (SUBFLOOR AND WALL)	6	12
¾" то ½"	2%" x 0.113" NAIL (SUBFLOOR AND WALL)	6	12
	1¾" 16 GAGE STAPLE, ½6" CROWN (SUBFLOOR AND WALL)	4	8
¹⁹ / ₃₂ " TO ³ / ₄ "	8d COMMON (2½" x 0.131") 6d DEFORMED (2" x 0.113") (SUBFLOOR AND WALL)	6	12
	EXTERIOR WALL SIDING		
WOOD SIDING TO WALL FRAMING	2%" x 0.113" RING SHANK NAIL	6 (SIDE WALL)	6
	2%" x 0.113" RING SHANK NAIL	3 (END WALL)	6

a. NAILS SPACED AT 6 INCHES AT INTERMEDIATE SUPPORTS WHERE SPANS ARE 48 INCHES OR MORE. NAILS FOR WALL SHEATHING ARE PERMITTED TO BE COMMON. BOX. OR CASING.

LOFTED BARN--FLORIDA--WIND=160 MPH--FBC 2023



PROJECT NO:	
DATE:	12-12-2023
DRAWN BY:	KLN
CHECKED BY:	KLN
REVISION:	


SHEET NUMBER

S-0.2


SCALE: NONE

- 1. This item has been electronically signed and sealed by Kevin L Nolan, PE on 01/03/2024 using a digital signature.
- 2. Printed copies of this document are not considered signed and sealed and the signature must be verified on any electronic copy.

b. WHERE A RAFTER IS FASTENED TO AN ADJACENT PARALLEL CEILING JOIST IN ACCORDANCE WITH THIS SCHEDULE AND THE CEILING JOIST IS FASTENED TO THE TOP PLATE IN ACCORDANCE WITH THIS SCHEDULE, THE NUMBER OF TOENAILS IN THE RAFTER SHALL BE PERMITTED TO BE REDUCED BY ONE NAIL.

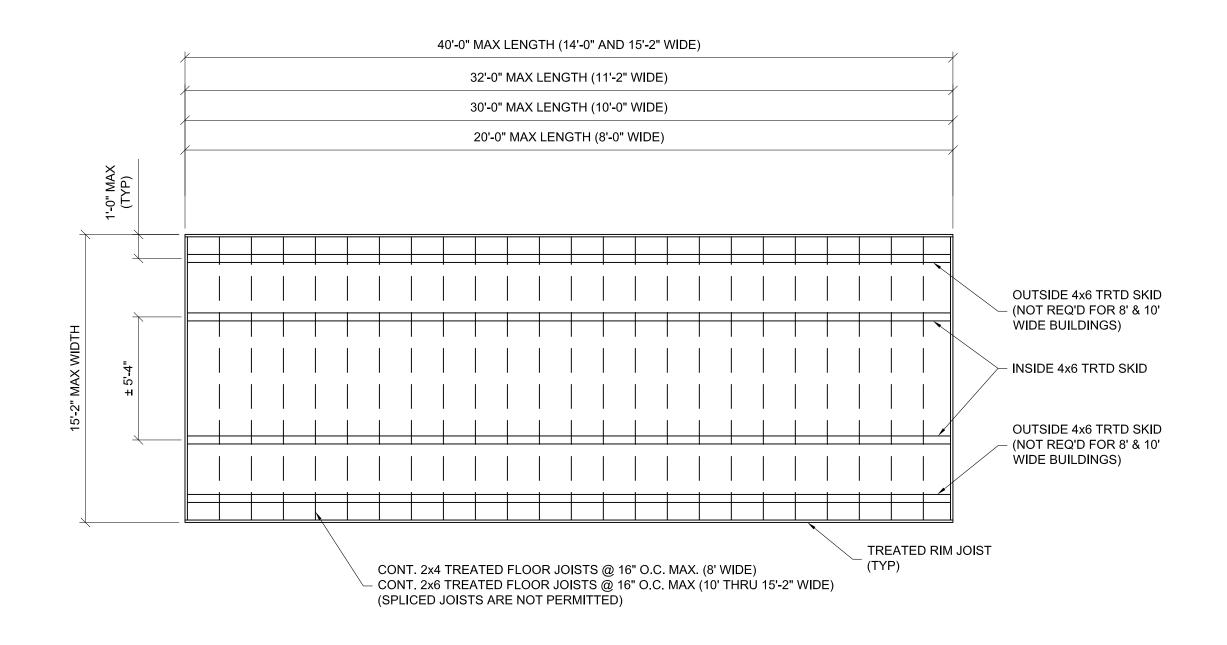

TYPICAL FLOOR FRAMING PLAN

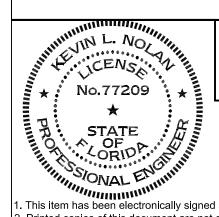

LOFTED BARN--FLORIDA--WIND=160 MPH--FBC 2023

Weather King®

PROJECT NO:

DATE: 12-12-2023

DRAWN BY: KLN

CHECKED BY: KLN


REVISION:

S-10


SHEET NUMBER

SCALE: NOT TO SCALE

1. This item has been electronically signed and sealed by Kevin L Nolan, PE on 01/03/2024 using a digital signature.

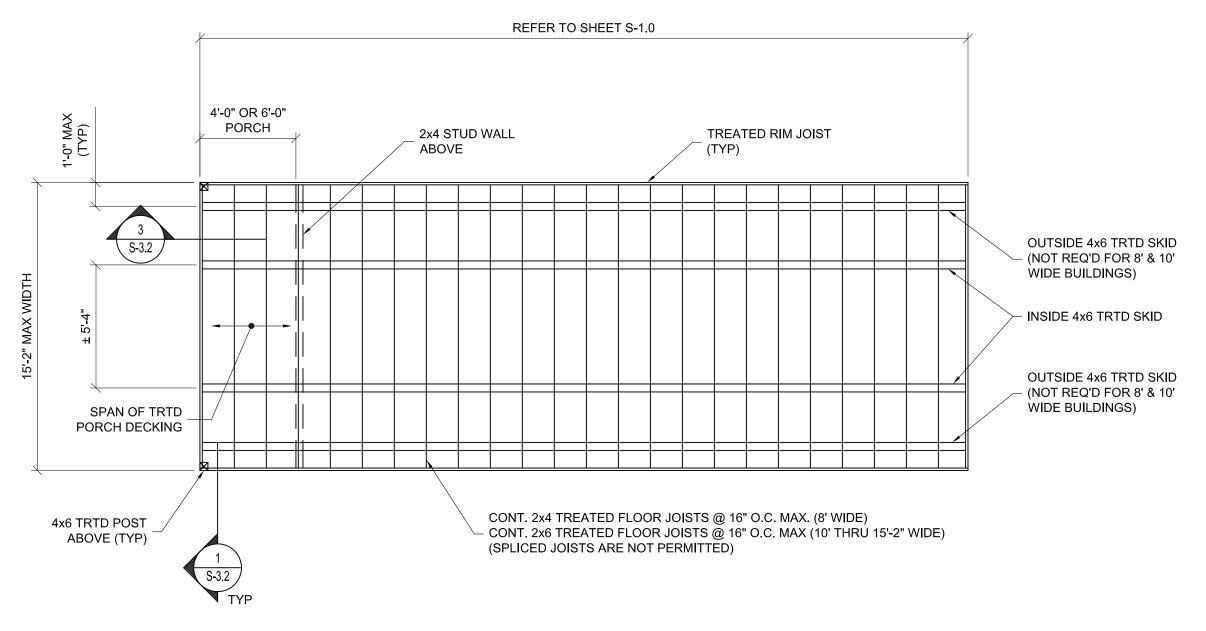

LOFTED BARN CABIN FLOOR FRAMING PLAN

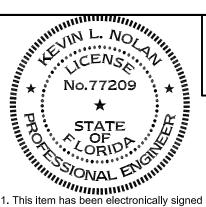

LOFTED BARN--FLORIDA--WIND=160 MPH--FBC 2023



PROJECT NO:

DATE: 12-12-2023

DRAWN BY: KLN

CHECKED BY: KLN


REVISION:

SHEET NUMBER


5-11

SCALE: NOT TO SCALE

1. This item has been electronically signed and sealed by Kevin L Nolan, PE on 01/03/2024 using a digital signature.

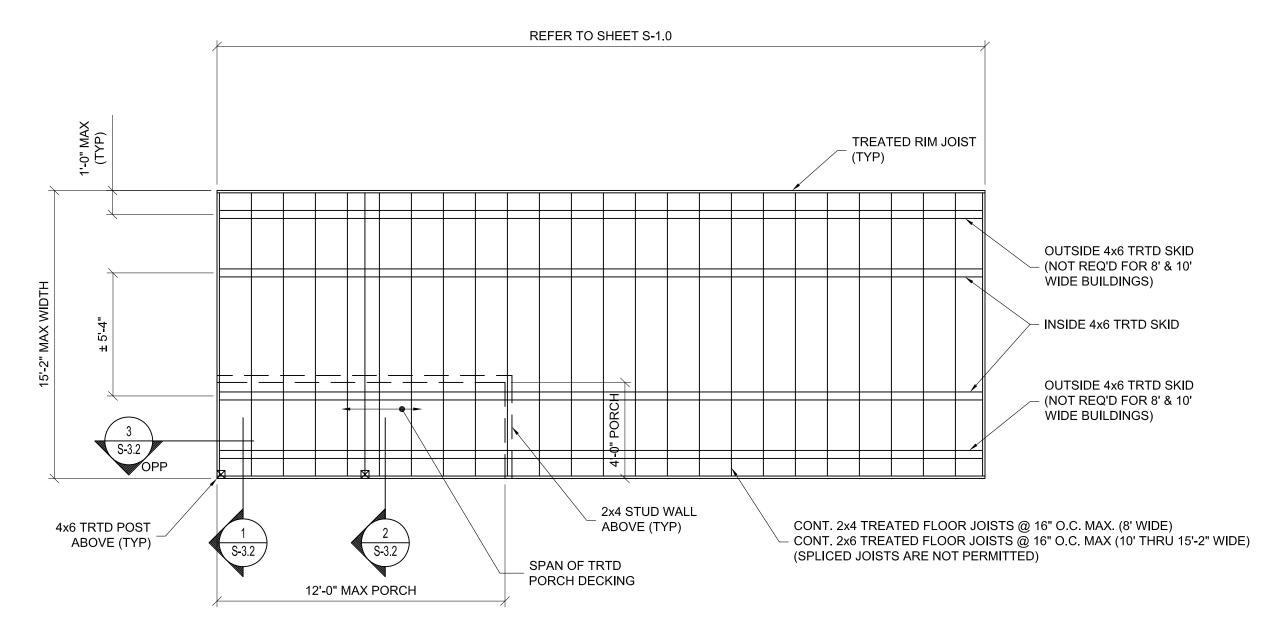

SIDE LOFTED BARN CABIN FLOOR FRAMING PLAN

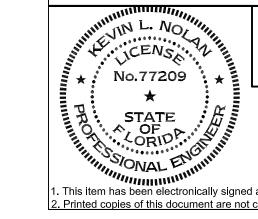

LOFTED BARN--FLORIDA--WIND=160 MPH--FBC 2023

Weather King®

PROJECT NO:

DATE: 12-12-2023

DRAWN BY: KLN

CHECKED BY: KLN


REVISION:


SHEET NUMBER

S-1.2

SCALE: NOT TO SCALE


- 1. This item has been electronically signed and sealed by Kevin L Nolan, PE on 01/03/2024 using a digital signature.
- 2. Printed copies of this document are not considered signed and sealed and the signature must be verified on any electronic copy.

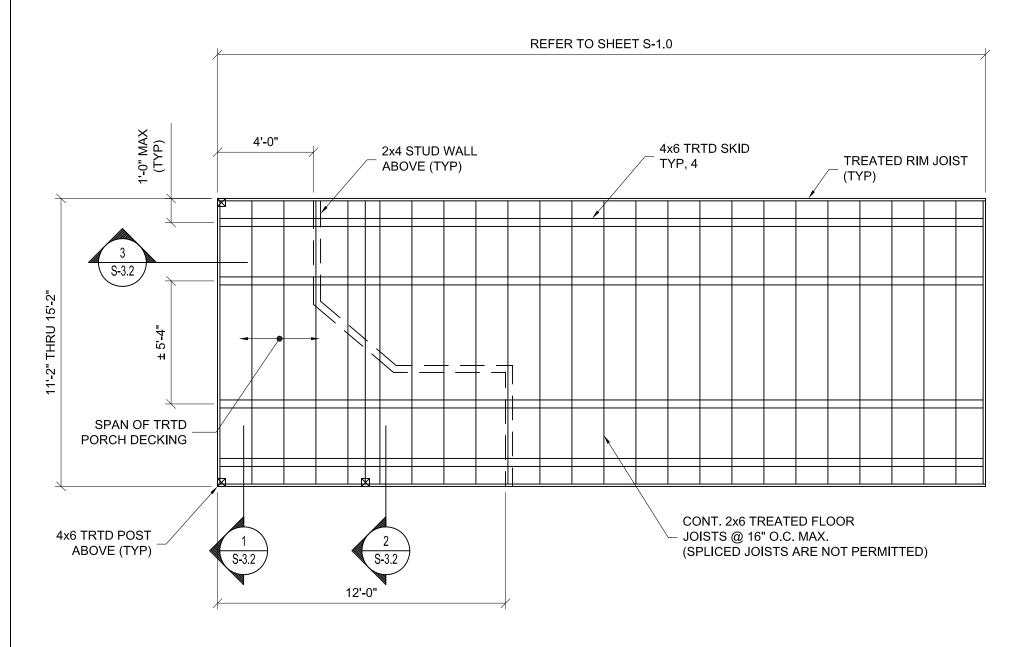

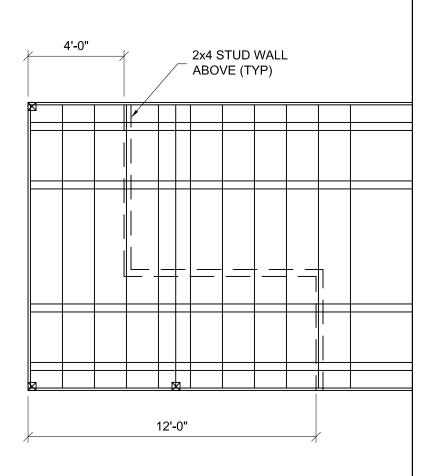

ALTERNATE DELUXE LOFTED BARN CABIN FRONT WALL LAYOUT

DELUXE LOFTED BARN CABIN FLOOR FRAMING PLAN

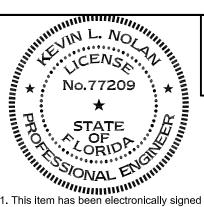

LOFTED BARN--FLORIDA--WIND=160 MPH--FBC 2023



PROJECT NO:

DATE: 12-12-2023

DRAWN BY: KLN

CHECKED BY: KLN


REVISION:

SHEET NUMBER


S-13

SCALE: NOT TO SCALE

1. This item has been electronically signed and sealed by Kevin L Nolan, PE on 01/03/2024 using a digital signature.

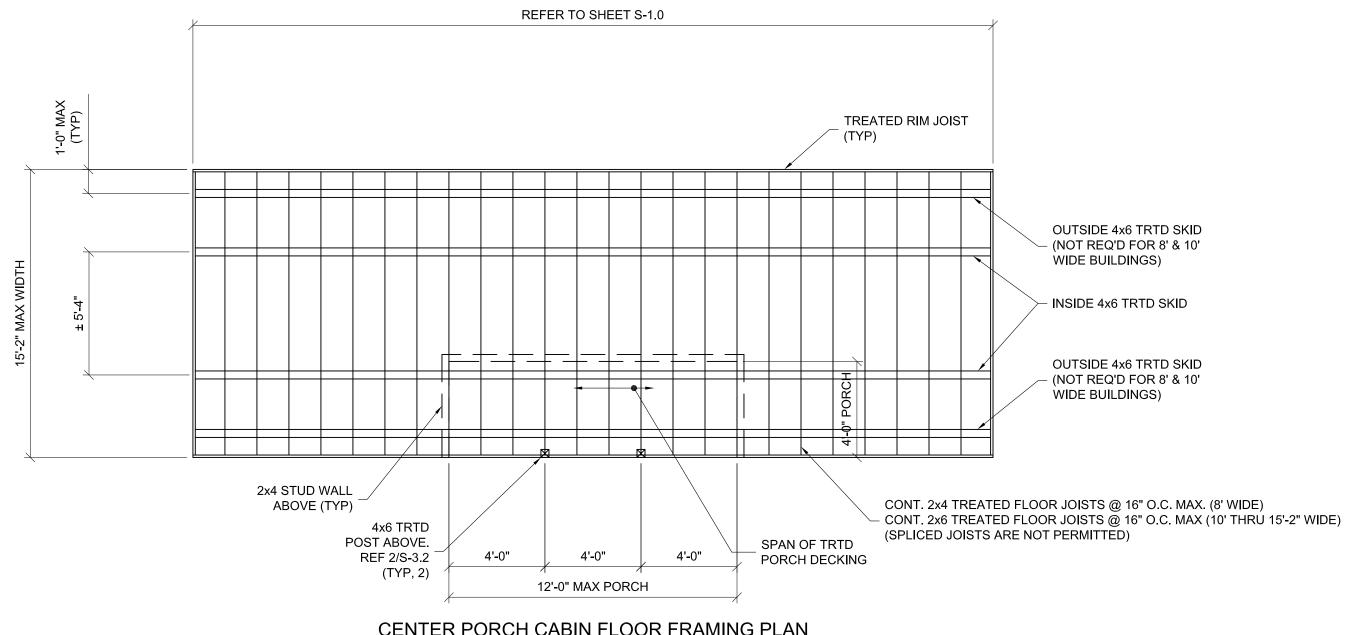



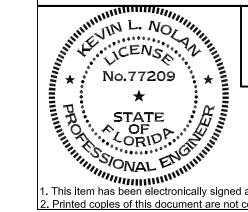

LOFTED BARN--FLORIDA--WIND=160 MPH--FBC 2023


Weather King® PORTABLE BUILDINGS

PROJECT NO: DATE: 12-12-2023 DRAWN BY: KLN CHECKED BY: KLN **REVISION:**


SHEET NUMBER

SCALE: NOT TO SCALE

. This item has been electronically signed and sealed by Kevin L Nolan, PE on 01/03/2024 using a digital signature.

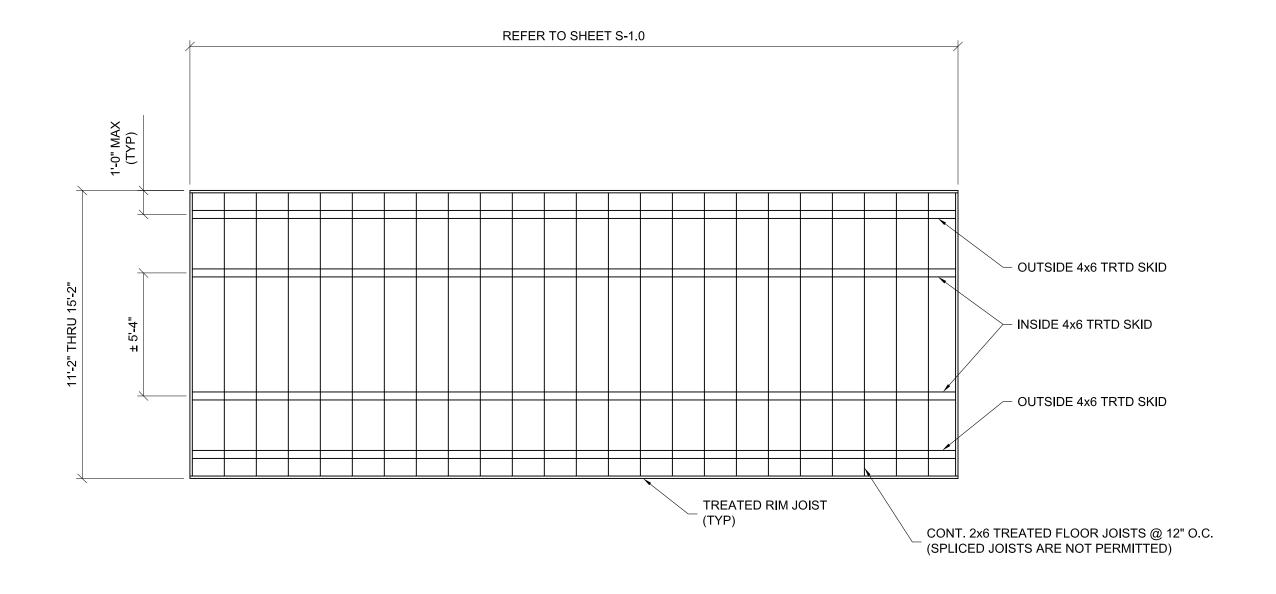

LOFTED BARN w/ ROLL-UP DOOR FLOOR FRAMING PLAN

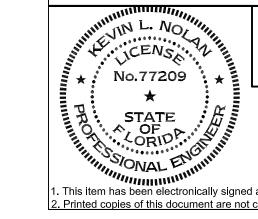

LOFTED BARN--FLORIDA--WIND=160 MPH--FBC 2023

Weather King®

PROJECT NO:

DATE: 12-12-2023

DRAWN BY: KLN

CHECKED BY: KLN


REVISION:

SHEET NUMBER

S-1.5

SCALE: NOT TO SCALE

1. This item has been electronically signed and sealed by Kevin L Nolan, PE on 01/03/2024 using a digital signature.

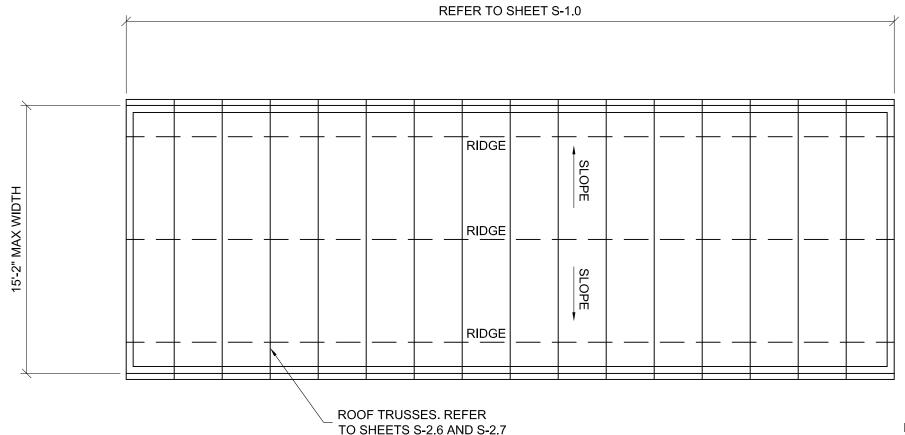


FASTEN ROOF SHEATHING TO FRAMING AT 4 INCHES O.C. AT EDGES AND IN THE FIELD WITHIN THE END STRIP AT EACH ENDWALL. REFER TO FASTENING SCHEDULE

FOR ADDITIONAL INFORMATION.

METAL ROOF PANELS WITHIN EACH END STRIP SHALL BE ATTACHED TO THE ROOF SHEATHING PER DETAIL 4/S-3.3 WITH A MAXIMUM SCREW SPACING OF 10" O.C. ALONG THE PANEL LENGTH FASTEN ROOF SHEATHING TO FRAMING AT 6 INCHES O.C. AT EDGES AND IN THE FIELD, UNO. REFER TO FASTENING SCHEDULE FOR ADDITIONAL INFORMATION.


METAL ROOF PANELS SHALL BE ATTACHED TO THE ROOF SHEATHING PER DETAIL 4/S-3.3 WITH A MAXIMUM SCREW SPACING OF 16" O.C. ALONG THE PANEL LENGTH

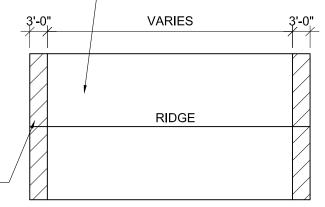

ROOF SHEATHING DIAGRAM

ROOF FRAMING PLAN

LOFTED BARN--FLORIDA--WIND=160 MPH--FBC 2023

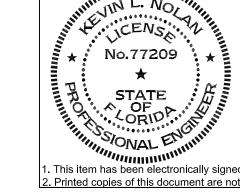

Weather King®

PROJECT NO:

DATE: 12-12-2023

DRAWN BY: KLN

CHECKED BY: KLN


REVISION:


SHEET NUMBER

S-16

SCALE: NOT TO SCALE

1. This item has been electronically signed and sealed by Kevin L Nolan, PE on 01/03/2024 using a digital signature.

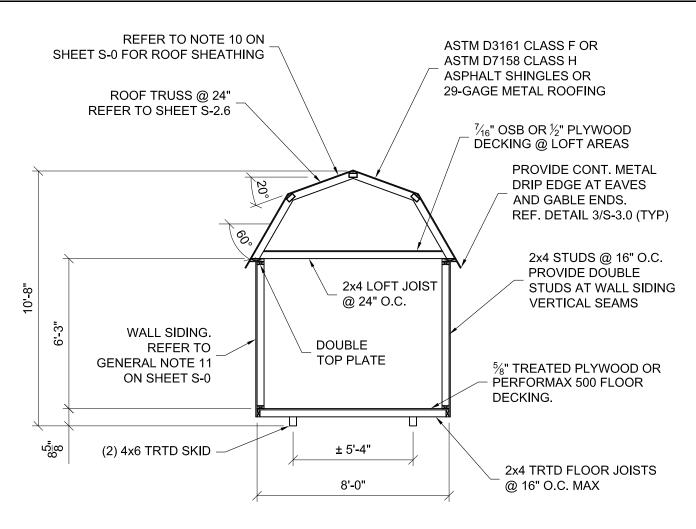

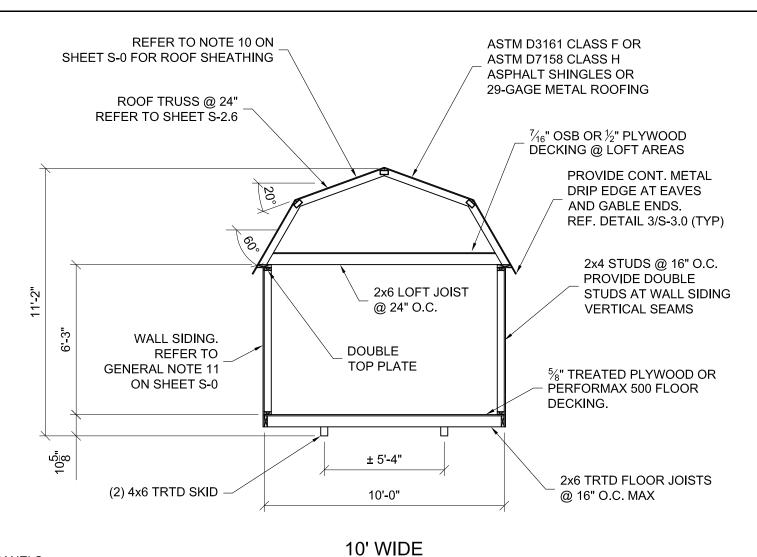

8' WIDE

NOTES FOR METAL WALL/ROOF PANELS:

1) METAL WALL PANELS WITH THE RIBS RUNNING HORIZONTALLY SHALL BE ATTACHED TO WALL SHEATHING PER DETAIL 4 ON SHEET S-3.3 AND DETAIL 1 ON SHEET S-3.4.

- 2) METAL WALL PANELS WITH THE RIBS RUNNING VERTICALLY SHALL BE ATTACHED TO 2x4 GIRTS IN ACCORDANCE WITH DETAILS 2 AND 3 ON SHEET S-3.3.
- 3) METAL PANELS ATTACHED DIRECTLY TO WOOD FRAMING SHALL BE ATTACHED IN ACCORDANCE WITH DETAIL 3 ON SHEET S-3.3
- 4) METAL PANELS ATTACHED TO DECKING SHALL BE ATTACHED IN ACCORDANCE WITH DETAIL 4 ON SHEET S-3.3

BUILDING SECTIONS

NOTE: REFER TO FASTENING SCHEDULE ON SHEETS S-0.1 & S-0.2 FOR MEMBER ATTACHMENTS UNLESS NOTED OTHERWISE.

LOFTED BARN--FLORIDA--WIND=160 MPH--FBC 2023




PROJECT NO: DATE: 12-12-2023 DRAWN BY: KLN CHECKED BY: KLN **REVISION:**

SHEET NUMBER

SCALE: 1/4" = 1'-0"

STA. OF OF OF ORIDA. CORIDA. C . This item has been electronically signed and sealed by Kevin L Nolan, PE on 01/03/2024 using a digital signature.

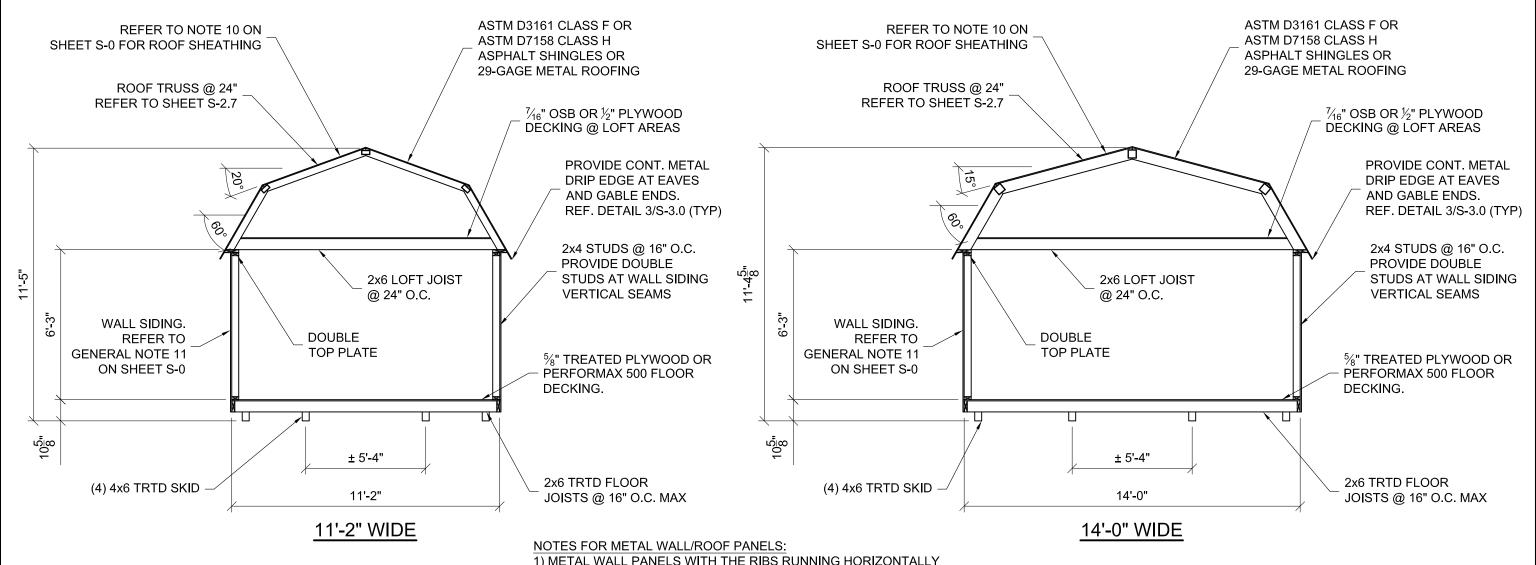

- 1) METAL WALL PANELS WITH THE RIBS RUNNING HORIZONTALLY SHALL BE ATTACHED TO WALL SHEATHING PER DETAIL 4 ON SHEET S-3.3 AND DETAIL 1 ON SHEET S-3.4.
- 2) METAL WALL PANELS WITH THE RIBS RUNNING VERTICALLY SHALL BE ATTACHED TO 2x4 GIRTS IN ACCORDANCE WITH DETAILS 2 AND 3 ON SHEET S-3.3.
- 3) METAL PANELS ATTACHED DIRECTLY TO WOOD FRAMING SHALL BE ATTACHED IN ACCORDANCE WITH DETAIL 3 ON SHEET S-3.3
- 4) METAL PANELS ATTACHED TO DECKING SHALL BE ATTACHED IN ACCORDANCE WITH DETAIL 4 ON SHEET S-3.3

BUILDING SECTIONS

No.77209 ** STATE OF ORIDA Alectronically signed are no

LOFTED BARN--FLORIDA--WIND=160 MPH--FBC 2023



PROJECT NO:

DATE: 12-12-2023

DRAWN BY: KLN

CHECKED BY: KLN

REVISION:

S-21


SHEET NUMBER

SCALE: 1/4" = 1'-0"

1. This item has been electronically signed and sealed by Kevin L Nolan, PE on 01/03/2024 using a digital signature.

NOTE: REFER TO FASTENING SCHEDULE ON SHEETS S-0.1 & S-0.2


FOR MEMBER ATTACHMENTS UNLESS NOTED OTHERWISE.

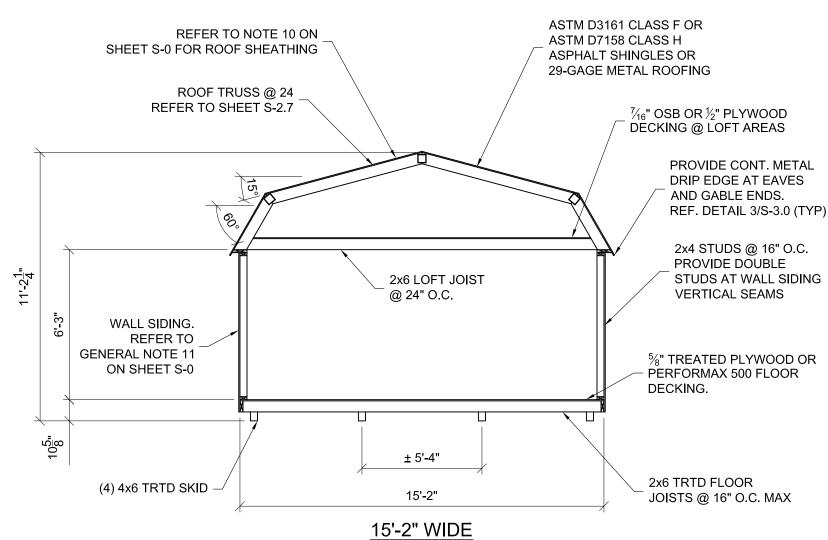

NOTES FOR METAL WALL/ROOF PANELS:

- 1) METAL WALL PANELS WITH THE RIBS RUNNING HORIZONTALLY SHALL BE ATTACHED TO WALL SHEATHING PER DETAIL 4 ON SHEET S-3.3 AND DETAIL 1 ON SHEET S-3.4.
- 2) METAL WALL PANELS WITH THE RIBS RUNNING VERTICALLY SHALL BE ATTACHED TO 2x4 GIRTS IN ACCORDANCE WITH DETAILS 2 AND 3 ON SHEET S-3.3.
- 3) METAL PANELS ATTACHED DIRECTLY TO WOOD FRAMING SHALL BE ATTACHED IN ACCORDANCE WITH DETAIL 3 ON SHEET S-3.3
- 4) METAL PANELS ATTACHED TO DECKING SHALL BE ATTACHED IN ACCORDANCE WITH DETAIL 4 ON SHEET S-3.3

BUILDING SECTION

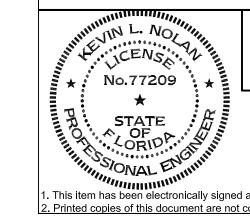

LOFTED BARN--FLORIDA--WIND=160 MPH--FBC 2023



PROJECT NO:	
DATE:	12-12-2023
DRAWN BY:	KLN
CHECKED BY:	KLN
REVISION:	

S-22


SHEET NUMBER

SCALE: NOT TO SCALE


1. This item has been electronically signed and sealed by Kevin L Nolan, PE on 01/03/2024 using a digital signature.

NOTE: REFER TO FASTENING SCHEDULE ON SHEETS S-0.1 & S-0.2


FOR MEMBER ATTACHMENTS UNLESS NOTED OTHERWISE.

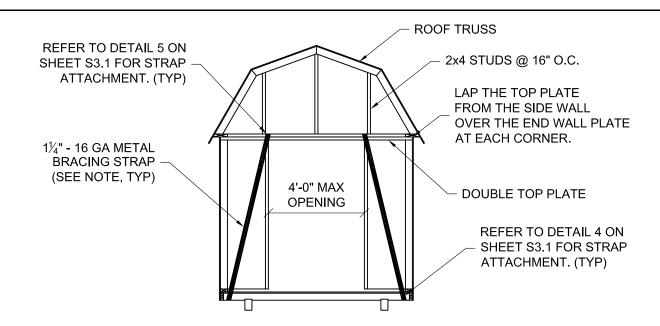

8' WIDE FRONT ENDWALL

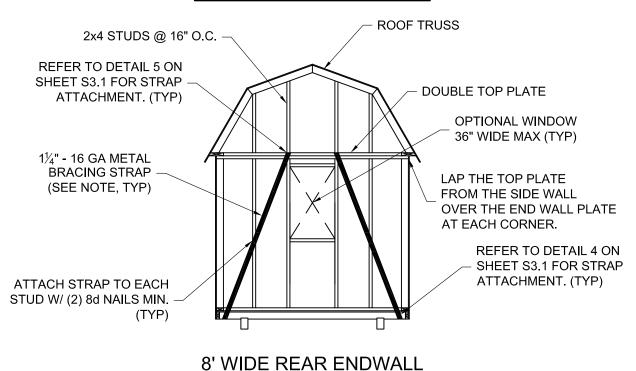


ROOF TRUSS REFER TO DETAIL 5 ON 2x4 STUDS @ 16" O.C. SHEET S3.1 FOR STRAP ATTACHMENT. (TYP) DOUBLE TOP PLATE $1\frac{1}{4}$ " - 16 GA METAL LAP THE TOP PLATE **BRACING STRAP** FROM THE SIDE WALL (SEE NOTE, TYP) OVER THE END WALL PLATE AT EACH CORNER. 6'-0" MAX OPENING REFER TO DETAIL 4 ON SHEET S3.1 FOR STRAP ATTACHMENT. (TYP) ATTACH STRAP TO EACH STUD W/ (2) 8d NAILS MIN. (TYP) ADDITIONAL 11/4" - 16 GA STRAP FOR BUILDINGS 10'-0" WIDE FRONT ENDWALL 22'-0" TO 30'-0" LONG (SEE NOTE, TYP)

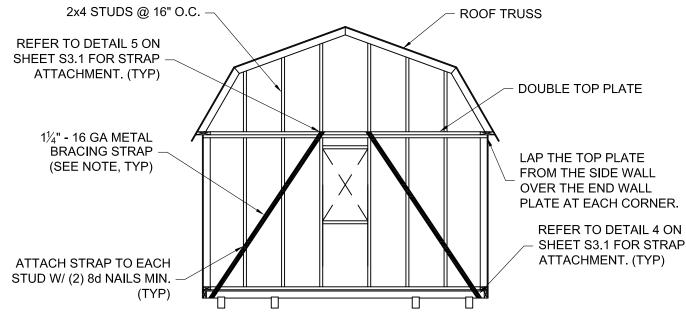

10'-0" WIDE REAR ENDWALL

NOTE: METAL STRAP BRACING IS NOT REQUIRED FOR WALLS SHEATHED WITH WOOD SIDING, PLYWOOD,OR OSB

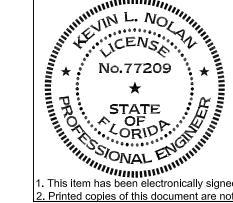

LOFTED BARN--FLORIDA--WIND=160 MPH--FBC 2023




PROJECT NO:	
DATE:	12-12-2023
DRAWN BY:	KLN
CHECKED BY:	KLN
REVISION:	

SHEET NUMBER


S-2.3

SCALE: NOT TO SCALE


- 1. This item has been electronically signed and sealed by Kevin L Nolan, PE on 01/03/2024 using a digital signature.
- . Printed copies of this document are not considered signed and sealed and the signature must be verified on any electronic copy.

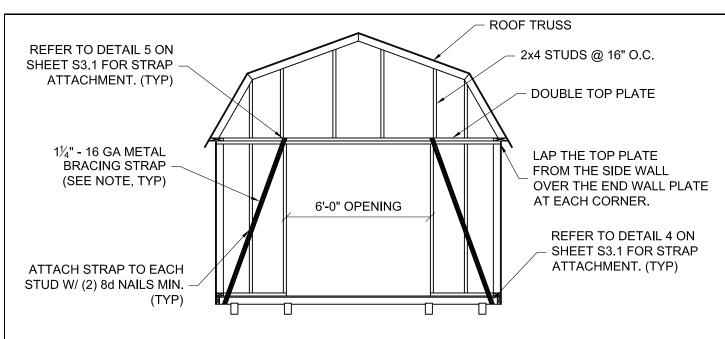

11'-2" WIDE FRONT ENDWALL

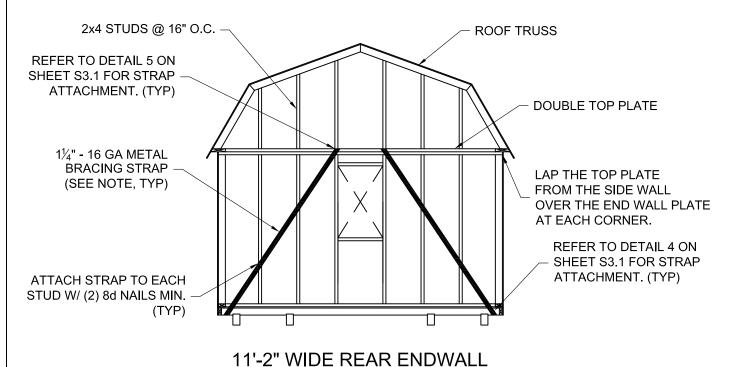

ATTACH EACH JAMB STUD TO ROOF TRUSS w/ (3) 3" x 0.131" RING SHANK NAILS

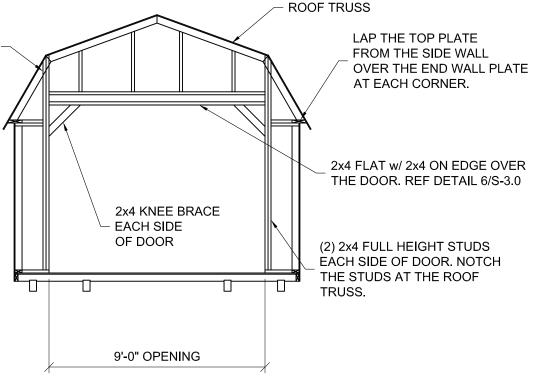


11'-2" WIDE FRONT ENDWALL W/ ROLL-UP DOOR (OPTIONAL)

NOTES FOR ROLL-UP DOOR OPTION:

- 1. FOR BUILDINGS SHEATHED WITH T1-11 OR LP SIDING, PROVIDE FULL HEIGHT $\frac{7}{16}$ " OSB OR PLYWOOD WALL SHEATHING ON THE INTERIOR FACE OF THE WALL. ATTACH THE SHEATHING TO THE WALL FRAMING WITH $2\frac{3}{8}$ " x 0.113" RING SHANK NAILS SPACED AT 3" MAX.
- 2. FOR BUILDINGS SHEATHED WITH METAL SIDING, PROVIDE $\frac{7}{16}$ " OSB OR PLYWOOD WALL SHEATHING ON THE INTERIOR FACE PLUS THE EXTERIOR FACE OF THE WALL. THE EXTERIOR METAL SIDING SHALL BE ATTACHED TO SHEATHING PER DETAIL 1 ON SHEET S-3.3. ATTACH THE SHEATHING TO THE WALL FRAMING WITH $2\frac{3}{8}$ " x 0.113" RING SHANK NAILS SPACED AT 3" MAX.

NOTE: METAL STRAP BRACING IS NOT REQUIRED FOR WALLS SHEATHED WITH WOOD SIDING, PLYWOOD,OR OSB

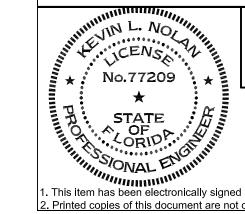

LOFTED BARN--FLORIDA--WIND=160 MPH--FBC 2023



PROJECT NO:

DATE: 12-12-2023

DRAWN BY: KLN

CHECKED BY: KLN


REVISION:

SHEET NUMBER


S-2.4

SCALE: 1/4" = 1'-0"

- 1. This item has been electronically signed and sealed by Kevin L Nolan, PE on 01/03/2024 using a digital signature.
- 2. Printed copies of this document are not considered signed and sealed and the signature must be verified on any electronic copy.

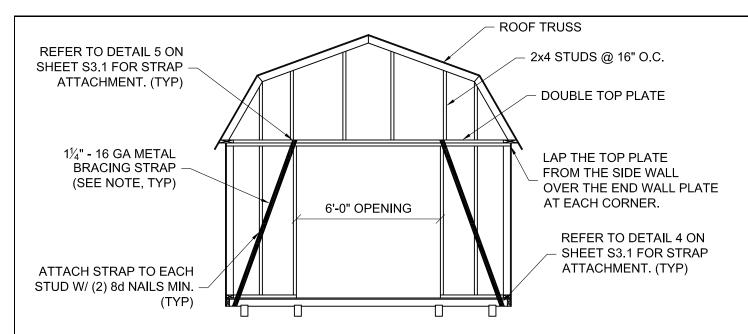

14'-0" & 15'-2" WIDE FRONT ENDWALL

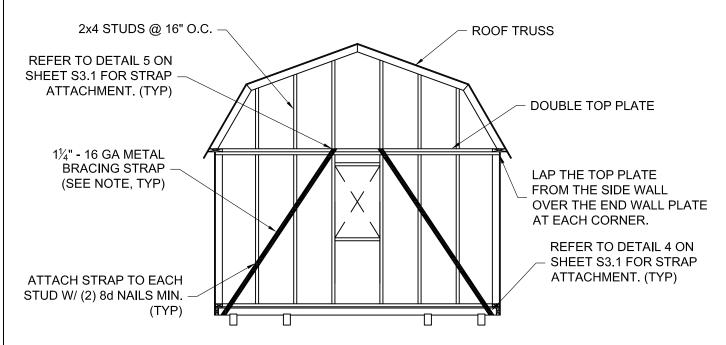

14'-0" & 15'-2" WIDE REAR ENDWALL

14'-0" & 15'-2" WIDE ENDWALL W/ ROLL-UP DOOR (OPTIONAL)


2x4 KNEE BRACE

9'-0" OPENING

EACH SIDE

OF DOOR

NOTE: METAL STRAP BRACING IS NOT REQUIRED FOR WALLS SHEATHED WITH WOOD SIDING, PLYWOOD, OR OSB

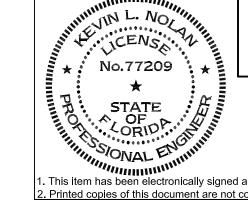

LOFTED BARN--FLORIDA--WIND=160 MPH--FBC 2023

ROOF TRUSS

REFER TO DETAIL 5 ON

SHEET S3.1 FOR STRAP

REFER TO DETAIL 4 ON

SHEET S3.1 FOR STRAP

ATTACHMENT. (TYP)

ATTACHMENT. (TYP)

 $1\frac{1}{4}$ " - 16 GA METAL

BRACING STRAP

(SEE NOTE, TYP)



PROJECT NO: SHEET NUMBER DATE: 12-12-2023 DRAWN BY: KLN CHECKED BY: KLN **REVISION:**

2x4 FLAT w/ 2x4 ON EDGE OVER

THE DOOR, REF DETAIL 6/S-3.0

LAP THE TOP PLATE FROM THE SIDE WALL OVER THE END WALL PLATE AT EACH CORNER.

(2) 2x4 STUDS EACH

ADDITIONAL 11/4" - 16 GA STRAP FOR BUILDINGS

26'-0" TO 40'-0" LONG (SEE NOTE, TYP)

SIDE OF DOOR

SCALE: 1/4" = 1'-0"


. This item has been electronically signed and sealed by Kevin L Nolan, PE on 01/03/2024 using a digital signature.

GENERAL NOTES:

- 1. REFER TO SHEET S-0 FOR DESIGN LOADS.
- 2. MAXIMUM TRUSS SPACING = 24" O.C. UNLESS NOTED OTHERWISE.
- 3. TRUSS TOP CHORD SHALL BE BRACED W/ STRUCTURAL WOOD SHEATHING ATTACHED DIRECTLY TO TRUSS MEMBERS.
- 4. ALL TRUSS MEMBERS ARE TO BE SPF #2 OR BETTER.
- 5. TRUSS PLATES ARE TO BE A MINIMUM OF 20 GAGE (MT20) PRESSED IN PLACE EACH SIDE OF TRUSS. AT ALL 2x4 TRUSS MEMBER JOINTS, PROVIDE A 2x4 TRUSS PLATE EACH SIDE OF TRUSS. AT ALL 2x6 TRUSS MEMBER JOINTS, PROVIDE A 4x4 TRUSS PLATES EACH SIDE OF TRUSS.
- 6. REACTIONS DUE TO WIND ARE BASED ON MWFRS END ZONE PRESSURES. INDIVIDUAL MEMBERS DESIGNED FOR COMPONENTS AND CLADDING WIND PRESSURE.
- 7. DEFLECTION MEETS L/240 LIVE LOAD AND L/180 TOTAL LOAD.
- 8. LOAD DURATION ADJUSTMENT FACTORS:


ROOF LIVE: 1.25 WIND: 1.60

- 9. REPETITIVE MEMBER INCREASE: 1.15
- 10. HORIZONTAL THRUST IS TO BE RESISTED BY LOFT JOISTS. REFER TO SHEETS S-2.0 THRU S-2.2, AND S-3.0 FOR LOFT JOIST SIZE AND ATTACHMENT INFORMATION.

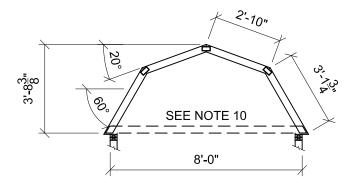


ALL TRUSS MEMBERS TO BE 2x4 SPF #2
NET UPLIFT: -191 LBS D+Lr: 188 LBS

8' WIDE LOFTED BARN TRUSS

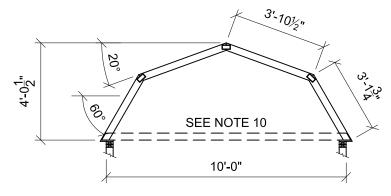

ALL TRUSS MEMBERS TO BE 2x4 SPF #2
NET UPLIFT: -247 LBS D+Lr: 237 LBS


10' WIDE LOFTED BARN TRUSS

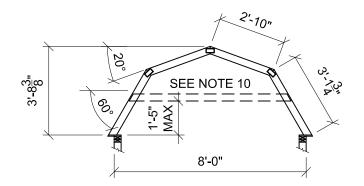

ALL TRUSS MEMBERS TO BE 2x4 SPF #2

NET UPLIFT: -191 LBS D+Lr: 188 LBS


8' WIDE LOFTED BARN TRUSS (OPTIONAL)

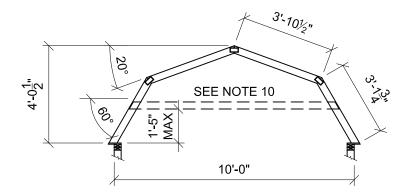

ALL TRUSS MEMBERS TO BE 2x4 SPF #2

NET UPLIFT: -247 LBS D+Lr: 237 LBS

10' WIDE LOFTED BARN TRUSS (OPTIONAL)

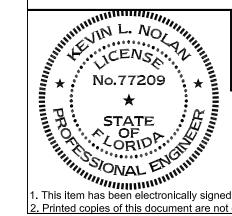

LOFTED BARN--FLORIDA--WIND=160 MPH--FBC 2023

Weather King®

PROJECT NO:

DATE: 12-12-2023

DRAWN BY: KLN

CHECKED BY: KLN


REVISION:

S-26

SHEET NUMBER


SCALE: 1/4" = 1'-0"

1. This item has been electronically signed and sealed by Kevin L Nolan, PE on 01/03/2024 using a digital signature.

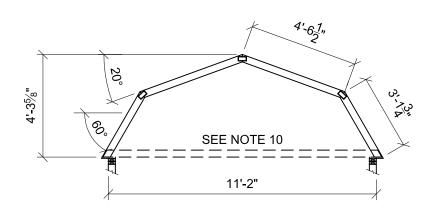


ALL TRUSS MEMBERS TO BE 2x4 SPF #2
NET UPLIFT: -282 LBS D+Lr: 269 LBS

11'-2" WIDE LOFTED BARN TRUSS

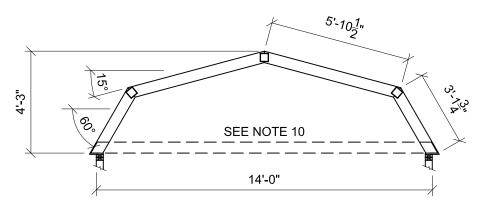


ALL TRUSS MEMBERS TO BE 2x6 SPF #2
NET UPLIFT: -359 LBS D+Lr: 330 LBS

14' WIDE LOFTED BARN TRUSS

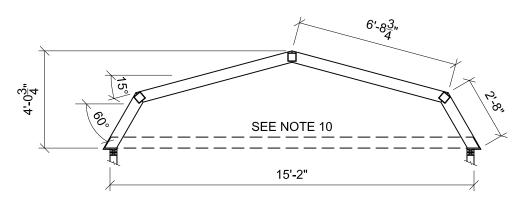

ALL TRUSS MEMBERS TO BE 2x6 SPF #2
NET UPLIFT: -397 LBS D+Lr: 361 LBS


15'-2" WIDE LOFTED BARN TRUSS

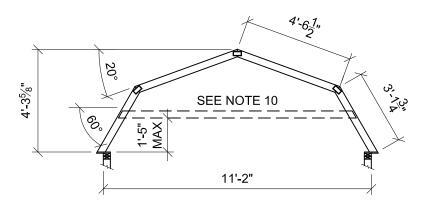

ALL TRUSS MEMBERS TO BE 2x4 SPF #2


NET UPLIFT: -282 LBS D+Lr: 269 LBS

11'-2" WIDE LOFTED BARN TRUSS (OPTIONAL)

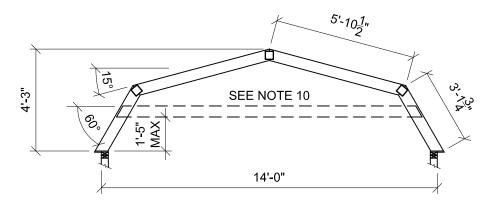

ALL TRUSS MEMBERS TO BE 2x6 SPF #2
NET UPLIFT: -359 LBS D+Lr: 330 LBS

14' WIDE LOFTED BARN TRUSS (OPTIONAL)

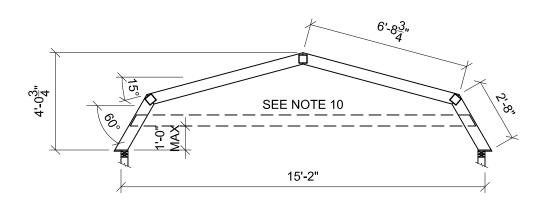

ALL TRUSS MEMBERS TO BE 2x6 SPF #2
NET UPLIFT: -397 LBS D+Lr: 361 LBS

15'-2" WIDE LOFTED BARN TRUSS (OPTIONAL)



LOFTED BARN--FLORIDA--WIND=160 MPH--FBC 2023



PROJECT NO:

DATE: 12-12-2023

DRAWN BY: KLN

CHECKED BY: KLN

REVISION:


SHEET NUMBER


S-2.7

SCALE: 1/4" = 1'-0"

1. This item has been electronically signed and sealed by Kevin L Nolan, PE on 01/03/2024 using a digital signature.

2. Printed copies of this document are not considered signed and sealed and the signature must be verified on any electronic copy.

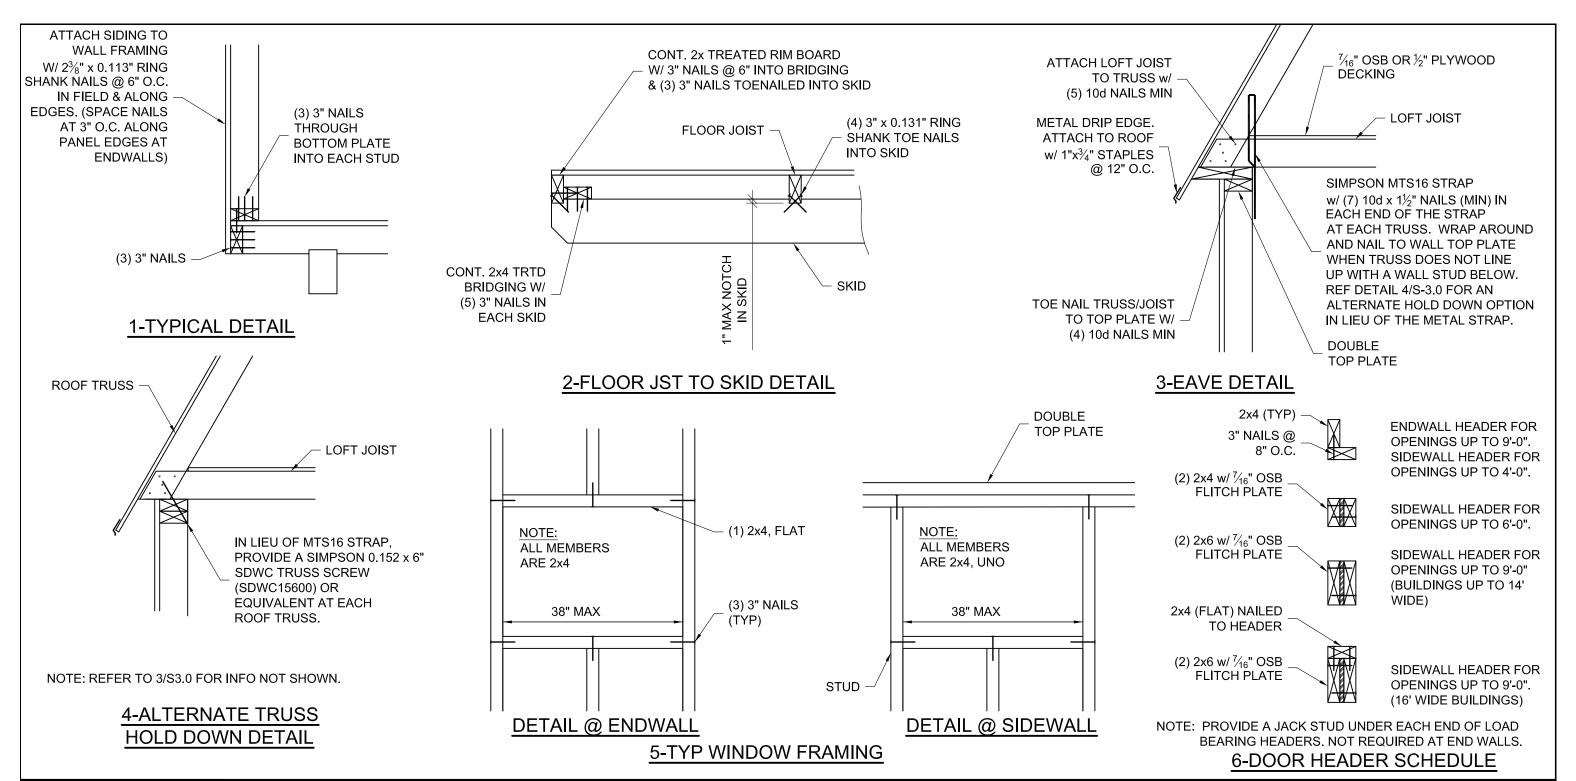

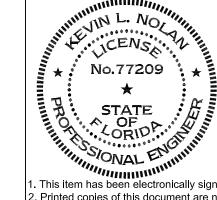

LOFTED BARN--FLORIDA--WIND=160 MPH--FBC 2023

NOTE: REFER TO FASTENING SCHEDULE ON SHEETS S-0.1 AND S-0.2 FOR ATTACHMENT INFORMATION NOT NOTED ON THIS SHEET.



PROJECT NO:

DATE: 12-12-2023

DRAWN BY: KLN

CHECKED BY: KLN


REVISION:

SHEET NUMBER

S-3.0

SCALE: 1"=1'-0

1. This item has been electronically signed and sealed by Kevin L Nolan, PE on 01/03/2024 using a digital signature.

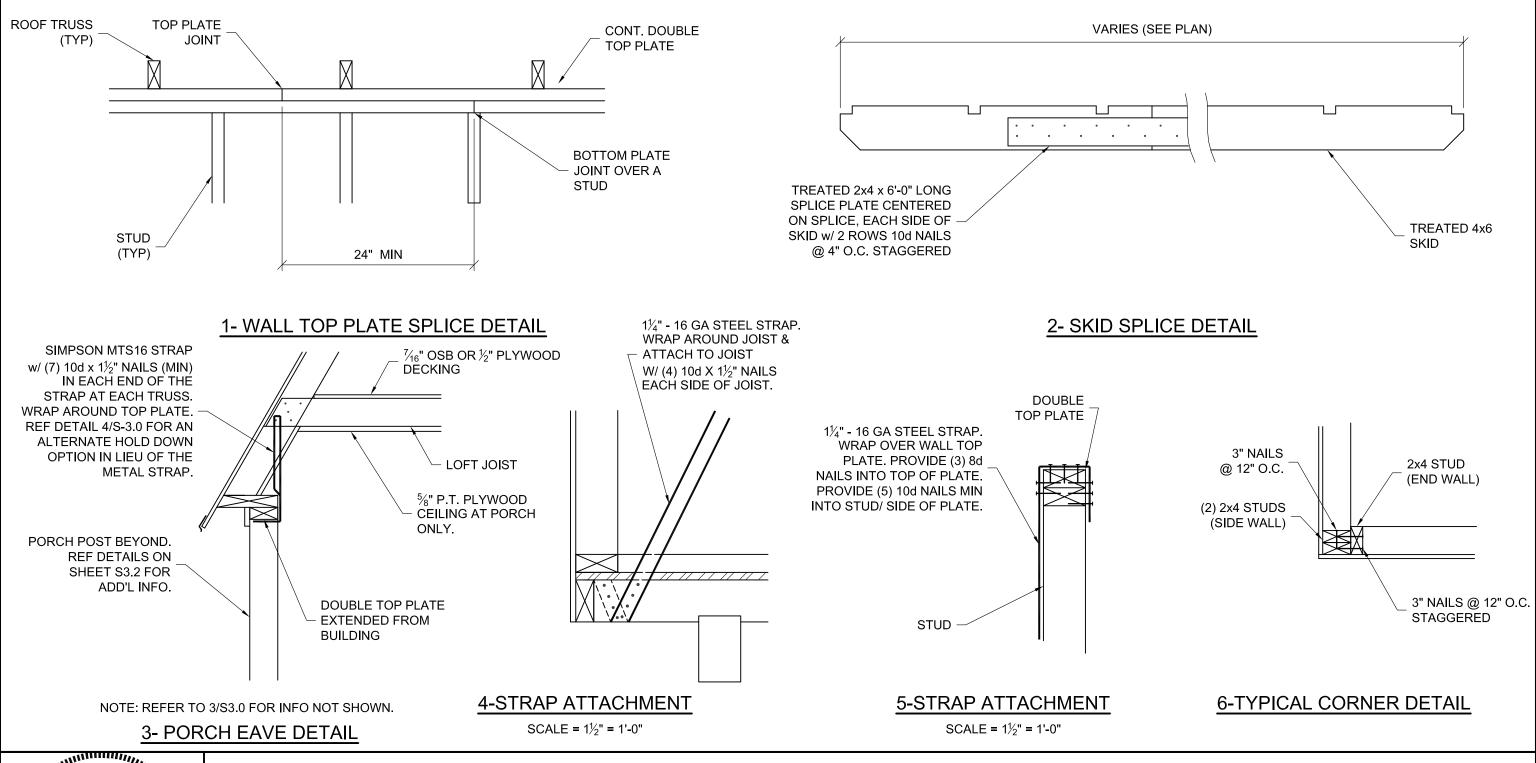



LOFTED BARN--FLORIDA--WIND=160 MPH--FBC 2023

NOTE: REFER TO FASTENING SCHEDULE ON SHEETS S-0.1 AND S-0.2 FOR ATTACHMENT INFORMATION NOT NOTED ON THIS SHEET.




PROJECT NO:		9
DATE:	12-12-2023	
DRAWN BY:	KLN	
CHECKED BY:	KLN	
REVISION:		

SHEET NUMBER

S-3.1

SCALE: 1"=1'-0


1. This item has been electronically signed and sealed by Kevin L Nolan, PE on 01/03/2024 using a digital signature.

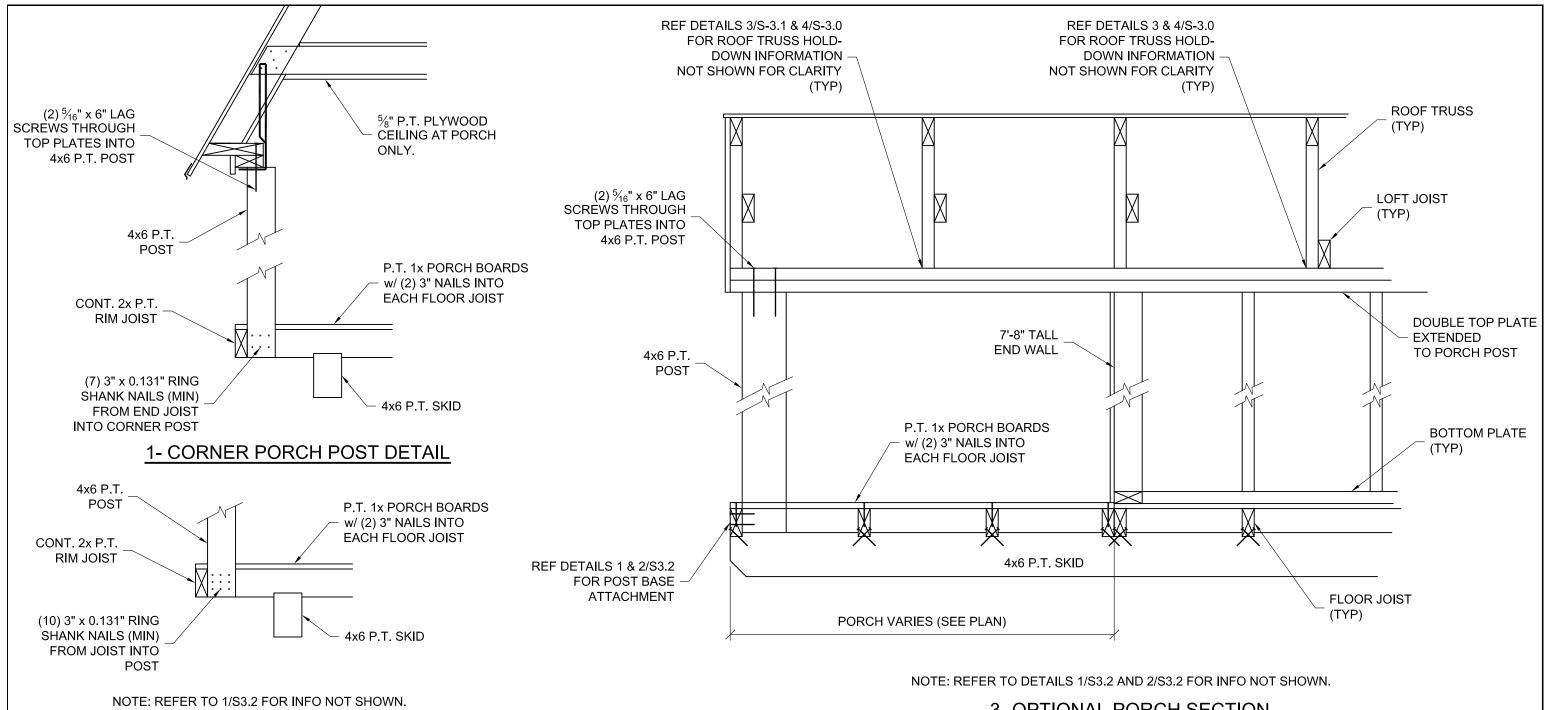

2- INTERMEDIATE PORCH POST DETAIL

3- OPTIONAL PORCH SECTION

NOT TO SCALE

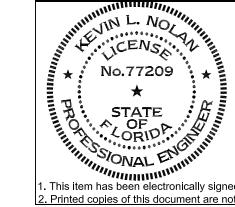

LOFTED BARN--FLORIDA--WIND=160 MPH--FBC 2023

NOTE: REFER TO FASTENING SCHEDULE ON SHEETS S-0.1 AND S-0.2 FOR ATTACHMENT INFORMATION NOT NOTED ON THIS SHEET.



PROJECT NO:

DATE: 12-12-2023

DRAWN BY: KLN

CHECKED BY: KLN


REVISION:

SHEET NUMBER

S-3.2

SCALE: 1"=1'-0

- 1. This item has been electronically signed and sealed by Kevin L Nolan, PE on 01/03/2024 using a digital signature.
- Printed copies of this document are not considered signed and sealed and the signature must be verified on any electronic copy.

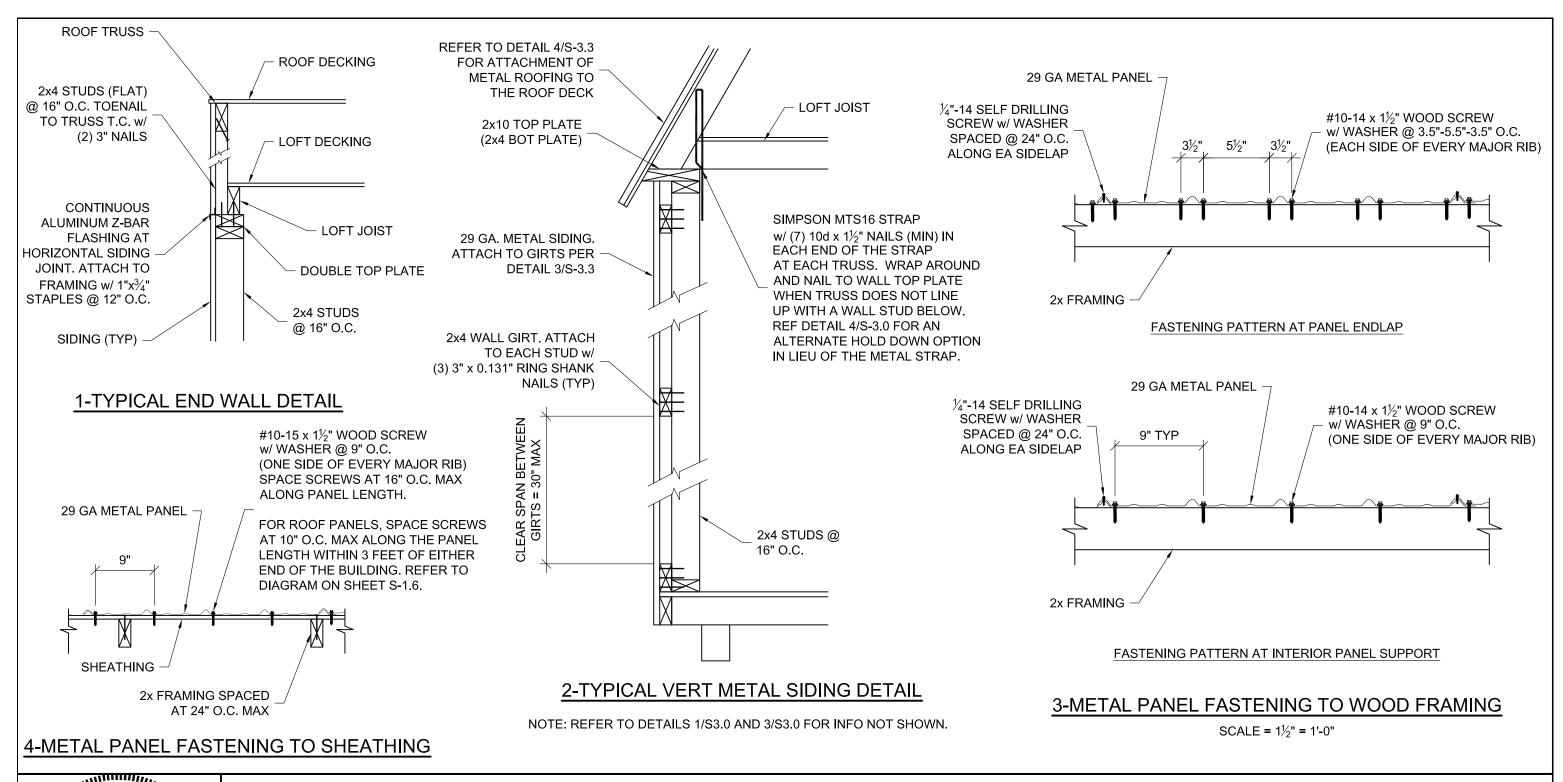

BARN--FLORIDA--WIND=160 MPH--FBC 2023

NOTE: REFER TO FASTENING SCHEDULE ON SHEETS S-0.1 AND S-0.2 FOR ATTACHMENT INFORMATION NOT NOTED ON THIS SHEET.




PROJECT NO: DATE: 12-12-2023 DRAWN BY: KLN CHECKED BY: KLN **REVISION:**

SHEET NUMBER SCALE: 1"=1'-0

STA. OF OF OF ORIDA. CORIDA. C . This item has been electronically signed and sealed by Kevin L Nolan, PE on 01/03/2024 using a digital signature.


LEVIN L. NO.

No.77209

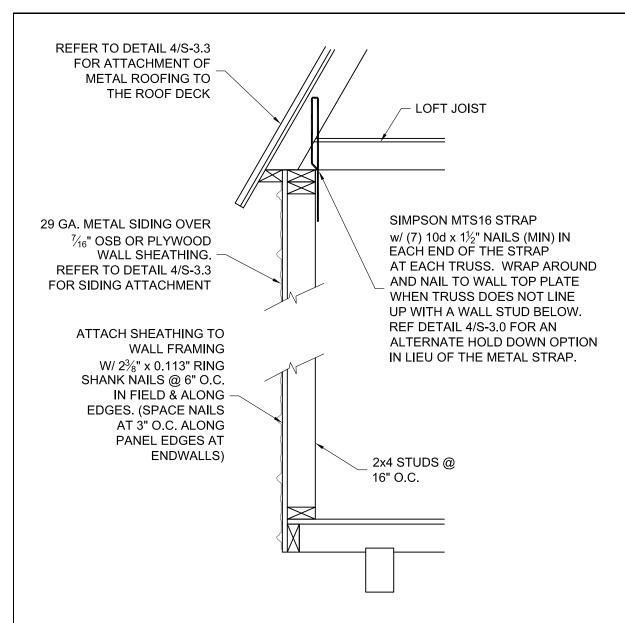

1-TYPICAL HORIZ METAL SIDING DETAIL

NOTE: REFER TO DETAILS 1/S3.0 AND 3/S3.0 FOR INFO NOT SHOWN.

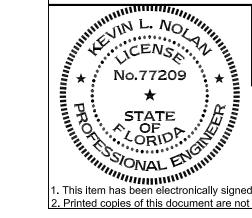

LOFTED BARN--FLORIDA--WIND=160 MPH--FBC 2023

NOTE: REFER TO FASTENING SCHEDULE ON SHEETS S-0.1 AND S-0.2 FOR ATTACHMENT INFORMATION NOT NOTED ON THIS SHEET.



PROJECT NO:

DATE: 12-12-2023

DRAWN BY: KLN

CHECKED BY: KLN


REVISION:

SHEET NUMBER

S-3.4

SCALE: 1"=1'-0

1. This item has been electronically signed and sealed by Kevin L Nolan, PE on 01/03/2024 using a digital signature.

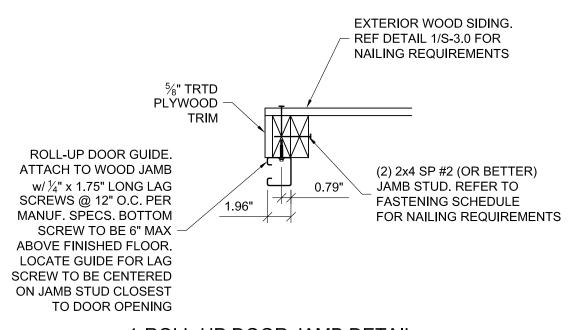

OR LAG
NTERED
LOSEST
PENING

1-ROLL-UP DOOR JAMB DETAIL

(WOOD SIDING)

METAL WALL SIDING OVER
7/16" OSB OR PLYWOOD
WALL SHEATHING.
REF DETAIL 1/S-3.0 FOR

ROLL-UP DOOR GUIDE.
ATTACH TO WOOD JAMB
w/½" x 1.75" LONG LAG
SCREWS @ 12" O.C. PER
MANUF. SPECS. BOTTOM
SCREW TO BE 6" MAX
ABOVE FINISHED FLOOR.
LOCATE GUIDE FOR LAG
SCREW TO BE CENTERED
ON JAMB STUD CLOSEST
TO DOOR OPENING


DE.
MB
LAG
PER
OM
MALL SHEATHING.
REF DETAIL 1/S-3.0 FOR
NAILING REQUIREMENTS

(2) 2x4 SP #2 (OR BETTER)
JAMB STUD. REFER TO
FASTENING SCHEDULE
FOR NAILING REQUIREMENTS

METAL WALL SIDING w/ 2x4 WALL GIRT, REFER RIBS RUNNING VERTICALLY. TO DETAIL 2/S3.3 FOR ATTACH TO WALL GIRT PER SPACING AND NAILING DETAIL 3/S-3.3 **REQUIREMENTS** %" TRTD PLYWOOD TRIM ROLL-UP DOOR GUIDE. ATTACH TO WOOD JAMB (2) 2x4 SP #2 (OR BETTER) $w/\frac{1}{4}$ " x 1.75" LONG LAG 0.79" JAMB STUD. REFER TO SCREWS @ 12" O.C. PER FASTENING SCHEDULE 1.96" MANUF SPECS BOTTOM FOR NAILING REQUIREMENTS SCREW TO BE 6" MAX ABOVE FINISHED FLOOR. LOCATE GUIDE FOR LAG SCREW TO BE CENTERED ON JAMB STUD CLOSEST TO DOOR OPENING

3-ROLL-UP DOOR JAMB DETAIL (VERT METAL SIDING)

2-ROLL-UP DOOR JAMB DETAIL (HORIZ METAL SIDING)

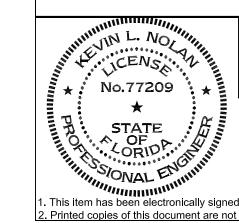

LOFTED BARN--FLORIDA--WIND=160 MPH--FBC 2023

NOTE: REFER TO FASTENING SCHEDULE ON SHEETS S-0.1 AND S-0.2 FOR ATTACHMENT INFORMATION NOT NOTED ON THIS SHEET.

Weather King®

PROJECT NO:

DATE: 12-12-2023

DRAWN BY: KLN

CHECKED BY: KLN


REVISION:


SHEET NUMBER


S-3.5

SCALE: 1 1/2"=1'-0

1. This item has been electronically signed and sealed by Kevin L Nolan, PE on 01/03/2024 using a digital signature.

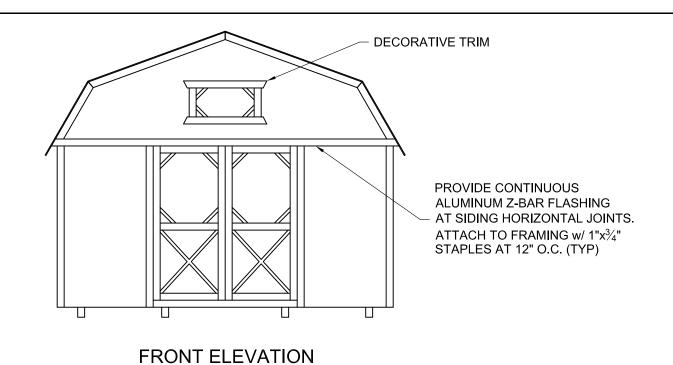

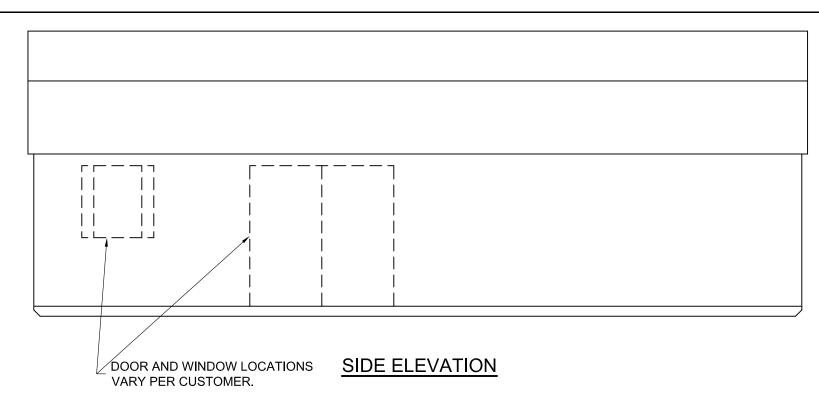

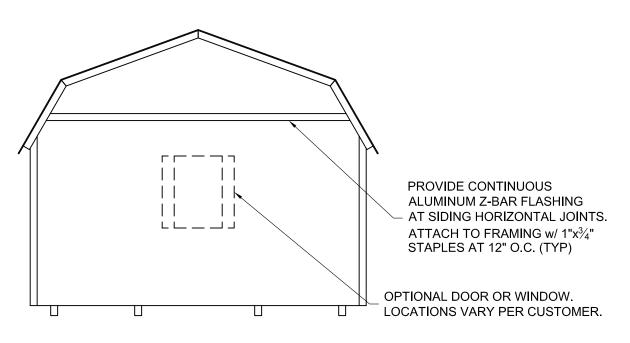


NOTE:

WINDOWS, DOORS, AND TRIM SHOWN ARE CONCEPTUAL. ACTUAL WINDOW, DOOR, AND TRIM MAY VARY PER CUSTOMER REQUEST.

REAR ELEVATION

LOFTED BARN--FLORIDA--WIND=160 MPH--FBC 2023

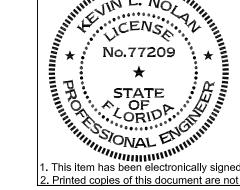

Weather King®

PROJECT NO:

DATE: 12-12-2023

DRAWN BY: KLN

CHECKED BY: KLN

REVISION:

SHEET NUMBER

S-4

SCALE: NOT TO SCALE

- 1. This item has been electronically signed and sealed by Kevin L Nolan, PE on 01/03/2024 using a digital signature.
- 2. Printed copies of this document are not considered signed and sealed and the signature must be verified on any electronic copy.

ELECTRICAL LEGEND

CEILING OUTLETS

SURFACE MOUNT LIGHT (LED/FLUORESCENT)

WALL SWITCHES (UNLESS OTHERWISE NOTED, MOUNT 48" A.F.F.)

S A.C. TYPE, SINGLE POLE, 20 AMP, 120/277 VOLT

WALL OUTLETS

- G \Longrightarrow DUPLEX RECEPTACLE 20 AMP, 125 VOLT, <u>GFI</u>, 2 POLE, 3 WIRE GROUNDED TYPE, NEMA 5-20R. MOUNT 18" A.F.F. UNLESS NOTED OTHERWISE
- Φ Surface-mounted junction box with blank screw cover and flexible conduit connection
- EXTERIOR WALL MOUNTED WET LOCATION LISTED LED/FLUORESCENT FIXTURE


BRANCH WIRING


KEYNOTES:

- ◆ INSTALL SURFACE—MOUNTED JUNCTION BOX FOR CONNECTION TO EXISTING EXTERIOR PANEL. FROM J—BOX, INSTALL A MINIMUM OF 2#10 CU, 1#10 CU GND TO EXISTING PANEL. CONNECT TO NEW 20A, 1—POLE BREAKER IN PANEL.
- ②INSTALL A MINIMUM OF 3/4"C SCHEDULE 80 PVC VIA FLOOR AT A MINIMUM OF 6" BELOW FLOOR. TO PREVENT INTRUSION BY RODENTS OR INSECTS, OPENING TO BE FILLED WITH WEATHERTIGHT CAULK.


GENERAL NOTE(S):

- 1. NUMBER AND LOCATION OF RECEPTACLES MAY VARY WITH EACH MODEL. NO MORE THAN SIX (6) RECEPTACLES TO BE INSTALLED.
- 2. THE EXISTING EXTERIOR PANEL, UNDERGROUND BRANCH CIRCUIT, CONNECTION TO UNIT (INCLUDING DISCONNECTS, OVERCURRENT DEVICES, PANELS, GROUNDING, ETC.) IS DESIGNED BY OTHERS. SITE INSTALLED AND SUBJECT TO LOCAL APPROVAL.
- 3. DOOR NUMBER/SIZE/LOCATION MAY VARY PER MODEL TYPE. COORDINATE AND ADJUST NUMBER/LOCATION OF RECEPTACLES AND SWITCH AS REQUIRED.

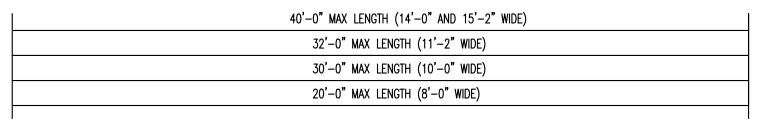

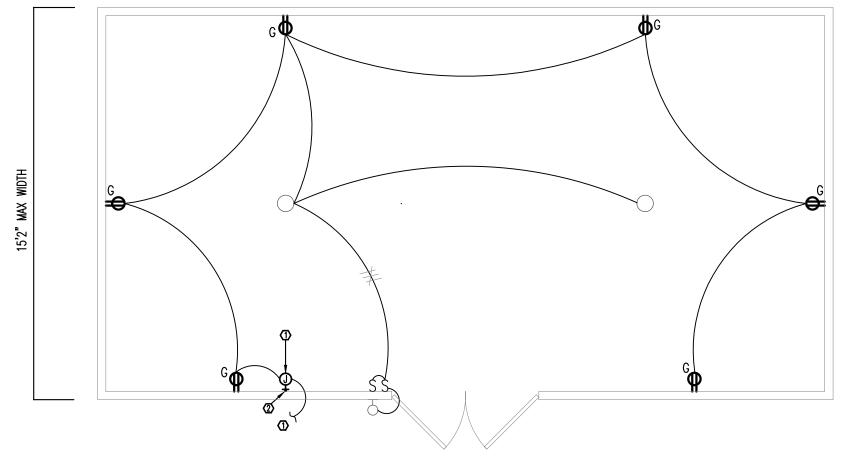



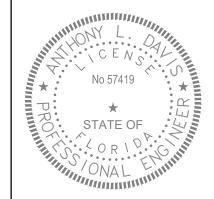

LOFTED BARN BUILDING--FLORIDA--WIND=160 MPH--FBC 2023



Florida CA Number: 27825 Anthony L Davis, PE Florida License Number: 57419 850.526.3447 Project Number: 2023-113

Drawn By: ALD



PROJECT NO:		,
DATE:	12-12-2023	
DRAWN BY:	ALD	
CHECKED BY:	ALD	
REVISION:		

SHEET NUMBER

E-4.1

SCALE: NOT TO SCALE