



ATC SITE NAME: FALLING CREEK FL ATC SITE NUMBER: 24516 T-MOBILE SITE NAME: 9JK0218A T-MOBILE SITE NUMBER: 9JK0218A SITE ADDRESS: HUNTSVILLE CHURCH RD LAKE CITY, FL 32055



LOCATION MAP

T-MOBILE EXCALIBUR ANTENNA AMENDMENT PLAN

COMPLIANCE CODE	ODE PROJECT SUMMARY PROJECT DESCRIPTION			SHEET INDEX			
ALL WORK SHALL BE PERFORMED AND MATERIALS INSTALLED IN ACCORDANCE WITH THE CURRENT EDITIONS OF THE	SITE ADDRESS: THE PROPOSED PROJECT INCLUDES MODIFYING GROUND AND TOWER MOUNTED EQUIPMENT AS INDICATED PER BE		SHEET NO:	DESCRIPTION:	REV:	DATE:	BY:
FOLLOWING CODES AS ADOPTED BY THE LOCAL GOVERNMENT AUTHORITIES. NOTHING IN THESE PLANS IS	HUNTSVILLE CHURCH RD	TOWER WORK: REMOVE (3) SECTOR FRAME(s), (9) ANTENNA(s), (7) RRH(s), (1)	G-001	TITLE SHEET	0	07/01/21	KS
TO BE CONSTRUED TO PERMIT WORK NOT CONFORMING TO THESE CODES.	LAKE CITY, FL 32055 COUNTY: COLUMBIA	COVP, (1) DIPLEXER, (1) 1.58" HYBRID CABLE AND (4) 1-5/8" COAX CABLE(s) INSTALL (3) SECTOR FRAME(s), (3) ANTENNA(s), (2) DISH(s), (6)	G-002	GENERAL NOTES	0	07/01/21	KS
1. 2020 FLORIDA BUILDING CODE, 7TH EDITION	GEOGRAPHIC COORDINATES:		C-101	DETAILED SITE PLAN	0	07/01/21	KS
2. ANSI/TIA-222-H 3. 6TH EDITION FLORIDA FIRE PREVENTION CODE (NFPA 70)	LATITUDE: 30.25068889		C-102	DETAILED GROUND PLAN	0	07/01/21	KS
4. 2017 NATIONAL ELECTRICAL CODE 5. BASIC WIND SPEED: 117 MPH (3-SECOND GUST)	LONGITUDE: -82.74429722	GROUND WORK:	C-201	TOWER ELEVATION	0	07/01/21	KS
6. CITY/COUNTY ORDINANCES	GROUND ELEVATION: 154' AMSL	REMOVE (1) DELTA SSC CABINET, (1) FCOA CABINET AND (1) COVP	C-401	ANTENNA INFORMATION & SCHEDULE	0	07/01/21	KS
		INSTALL (1) ENCLOSURE 6160 CABINET AND (1) B160 BATTERY	C-501	CONSTRUCTION DETAILS	0	07/01/21	KS
		DDO ISOT MOTES	E-501	GROUNDING DETAILS	0	07/01/21	KS
		PROJECT NOTES	R-601	SUPPLEMENTAL			
	PROJECT TEAM TOWER OWNER: APPLICANT: AMERICAN TOWER T-MOBILE	2. A TECHNICIAN WILL VISIT THE STIE APPROXIMATELY UNCE A MONTH FOR ROUTINE INSPECTION AND MAINTENANCE. 3. THE PROJECT WILL NOT RESULT IN ANY SIGNIFICANT LAND DISTURBANCE OR EFFECT OF STORM WATER DRAINAGE. 4. NO SANITARY SEWER, POTABLE WATER OR TRASH DISPOSAL IS REQUIRED. 5. HANDICAP ACCESS IS NOT REQUIRED.	R-602	SUPPLEMENTAL			
			R-603	SUPPLEMENTAL			
			R-604	SUPPLEMENTAL			
	10 PRESIDENTIAL WAY WOBURN, MA 01801						
UTILITY COMPANIES	ENGINEER:	THE PROJECT DEPICTED IN THESE PLANS QUALIFIES AS AN ELIGIBLE FACILITIES REQUEST ENTITLED TO EXPEDITED					
POWER COMPANY: SUWANNEE VALLEY ELECTRIC PHONE: (386) 364-5200	ATC TOWER SERVICES, LLC	REVIEW UNDER 47 U.S.C. § 1455(A) AS A MODIFICATION OF AN EXISTING WIRELESS TOWER THAT INVOLVES THE					
, ,	3500 REGENCY PRWY STE 100 COLL HONE COMPANY: BELLSOUTH CARY, NC 27518 TRAN CHAN	COLLOCATION, REMOVAL, AND/OR REPLACEMENT OF TRANSMISSION EQUIPMENT THAT IS NOT A SUBSTANTIAL					
PHONE: (800) 252-0803		CHANGE UNDER CFR § 1.61000 (B)(7).					
000	PROPERTY OWNER: PETTIGREW MARGARET H	PROJECT LOCATION DIRECTIONS					
211	HUNTSVILLE CHURCH RD LAKE CITY. FL 32055	TAKE I-75 TO EXIT 82, LAKE CITY, TO 90 EAST. GO 2.6 MILES, THERE WILL BE A SIGN TO TURN TO THE ARMORY. TURN LEFT THERE ON LAKE JEFFERY RD GO. 6.6 MILES FROM 90 TAKE A LEFT ON HUNTSVILLE CHURCH ROAD. GO UNTIL IT DEAD ENDS					
	w what's below.						
Know what's below.		AT I-75. SITE IS ON THE LEFT.					
Call before you dig.							

AMERICAN TOWER® ATC TOWER SERVICES, LLC

3500 REGENCY PARKWAY SUITE 100 CARY, NC 27518 PHONE: (919) 468-0112 COA: 9053

THE USE AND PUBLICATION OF THESE DRAWINGS SHALL BE RESTRICTED TO THE ORIGINAL SITE FOR WHICH THEY ARE PREPARED. ANY USE OR DISCLOSURE OTHER THAN THAT WHICH RELATES TO AMERICAN TOWER OR THE SPECIFIED CARRIER IS STRICTLY PROHIBITED. NEITHER THE ARCHITECT NOR THE ENGINEER WILL BE PROVIDING ON-SITE CONSTRUCTION REVIEW OF THIS PROJECT. CONTRACTOR(S) MUST VERIFY ALL DIMENSIONS AND ADVISE AMERICAN TOWER OR THE SPECIFIED CARRIER OF ANY DISCREPANCIES. ANY PRIOR ISSUANCE OF THIS DRAWING IS SUPERSEDED BY THE LATEST VERSION.

REV.	DESCRIPTION	BY	DATE
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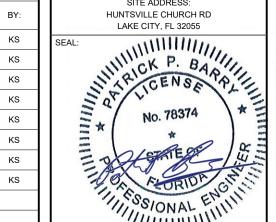
ATC SITE NUMBER: 24516

ATC SITE NAME: FALLING CREEK FL

T-MOBILE SITE NAME:

9JK0218A

SITE ADDRESS: HUNTSVILLE CHURCH RD



T - Mobile sign

	DATE DRAWN:	07/01/21
	ATC JOB NO:	13666522_G3
	CUSTOMER ID:	9JK0218A
	CUSTOMER #:	9JK0218A

TITLE SHEET

SHEET NUMBER: G-001 REVISION:

0

GENERAL CONSTRUCTION NOTES:

- OWNER FURNISHED MATERIALS, T-MOBILE "THE COMPANY" WILL PROVIDE AND THE CONTRACTOR WILL INSTALL
- A. BTS EQUIPMENT FRAME (PLATFORM) AND ICEBRIDGE SHELTER (GROUND BUILD/CO-LOCATE ONLY)
- AC/TELCO INTERFACE BOX (PPC)
- ICE BRIDGE (CABLE TRAY WITH COVER) (GROUND BUILD/CO-LOCATE ONLY, GC TO FURNISH AND INSTALL FOR ROOFTOP INSTALLATION)
- D. TOWERS, MONOPOLES
- TOWER LIGHTING
- GENERATORS & LIQUID PROPANE TANK
- ANTENNA STANDARD BRACKETS, FRAMES AND PIPES FOR MOUNTING
- ANTENNAS (INSTALLED BY OTHERS)
- TRANSMISSION LINE
- TRANSMISSION LINE JUMPERS
- TRANSMISSION LINE CONNECTORS WITH WEATHERPROOFING KITS
- TRANSMISSION LINE GROUND KITS
- HANGERS
- HOISTING GRIPS
- O. BTS EQUIPMENT
- THE CONTRACTOR IS RESPONSIBLE TO PROVIDE ALL OTHER MATERIALS FOR THE COMPLETE INSTALLATION OF THE SITE INCLUDING, BUT NOT LIMITED TO, SUCH MATERIALS AS FENCING, STRUCTURAL STEEL SUPPORTING SUB-FRAME FOR PLATFORM, ROOFING LABOR AND MATERIALS GROUNDING RINGS GROUNDING WIRES COPPER-CLAD OR XIT CHEMICAL GROUND ROD(S), BUSS BARS, TRANSFORMERS AND DISCONNECT SWITCHES WHERE APPLICABLE, TEMPORARY ELECTRICAL POWER, CONDUIT, LANDSCAPING COMPOUND STONE, CRANES, CORE DRILLING, SLEEPERS AND RUBBER MATTING, REBAR, CONCRETE CAISSONS, PADS AND/OR AUGER MOUNTS, MISCELLANEOUS FASTENERS, CABLE TRAYS, NON-STANDARD ANTENNA FRAMES AND ALL OTHER MATERIAL AND LABOR REQUIRED TO COMPLETE THE JOB ACCORDING TO THE DRAWINGS AND SPECIFICATIONS. IT IS THE POSITION OF T-MOBILE TO APPLY FOR PERMITTING AND CONTRACTOR RESPONSIBLE FOR PICKUP AND PAYMENT OF REQUIRED
- ALL WORK SHALL CONFORM TO ALL CURRENT APPLICABLE FEDERAL, STATE, AND LOCAL CODES, INCLUDING ANSI/EIA/TIA-222, AND COMPLY WITH ATC CONSTRUCTION
- CONTRACTOR SHALL CONTACT LOCAL 811 FOR IDENTIFICATION OF UNDERGROUND
- CONTRACTOR SHALL BE RESPONSIBLE FOR COORDINATING ALL REQUIRED INSPECTIONS.
- ALL DIMENSIONS TO, OF, AND ON EXISTING BUILDINGS, DRAINAGE STRUCTURES, AND SITE IMPROVEMENTS SHALL BE VERIFIED IN FIELD BY CONTRACTOR WITH ALL DISCREPANCIES REPORTED TO THE ENGINEER.
- DO NOT CHANGE SIZE OR SPACING OF STRUCTURAL ELEMENTS
- DETAILS SHOWN ARE TYPICAL; SIMILAR DETAILS APPLY TO SIMILAR CONDITIONS UNLESS
- THESE DRAWINGS DO NOT INCLUDE NECESSARY COMPONENTS FOR CONSTRUCTION SAFETY WHICH SHALL BE THE SOLE RESPONSIBILITY OF THE CONTRACTOR
- CONTRACTOR SHALL BRACE STRUCTURES UNTIL ALL STRUCTURAL ELEMENTS NEEDED FOR STABILITY ARE INSTALLED. THESE ELEMENTS ARE AS FOLLOWS: LATERAL BRACING,
- CONTRACTOR SHALL DETERMINE EXACT LOCATION OF EXISTING UTILITIES. GROUNDS DRAINS, DRAIN PIPES, VENTS, ETC, BEFORE COMMENCING WORK
- INCORRECTLY FABRICATED, DAMAGED, OR OTHERWISE MISFITTING OR NONCONFORMING MATERIALS OR CONDITIONS SHALL BE REPORTED TO THE T-MOBILE REP PRIOR TO REMEDIAL OR CORRECTIVE ACTION, ANY SUCH REMEDIAL ACTION SHALL REQUIRE WRITTEN APPROVAL BY THE T-MOBILE REP PRIOR TO PROCEEDING.
- EACH CONTRACTOR SHALL COOPERATE WITH THE T-MOBILE REP, AND COORDINATE HIS WORK WITH THE WORK OF OTHERS.
- CONTRACTOR SHALL REPAIR ANY DAMAGE CAUSED BY CONSTRUCTION OF THIS PROJECT TO MATCH EXISTING PRE-CONSTRUCTION CONDITIONS TO THE SATISFACTION
- ALL CABLE/CONDUIT ENTRY/EXIT PORTS SHALL BE WEATHERPROOFED DURING 15. INSTALLATION LISING A SILICONE SEALANT
- WHERE EXISTING CONDITIONS DO NOT MATCH THOSE SHOWN IN THIS PLAN SET. CONTRACTOR SHALL NOTIFY THE T-MOBILE REP AND ENGINEER OF RECORD
- CONTRACTOR SHALL ENSURE ALL SUBCONTRACTORS ARE PROVIDED WITH A COMPLETE AND CURRENT SET OF DRAWINGS AND SPECIFICATIONS FOR THIS PROJECT
- CONTRACTOR SHALL REMOVE ALL RUBBISH AND DEBRIS FROM THE SITE AT THE END OF
- CONTRACTOR SHALL COORDINATE WORK SCHEDULE WITH AMERICAN TOWER CORPORATION (ATC) AND TAKE PRECAUTIONS TO MINIMIZE IMPACT AND DISRUPTION OF OTHER OCCUPANTS OF THE FACILITY.
- CONTRACTOR SHALL FURNISH T-MOBILE AND AMERICAN TOWER CORPORATION (ATC) ITH A PDF MARKED UP AS-BUILT SET OF DRAWINGS UPON COMPLETION OF WORK
- PRIOR TO SUBMISSION OF BID CONTRACTOR SHALL COORDINATE WITH T-MOBILE REP. TO DETERMINE WHAT, IF ANY, ITEMS WILL BE PROVIDED. ALL ITEMS NOT PROVIDED SHALL BE PROVIDED AND INSTALLED BY THE CONTRACTOR. CONTRACTOR WILL INSTALL

- 22. PRIOR TO SUBMISSION OF BID. CONTRACTOR SHALL COORDINATE WITH T-MORII F REP TO DETERMINE IF ANY PERMITS WILL BE OBTAINED BY CONTRACTOR. ALL REQUIRED PERMITS NOT OBTAINED BY T-MOBILE MUST BE OBTAINED, AND PAID FOR, BY THE
- 23. CONTRACTOR SHALL INSTALL ALL SITE SIGNAGE IN ACCORDANCE WITH T-MOBILE SPECIFICATIONS AND REQUIREMENTS.
- 24. CONTRACTOR SHALL SUBMIT ALL SHOP DRAWINGS TO T-MOBILE FOR REVIEW AND
- ALL EQUIPMENT SHALL BE INSTALLED ACCORDING TO MANUFACTURER'S SPECIFICATIONS AND LOCATED ACCORDING TO T-MOBILE SPECIFICATIONS, AND AS SHOWN IN THESE PLANS
- 26. THE CONTRACTOR SHALL SUPERVISE AND DIRECT THE PROJECT DESCRIBED HEREIN THE CONTRACTOR SHALL BE SOLELY RESPONSIBLE FOR ALL THE CONSTRUCTION MEANS, METHODS, TECHNIQUES, SEQUENCES AND PROCEDURES AND FOR COORDINATING ALL PORTIONS OF THE WORK UNDER THE CONTRACT.
- CONTRACTOR SHALL NOTIFY T-MOBILE REP A MINIMUM OF 48 HOURS IN ADVANCE OF POURING CONCRETE OR BACKFILLING ANY UNDERGROUND UTILITIES, FOUNDATIONS OR SEALING ANY WALL, FLOOR OR ROOF PENETRATIONS FOR ENGINEERING REVIEW AND
- CONTRACTOR SHALL BE RESPONSIBLE FOR SITE SAFETY INCLUDING COMPLIANCE WITH ALL APPLICABLE OSHA STANDARDS AND RECOMMENDATIONS AND SHALL PROVIDE ALL NECESSARY SAFETY DEVICES INCLUDING PPE AND PPM AND CONSTRUCTION DEVICES SUCH AS WELDING AND FIRE PREVENTION, TEMPORARY SHORING, SCAFFOLDING, TRENCH BOXES/SLOPING, BARRIERS, ETC.
- THE CONTRACTOR SHALL PROTECT AT HIS OWN EXPENSE ALL EXISTING FACILITIES AND SUCH OF HIS NEW WORK LIABLE TO INJURY DURING THE CONSTRUCTION PERIOD. ANY DAMAGE CAUSED BY NEGLECT ON THE PART OF THIS CONTRACTOR OR HIS REPRESENTATIVES, OR BY THE ELEMENTS DUE TO NEGLECT ON THE PART OF THIS CONTRACTOR OR HIS REPRESENTATIVES, EITHER TO THE EXISTING WORK, OR TO HIS WORK OR THE WORK OF ANY OTHER CONTRACTOR, SHALL BE REPAIRED AT HIS EXPENSE TO THE OWNER'S SATISFACTION.
- ALL WORK SHALL BE INSTALLED IN A FIRST CLASS, NEAT AND WORKMANLIKE MANNER BY MECHANICS SKILLED IN THE TRADE INVOLVED. THE QUALITY OF WORKMANSHIP SHALL BE SUBJECT TO THE APPROVAL OF THE T-MOBILE REP. ANY WORK FOUND BY THE T-MOBILE REP TO BE OF INFERIOR QUALITY AND/OR WORKMANSHIP SHALL BE REPLACED AND/OR REWORKED AT CONTRACTOR EXPENSE UNTIL APPROVAL IS
- 31. IN ORDER TO ESTABLISH STANDARDS OF QUALITY AND PERFORMANCE, ALL TYPES OF MATERIALS LISTED HEREINAFTER BY MANUFACTURER'S NAMES AND/OR
 MANUFACTURER'S CATALOG NUMBER SHALL BE PROVIDED BY THESE MANUFACTURERS
- T-MOBILE FURNISHED EQUIPMENT SHALL BE PICKED-UP AT THE T-MOBILE WAREHOUSE. NO LATER THAN 48HR AFTER BEING NOTIFIED INSURED, STORED, UNCRATE, PROTEC AND INSTALLED BY THE CONTRACTOR WITH ALL APPURTENANCES REQUIRED TO PLACE THE EQUIPMENT IN OPERATION, READY FOR USE. THE CONTRACTOR SHALL BE RESPONSIBLE FOR THE EQUIPMENT AFTER PICKING IT UP.
- T-MOBILE OR HIS ARCHITECT/ENGINEER RESERVES THE RIGHT TO REJECT ANY 33. EQUIPMENT OR MATERIALS WHICH, IN HIS OWN OPINION ARE NOT IN COMPLIANCE WITH THE CONTRACT DOCUMENTS, EITHER BEFORE OR AFTER INSTALLATION AND THE EQUIPMENT SHALL BE REPLACED WITH EQUIPMENT CONFORMING TO THE REQUIREMENTS OF THE CONTRACT DOCUMENTS BY THE CONTRACTOR AT NO COST TO T-MOBILE OR THEIR ARCHITECT/ENGINEER

SPECIAL CONSTRUCTION ANTENNA INSTALLATION NOTES:

- WORK INCLUDED:
 - ANTENNA AND COAXIAL CABLES ARE FURNISHED BY T-MOBILE UNDER A SEPARATE CONTRACT. THE CONTRACTOR SHALL ASSIST ANTENNA INSTALLATION CONTRACTOR IN TERMS OF COORDINATION AND SITE ACCESS ERECTION SUBCONTRACTOR SHALL BE RESPONSIBLE FOR THE PROTECTION OF
 - B. INSTALL ANTENNA AS INDICATE ON DRAWINGS AND T-MOBILE SPECIFICATIONS.
 - C. INSTALL GALVANIZED STEEL ANTENNA MOUNTS AS INDICATED ON DRAWINGS
 - D. INSTALL FURNISHED GALVANIZED STEEL OR ALUMINUM WAVEGUIDE
 - CONTRACTOR SHALL PROVIDE FOUR (4) SETS OF SWEEP TESTS USING ANRITZU-PACKARD 8713B RF SCALAR NETWORK ANALYZER. SUBMIT FREQUENCY DOMAIN REFLECTOMETER(FDR) TESTS RESULTS TO THE PROJECT MANAGER. SWEEP TESTS SHALL BE AS PER ATTACHED RFS "MINIMUM FIELD TESTING RECOMMENDED FOR ANTENNA AND HELIAX COAXIAL CABLE SYSTEMS" DATED 10/5/93 TESTING SHALL BE PERFORMED BY AN INDEPENDENT TESTING SERVICE AND BE BOUND AND SUBMITTED WITHIN ONE WEEK OF WORK COMPLETION
 - INSTALL COAXIAL CABLES AND TERMINATING BETWEEN ANTENNAS AND EQUIPMENT PER MANUFACTURER'S RECOMMENDATIONS, WEATHERPROOF ALL CONNECTIONS BETWEEN THE ANTENNA AND EQUIPMENT PER MANUFACTURER'S REQUIREMENTS. TERMINATE ALL COAXIAL CABLE THREE (3) FEET IN EXCESS OF ENTRY PORT LOCATION UNLESS OTHERWISE STATED.
 - G ANTENNA AND COAXIAL CABLE GROUNDING:
- ALL EXTERIOR #6 GREED GROUND WIRE "DAISY CHAIN" CONNECTIONS ARE TO BE WEATHER SEALED WITH RFS CONNECTORS/SPLICE WEATHERPROOFING KIT #221213 OR
- ALL COAXIAL CABLE GROUNDING KITS ARE TO BE INSTALLED ON STRAIGHT RUNS OF

ALL DISCREPANCIES FROM WHAT IS SHOWN ON THESE CONSTRUCTION DRAWINGS SHALL BE COMMUNICATED TO ATC ENGINEERING IMMEDIATELY FOR CORRECTION OR RE-DESIGN. FAILURE TO COMMUNICATE DIRECTLY WITH ATC ENGINEERING OF ANY CHANGES FROM THE DESIGN CONDUCTED WITHOUT PRIOR APPROVAL FROM ATC ENGINEERING SHALL BE THE SOLE RESPONSIBILITY OF THE GENERAL CONTRACTOR.



3500 REGENCY PARKWAY SUITE 100 **CARY, NC 27518** PHONE: (919) 468-0112 COA: 9053

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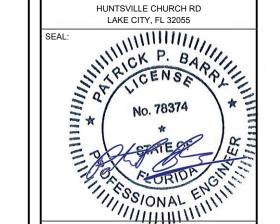
ATC SITE NUMBER: 24516

ATC SITE NAME: FALLING CREEK FL

T-MOBILE SITE NAME:

9JK0218A

SITE ADDRESS: HUNTSVILLE CHURCH RD



T-Mobile sign

DATE DRAWN:	07/01/21
ATC JOB NO:	13666522_G3
CUSTOMER ID:	9JK0218A
CUSTOMER #:	9JK0218A

GENERAL NOTES

SHEET NUMBER:

REVISION

G-002

SITE PLAN NOTES:

- 1. THIS SITE PLAN REPRESENTS THE BEST PRESENT KNOWLEDGE AVAILABLE TO THE ENGINEER AT THE TIME OF THIS DESIGN. THE CONTRACTOR SHALL VISIT THE SITE PRIOR TO CONSTRUCTION AND VERIFY ALL EXISTING CONDITIONS RELATED TO THE SCOPE OF WORK FOR THIS PROJECT.
- ICE BRIDGE, CABLE LADDER, COAX PORT, AND COAX CABLE ARE SHOWN FOR REFERENCE ONLY. CONTRACTOR SHALL CONFIRM THE EXACT LOCATION OF ALL PROPOSED AND EXISTING EQUIPMENT AND STRUCTURES DEPICTED ON THIS PLAN. BEFORE UTILIZING EXISTING CABLE SUPPORTS, COAX PORTS, INSTALLING NEW PORTS OR ANY OTHER EQUIPMENT, CONTRACTOR SHALL VERIFY ALL ASPECTS OF THE COMPONENTS MEET THE ATC SPECIFICATIONS.
- 3. NO ELECTRICAL SCOPE IS INCLUDED IN THIS PROJECT.

LEGEND

GROUNDING TEST WELL
AUTOMATIC TRANSFER SWITCH
BOLLARD
CELL SITE CABINET
DISCONNECT
ELECTRICAL
FIBER
GENERATOR
GENERATOR RECEPTACAL
HAND HOLE, VAULT
ICE BRIDGE
KENTROX BOX
LIGHTING CONTROL
METER
PULL BOX
POWER POLE
TELCO
TRANSFORMER

CHAINLINK FENCE

	+	PROVIDE LIGHTING INSIDE THE CABINETS. 2. EXISTING BTS CABINETS TO BE REMOVED. UTILL INCLUDING PPC SHALL REMAIN AND RECONNECTION.
×		×
× P	EXISTING — (4) 1-5/8" COAX CABLES AND (1) 1.58" HYBRID CABLES (TO BE REMOVED)	×
×	PROPOSED (2) 1.99" HYBRID CABLES — (ROUTED PER PROPOSED CABLE LENGTH NOTE 2) (REFER TO PROPOSED CABLE LENGTH NOTE ON THIS PAGE)	EXISTING T-MOBILE GPS ANTENNA TO REMAIN
×	GUYED TOWER IB	EXISTING T-MOBILE 8' X 13' CONCRETE PAD W/ 15' X 23' GROUND SPACE (MODIFIED AS REQUIRED FOR UPGRADE TO NEW CONFIGURATION)
X	EXISTING T-MOBILE CIENA TO REMAIN	× × × × × × × × × × × × × × × × × × ×
×	EXISTING T-MOBILE TELCO BOX TO REMAIN	PROPOSED B160 BATTERY CABINET PROPOSED
\ \ \ \ \	EXISTING T-MOBILE PPC TO REMAIN	ENCLOSURE 6160 CABINET R-602
× x		EXISTING T-MOBILE GENERATOR TO REMAIN ×

ECOA CABINET

GROUND WORK:


1. TECH LIGHTS WILL BE REPOSITIONED IF NECESSARY,

DELTA SSC

COVP

PROPOSED CABLE LENGTH:

- ESTIMATED LENGTH OF PROPOSED CABLE IS 325'. ESTIMATED LENGTH OF CABLE WAS PROVIDED BY CUSTOMER OR CALCULATED BY ADDING THE RAD CENTER AND THE DISTANCE FROM THE SHELTER ENTRY PLATE TO THE TOWER (ALONG THE ICE BRIDGE) AND A SAFETY FACTOR MEASUREMENT OF 15% (OF THE TWO PREVIOUS VALUES), CDS DEFER TO GREATEST CABLE LENGTH.
- 2. ROUTE PROPOSED CABLES ALONG SAME PATH AS EXISTING CABLES AND IN ACCORDANCE WITH STRUCTURAL ANALYSIS. WHERE POSSIBLE UTILIZE EXISTING CABLE SUPPORT STRUCTURES AS PROVIDED FOR CARRIER TO ADEQUATELY SECURE CABLES, USING EITHER APPROPRIATELY SIZED STAINLESS STEEL SNAP-INS OR MOUNTING HARDWARE AND BRACKETS AS SPECIFIED BY CABLE MANUFACTURER. OTHERWISE, ATTACH CABLES TO HORIZONTAL OR DIAGONAL TOWER MEMBERS USING PROPOSED STAINLESS STEEL ADAPTERS (DO NOT ATTACH TO TOWER LEG).

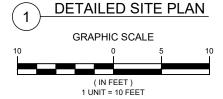





ATC TOWER SERVICES, LLC

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T-MOBILE SITE NAME:

9JK0218A

SITE ADDRESS: HUNTSVILLE CHURCH RD LAKE CITY, FL 32055

AL:

No. 78374

No. 78374

*

${f F}$ - ${f Mobile}$

DATE DRAWN:	07/01/21
ATC JOB NO:	13666522_G3
CUSTOMER ID:	9JK0218A
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DETAILED SITE PLAN

SHEET NUMBER:

C-101


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REVISION:

Equipment that is physically being removed from the ground		
Equipment Type	Quantity	
FCOA CABINET	1	
DELTA SSC	1	
COVP	1	

GROUND WORK:

- TECH LIGHTS WILL BE REPOSITIONED IF NECESSARY, PROVIDE LIGHTING INSIDE THE CABINETS.
- EXISTING BTS CABINETS TO BE REMOVED. UTILLTY FEEDS INCLUDING PPC SHALL REMAIN AND RECONNECT.

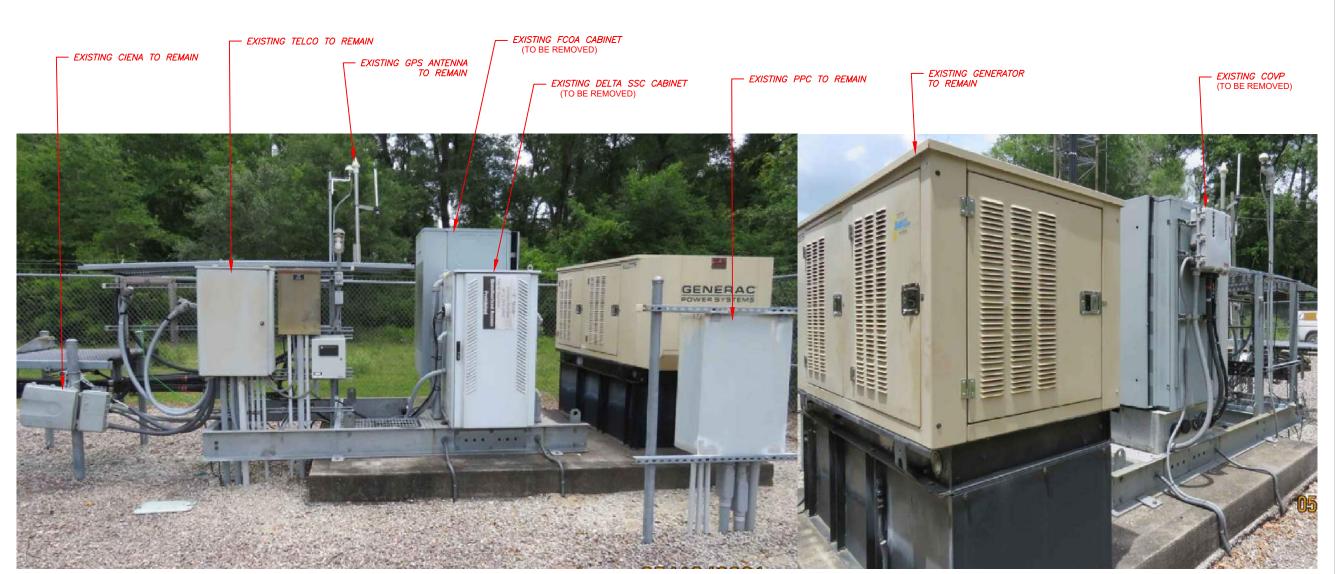

EXISTING GROUND EQUIPMENT



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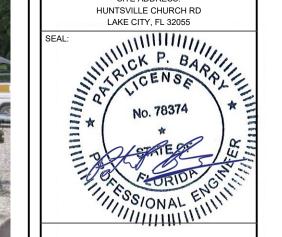
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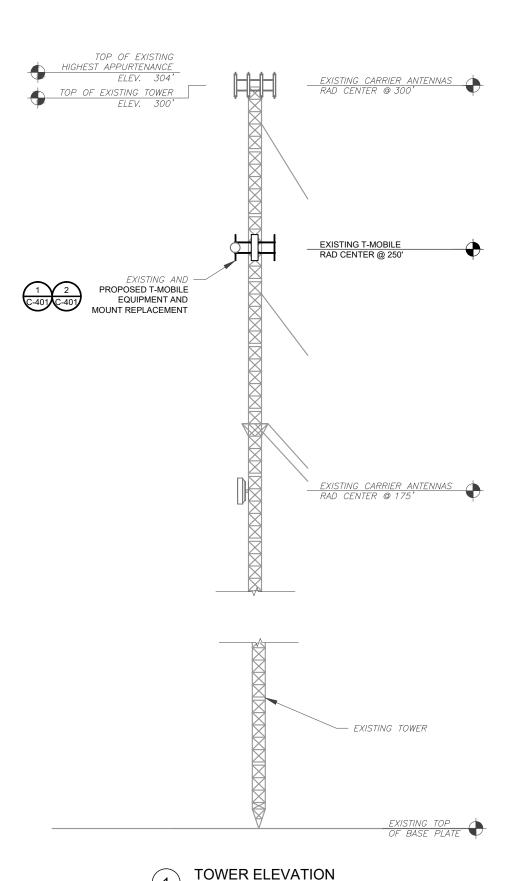
EXISTING GROUND EQUIPMENT

SHEET NUMBER:

C-102

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REVISION:



SCALE: N.T.S.

- TOWER NOTE:

 1. IT IS THE CONTRACTOR'S RESPONSIBILITY TO CONFIRM WITH THE PROJECT MANAGER THAT THEY HAVE THE MOST RECENT VERSION OF THE STRUCTURAL ANALYSIS BEFORE COMMENCING WORK. EXISTING AND PROPOSED TOWER APPURTENANCES, MOUNTS, AND ANTENNAS ARE SHOWN BASED ON THE STRUCTURAL ANALYSIS.
- 2. WHERE APPLICABLE, ALL NEW ANTENNAS, EQUIPMENT, MOUNTS, CABLING, ETC. SHALL BE PAINTED/SOCKED TO MATCH EXISTING EQUIPMENT IN ACCORDANCE WITH FAA, JURISDICTION, AND/OR OTHER LOCAL REQUIREMENTS.
- ROUTE PROPOSED CABLES ALONG SAME PATH AS EXISTING CABLES AND IN ACCORDANCE WITH STRUCTURAL ANALYSIS. WHERE POSSIBLE UTILIZE EXISTING CABLE SUPPORT STRUCTURES AS PROVIDED FOR CARRIER TO ADEQUATELY SECURE CABLES, USING EITHER APPROPRIATELY SIZED STAINLESS STEEL SNAP-INS OR MOUNTING HARDWARE AND BRACKETS AS SPECIFIED BY CABLE MANUFACTURER. OTHERWISE, ATTACH CABLES TO HORIZONTAL OR DIAGONAL TOWER MEMBERS USING PROPOSED STAINLESS STEEL ADAPTERS (DO NOT ATTACH TO TOWER LEG).
- 4. TOWER ELEVATIONS ARE MEASURED FROM TOP OF BASE PLATE TO MATCH STRUCTURAL ANALYSIS. ELEVATIONS DO NOT REFLECT TRUE ABOVE GROUND LEVEL (A.G.L.)



ATC TOWER SERVICES, LLC

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ATC SITE NUMBER: 24516

ATC SITE NAME: FALLING CREEK FL

T-MOBILE SITE NAME:

9JK0218A

SITE ADDRESS: HUNTSVILLE CHURCH RD LAKE CITY, FL 32055

No. 78374

*
No. 78374

T - Mobile sign

DATE DRAWN:	07/01/21
ATC JOB NO:	13666522_G3
CUSTOMER ID:	9JK0218A
CUSTOMER #:	9JK0218A


TOWER ELEVATION


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C-201

REVISION:

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FINAL ANTENNA PLAN

Equipment that is physically being removed from the tower **Equipment Size** PANEL 81x15x5.2 CMA-BDHH/6521/E0-6 BOB/SSB 18.9x16.1x5.8 ASU9338TYP01 DIPLEXER/DUAL COUPLER 4.3x2.9x1.8 ATBT-TOP-24V RRU/RRH 18.1x15.2x6 FRIG w/o Solar Shield RRU/RRH 22.1x19.4x5.2 EXFB RRU/RRH 22x19.3x5.2 3-Sector RF Module 15/8" Coax Coax Coax Fiber/Hybrid 1.58" (40.1mm) Hybrid Fiber/Hybrid

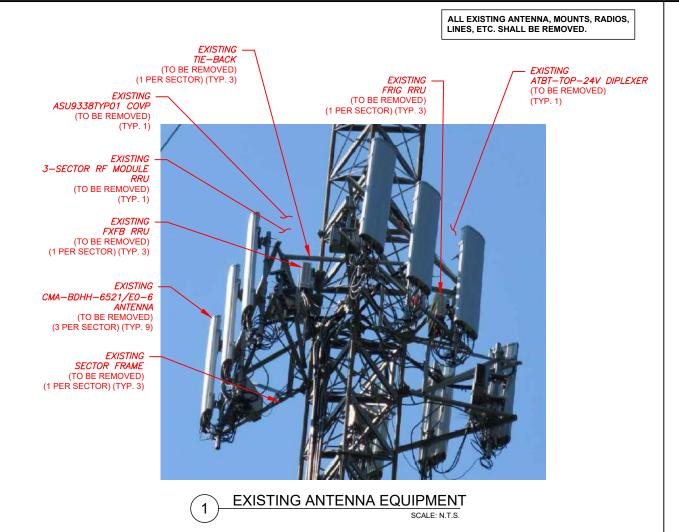CONFIRM WITH T-MOBILE REP FOR APPLICABLE UPDATES/REVISIONS AND MOST RECENT RFDS FOR NSN CONFIGURATION (CONFIG), GC TO CAP ALL UNUSED PORTS. CONFIRM SPACING OF PROPOSED EQUIP DOES NOT CAUSE TOWER CONFLICTS NOR IMPEDE TOWER CLIMBING PEGS.

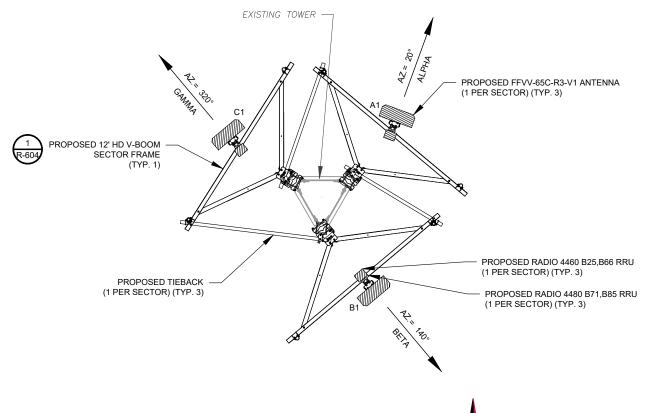NOTES

STATUS ABBREVIATIONS

RMV: TO BE REMOVED RMN: TO REMAIN REL: TO BE RELOCATED ADD: TO BE ADDED

CABLE LENGTHS FOR JUMPERS

JUNCTION BOX TO RRU: 15' RRU TO ANTENNA: 10'

SECTOR	RAD	AZ	POS	ANTENNA	STATUS	ADD'L EQUIPMENT	STATUS
ALDILA:		20	0.5	FENAL CEC DO VIII	ADD	4460	ADD
ALPHA		20	A1	FFVV-65C-R3-V1		4480	ADD
DETA	250.0	140	D.1	FEVA / SEC DO 144	V1 ADD	4460	ADD
BETA	250.0	140	B1	FFVV-65C-R3-V1		4480	ADD
C 0 5 4 5 4 6		220		FEVAL SEC DO VIII	ADD	4460	ADD
GAMMA		320 C1 FFVV-65C-R3-V1 ADD	ADD	4480	ADD		

FINAL FIBER DISTRIBUTION / OVI	FINAL	CABLING SUMMARY		
MODEL NUMBER	STATUS	COAX	HYBRID	STATUS
-	-	-	(2) 1.99"	ADD
-	-	-	-	-



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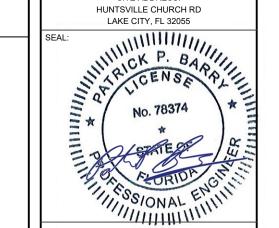
ATC SITE NUMBER: 24516

ATC SITE NAME: FALLING CREEK FL

T-MOBILE SITE NAME:

9JK0218A

SITE ADDRESS: HUNTSVILLE CHURCH RD



T - Mobile sign

DATE DRAWN:	07/01/21
ATC JOB NO:	13666522_G3
CUSTOMER ID:	9JK0218A
CUSTOMER #:	9JK0218A


ANTENNA INFORMATION & SCHEDULE

SHEET NUMBER:

C-401

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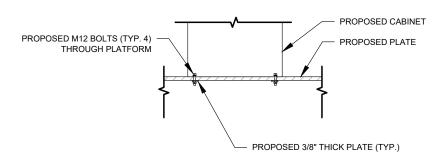
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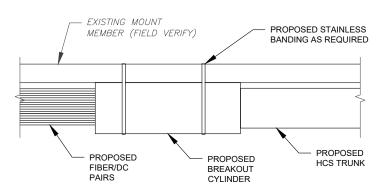
PROPOSED ANTENNA MOUNTING DETAIL - TYPICAL

PROPOSED RRU MOUNT LOCATION (OPTION 2) (MOUNT PER MANUFACTURER'S SPECS) ENSURE THAT BRACKET DOES NOT CONFLICT WITH EXISTING OR PROPOSED EQUIPMENT) PROPOSED RRU MOUNT LOCATION (OPTION 1) (MOUNT PER MANUFACTURER'S SPECS) (ENSURE THAT BRACKET DOES NOT CONFLICT WITH EXISTING OR PROPOSED EQUIPMENT) PROPOSED SECTOR FRAME PROPOSED RRU MOUNT LOCATION (OPTION 3) (MOUNT PER MANUFACTURER'S SPECS) (ENSURE THAT BRACKET DOES NOT CONFLICT WITH EXISTING OR PROPOSED EQUIPMENT)

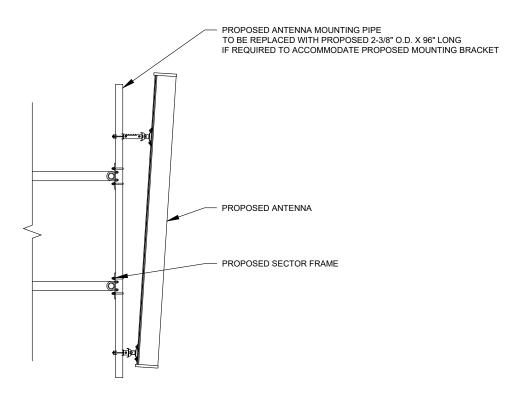PROPOSED RRU MOUNTING DETAIL - TYPICAL



CABINET ATTACHMENT TO PLATE



PROPOSED BREAKOUT CYLINDER ATTACHMENT

AMERICAN TOWER®

ATC TOWER SERVICES, LLC 3500 REGENCY PARKWAY

SUITE 100 **CARY, NC 27518** PHONE: (919) 468-0112 COA: 9053

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ATC SITE NUMBER: 24516

ATC SITE NAME: FALLING CREEK FL

T-MOBILE SITE NAME:

9JK0218A

SITE ADDRESS: HUNTSVILLE CHURCH RD

No. 78374 FORIDA ENGLIS

07/01/21
13666522_G3
9JK0218A
9JK0218A


CONSTRUCTION **DETAILS**

SHEET NUMBER:

C-501

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REVISION

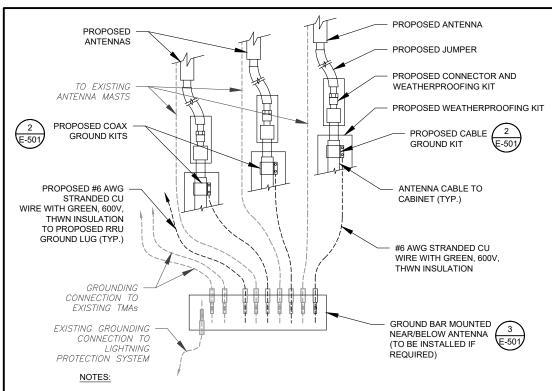

- 1. THIS DETAIL IS INTENDED TO SHOW THE GENERAL GROUNDING REQUIREMENTS. SLIGHT ADJUSTMENTS MAY BE REQUIRED BASED ON EXISTING SITE CONDITIONS. THE CONTRACTOR SHALL MAKE FIELD ADJUSTMENTS AS NEEDED AND INFORM THE CONSTRUCTION MANAGER OF ANY CONFLICTS.
- 2. SITE GROUNDING SHALL COMPLY WITH T-MOBILE GROUNDING STANDARDS, LATEST EDITION, AND COMPLY WITH T-MOBILE GROUNDING CHECKLIST, LATEST VERSION. WHEN NATIONAL AND LOCAL GROUNDING CODES ARE MORE STRINGENT THEY SHALL GOVERN.

TYPICAL ANTENNA GROUNDING DIAGRAM



TO EQUIPMENT

GROUND WIRE DOWN TO GROUND BAR.

CABLE GROUND KIT CONNECTION DETAIL

NUMBER 221213) AND INSTALL/TAPE PER MANUFACTURER'S SPECIFICATIONS.

GROUND KIT NOTES:

1. DO NOT INSTALL CABLE GROUND KIT AT A BEND AND ALWAYS DIRECT

2. CONTRACTOR SHALL PROVIDE WEATHERPROOFING KIT (ANDREW PART

ANTENNA CABLE 2 1/2"Ø MAX

GROUNDING KIT PER CABLE

TO GROUND BAR

(ANDREW OR APPROVED EQUAL)

MANUFACTURER'S RECOMMENDATIONS

#6 AWG STRANDED COPPER GROUND


WIRE (GROUNDED TO GROUND BAR)






- IT IS THE RESPONSIBILITY OF THE CONTRACTOR TO COORDINATE WITH THE T-MOBILE REPRESENTATIVE AND LOCAL UTILITY COMPANY FOR THE INSTALLATION OF CONDUITS, CONDUCTORS, BREAKERS, DISCONNECTS, OR ANY OTHER EQUIPMENT REQUIRED FOR ELECTRICAL SERVICE. ALL ELECTRICAL WORK SHALL BE PERFORMED IN ACCORDANCE WITH LATEST EDITION OF THE STATE AND NATIONAL CODES, ORDINANCES AND REGULATIONS APPLICABLE TO THIS PROJECT.
- ATC HAS NOT VERIFIED ANY EXISTING T-MOBILE GROUND EQUIPMENT OR ELECTRICAL LOADING. PROPOSED WORK BASED ON INSTALLATION CONFIGURATION PROVIDED BY T-MOBILE. CONTRACTOR TO VERIFY EXISTING T-MOBILE PANEL HAS SUFFICIENT SPACE FOR PROPOSED BREAKER, PROPOSED CABLE AND CONDUIT SHALL BE MINIMUM SIZE PER BELOW IN CHART.
- FOR SPECIFIC CABINET / ANCILLARY EQUIPMENT WIRING REQUIREMENTS, THE T-MOBILE CONTRACTOR SHOULD REFERENCE DESIGN DOCUMENTS PROVIDED BY T-MOBILE FOR THIS CURRENT PROJECT CONFIGURATION, IN ACCORDANCE WITH LOCAL JURISDICTION REQUIREMENTS & NEC STANDARDS & PRACTICES

OCPD SIZE	WIRE SIZE	GROUND SIZE	CONDUIT SIZE
80A/2P	2#3 AWG	#8 AWG	1-1/4"
100/2P	2#2 AWG	#8 AWG	1-1/4"
125A/2P	2#1 AWG	#8 AWG	1-1/2"
150A/2P	2#1/0 AWG	#8 AWG	1-1/2"

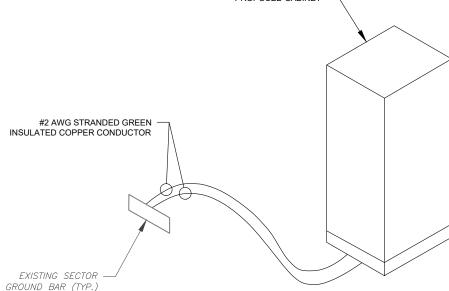

CABINET GROUNDING DETAIL

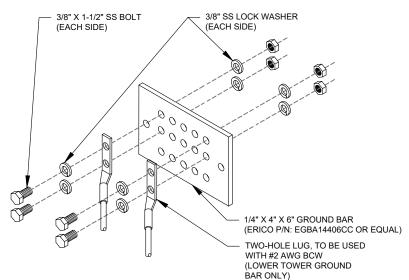

GROUND BAR NOTES:

- GROUND BAR KITS COME WITH ALL HARDWARE, NUTS, BOLTS, WASHERS, ETC. EXCEPT THE STRUCTURAL MOUNTING MEMBER(S).
- 2. GROUND BAR TO BE BONDED DIRECTLY TO TOWER.





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ATC SITE NAME: FALLING CREEK FL

T-MOBILE SITE NAME:

9JK0218A

SITE ADDRESS: HUNTSVILLE CHURCH RD

No. 78374 SSIONAL ENG III SSIONAL ENGLIS


T - Mobile sign

DATE DRAWN:	07/01/21
ATC JOB NO:	13666522_G3
CUSTOMER ID:	9JK0218A
CUSTOMER #:	9JK0218A

GROUNDING DETAILS


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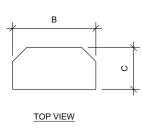
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TO ANTENNA

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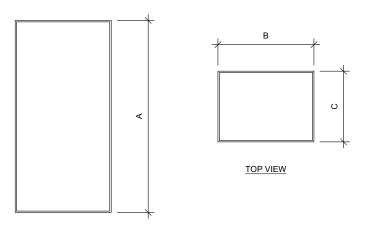


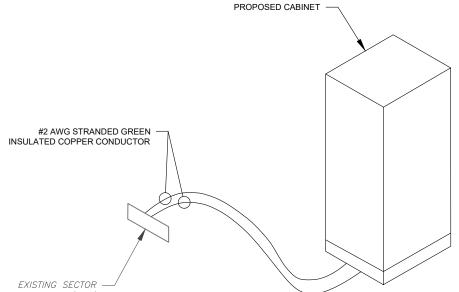

FRONT VIEW

ANTENNA SPECIFICATIONS FOR ILLUSTRATIVE PURPOSES ONLY - N.T.S.

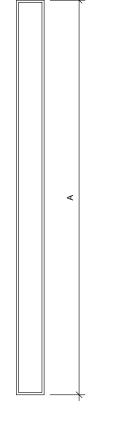ANTENNA SPECIFICATIONS					
ANTENNA MODEL A B C WEIGHT (LBS)					
FFVV-65C-R3-V1	95.9"	25.2"	9.3"	124.6	



FRONT VIEW

RRU SPECIFICATIONS FOR ILLUSTRATIVE PURPOSES ONLY - N.T.S.

RRU SPECIFICATIONS				
RRU MODEL	А	В	С	WEIGHT (LBS)
4460	19.6"	15.7"	12.1"	109.0
4480	21.8"	15.7"	7.5"	84.0

SUPPLEMENTAL

SHEET NUMBER:

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R-601

REVISION: 0



Enclosure 6160 AC

The Enclosure 6160 is a multi-purpose site cabinet designed to support a multitude of equipment such as ERS Baseband, Transport, Li-Ion battery and 3PP vendor equipment. It also provides a highly capable power system and battery back-up - all in a streamlined design and minimized footprint to support cost efficient expansion of mobile broadband.

Being an all-in-one enclosure, the Enclosure 6160 is a very fitting choice for all types of sites where the capacity need is large or room for future expansion is needed. It is ideally used for modernizing existing sites or in greenfield scenarios to match both current and future needs.

With a robust design, IP65 compliance and a sealed Heat Exchanger (HEX) climate system the Enclosure 6160 ensures optimal environmental protection of the active equipment - enabling them for a long-lasting service. The complete system is also integrated and verified for the entire Ericsson Radio System and ensures best-in-class service.

The power system offers 31,5kW of power in total and provides 24kW of –48V DC power for both internal and external consumers.

The equipment space allows 19U of rack space ensuring well enough capacity for existing need and future expansion.

One of the main advantages of the Enclosure 6160 is its default integration with ENM - allowing for advanced remote monitoring and control such a fault management (alarms), inventory management and performance measurements. The cabinet also provides an open O&M interface for integration to 3PP O&M systems.



Preliminary technic	cal specification for Enclosure 6160 AC			
CAPACITY				
Rack space user equipment	19U (19" rack)			
Hardware capabilities	Power and CPRI support for multi-standard remote radios (RRU or AIR)			
	ERS Baseband and Transport units			
	Li-lon batteries			
	3PP equipment			
	Additional power feed available as option			
MECHANICAL SPECIFICATION				
Weight	145 kg (excluding active equipment) 320 lbs (excluding active equipment)			
Dimension (H x W x D)	1600 x 650 x 650 mm (incl. Base frame) 63 x 26 x 26 in. (incl. Base frame)			
Base frame height	150 mm 6 in.			
Mounting position	Ground			
Enclosure material	Aluminum			
Color	Power paint NCS 2002-B			
Door	Front access			
Rack type	19" (IEC 60297-3-100)			
Locking type	Pad lock or Cylinder			
POWER SYSTEM				
Input voltage	3P+N+PE: 346/200-415/240 VAC 2P+N+PE: 208/120-220/127 VAC 1P+N+PE: 200-250 VAC			
Input power	<33kW			
Output load (-48VDC)	24kW			
Total capacity (-48VDC)	31.5kW			
AC SPD	Class 2/Type 2			
DC SPD	Class 2/Type 2			
PSU Slots	9x			
Service outlet	Optional			
Priority load	8x Circuit Breaker			
LLVD 1	6x Circuit Breaker			
LLVD 2	6x Circuit Breaker			
CB ratings	3A / 5A / 10A / 15A / 20A / 25A / 30A / 40A / 50A / 60A / 80A / 100A			
Battery Interface	2x Circuit Breaker			
Battery Circuit Breaker rating	125A 2pol (200A)			
PSU capacity	3500W			

SUPPLEMENTAL

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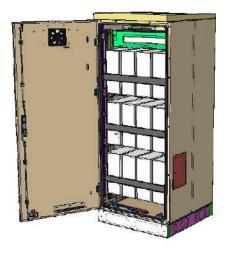
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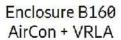
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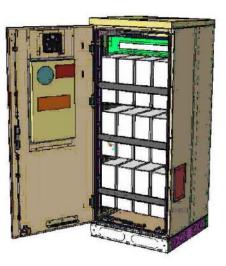
R-602

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Enclosure B160







Enclosure B160 AirCon + Li-Ion



Enclosure B160 **Convection Cooling** + VRLA

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Enclosure B160

Capacity

 VRLA 12V: 100Ah / 150Ah / 170Ah / 190Ah / 210Ah

— Li-Ion: 24U 19" / 23" 3x FIAMM Sodium-Nickel:

Electrical specification

-48VDC/200A — DC Output: Battery breakers: 2x 125/2p

- Alarms: Door open, Climate failure, MCB Connection

Mechanical specification

— Weight: 134kg

- Dimensions: 63 x 26 x 26 in. (incl. Base frame)

Base frame height: 6 in.

- Material: Galvanized steel (180g/m²) Powder paint NCS 2002-B Color:

Front access — Door: Locking type: Pad lock / cylinder Environmental specification

VRLA/Sodium IP44 Ingress protection:

Li-Ion IP55

 Relative humidity: 15-100%

Climate system

Air Conditioner

Fan type: DC

 Cooling capacity: 500W @L35/L35

Convection cooling

Emergency fan

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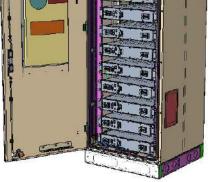
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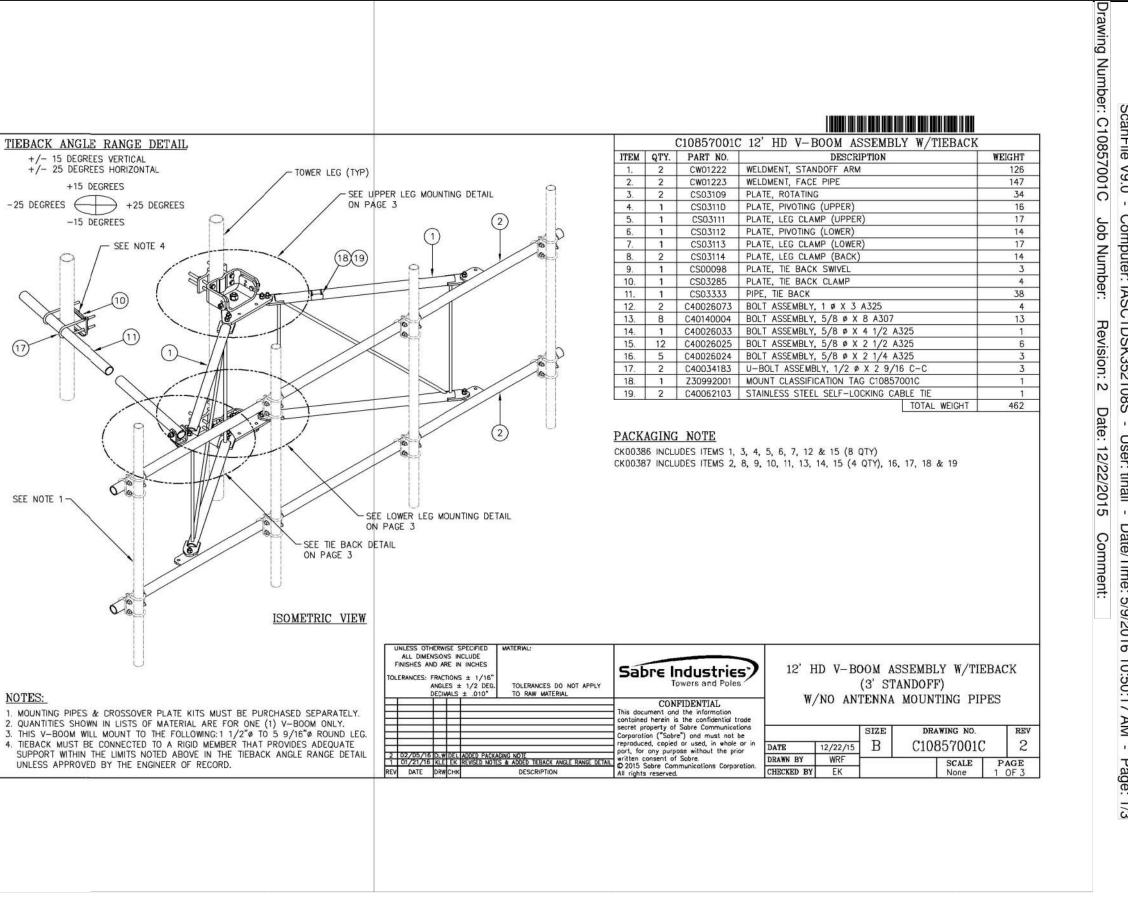
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ANALYSIS CALCULATIONS AND DETAILS. SUPPLEMENTAL PAGES INCLUDED IN THE CONSTRUCTION DRAWINGS ARE FOR REFERENCE ONLY. GENERAL CONTRACTOR IS TO

VERYIFY THEY HAVE THE MOST RECENT MOUNT ANALYSIS PRIOR TO CONTRUCTION.

WITHOUT EDIT. PLEASE REFERENCE THE MOUNT ANALYSIS REPORT FOR COMPLETE MOUNT

SUPPLEMENTAL

SHEET NUMBER:

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R-604