DATE 01/18/	/2008	Colum This Permit Must B	bia County	Building P	ermit	estruction		000026641	
ADDI ICANIT	WILLIAM		e Frommently 1 ost		PHONE	623-3873	,	700020041	
APPLICANT ADDRESS	119	SW HOBBY PLAC	E	LAKE CITY		025 5075	— FL	32024	
The state of the s	-	KELLY BRIGGS			PHONE	754-3883			
ADDRESS	388	SW RAMON CT		LAKE CITY	Y		FL	32024	- 91
CONTRACTOR	R WIL	LIAM HARPER			PHONE	623-3873			
LOCATION OF	PROPERT	90 W, L P	INEMOUNT, L BIR	LEY, R BRIM, L	RAMON (CT,			
		3RD LOT	ON RIGHT SEE BA	AORD FENCE					
TYPE DEVELO	PMENT	MODULAR, UTI	LITY	ESTIMATED CO	ST OF CO	ONSTRUCTIO	N	0.00	
HEATED FLOO	OR AREA		TOTAL A	AREA		HEIGHT	16.00	STORIES 1	_
FOUNDATION		WAL	LS	ROOF PITCH			FLOOR		
LAND USE & Z	ZONING	A-3			MAX	. HEIGHT	35		
Minimum Set Ba	ack Requir	ments: STREET-	FRONT 30	.00	REAR	25.00	SIDE	25.00	
NO. EX.D.U.	1	FLOOD ZONE	X	DEVELOPM	ENT PER	MIT NO.			
PARCEL ID	18-4S-16-0	3054-103	SUBDIVIS	SION THISTL	EDEW UN	NREC			
	BLOCK	PHASE	UNIT				11.56		_
LOT <u>C</u>	BLOCK	THASE	ONIT		1011	TETICIES _	1		
			R282811402		de	en Al	Lupe	-	
Culvert Permit N	No.		Contractor's License BK	Number		Applicant/Ow JH	ner/Contra	ctor	
EXISTING Driveway Conne	ootion	08-0031 Septic Tank Number	-	Coning checked by	_	proved for Issu	ance	New Resident	
		NE FOOT ABOVE T		oning checked by	Ар	proved for issu	arice	THE RESIDENT	
COMMENTS.	· Book o								
					E	Check # or	Cash	1414	
		FOR BI	JILDING & ZOI	NING DEPAR	TMENT	ONLY		(footer/Slab)	
Temporary Power	er		Foundation		egas comment. And so the	Monolithic	;	(100101/3140)	
		date/app. by		date/app. by	,		9	date/app. by	
Under slab rough	h-in plumb	-	Sla			Sheathi	ng/Nailing		
Framing		date/ap		date/app		d floor		date/app. b	y
	date/app		Kougn-in piumoin	ig above slab and b	below woo			date/app. by	
Electrical rough	n-in		_ Heat & Air Duct			Peri. beam (L	intel)		
ъ .		date/app. by		date/app.	by		_	date/app. by	
Permanent power		te/app. by	C.O. Final	date/app. by		Culvert _	da	ite/app. by	_
M/H tie downs, b	blocking, el	ectricity and plumbing				Pool			
Reconnection			Pump pole	/app. by	Utility Po	le	date	e/app. by	
M/H Pole	d	late/app. by	avel Trailer	date/app. by		date/app Re-roof	, by		
	e/app. by	_	- Tranci	date/app. by	-	Re-1001	date/	app. by	-
BUILDING PER	RMIT FEE S	0.00	CERTIFICATION	FEE \$ 0.00	0	SURCHAR	GE FEE \$	0.00	
MISC. FEES \$	250.00	N NOTE OF THE PARTY OF THE PART							
	350.00	ZONING	CERT. FEE \$ 50	0.00 FIRE FEI	E\$ 0.00	WA	STE FEE	\$	
FLOOD DEVELO			OOD ZONE FEE \$		E \$ <u>0.00</u>			\$ EE 425.00	_
INSPECTORS C	OPMENT		·	25.00 CULVE	-			-	_

NOTICE: IN ADDITION TO THE REQUIREMENTS OF THIS PERMIT, THERE MAY BE ADDITIONAL RESTRICTIONS APPLICABLE TO THIS PROPERTY THAT MAY BE FOUND IN THE PUBLIC RECORDS OF THIS COUNTY. AND THERE MAY BE ADDITIONAL PERMITS REQUIRED FROM OTHER GOVERNMENTAL ENTITIES SUCH AS WATER MANAGEMENT DISTRICTS, STATE AGENCIES, OR FEDERAL AGENCIES.

"WARNING TO OWNER: YOUR FAILURE TO RECORD A NOTICE OF COMMENCEMENT MAY RESULT IN YOUR PAYING TWICE FOR IMPROVEMENTS TO YOUR PROPERTY. IF YOU INTEND TO OBTAIN FINANCING, CONSULT WITH YOUR LENDER OR AN ATTORNEY BEFORE RECORDING YOUR NOTICE OF COMMENCEMENT."

EVERY PERMIT ISSUED SHALL BECOME INVALID UNLESS THE WORK AUTHORIZED BY SUCH PERMIT IS COMMENCED WITHIN 180 DAYS AFTER ITS ISSUANCE, OR IF THE WORK AUTHORIZED BY SUCH PERMIT IS SUSPENDED OR ABANDONED FOR A PERIOD OF 180 DAYS AFTER THE TIME THE WORK IS COMMENCED. A VALID PERMIT RECIEVES AN APPROVED INSPECTION EVERY 180 DAYS. WORK SHALL BE CONSIDERED TO BE IN ACTIVE PROGESS WHEN THE PERMIT HAS RECIEVED AN APPROVED INSPECTION WITHIN 180 DAYS.

The Issuance of this Permit Does Not Waive Compliance by Permittee with Deed Restrictions.

Columbia County Building Permit Application

	For Office Use Only Application # 0712-87 Date Received 12/21/07 By G Permit # 26441
	Zoning Official BLK Date 04.01,08 Flood Zone FEMA Map # WA Zoning A-3
	Land Use A-B Elevation NA MFE and east River NA Plans Examiner OK 57H Date 1-3-07
	Comments Existing MH to be removed within 45 days of CO being is swed
	NOC EH Deed or PA Site Plan State Road Info Parent Parcel #
	□ Dev Permit # □ In Floodway □ Letter of Authorization from Contractor
	□ Unincorporated area □ Incorporated area □ Town of Fort White □ Town of Fort White Compliance letter
	Septic Permit No. 08-003/ Fax 386-752-2571
	Name Authorized Person Signing Permit WILLIAM L. HARPER Phone 386-623-3873
	Address 119 Switobby PL, LAKECITY, FL. 32024
	Owners Name RANDY AND KELLY BRIGGS Phone 386-754-3883
	911 Address 388 S.W. RAMON CT., LAKE CITY, FL. 32024
	Contractors Name WILLIAM L. HARPER Phone 386-623-3873
	Address 119 SW HOBBY PL. LAKE CITY, FL. 32024
	Fee Simple Owner Name & Address
	Bonding Co. Name & Address
	Architect/Engineer Name & Address CURTIS KEEN 9263 CR. 417 LIVE OAK FL. 32060
	Mortgage Lenders Name & Address CTY MORTAGE INC. 1000 TECHNOLOGY OR. O'FALLON, MO
	Circle the correct power company - FL Power & Light - Clay Elec Suwannee Valley Elec Progress Energy
	Property ID Number 18-45-16-03054-103 HX Estimated Cost of Construction \$100,000,00
	Subdivision Name Thistleden Subdivision (unrec.) Lot C Block Unit Phase
	Driving Directions GO HWY. 90 WEST TO HWY 252 (PINEMOUNT), GO LEFT, GO HWY.
ß	252 TO BARWICK, GO WEFT, GO BARWICK TO BRIM, GO RIGHT GO RIM TO RAMON CT., GO LEFT, EORAMON CT. TO PROFERRY ON RIGHT (BOARD FENCE AND CEDAR Number of Existing Dwellings on Property 1
	Construction of ModuLAR Home Total Acreage 11.560 Lot Size
	Do you need a - <u>Culvert Permit</u> or <u>Culvert Waiver</u> or <u>Have an Existing Drive</u> Total Building Height
	Actual Distance of Structure from Property Lines - Front 250' Side 375' Side 375' Rear 325'
	Number of Stories Heated Floor Area 1546 Total Floor Area 1546 Roof Pitch 8/12
	Application is hereby made to obtain a permit to do work and installations as indicated. I certify that no work or installation has commenced prior to the issuance of a permit and that all work be performed to meet the standards of all laws regulating construction in this jurisdiction.
	of all laws regulating construction in this jurisdiction. Spoke 46 Bill 1/8/08 Page 1 of 3 (Both Pages must be submitted together)
	Page 1 of 2 (Both Pages must be submitted together.) Revised 11-30-07

Revised 11-30-07

Page 1 of 2 (Both Pages must be submitted together.)

WARNING TO OWNER: YOUR FAILURE TO RECORD A NOTICE OF COMMENCMENT MAY RESULT IN YOU PAYING TWICE FOR IMPROVEMENTS TO YOUR PROPERTY. A NOTICE OF COMMENCEMENT MUST BE RECORDED AND POSTED ON THE JOB SITE BEFORE THE FIRST INSPECTION. IF YOU INTEND TO OBTAIN FINANCING, CONSULT WITH YOUR LENDER OR ATTORNEY BEFORE RECORDING YOUR NOTICE OF COMMENCEMENT.

FLORIDA'S CONSTRUCTION LIEN LAW: Protect Yourself and Your Investment

According to Florida Law, those who work on your property or provide materials, and are not paid-in-full, have a right to enforce their claim for payment against your property. This claim is known as a construction lien. If your contractor fails to pay subcontractors or material suppliers or neglects to make other legally required payments, the people who are owed money may look to your property for payment, even if you have paid your contractor in full. This means if a lien is filed against your property, it could be sold against your will to pay for labor, materials or other services which your contractor may have failed to pay.

NOTICE OF RESPONSIBILITY TO BUILDING PERMITEE:

YOU ARE HEREBY NOTIFIED as the recipient of a building permit from Columbia County, Florida, you will be held responsible to the County for any damage to sidewalks and/or road curbs and gutters, concrete features and structures, together with damage to drainage facilities, removal of sod, major changes to lot grades that result in ponding of water, or other damage to roadway and other public infrastructure facilities caused by you or your contractor, subcontractors, agents or representatives in the construction and/or improvement of the building and lot for which this permit is issued. No certificate of occupancy will be issued until all corrective work to these public infrastructures and facilities has been corrected.

OWNERS CERTIFICATION: I hereby certify that all the foregoing information is accurate and all work will be done in compliance with all applicable laws and regulating construction and zoning. I further understand the above written responsibilities in Columbia County for obtaining this Building Permit.

CONTRACTORS AFFIDAVIT: By my signature I understand and agree that I have informed and provided this written statement to the owner of all the above written responsibilities in Columbia County for obtaining this Building Permit.

Contractor's Signature (Permitee)

Owners Signature

Contractor's License Number RR 282811402 Columbia County Competency Card Number 000258

Affirmed under penalty of perjury to by the Contractor and subscribed before me this 27 day of December 2007. Personally known____ or Produced Identification_DR. License

la K. Jonescu - adams

State of Florida Notary Signature (For the Contractor)

PAULA K IONESCU-ADAMS MY COMMISSION # DD605863 EXPIRES: Oct. 16, 2010 (407) 398-0153 Florida Notary Service.com

Revised 11-30-07



STATE OF FLORIDA

DEPARTMENT OF HEALTH

APPLICATION FOR ONSITE SEWAGE DISPOSAL SYSTEM CONSTRUCTION PERMIT

Permit Application Number 08-003)

Scale: Each block represents	5 feet and 1 inch = 50 feet.	Property Springers of the Springers	A STATE OF THE STA	
666				
HILLIAN 1&				
51.8	710'	210'		· · · · · · · · · · · · · · · · · · ·
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				- 11
Site Plan submitted by:	CVILLETON L. HE	ARPER nature		CONTRACTOR
Plan Approved X				Date_//9/2008
Volan III	Columbia	CHO APP	HUVED	7./
By P				County Health Departmen

Inst. Number: 200712023193 Book: 1133 Page: 1576 Date: 10/15/2007 Time: 3:28:00 PM Page 1 of 2

103/12/200	7 00.94	TAT	010	079	0510

CITIMORTGAGE

Ø003/009

S Allies	Permit No		Tan Follo No.
5		NOTIC	GE OF COMMENCEMENT
2	State of F	orida	Date: 10/15/2007 Time: 3:28 PM DC,P.DeWitt Cason,Columbia County Page 1 of 2
			rovement will be made to certain real property, and in accordance ing information is provided in this Notice of Commencement.
	I.	Description of property:	SEE ATTACHED EXHIBIT "A"
	. 2.	General description of improve	wencet New Construction
	3.	Owace information: a. Name and address:	Single Family Residence Randy and Kelly Briggs
		b. Interest in property: c. Name and address of fe	388 SW Ramon Court Lake City, FL 3202
	4.		Safe Harbor Homes, Inc.
		a. Phone Number:	Take City, FL 32055 (386) 758-9433
	5.	Surety: a. Name and address:	
,		b. Phone Number: c. Amount of bond:	
	6.	Lunder (name and address):	CitiMortgage c/o Granite Loan Management, LLC 10770 E. Briarwood Ave. Suite 280, Centennial, CO 80112
	7.		rida designated by Owner upon whom notices or other royided by Section 713.13(1)(a)7., Florida Statutes:
	8.	In addition to himself or hersel 18770 E. Briarwood Ave. Sui	f, Owner designates Granite Lonn Management, LLC of te 280, Centennial, CO 80012 to receive a copy of Lienor's
		Notice as provided in Section 2 a. Phone Number:	
Challe - 5	9.	Expiration date 3 years from the	Mand Sous Kelly Briggs
State of	Swom to (or a	firmed) and subscribed before a a making statement) Roy de	no this 4 M day of Ord 2007 by
Γ	A Com	THA BRYAN mission DD 675924 res August 10, 2011 1 Truy Tray Fam Insurance 800-385-7019	(Signature of Notary Public State of Florida) Merthe Bryen
1	Bonds) vite titel	(Print, Type, or Stamp Commissioned Name of Notsry Public)

Type of Identification Produced Driver's License

Inst. Number: 200712023193 Book: 1133 Page: 1577 Date: 10/15/2007 Time: 3:28:00 PM Page 2 of 2

EXHIBIT "A"

PARCEL "C", THISTLEDEW SUBDIVISION (UNPLATTED), DESCRIBED AS FOLLOWS:

A PART OF THE E ½ OF THE NE ¼, SECTION 18, TOWNSHIP 4 SOUTH, RANGE 16 EAST, MORE PARTICULARLY DESCRIBED AS FOLLOWS:

COMMENCE AT THE NW CORNER OF THE NE ¼ OF THE NE ¼ AND RUN S 1°41'53" E, ALONG THE WEST LINE OF SAID E ½ OF THE NE ¼, 1342.76 FEET TO THE POINT OF BEGINNING; THENCE CONTINUE S 1°41'53" E, 730.66 FEET; THENCE N 87°45'29" E, 616.47 FEET; THENCE N 84°24'05" E, 83.06 FEET; THENCE N 1°54'47" W, 707.74 FEET; THENCE S 89°14'27" W, 696.75 FEET TO THE POINT OF BEGINNING, COLUMBIA COUNTY, FLORIDA.

SUBJECT TO AN EASEMENT FOR INGRESS AND EGRESS OVER AND ACROSS THE EAST 30 FEET THEREOF.

ALSO:

THE RIGHT OF INGRESS AND EGRESS OVER AND ACROSS A 60 FOOT EASEMENT LYING 30 FEET TO THE RIGHT AND 30 FEET TO THE LEFT OF THE FOLLOWING DESCRIBED CENTERLINE:

COMMENCE AT THE NW CORNER OF THE E ½ OF SAID NE ¼ AND RUN S 1°41'53" E, 25 FEET TO THE SOUTH MAINTAINED RIGHT-OF-WAY OF THOMPKINS ROAD; THENCE N 89°14'22" E, 691.80 FEET ALONG SAID RIGHT-OF-WAY FOR A POINT OF BEGINNING OF THE CENTERLINE OF SAID EASEMENT; THENCE S 1°54'47" E ALONG SAID CENTERLINE 2026.0 FEET TO THE POINT OF TERMINATION OF SAID EASEMENT.

02044611 ADVANCE HOMESTEAD TITLE, INC. WARRANTY DEED

THIS INSTRUMENT WAS PREPARED INCIDENTAL TO THE WRITING OF A TITLE INSURANCE POLICY BY AND RETURN TO: PATRICIA L. SWEET

ADVANCI, HOMESTEAD TITLE 100 SW 75TH STREET, STE. 3 GAINESVILLE, FLORIDA 32607

Property Appraisers Parcel I.D. (Folio) Number(s):

03054-103

Inst: 2003001821 Date: 01/30/2003 Time: 11:00

(FROM CORPORATION)

Doc Stamp-Deed : 0.70 YNCK DC, P. DeWitt Cason, Columbia County B: 973 P:793

Granteets) S.S.#(s):

SPACE ABOVE THIS LINE FOR PROCESSING DATA

SPACE ABOVE THIS LINE FOR RECORDING DATA

. :

This Warranty Deed Made and executed the 13TH day of JANUARY M. G. MECHANICAL CONTRACTORS, INC. A. D. 2003by

a corporation existing under the laws of FLORIDA business at Rt. 13, Box 418, Lake City, FL 32055-9003 and having its principal place of hereinafter called the grantor, to RANDY BRIGGS and KELLY M. BRIGGS, f/k/a KELLY BACH, husband and wife whose postoffice address is ROUTE 11 BOX 394-25 LAKE CITY, FL 32024 hereinafter called the grantee:

the growth. (Wherever used herein the terms "grantor" and "grantee" include all the parties to this instrument and slie heirs, legal representatives and assigns of individuals, and the successors and assigns of corporations)

Witnesseth: That the grantor, for and in consideration of the sum of \$10.00 and other valuable considerations, receipt whereof is hereby acknowledged, by these presents does grant, bargain, sell, alien, remise, release, convey and confirm unto the county, Florida, vi::

SEE EXHIBIT "A" ATTACHED HERETO AND MADE A PART HEREOF.

Together with all the tenements, hereditaments and appurtenances thereto belonging or in anywise appertaining. To Have and to Hold, the same in fee simple forever.

All the grantor hereby covenants with said grantee that it is lawfully seized of said land in fee simple, that it has good right and lawful authority to sell and convey said land; that it hereby fully warrants the title to said land and will defend the same against the lawful claims of all persons whomsoever; and that soid land is free of all encumbrances, except laxes accruing subsequent to December 31, 2002, restrictions, reservations, covenants and easements of record, if any.

(Corporate Seal)

ATTEST:

In Witness Whereof, the gruntor has caused these presents to he executed in its name, and its corporate seal to be hereunto affixed, by its proper officers thereunto duty authorized, the day and year first above written.

Signed, sealed and delivered in our presence: Elyse N.1. By Witness Signature Elyse M. F.C., de-	INC.	Traje.	Killy	RESIDENT
Printed Name fell subles		Printed 1		
Witness Signature Kathy M. Blake				
Printed Name				
STATE OF FLORIDA				
COUNTY OF ALACHUA				
The foregoing instrument was acknowledged before me this 2003. by TERRY M. KELLY, President of	1377	day of	JANUARY	
M. G. MECHANICAL CONTR	Flor	ida		
on behalf of the corporation. He/she is personally known to me or he as identification and did not take an oath	as produced _	a di	iver's Hoenes	Corporation,



Kathy M. Blake Printed Notary Signature

My Commission Expires:

EXHIBIT "A"

Parcel "C", THISTLEDEW SUBDIVISION (Unplatted), described as follows:

A part of the E 1/2 of the NE 1/4, Section 18, Township 4 South, Range 16 East, more particularly described as follows:

Commence at the NW corner of the NE 1/4 of the NE 1/4 and run S.1°41′53″E. along the West line of said E 1/2 of the NE 1/4, 1342.76 feet to the Point of Beginning; thence continue S.1°41′53″E., 730.66 feet; thence N.87°45′29″E., 616.47 feet; thence N.84°24′05″E., 83.06 feet; thence N.1°54′47″W., 707.74 feet; thence S.89°14′27″W., 696.75 feet to the Point of Beginning, Columbia County, Florida.

Subject to an easement for ingress and egress over and across the Eat 30 feet thereof.

ALSO:

er or or or

The right of ingress and egress over and across a 60 foot easement lying 30 feet to the right and 30 feet to the left of the following described centerline:

Commence at the NW corner of the E 1/2 of said NE 1/4 and run S.1°41′53″E., 25 feet to the South maintained right-of-way of Thompkins Road; thence N.89°14′22″E., 691.80 feet along said right-of-way for a Point of Beginning of the centerline of said easement; thence S.1°54′47″E. along said centerline 2026.0 feet to the Point of Termination of said easement.

Property is subject to a DECLARATION OF COVENANTS AND RESTRICTIONS recorded in the public records of Columbia County, Florida and subject to other restrictions, reservations and easements of record.

Inst:2003001821 Date:01/30/2003 Time:11:00
Doc Stamp-Deed: 0.70
pmck_DC,P.DeWitt Cason,Columbia County B:973 P:794

Columbia County Property Appraiser

DB Last Updated: 11/15/2007

Parcel: 18-4S-16-03054-103 HX

2008 Proposed Values

Tax Record

Property Card

Interactive GIS Map

Search Result: 5 of 6 Next >>

Print

Owner & Property Info

Owner's Name	BRIGGS RAND	OY &					
Site Address	RAMON						
Mailing Address	KELLY BACH BRIGGS 388 SW RAMON CT LAKE CITY, FL 32024						
Use Desc. (code)	IMPROVED A	IMPROVED A (005000)					
Neighborhood	18416.00	Tax District	3				
UD Codes	MKTA01	Market Area	01				
Total Land Area	11.560 ACRES	3					
Description	COMM NW COR OF NE1/4 OF NE1/4, RUN S 1342.76 FT FOR POB, CONT S 730.66 FT, E 616.47 FT, NE 83.06 FT, N 707.74 FT, W 696.75 FT TO POB. (AKA PRCL C THISTLEDEW S/D UNREC) ORB 840-1822, 973-793.						

<< Prev GIS Aerial



Property & Assessment Values

Mkt Land Value	cnt: (2)	\$16,040.00
Ag Land Value	cnt: (1)	\$2,344.00
Building Value	cnt: (1)	\$23,279.00
XFOB Value	cnt: (0)	\$0.00
Total Appraised Value		\$41,663.00

Just Value		\$113,239.00
Class Value		\$41,663.00
Assessed Value		\$36,455.00
Exempt Value	(code: HX)	\$25,000.00
Total Taxable Value		\$11,455.00

Sales History

Sale Date	Book/Page	Inst. Type	Sale Vimp	Sale Qual	Sale RCode	Sale Price
1/13/2003	973/793	WD	I	U	04	\$100.00
8/7/1997	840/1822	AD	V	U	01	\$29,900.00


Building Characteristics

Bldg Item	Bldg Desc	Year Blt	Ext. Walls	Heated S.F.	Actual S.F.	Bldg Value
1	MOBILE HME (000800)	1997	Vinyl Side (31)	924	924	\$23,279.00
	Note: All S.F. calculation	s are based	on exterior build	ling dimensions	S.	

Extra Features & Out Buildings

Code	Desc	Year Bit	Value	Units	Dims	Condition (% Good)
				NONE		

Land Breakdown

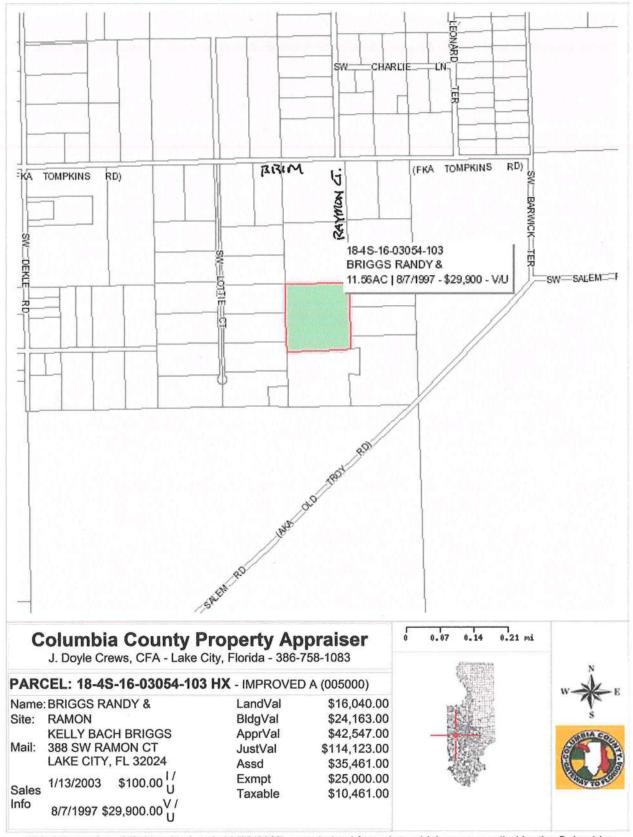

This information, GIS Map Updated: 10/22/2007, was derived from data which was compiled by the Columbia County Property Appraiser Office solely for the governmental purpose of property assessment. This information should not be relied upon by anyone as a determination of the ownership of property or market value. No warranties, expressed or implied, are provided for the accuracy of the data herein, it's use, or it's interpretation. Although it is periodically updated, this information may not reflect the data currently on file in the Property Appraiser's office. The assessed values are NOT certified values and therefore are subject to change before being finalized for ad valorem assessment purposes.



0712-87

FLORIDA ENERGY EFFICIENCY CODE FOR BUILDING CONSTRUCTION

Florida Department of Community Affairs
Residential Whole Building Performance Method A

1,651001	Ittal Whole Bullan	ig i chomanee me	
Project Name: M2866SS3200	96-140	Builder:	Modular One, LLC
Address:		Permitting Offi	ce:
City, State:		Permit Numbe	r:
Owner:		Jurisdiction Nu	mber:
Climate Zone: North			
			811 27 2 2 3 3 3 3 3 3 3 3 3 3 3 3 3 3 3 3
1. New construction or existing	New	12. Cooling systems	
Single family or multi-family	Single family	a. Central Unit	Cap: 48.0 kBtu/hr
3. Number of units, if multi-family	1		SEER: 13.00
Number of Bedrooms	3	b. N/A	_
5. Is this a worst case?	Yes	200000-11-28-	
 Conditioned floor area (ft²) 	1547 ft²	c. N/A	_
 Glass type 1 and area: (Label reqd. by 1 	3-104.4.5 if not default)	APPE	OVED BY -
a. U-factor:	Description Area	13. Heating systems	Commission of the Commission o
(or Single or Double DEFAULT) 7a.	(Dble, U=0.3) 197.3 ft ²	a. Electric Heat Pump	Cap: 48.0 kBtu/hr
b. SHGC:		DEC	C 7 - 2007 HSPF: 9.00 _
(or Clear or Tint DEFAULT) 7b.	·(SHGC=0.28) 197.3 ft ²	b. N/A	_
8. Floor types		- B	_
a. Raised Wood, Stem Wall	R=19.0, 1547.0ft ²	c. N/A	FINC =
b. N/A			INC
c. N/A	-	14. Hot water systems	
Wall types		a. Electric Resistance	Cap: 50.0 gallons
a. Frame, Wood, Exterior	R=13.0, 1266.7 ft ²	100	EF: 0.92
b. N/A		b. N/A	
c. N/A			 -
d. N/A		c. Conservation credits	
e. N/A	_	(HR-Heat recovery, Solar	
10. Ceiling types		DHP-Dedicated heat pump)
a. Under Attic	R=30.0, 1547.0 ft ²	15. HVAC credits	
b. N/A	_	(CF-Ceiling fan, CV-Cross	ventilation,
c. N/A		HF-Whole house fan,	
11. Ducts		PT-Programmable Thermo	stat,
a. Sup: Con. Ret: Con. AH: Interior	Sup. R=6.5, 144.0 ft	MZ-C-Multizone cooling,	
b. N/A	3	MZ-H-Multizone heating)	
	District Co.	Total a	
Glass/Floor Area: 0	Total as-built p		PASS
Glass/Floor Area. C	Total base p	oints: 22595	700

I hereby certify that the plans and specifications covered by this calculation are in compliance with the Florida Energy Code.

PREPARED BY:

DATE:

I hereby certify that this building, as designed, is in compliance with the Florida Energy Code.

OWNER/AGENT: _____

DATE:

Review of the plans and specifications covered by this calculation indicates compliance with the Florida Energy Code. Before construction is completed this building will be inspected for compliance with Section 553.908

BUILDING OFFICIAL: (DATE: 12/07/2007

Florida Statutes.

lix h. There are

1 Predominant glass type. For actual glass type and areas, see Summer & Winter Glass output on pages 2&4. EnergyGauge® (Version: FLRCSB v4.5.2)

PLAN #MFT-5308-M2866 SS 320096

SUMMER CALCULATIONS

Residential Whole Building Performance Method A - Details

the state of the s	
ADDRESS: , , ,	PERMIT #:
ADDITIOO. 111	

BASE		AS-BUILT	
GLASS TYPES .18 X Conditioned X BSPM = Points Floor Area		overhang nt Len Hgt Area X SPM X SOF	= Points
.18 1547.0 18.59 5177.	1.Double,U=0.35,SHGC=0.28	W 1.0 7.3 60.0 15.55 0.99	919.0
	2.Double,U=0.35,SHGC=0.28	E 1.0 7.3 60.0 17.03 0.99	1006.0
	3,Double,U=0.35,SHGC=0.28	E 1.0 5.3 9.0 17.03 0.96	146.0
	4.Double,U=0.35,SHGC=0.28	S 9.0 9.0 40.0 14.43 0.52 S 9.0 7.3 15.0 14.43 0.49	300.0 106.0
	5.Double,U=0.35,SHGC=0.28		225.0
	6.Double,U=0.35,SHGC=0.28	E 1.0 9.0 13.3 17.03 0.99	225.0
	As-Built Total:	197.3	2702.0
WALL TYPES Area X BSPM = Po	s Type	R-Value Area X SPM =	Points
Adjacent 0.0 0.00	0 1. Frame, Wood, Exterior	13.0 1266.7 1.50	1900.0
Exterior 1266.7 1.70 21			
	1		
Base Total: 1266.7 21	4 As-Built Total:	1266.7	1900.0
DOOR TYPES Area X BSPM = Po	s Туре	Area X SPM =	Points
Adjacent 0.0 0.00	.0 1.Exterior Wood	60.0 6.10	366.2
,	2		
EXISTS SOLUTION			
Base Total: 60.0 3	2 As-Built Total:	60.0	366.2
CEILING TYPES Area X BSPM = Po	туре	R-Value Area X SPM X SCM =	Points
Under Attic 1547.0 1.73 26	.3 1. Under Attic	30.0 1547.0 1.73 X 1.00	2676.3
Base Total: 1547.0 26	.3 As-Built Total:	1547.0	2676.3
FLOOR TYPES Area X BSPM = Po		R-Value Area X SPM =	Points
		19.0 1547.0 -1.50	-2320.5
Slab 0.0(p) 0.0	.0 1. Raised Wood, Stem Wall	10.0 10-11.0 -1100	_52510
Raised 1547.0 -3.99 -61	.5		
Base Total: -61	.5 As-Built Total:	1547.0	-2320.5
INFILTRATION Area X BSPM = Po	ts	Area X SPM =	Points
	Contract the first of the first		



SUMMER CALCULATIONS

Residential Whole Building Performance Method A - Details

ADDRESS:,,, PERMIT #:

	BASE		AS-BUILT				
Summer Ba	se Points: ′	19995.2	Summer As-Built Points:	21118.9			
Total Summer Points	X System Multiplier	= Cooling Points	Total X Cap X Duct X System X Credit Component Ratio Multiplier Multiplier Multiplier Multiplier (System - Points) (DM x DSM x AHU)	= Cooling Points			
19995.2	0.3250	6498.4	(sys 1: Central Unit 48000btuh ,SEER/EFF(13.0) Ducts:Con(S),Con(R),Int(AH),R6.5(21119 1.00 (1.00 x 1.147 x 0.91) 0.260 1.000 21118.9 1.00 1.044 0.260 1.000	5731.3 5731.3			

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WINTER CALCULATIONS

Residential Whole Building Performance Method A - Details

ADDRESS:,,,	PERMIT #:

	BASE					AS-	BUI	LT				
GLASS TYPES .18 X Conditio Floor Ar	ned X B	WPM =	Points	Type/SC	Ove Ornt	rhang Len	Hgt	Area X	WF	PM >	(W	OF = Points
.18 1547	.0	20.17	5617.0	1.Double,U=0.35,SHGC=0.28 2.Double,U=0.35,SHGC=0.28 3.Double,U=0.35,SHGC=0.28 4.Double,U=0.35,SHGC=0.28 5.Double,U=0.35,SHGC=0.28 6.Double,U=0.35,SHGC=0.28	E E S	1.0 1.0 9.0 9.0	7.3 7.3 5.3 9.0 7.3 9.0	60.0 60.0 9.0 40.0 15.0 13.3		9.89 9.12 9.12 6.72 6.72 9.12	1.0 1.0 1.0 2.7 3.0 1.0	553.0 83.0 733.0 7309.0
WALL TYPES	Area X	BWPM	= Points	As-Built Total: Type		R-\	/alue	197.3 Area	Х	WP	M	2395.0 = Points
Adjacent Exterior	0.0 1266.7	0.00 3.70	0.0 4686.8	1, Frame, Wood, Exterior		•	13.0	1266.7		3.40)	4306.8
Base Total:	1266.7	-	4686.8	As-Built Total:				1266.7				4306.8
DOOR TYPES	Area X	BWPM	= Points	Туре				Area	х	WP	M :	Points
Adjacent Exterior	0.0 60.0	0.00 12.30	0.0 738.4	1.Exterior Wood				60.0		12.30)	738.4
Base Total:	60.0		738.4	As-Built Total:				60.0				738.4
CEILING TYPES	S Area X	BWPM	= Points	Туре	R	-Value	Ar	ea X W	PM	ΧW	CM:	= Points
Under Attic	1547.0	2.05	3171.3	1. Under Attic			30.0	1547.0	2.05	X 1.00)	3171.3
Base Total:	1547.0		3171.3	As-Built Total:			HI Par	1547.0				3171.3
FLOOR TYPES	Area X	BWPM	= Points	Туре		R-V	/alue	Area	X	WP	M :	Points
Slab Raised	0.0(p) 1547.0	0.0 0.96	0.0 1485.1	1. Raised Wood, Stem Wall			19.0	1547.0		0.80)	1237.6
Base Total:			1485.1	As-Built Total:				1547.0				1237.6
INFILTRATION	Area X	BWPM	= Points					Area	Х	WP	M :	= Points
	1547.0	-0.59	-912.7					1547.	0	-0.5	59	-912.7

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WINTER CALCULATIONS

Residential Whole Building Performance Method A - Details

ADDRESS: , , , PERMIT #:

	BASE		AS-BUILT							
Winter Base	Points:	14785.9	Winter As-Built Points:	10936.4						
Total Winter X Points	System = Multiplier	Heating Points	Total X Cap X Duct X System X Credit = Component Ratio Multiplier Multiplier Multiplier (System - Points) (DM x DSM x AHU)	Heating Points						
14785.9	0.5540	8191.4	(sys 1: Electric Heat Pump 48000 btuh ,EFF(9.0) Ducts:Con(S),Con(R),Int(AF 10936.4 1.000 (1.000 x 1.169 x 0.93) 0.379 1.000 10936.4 1.00 1.087 0.379 1.000	4504.9 4504.9						

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WATER HEATING & CODE COMPLIANCE STATUS

Residential Whole Building Performance Method A - Details

ADDRESS: , , , PERMIT #:

BASE					AS-BUILT							
WATER HEA Number of Bedrooms	X	Multiplier	=	Total	Tank Volume	EF	Number of Bedrooms	X	Tank X Ratio	Multiplier	X Credit Multiplie	
3		2635.00		7905.0	50.0	0.92	3		1.00	2635.00	1.00	7905.0
					As-Built To	otal:						7905.0

		4		CODE	C	OMPLI	ANCE	S	TATUS	3			
		BAS	ŝΕ							AS	-BUILT		
Cooling Points	+	Heating Points	+	Hot Water Points	F	Total Points	Cooling Points	+	Heating Points	+	Hot Water Points	=	Total Points
6498		8191		7905		22595	5731		4505		7905		18141

PASS



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Code Compliance Checklist

Residential Whole Building Performance Method A - Details

ADDRESS: ,,, PERMIT #:

6A-21 INFILTRATION REDUCTION COMPLIANCE CHECKLIST

COMPONENTS	SECTION	REQUIREMENTS FOR EACH PRACTICE	CHECK
Exterior Windows & Doors	606.1.ABC.1.1	Maximum:.3 cfm/sq.ft. window area; .5 cfm/sq.ft. door area.	
Exterior & Adjacent Walls	606.1.ABC.1.2.1	Caulk, gasket, weatherstrip or seal between: windows/doors & frames, surrounding wall; foundation & wall sole or sill plate; joints between exterior wall panels at corners; utility penetrations; between wall panels & top/bottom plates; between walls and floor. EXCEPTION: Frame walls where a continuous infiltration barrier is installed that extends from, and is sealed to, the foundation to the top plate.	
Floors	606.1.ABC.1.2.2	Penetrations/openings >1/8" sealed unless backed by truss or joint members. EXCEPTION: Frame floors where a continuous infiltration barrier is installed that is sealed to the perimeter, penetrations and seams.	
Ceilings	606.1.ABC.1.2.3	Between walls & ceilings; penetrations of ceiling plane of top floor; around shafts, chases, soffits, chimneys, cabinets sealed to continuous air barrier; gaps in gyp board & top plate; attic access. EXCEPTION: Frame ceilings where a continuous infiltration barrier is installed that is sealed at the perimeter, at penetrations and seams.	
Recessed Lighting Fixtures	606.1.ABC.1.2.4	Type IC rated with no penetrations, sealed; or Type IC or non-IC rated, installed inside a sealed box with 1/2" clearance & 3" from insulation; or Type IC rated with < 2.0 cfm from conditioned space, tested.	
Multi-story Houses	606.1.ABC.1.2.5	Air barrier on perimeter of floor cavity between floors.	
Additional Infiltration reqts	606.1.ABC.1.3	Exhaust fans vented to outdoors, dampers; combustion space heaters comply with NFPA, have combustion air.	

6A-22 OTHER PRESCRIPTIVE MEASURES (must be met or exceeded by all residences.)

COMPONENTS	SECTION	REQUIREMENTS	CHECK
Water Heaters	612.1	Comply with efficiency requirements in Table 612.1.ABC.3.2. Switch or clearly marked cir breaker (electric) or cutoff (gas) must be provided. External or built-in heat trap required.	
Swimming Pools & Spas	612.1	Spas & heated pools must have covers (except solar heated). Non-commercial pools must have a pump timer. Gas spa & pool heaters must have a minimum thermal efficiency of 78%.	
Shower heads	612.1	Water flow must be restricted to no more than 2.5 gallons per minute at 80 PSIG.	
Air Distribution Systems	610.1	All ducts, fittings, mechanical equipment and plenum chambers shall be mechanically attached, sealed, insulated, and installed in accordance with the criteria of Section 610. Ducts in unconditioned attics: R-6 min. insulation.	
HVAC Controls	607.1	Separate readily accessible manual or automatic thermostat for each system.	
Insulation	604.1, 602.1	Ceilings-Min. R-19. Common walls-Frame R-11 or CBS R-3 both sides. Common ceiling & floors R-11.	

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ENERGY PERFORMANCE LEVEL (EPL) DISPLAY CARD

ESTIMATED ENERGY PERFORMANCE SCORE* = 88.4

The higher the score, the more efficient the home.

1111

New construction or existing Single family or multi-family	New Single family	-1100	Cooling syst		Cap: 48.0 kBtu/hr	
3. Number of units, if multi-family	Single family		. Comitai omi	<u> </u>	SEER: 13.00	_
4. Number of Bedrooms	3		. N/A		DA-111 15100	
5. Is this a worst case?	Yes					_
The second secon	1547 ft²		. N/A	APPROVED BY	V	
			. INCA	HI I HICHLD D	1	-
40(A)		12	Heating syst	ana a		
a. U-factor:	Description Area	13.	Floatric Use	t PumDEC 7 - 2007	Cap: 48.0 kBtu/hr	
(or Single or Double DEFAULT)	/a. (Dble, U=0.3) 197.3 ft ²		. Electric riea	ii Fullipio 1 2007	HSPF: 9.00	_
b. SHGC:	-	3	NUA	Marie	H3FF, 9.00	-
(or Clear or Tint DEFAULT)	7b. (SHGC=0.28) 197.3 ft ²	(. N/A	NHINC.		-
8. Floor types	D 400 114 000		27/4			-
a. Raised Wood, Stem Wall	R=19.0, 1547.0ft ²		. N/A	H ABBUN MILAC		_
b. N/A		-				
c. N/A		-	Hot water sy		C 100 II	
Wall types		a	. Electric Resi	istance	Cap: 50.0 gallons	
a. Frame, Wood, Exterior	R=13.0, 1266.7 ft ²				EF: 0.92	
b. N/A		ł	. N/A			_
c. N/A						_
d. N/A		_ (. Conservation			_
e. N/A				covery, Solar		
Ceiling types				ated heat pump)		
a. Under Attic	R=30.0, 1547.0 ft ²	15.	HVAC credi			
b. N/A			(CF-Ceiling	fan, CV-Cross ventilation,		
c. N/A			HF-Whole h			
11. Ducts			PT-Program	nmable Thermostat,		
a. Sup: Con. Ret: Con. AH: Interior	Sup. R=6.5, 144.0 ft	-	MZ-C-Mult	tizone cooling,		
b. N/A		Section 1	MZ-H-Mult	tizone heating)		
ans. or 4 year 200		Section 1				
I certify that this home has compli-	ed with the Florida Energy	Efficienc	y Code For l	Building	THE STA	
Construction through the above en	ergy saving features which	h will be in	stalled (or e	exceeded)	NO TO	M
in this home before final inspection	n. Otherwise, a new EPL I	Display Ca	rd will be co	ompleted		1
based on installed Code compliant				(#S)	Z mind was	12
		Date				5
Builder Signature:		Date.				
Address of New Home:		City/FL 2	Zip:		GOD WE TRUST	9"

*NOTE: The home's estimated energy performance score is only available through the FLA/RES computer program. This is <u>not</u> a Building Energy Rating. If your score is 80 or greater (or 86 for a US EPA/DOE EnergyStarTM designation), your home may qualify for energy efficiency mortgage (EEM) incentives if you obtain a Florida Energy Gauge Rating. Contact the Energy Gauge Hotline at 321/638-1492 or see the Energy Gauge web site at www.fsec.ucf.edu for information and a list of certified Raters. For information about Florida's Energy Efficiency Code For Building Construction, contact the Department of Community Affairs at 850/487-1824.

1 Predominant glass type. For actual glass type and areas, see Summer & Winter Glass output on pages 2&4. EnergyGauge® (Version: FLRCSB v4.5.2)



COLUMBIA COUNTY, FLORIDA

Department of Building and Zoning Inspection

This Certificate of Occupancy is issued to the below named permit holder for the building and premises at the below named location, and certifies that the work has been completed in accordance with the Columbia County Building Code.

Building permit No. 000026641

97.68

Fire:

Waste: 134.00

Parcel Number 18-4S-16-03054-103

Use Classification MODULAR, UTILITY

Permit Holder WILLIAM HARPER

Owner of Building RANDY & KELLY BRIGGS

231.68


Total:

388 SW RAMON COURT, LAKE CITY, FL 32024 Location:

Date: 02/22/2008

Building Inspector

POST IN A CONSPICUOUS PLACE (Business Places Only)

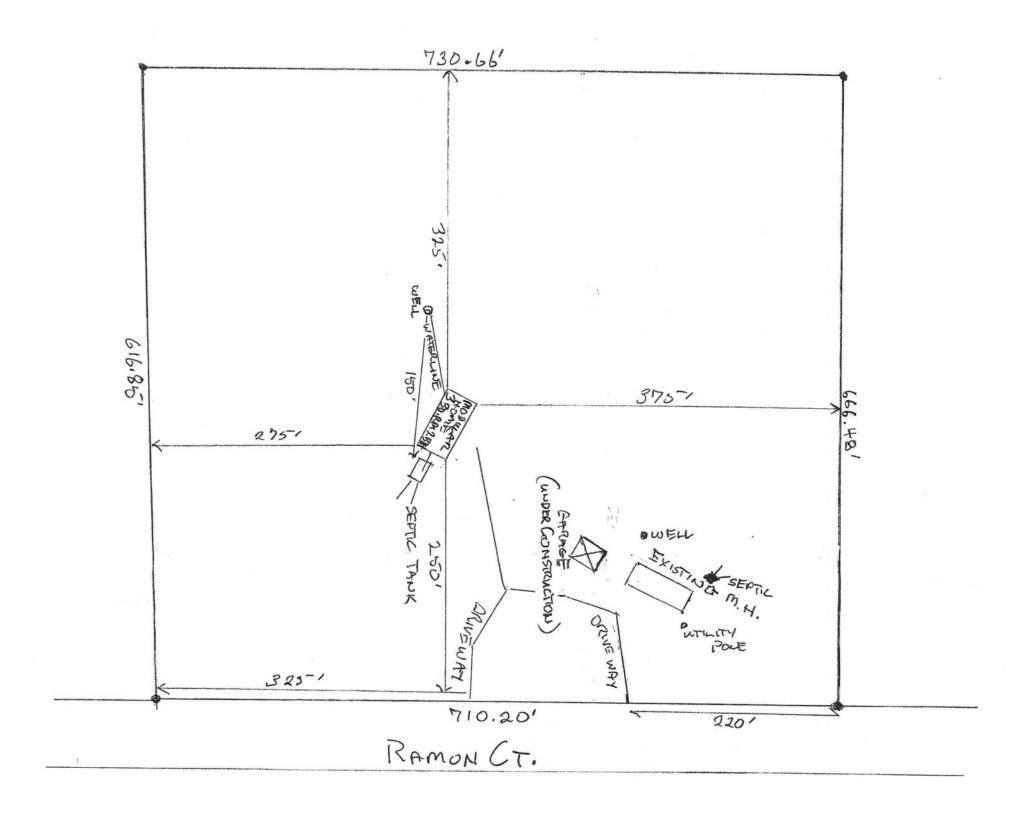


MOVED OF FORE WILL BE MOVED OF FORESTY AND SECTION TANK CRUSTED


SCALE 1" = 100"


CONTRACTOR! WICH IOM L. HARTER

SITE TO

2

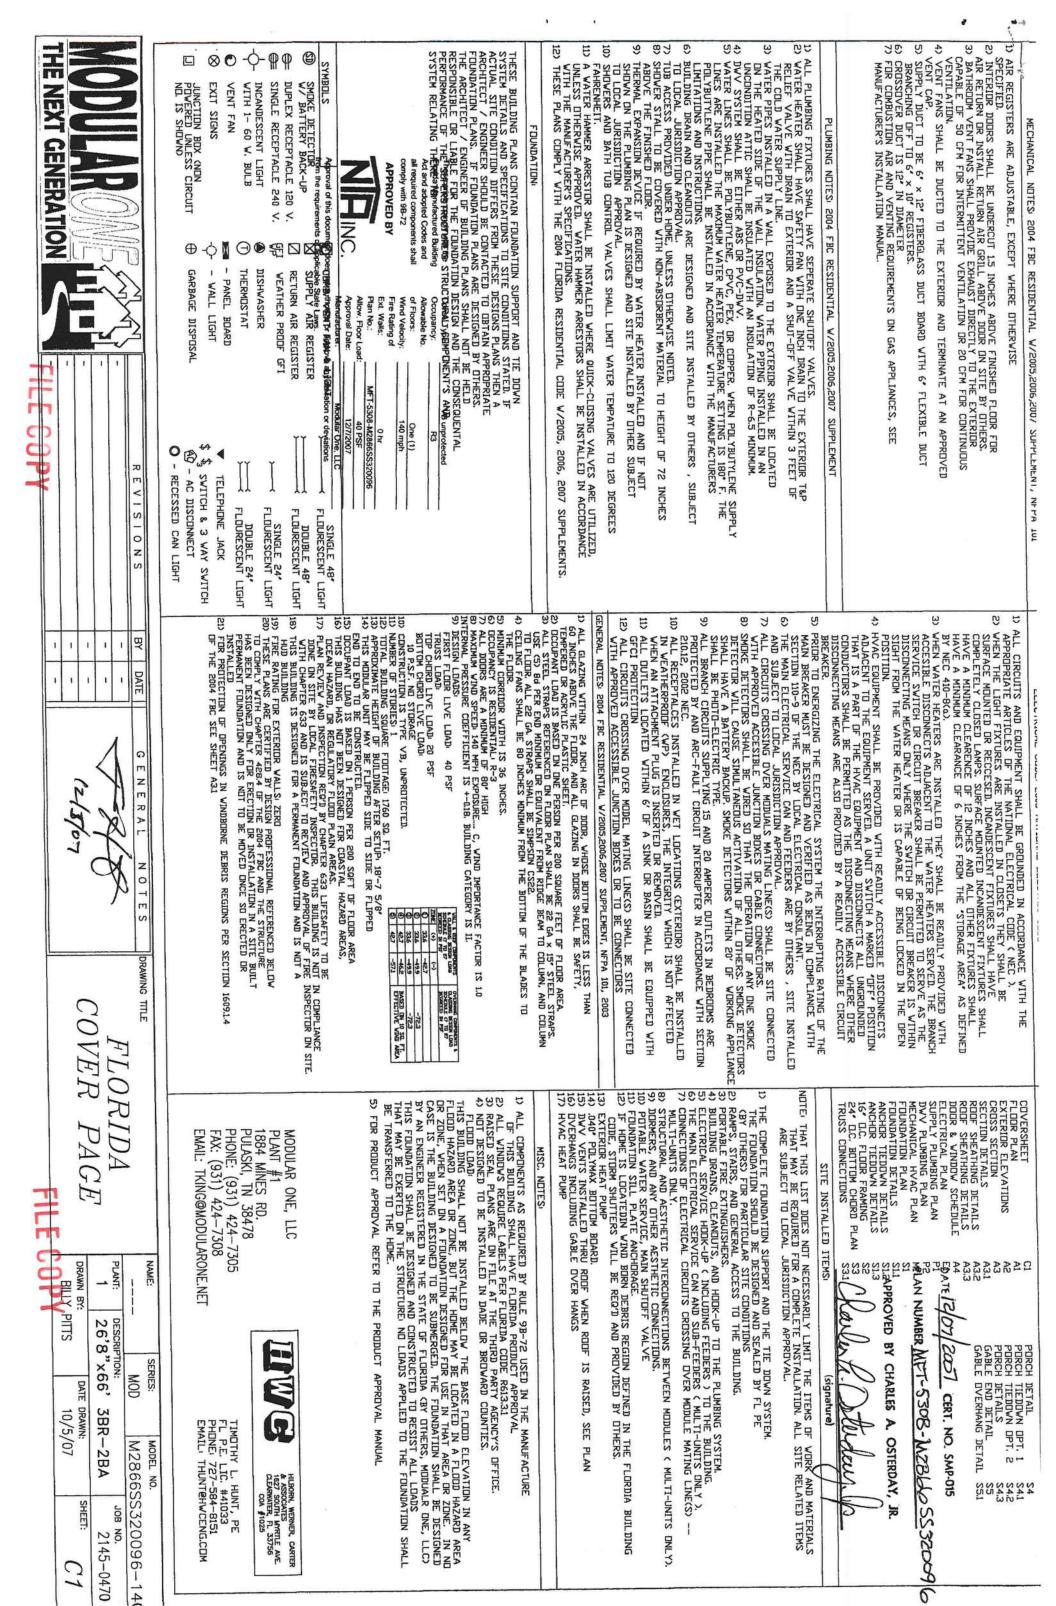

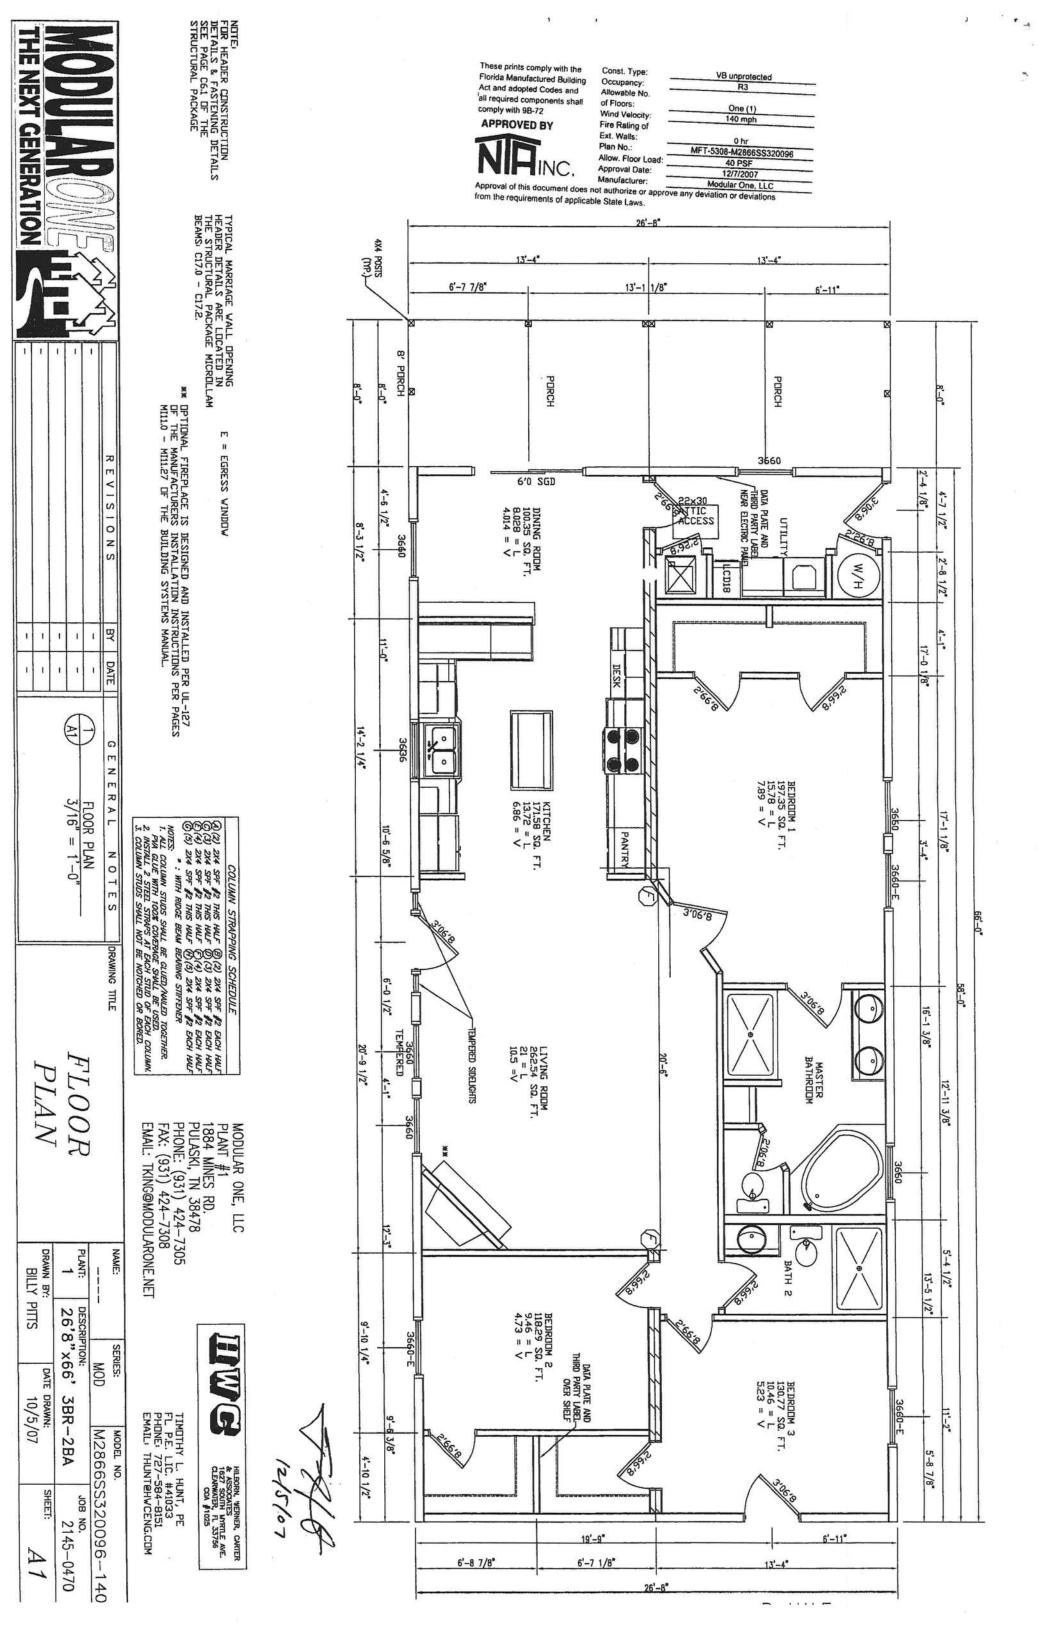

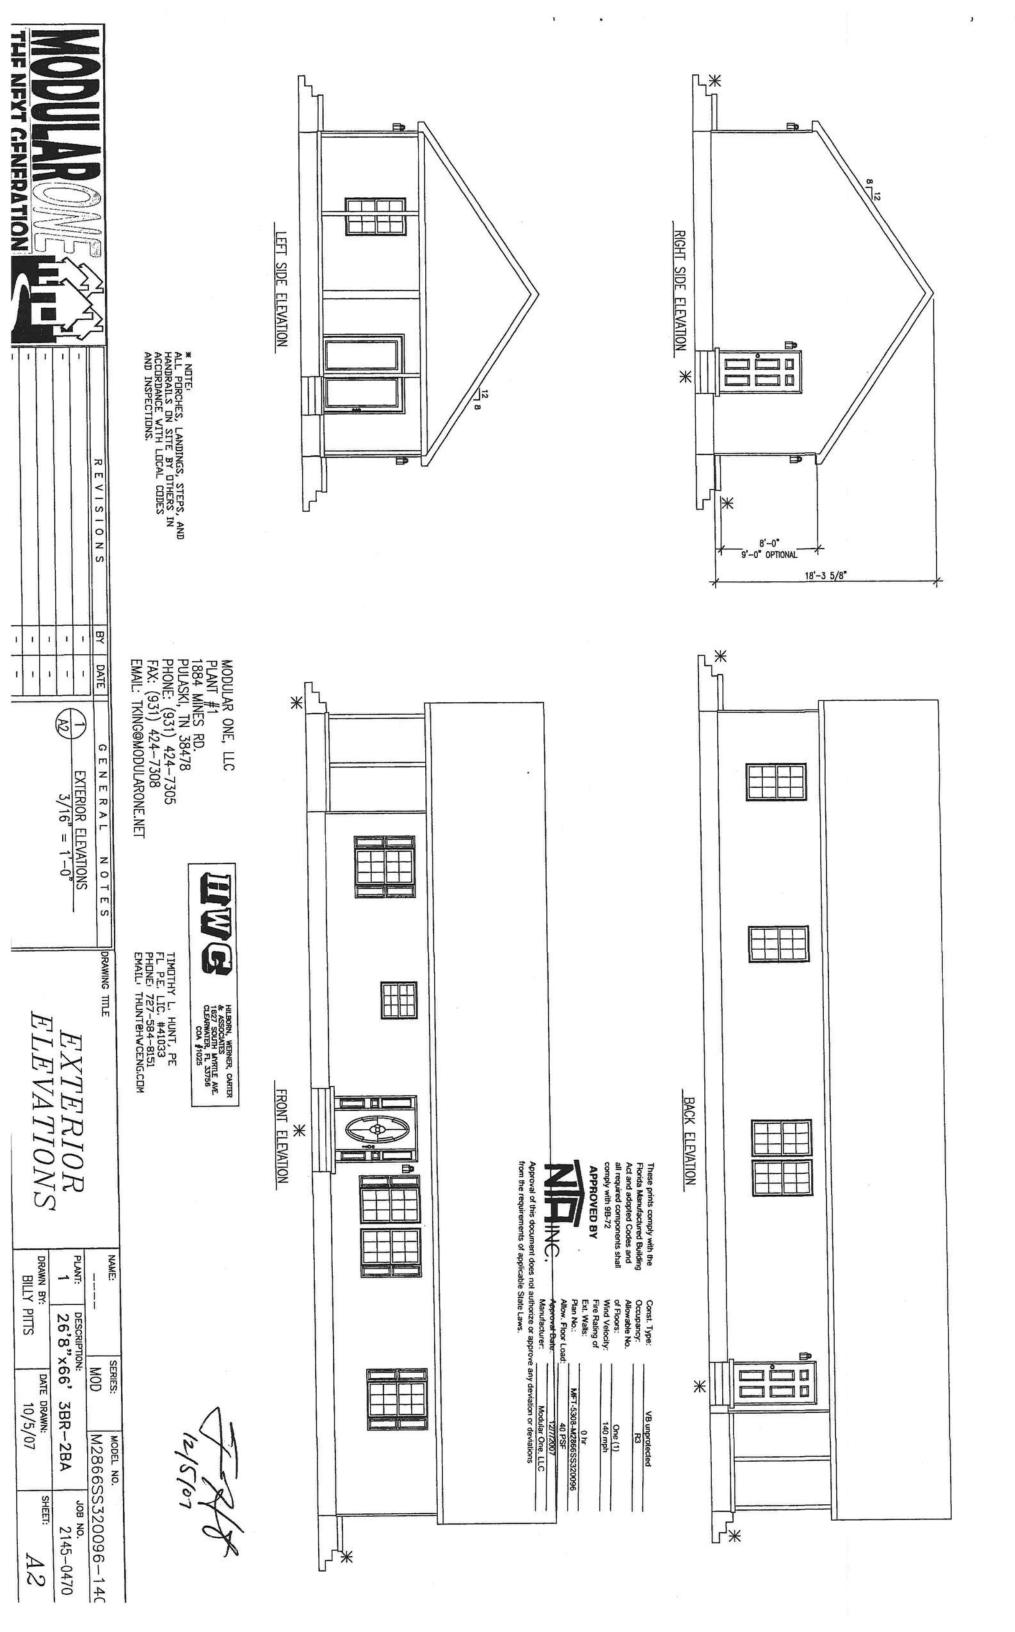

ATTIC *VENT REQ'D 1740 2.59 AREA SQFT SOF MAX LENGTH *ROOF VENT 3.63 58 FINS 口

*PER MODULE

PLANT #1 1884 MINES RD. PULASKI, TN 38478 PHONE: (931) 424-7305 FAX: (931) 424-7308 EMAIL: TKING@MODULARONE.NET MODULAR ONE, LLC

HILBORN, WERNER, CARTER & ASSOCIATES
1627 SOUTH MYRTLE AVE.
CLEARWATER, FL 33756
COA \$1025

1 LAYER(S) 1 1/2" X 18" MICROLLAM LVL 2.0 SP BEAM EACH MODULE CONTINUOUS OVER OPEN SPANS.

1 LAYER(S) 1 1/2" X 14" MICROLLAM LVL 2.0 SP BEAM EACH MODULE CONTINUOUS OVER PORCH

RIDGE

BEAM CONSTRUCTION

TIMOTHY L. HUNT, PE FL P.E. LIC. #41033 PHONE: 727-584-8151 EMAIL: THUNT@HVCENG.COM

2"X6" SYP#3 TOP PLATE MIN. (2) FULL STUDS PER OPENING R-13 WALL INSULATION 76' STRUCTUREWOOD SHEATHING ALL EXTERIOR WALLS R-19 FLOOR INSULATION 2x6 CONT. FASCIA SPF #2 MIN. R-30 INSULATION W/KRAFTBACK 验 X 2% INDEX STRUCTUREWOOD ROOF DECKING #235 SHINGLES 15# FELT ROOF UNDERLAYMENT (ASTM D-226, TYPE II) 22 GA. × 1.5° STEEL STRAPS (SIMPSON CS22) AT BOTTOM FROM WALL STUD TO RIM JOIST @ EA. STUD 16° D.C. WITH (8) 8D NAILS PER STRAP END. CUT SO 10° IS ON STUD AND 10° ON JOIST (WRAP IF REQ'D) 2x4 STUDS 16'o.c. #2 JOISTS @ 16° D.C. SINGLE 2x4 BOTTOM PLATE SPF #2 DROP-IN A-FRAMES MAY REQUIRE SHIMS SPF $\left(\frac{2}{3.1}\right)$ (13.3) (34/OR 38 X3.1 FLOOR DECKING TO BE &OR FMIN, EXP 1-20" D.C. 4x8 T&G OR 48"x180" DECKING LONG DIMENSION PARALLEL W/JOIST SPAN PRDIECTIVE FLASHING

22 GA. X 1.5*

CSIMPSON CS22) FROM TOP

CHORD TO TOP CHORD AT EACH TRUSS

W/ (7) 8D NAILS PER STRAP END 22 GA. x 1.5' STEEL STRAPS (SIMPSON CS22) FROM WALL STUD TO RIDGE BEAM AND AT BOTTOM FROM WALL STUD TO MATELINE RIM JOIST @ 16' D.C. WITH GROWN AND MAILS PER STRAP END PER FLOOR PLAN (TYP. EACH MARRIAGE WALL), MINIMUM STRAP END LENGTH ON STUD AND BEAM = 10' (WRAP IF REQ'D). SITE INSTALLED & x 7' BOLTS INTO PRE-DRILLED HOLES @ 48' O.C. MAX. DOUBLE 2x4 TOP PLATE SPF#2 MIN. TRUSS # H1328 @ 24' D.C.
SEE ATTACHED TRUSSES
DIUBLE TRUSSES 4' FROM
ENDWALLS AND PORCH AREAS.
TRUSS TO HAVE
SYP LUMBER TOP CHORD. TYP 8 TYP OPTIONAL SIMPSON MISIB TWIST STRAP OR EQUAL AT EA TRUSS,
NAIL WITH (7) 100 PER
END. INSTALL ALL (7) AMILS
TO SIDE AND BOTTOM OF TOP
TO STUD; AND (7) TO TOP CHORD OF
TRUSS - Install (1) a35 angle cup from truss to top plate at each truss use (6) 8d × 1.5* Nails per side of bracket ALONG SIDE WALLS—
IN ADDITION TO STANDARD END NALING
STUD, WHERE STUD DOES NOT ALIGN W
INSTALL SIMPSON SP6 PLATE TIE WITH I WILS (3) PER SIDE

> MICROLLAM BEAM FB=2800 PSI.
>
> MICROLLAM MUST BE CONTINUOUS OVER CLEAR SPANS.
>
> BEAMS SUPPORTED BY ENDWALL COLUMNS MUST EXTEND CONTINUOUS OVER COLUMNS TO EXTERIOR FACE OF ENDWALL.
>
> INSTALL 2 X 4 X 20° SPF #37 RIDGE BEAM BEARING STIFFENERS OVER SUPPORT COLUMNS WHEN SPECIFIED ON FLOOR PLAN; FASTEN THE FACE OF THE STIFFENERS TO THE RIDGE BEAM WITH 100% GLUE COVERAGE AND 6-16 GAUGE STAPLES WITH 3/4° MINIMUM PENETRATION INTO BEAM. WHEN MORE THAN ONE LAYER OF MICROLLAM IS INSTALLED ON EITHER SIDE OF THE MATELINE, LAYERS ON THAT SIDE OF THE MATELINE MUST BE FASTENED TOCETHER WITH 16 CAUGE STAPLES X 7/16" MINIMUM CROWN (INSTALLED PARALLE TO BEAM SPAN) X 1" MINIMUM PENETRATION INTO CONNECTING LAYERS, STAPLES SHALL BE PLACED AT 6" O.C. MAXIMUM VERTICALLY AND HORIZONTALLY MITH FIRST AND LAST ROW OF STAPLES LOCATED 1" FROM TOP AND BOTTOM EDGE OF BEAM RESPECTIVELY.

EXTERIOR FINISH MATERIALS

ROOF - SHINGLES INSTALLED PER MANUFACTURER'S

SPECIFICATIONS. SHINGLES SHALL BE INSTALLED

OVER NO. 15 FELT OR EQUIVALENT, 2 LAYERS FOR

PITCHES UP TO 412 AND 1 LAYER FOR 4:12 AND

STEEPER.

WALLS - VINYL SIDING OR HARDI PLANK INSTALLED PER

MANUFACTURER'S SPECIFICATIONS. FUR

WALL BRACING
SIDE WALLS:
7/16' APA RATED 24/0. EXP. 1 SHEATHING SHALL EXTEND
7/16' APA RATED 24/0. EXP. 1 SHEATHING SHALL EXTEND
1/16' APA RATED 24/0. EXP. 1 SHEATHING EDGES EXTENDING
1/16' APA RATED 24/0. EXP. 1 SHEATHING EDGES EXTENDING
1/16' AND SPECIE AS THE EXTERIOR WALL FRAMING.
1/16' FASTENED W/ 8d NAILS @ 6' D.C. PANEL EDGES, 6' D.C. FIELD.

OF MTH TRUSS (6) 10d x 1.5 RIGHT SIDE ENDWALLS:
7/16' APA RATED 24/0. EXP. 1 SHEATHING SHALL EXTEND
7/16' APA RATED 24/0. EXP. 1 SHEATHING SHALL EXTEND
7/16' APA RATED 24/0. EXP. 1 SHEATHING SHALL SHEATHING
TO THE BOTTOM OF THE RIM JOIST WITH ALL SHEATHING
EDGES SUPPORTED BY 2' NUMINAL LUMBER OF THE SAME
SIZE AND SPECIE AS THE EXTERIOR WALL FRAMING.
FASTENED W/ 8d NAILS 3' D.C PANEL EDGES, 6' D.C. FIELD
OVER SYP LUMBER CHERI

Ü PORCH ENDWALLS:
7/16' APA RATED 24/0, EXP. 1 SHEATHING SHALL EXTEND
17/16' APA RATED 24/0, EXP. 1 SHEATHING SHALL EXTEND
INSIDE AND DUTSIDE CONTINUOUSLY FROM THE TOP OF THE END
WALL TOP PLATE TO THE BOTTOM OF THE RIM JOIST (INSIDE TO
BOTTOM PLATE) WITH ALL SHEATHING EDGES SUPPORTED BY 2'
BOTTOM PLATE) WITH ALL SHEATHING EDGES SUPPORTED BY 2'
ROMINGAL LUMBER OF THE SAME SIZE AND SPECIE AS THE EXTERI
WALL FRAMING. OFF SET HORIZONTAL PANEL JOINTS INSIDE TO C
FASTENED W/ Bd NAILS 3' D.C PANEL EDGES, 6' D.C. FIELD
OVER SYP LUMBER

INTERIOR WALLS TO BE 2x4 SPF # 2 MINIMUM.

2'X6' SYP #2 BOTTOM PLATE

BOTTOM PLATE TO FLOOR FASTENING: #10 × 3" W.S. 3" O.C. MIN.

CALU PIER

-.040 POLYMAX BOTTOM BOARD SITE INSTALLED (TYP.)

GRADE

DOUBLE 2×10 PERIMETER

2X8 SILL PLATE TO BE PRESSURE TREATED TIELD INSTALLED

8" BLUCK

comply with 9B-72 all required components shall

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Fire Rating of Ext. Walls: of Floors: Wind Velocity:

Plan No.: Now. Floor Load

0 hr MFT-5308-M2866SS320096 40 PSF

One (1)

Act and adopted Codes and

lorida Manufactured Building

VAPOR BARRIER: SHERWIN WILLIAMS INTEROR LATEX MOISTURE VAPOR BARRIER 872W1 1 PERM. MINIMUM

INTER FINISH MATERIALS

A. CEILING - 1/2* MINIMUM GYPSUM BDARD INSTALL 5d CODLER

NAILS 7* D.C., PANEL EDGES - 10* IN THE FIELD

NAILS 7* D.C., PANEL EDGES - 10* IN THE FIELD

B. WALLS - 1/2* MINIMUM GYPSUM BDARD INSTALLED PER

MANUFACTIVEREY'S SPECIFICATIONS.

C. FLOOR - TILE MAY BE USED IN BATHROOM AND OTHER WET AREAS. CARPET, TILE, DR WITEX WOUDD FLOORING INSTALLED IN ALL OTHER AREAS. CARPET MAY BE INSTALLED IN BATH AND KITCHEN AREAS PROVIDED THE FLOOR IS SEALED WITH MOISTURE PROOFING OR DESKING IS EXPOSURE ONE MATERIAL AND CARPET IS CUT FROM UNDER CONCEALLED SPACES.

ALL GABLE ENDWALL CONSTRUCTION PER SHEET S5.1 22 GA. STRAPS TO BE SIMPSON CS22.

PLANT: NAME: DRAWN BY: ATIB BILLY PITS DESCRIPTION: 26'8"x66' SERIES: MOD DATE DRAWN: 3BR-2BA 10/5/07 M2866SS320096-140 MODEL NO. SHEET: go NO. 2145-0470 A Co

GENERATION REVISIONS A3

rom the requirements of applicable State Laws.

Manufacturer: Modular One, LL Approval of this document does not authorize or approve any deviation or deviations

Approval Date: Manufacturer:


INC.

界 DATE SECTION VIEW ENERAL N.T.S. OTES

DRAWING TITLE

SECTION VIEW STANDARD

ROOF PENETRATIONS

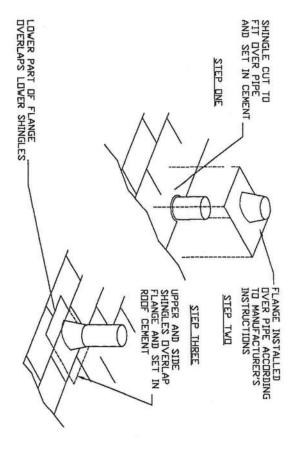

These prints comply with the Florida Manufactured Building Act and adopted Codes and all required components shall comply with 9B-72 APPROVED BY

THE OWNER OF THE STATE OF STAT

at hole by anomyddor oddings defyldy llynn so, n holh ar anomyddor oddingae defyldy llyn llyn so, n holh ${\rm d}_{\rm c}$ OF OPDING AT 18 D.C. (WX.) - SEE NOTE (T HAMOOD STORM CONES HESULLID WIN FACE CRAIM RAZED HORZONOM, (THE) SEE MINEE ON THIS SHEET FOR FLAMOOD SHEETCATIONS.

of Floors:
Wind Velocity:
Fire Rating of
Ext. Walls:
Plan No.:
Allow, Floor Load: Const. Type: Occupancy: Allowable No. VB unprotected R3 One (1)

the requirements of applicable State Laws. I NC. of this document does not authorize or approve any deviation or deviations

I ISOMETRIC

Gentle Album

PLYVOOD STORM COVER SPECIFICATIONS
USE EXTERIOR GRADE PARTED SHEATHING PLYVOOD
WITH THE MINIMAN THICKNESS AND SPAN INDEX
SPECIFIED BELDV.

MAX DING VIDTH

HIN THICKNESS

24/0

(M-DOW DASHED) ALTA THEN SEE WORMTHISSE BEAUTH R. A. LENG SHU .Y.-.Y. THEN EES HOUTHYEN KENCE TO-

NOTES:

1. WHEN ROOF DECKING IS PENETRATED, THE AREA PENETRATES MAY BBE 1/2"

1. WHEN ROOF DECKING IS PENETRATED, THE AREA PENETRATES MAY BBE 1/2"


1. WHEN ROOF DECKING IS PENETRATED.

1. WHEN APPRICAMENT OF PENETRATIONS TO BE SEALED IN ACCORDANCE WITH THE FLASH-ING MANUFACTURER INSTALLATION INSTRUCTIONS WHEN APPLICABLE. DITHERWISE USE THE DETAIL ABOVE.

3. DO NOT USE PETROLEUM BASED SEALANTS ON BASE OF FLASHING WHEN USING A NO CAULK FLASHING.

4. PLUMBING VENT PENETRATION SHALL EXTEND A MINIMUM OF 12" ABOVE ROOF PROTECTION.

CHIMNEYS TOI BE LOCATED BETWEEN TRUSSES TO MAINTAIN MINIMUM REQUIRED DISTANCES FROM COMBUSTIBLE MATERIAL. DETAILS APPLICABLE TO PLUMBING VENTS, FLUES, CHIMNEYS, AND ELECTRICAL

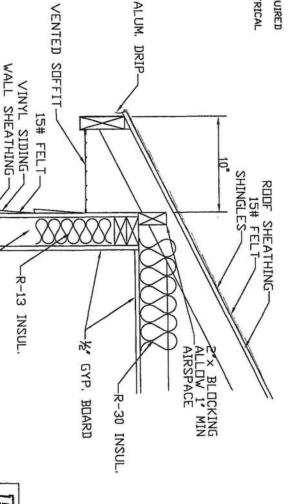

A SECTION A N.T.S.

- TYP. SCREW INSTALLATION

B SECTION
B N.T.S.

ONE THIN/BINE

IN X 2 1/2" WOOD SCIENT W/ 1 1/2" CM-STEEL WIGGE (PROFULLE MAST LOCALT WOOD SCIENTS, S/4" FRAM LOCAL OF WOOD SCIENT FRAME AND MED 1/252" THAT WOOD SCIENT FLACEMENT PROFULLY BELOCES LIMBERS FRAMES.

RYMOOD STORM COVER (MUST EXTEND MAK N° BEYOND EDGE OF INDICOM/DOOR FRAME AS SHOWN.

STREEDS WASHES AT EACH DO STREEDS WASHES AT EACH DO

224 SIBFROOR DOING

PLYMOOD STORM CONER

PULL TO SOURCE FOR (MARCH)

- SIED, WASHER
- WEIM, THEE/COLNOER
(OR PLYMOOD SPACER)

RUSSEDR WASHER

WHI SONE W/ EXTENDE SENDANG (AS SIGNA)
OR EXTENDE HANDSHAD SONG (NOT SHOWN)
STILD OR LIMEDS RECORDS (202 SFF MAY)

1. DISTALLER MAST REPORTE ALL DECERATIVE ALL STERN PORTECTION HAS SUBSIDED.
10. DISTALLER MAST REPORTE ALL DECERATIVE HERDINGLY REPORTED ECCUPANCY
10. DISTALLER MAST REPORTE ALL DECERATIVE
10. DISTALLER MAST REPORTE ALL DECERATIVE
10. ALL STERN PORTECTION HAS SUBMITTED.
10. DISTALLER MAST REPORTE ALL DECERATIVE
10. ALL STERN PORTECTION HAS SUBMITTED.
10. DISTALLER MAST REPORTE ALL DECERATIVE
10. DISTALLER

A IMEDIATELY AFTER INSTALLING THESE COVERS THE BUILDING MUST BE VACATED AND/OR NO DOCUPANTS SHOULD REMAIN IN THE STRUCTURE.

7. WACH OPENING VIDTH EXCEEDS 84" (UP TO A MAXIMUM OF 120") USE 236" STP 182 STIFFEMENS AND USE 374" PLYOUDD VITH A SPAM INDEX OF 48724. ALL DIMER INSTALLATION SPECIFICATIONS REMAIN UNCHANGED.

6. ALL VOID SCREV HOLES RESULTING FROM STIBM COVER INSTALLATION MUST BE FILLED VITH GOOD OWALITY EXTERIOR GRADE CAULK

2. WEN HURICANE OR SEVERE VIND STIGHTS APPEACH, THE VINDOV AND DOOR PROTECTION COVERS SPECIFIED ON THIS DRAVING SHOULD BE INSTALLED.

4. NOTE: THIS STORM PROTECTION SYSTEM POOLS NOT PEONIT EXCESS FROM THE SHEDWIS UNDER FIRE OF OTHER EMERGENCY CONDITIONS.

B. FOR OPDINKS VIDER THAN 85', LICATE STORM COVER BUTT JUNI VITHIN 30' OF VERTICAL STUDIES AND INSTALL "Y CLIP'S BETVEEN LUMBER STIFFENERS AS SHOWN.

HWG

-2"x6" @ 16" D.C.

HILBORN, WERNER, CARTER & ASSOCIATES
1827 SOUTH MYRTLE AVE.
CLEARWATER, FL 33756
CCA \$1025

TIMOTHY L. HUNT, PE FL P.E. LIC. #41033 PHONE: 727-584-8151 EMAIL: THUNT@HWCENG.COM

AIR FLOW DETAIL

MODULAR ONE, LLC PLANT #1 1884 MINES RD. PULASKI, TN 38478 PHONE: (931) 424-7305 FAX: (931) 424-7308 EMAIL: TKING@MODULARONE.NET


SECTIODETAIL

DRAWING TITLE

V.) <	ı	
BILLY PITTS	PLANT:	-	NAME:
PITTS	26'8"x66"	- MOD	SERIES:
DATE DRAWN: 10/5/07	3BR-2BA		
MEET: A3.1	JOB NO. 2145-0470	M2866SS320096-140	


T	1	1	1	1	
					REVISIONS
-	1	1	1	1	Вү
1	1	1	1	1	DATE
	1976	A3.1 N.T.S.	1 SECTION DETAILS)	G E N E X A C N C - E U

THE NEVT CENEDATION

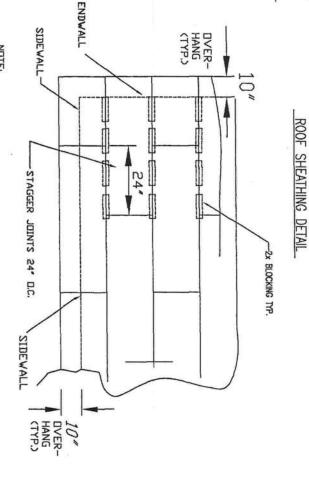


NOTE:

ROOF SHEATHING SHALL BE ¹⁵/₂₀*APA RATED 24/16 SPAN INDEX, EXP. 1 DR D.S.B. ROOF SHEATHING. PROVIDE BLOCKING FOR A DISTANCE OF 16 FT FROM EACH END WALL WITH 2' NOMINAL LUMBER OF THE SAME SPECIES AND GRADE OF THE TRUSS TOP CHORD. SEE UPLIFT NAILING SCHEDULE FOR NAIL SPACING REQUIREMENTS. TRUSS TOP CHORD AND BLOCKING TO BE SYP LUMBER.

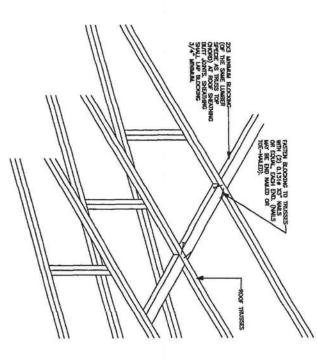

GABLE END WALL

TYPICAL ROOF SHEATHING BLOCKING DETAIL NOTE:
THIS DEFAIL IS ONLY APPLICABLE
WHEN PLANS REQUIRE ROOF
SHEATHING EDGE TO BE BLOCKED.

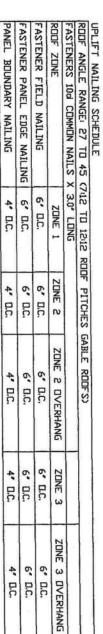

WALL LINE-

WALL LINE

NOTE: PANEL BOUNDARY NAILING APPLICABLE ONLY TO BLOCKED SECTIONS OF ROOF

These prints comply with the Florida Manufactured Building Act and adopted Codes and all required components shall comply with 98-72 APPROVED BY

FINC.

THE NEVT CENEDATION

Const. Type:
Occupancy:
Allowable No.
of Floors:
Wind Velocity:
Fire Railing of
Ext. Walls:
Plan No.:
Allow. Floor Load:
Approval Date:
Manufacturer:

0 hr MFT-5308-M2866SS320096 40 PSF One (1) 140 mph

Approval of this document does not authorize or approve any deviation or deviations from the from the requirements of applicable State Laws.

REVISIONS

ВΥ

DATE

GENE

RAL

OTES

DRAWING TITLE

HWG

HILBORN, WERNER, CARTER & ASSOCIATES
1627 SOUTH MORTLE AVE.
CLEARWATER, FL 33756
COA \$1025

TIMOTHY L. HUNT, PE FL P.E. LIC. #41033 PHONE: 727-584-8151 EMAIL: THUNT@HWCENG.COM

PLANT #1 1884 MINES RD. PULASKI, TN 38478 PHONE: (931) 424-7305 FAX: (931) 424-7308 EMAIL: TKING@MODULARONE.NET MODULAR ONE, LLC

-	
S	
=	

DISTANCE "a" = 4'-0" TYP. 3 OVERHANG GABLE END WALL 3 OVERHANG--3 OVERHANG

ROOF SHE ATHING FASTENING DETAIL


1 ROOF SHEATHING DETAILS A3.2 N.T.S.

SHEATHING DETAILS

26'8"x66' 3BR-2BA DESCRIPTION: SERIES: MOD MODEL NO.


M2866SS320096-140 JOB NO. 2145-0470

DRAWN BY:
BILLY PITTS 10/5/07

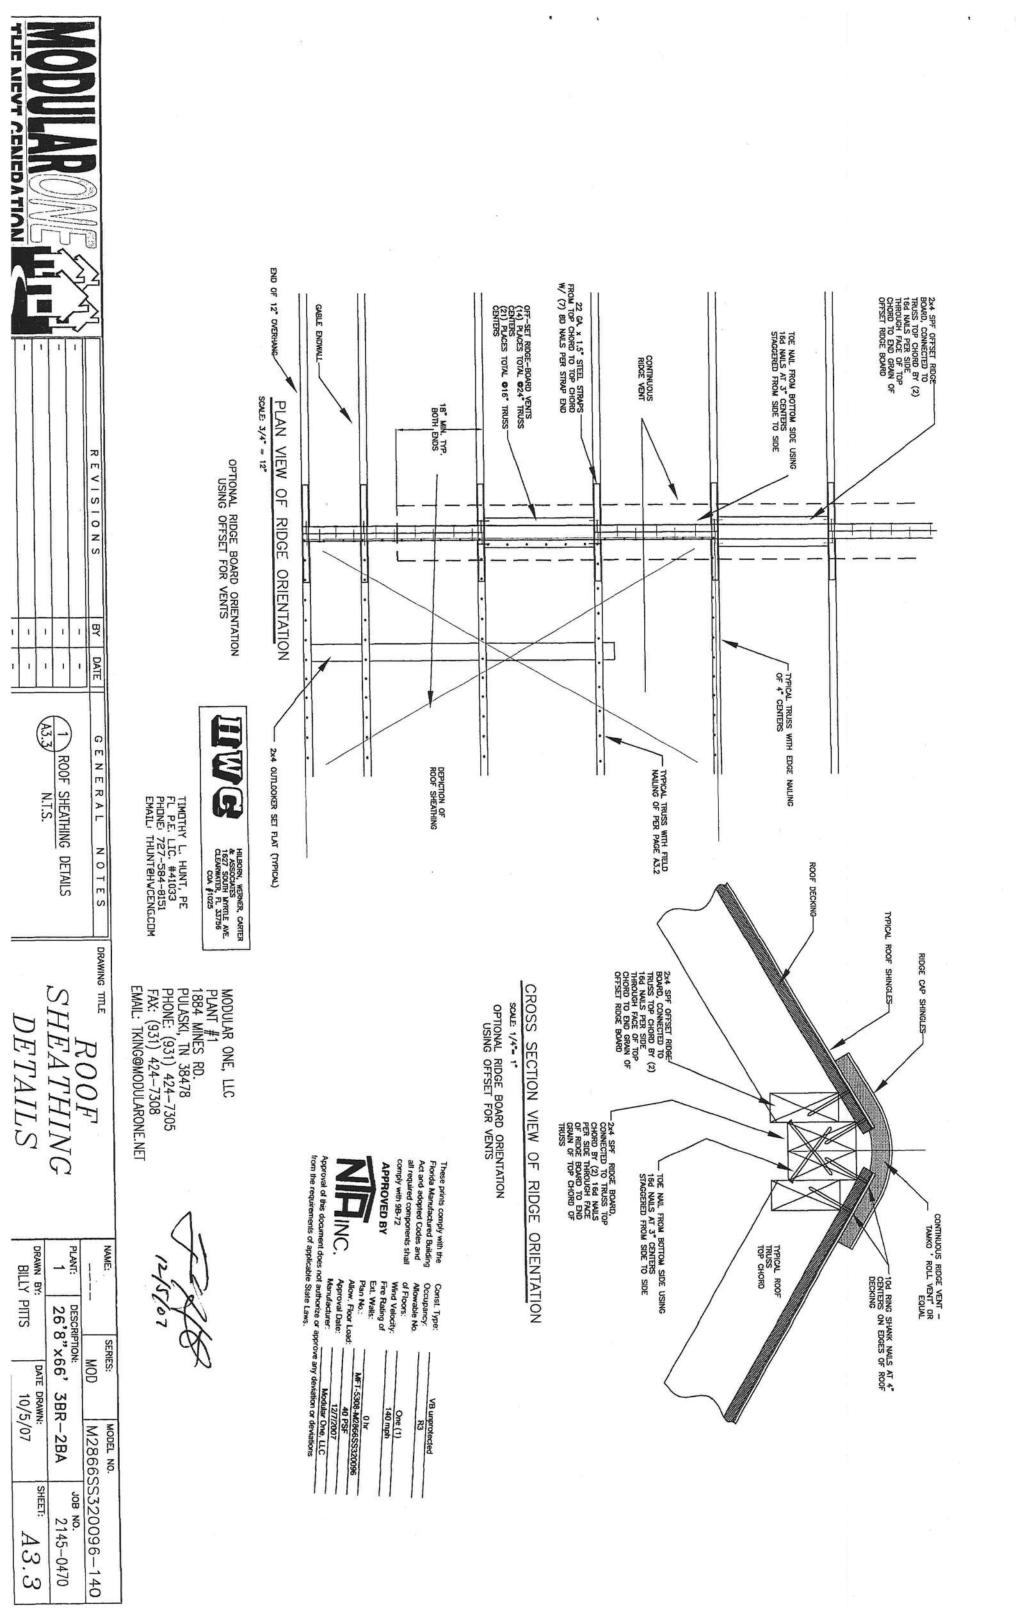

EXTERIOR DOOR W/ SIDELIGHTS	6'-8"	3'-0'	1	6
INTERIOR DOOR	6'-8"	2'-0"	1	5
INTERIOR DOOR	6'-8"	3'-0"	6	4
INTERIOR DOOR	6'-8"	2'-6"	4	4A
INTERIOR DOOR	6'-8"	2'-2"	r)	ω
EXTERIOR DOOR	6'-8"	3'-0"	2	ъ
SLIDING GLASS DOOR	6'-8"	6'-0"	1	1
Remarks	Width Height	Width	[ag Quantity	Tag
SCHEDULE	SCHE)00R		

Ð	С	В	Þ	Tag	
1	3	N	4	Tag Quantity Width Height	N N N N N N N N N N N N N N N N N N N
36	36	36	36	Width	DOW
36	60	60	60	Height	WINDOW SCHEDULE
SINGLE HUNG	EGRESS SINGLE HUNG	TEMPERED SINGLE HUNG	SINGLE HUNG	Remarks	DULE

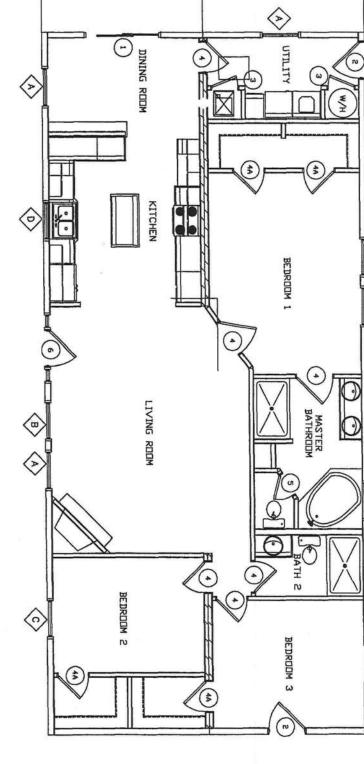

0

LIGHT AND VENT AS FOLLOWS:

	_		
3'0×5'0	3'0×3'0	SIZE	MDGNIM
35 1/2"	35 1/2"	HTUIW	FRAME
59 1/2"	35 1/2"	HEIGHT	FRAME
6.12	3,42	HEIGHT SASH INSTALLED	EGRESS SQGFT
32 1/16, 27 15/32,	32 1/16	HIDIM	EGRESS
27 15/32	32 1/16' 15 11/32'	THIGHT	CLEAR
11.98	6,60	AREA	GLASS
6/6	6/6	חדאדחבח	STANDARD

VB unprotected R3

DOOR U-VALUE - 0.35 WINDOW U-VALUE - 0.35 SHGC=0.28 MINIMUM WINDOW AND DOOR DP: +48.9 PST/-53.2 PST



HILBORN, WERNER, CARTER & ASSOCIATES
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COA \$1025

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EMAIL: TKING@MODULARONE.NET

12/5/21

DOOR & WINDOW

SCHEDULE

O" SCHEDULE

SCHEDULE


REVISIONS

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DOOR & WINDOW SCHEDULE $3/16^n = 1^{n} - 0^n$

THE NEXT GENERATION

DOLE	WINDOW	
BILLY PITTS	PLANT:	NAME
	26'8"x66'	- MOD
DATE DRAWN: 10/5/07	3BR-2BA	M2866
SHEET: $A4$	2145-0470	M2866SS320096-140

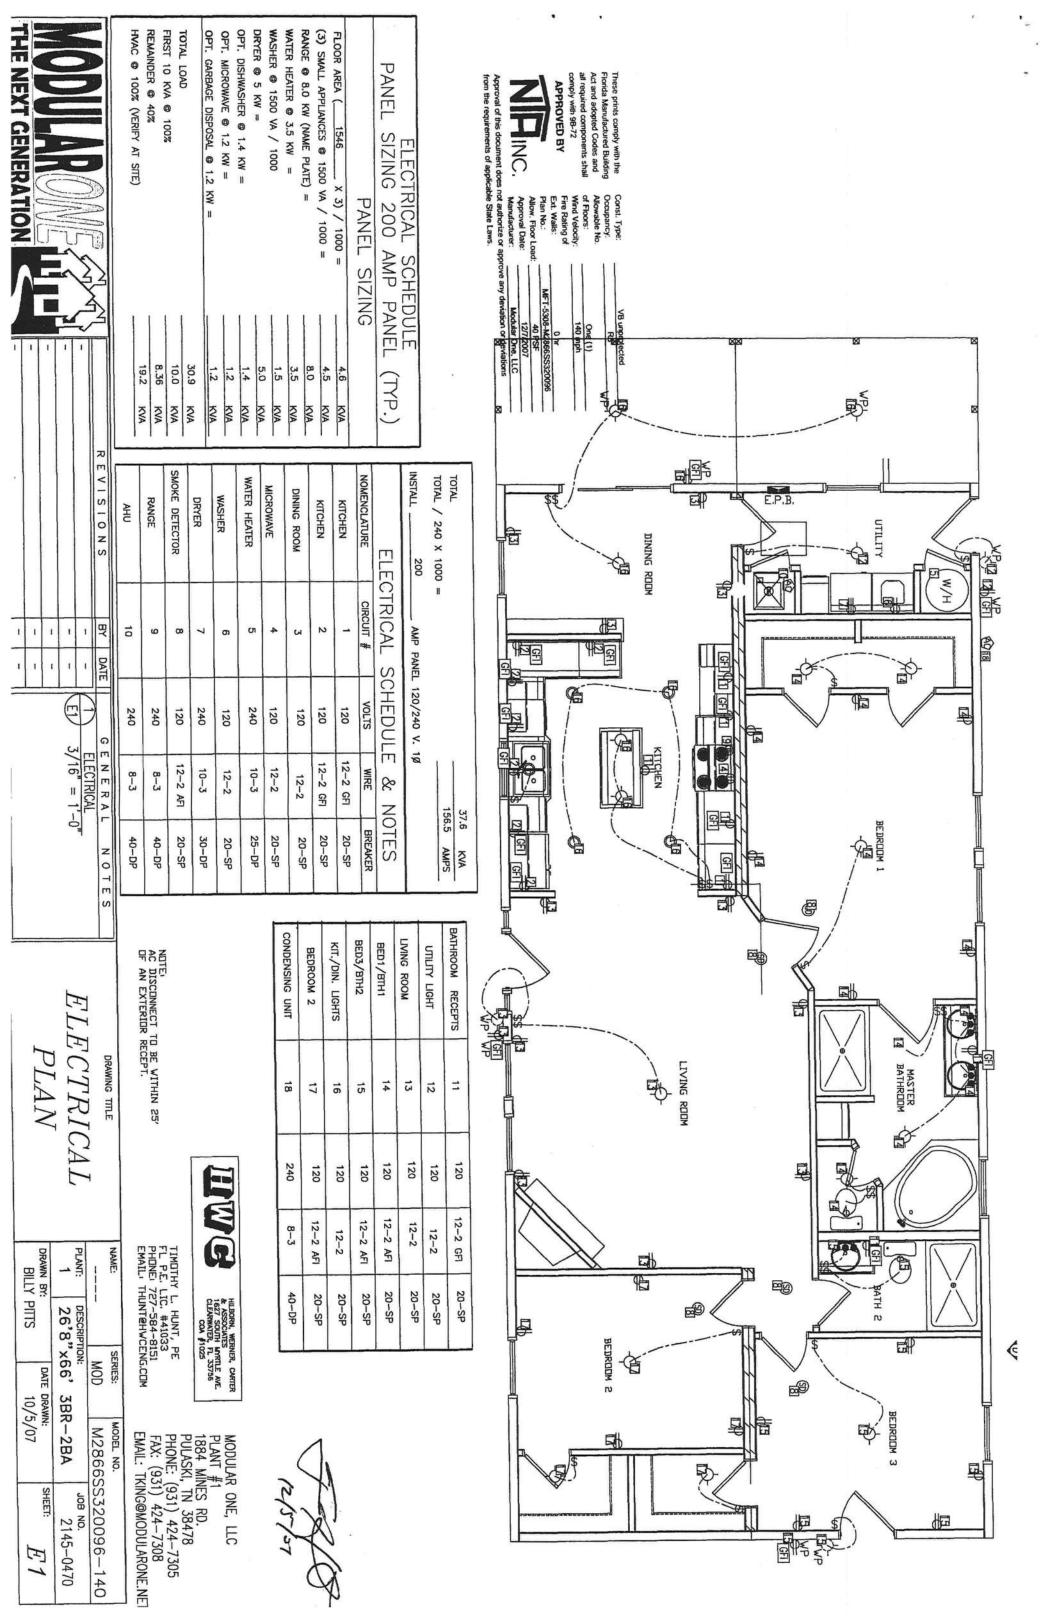

GENERAL MECHANICAL NOTES

DO NOT SCALE DRAWINGS, REFER TO FLOD PLAN FOR EXACT LOCATION OF DOORS, WINDOWS, AND CEILING DEVICES, PROJECT IS A NEW STRUCTURE. ROUTE ALL PIPING AND CONDUUIT AS INDICATED, BUT SO AS NOT TO DEFACE EXTERIOR OF BUILDING. VERIFY EXISTING CONDITIONS PRIOR TO PERFORMING WORK, DAMAGE TO STRUCTURE BEYONDCUTTING AND PATCHING FOR WORK INDICATED WILL BE REPAIRED TO EXISTING CONDITIONS AT THE CONTRACTORS EXPENSE.

COORDINATE ALL PIPING AND DUCT WORK LOCATIONS WITH OTHER DIVISIONS AND EXISTING CONDITIONS.

CONDENSATE DRAINS SHALL BE TRAPPED AT UNIT OUTLET AND RYPER VENT TO WALL CAP TO BE SITE INSTALLED BY OTHERS SUBJECT TO LOCAL JURRISDICTION APPROVAL.

ANY AND ALL DUCT WORK MAY BE DONE ON SITE BY OTHERS

These prints comply with the Florida Manufactured Building Act and adopted Codes and all required components shall comply with 9B-72

APPROVED BY

One (1)

RANE MODEL 2TWB2048A, 4 TON HEAT PUMP OR EQUAL, 9.00 HSPF.

AIR HANDLER
RANE MODEL TWO48C140B OR EQUAL

XXX = SUPPLY AIR REGISTER HYAC SYMBOL LEGEND


= FLEXIBLE DUCTWORK

THERMUSTAT

HWG HILBORN, WERNER, CARTER & ASSOCIATES
1627 SOUTH MYRTLE AVE.
CLEARMATER, FL 33756
CDA #1025

PLANT #1 1884 MINES RD. PULASKI, TN 38478 PHONE: (931) 424-7305 FAX: (931) 424-7308 MODULAR ONE, LLC TIMDTHY L. HUNT, PE FL P.E. LIC. #41033 PHONE: 727-584-8151 EMAÎL: THUNT@HWCENG.COM

EMAIL: TKING@MODULARONE.NET

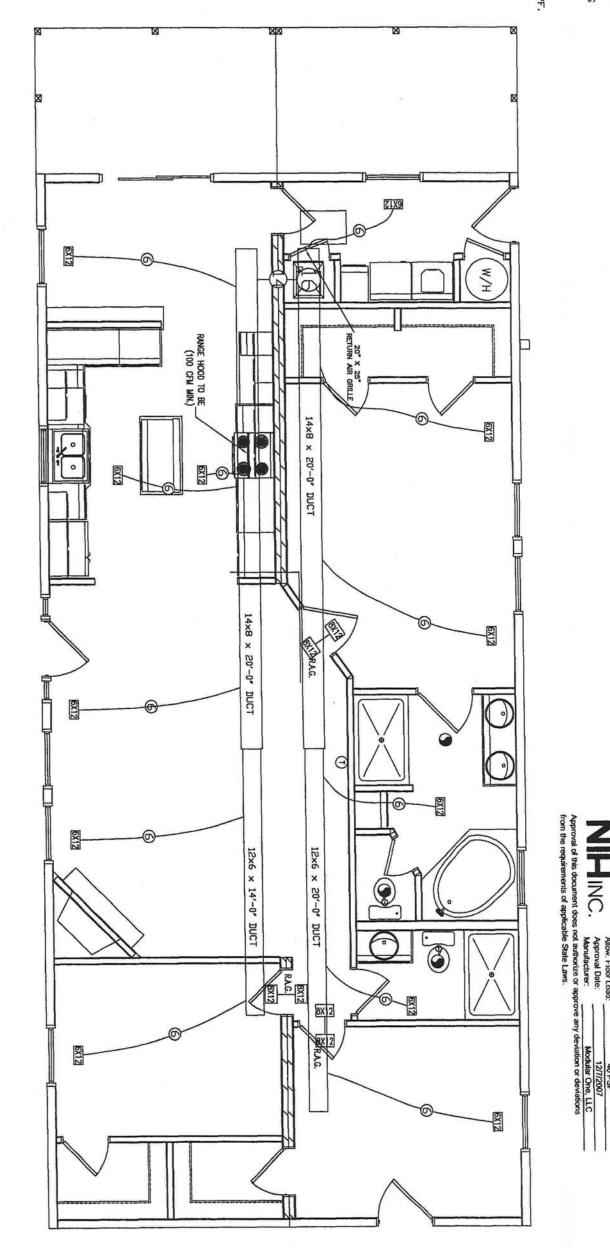



NOTES


MODEL NO.

MECHANICA HVAC PLA

4N	AL	4	
DRAWN BY: BILLY	PLANT:		
BILLY PITTS	26'8"x66'		•
DATE	66,	MOD	0
DATE DRAWN: 10/5/07	3BR-2BA	M28669	The same of the sa
SHEET: M1	2145-0470	M2866SS320096-140	

THE NEXT CENERATION SNOISIA BΥ DATE MECHANICAL PLAN 3/16" = 1'-0"GENERAL

WATER HEATER DETAIL

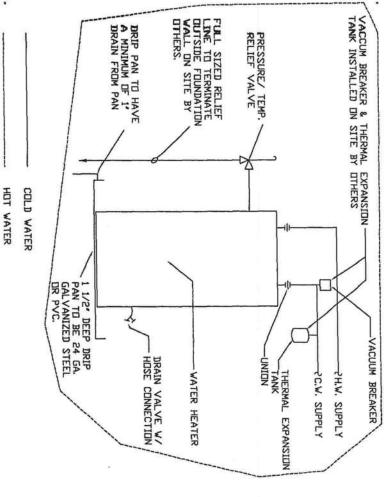

SHOWER

SHOWER

B-HALF

all required components shall comply with 98-72

APPROVED BY

Const. Type:
Occupancy:
Allowable No.
of Floors:
Wind Velocity:
Fire Rating of
Ext. Walks:
Plan No.:
Allow. Floor Load:
Approval Date:
Manufacturer:

These prints comply with the Florida Manufactured Building Act and adopted Codes and

VB unprotected R3

One (1) 140 mph

- SUPPLY LINES

 1. SUPPLY LINES SIZING IS BASED

 IN AN ASSUMED AVAILABLE PRESSURE

 OF 46 TO 60 PSI AT MAIN INLET AND

 SHOULD BE VERIFIED PRIOR TO

 CONSTRUCTION.

 2. ALL SUPPLY LINES SHALL BE 3/4',

 ALL STUB-UPS SHALL BE 1/2', UNLESS

 OTHERWISE SPECIFIED.
- PLUMBING NOTES

 I. MAIN WATER LINE, SHUT-OFF VALVE, AND PRESSURE REDUCING VALVE ARE DESIGNED BY DITHERS, SITE INSTALLED SUBJECT TO LOCAL JURRISDICTION APPROVAL.

 2. MAIN VENT AND WASTE STACK LOCATED IN CLUSET IN CHASE.

 3. ALL PIPING LOCATED IN EXTERIOR WALLS SHALL BE PROTECTED FROM FREEZING.


 4. HOSE BIBB IS TO BE FROST PROOFED WITH BACK FLOW PREVENTER.


 5. HOT WATER TO BE LEFT HAND SIDE OF THE COLLD WATER.
- STANDARD 40 GALLON WATER HEATER

HILBORN, WERNER, CARTER & ASSOCIATES
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COA \$1025

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PULASKI, TN 38478
PHONE: (931) 424-7305
FAX: (931) 424-7308
EMAIL: TKING@MODULARONE.NET



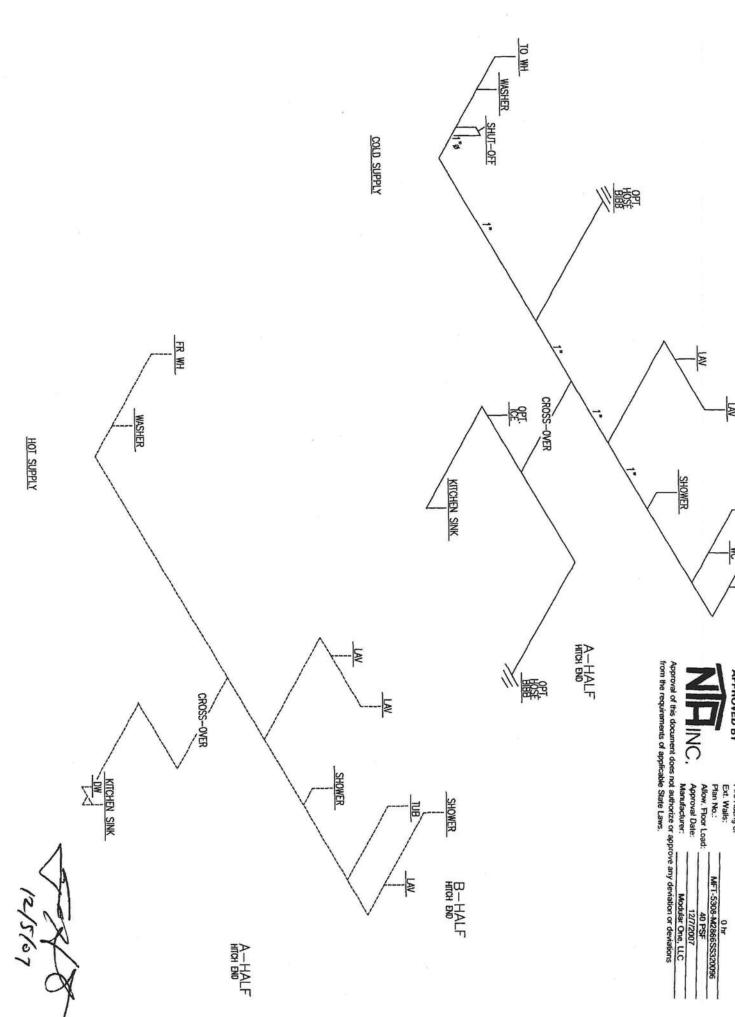

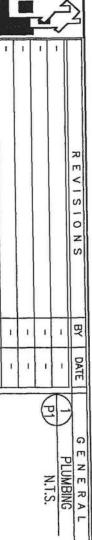PENEDATION

SUPPLY PLUMBING PLA.

0

TES

DRAWING TITLE

BILLY PITTS PLANT: NAME: 26'8"x66' 3BR-2BA SERIES: MOD DATE DRAWN: 10/5/07 M2866SS320096-140 MODEL NO. SHEET: лов NO. 2145-0470


NOTE: AIR ADMOTTANCE VALVE TO BE TYPE B PER ASSE 1051. NOTE: UNITS PER SECTION P3107/P3108 OF 2004 FRC CHAPTER 31 = VENT THRU ROOF 2" V.T.R. REVISIONS 2" V.T.R. 뫈 GENERAL PLUMBING N.T.S. 經經 1 1/2" V.T.R. SHOWER 1 1/2" DWV PLUMBING PLAN DRAWING TITLE 2" V.T.R. Act and adopted Codes and all required components shall comply with 9B-72

APPROVED BY

APPROVED These prints comply with the Florida Manufactured Building Act and adopted Codes and all required components shall comply with 98-72

APPROVED BY)/_C TIMOTHY L. HUNT, PE FL P.E. LIC. #41033 PHONE: 727-584-8151 EMAIL: THUNT@HWCENG.COM DRAWN BY: BILLY PITTS PLANT: NAME: HILBORN, WERNER, CARTER & ASSOCIATES
1627 SOUTH MYRTLE AVE.
CLEARWAITER, FL 33756
COA \$1025 DESCRIPTION: 26'8"x66' 3BR-2BA SERIES: MOD DATE DRAWN: 10/5/07 MODULAR ONE, LLC
PLANT #1
1884 MINES RD.
PULASKI, TN 38478
PHONE: (931) 424-7305
FAX: (931) 424-7308
EMAIL: TKING@MODULARONE.NET M2866SS320096-140 MODEL NO. SHEET: 2145-0470

P2

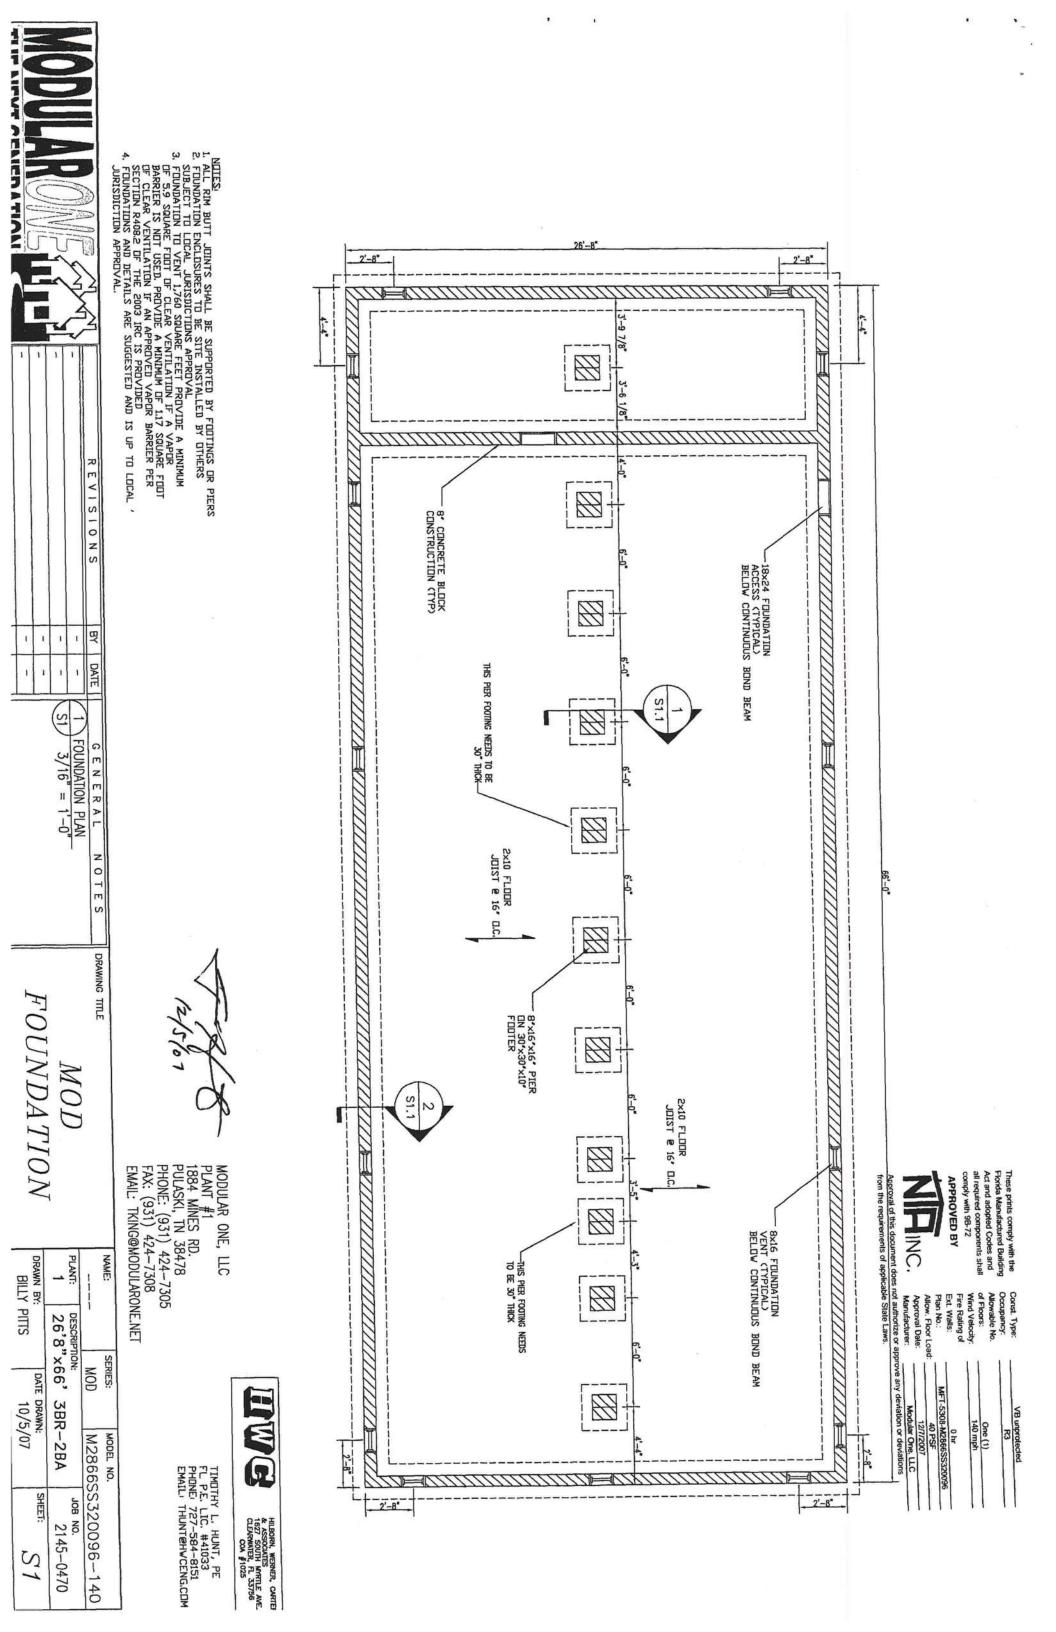

DESIGN AND CODE INFORMATION

1. VERIFY EXISTING CONDITION

DO NOT COMPLY WITH PLANS **** NOTE ****

1. FOUNDATION AND DETAILS ARE SUGGESTED.

FOUNDATIONS ARE PER LOCAL JURGISDICTION APPROVAL.

2. FODTINGS SHALL NOT BE PLACED ON EXPANSIVE SOILS. EQUINDATION PLAN NOTES

LOT TO GRADE AS TO DRAIN SURFACE WATER AWAY FROM FOUNDATION WALLS. THE GRADE AWAY
FROM FOUNDATION WALLS SHALL FALL A MINIMUM OF 6° WITHIN THE FIRST 10 FEET.
THE SUB-GRADE SHALL BE CLEANED OF ALL VEGETATION AND ORGANIC MATERIAL. ALL CONCRETE
FORMS SHALL BE REMOVED PRIOR TO THE BUILDING BEING DECUPIED. ALL CONSTRUCTION MATERIALS
SHALL ALSO BE REMOVED BEFORE BUILDING IS OCCUPIED.
MECHANICAL DUCTS AND PLUMBING SHALL BE ADEQUATELY SUPPORTED FROM THE FLOOR STRUCTURE.
NO DUCT WORK SHALL BE IN CONTACT WITH THE GROUND.

A' PVC POSITIVE DRAIN TO BE LOCATED AT THE LOWEST POINT IN THE CRAYL SPACE AND EXTEND
12° BEYOND THE EDGE OF THE FOOTING. THE DRAIN OPENING SHALL BE ON THE TOP OF THE CONCRETE MASDNARY
CONCRETE MASDNARY
SHALL CONFORM TO ASTM C90, GRADE N, AND TYPE 1 WITH AN OVEN DRY
WEIGHT 155 P.C.F. THE MINIMUM COMPRESSIVE STRENGTH OF THE NET CROSS SECTIONAL AREA
OF MASDNARY UNITS SHALL BE 1,250 P.S.I.
GROUT FOR FILLING MASDNARY CELLS SHALL HAVE A 28 DAY COMPRESSIVE STRENGTH EQUAL TO
OR GREATER THAN THE UNIT MASDNARY STRENGTH DR 2000 P.S.I. THE SLUMP SHALL BE BETWEEN
8' AND 10'. CELL IS GREATER THAN 4'.


TYPE 'S' MORTAR SHALL BE USED FOR MASOURY.


LAP SPLICES FOR REINFORCEMENT IN MASOURY SHALL BE 27 BAR DIAMETERS.

REINFORCEMENT SHALL BE PLACED AND SECURED IN POSITION AND HAVE LOCAL INSPECTION WHERE REQUIRED PRIOR TO GROUTING OPERATION.

WHERE REQUIRED PRIOR TO GROUTING OPERATION.

PLACE VERTICAL REINFORCEMENT IN THE CENTER OF CELLS UNLESS NOTED OTHERWISE. ALL CONCRETE WORK SHALL CONFORM TO THE BOILDING CODE REGISTED CONCRETE, BE BARS CONFORMING TO ASTM A615 (GRADE 60).
THE COPMPRESSIVE STRENGTH AT 28 DAYS OF ALL CAST IN PLACE CONCRETE SHALL BE **EXT GENERATION** E GROUT CONTAINING PEA GRAVEL WHERE THE DIMENSION OF ANY CONTINUOUS VERTICAL L CONFORM TO THE BUILDING CODE REQUIREMENTS AND DIMENSIONS AND NOTIFY ARCHITECT OF ANY CONDITION WHICH AND SPECIFICATIONS. C PLANT #1 1884 MINES RD. PULASKI, TN 38478 PHONE: (931) 424-7305 FAX: (931) 424-7308 EMAIL: TKING@MODULARONE.NET MODULAR ONE, LLC REVISIONS BY DATE PERIPHERAL ANCHOR DETAIL 1/2" = 1-0" HILBORN, WERNER, CARTER & ASSOCIATES, INC. 1627 SOUTH MYRTLE AVE. CLEARWATER, FL 33756 CONTINUOUS 8" CMU GENERAL MATELINE PIER DETAIL WALL GROUTED AT REBAR LOCATIONS #5 FOUNDATION PLAN 3/16" = 1'-0"P.T. SILL PLATE REBAR CONT.-CONT. CONC **FOOTER** ES GRAD,E 10" SPECIAL NOTE: TWO PIERS UNDER LARGE OPENING THICKNESS DIMENSION MUST BE 30" FOUNDATION24" 30" سلبت DETAILSFLOOR CONSTRUCTION FLOOR CONSTRUCTION DRAWING TITLE 18" MIN SEE ANCHOR DETAILS ON 18" DETAILS ON SHEETS S1.3 SEE ANCHOR AND REBAR GROUTED CELLS AND 4 # 4 BARS IN EACH PIER 16"x16" CMU PIER W/ 2 These prints comply with the Florida Manufactured Building Act and adopted Codes and all required components shall comply with 9B-72 SHEETS S1.3 Approval of this document does not authorize or approve any deviation or deviations from the requirements of applicable State Laws. APPROVED BY AND REBAR ZINC. # S NAME: PLANT: BARS DRAWN BY: TIMOTHY L. HUNT, PE FL P.E. LIC. #41033 PHONE: 727-584-8151 EMAIL: THUNT@HWCENG.COM BILLY PITTS EACH WAY DESCRIPTION: 26'8"x66' 3BR-2BA Const. Type:
Occupancy:
Altowable No.
of Floors:
Wind Velocity:
Fire Rating of
Ext. Walls:
Plan No.:
Allow: Floor Load:
Approval Date:
Manufacturer: SERIES: MOD DATE DRAWN: 10/5/07 0 hr MFT-5308-M2866SS320096 40 PSF M2866SS320096-140 MODEL NO. One (1) SHEET: JOB NO. 2145-0470 S1.1

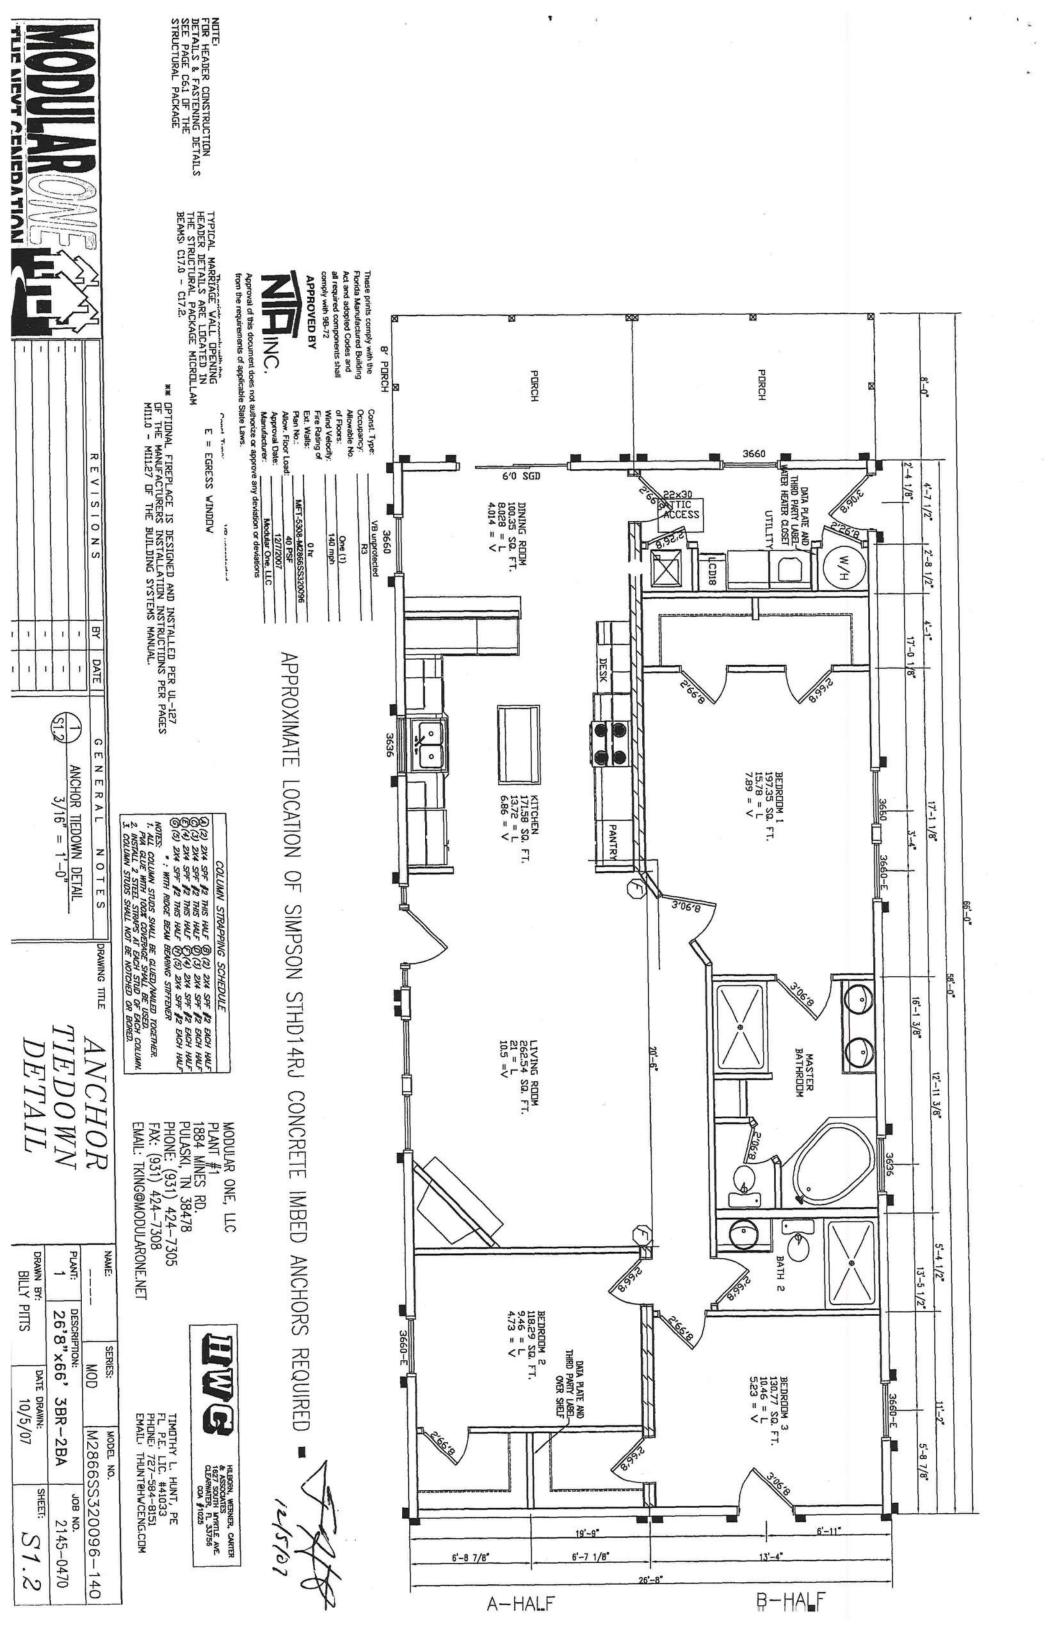


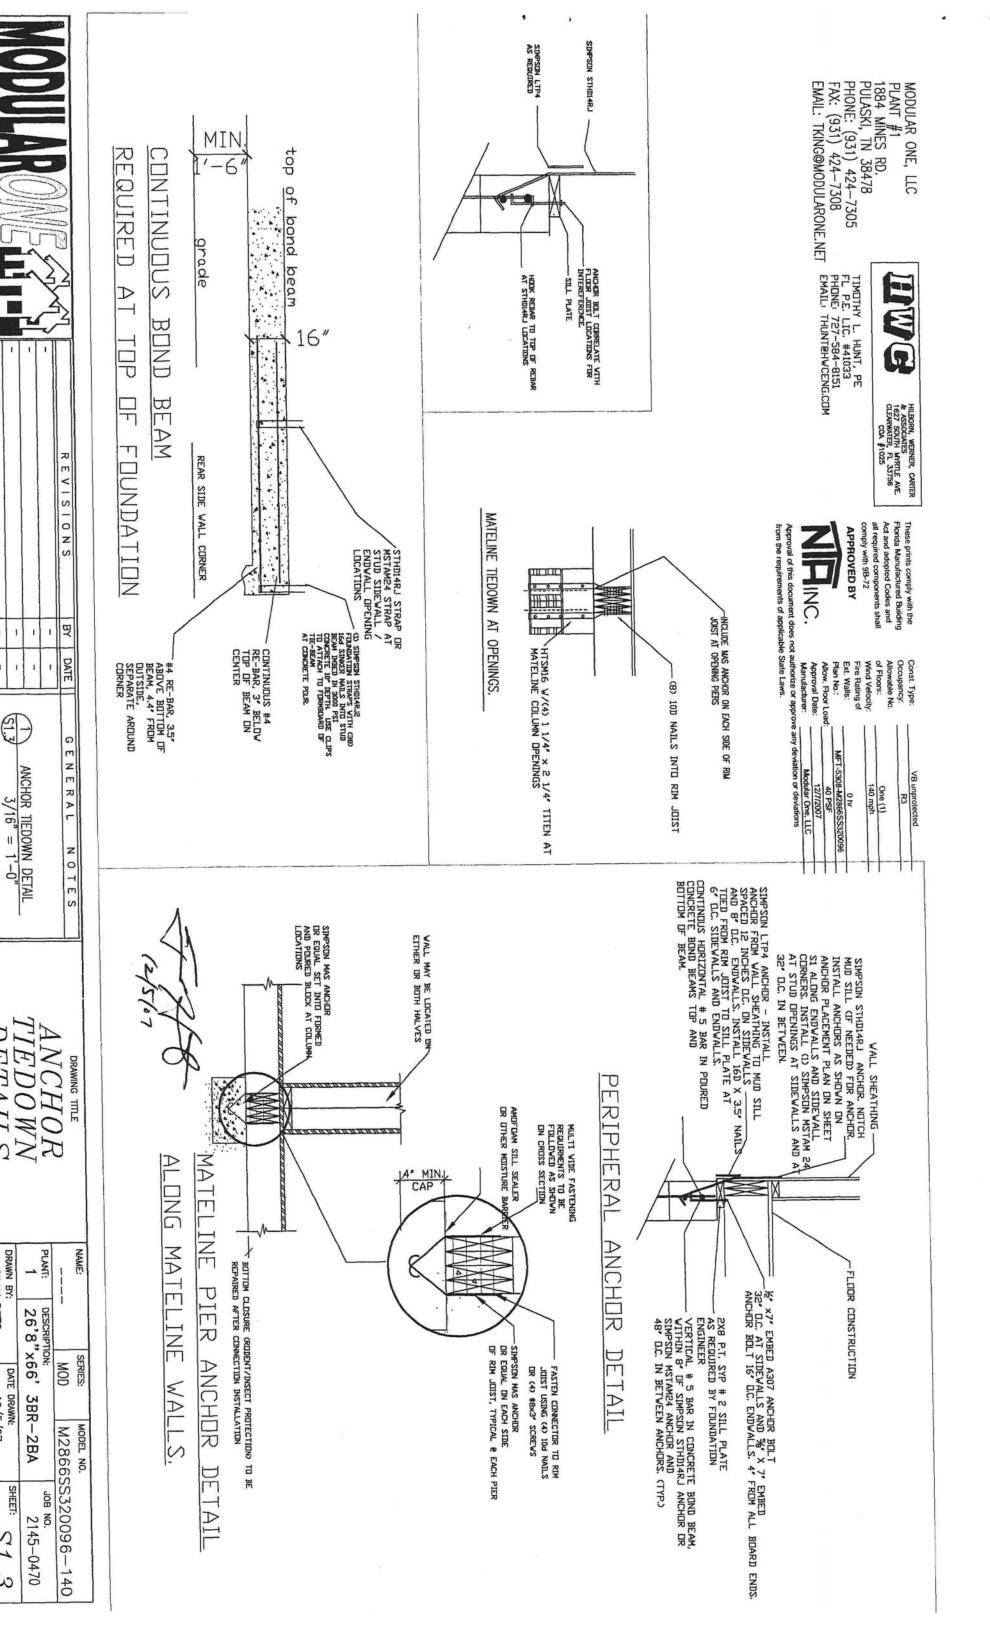

BILLY PITTS

DATE DRAWN: 10/5/07

SHEET:

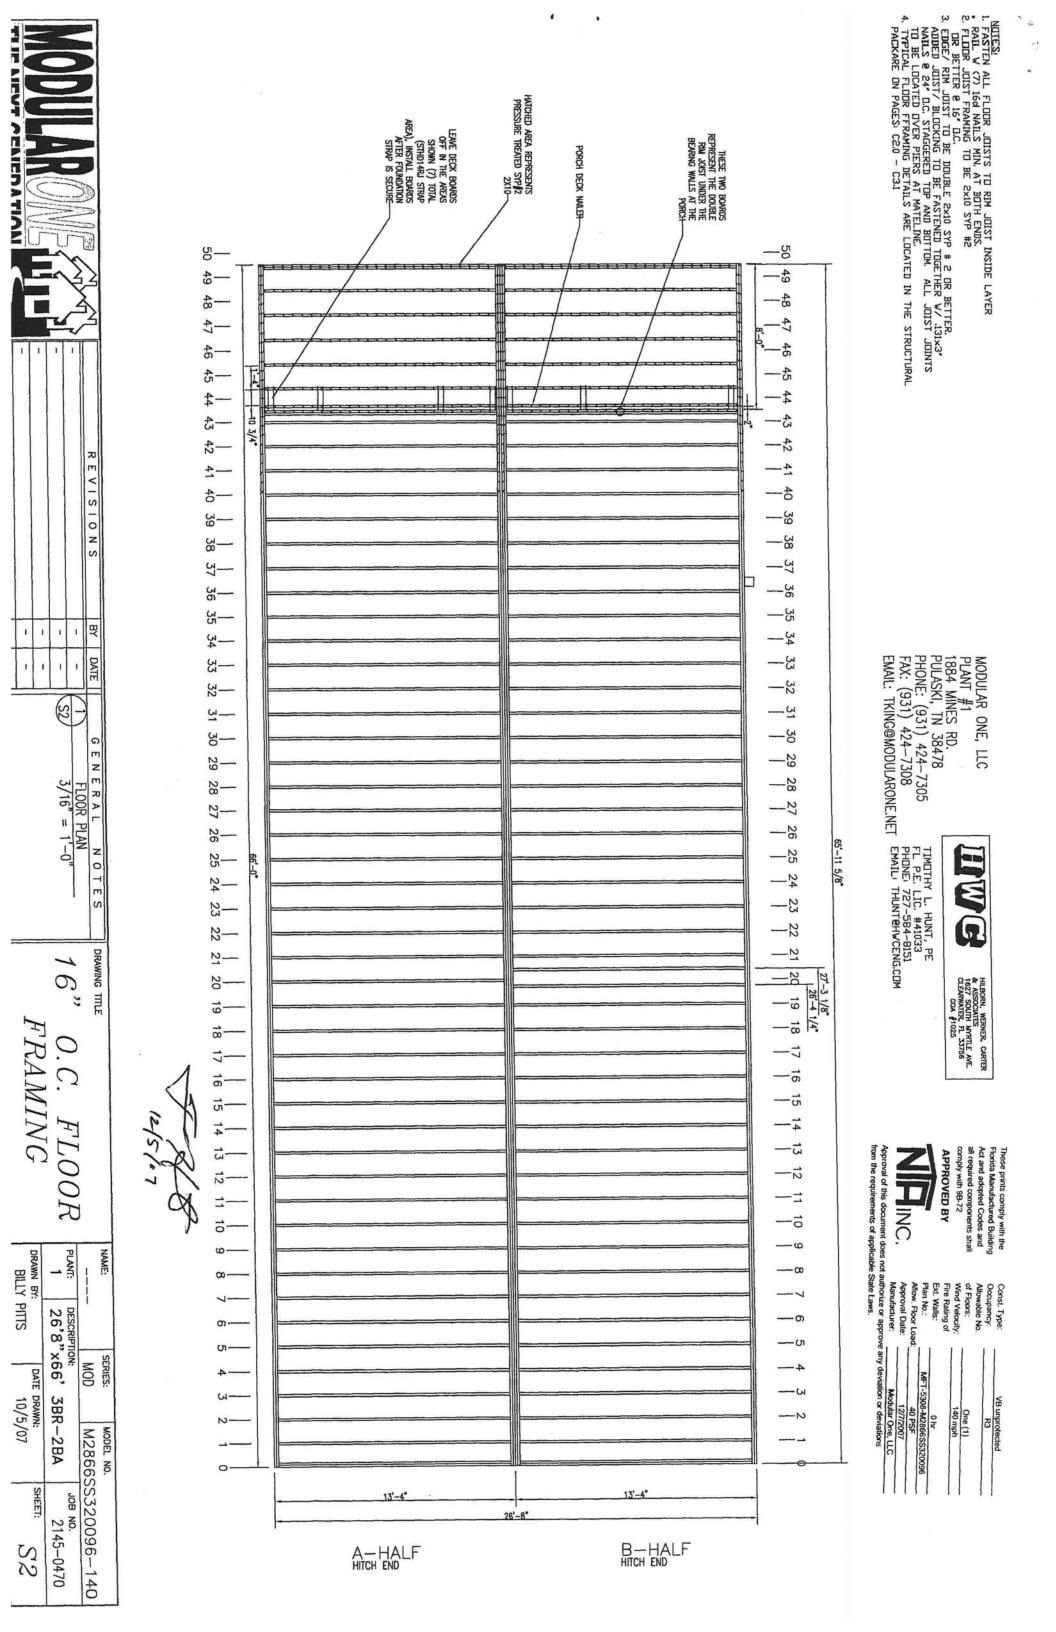

RAMED OPENINGS

EADER SECURMENT 48' MAXIMUM OPENING

*RODET TRUSSES ARE TO BE DOUBLED ON EACH SIDE AND FASTENED TOGETHER W/


*RODET TRUSSES ARE TO BE DOUBLED ON EACH SIDE AND BOTTOM OR 14 GA. STAPLES @ 20'


O.C. STAGGERED TOP AND BOTTOM.

DOUBLE HEADERS TO BE FASTENED TOGETHER W/ .131x3' PD NAILS @ 24' O.C.

STAGGERED TOP AND BOTTOM OR 14 GA. STAPLES @ 20' O.C. STAGGERES TOP

AND BOTTOM. NOTE: GABLE END WALLS
ARE 2X6 SYP#2, STUDS 16*
D.C., SHEATHED BOTH SIDES
WITH 7/16' OSB CABLE END WALL-10 14" MICROLLAM 14" MICROLLAM 8'-4 1/2" 8'-4 1/2" -CABLE DID WALL CABLE NO WALL BRACING 1x4 SHF # 2 8' LONG EVISIO 27 MINIMUM, 4 O.C. AT BOTTOM AND TOP CHORD OF TRUSS (TYP.) 3, FASTEN HEADERS TO JOIST W/ (5) .131x3" NAILS OR (9) 14 GA. STAPLES BEFORE ADDING 2nd JOIST.
4, (TYPICAL) CONNECTION HEADER TO CUT JOIST W/ (5) .131x3" NAILS OR (9) 14 GA. STAPLES N S 21'-6 3/4" 21'-6 3/4" 288 228 ВΥ 1 DATE 24" O.C. ROOF 3/16" = 1'-0" GENERAL NOTES MODULAR ONE, LLC
PLANT #1
1884 MINES RD.
PULASKI, TN 38478
PULASKI, TN 38478
PHONE: (931) 424-7308
FAX: (931) 424-7308 EMAIL: TKING@MODULARONE.NET 24" VED B opted Co 4" O.C. BOTTC CHORD PLAN 22'-1 1/2" 18" MICROLLAM 22'-1 1/2 18 NICROLLAM Const. Type:
Occupancy:
Allowable No
of Floors:
Wad Velocit DRAWING TITLE TIMOTHY L. HUNT, PE FL P.E. LIC. #41033 PHONE: 727-584-8151 EMAIL: THUNTEHWCENG.COM HWG 0 hr MFT-5308-M2866 40 PSF 12/7/200 Mcdular One deviation or deviati One (1) unprote R3 HILBORN, WERNER, CARTER & ASSOCIATES
1827 SOUTH MYRTLE AVE.
CLEARWATER, FL 33756
COA \$1025 PLANT: BILLY PITTS NAME: DESCRIPTION: 26'8"x66' 3BR-2BA 13'-11 1/4" 2X8 13'-11 1/4" 2X8 SERIES: MOD DATE DRAWN: 10/5/07 MODEL NO. M2866SS320096-140 Ē F. SHEET: JOB NO. 2145-0470 10-10" LE BND WALL LE BND WALL B-HALF A-HALF S3

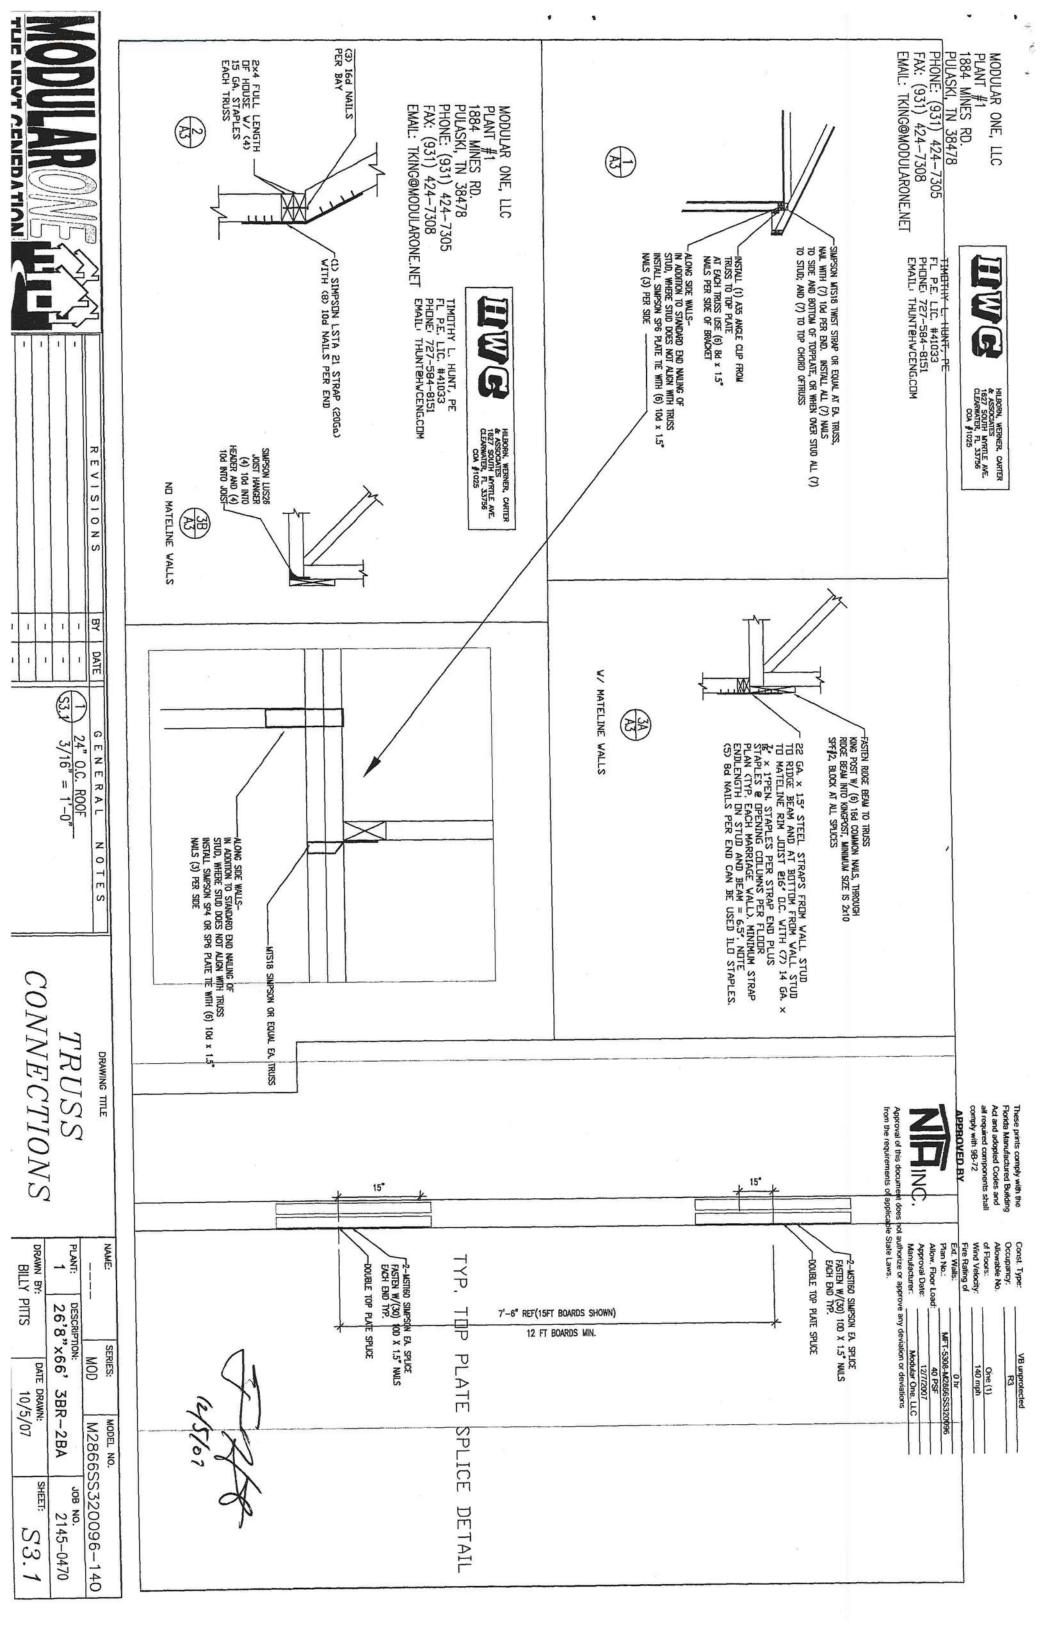

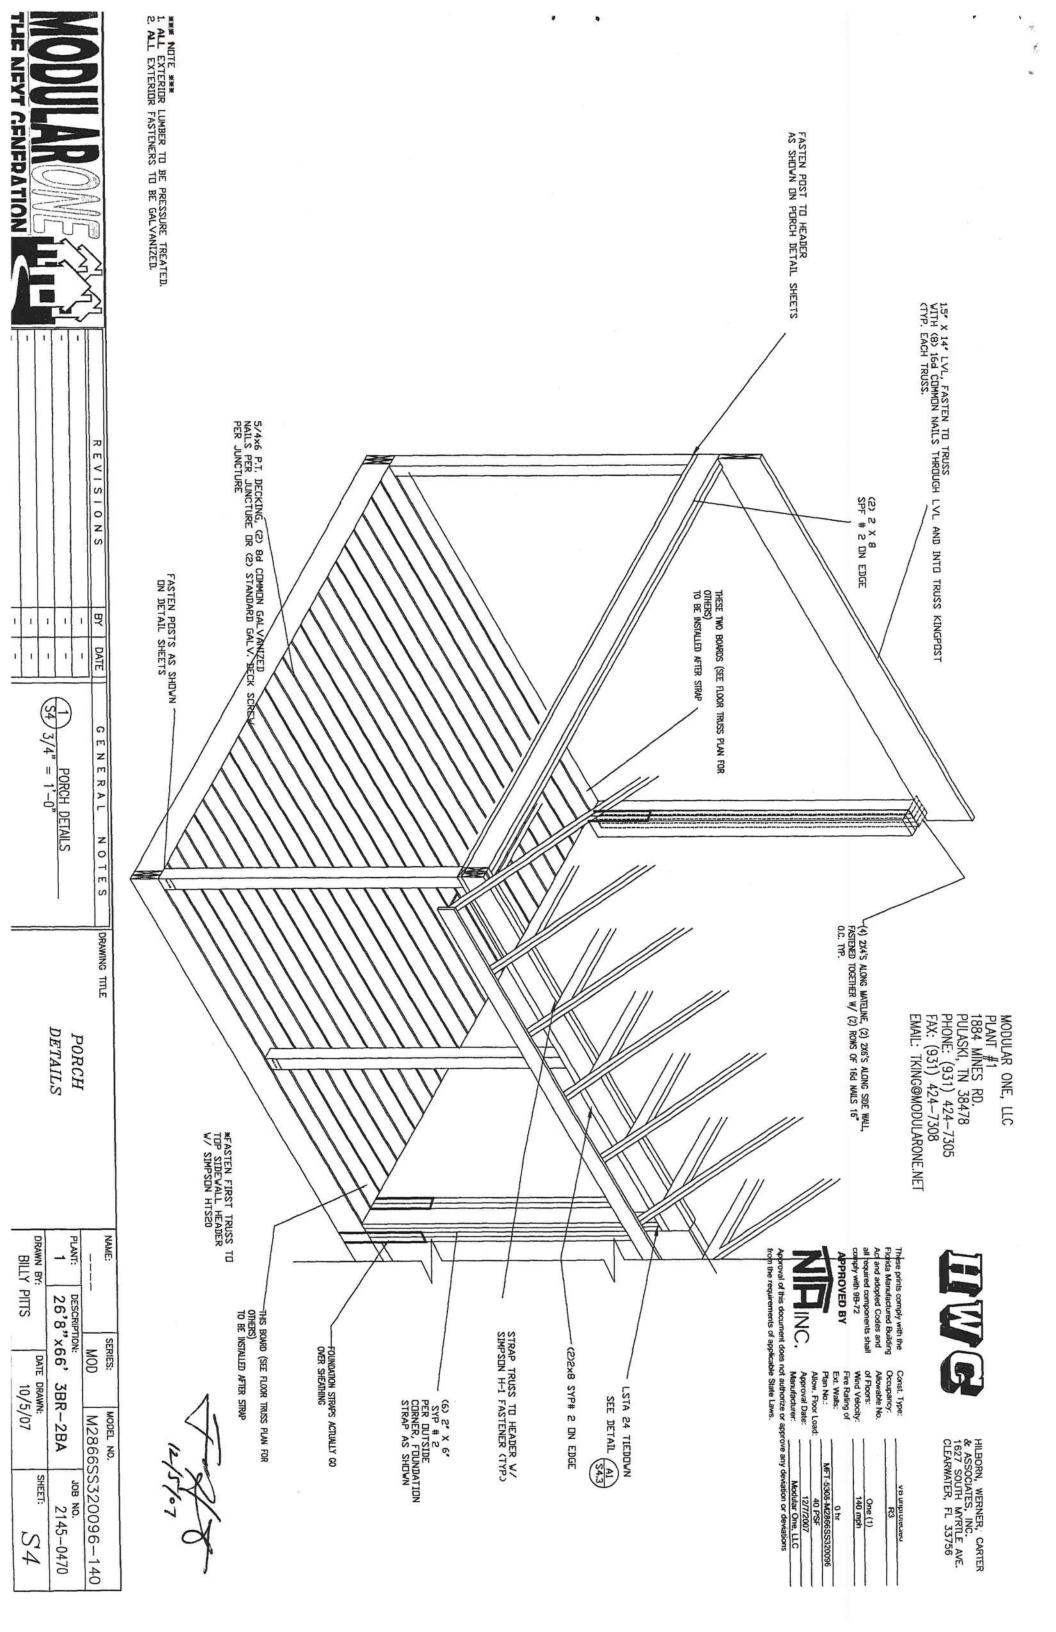

MODULAR ONE, LLC PLANT #1 1884 MINES RD. PULASKI, TN 38478 PHONE: (931) 424-7305 FAX: (931) 424-7308 PHONE: (931) 424-7305

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FL P.E. LIC. #41033

PHONE: 727-584-8151

EMAIL: TKING@MODULARONE.NET EMAIL: THUNT@HWCENG.COM

HWG

HILBORN, WERNER, CARTER & ASSOCIATES
1627 SOUTH MYRTLE AVE.
CLEARWATER, FL 33756
COA \$1025

These prints comply with the Florida Manufactured Building Act and adopted Codes and all required components shall comply with 9B-72


APPROVED BY I INC. Const. Type:
Occupancy:
Allowable No.
of Floors:
Wind Velocity:
Fire Rating of
Ext. Walls:
Plan No.:
Allow. Floor Load:

VB unprotected R3

One (1) 140 mph

0 hr MFT-5308-M2866SS320096

Approval of this document does not authorize or approve any deviation or deviations from the requirements of applicable State Laws. Approval Date: Manufacturer:

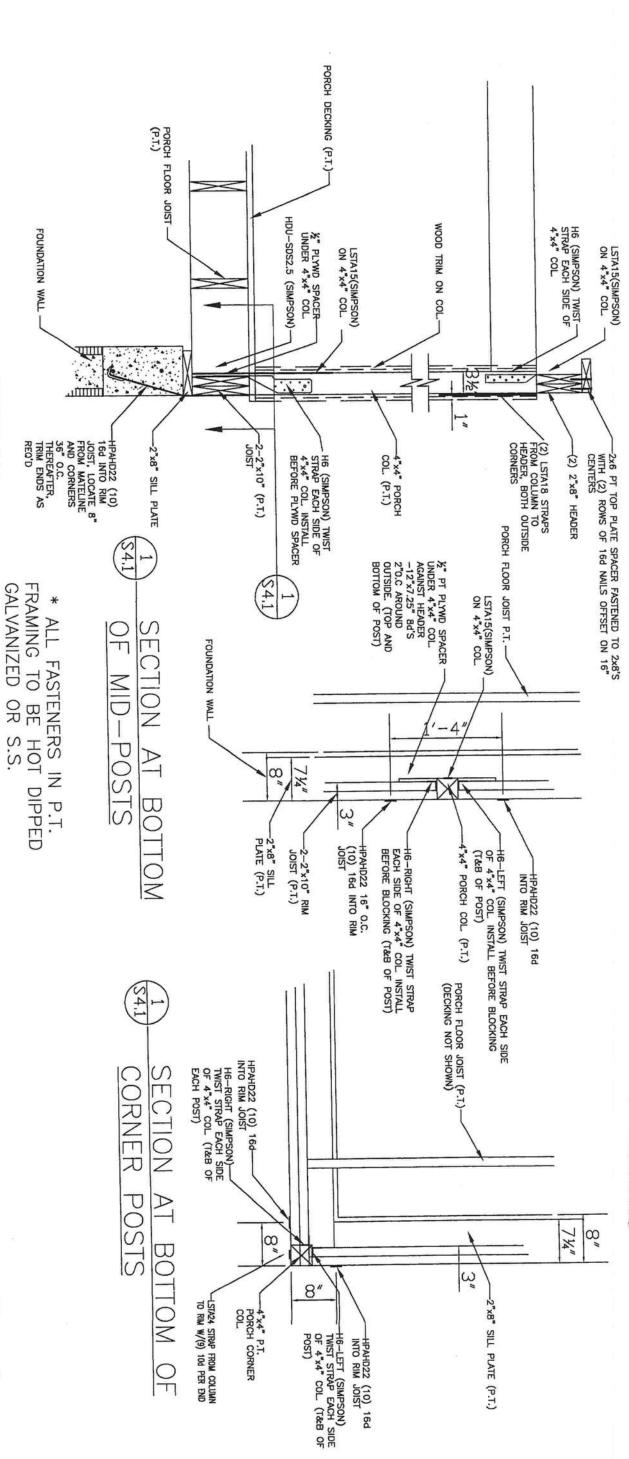

*** NOTE ***

1. ALL EXTERIOR LUMBER TO BE PRESSURE TREATED.
2. ALL EXTERIOR FASTENERS TO BE GALVANIZED.

OOKING

FROM

SIDEWALL

EVATION SECTION

SCNICONTION IN COMME					
					REVISIONS
-	1	1	1	1	망
1	1	,	•	1	DATE
			94.73/4 = 1-0	PORCH DETAILS	GENERAL

DRAWING TITLE SIMPSON HPAHD22 AN RIM JOIST TO FOUND TIEDOWN OPTION **PORCH**

OTES

<i>VCHORS</i>	DATION 1:		
BILLY PITTS	PLANT:	!	NAME:
PITTS	26'8"x66'	_	10
DATE	6,	MOD	SERIES:
DATE DRAWN: 10/5/07	3BR-2BA	M2866S	MODEL NO.
S4.1	JOB NO. 2145-0470	M2866SS320096-140	

PLANT #1 1884 MINES RD. PULASKI, TN 38478 PHONE: (931) 424-7305 FAX: (931) 424-7308 EMAIL: TKING@MODULARONE.NET MODULAR ONE, LLC

HWG

HILBORN, WERNER, CARTER & ASSOCIATES
1627 SOUTH MYRTLE AVE.
CLEARWATER, FL 33756
COA \$1025

*** NOTE ***

1. ALL EXTERIOR LUMBER TO BE PRESSURE TREATED.
2. ALL EXTERIOR FASTENERS TO BE GALVANIZED.


Const. Type:
Occupancy:
Allowable No.
of Floors:
Wind Velocity:

VB unprotected R3

One (1) 140 mph

Fire Rating of Ext. Walls:



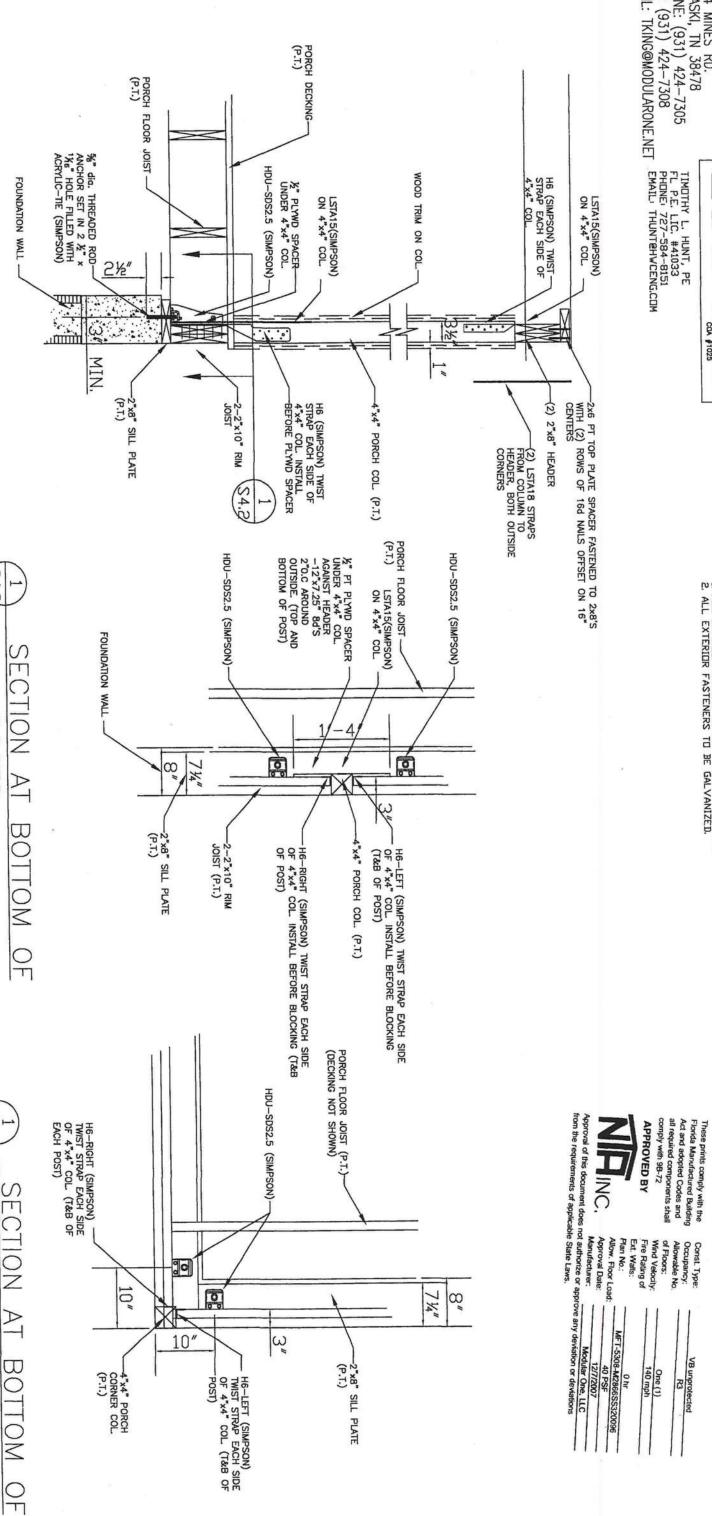

DRAWING TITLE RIM JOIST TO FOUNDATION SIMPSON HDU-SDS2.5 TIEDOWN OPTION 2: PORCH

THE NEXT CENERATION

OOKING

T ROM

REVISIONS

BA

DATE

GENERAL

NOTES

PORCH TIEDOWN DETAILS $3/4^n = 1'-0^n$

1

EVATION

SECTION

\$4.9


-POSTS


S4.8

CORNER

NAME: PLANT: DESCRIPTION: 26'8"x66' 3BR-2BA SERIES: MOD M2866SS320096-140 SHEET: JOB NO. 2145-0470 S4.2

BILLY PITTS DATE DRAWN: 10/5/07

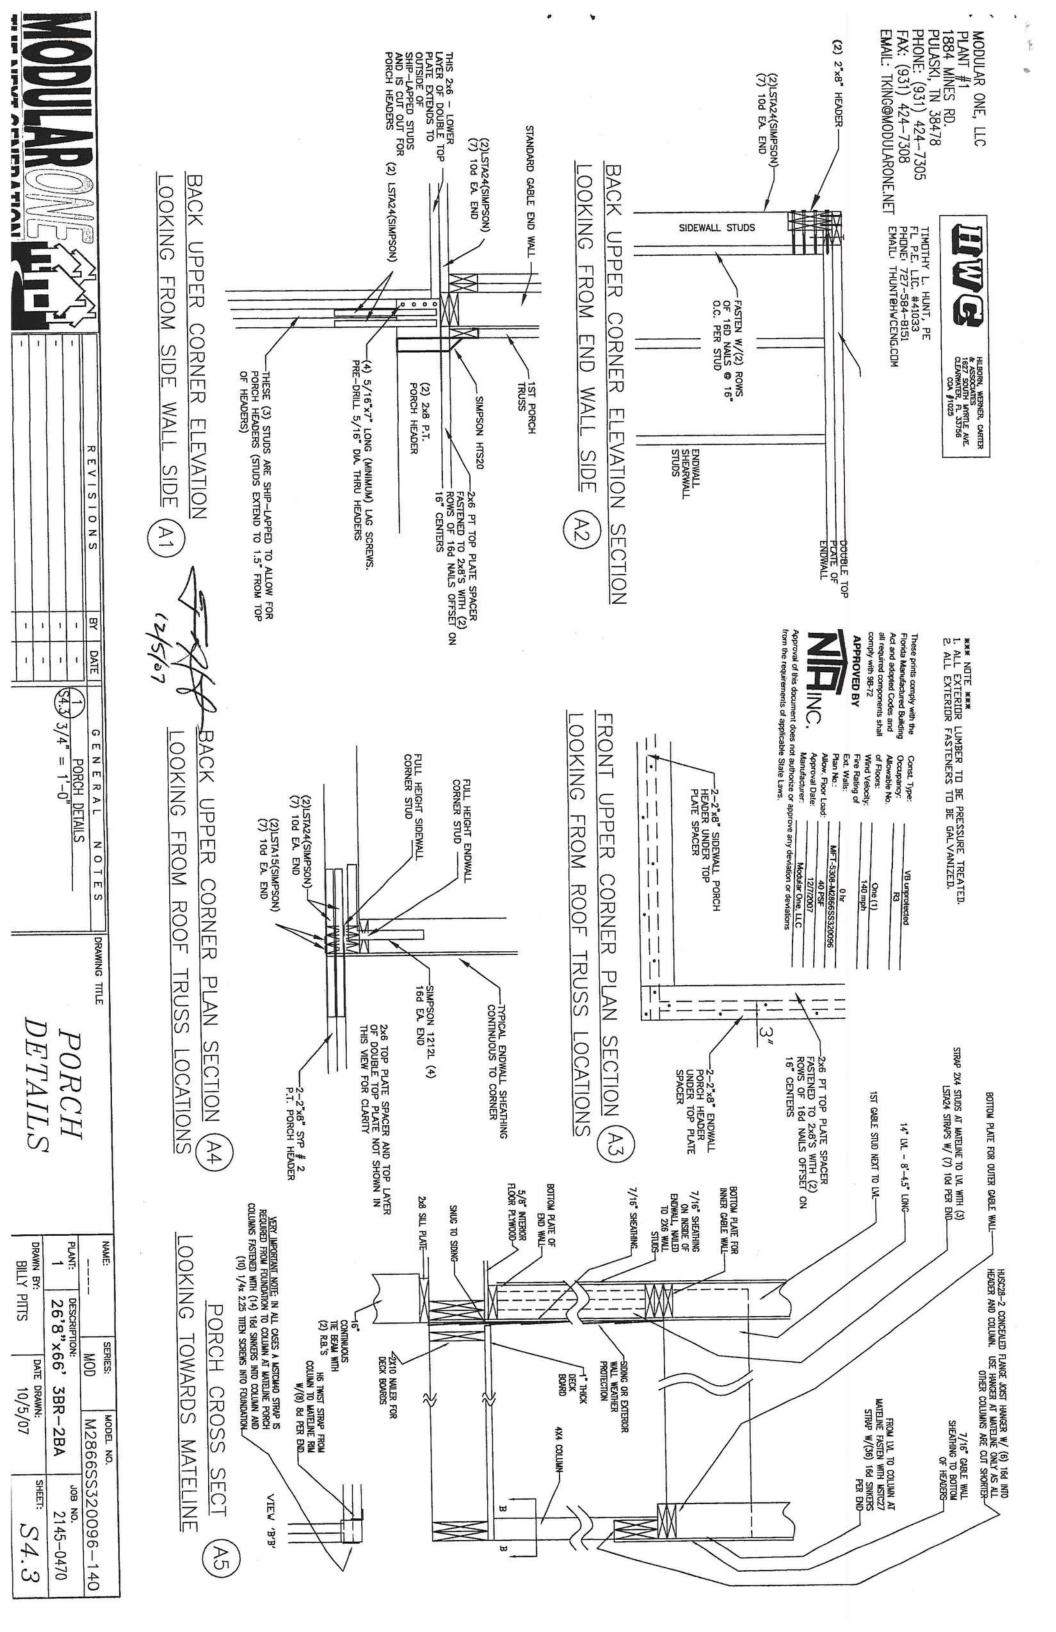

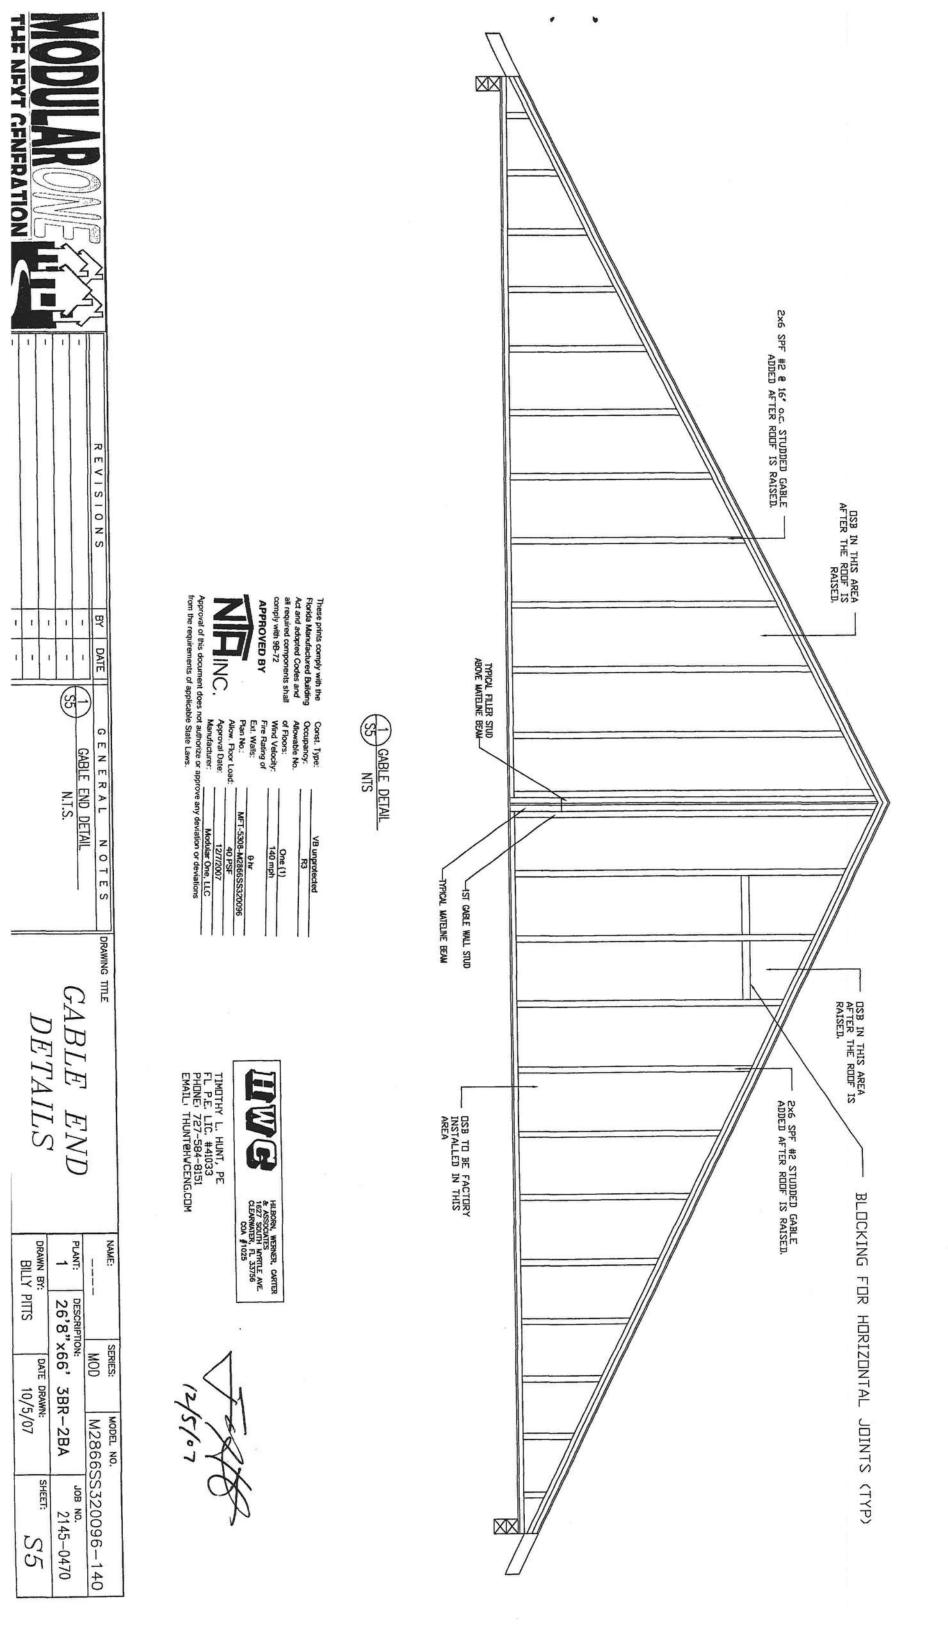

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