



REVISIONS	

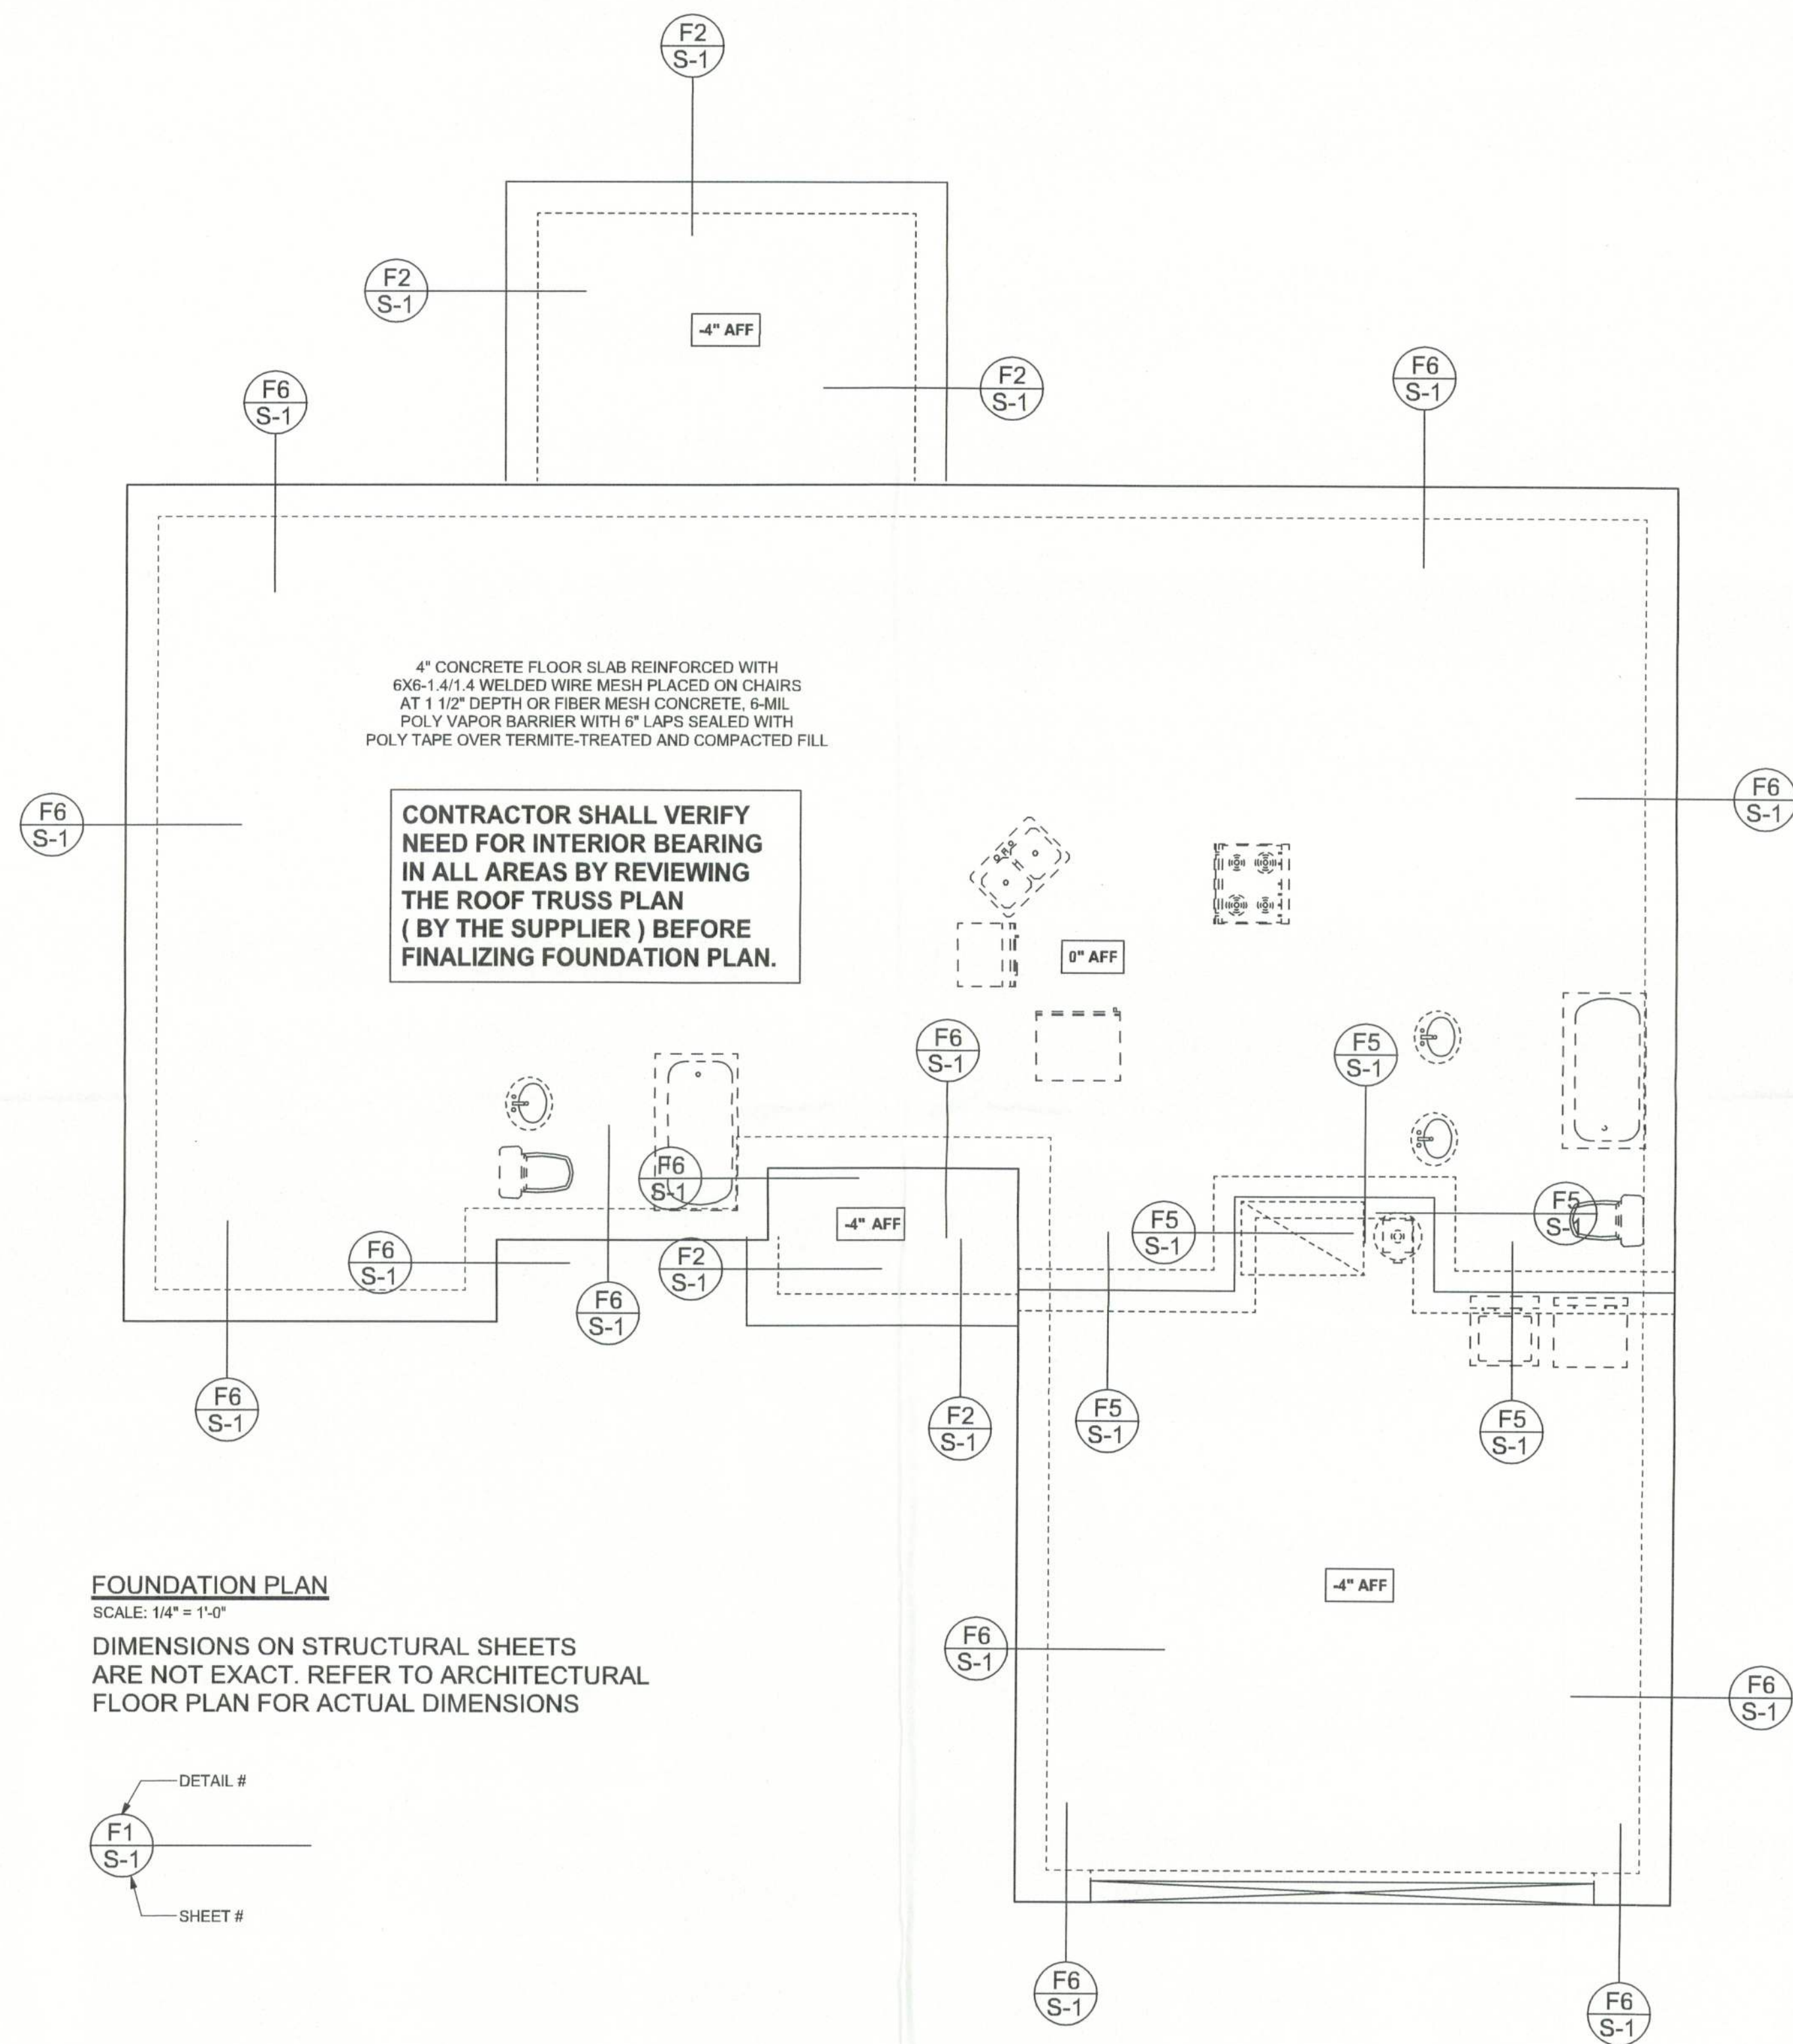

FOUNDATION PLAN
 SCALE: 1/4" = 1'-0"
 DIMENSIONS ON STRUCTURAL SHEETS
 ARE NOT EXACT. REFER TO ARCHITECTURAL
 FLOOR PLAN FOR ACTUAL DIMENSIONS

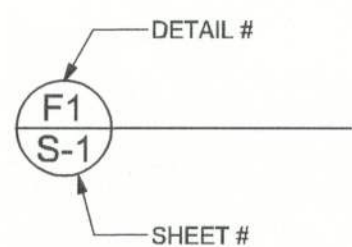

WINDLOAD ENGINEER: Mark Disosway,
 P.E. No. 53915, P.O. Box 868, Lake City, FL
 32056, 386-754-5419

DIMENSIONS:
 Stated dimensions supercede scaled
 dimensions. Refer all questions to
 Mark Disosway, P.E. for resolution.
 Do not proceed without clarification.

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 permission and consent of Mark Disosway.

CERTIFICATION: These plans and
 "Windload Engineering" Sheet S-1, attached,
 comply with Florida Building Code 2004,
 Section 1609 wind loads, to the best of my
 knowledge.

LIMITATION: This design is valid for one
 building at specified location. In case of conflict,
 structural requirements, scope of work, and
 builder responsibilities on sheet S-1 control.

MARK DISOSWAY
 P.E. 53915

Mark Disosway
 INNOVOS
 SEAL

**Cornerstone
 Development**

The Thomas Model

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PRINTED DATE:
 November 16, 2005

DRAWN BY: Evan Beasley	CHECKED BY:
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JOB NUMBER:
 511104

DRAWING NUMBER
 S-2
 OF 2 SHEETS