



CONSTRUCTION PLANS FOR:

BUSY BEE NO. 7 SERVICE AREA EXPANSION



sunshine state

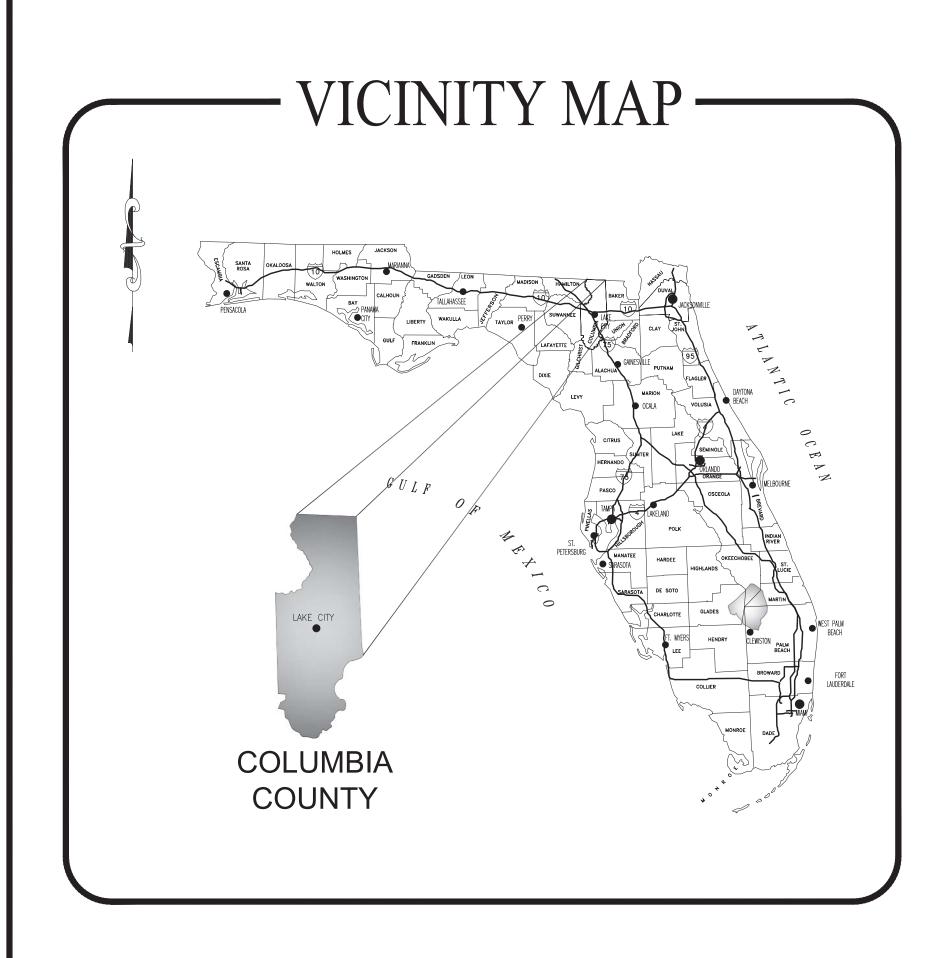




JOHNSON & JOHNSON, INC.

COLUMBIA COUNTY, FLORIDA

CONSTRUCTION DOCUMENTS



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SHEET NO.	SHEET DESCRIPTION:
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L1	LANDSCAPE PLAN

OWNER, DEVELOPER, AGENT

OWNER/DEVELOPER:

JOHNSON & JOHNSON, INC. P.O. BOX 157 MADISON, FLORIDA 32341 (850) 973-2277

ENGINEER/AGENT

DEWBERRY ENGINEERS, INC. 101 N. MONROE ST., SUITE 710 TALLAHASSEE, FL 32301 PHONE 850.523.0062

SITE ADDRESS:

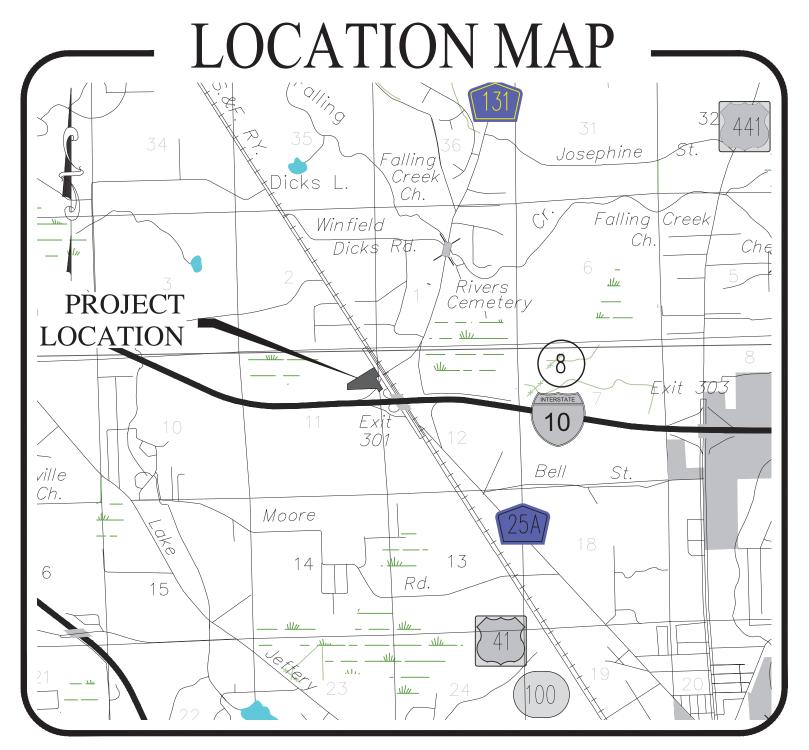
4772 NW US HIGHWAY 41 LAKE CITY, FL 32055

PREPARED BY: Dewberry®

101 N. MONROE ST., SUITE 710, TALLAHASSEE, FL 32301 850.523.0062

PROJECT NUMBER - 50136924

AUGUST 2021



ERRORS AND OMISSIONS, IF ANY, IN THESE CONSTRUCTION DOCUMENTS SHALL IMMEDIATELY BE BROUGHT TO THE ATTENTION OF THE ENGINEER FOR RESOLUTION.

GENERAL CONTRACTOR TO THOROUGHLY INSPECT EXISTING CONDITIONS PRIOR TO SUBMITTING BIDS. ANY DISCREPANCIES BETWEEN PLANS AND FIELD CONDITIONS SHALL BE NOTED AT ONCE AND CALLED TO THE ENGINEER'S ATTENTION 48 HOURS PRIOR TO SUBMITTING BIDS.

ALL CORRESPONDENCE IN REGARDS TO THESE CONSTRUCTION / BID DOCUMENTS SHALL BE DIRECTED TO WLILLIAM A. MENADIER, P.E. AT DEWBERRY ENGINEERS, INC. 654 SOUTHEAST BAYA DR. LAKE CITY, FLORIDA 32025

GOVERNING STANDARDS AND SPECIFICATIONS: FLORIDA DEPARTMENT OF TRANSPORTATION, DESIGN STANDARDS LATEST EDITION, AND STANDARD SPECIFICATIONS FOR ROAD AND BRIDGE CONSTRUCTION LATEST EDITION, AS AMENDED BY CONTRACT DOCUMENTS. For Design Standards Modifications click on "Design Standards" at the following web site: http://www.dot.state.fl.us/rddesign/

William A. Menadier, PE Date: 2021.09.02 15:57:54 -04'00'

Digitally signed by William A. Menadier, PE

THIS ITEM HAS BEEN DIGITALLY SIGNED AND SEALED BY WILLIAM A. MENADIER, PE. ON THE DATE NOTED ON THE ELECTRONIC SIGNATURE.

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WILLIAM A. MENADIER, P.E. NO. 74581

DATE:

GENERAL NOTES

- 1) THE CONTRACTOR SHALL LOCATE AND VERIFY ALL EXISTING UTILITIES, PRIOR TO COMMENCING CONSTRUCTION ACTIVITIES. THE CONTRACTOR SHALL COORDINATE THE RELOCATION OF ANY AND ALL UTILITIES, AS REQUIRED BY THE PLANS AND UTILITY COMPANIES, TO CONSTRUCT THE PROPOSED IMPROVEMENTS. UNLESS OTHERWISE NOTED, CONTRACTOR SHALL ALSO BE RESPONSIBLE FOR THE COST OF SAID RELOCATION. CONTRACTOR SHALL ALSO NOTIFY UTILITY OWNERS THROUGH SUNSHINE ONE CALL (800-432-4770) AT LEAST 2 FULL DAYS PRIOR TO EXCAVATION OR DEMOLITION, AND UTILITY OWNERS NOT COVERED BY THIS PROGRAM.
- 2) MINIMUM COMPACTION SHALL BE PROVIDED FOR THE PROPOSED PAVEMENT AND SURROUNDING AREAS BY THE GEOTECHNICAL ENGINEER. ANY BORROW MATERIAL SHALL, IF REQUIRED, BE PROVIDED BY THE CONTRACTOR BASED ON GEOTECHNICAL FINDINGS AND RECOMMENDATIONS. CONTRACTOR SHALL UTILIZE SUITABLE SOIL ON SITE FOR ANY BORROW MATERIAL. FOLLOWING FINAL GRADING, ANY STOCKPILED TOPSOIL SHALL BE SPREAD OVER DISTURBED AREAS OR OWNERS PROPERTY AS NEEDED. THE SOIL SHALL BE STABILIZED AS SPECIFIED IN SWPPP TO PREVENT EROSION ON SITE. GEOTECHNICAL INVESTIGATION CONDUCTED BY NB GEO SERVICES, LLC, LAKE CITY, FL, #16-00002.
- 3) WHERE REFERENCE IS MADE TO A STANDARD INDEX OR DETAIL, THE FDOT DESIGN STANDARDS, CURRENT EDITION, SHALL BE UTILIZED AS IF A PART OF THESE PLANS. CONTRACTOR MAY SUBSTITUTE FDOT ITEMS FOR THE INFRASTRUCTURE CONSTRUCTION; ANY SUBSTITUTIONS SHALL HAVE A 50 YEAR LIFESPAN. CONTRACTOR/OWNER WILL BE REQUIRED TO PROVIDE DESIGNS OR VERIFICATION OF SUBSTITUTE. ALL SIGNS REFERRED TO IN THE PLANS SHALL BE IN ACCORDANCE WITH MUTCD (MANUAL OF UNIFORM TRAFFIC CONTROL DEVICES) LATEST EDITION.
- 4) UNLESS OTHERWISE NOTED OR DETAILED ON THE PLANS OR IN THE SPECIFICATIONS, THE FDOT STANDARD SPECIFICATIONS FOR ROAD AND BRIDGE CONSTRUCTION, CURRENT EDITION, SHALL BE THE GOVERNING SPECIFICATIONS FOR MATERIALS AND CONSTRUCTION FOR SITE WORK.
- 5) NO MUNICIPAL WATER OR SEWER SYSTEM IS AVAILABLE. THE DEVELOPMENT SHALL UTILIZE AN ON-SITE WELL FOR DOMESTIC WATER AND A SEPTIC TANK AND DRAINFIELD FOR SANITARY WASTE AND TREATMENT. CONSTRUCTION SHALL COMPLY WITH COLUMBIA COUNTY SPECIFICATIONS, AS WELL AS THE REQUIREMENTS OF THE FLORIDA DEPARTMENT OF ENVIRONMENTAL PROTECTION AND COUNTY DEPARTMENT OF HEALTH.
- 6) THE CONTRACTOR SHALL COMPLY WITH ALL LOCAL, STATE, AND FEDERAL REGULATIONS. THE CONTRACTOR SHALL ALSO MAINTAIN EROSION CONTROL DEVICES DURING CONSTRUCTION TO PREVENT SEDIMENT FROM LEAVING THE PROJECT SITE AND ENTERING THE STORMWATER POND. THE EROSION CONTROL DEVICES SHOWN ON THE EROSION CONTROL (SWPPP) PLANS ARE THE MINIMUM REQUIRED AND SHALL BE MAINTAINED IN ACCORDANCE WITH ALL APPLICABLE REGULATIONS. ADDITIONAL EROSION CONTROLS MAY BE REQUIRED BY THE INSPECTOR TO CONTROL SEDIMENTS AND SHALL BE THE RESPONSIBILITY OF THE CONTRACTOR. ALL STORMWATER RUNOFF SHALL BE CONTROLLED DURING THE COURSE OF CONSTRUCTION IN SUCH A MANNER AS TO PREVENT DAMAGE OR DETRIMENTAL HARM TO OFFSITE PROPERTIES. THE CONTRACTOR SHALL REFER TO THE "FLORIDA STORMWATER EROSION AND SEDIMENT CONTROL INSPECTORS MANUAL" FOR ADDITIONAL EROSION CONTROL MEASURE AND ALTERNATIVES. CONTRACTOR SHALL SEEK APPROVAL FROM THE ENGINEER OF RECORD FOR ANY SUBSTITUTIONS TO THE EROSION CONTROL MEASURES.
- 7) ALL DISTURBED AREAS SHALL BE STABILIZED PER THE SWPPP. DISTURBED AREAS OUTSIDE THE SILT FENCED PERIMETER SHALL BE STABILIZED IMMEDIATELY AFTER FINAL GRADE IS ACHIEVED. ALL DISTURBED AREAS TO BE LEFT IDLE FOR MORE THAN 14 DAYS SHALL BE STABILIZED WITH QUICK GROW GRASS SEED AND MULCH. THE CONTRACTOR SHALL WARRANTY LANDSCAPING FOR A MINIMUM OF 1 YEAR AFTER ACCEPTANCE UNLESS OTHERWISE NOTED.
- 8) AS-BUILTS ARE THE RESPONSIBILITY OF THE CONTRACTOR. IF THE AS-BUILT SURVEY INDICATES AN AREA OF INCOMPLETE OR UNACCEPTABLE WORK, THE CONTRACTOR IS RESPONSIBLE FOR PERFORMING THE NECESSARY REPAIRS, AS DIRECTED BY THE ENGINEER, OR COLUMBIA COUNTY. CONTRACTOR WILL BE REQUIRED TO PROVIDE UPDATED AS-BUILTS TO DEMONSTRATE COMPLIANCE WITH THE PLANS AND PERMITS. ALL FINAL AS-BUILT SURVEYS ARE REQUIRED TO BE CERTIFIED BY A FLORIDA REGISTERED PROFESSIONAL. AS-BUILTS ARE REQUIRED TO RECEIVE FINAL C.O.'S. TEMPORARY C.O.'S MAY BE ISSUED PRIOR TO FINAL CLOSE OUT. IF THE CONTRACTOR IS SEEKING TEMPORARY C.O.'S, ALL ASSOCIATED INFRASTRUCTURE, LANDSCAPING, PARKING ETC... SHALL BE COMPLETED.
- 9) ALL WORK WITHIN FDOT RIGHT-OF-WAY SHALL CONFORM TO THE MOST RECENT DEPARTMENT STANDARDS AND SPECIFICATIONS.

CONSTRUCTION SEQUENCE

- 1. CONTRACTOR WILL BE RESPONSIBLE FOR SCHEDULING A PRE-CONSTRUCTION CONFERENCE WITH THE OWNER, COLUMBIA COUNTY, ENGINEER, FDOT AND ALL OTHER PARTIES REQUIRED FOR COMMENCEMENT OF PROJECT. THIS MEETING SHALL TAKE PLACE PRIOR TO COMMENCEMENT OF ANY PROJECT RELATED ACTIVITIES. PRIOR TO ANY CONSTRUCTION THE PERMIT MUST BE POSTED WITHOUT NAILING TO ANY TREE ON SITE. THE NAME AND PHONE NUMBER OF THE SEDIMENT AND EROSION CONTROL OFFICER SHALL BE PROVIDED AT THE PRE CONSTRUCTION MEETING.
- 2. THE CONTRACTOR SHALL ENSURE THAT A FOREMAN OR SUPERVISOR WHO HAS BEEN CERTIFIED UNDER FLORIDA STORMWATER, EROSION, AND SEDIMENTATION CONTROL INSPECTOR TRAINING PROGRAM IS AVAILABLE IN PERSON OR BY TELEPHONE AT ALL TIMES DURING CONSTRUCTION ACTIVITIES. CONSTRUCTION SHALL NOT COMMENCE UNTIL INFORMATION (NAME AND PHONE NUMBER) OF CERTIFIED STORMWATER EROSION AND SEDIMENT CONTROL INSPECTOR HAS BEEN PROVIDED TO THE ENGINEER.
- 3. PRIOR TO DISTURBANCE, A SILT FENCE BACKED WITH 4' HOG WIRE FENCE (TRENCHED 8 INCHES DEEP AND BACKFILLED ON THE UPHILL SIDE), SHALL BE INSTALLED AS SHOWN ON THE PLANS. SILT FENCE MUST NOT BE TRENCHED WITHIN THE CPZ OF ANY TREES TO BE PROTECTED. EROSION CONTROL SHOWN ON PLANS IS REQUIRED. ADDITIONAL SEDIMENT AND EROSION CONTROL MEASURES MAY BE REQUIRED DURING ANY PHASE OF THE DEVELOPMENT, AT THE DISCRETION OF COLUMBIA COUNTY OR THE ENGINEER. COLUMBIA COUNTY MAY REQUIRE ADDITIONAL MEASURES TO PREVENT ADDITIONAL EROSION CONTROL. CONTRACTOR SHALL PROVIDE OUTLET PROTECTIONS FOR SEDIMENTS THAT MAY ENTER THE STORMWATER FACILITY. CONTRACTOR WILL BE RESPONSIBLE FOR CLEANING THE POND AFTER CONSTRUCTION TO REMOVE ALL SEDIMENT AND GRADE TO PROPOSED ELEVATIONS. CONTRACTOR WILL BE RESPONSIBLE FOR THE CONDITION OF THE POND DURING CONSTRUCTION AND SHALL USE A TURBIDITY BARRIER AT EACH POND CONNECTION TO PREVENT SEDIMENTATION ENTERING THE POND.
- 4. DISTURBED PORTIONS OF THE SITE WHERE CONSTRUCTION ACTIVITIES HAVE PERMANENTLY CEASED SHALL BE STABILIZED WITH PERMANENT SOD OR OTHER PERMANENT STABILIZATION METHODS.
- 5. CREATE DIVERSION CHANNELS IF NECESSARY TO DIRECT STORM WATER FLOW TO THE CONVEYANCE SYSTEM. CONSTRUCT HAY BALE CHECK DAMS WHERE NEEDED TO TRAP SEDIMENT BEFORE IT REACHES THE CONVEYANCE SYSTEM OR POND. DO NOT BLOCK ACCESS DRIVES.
- 6. CARE SHALL BE TAKEN TO ASSURE THE REMOVAL OF ACCUMULATED FINE SEDIMENTS FROM THE POND AND THAT THE EXCESSIVE COMPACTION OF SOIL BY CONSTRUCTION MACHINERY IS AVOIDED. INLET(S)/OUTFALLS SHALL BE PROTECTED WITH FILTER FABRIC AND PROPERLY INSTALLED HAY BALES.
- 7. ALL SEDIMENT IS TO BE CAPTURED ON THE PROJECT SITE. ANY SEDIMENT ESCAPING THE PROJECT SITE WILL BE REQUIRED TO BE REMOVED AND RESTORED INCLUDING THE TRACKING OF SOIL ON STREETS. THIS INCLUDES SEDIMENT INTO COUNTY & STATE WATERS AND THE POND. CONTRACTOR WILL BE RESPONSIBLE FOR ANY SEDIMENT ENTERING THE COUNTY AND STATE WATERS OR POND AND WILL BE RESPONSIBLE FOR ITS REMOVAL.
- 8. DAILY SWEEPING WILL BE REQUIRED ON THE SITE AND IMMEDIATELY AFTER STORM EVENTS TO PREVENT TRACKING OF SEDIMENT ON TO STREETS AND RIGHT OF WAY OR POND.
- 9. TWO WEEKS PRIOR TO FINAL INSPECTION, THE CONTRACTOR SHALL HAVE A WALK THROUGH WITH THE ENGINEER AND FDOT AND A PUNCH LIST SHALL BE PREPARED. ONCE ALL PUNCH LIST ITEMS ARE ADDRESSED TO SATISFY THE PERMIT CONTRACTOR SHALL ALSO SCHEDULE A WALK THROUGH WITH THE OWNER, ENGINEER AND COLUMBIA COUNTY UPON COMPLETION.
- 10. CONTRACTOR SHALL PAY FOR AND PROVIDE THE ENGINEER WITH TWO (2) COPIES OF A SIGNED AND SEALED AS-BUILT SURVEY OF ALL INFRASTRUCTURE, STORMWATER FACILITY AND ASSOCIATED CONVEYANCES, INCLUDING LANDSCAPE IMPROVEMENTS AND ELECTRONIC CADD FILE.

MAINTENANCE AND INSPECTION SCHEDULE

- 1) EROSION CONTROL MEASURES SHALL BE INSPECTED AT LEAST ONCE A WEEK AND AFTER EVERY 1/2" OF RAINFALL. REQUIRED REPAIRS SHALL BE MADE IMMEDIATELY. SEDIMENT DEPOSITS SHALL BE REMOVED WHEN THEY REACH APPROXIMATELY ONE-HALF THE HEIGHT OF THE BARRIER.
- 2) SYNTHETIC HAY BALES SHALL BE USED IN AREAS WHERE EFFECTIVENESS IS REQUIRED FOR LESS THAN 3 MONTHS. INSPECTION OF THE SYNTHETIC HAY BALES SHALL TAKE PLACE IMMEDIATELY AFTER EACH RAINFALL AND ANY REQUIRED REPAIRS SHALL BE MADE IMMEDIATELY. SYNTHETIC HAY BALES SHALL BE PER FDOT SPECIFICATIONS.
- 3) INLET(S)/OUTFALLS SHALL BE INSPECTED IMMEDIATELY AFTER EACH RAIN EVENT AND ANY REQUIRED REPAIRS TO THE HAY BALES, SILT FENCE, OR FILTER FABRIC SHALL BE PERFORMED IMMEDIATELY.
- 4) BARE AREAS OF THE SITE THAT WERE PREVIOUSLY SEEDED OR SODDED SHALL BE RESEEDED OR RESODDED PER MANUFACTURES' INSTRUCTIONS.
- 5) MULCH AND SOD THAT HAS BEEN WASHED OUT SHALL BE REPLACED IMMEDIATELY. CONTRACTOR SHALL PIN SOD ON SLOPES STEEPER THAN 3:1
- 6) MAINTAIN ALL AREAS OF THE SITE WITH PROPER CONTROLS AS NECESSARY OR REQUIRED BY COLUMBIA COUNTY.
- 7) IF PROPOSED EROSION AND SEDIMENTATION CONTROLS ARE FOUND INEFFECTIVE OR IN NEED OF MAINTENANCE, THE COUNTY MAY DIRECT INSTALLATION OF ADDITIONAL MEASURES TO PROTECT THE ENVIRONMENT. THE ENGINEER SHALL FURNISH THE CONTRACTOR WITH INFORMATION PERTAINING TO THE CONSTRUCTION, OPERATION AND MAINTENANCE OF EROSION AND SEDIMENTATION CONTROL PRACTICES PER FLORIDA ADMINISTRATIVE CODE CHAPTER 62-25.025(7).

CONTRACTOR SHALL CONTROL EROSION WITHIN THE PROJECT LIMITS SUCH THAT THERE ARE NO NEGATIVE IMPACTS DOWNSTREAM OF THE PROJECT DUE TO UNCONTROLLED EROSION OR SEDIMENTATION. SHOULD ADDITIONAL BMP'S BE REQUIRED TO CONTROL EROSION AND SEDIMENTATION. THE CONTRACTOR SHALL PROVIDE A SUPPLEMENTARY STORMWATER POLLUTION PROTECTION PLAN WITH APPROPRIATE BMP'S PLACED AS NEEDED. CONTRACTOR SHALL BE RESPONSIBLE FOR THE ESCAPE OF SEDIMENT FROM THE SITE AND SHALL BE HELD RESPONSIBLE FOR ANY AND ALL IMPACTS RESULTING FROM SUCH EVENTS. CONTRACTOR SHALL BE RESPONSIBLE FOR THE REPAIR OF DOWNSTREAM IMPACTS DUE TO THE RELEASE OF SEDIMENTS FROM THE SITE INCLUDING BUT NOT LIMITED TO SEDIMENTATION AND EROSION THAT MAY RESULT FROM THE BUILDUP OF SUCH SEDIMENTS DOWNSTREAM OF THE PROJECT. CONTRACTOR SHALL FULLY BEAR THE FINANCIAL COST OF ANY PENALTIES OR FINES RESULTING FROM SUCH EVENTS.

ONSITE SEWAGE DISPOSAL SYSTEM

- 1. ANY ONSITE SEWAGE DISPOSAL SYSTEM SHALL BE IN ACCORDANCE W/ COLUMBIA COUNTY DEPARTMENT OF HEALTH AND F.A.C.
- 2. CONTACT COLUMBIA COUNTY DEPARTMENT OF HEALTH AT (386) 758-1068 FOR MORE INFORMATION.

CIVIL SHOP DRAWINGS

- 1. THE CONTRACTOR SHALL SUBMIT THE FOLLOWING SHOP DRAWINGS FOR APPROVAL TO THE CIVIL ENGINEER. HARD COPIES MAY BE SENT TO JOSHUA BAXLEY, P.E. AT 654 SOUTHEAST BAYA DRIVE, LAKE CITY, FL 32025. ELECTRONIC COPIES ARE ALSO ACCEPTABLE AND MAY BE SENT TO JBAXLEY@DEWBERRY.COM. PLEASE CONFIRM RECEIPT OF ELECTRONIC COPIES WITH ENGINEER. IT SHOULD BE NOTED ADDITIONAL SHOP DRAWINGS MAY BE REQUIRED BY OTHER DISCIPLINES.
- A) ASPHALT MIX DESIGN
- B) CONCRETE MIX DESIGNC) WATER DISTRIBUTION SYSTEM PIPING
- D) BACKFLOW PREVENTION DEVICES
- E) SANITARY AND GREASE WASTE SYSTEM DISTRIBUTION PIPING
- F) STORM OUTFALL CONTROL STRUCTURE AND STORM PIPING
- G) PROVIDE RESULTS OF COMPACTION TESTING IN PAVEMENT AREAS, ONE TEST PER 5,000 SF

CIVIL GEOTECHNICAL REQUIREMENTS

- 1. CONTACT DEWBERRY AT 386-719-9985 TO OBTAIN AN ELECTRONIC COPY OF THE GEOTECHNICAL REPORT. CONTRACTOR IS RESPONSIBLE FOR REMOVAL AND REPLACEMENT OF UNSUITABLE MATERIALS.
- 2. ALL SOILS WITHIN PAVED AREAS (INCLUDING A MINIMUM OF 5 FEET OUTSIDE THE PERIMETER) SHOULD BE DENSIFIED WITH OVERLAPPING PASSES OF APPROPRIATE COMPACTION EQUIPMENT. EXPOSED SURFACES WITHIN THE PAVEMENT AREAS SHOULD BE COMPACTED TO A MINIMUM OF 95 PERCENT OF THE MODIFIED PROCTOR MAXIMUM DRY DENSITY (ASTM D1557).
- 3. INITIAL SITE PREPARATIONS SHOULD INCLUDE THE COMPLETE REMOVAL OF TOPSOIL, MUCK, CONCRETE OR ASPHALT PAVEMENT AND ANY OTHER DELETERIOUS MATERIAL ASSOCIATED WITH BURIED UTILITIES. THE REMOVAL OF UNSUITABLE MATERIAL SHALL EXTEND A MINIMUM OF FIVE FEET OUTSIDE THE LIMIT OF ALL STRUCTURE AND PAVED AREAS. ONCE REMOVED ALL EXPOSED SURFACES SHOULD BE DENSIFIED PRIOR TO PLACEMENT OF ANY SUBSEQUENT FILL REQUIRED TO RE-ESTABLISH THE SUBGRADE.
- 4. STRUCTURAL FILL SHOULD BE PLACED IN THIN LOOSE LIFTS NOT EXCEEDING 12 INCHES IN THICKNESS AND COMPACTED WITH APPROPRIATE EQUIPMENT TO ACHIEVE THE REQUIRED COMPACTION. EACH LIFT OF STRUCTURAL FILL SHALL BE BE COMPACTED TO A MINIMUM OF 98 PERCENT OF THE MODIFIED PROCTOR MAXIMUM DRY DENSITY (ASTM D1557) WITHIN THE PAVEMENT AREAS. STRUCTURAL FILL SHALL CONSIST OF INORGANIC, NON-PLASTIC, GRANULAR SOIL CONTAINING LESS THAN 12 PERCENT MATERIAL PASSING THE NO. 200 SIEVE (UNIFIED SOIL CLASSIFICATION OF SP OR SP-SM).
- 5. TO ALLEVIATE ADVERSE EFFECTS OF DIFFERENTIAL SETTLEMENT THE NEW STRUCTURAL FILL PLACED WITHIN THE AREAS SURROUNDING THE PREVIOUSLY DEMUCKED DRAINAGE DITCH BE BENCHED IN TO THE EXCAVATION DITCH SIDES. THIS MAY BE ACCOMPLISHED BY CUTTING A MINIMUM 5 FOOT WIDE HORIZONTAL BENCH INTO THE EXISTING SOILS FOR EVERY 12 INCH LIFT OF NEW FILL.
- 6. REMOVAL OF TOPSOIL, WET AND SOFT/LOOSE SOILS SHOULD BE EXPECTED DURING THE SUBGRADE PREPARATIONS WITHIN PAVEMENT AREAS. IN ADDITION, THE PAVEMENT AREA IS PROPOSED WITHIN THE LIMITS OF THE EXISTING DRAINAGE MOUND LOCATED ON THE NORTH SIDE OF THE SUBJECT PROPERTY. AFTER REMOVAL OF ALL UNSUITABLE MATERIAL FROM THE PAVEMENT AREA ALL EXPOSED SURFACES SHALL BE THOROUGHLY PROOFROLLED BY A QUALIFIED PROFESSIONAL TO DELINEATE AREAS OF UNSUITABLE SUBGRADE.

EROSION CONTROL

- 1. CONTRACTOR SHALL STAGE AND TIME CONSTRUCTION TO MINIMIZE THE SIZE OF EXPOSED SOIL AREAS AND THE TIME BETWEEN EXPOSING THE SOIL AREA AND FINISHING THE SOIL AREA.
- 2. IT SHALL BE THE RESPONSIBILITY OF THE CONTRACTOR PERFORMING A TASK TO PROVIDE EROSION CONTROL UNLESS ANOTHER PARTY HAS BEEN PREVIOUSLY SPECIFIED AS RESPONSIBLE FOR THE EROSION CONTROL ASSOCIATED WITH THAT TASK. IN THE EVENT ANOTHER PARTY IS RESPONSIBLE FOR EROSION CONTROL, THE CONTRACTOR SHALL STILL BE RESPONSIBLE FOR COORDINATION WITH THE PARTY RESPONSIBLE. IN THE EVENT THAT DAMAGE TO THE CONSTRUCTED ITEM RESULTS ARE DUE TO LACK OF EROSION CONTROL, THE CONTRACTOR SHALL REPAIR OR REPLACE THE ITEM AT NO CHARGE TO THE OWNER.
- 3. THE CONTRACTOR IS TO PROVIDE EROSION CONTROL/ SEDIMENTATION BARRIER (HAY BALES, SILT FENCE, TURBIDITY BARRIER, OR AS SPECIFIED IN THE CONSTRUCTION DRAWINGS) TO PREVENT SILTATION OF ADJACENT PROPERTY, STREETS, STORM SEWERS, WATERWAYS, AND WETLAND OR JURISDICTIONAL AREAS. IF, IN THE OPINION OF THE ENGINEER, AND/OR REGULATORY AUTHORITIES, EXCESSIVE QUANTITIES OF MATERIAL ARE TRANSPORTED OFF-SITE BY EROSION OR STORMWATER RUNOFF, THE CONTRACTOR SHALL IMPROVE CONDITIONS TO THE SATISFACTION OF THE ENGINEER AND/OR AUTHORIES AT NO ADDITIONAL COST TO THE OWNER. IN NO CASE SHALL CONSTRUCTION COMMENCE PRIOR TO INSTALLATION OF EROSION CONTROL/SEDIMENTATION BARRIER.
- 4. CONTRACTOR SHALL PLACE STRAW, MULCH, OR OTHER SUITABLE MATERIAL (OR AS SPECIFIED IN THE PLANS) ON THE GROUND IN AREAS WHERE CONSTRUCTION RELATED TRAFFIC IS TO ENTER AND EXIT SITE.
- 5. IF WIND EROSION BECOMES SIGNIFICANT DURING CONSTRUCTION, THE CONTRACTOR SHALL STABILIZE THE AREA USING SPRINKLING IRRIGATION OR OTHER ACCEPTABLE METHODS.



Dewberry Engineers Inc 101 N. Monroe St. Suite 710 Tallahassee, FL 32301 850.523.0062

SERVICE AREA EXPANSIC JOHNSON & JOHNSON, INC. COLUMBIA COUNTY, FLORIDA

SEAL

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WILLIAM A. MENADIER, P.E. 74581 COA# 8794

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REVISIONS

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APPROVED BY

CHECKED BY

DATE

JAL

WAM

AUGUST 2021

TITLE

GENERAL NOTES

PROJECT NO.

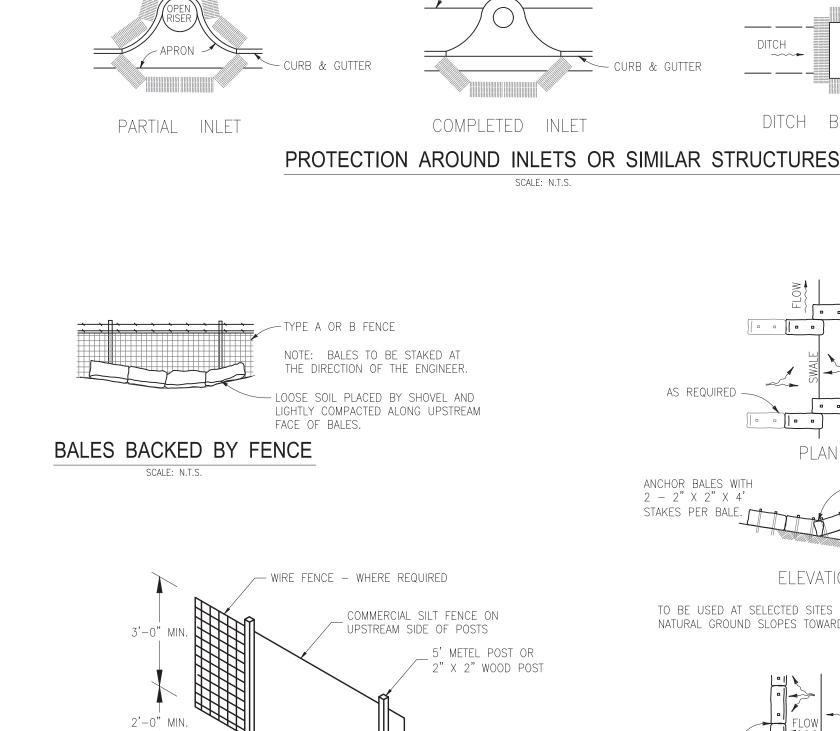
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C2

SHEET NO.

،0136924 Busy Bee No. 7 Permit Modification\CAD\Civil\Production\50093979 Cvr_Details.dwg, 8/19/2021 ك





NOTES:

1. DIG TRENCH 6" DEEP.

2. LAY IN FABRIC TO BOTTOM OF TRENCH.

3. BACK TRENCH, COVERING FABRIC

ANCHOR BALES WITH

2 - 2" X 2" X 4'

6'-0" MIN.

STAKES PER BALE.

ANCHOR BALES WITH OVERLAP ENDS 2 - 2" X 2" X 4' STAKES PER BALE. ELEVATION TO BE USED AT SELECTED SITES WHERE THE NATURAL GROUND SLOPES TOWARD THE TOE OF SLOPE ANCHOR BALES WITH $2 - 2" \times 2" \times 4'$ BALES TO BUTT LOOSE SOIL PLACED BY SHOVEL AND LIGHTLY - COMPACTED ALONG THE UPSTREAM EDGE OF BALES. - FILL SLOPE ELEVATION TO BE USED AT SELECTED SITES WHERE THE

DITCH BOTTOM INLET

— 50' O.C.(TYP.)

ANCHOR BALES WITH

2 - 2" X 2" X 4'

STAKES PER BALE

- SIDEWALK -

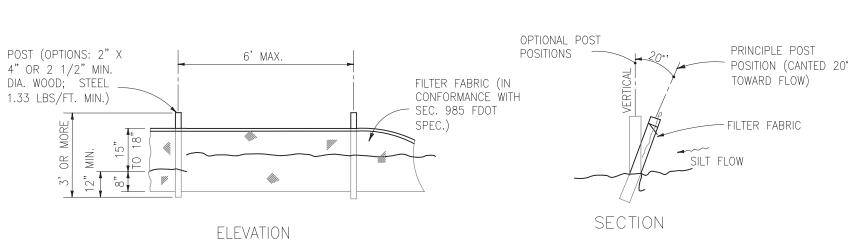
COMPLETED INLET

2" X 2" WOOD POST

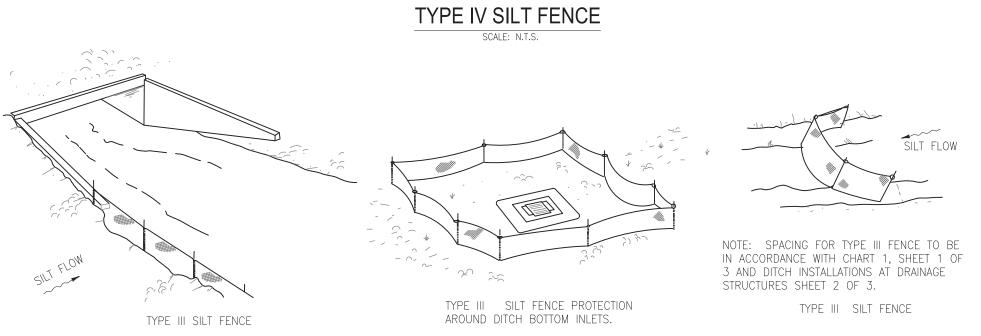
SCALE: N.T.S

NATURAL GROUND SLOPES AWAY FROM THE TOE OF SLOPE

BARRIERS FOR FILL SLOPES SCALE: N.T.S.

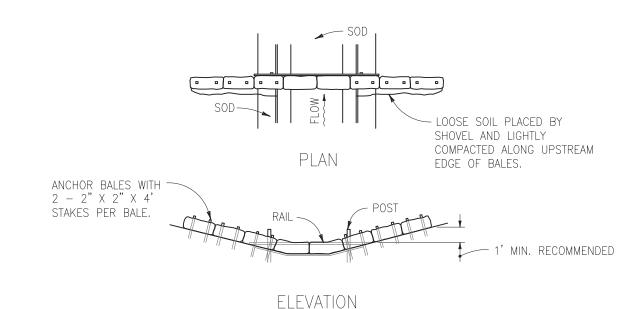


NOTE: SILT FENCE TO BE PAID FOR UNDER THE CONTRACT UNIT PRICE FOR STAKED SILT FENCE (LF).



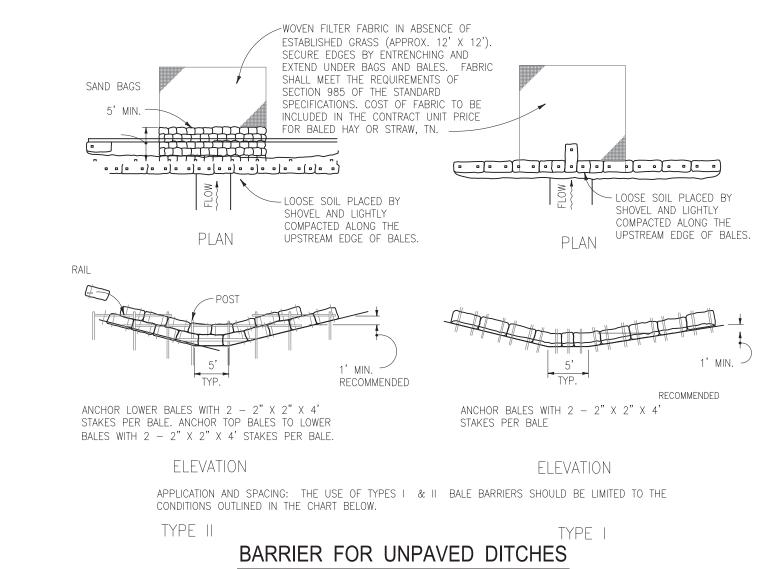
DO NOT DEPLOY IN A MANNER THAT SILT FENCES WILL ACT AS A DAM ACROSS PERMANENT FLOWING WATERCOURSES. SILT FENCES ARE TO BE USED AT UPLAND LOCATIONS AND TURBIDITY BARRIERS USED AT PERMANENT BODIES OF WATER.

SILT FENCE APPLICATIONS

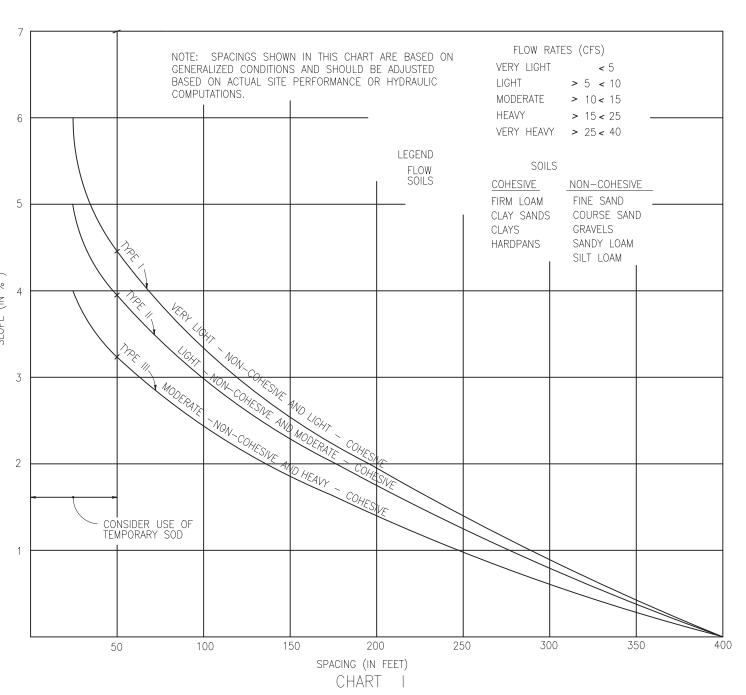


SPACING: BALE BARRIERS FOR PAVED DITCHES SHOULD BE SPACED IN ACCORDANCE WITH THE CHART BELOW

BARRIER FOR PAVED DITCH



SCALF: N.T.S.



RECOMMENDED SPACING FOR TYPE I AND TYPE II HAY BALE BARRIERS, AND TYPE III SILT FENCES



Dewberry Engineers Inc. 101 N. Monroe St. Suite 710 Tallahassee, FL 32301 850.523.0065

> ANSIO I, INC. Ш

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WILLIAM A. MENADIER, P.E. 74581 COA# 8794

CONSTRUCTION DOCUMENTS

SCALE

NO SCALE

REVISIONS DESCRIPTION

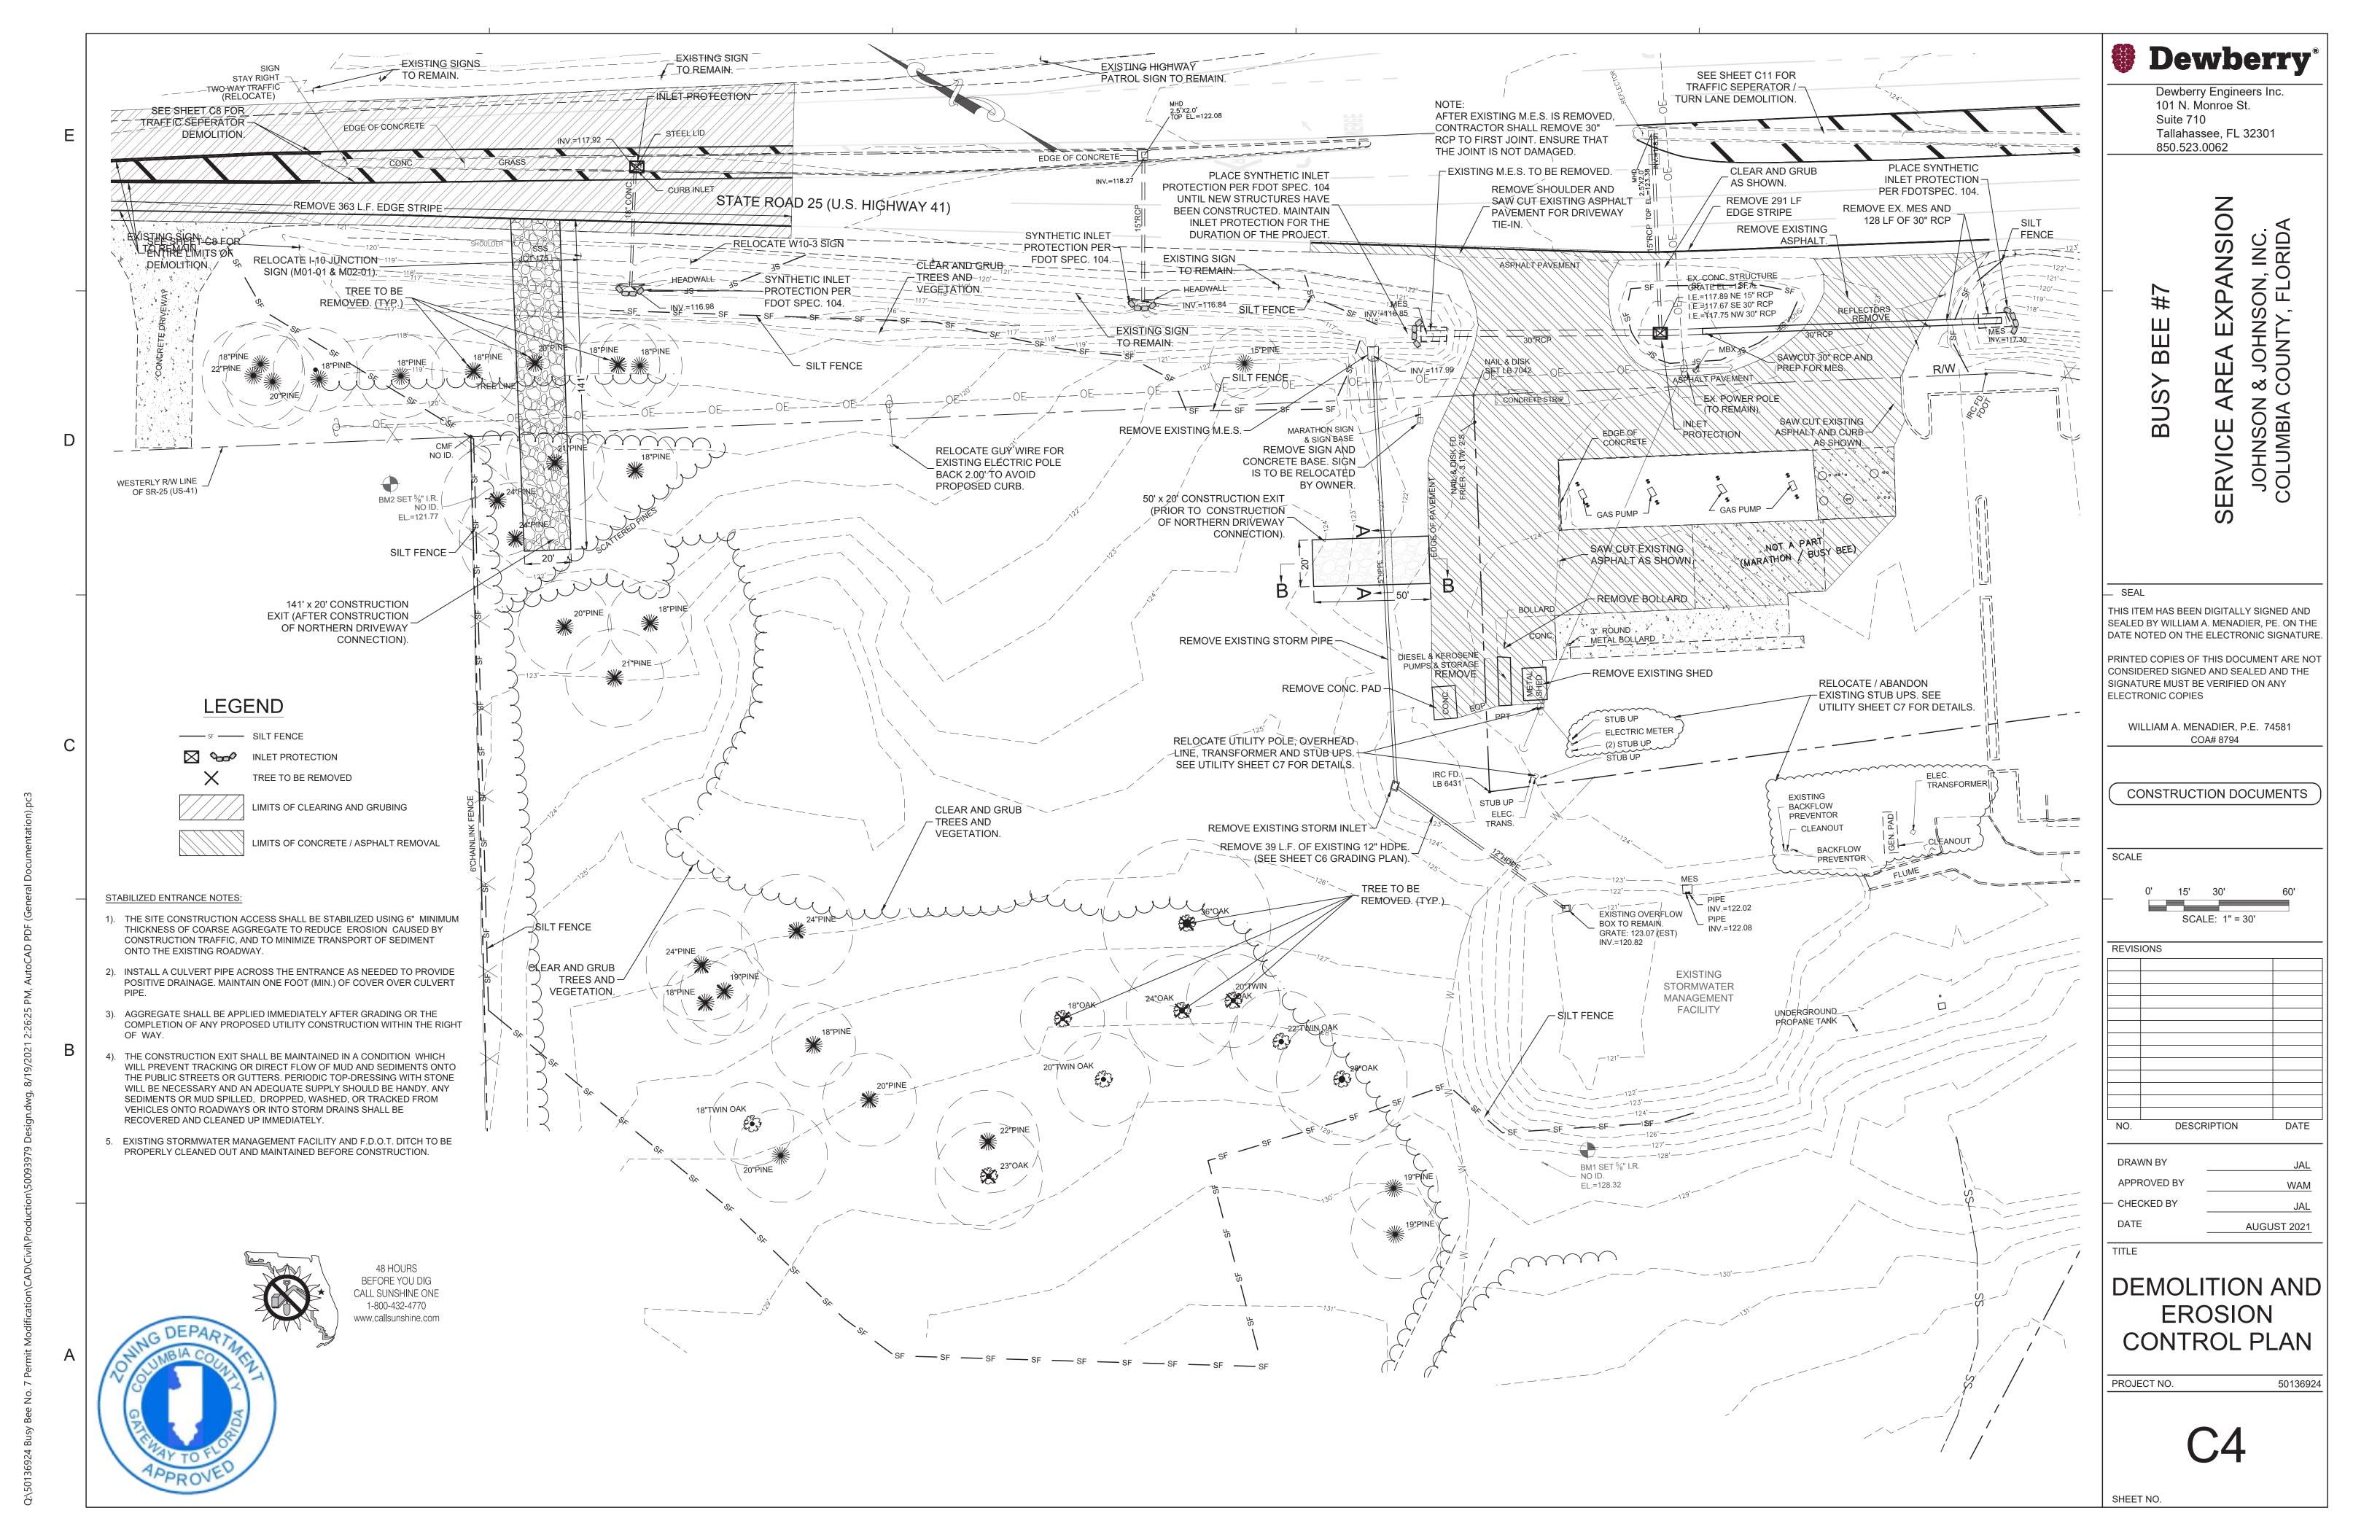
DRAWN BY JAL APPROVED BY JBB CHECKED BY WAM AUGUST 2021

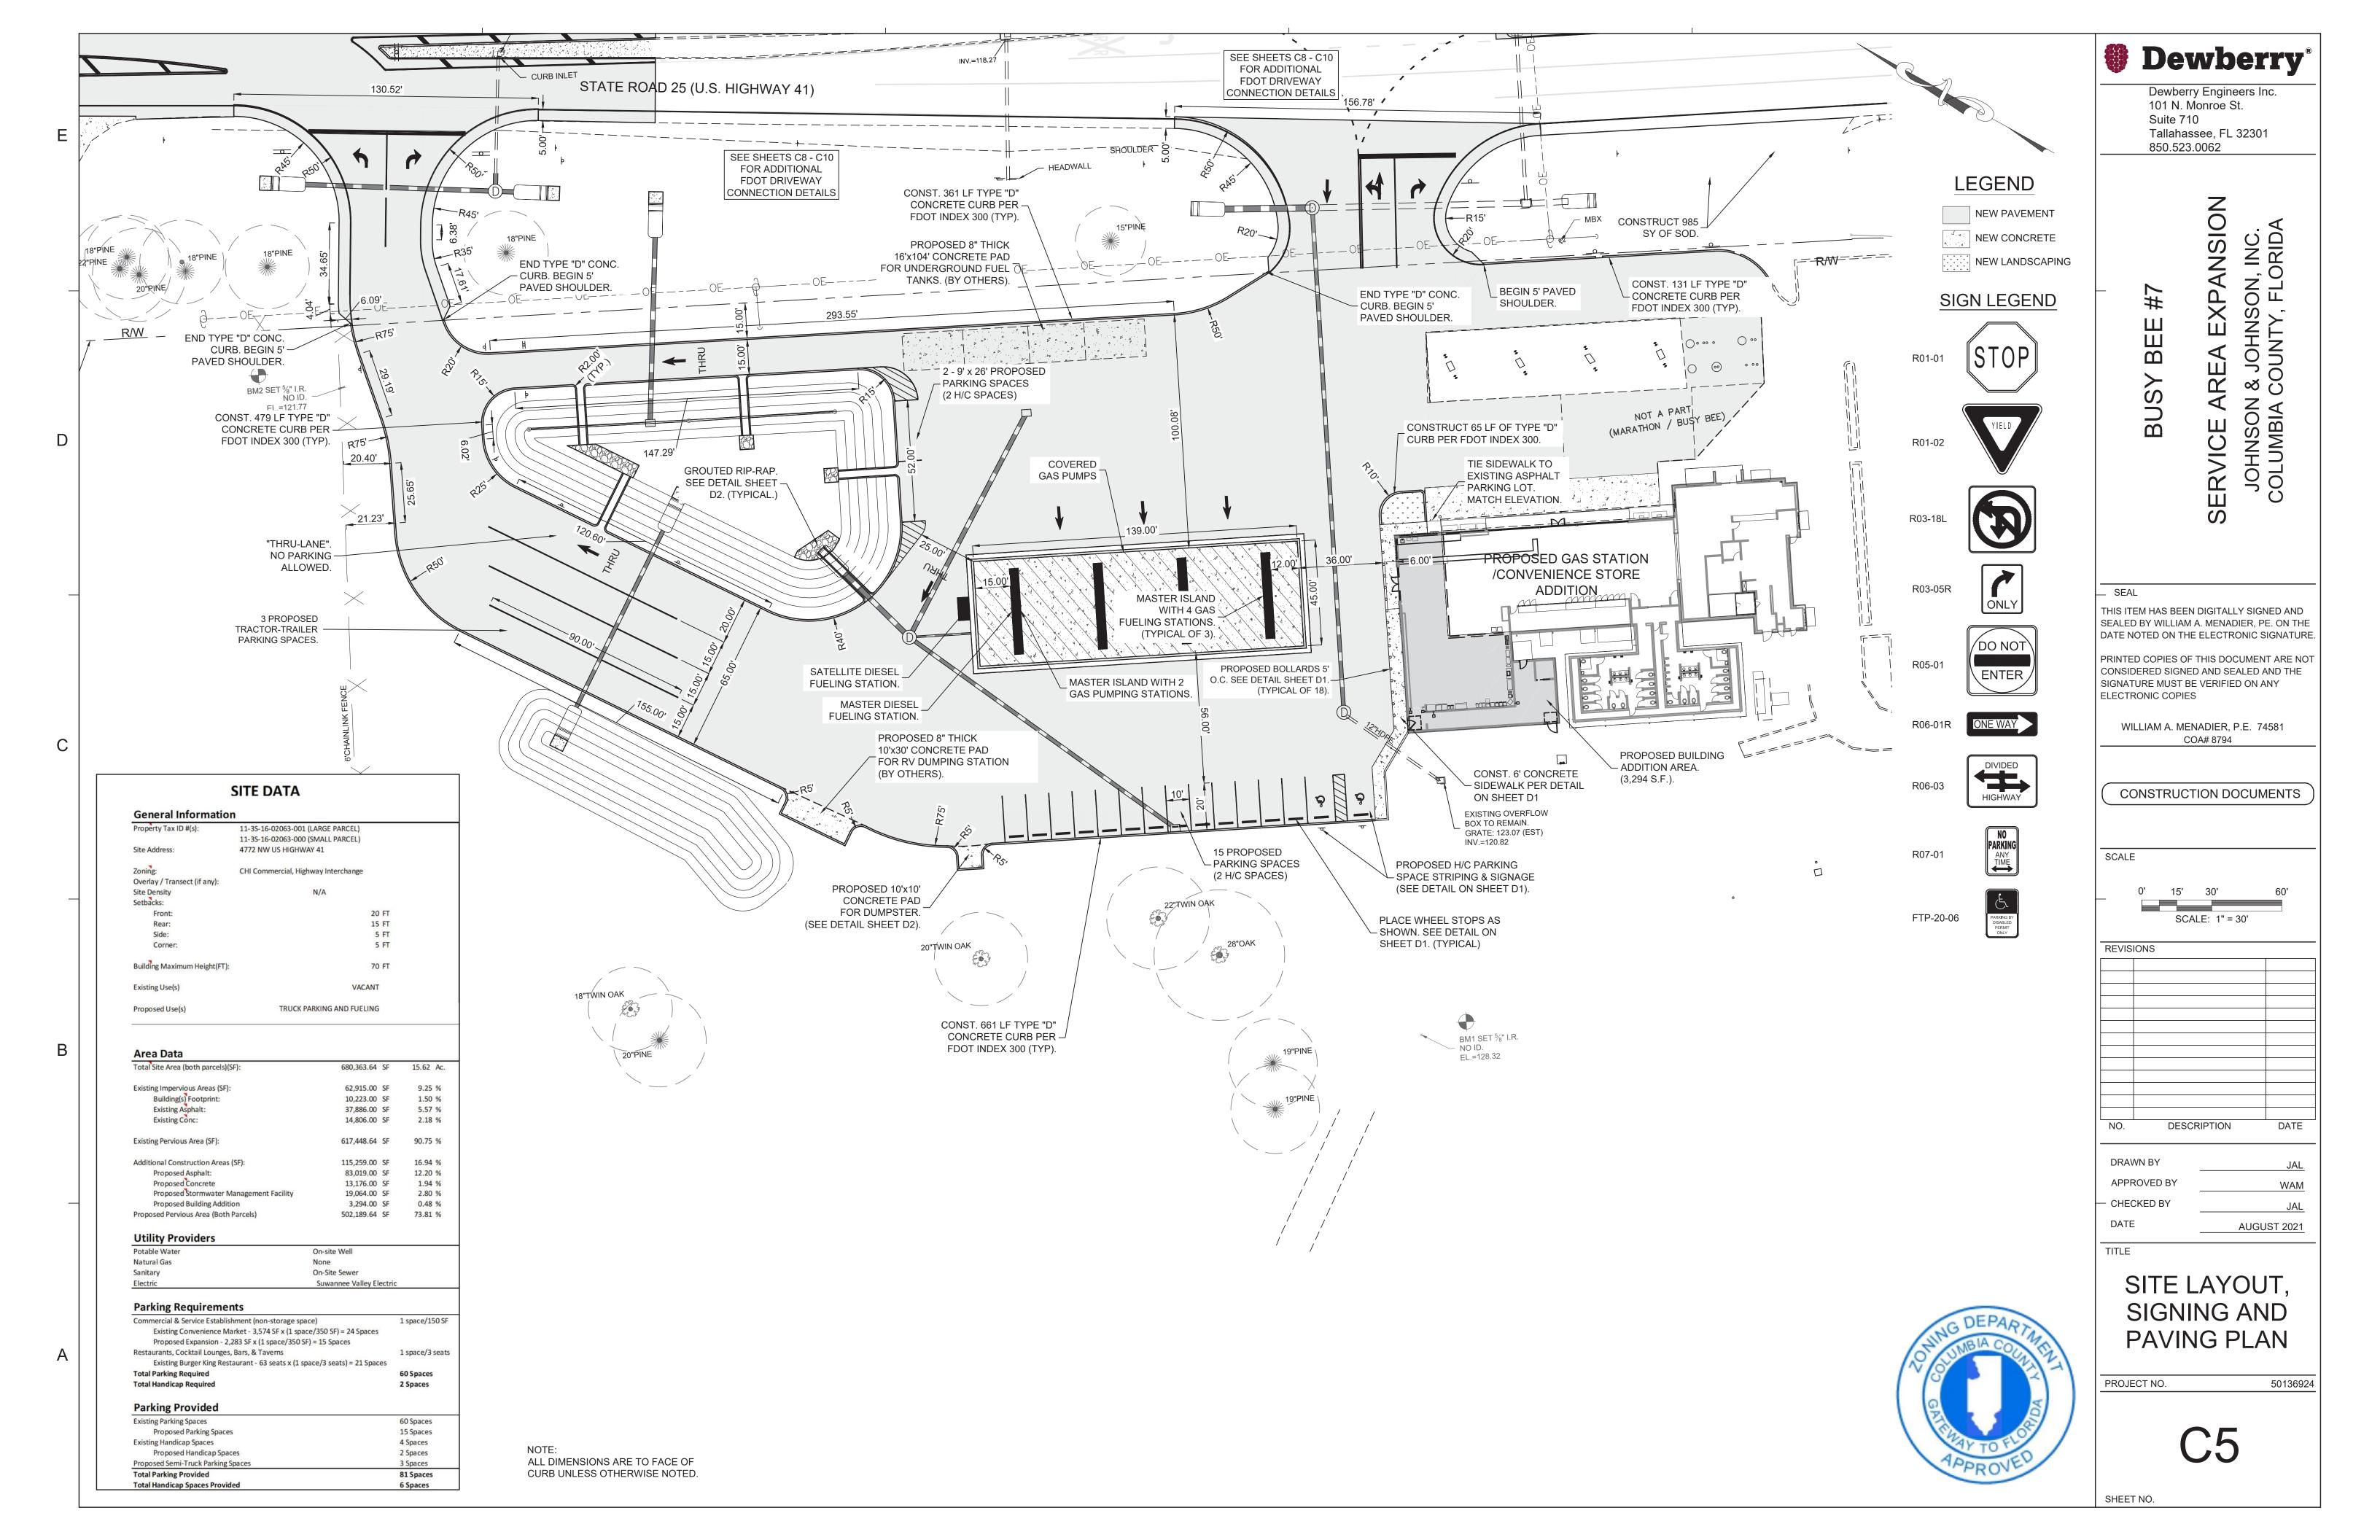
STORMWATER **POLLUTION PREVENTION** PLAN

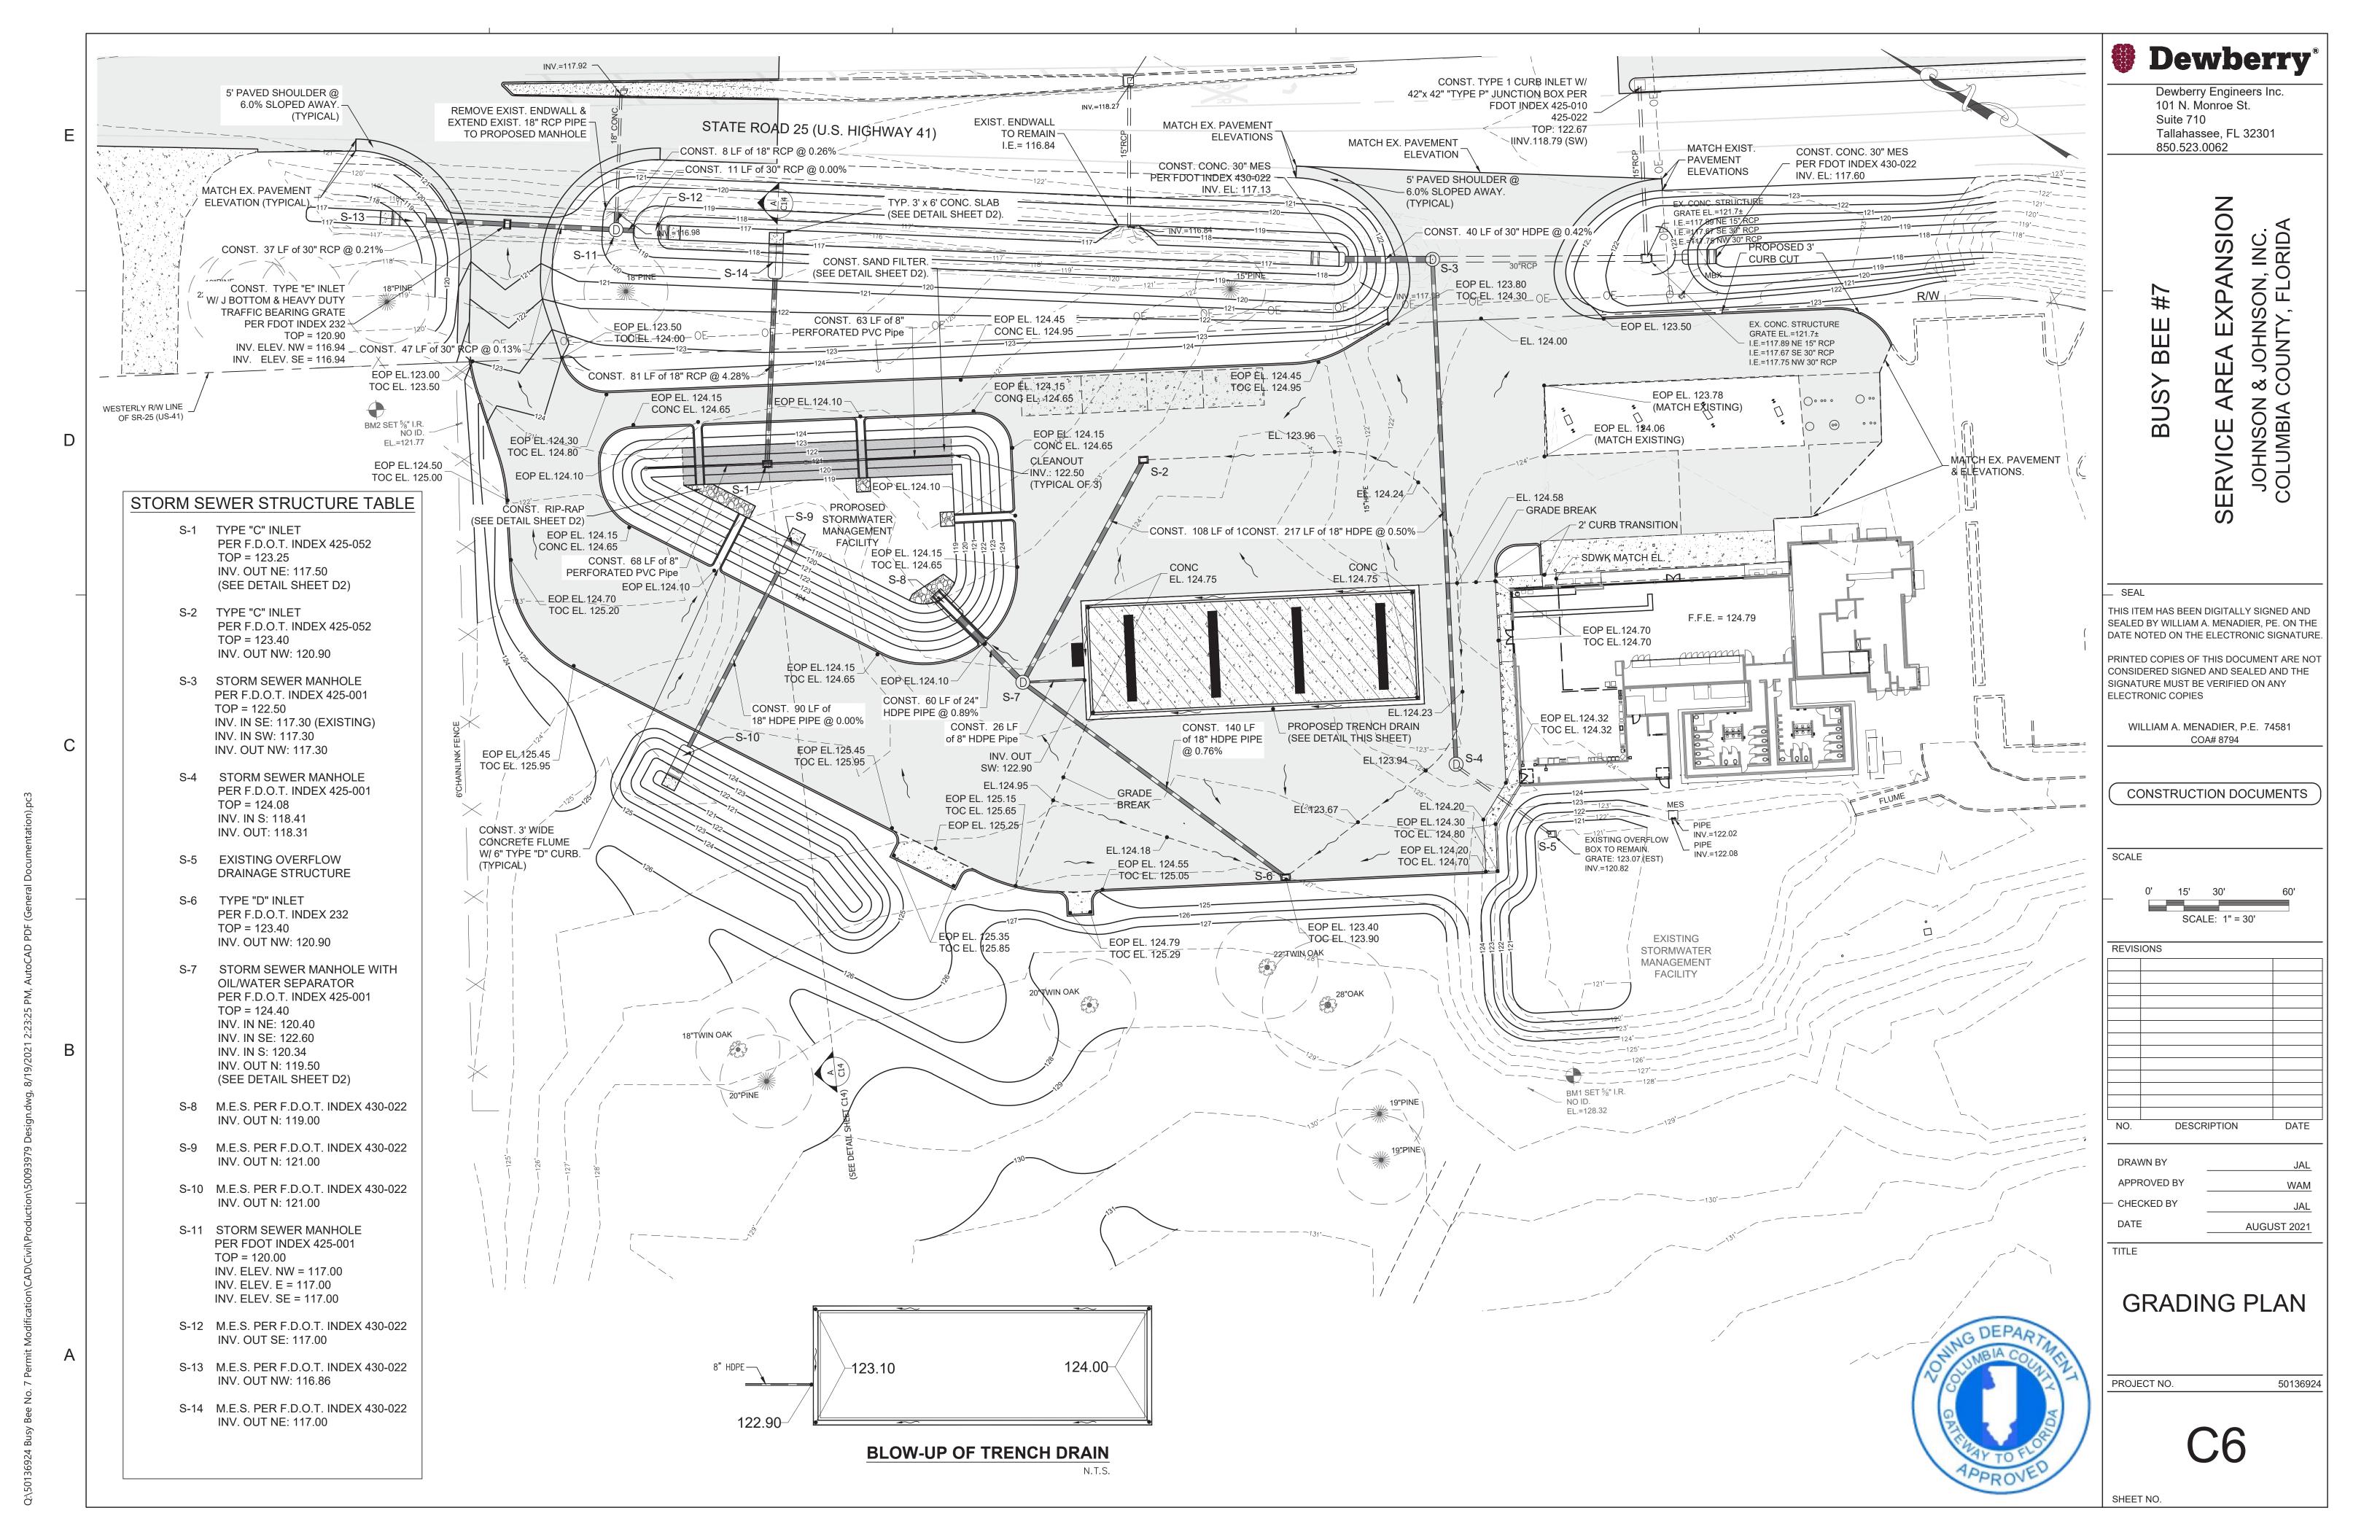
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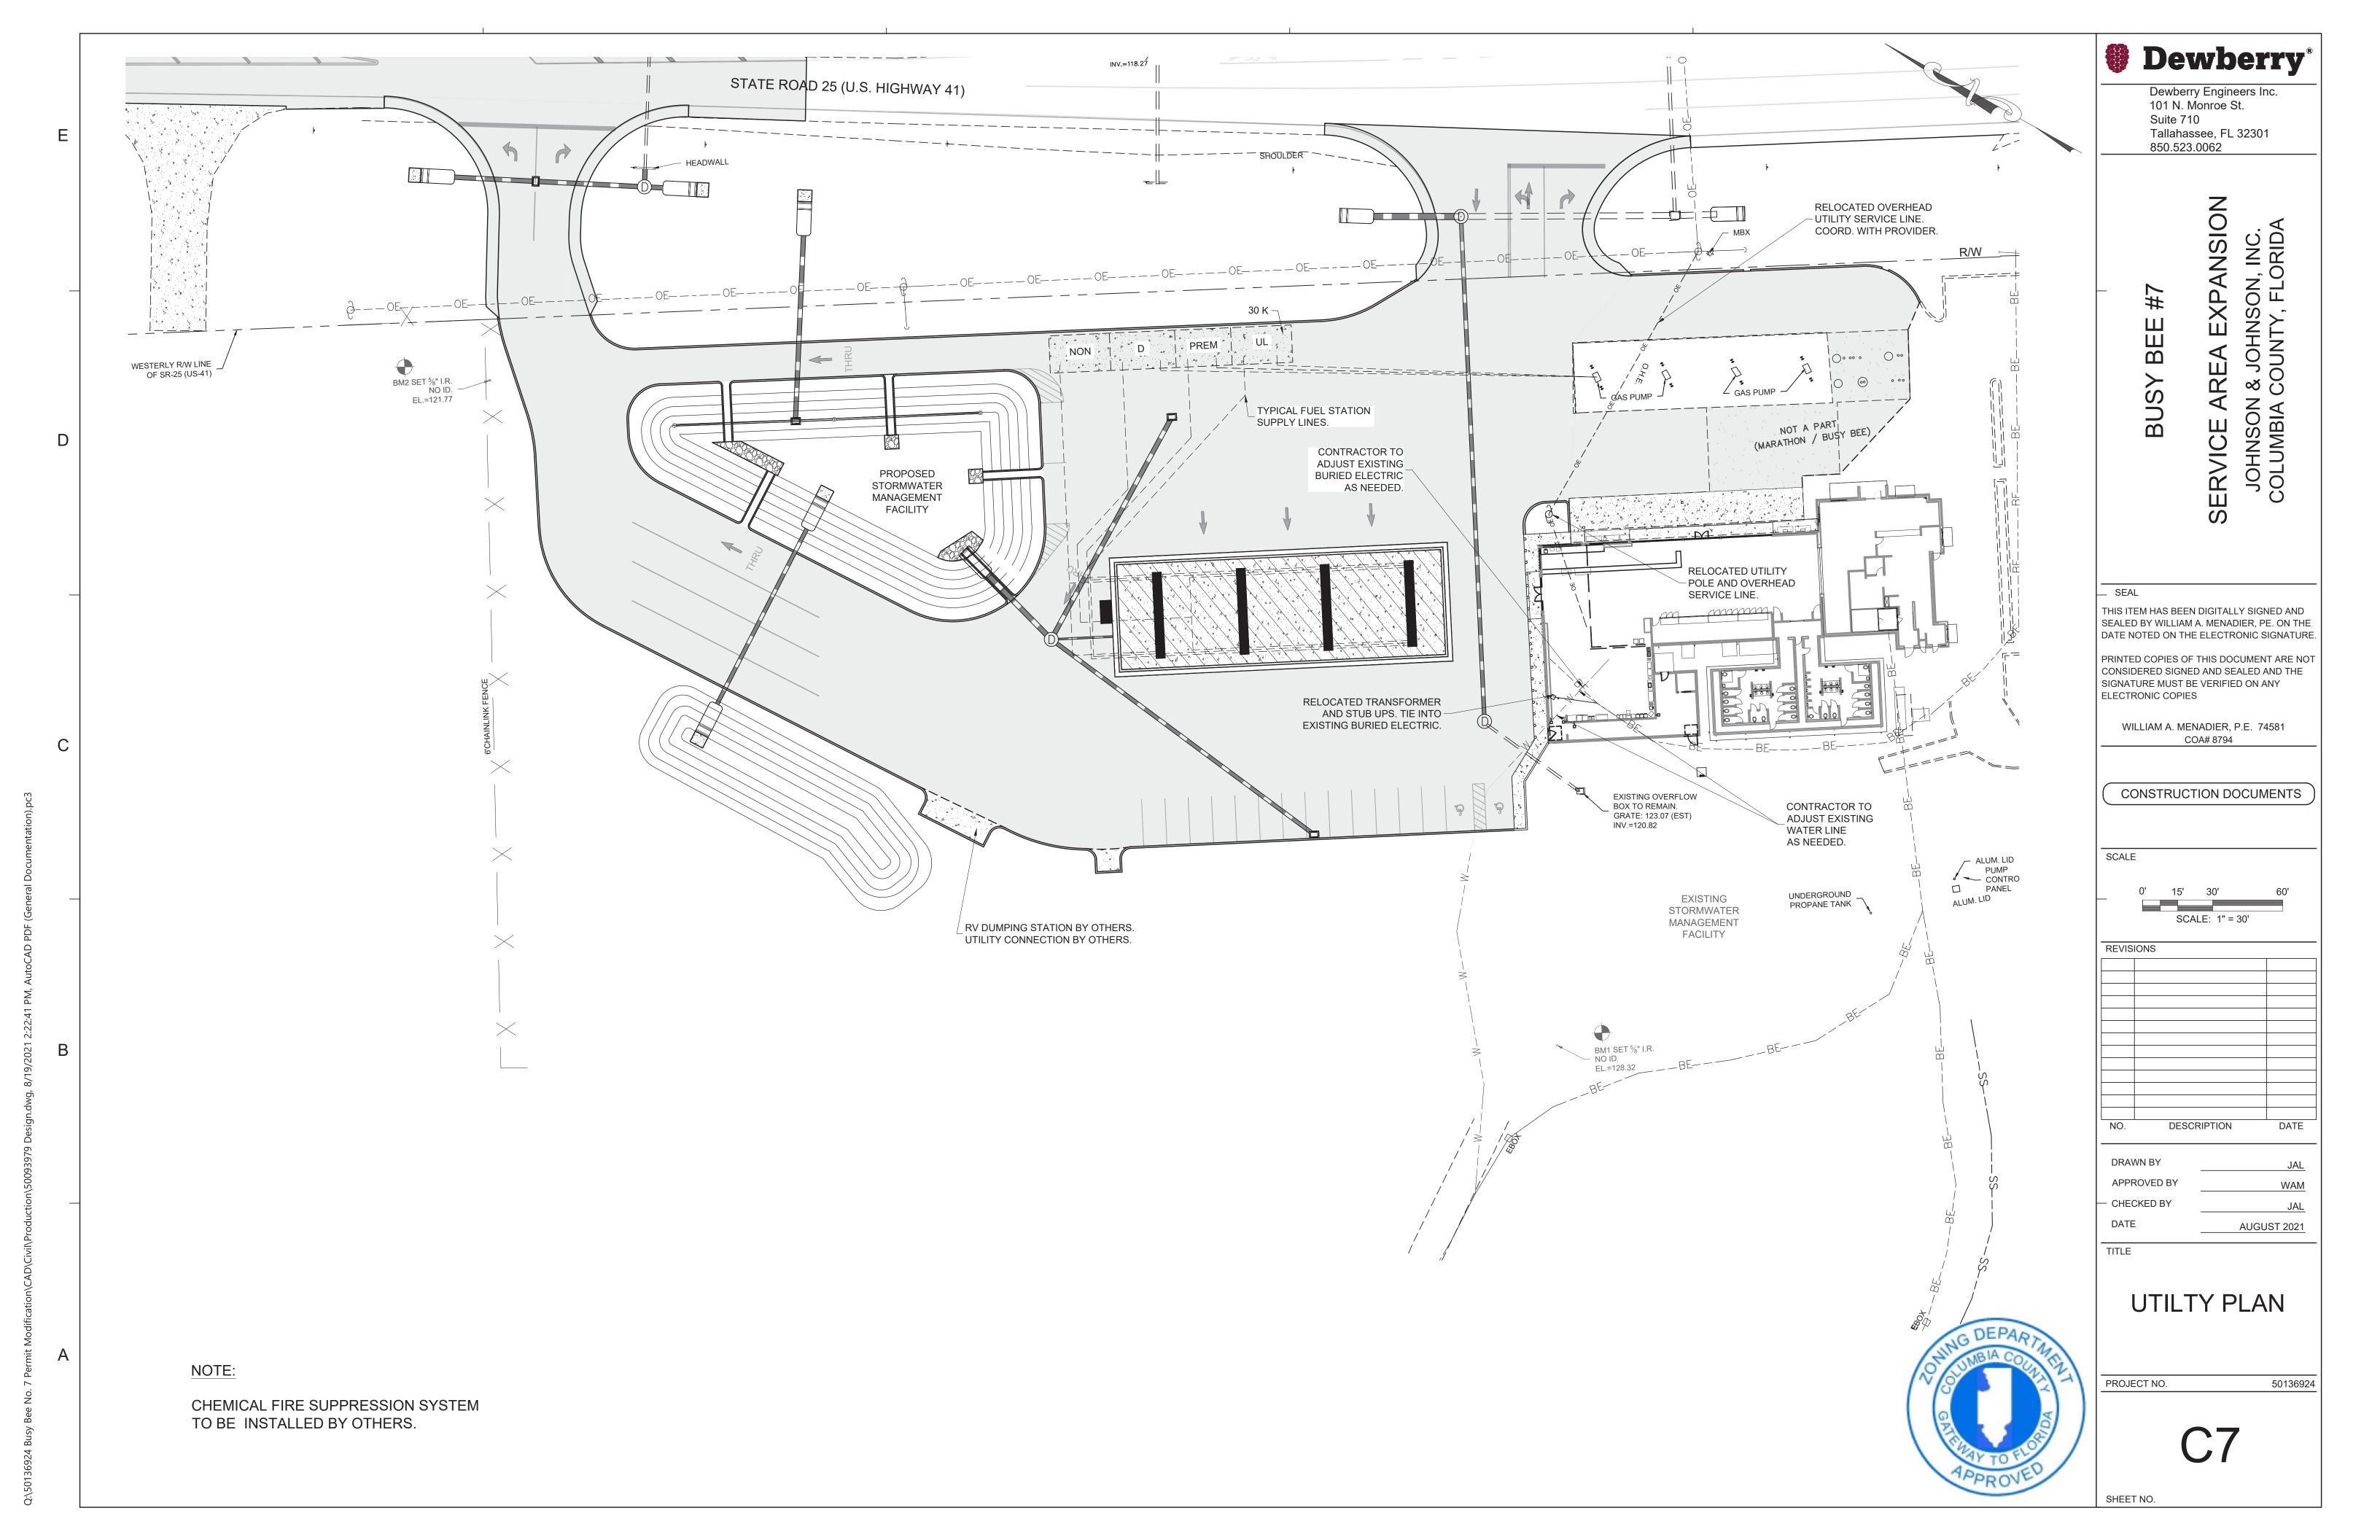
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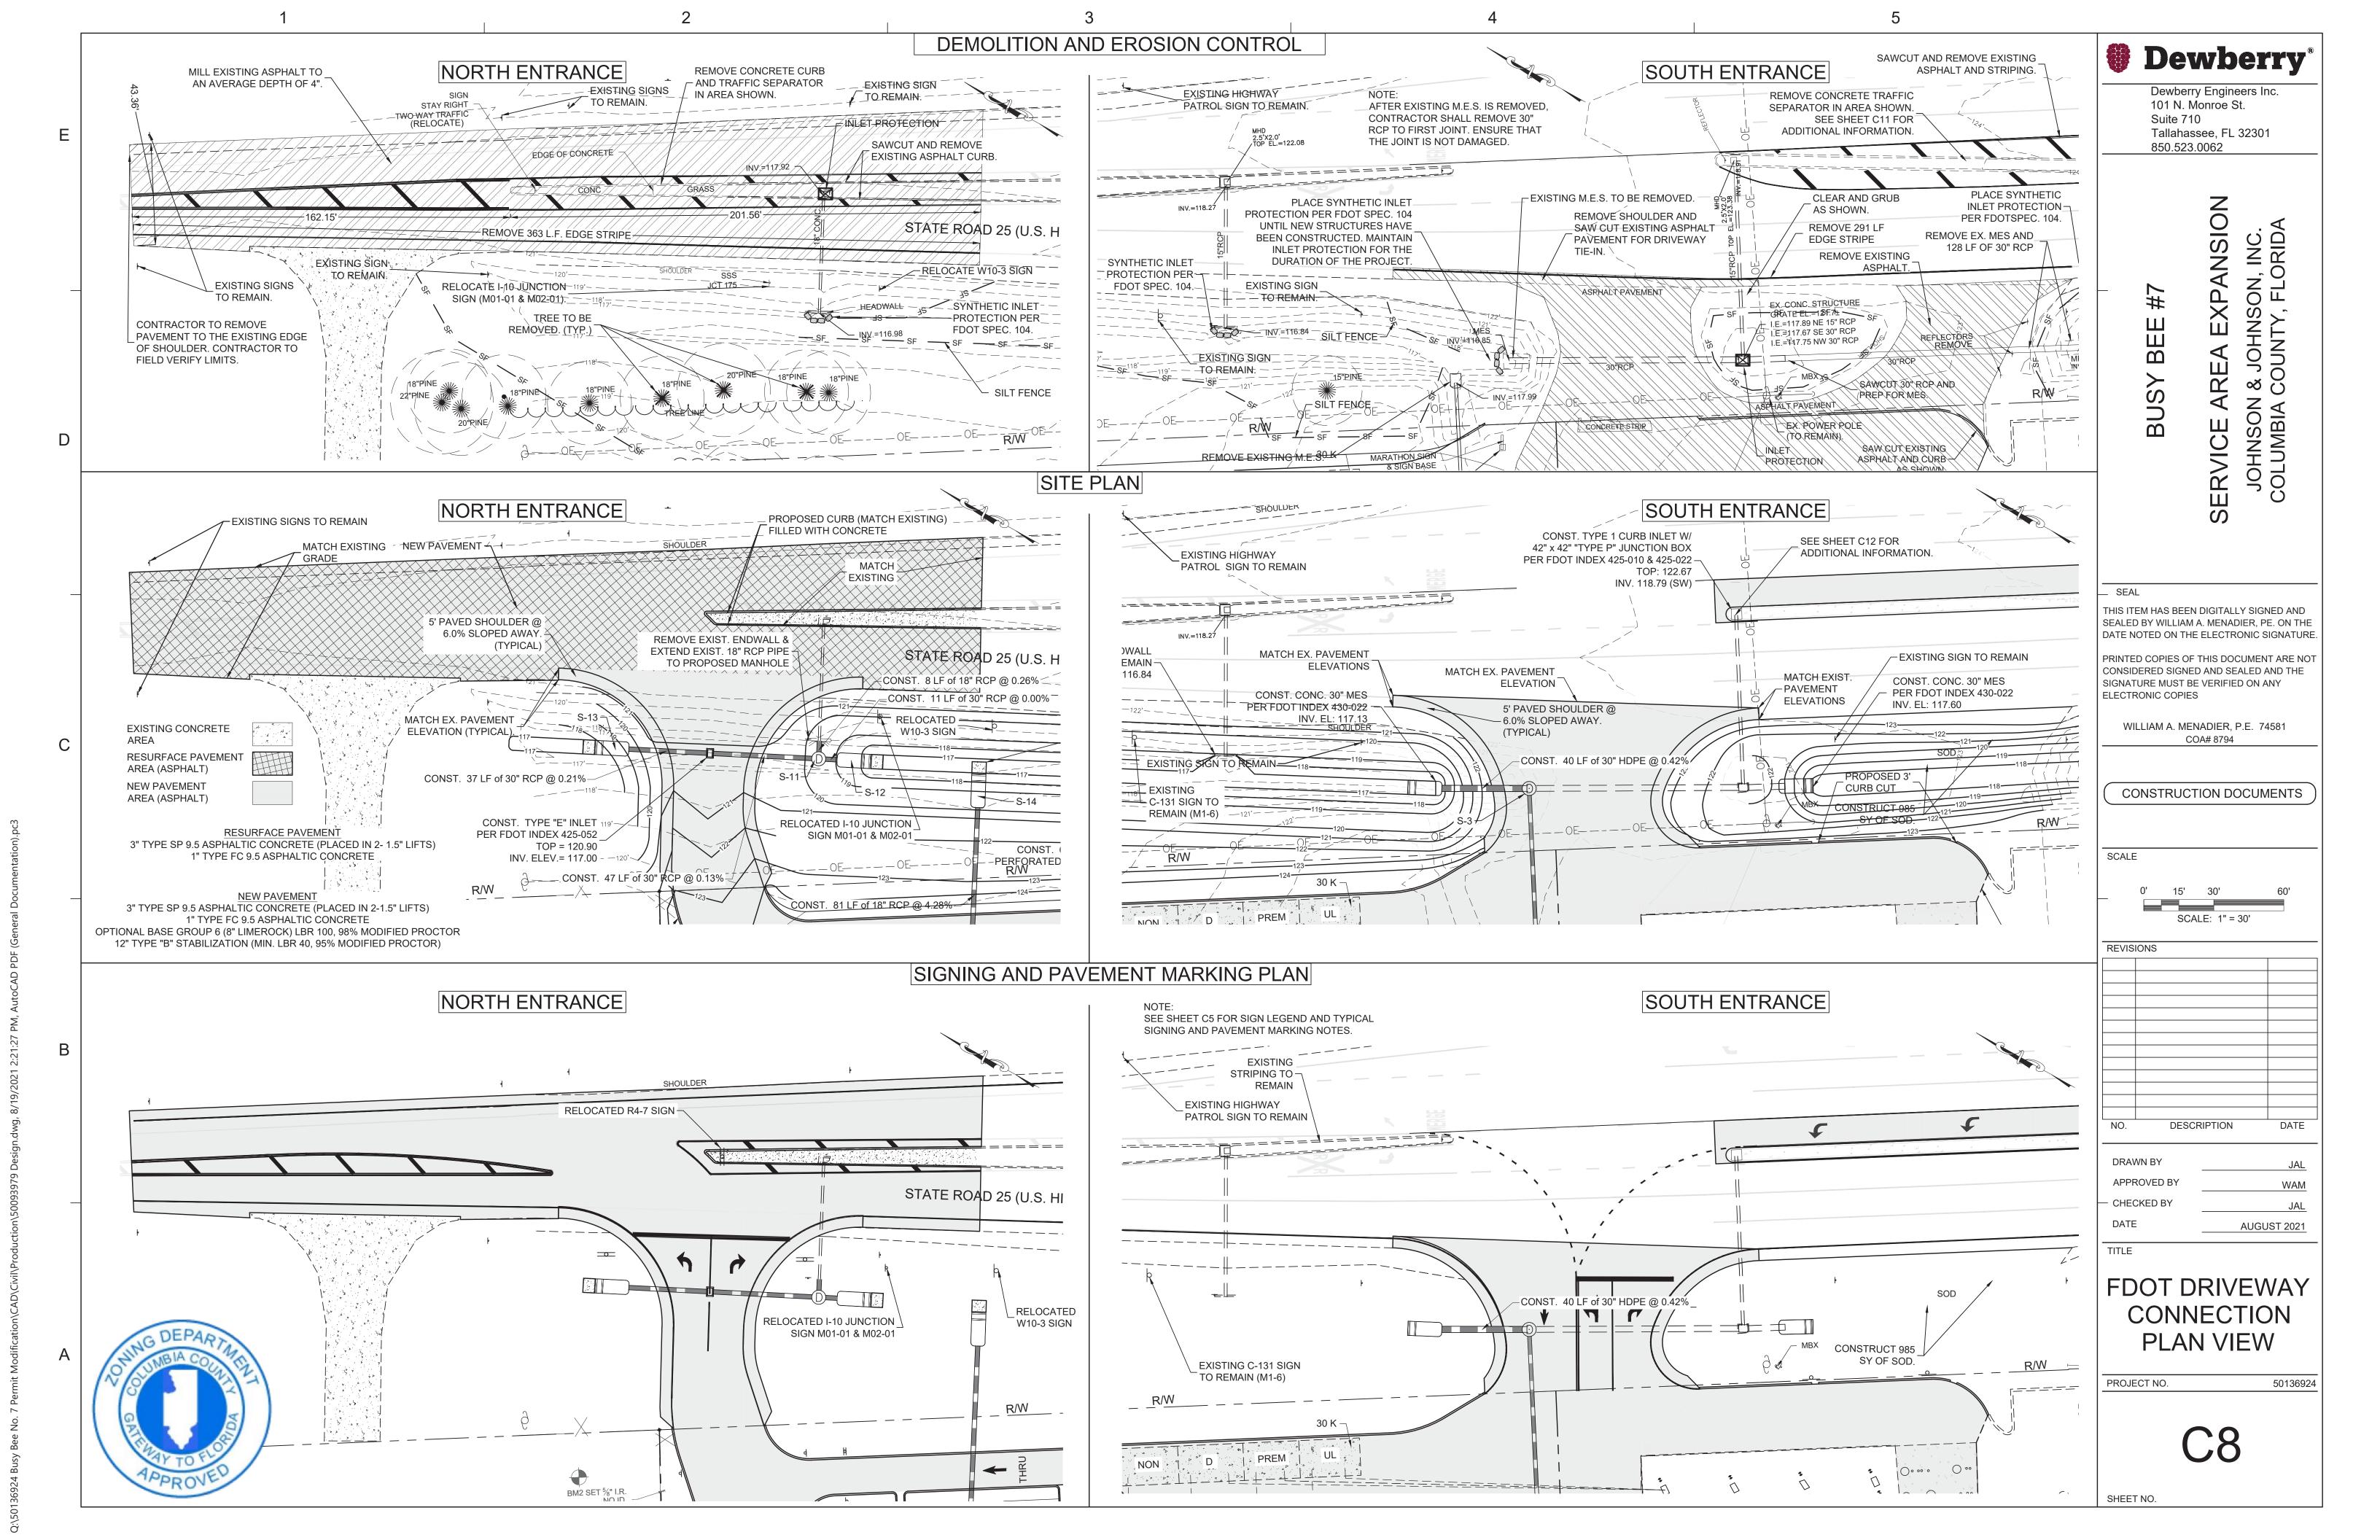
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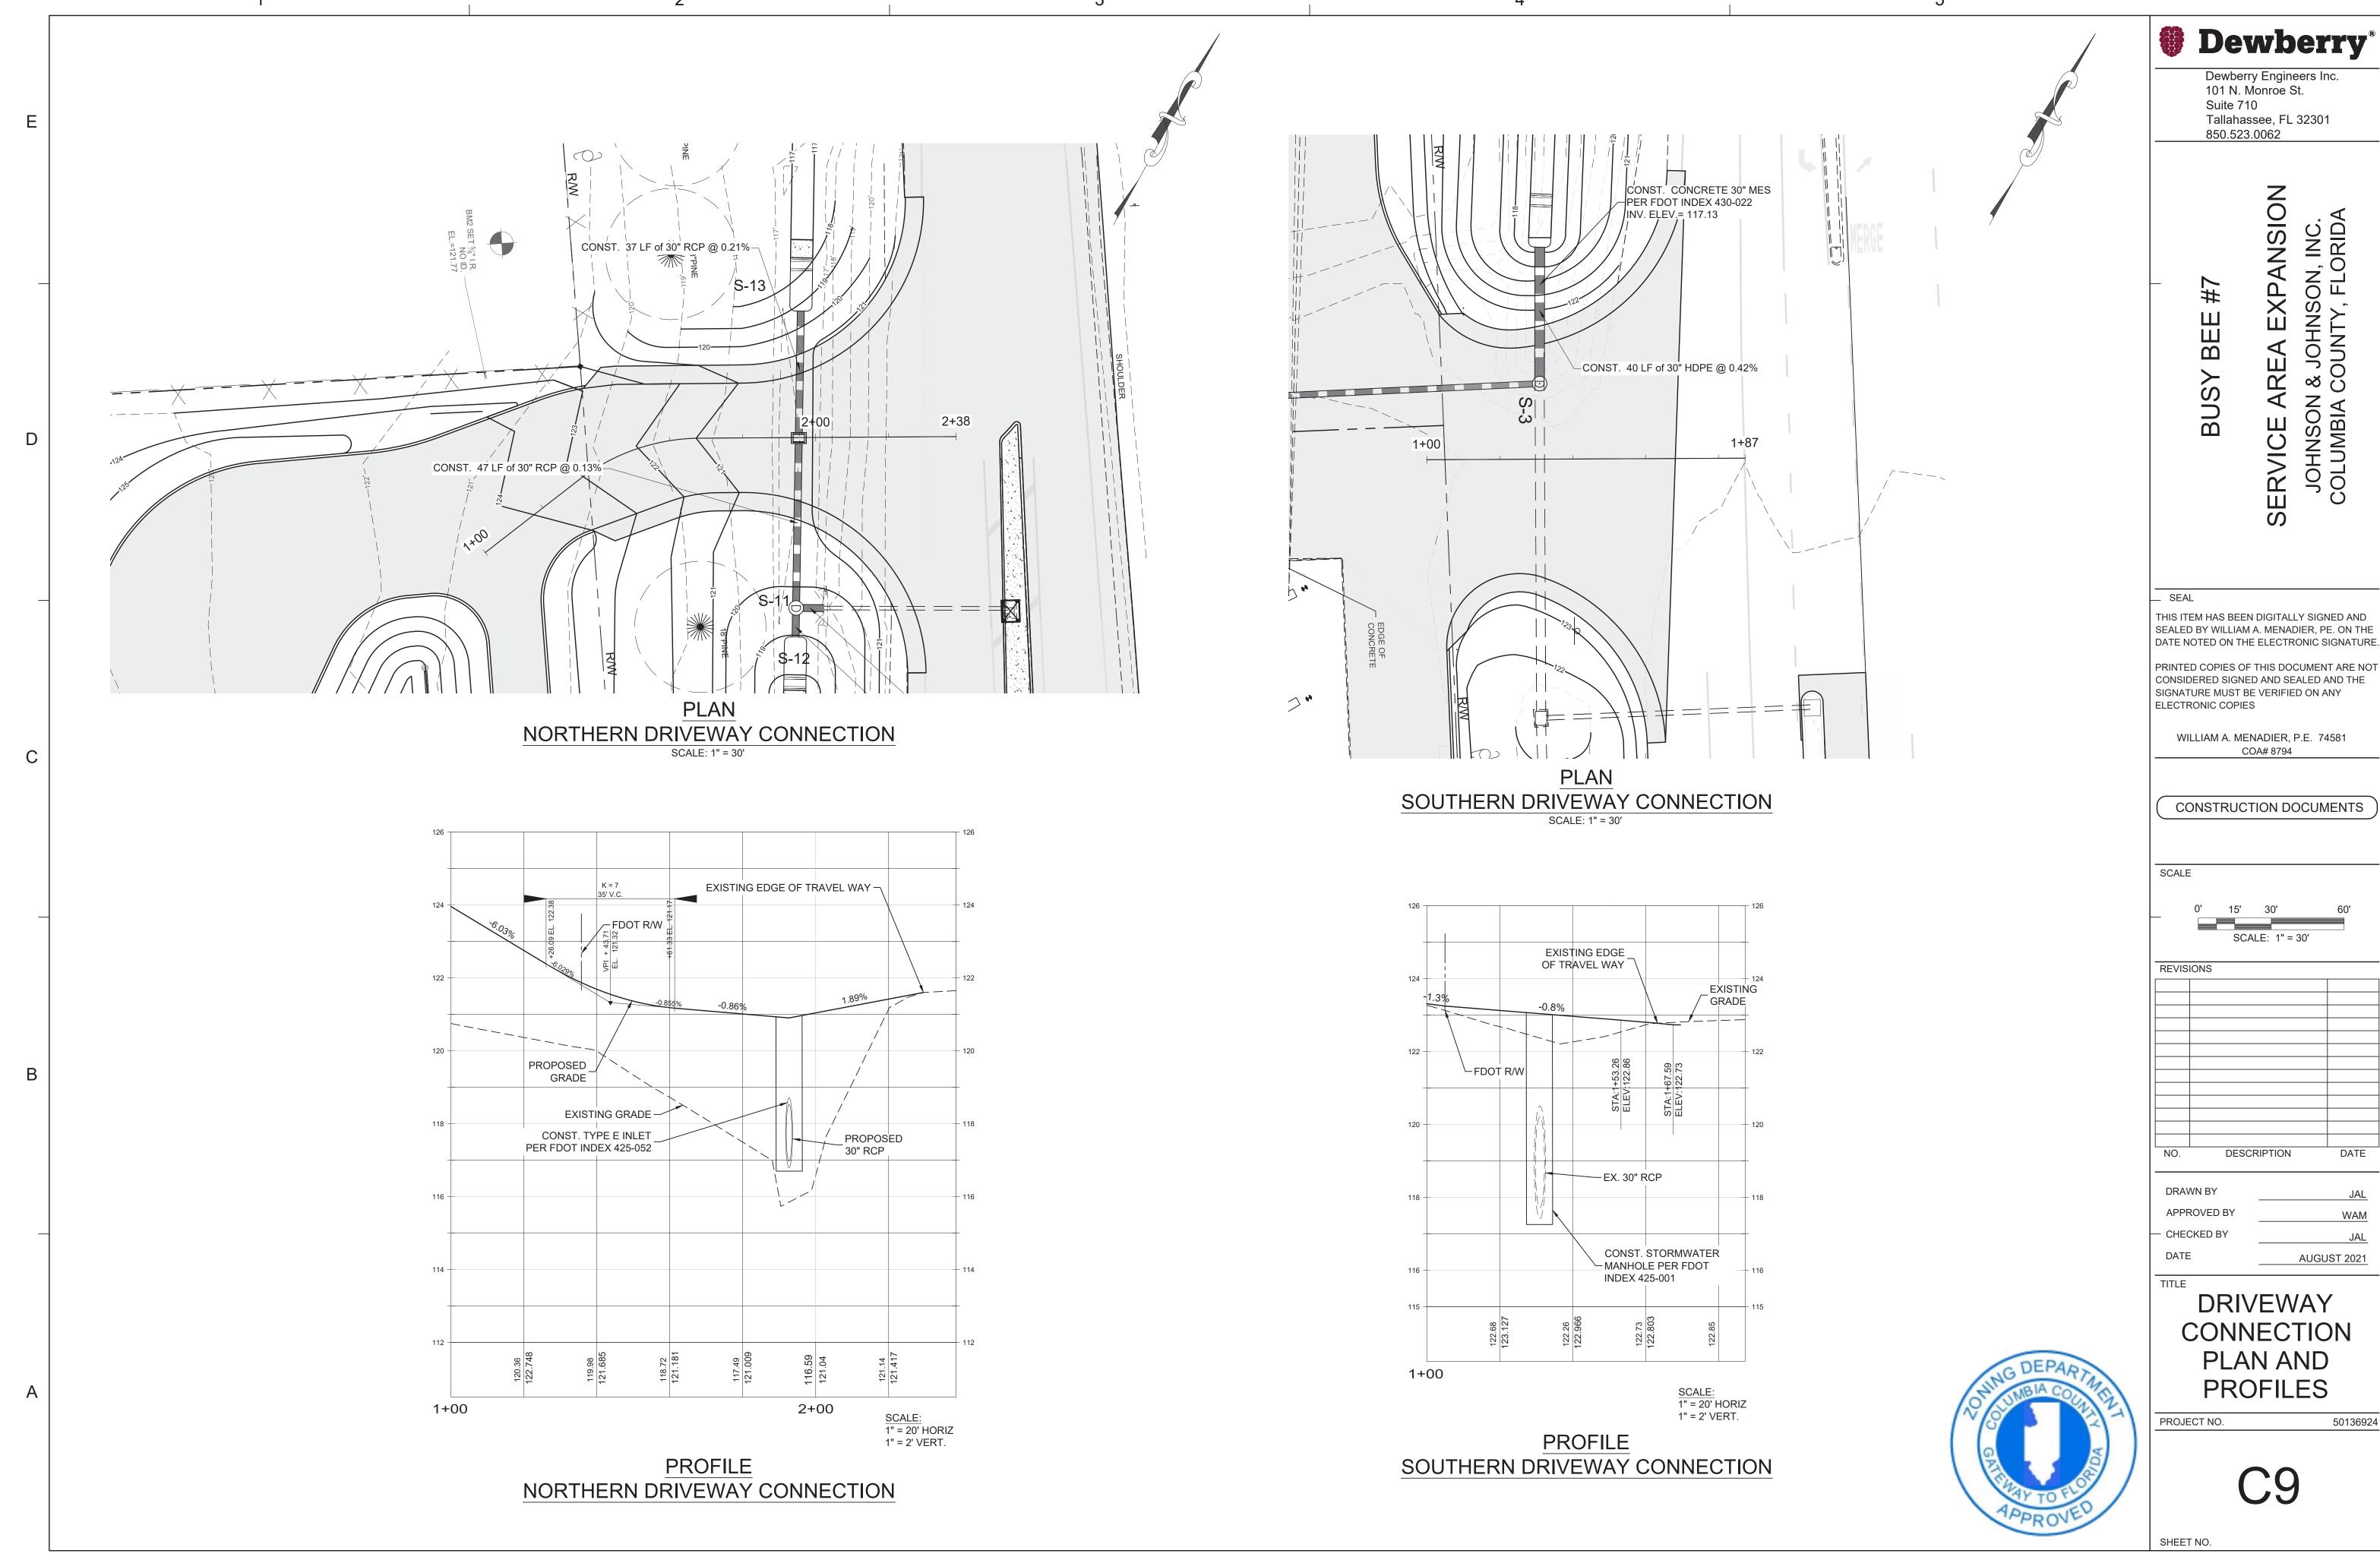


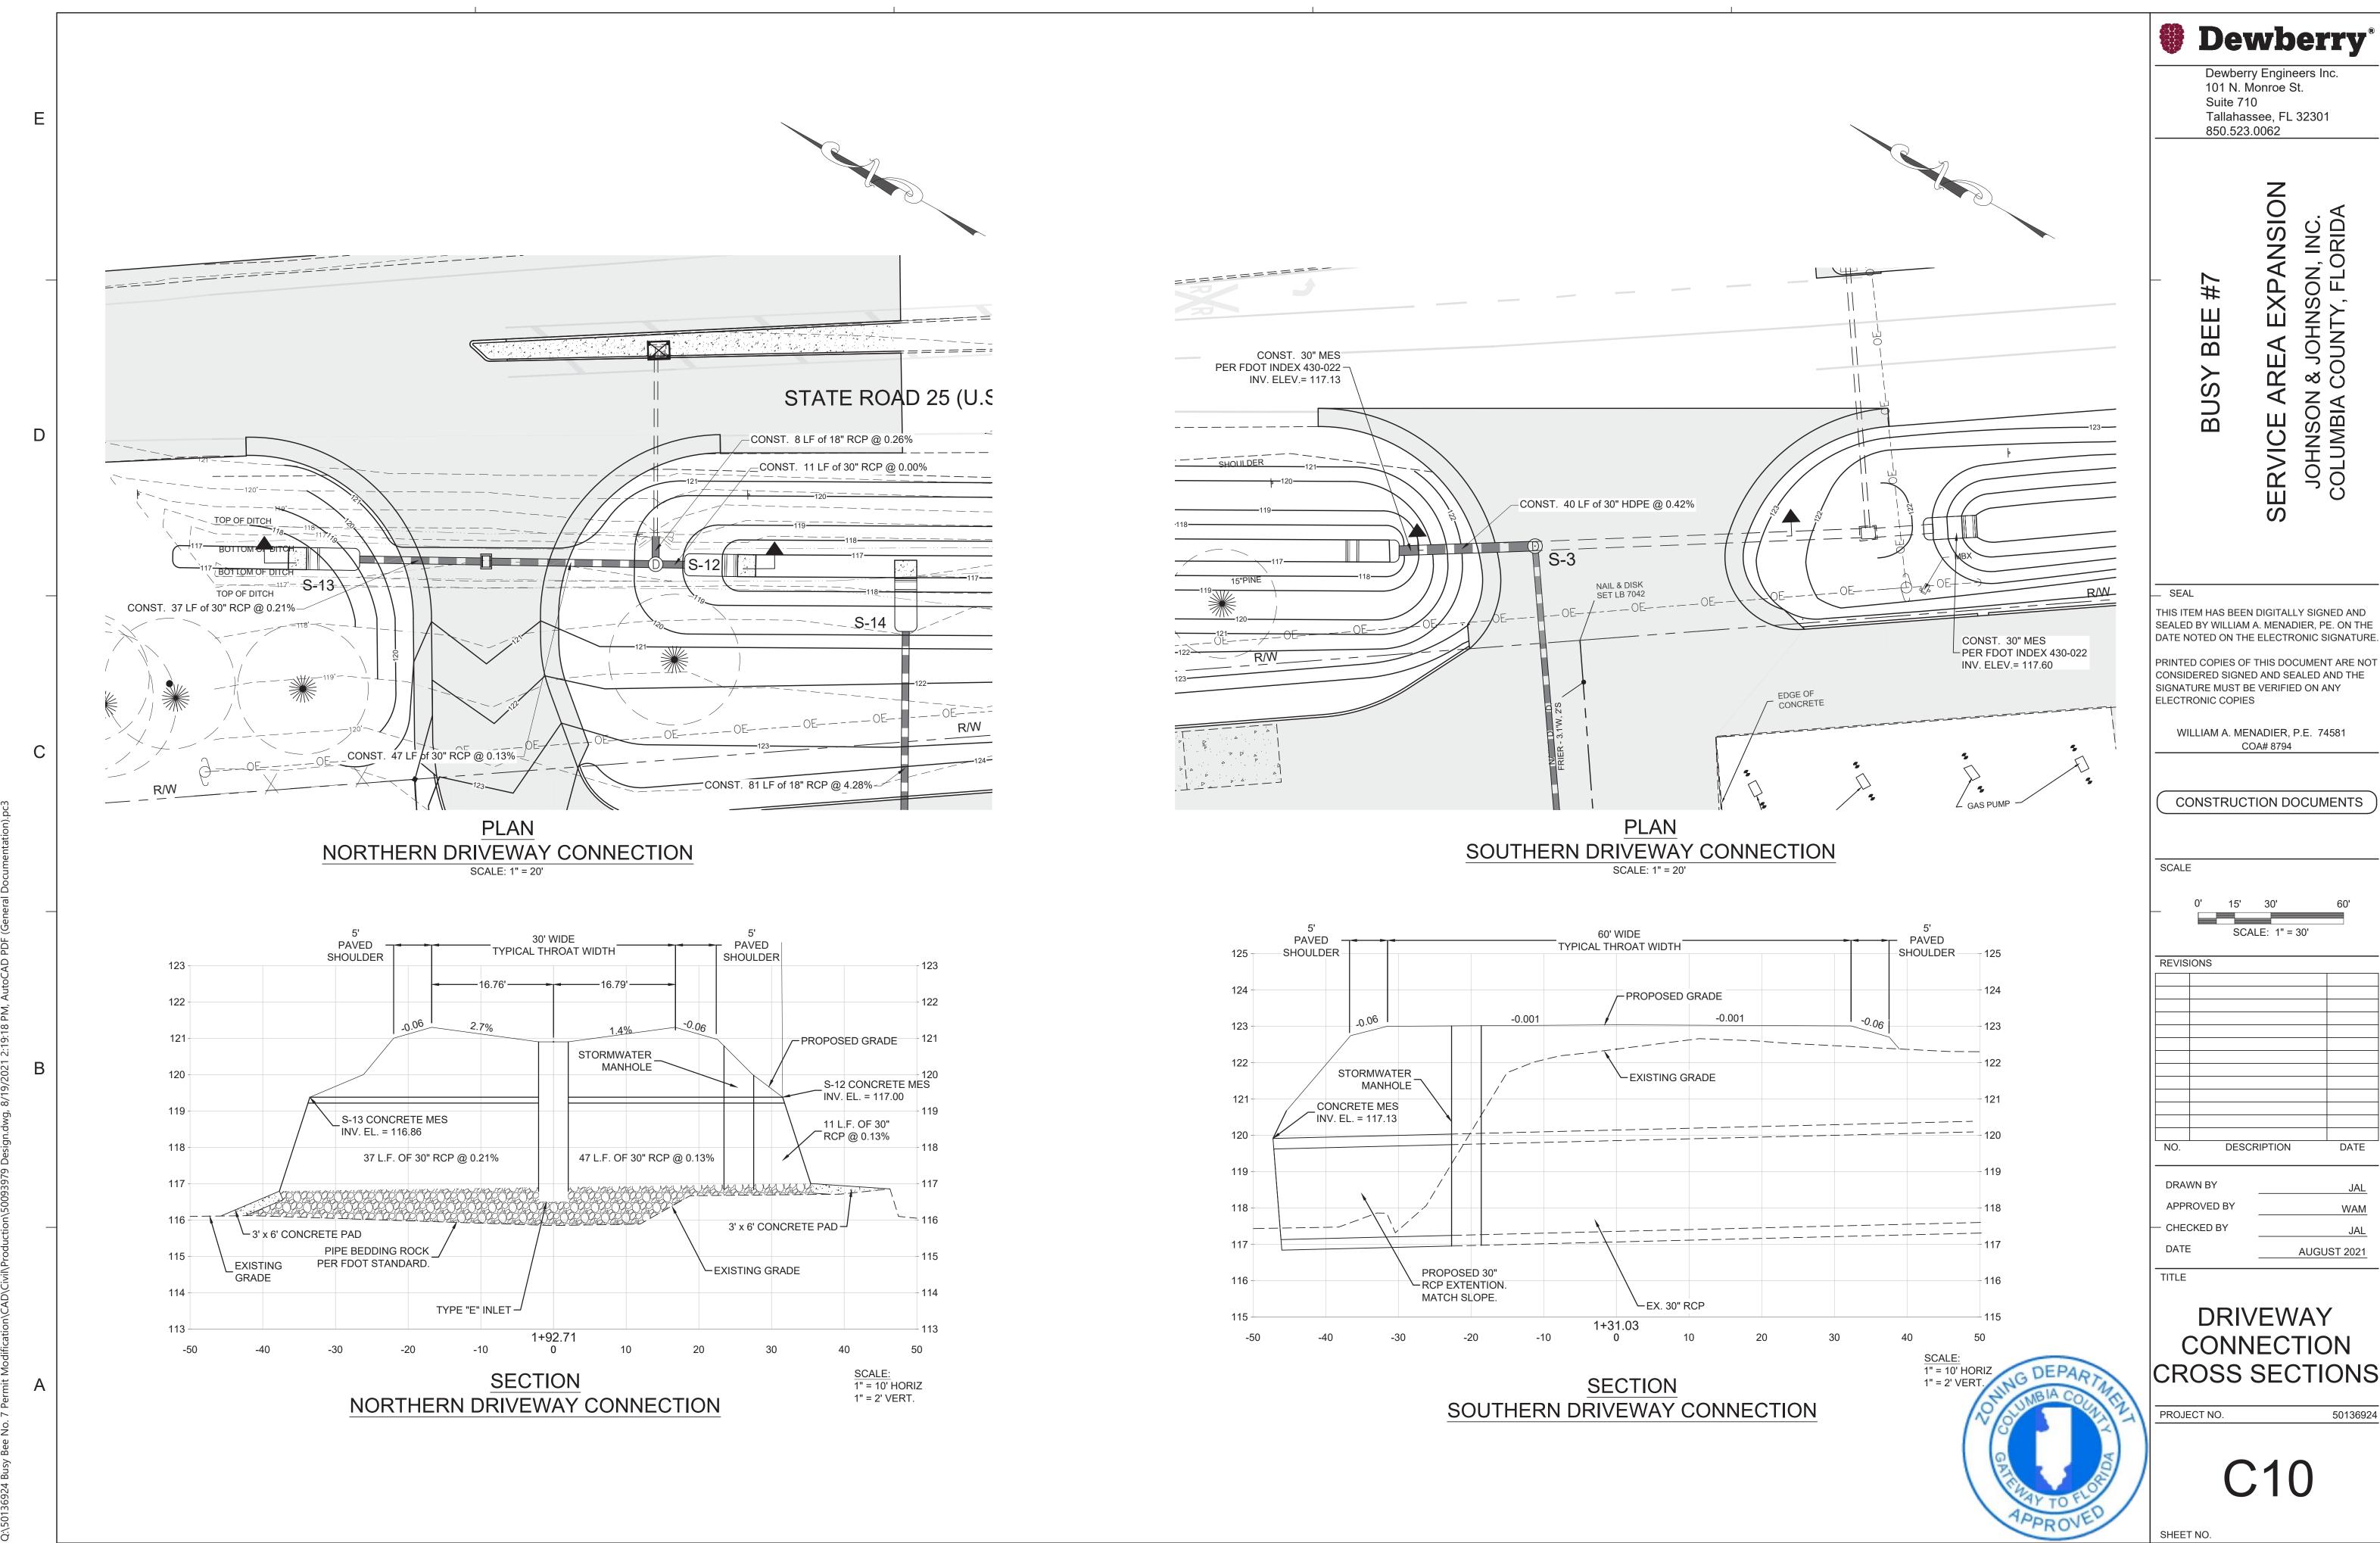




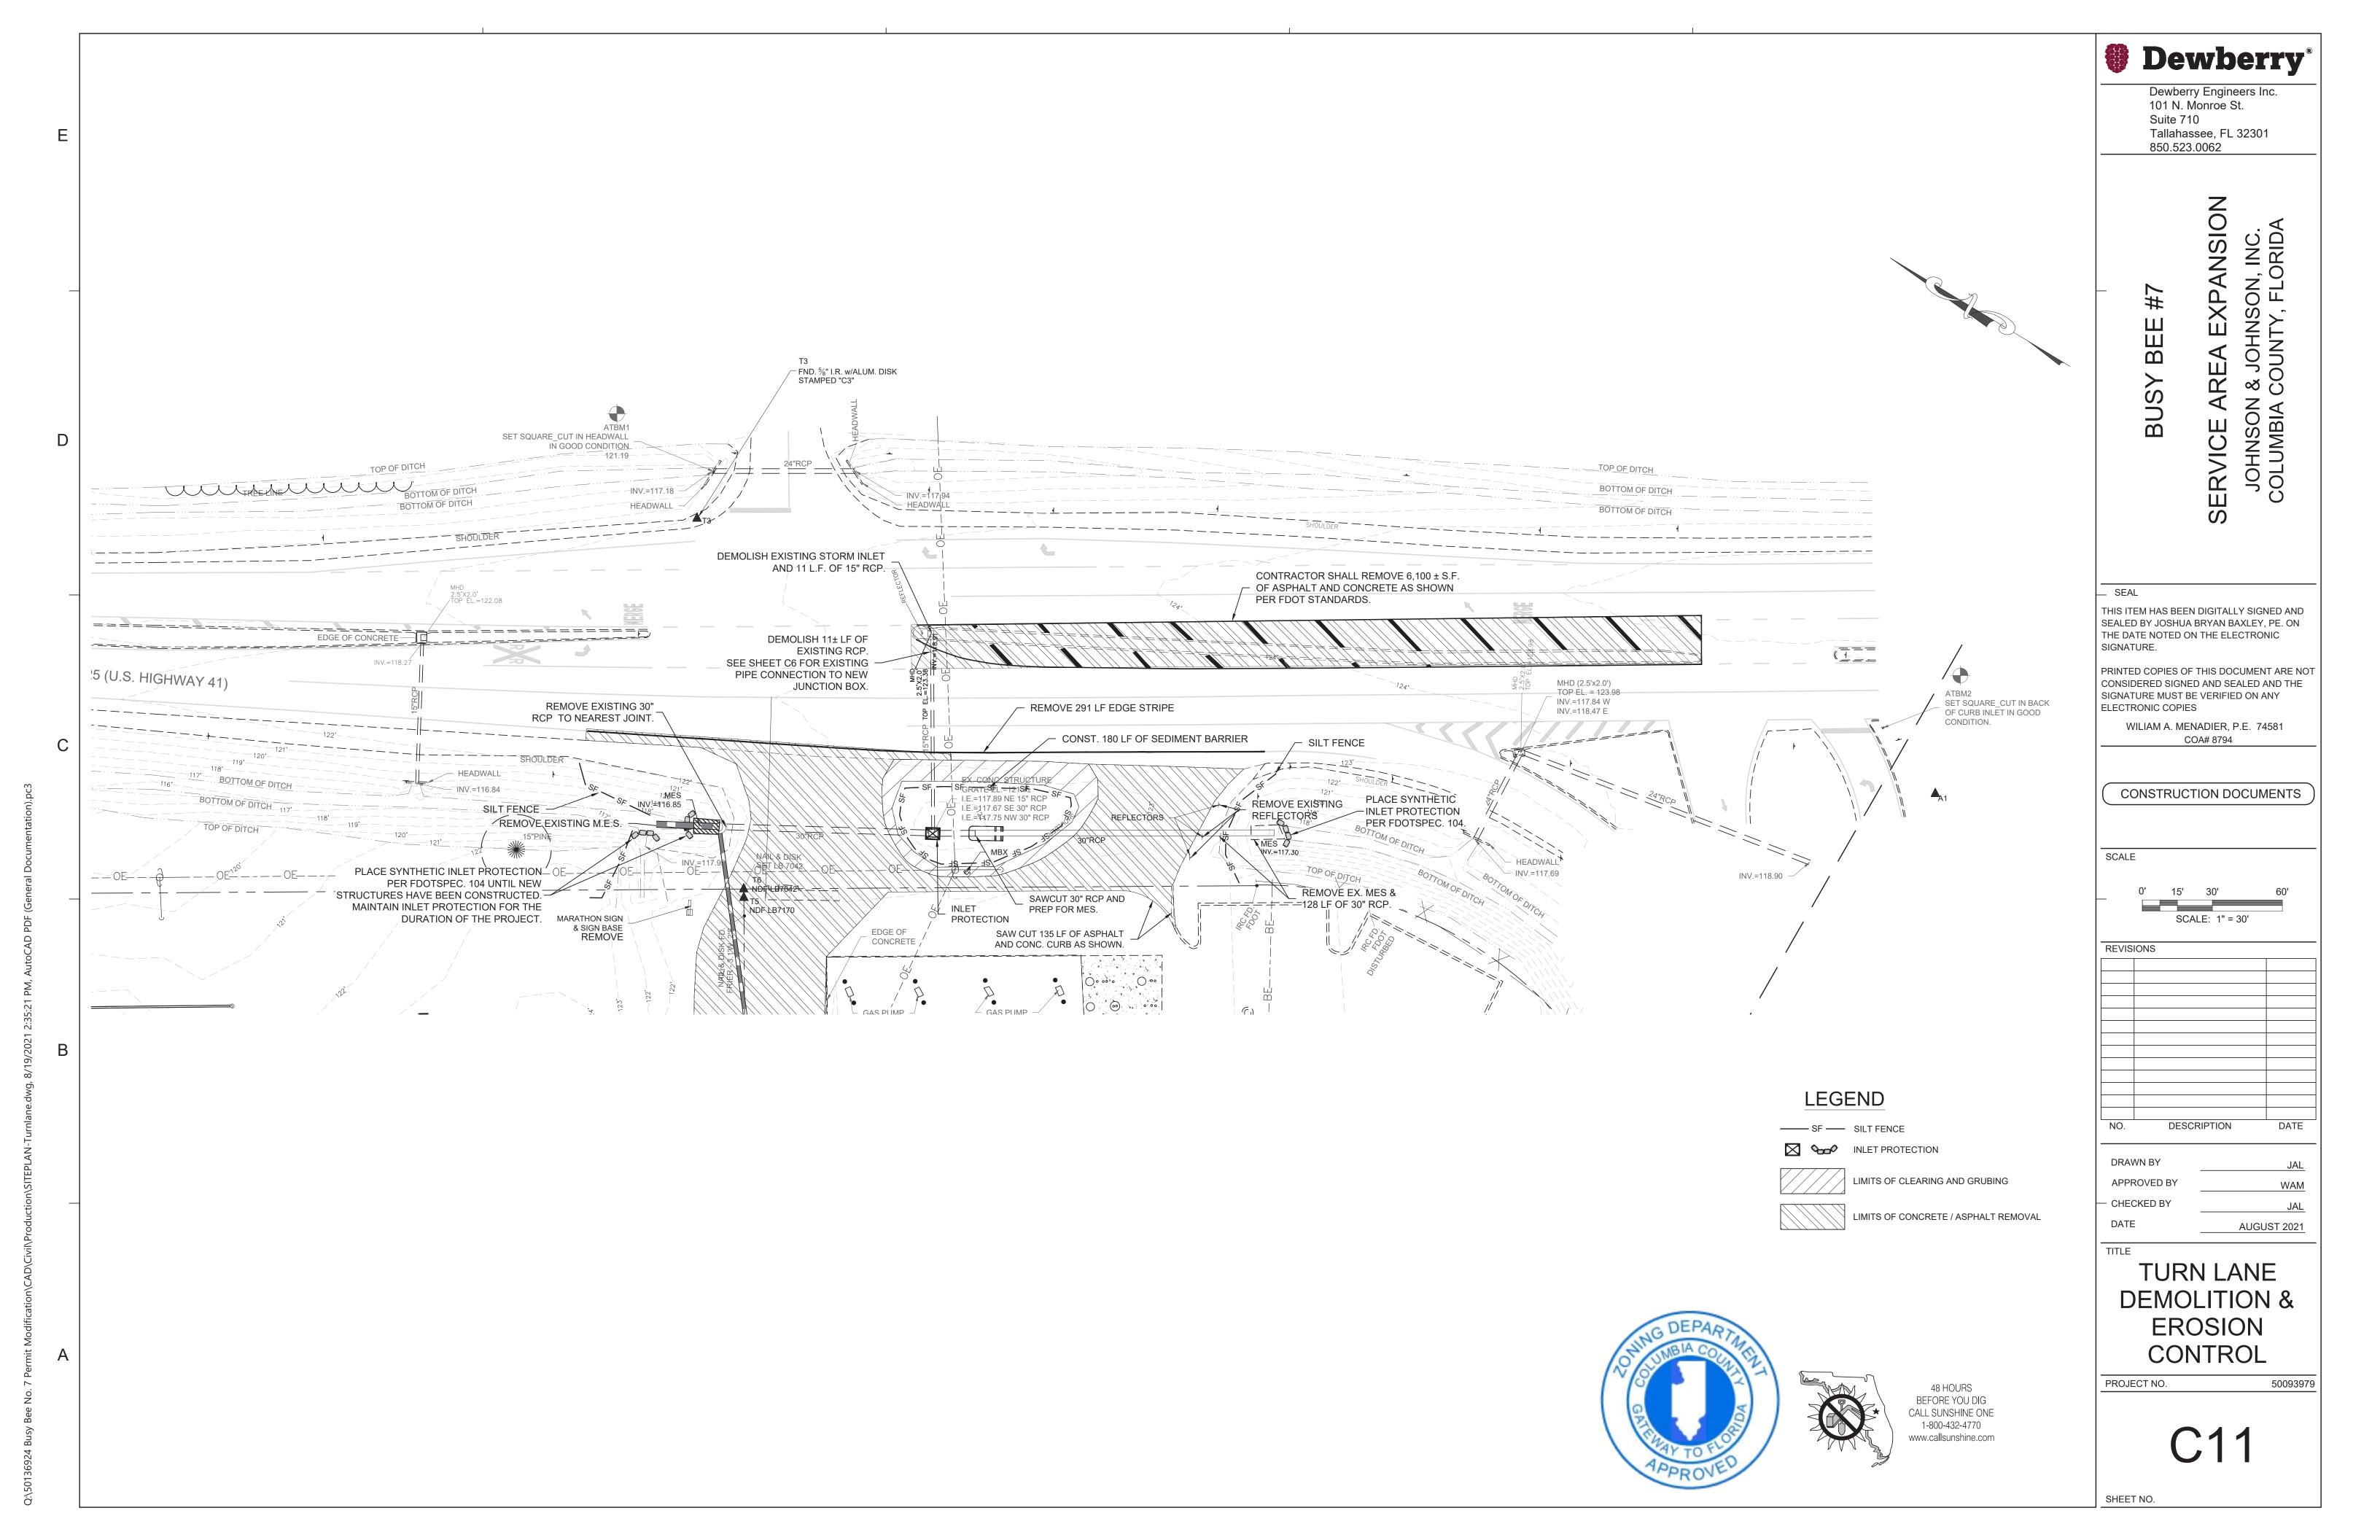


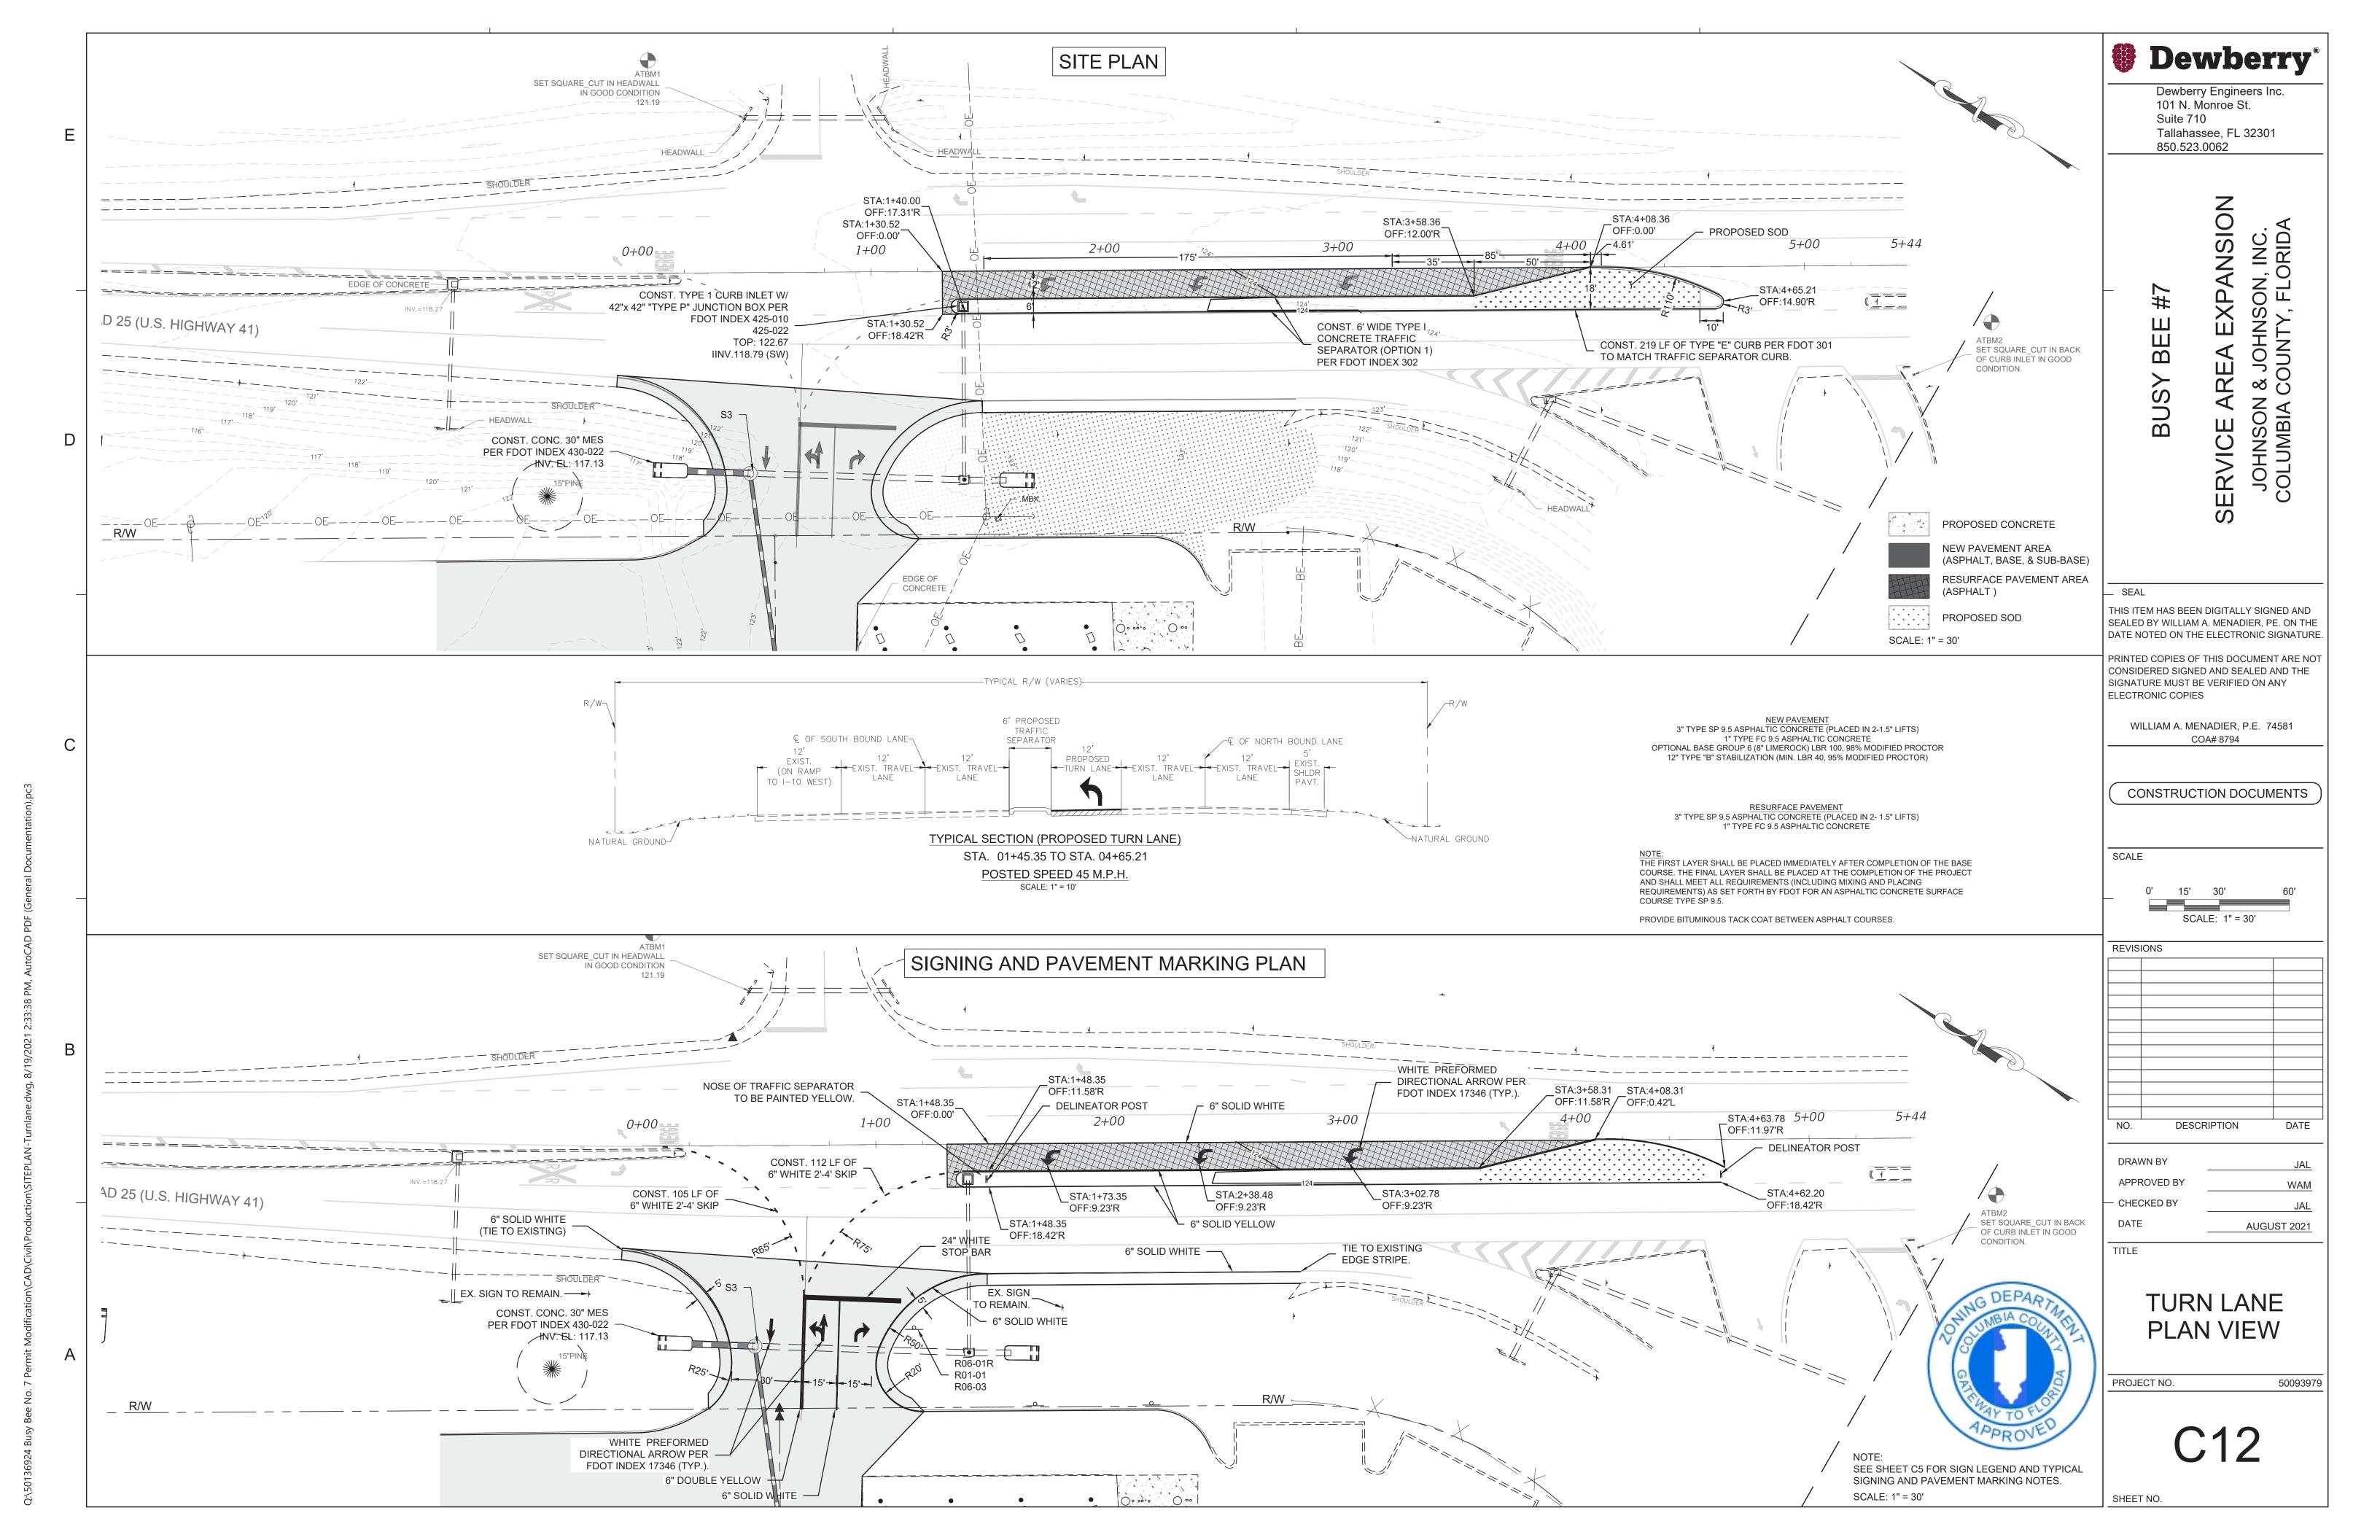


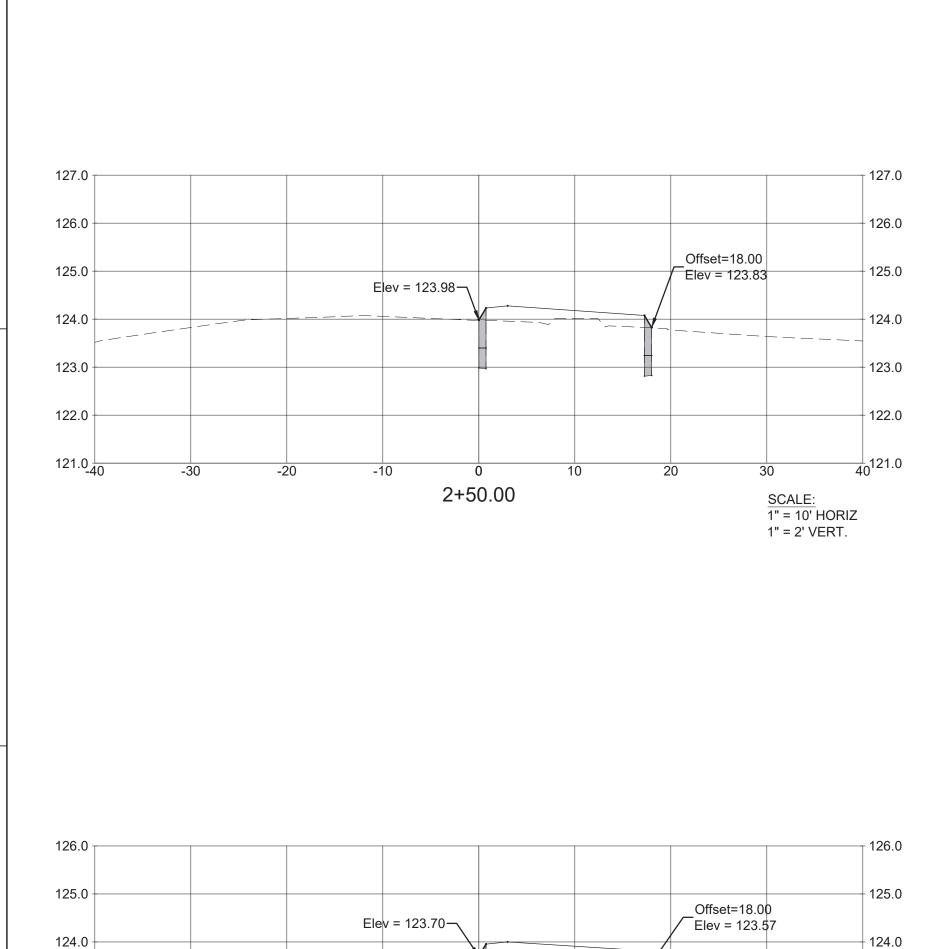




CROSS SECTIONS



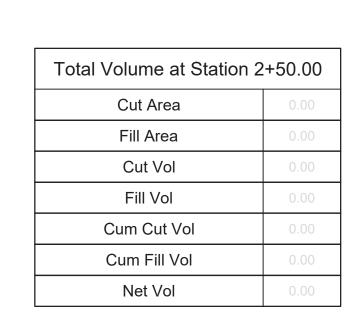


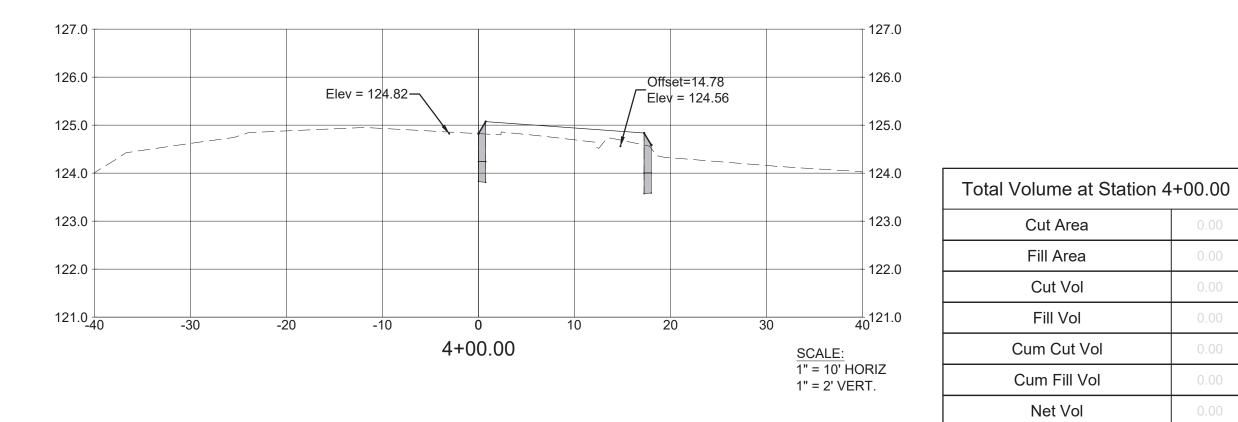


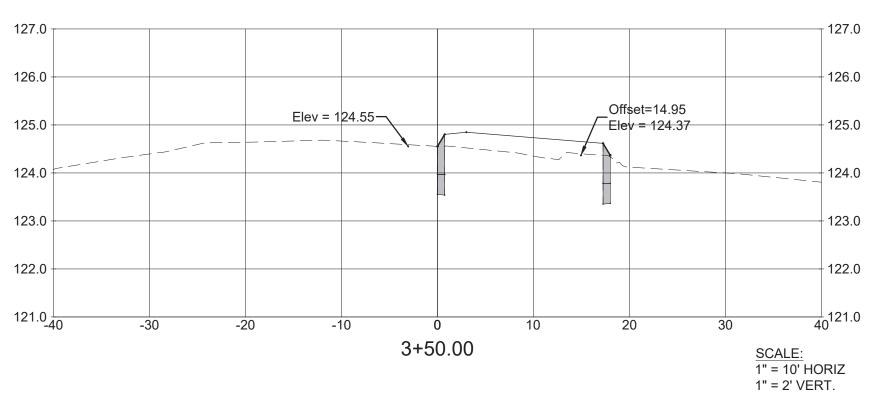
2+00.00

Elev = 123.36-\(\)

1+50.00







Total Volume at Station 3	Total Volume at Station 3+50.00				
Cut Area	0.00				
Fill Area	0.00				
Cut Vol	0.00				
Fill Vol	0.00				
Cum Cut Vol	0.00				
Cum Fill Vol	0.00				
Net Vol	0.00				

Cut Area

Fill Area

Cut Vol

Fill Vol

Cum Cut Vol

Cum Fill Vol

Net Vol



Total Volume at Station 3+00.00				
Cut Area	0.00			
Fill Area	0.00			
Cut Vol	0.00			
Fill Vol	0.00			
Cum Cut Vol	0.00			
Cum Fill Vol	0.00			
Net Vol	0.00			

		125.0	
3.00 3.57		124.0	
		123.0	
		122.0	
		121.0	
30	40	₀ 120.0	
SCALE: 1" = 10' H 1" = 2' VI			

Total Volume at Station 2+00.00		
Cut Area	0.00	
Fill Area	0.00	
Cut Vol	0.00	
Fill Vol	0.00	
Cum Cut Vol	0.00	
Cum Fill Vol	0.00	
Net Vol	0.00	

	125.0		
00 3.21	124.0		
	123.0	Total Volume at Stati	on 1+50.00
	122.0	Cut Area	0.00
	121.0	Fill Area	0.00
	121.0	Cut Vol	0.00
30	40120.0	Fill Vol	0.00
SCALE:		Cum Cut Vol	0.00
1" = 10' H0 1" = 2' VEF		Cum Fill Vol	0.00
		Net Vol	0.00

126.0

Offset=18.00 Elev = 123.21

127.0									127.0
126.0									126.0
125.0			Elev =	124.28—			set=14.95		125.0
124.0						Ele	v = 123.97 — — — — —		124.0
123.0									123.0
122.0									122.0
121.0_	40 -30) -2	20 -1			0 2	0 30) 4	121.0
				3+0	0.00			SCALE: 1" = 10' HC 1" = 2' VEF	



101 N. Monroe St. Suite 710 Tallahassee, FL 32301 850.523.0062

> **EXPANSION** A & JOHNSON, INC. AREA SERVICE

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WILLIAM A. MENADIER, P.E. 74581 COA# 8794

CONSTRUCTION DOCUMENTS

SCALE

AS SHOWN

REVISIONS DESCRIPTION

DRAWN BY APPROVED BY WAM CHECKED BY DATE AUGUST 2021

TITLE

CROSS **SECTIONS**

PROJECT NO.

50093979

SHEET NO.

D

123.0 -

122.0 -

121.0 -

126.0_T

125.0 -

124.0

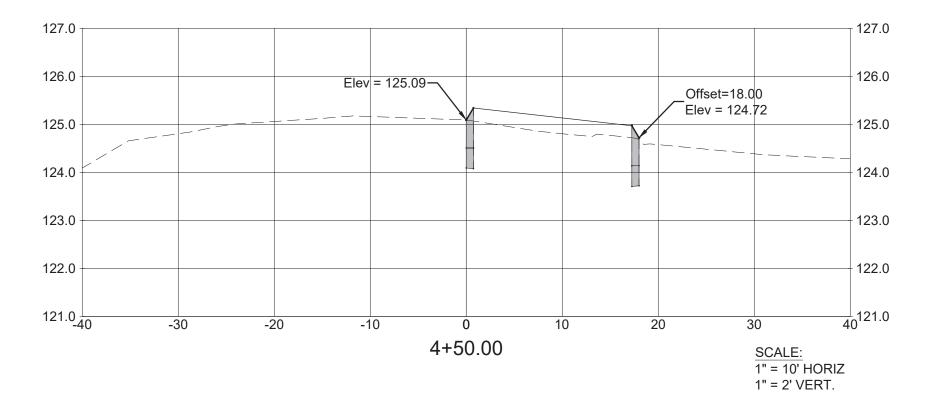
123.0

122.0

121.0 -

120.0_40

PROPOSED ASPHALT PAVEMENT PROPOSED - ASPHALT PAVEMENT EXISTING GRADE - TOP OF POND 125.00 TOP OF POND 124.00 PROPOSED PROPOSED GRADE — TYPE "D" CURB (TYPICAL) PROPOSED PROPOSED TYPE "C" INLET
OUTFALL STRUCTURE. GRADE 128 TOP EL. = 123.00 PROPOSED PROPOSED 126 -18" RCP -STORMWATER STORM PIPE -MANAGEMENT PROPOSED **FACILITY** 124 -124 GRADE PROPOSED 122 M.E.S. PROPOSED STORMWATER MANAGEMENT FACILITY _ 12" CLAY LINER __ _ TOP EL. = 124.00 __ PROPOSED 120 -- 120 18" RCP STORM PIPE. ► POND BOTTOM = 121.00 INV. EL. = 121.00 118 -─ POND BOTTOM = 119.00 0+00 0+60 0+80 3+60 0+20 0+40 1+00 1+20 1+40 1+60 1+80 2+00 2+20 2+40 2+60 2+80 3+00 3+20 3+40 3+80 4+00 12" CLAY LINER SCALE: 1" = 2' HORIZ **CROSS SECTION "A"** 1" = 2' VERT.



Total Volume at Station 4+50.00			
Cut Area	0.00		
Fill Area	0.00		
Cut Vol	0.00		
Fill Vol	0.00		
Cum Cut Vol	0.00		
Cum Fill Vol	0.00		
Net Vol	0.00		





Dewberry Engineers Inc. 101 N. Monroe St. Suite 710 Tallahassee, FL 32301 850.523.0062

> EXPANSION & JOHNSON, INC. COUNTY, FLORIDA SERVICE AREA E
> JOHNSON & JOHN
> COLUMBIA COUNT

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> WILLIAM A. MENADIER, P.E. 74581 COA# 8794

CONSTRUCTION DOCUMENTS

SCALE

REVISIONS DESCRIPTION

DRAWN BY APPROVED BY WAM CHECKED BY DATE AUGUST 2021

TITLE

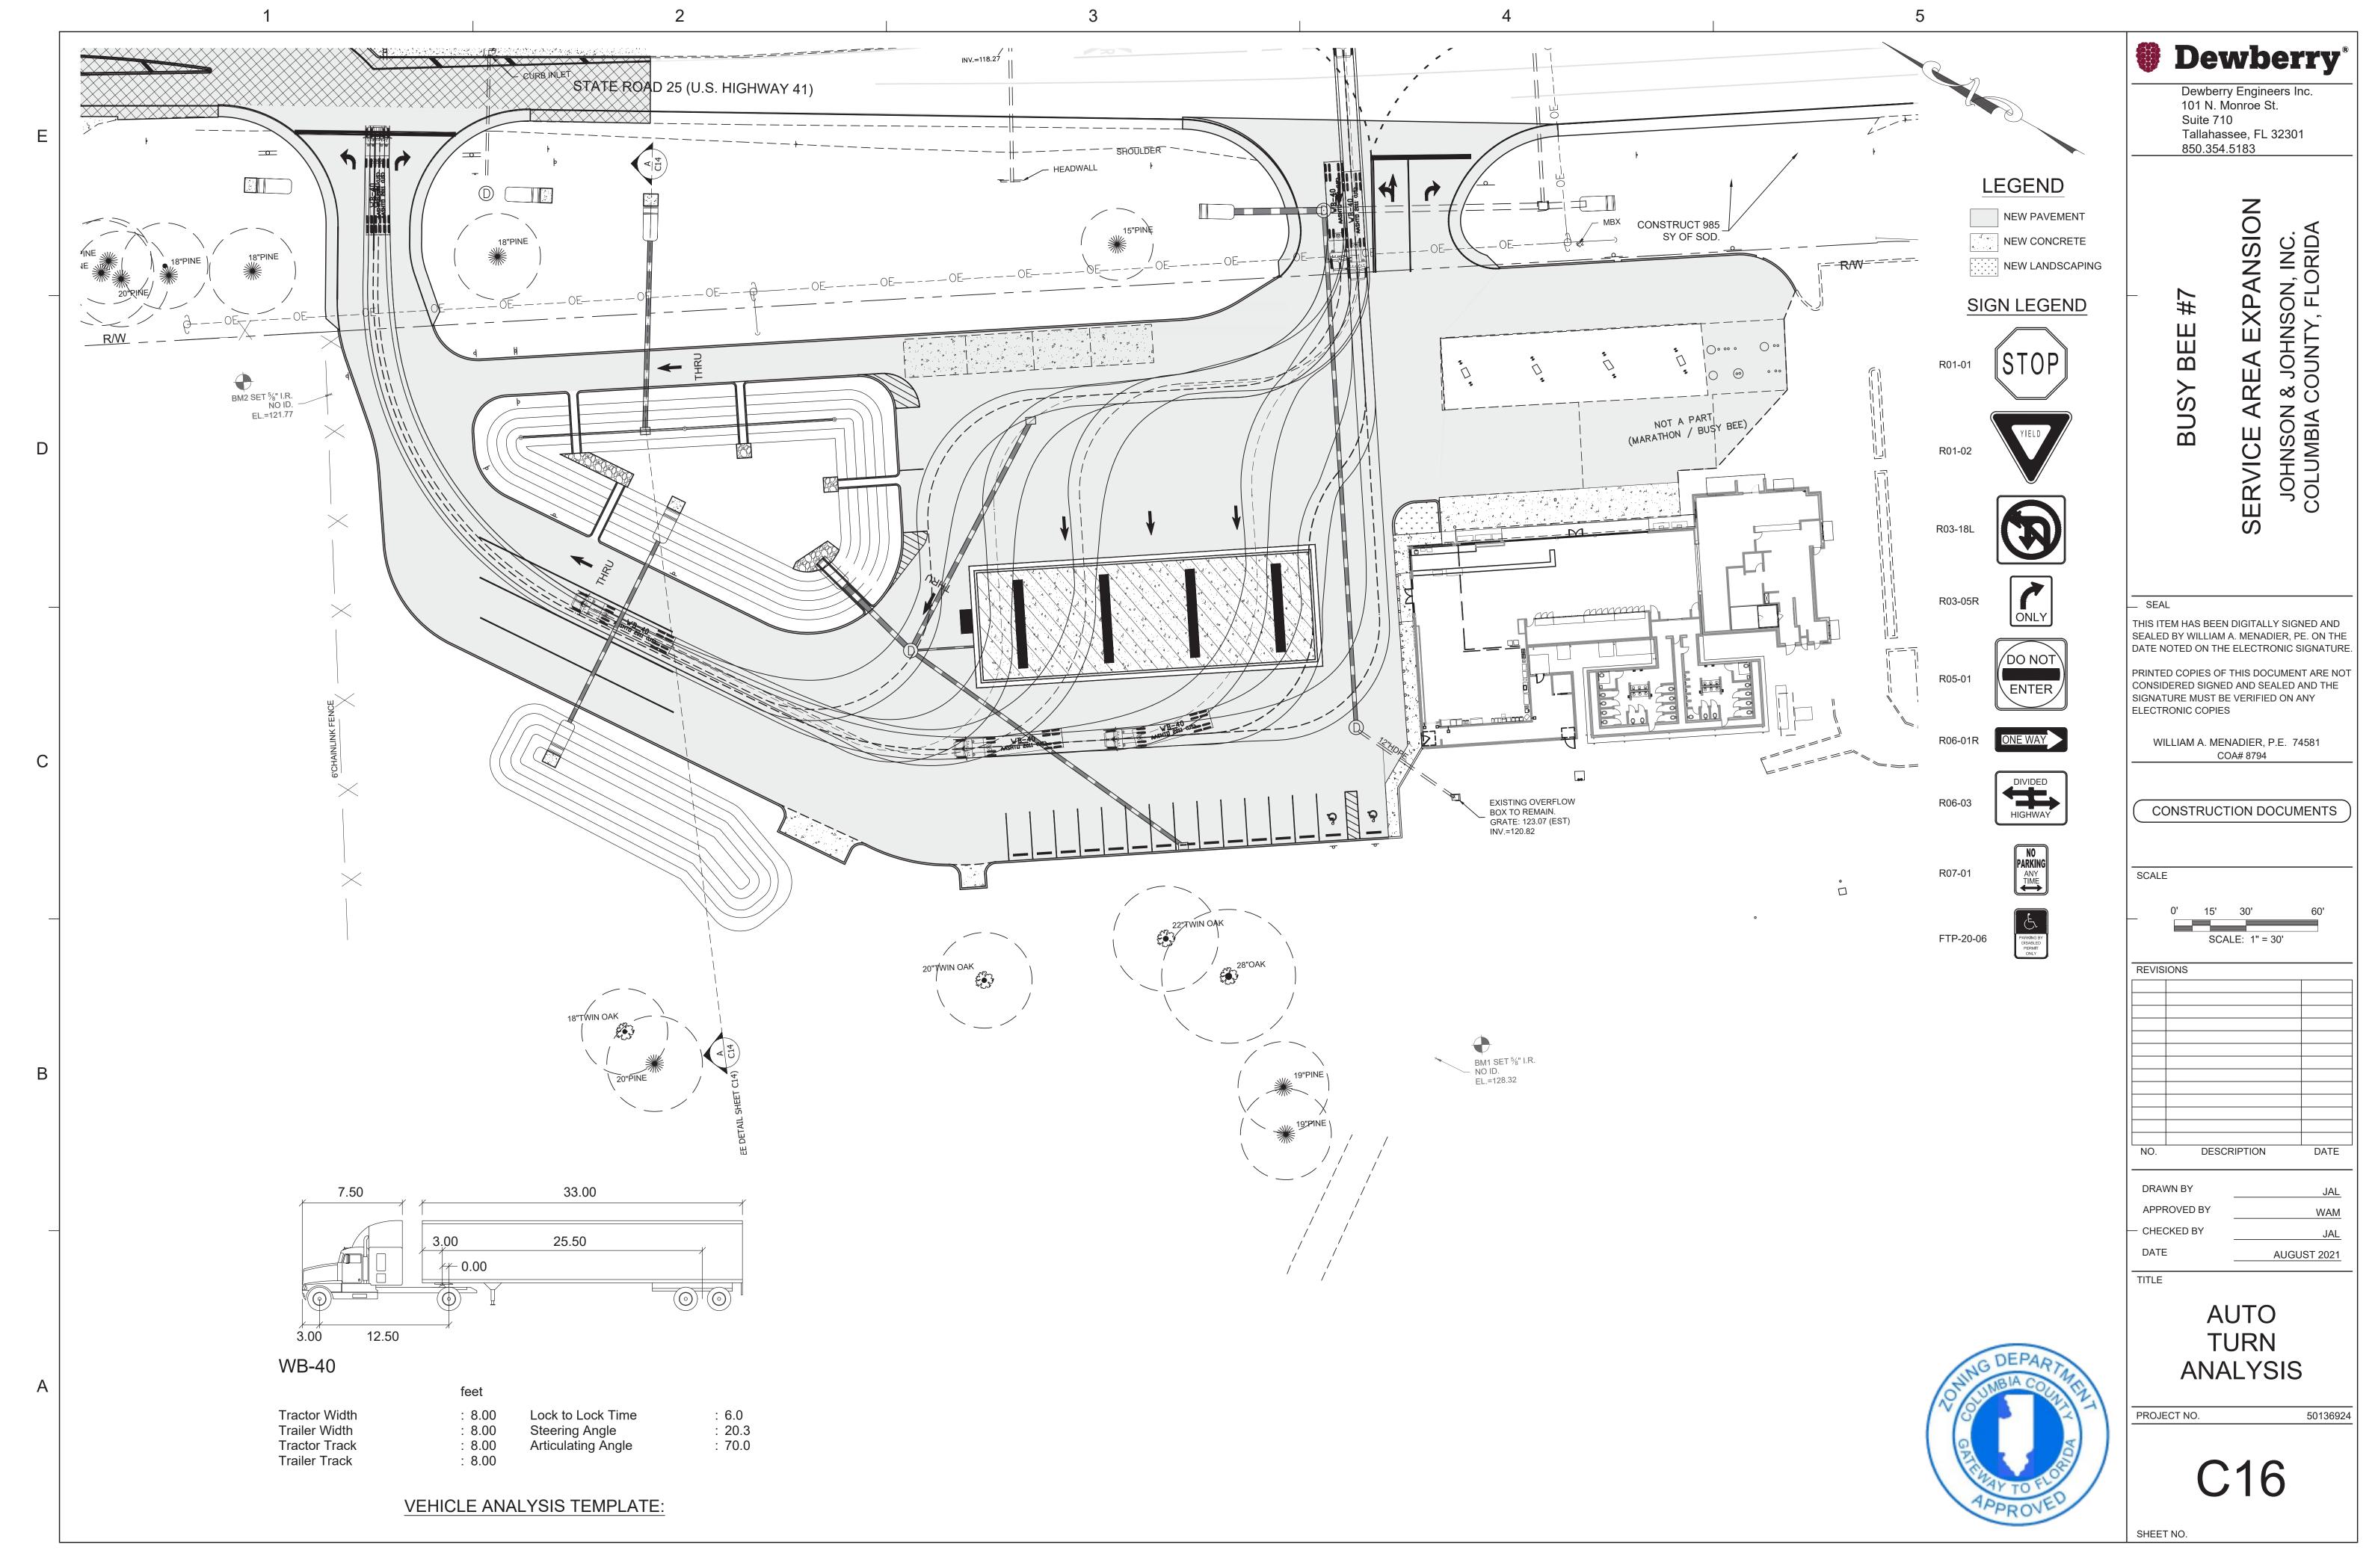
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PROJECT NO.

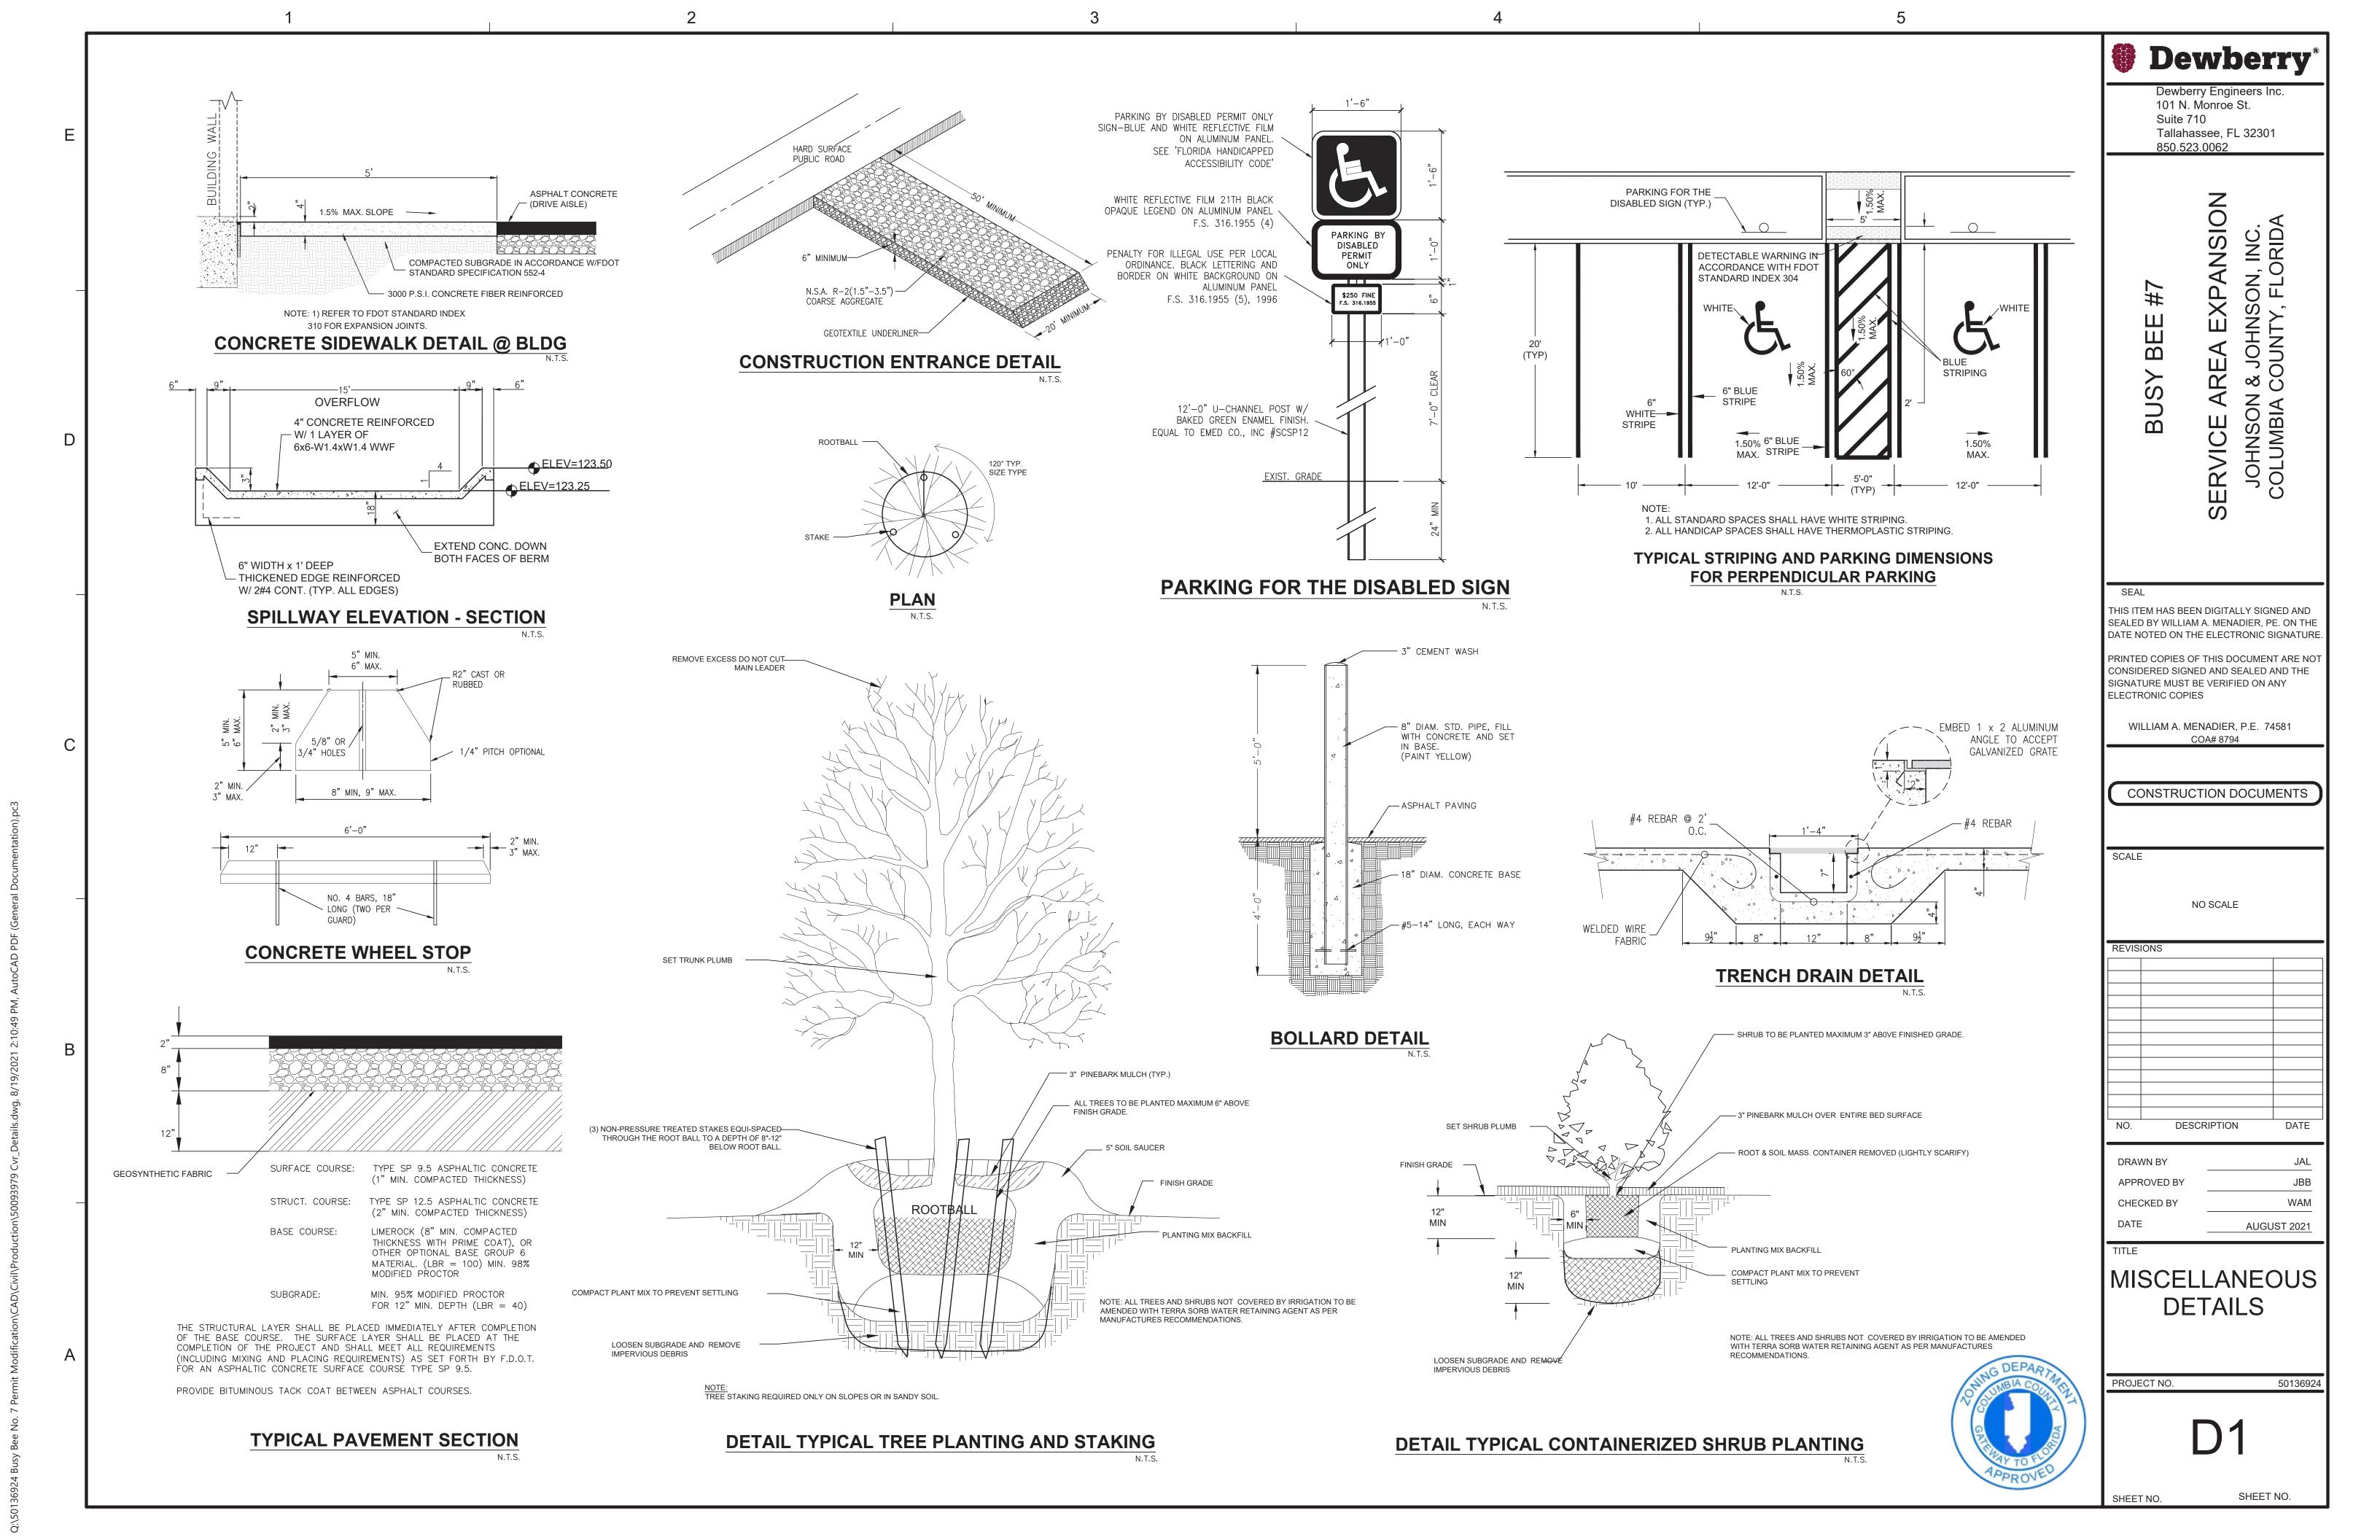
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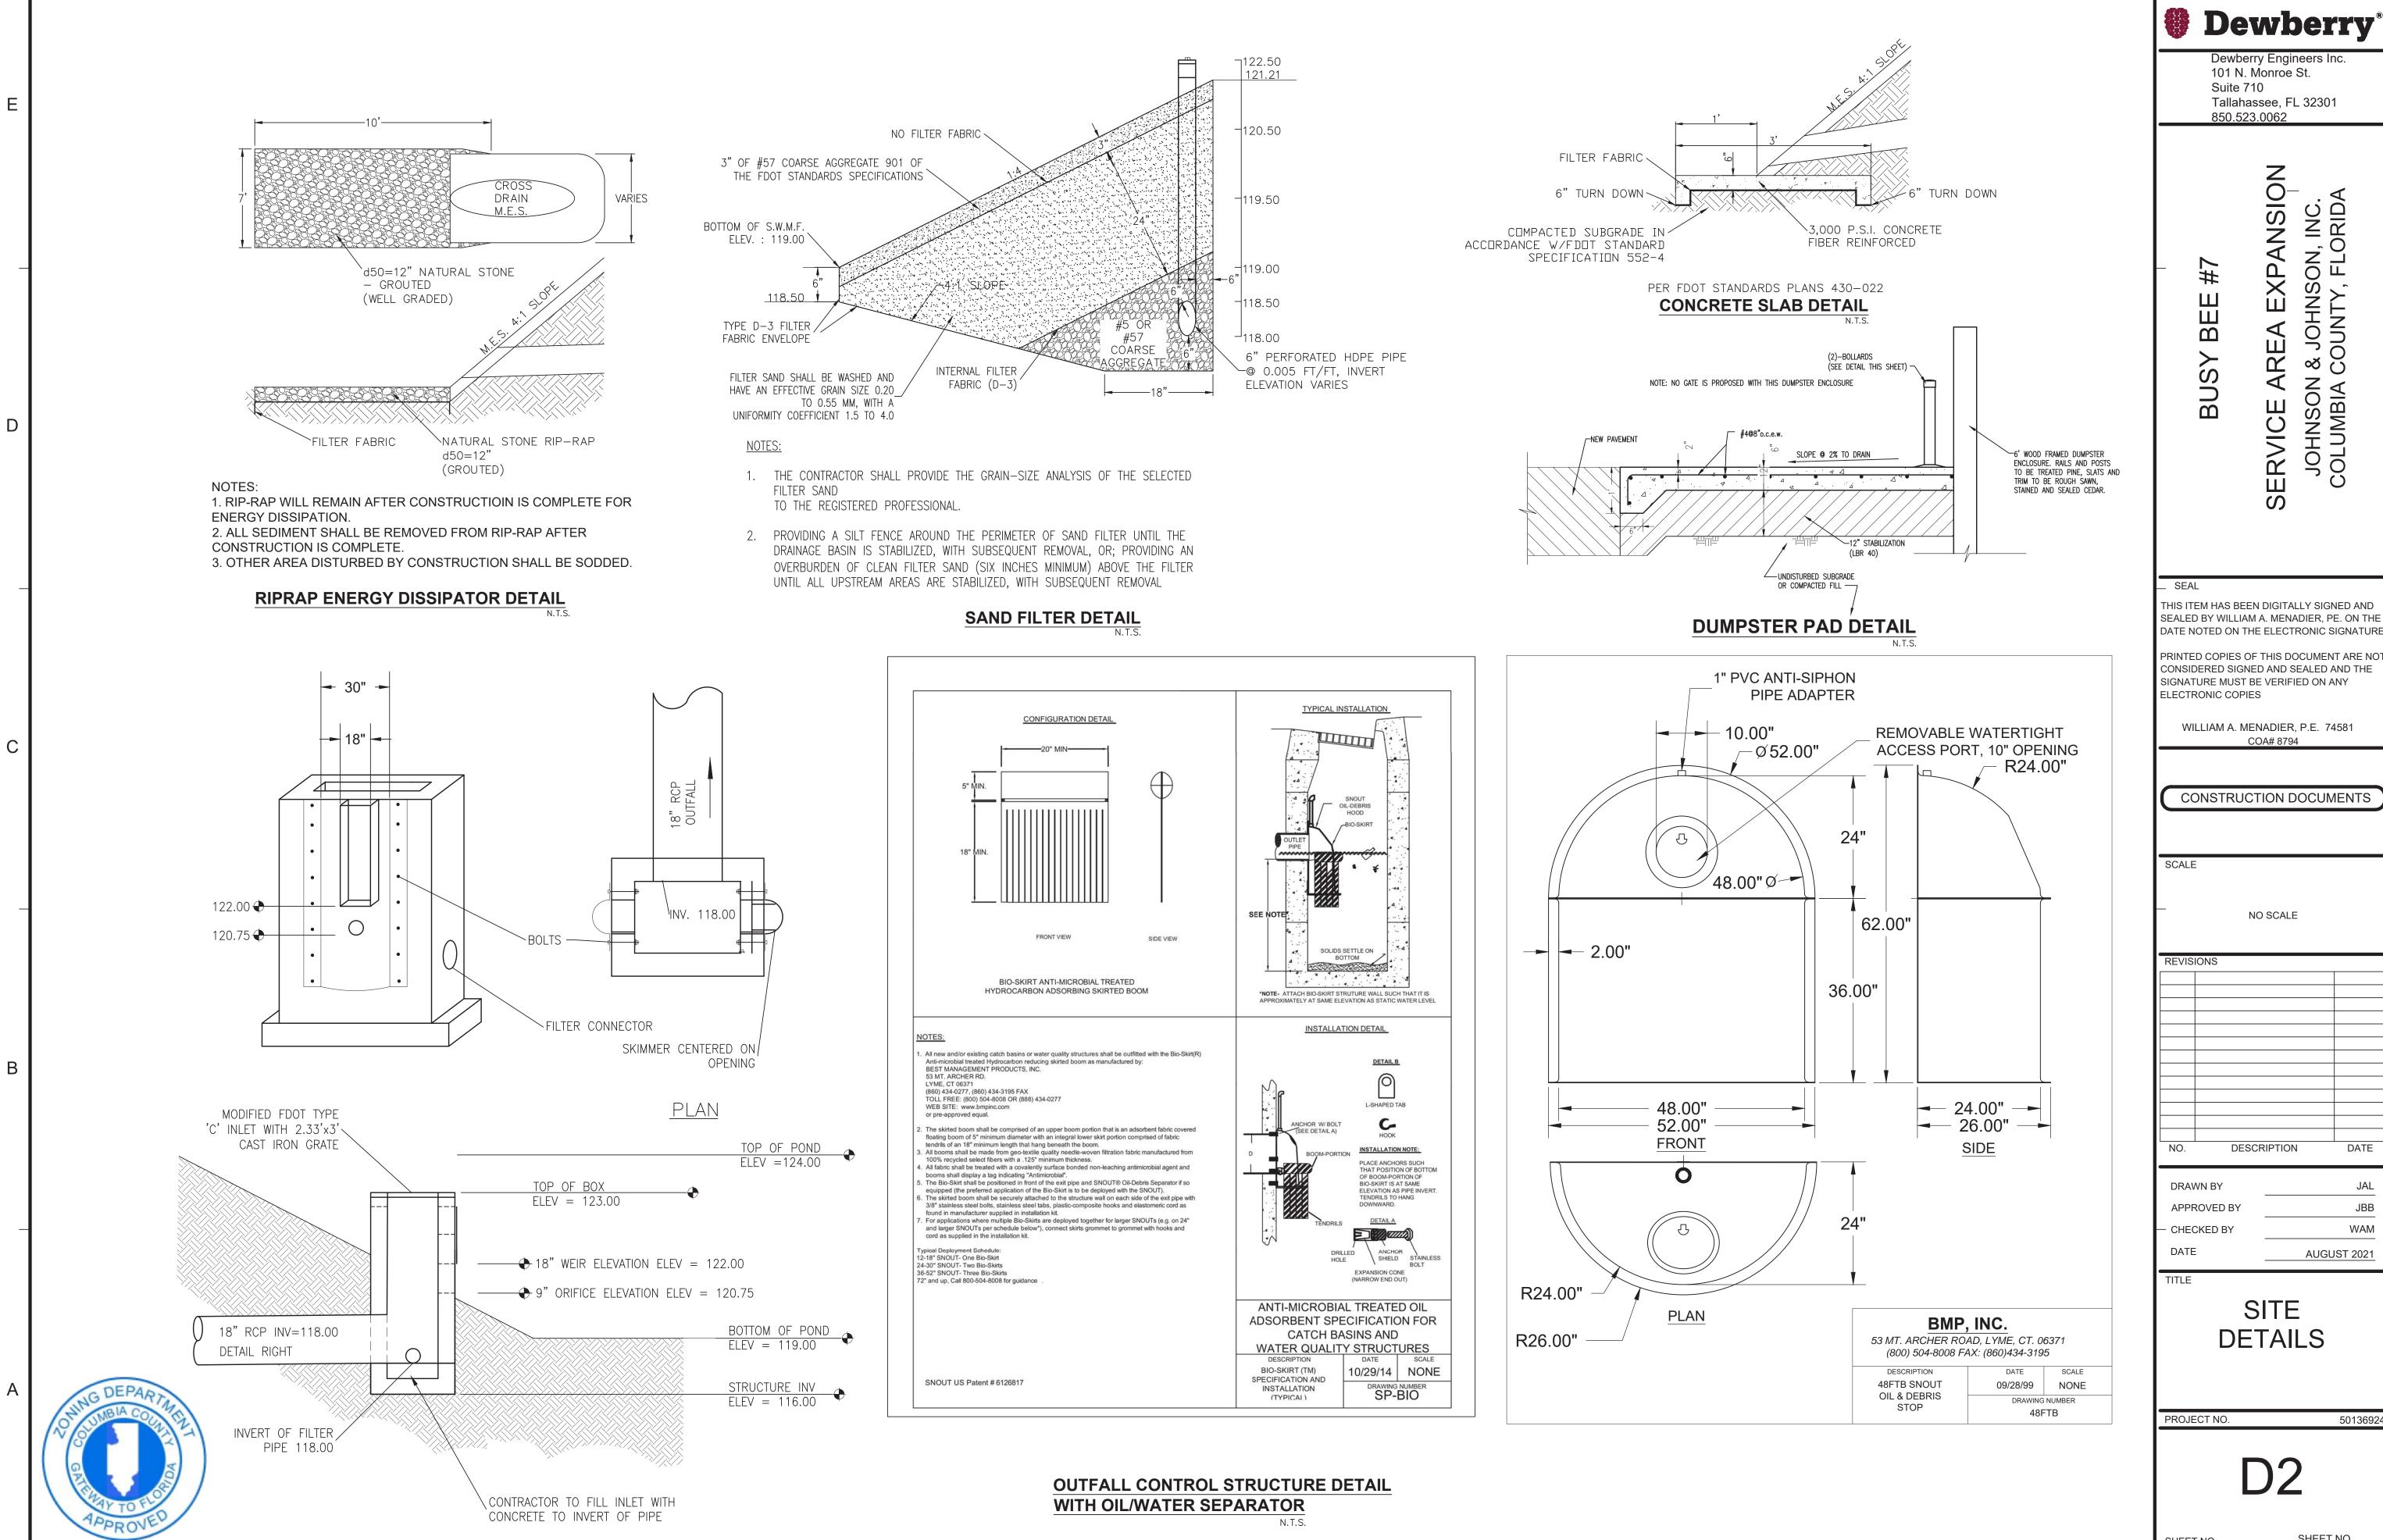
SHEET NO.

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