
REVISIONS

SOFTPIAN ARCHITECTURL DESIGN SOFTWARE

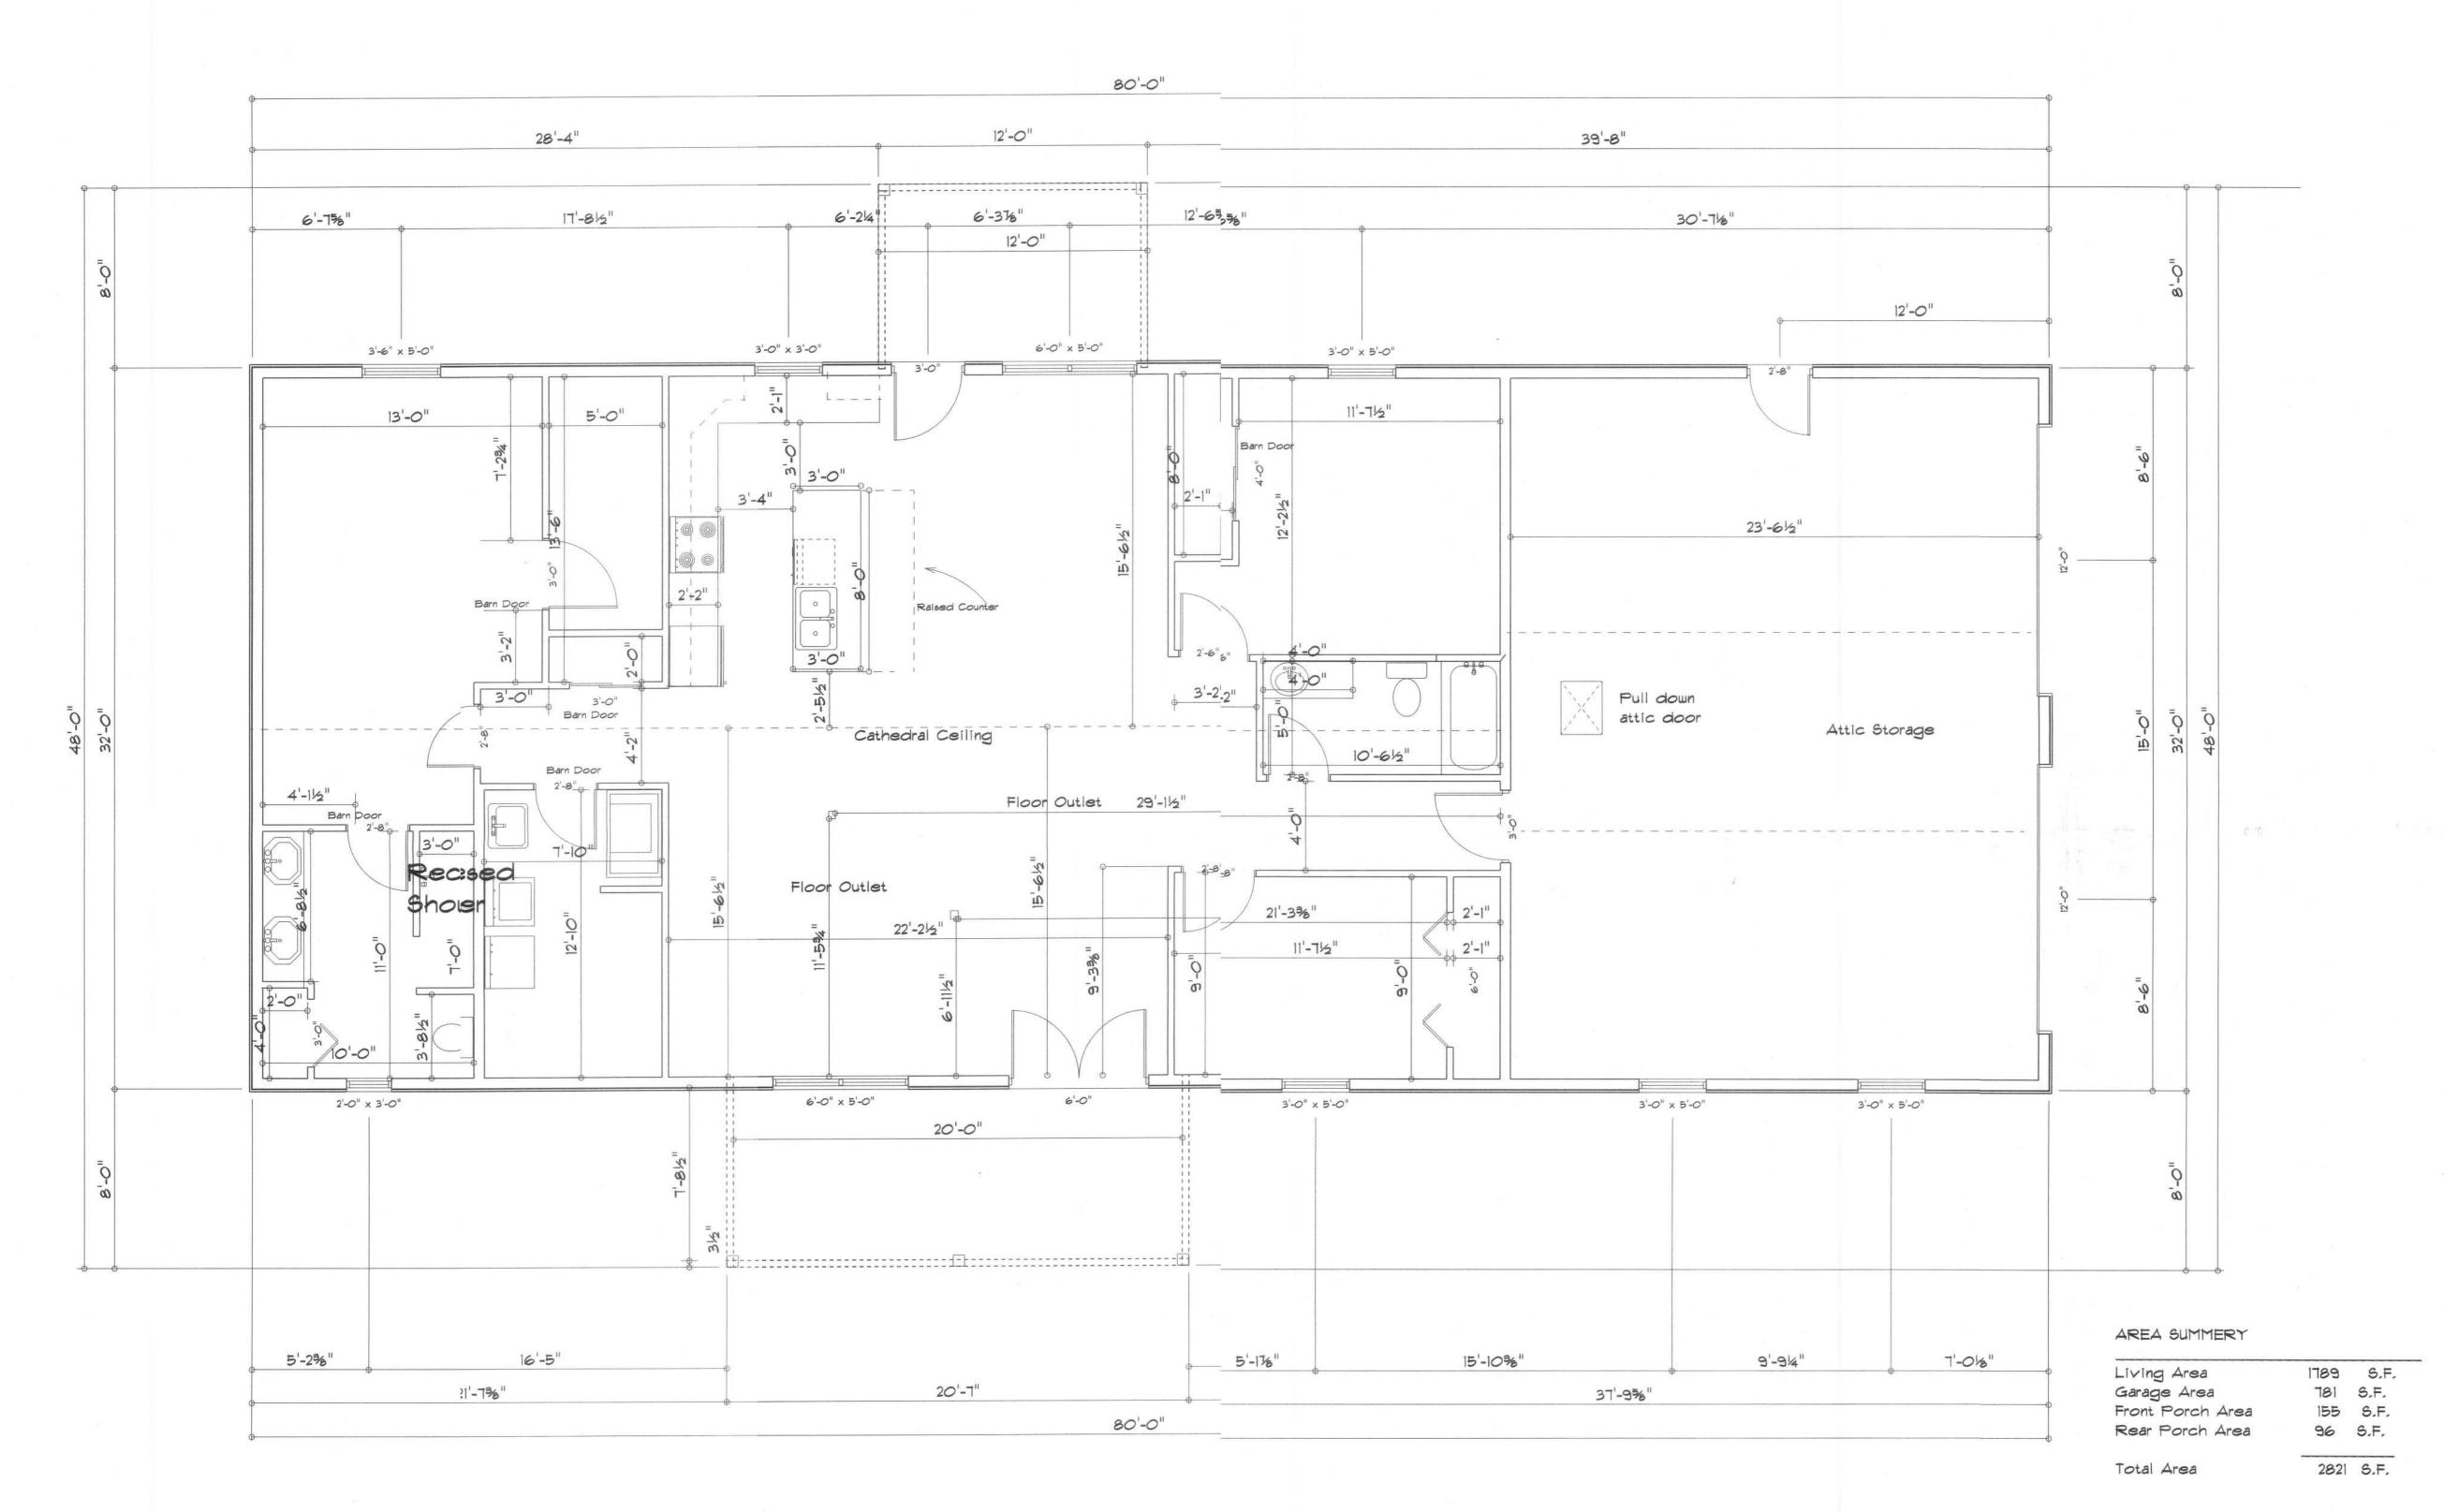

Floor Plann
1" = 1'



RESIDENCE
Scot Paul

AIDRESS: ColumbiaCounty, Florida

Woodman Park Builders, Inc. Lake Cty, Florida Phone: (3(6) 755 - 2411 Fax: (38)) 755-8684 Email:

PRIN'ED DATE:

DRAWN BY: CHECKED BY:

DESGNED BY:

Mark Haddox


FINALS DATE:

JOB NUMBER:

A-1

## Electrical Plan Notes:

- E-1 Wire all appliances, HVAC units and other equiptment per manufactures specifications.
- E-2 Consult the owner for the number or seperate telephone lines to be installed. Owner is responsible for all overages not noted on plan.
- E-3 All installations shall be per national code 2008.
- E-4 All smoke detectors shall be 120v with battery back-up of the photoelectric type, and shall be interlocked together, install inside and near all bedrooms.
- E-5 Telephone, television and other low voltage devices or outlets shall be as per the owners directions and in accordance with applicable sections of the National Electric Codes latest edition. Owner is responsible for all overages not noted on plan.
- E-6 Electrical contractor shall be responssible for the design and sizing of electrical service and circuits.
- E-T Entry of service (underground or overhead) to to be determined by contractor agreement.
- E-8 All outlets located in residential to be tamper-resistant per NEC.
- E-9 All outlets to be located above base flood elevation.
- E-10 All exterior GFI outlets shall be weatherproof.
- E-11 Overcurrent Protection device shall be installed on the exterior of structures on the load side of the meter to serve as a disconnecting means. Conductors used from the exterior disconnecting means to a panel or sub panel shall have four-wire conductors, of which one conductor shall be used as an equiptment ground.
- E-12 All 120-VOLT, single phase, 15 and 20 ampere branch circuits supplying outlets installed in dwelling unit family rooms, dining rooms, living rooms, parlors, libraries, dens, bedrooms, sun rooms, recreation rooms, closets, hallways, or similar rooms or areas shall be protected by a listed arc-fault circuit interrupter, combination-type installed to provide protection of the branch circuit.
- E-13 Carbon Monoxide alarms shall be required within 10' of all rooms for sleeping purposes in buildings having a fossil-fuel burning heater or appliance, a fireplace or attached garage.

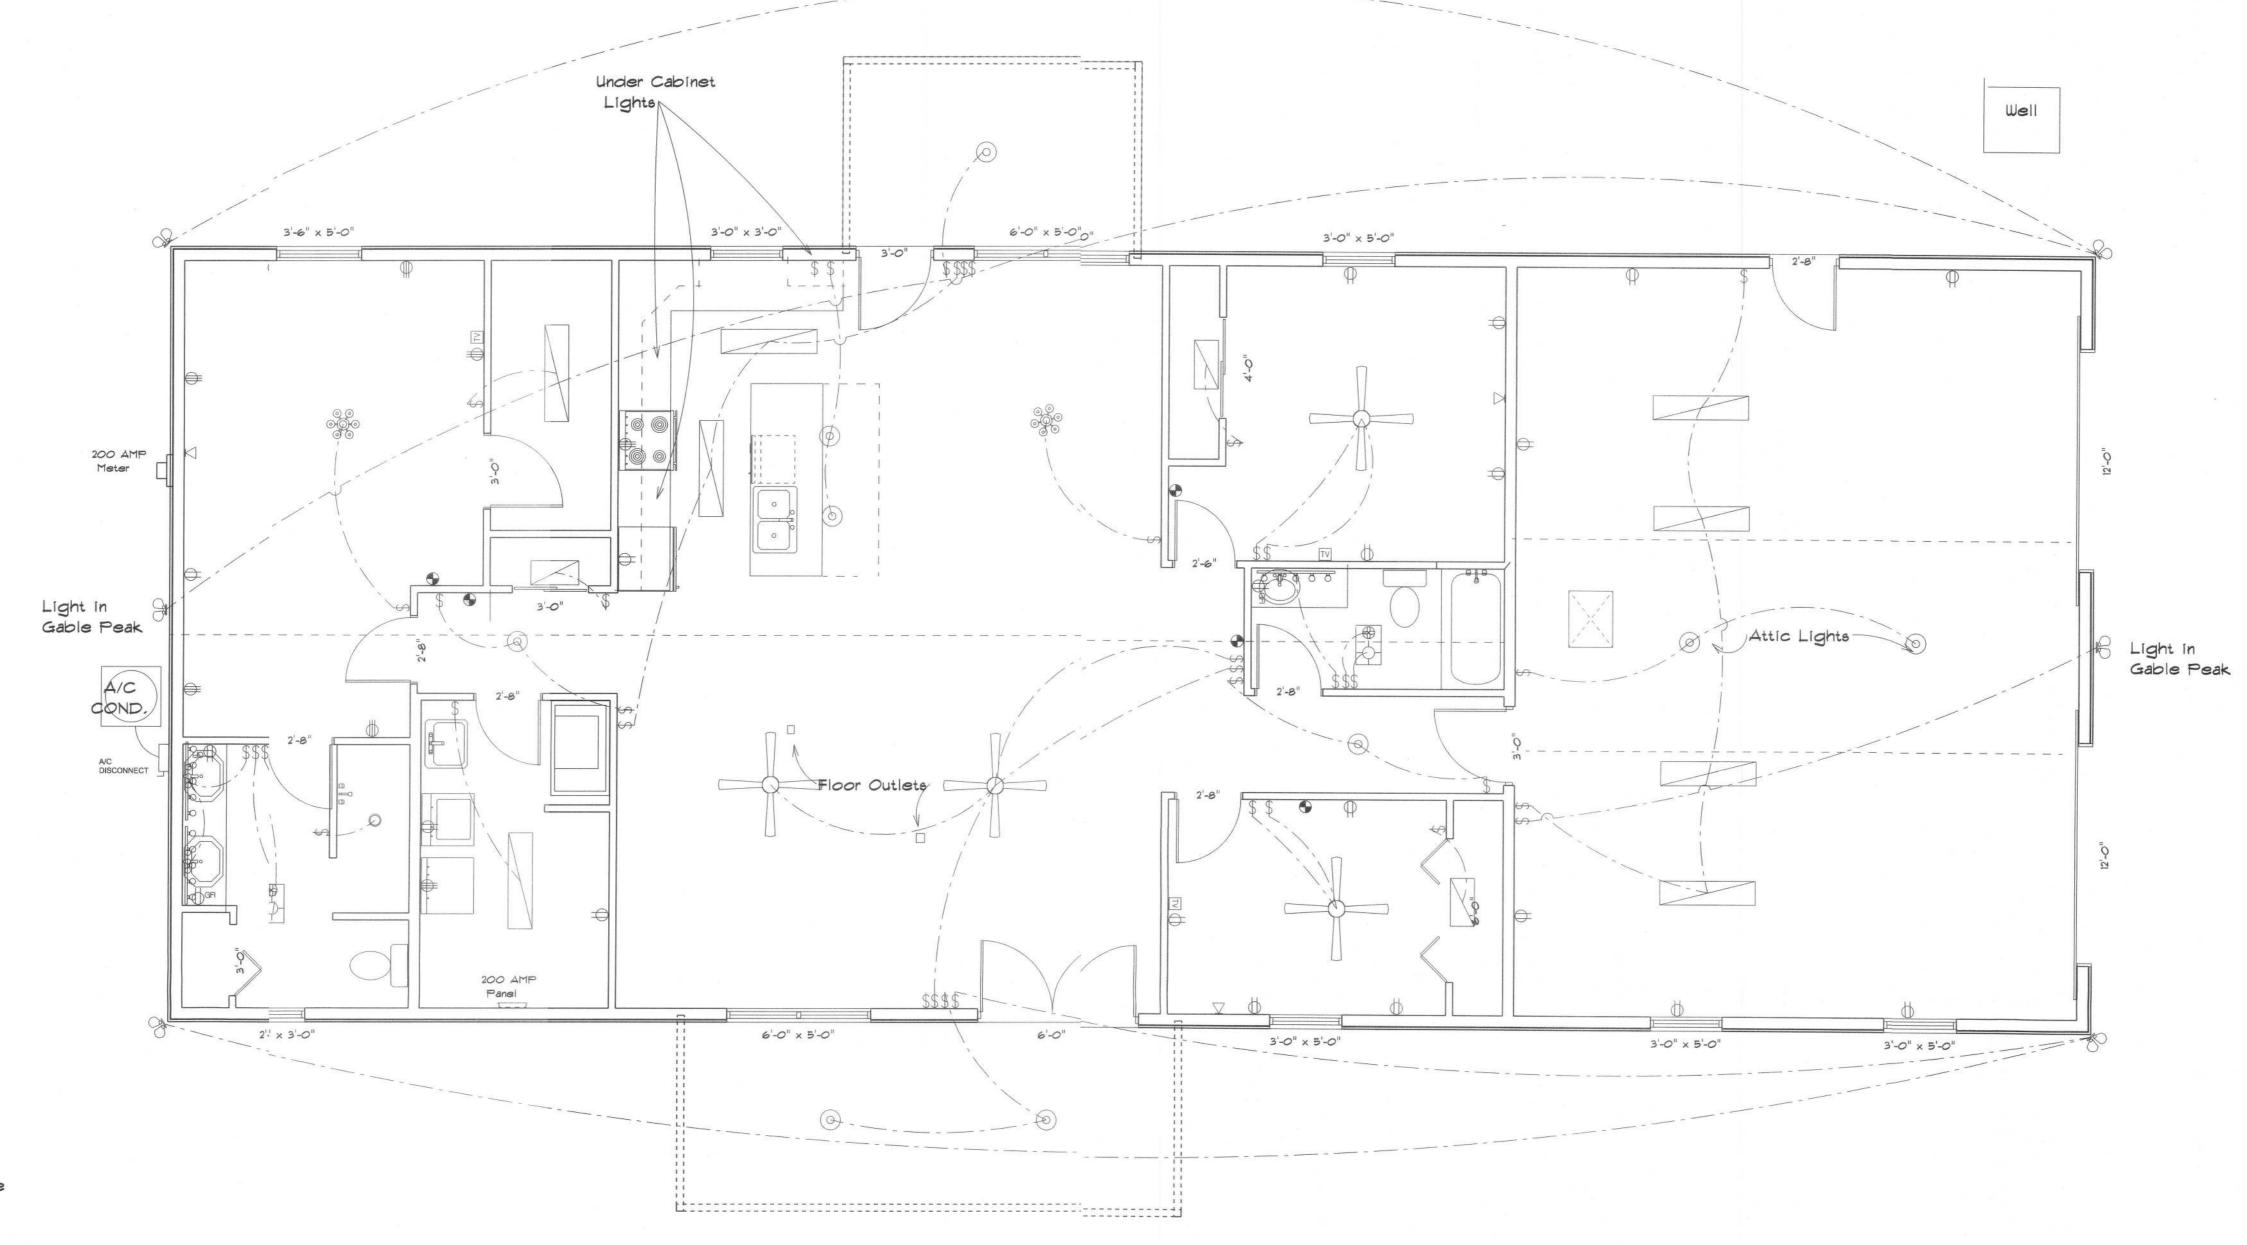

Electrical Folan

## SOFTPIAN PERCENT OF THE PERCENT OF T

**REVISIONS** 

	ARCHITECTURAL DESIGN OFTWARE
ELECTRICAL	SYMBOL
ceiling fan globe 1	
ceiling globe light	(i)
chandelier	9 <del>2</del> 9 939
double spotlight	₫₽
fluorescent fixture	
pot light	0
vanity bar light	<u> </u>
wall sconce	<b>©</b>
electrical panel	TJ
AC Disconnect	DISCONNECT
cable ty outlet	TV
fan	⊕
light	-\$-
outlet	Ф
outlet 220v	<b>(b)</b>
outlet gfi	⊕an
smoke detector	•
switch	\$
telephone	$\nabla$

RESIDENCE

Scott Paul

ADDRESS Columbia County,Florida

Woodman Park Bulders, Ind Lake City, Flerida Phone: (386) 755 - 2411 Fax: (386) 755-8684 Email:

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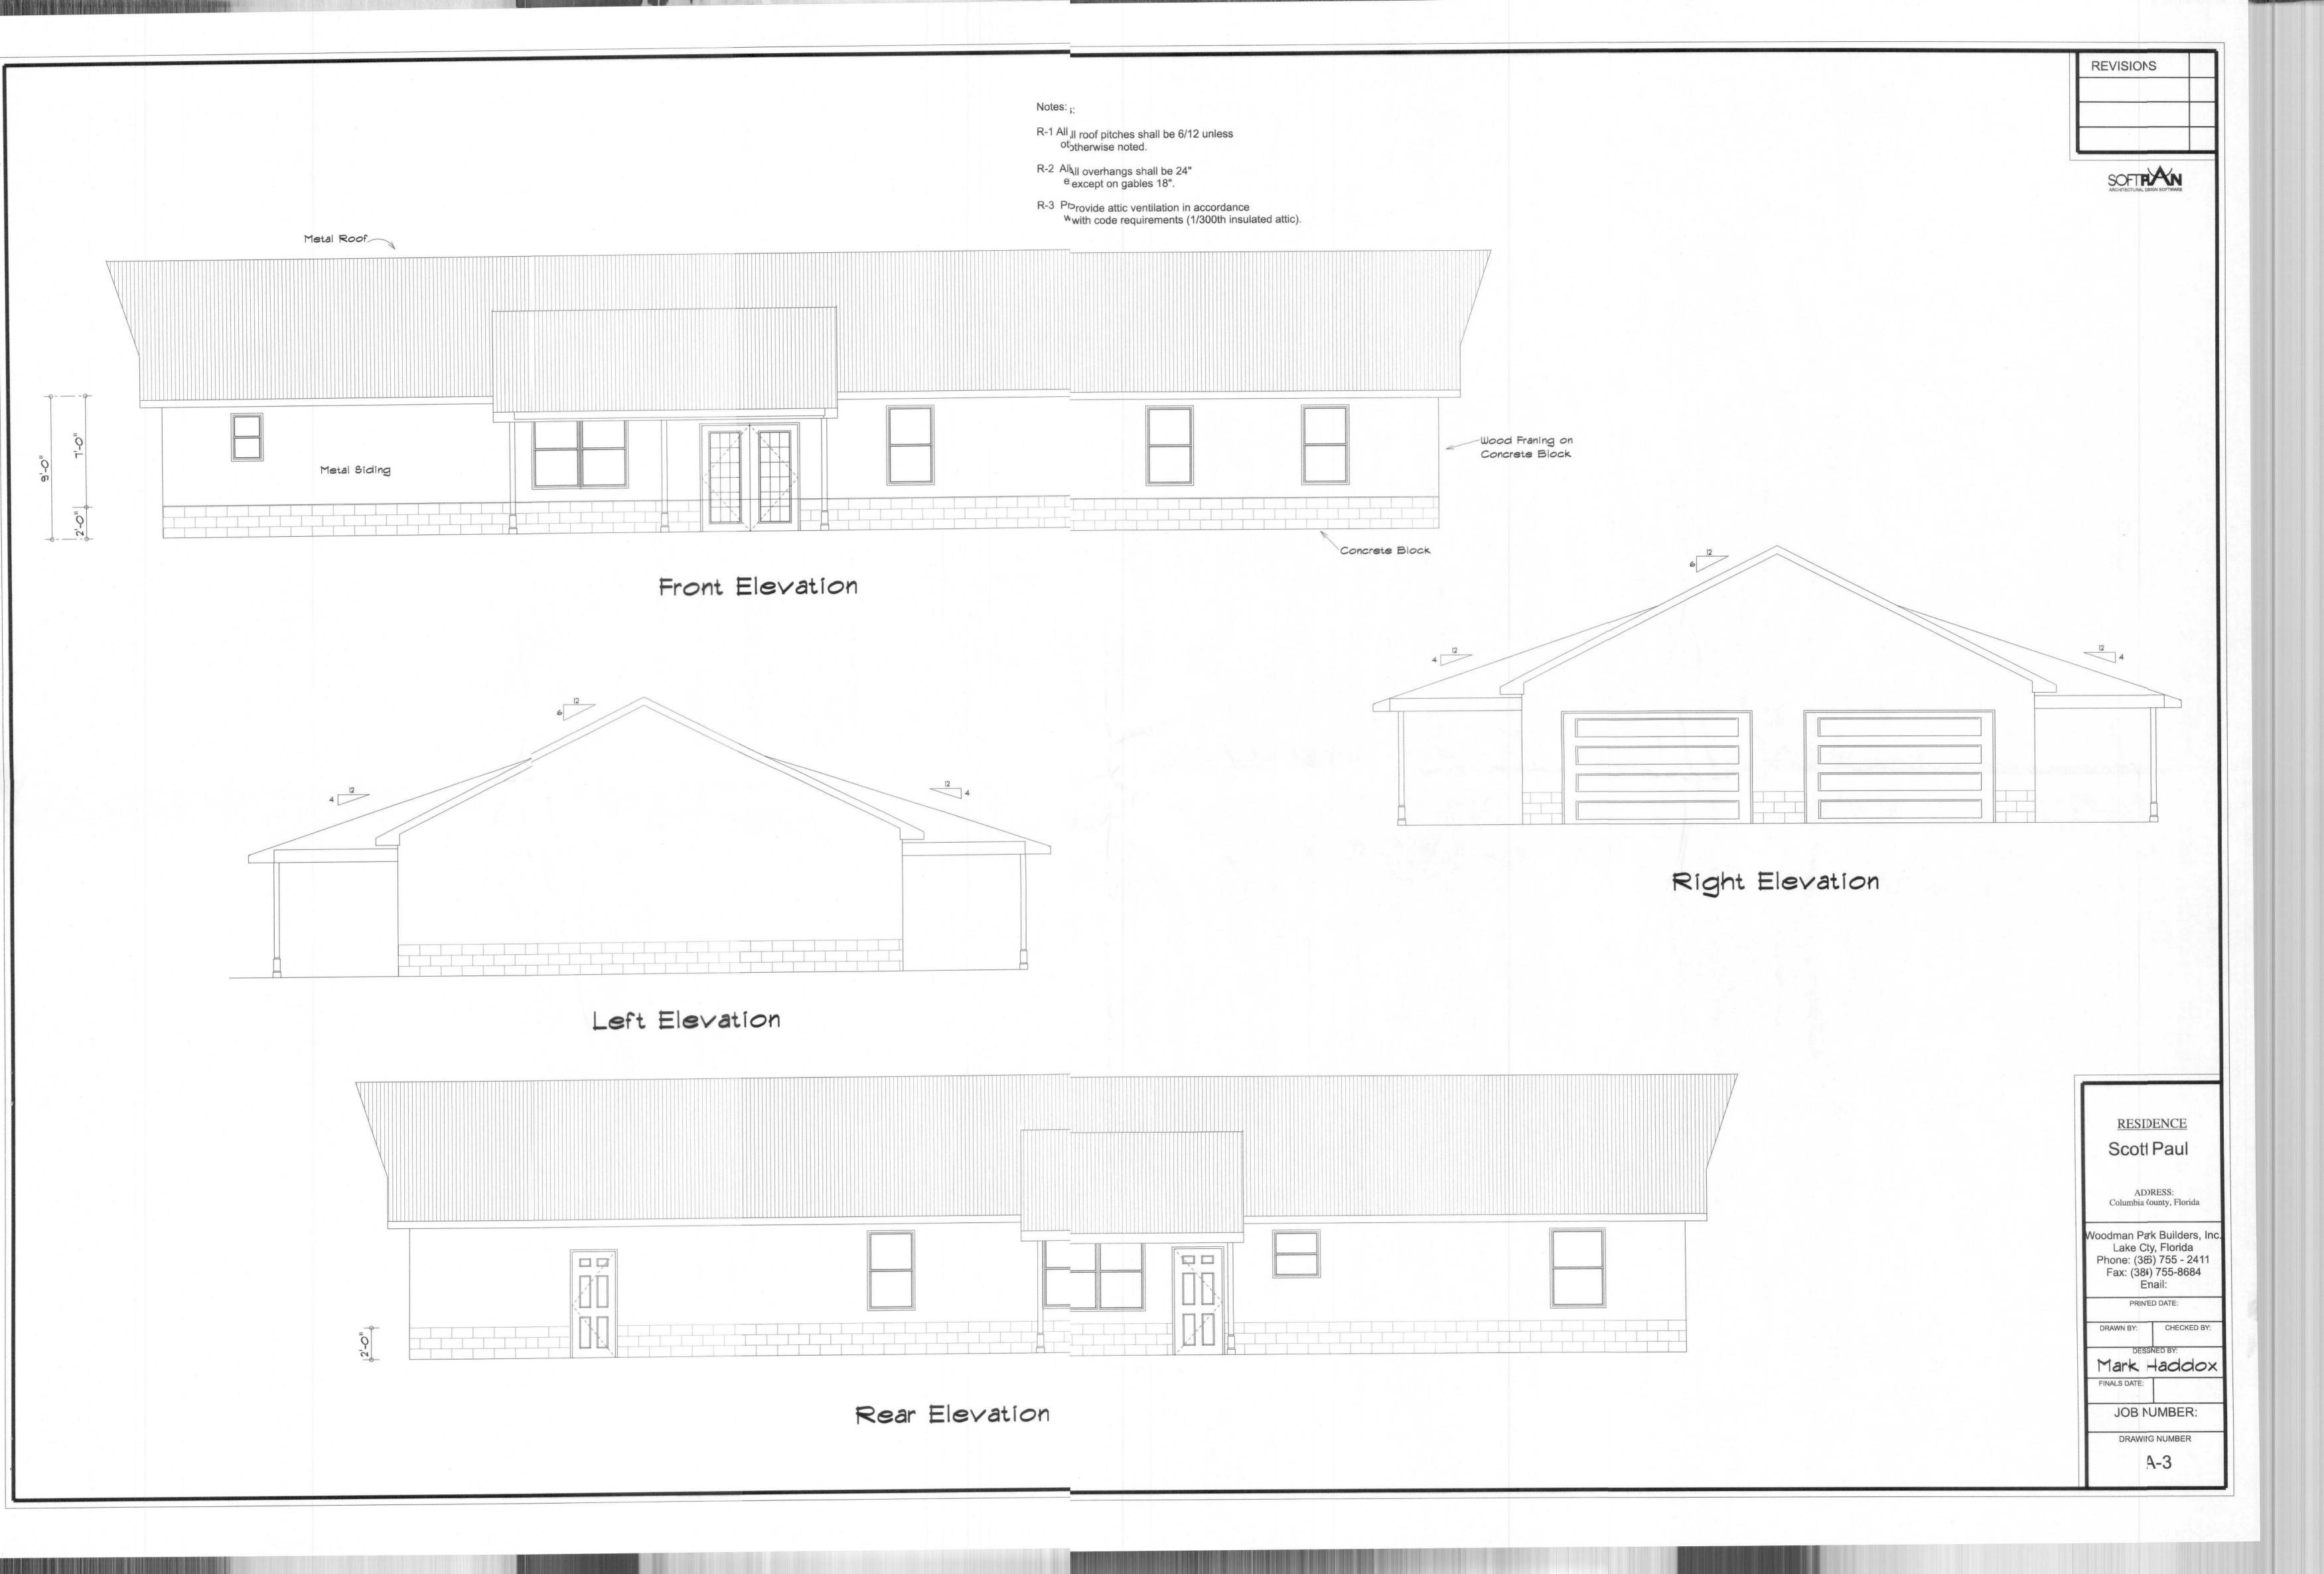
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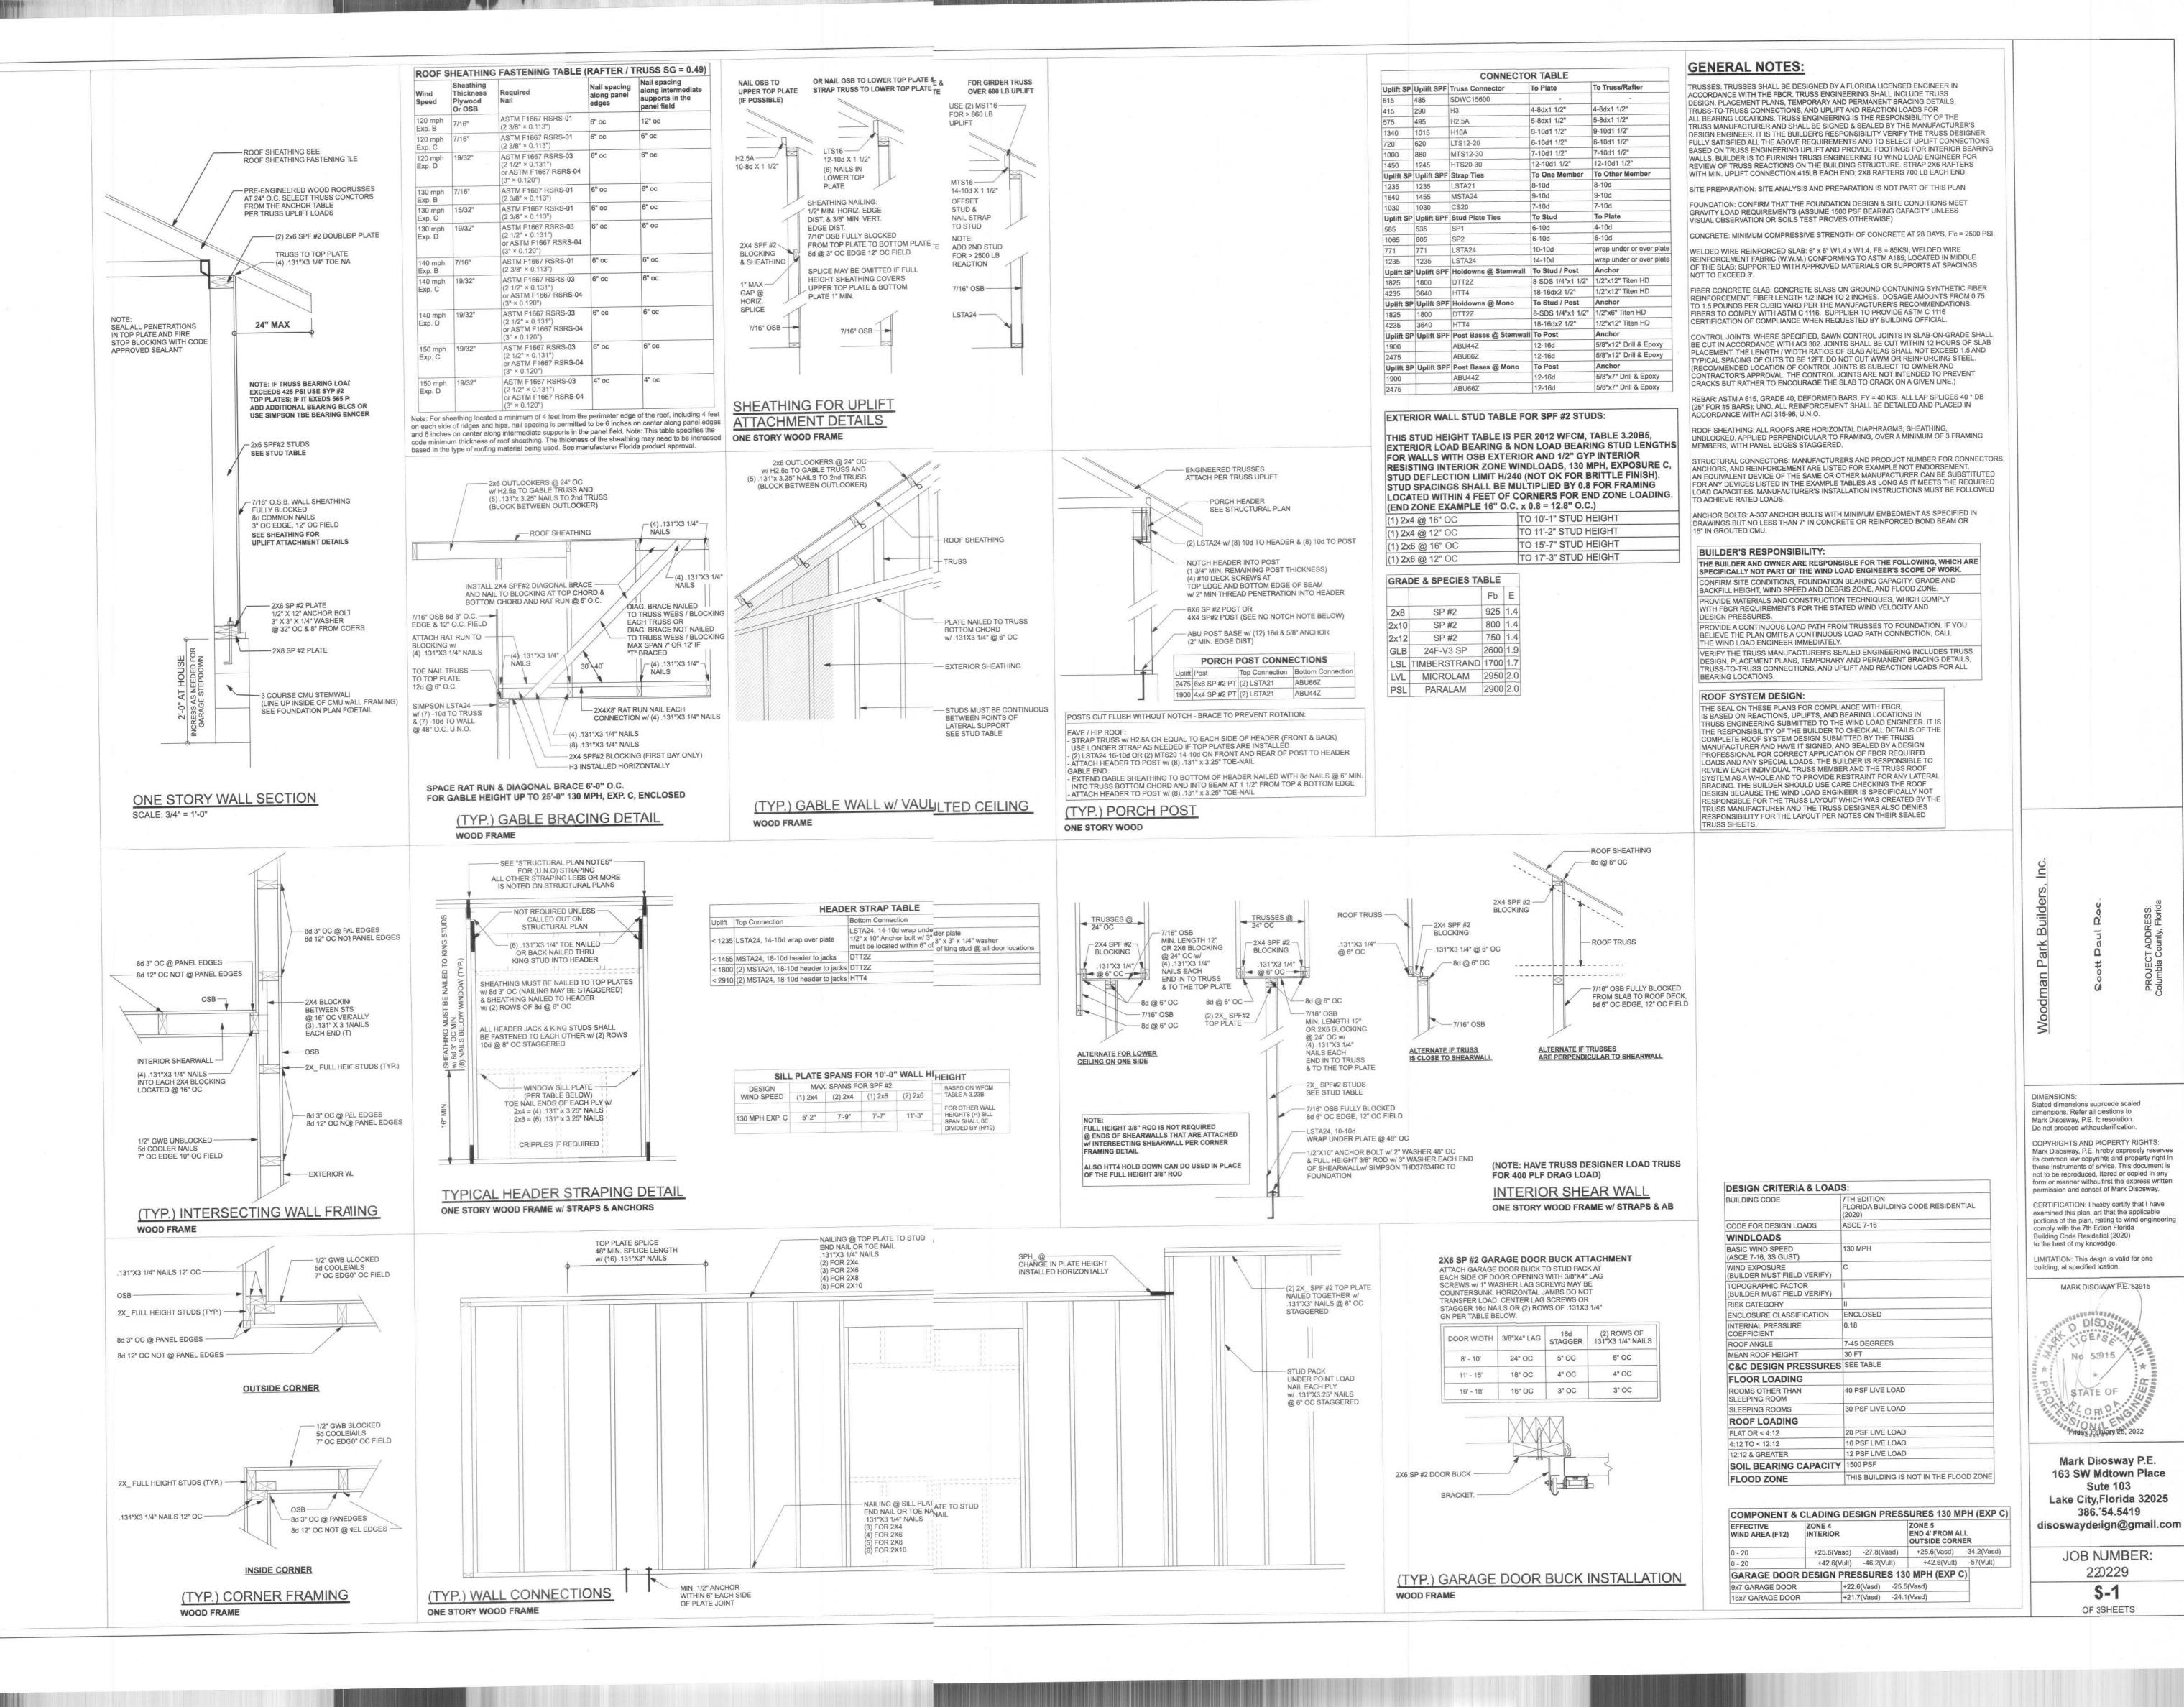
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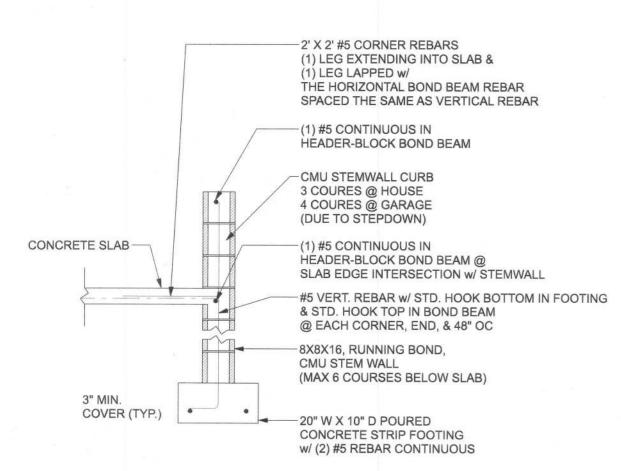
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386.'54.5419

220229

**S-1** 

OF 3SHEETS



F1 STEM WALL FOOTING w/ CMU CURB
S-2 SCALE: 1/2" = 1'-0"

CONCRETE SLAB


12" W X 16" D FOR PORCH
MONO FOOTING
W/ (2) #5 CONTINUOUS

F2 MONOLITHIC PORCH FOOTING S-2 SCALE: 1/2" = 1'-0"

CONCRETE SLAB

TO THICKENED SLAB FOOTING
W/ (2) #5 CONTINUOUS

F3 INTERIOR BEARING STEP FOOTING
S-2 SCALE: 1/2" = 1'-0"

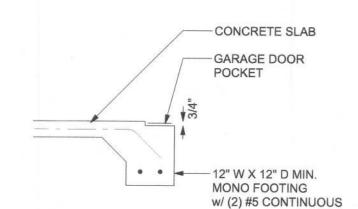


F5 GARAGE DOOR POCKET FOOTING
S-2 SCALE: 1/2" = 1'-0"

MASONRY NOTE:
MASONRY CONSTRUCTION AND MATERIALS FOR THIS PROJECT
SHALL CONFORM TO ALL REQUIREMENTS OF "SPECIFICATION
FOR MASONRY STRUCTURES" (ACI 530.1/ASCE 6/TMS 602).
THE CONTRACTOR AND MASON MUST IMMEDIATELY, BEFORE
PROCEEDING, NOTIFY THE ENGINEER OF ANY CONFLICTS
BETWEEN ACI 530.1-02 AND THESE DESIGN DRAWINGS.
ANY EXCEPTIONS TO ACI 530.1-02 MUST BE APPROVED BY
THE ENGINEER IN WRITING.

THE ENGINEER IN WRITING.			
	ACI530.1-02 Section	Specific Requirements	
1.4A	Compressive strength	8" block bearing walls F'm = 1500 psi	
2.1	Mortar	ASTM C 270, Type N, UNO	
2.2	Grout	ASTM C 476, admixtures require approval	
2.3	CMU standard	ASTM C 90-02, Normal weight, Hollow, medium surface finish, 8"x8"x16" running bond and 12"x12" or 16"x16" column block	
2.3	Clay brick standard	ASTM C 216-02, Grade SW, Type FBS, 5.5"x2.75"x11.5"	
2.4	Reinforcing bars, #3 - #11	ASTM 615, Grade 40, Fy = 40 ksi, Lap splices min 40 bar dia. (25" for #5)	
2.4F	Coating for corrosion protection	Anchors, sheet metal ties completely embedded in mortar or grout, ASTM A525, Class G60, 0.60 oz/ft2 or 304SS	
2.4F	Coating for corrosion protection	Joint reinforcement in walls exposed to moisture or wire ties, anchors, sheet metal ties not completely embedded in mortar or grout, ASTM A153, Class B2, 1.50 oz/ft2 or 304SS	
3.3.E.2	Pipes, conduits, and accessories	Any not shown on the project drawings require engineering approval.	
3.3.E.7	Movement joints	Contractor assumes responsibility for type and location of movement joints if not detailed on project drawings.	

BOTTOM OF EXTERIOR FOOTINGS SHALL BE A MINIMUM OF 12" BELOW UNDISTURBED SOIL OR ENGINEERED FILL

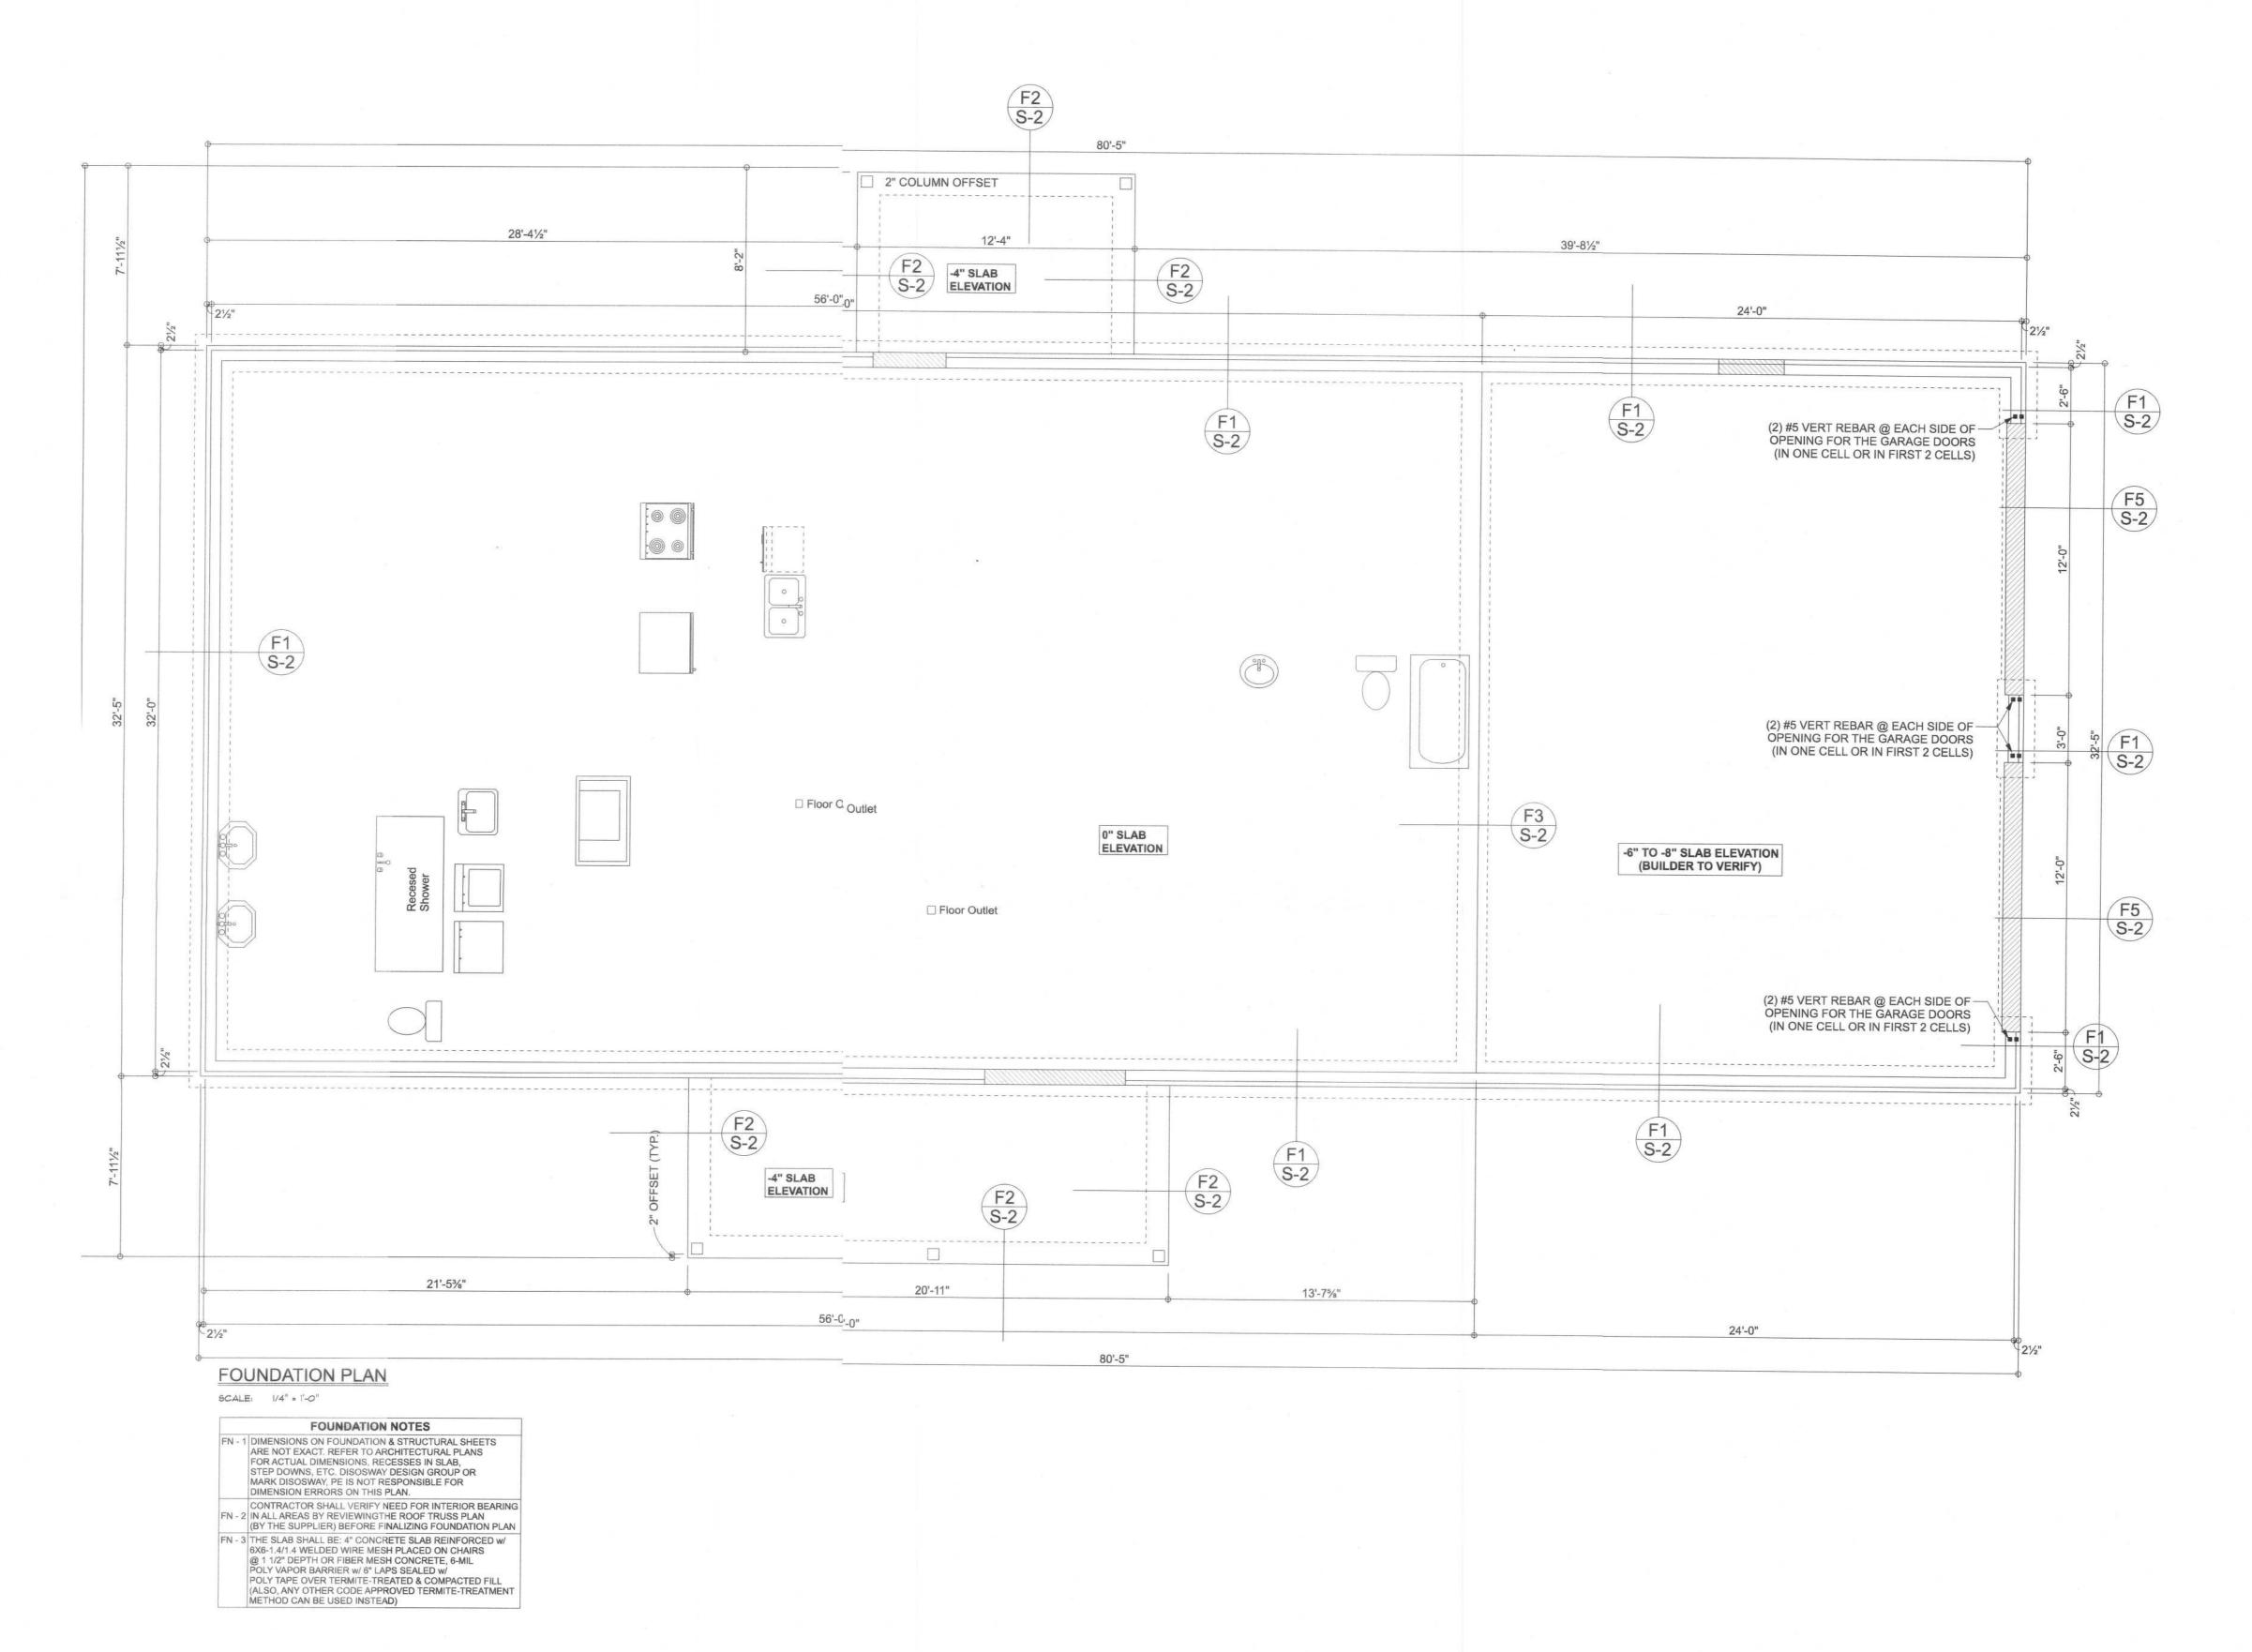

DIMENSIONS:
Stated dimensions spercede scaled dimensions. Refer a questions to Mark Disosway, P.E. for resolution.
Do not proceed withut clarification.

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CERTIFICATION: I breby certify that I have

permission and conent of Mark Disosway.

CERTIFICATION: I breby certify that I have examined this plan, and that the applicable portions of the plan, elating to wind engineering comply with the 7th Idition Florida Building Code Residntial (2020) to the best of my knovledge.


LIMITATION: This deign is valid for one building, at specifiedocation.

DISOS PER STATE OF Friday, Feruary 25, 2022

Mark Disosway P.E. 163 SW Mdtown Place Sute 103 Lake City,Florida 32025 386.754.5419 disoswaydesign@gmail.com

JOB NJMBER: 22)229

**\$-2**OF 33HEETS

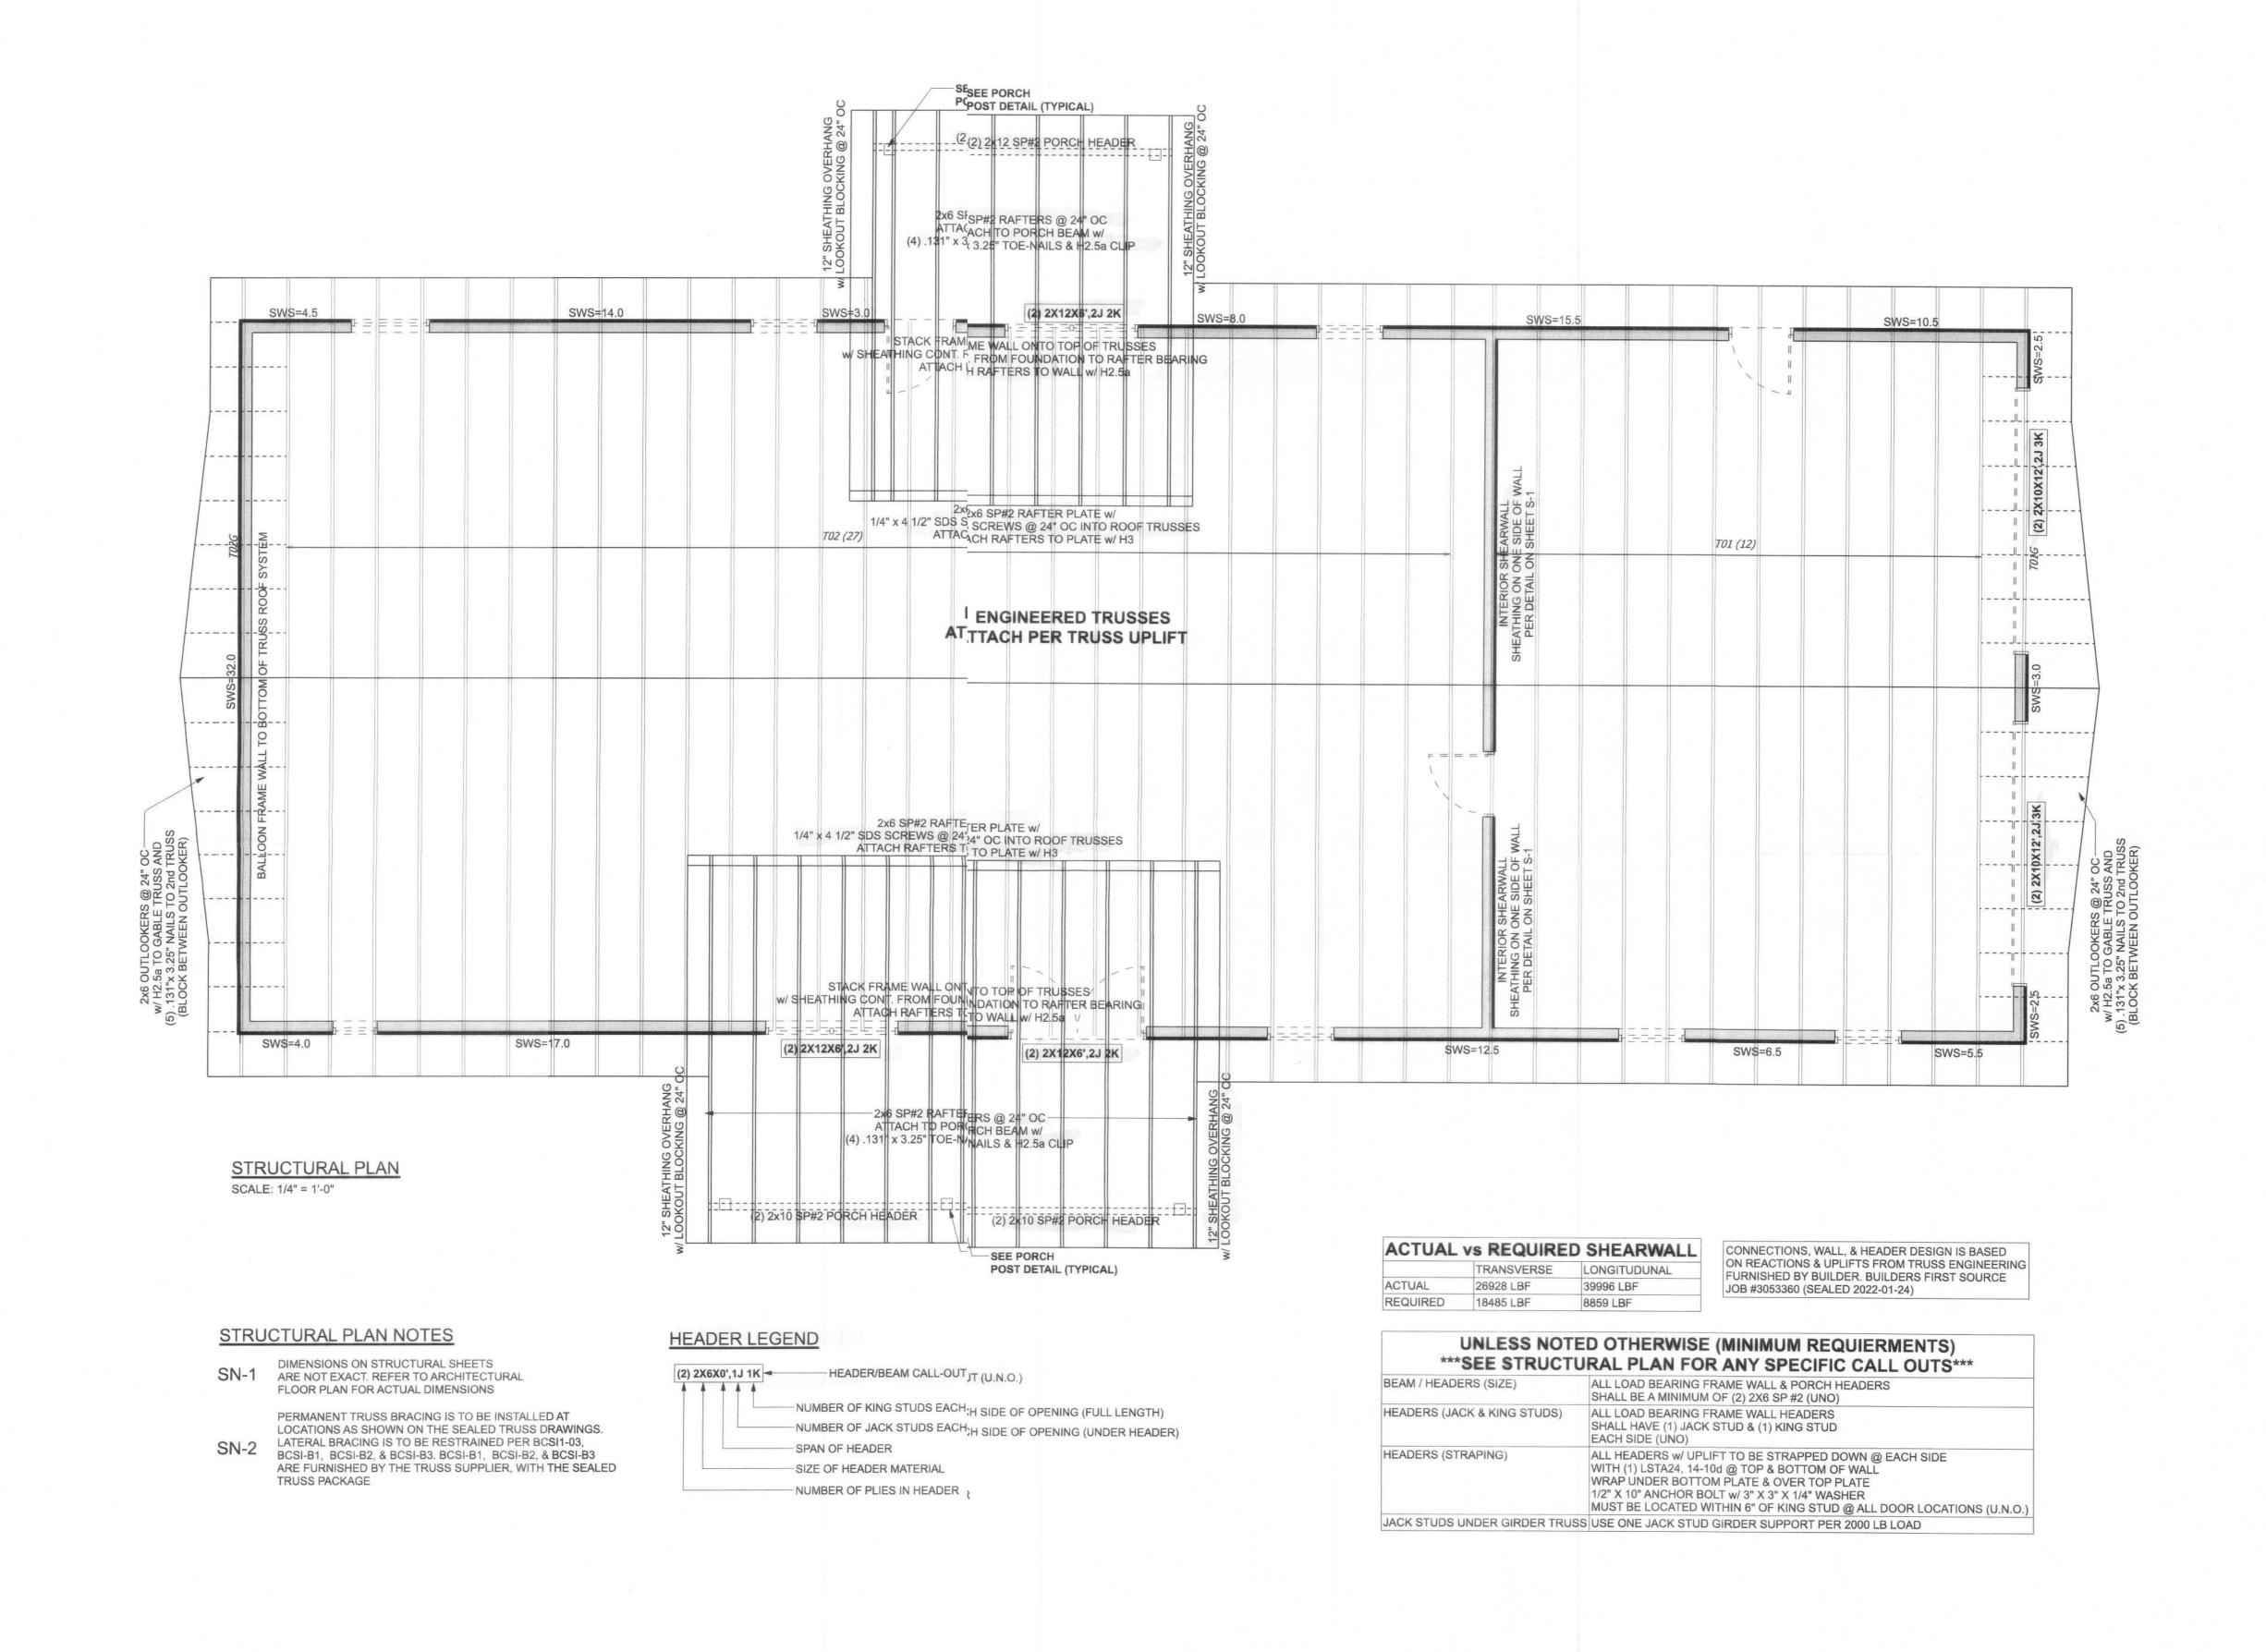


man Park Builders, Inc.

DIMENSIONS: Stated dimension supercede scaled dimensions. Refe all questions to Mark Disosway, E. for resolution. Do not proceed whout clarification.

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CERTIFICATION! hereby certify that I have examined this pla, and that the applicable portions of the pla, relating to wind engineering comply with the 71 Edition Florida Building Code Reidential (2020) to the best of my howledge.

LIMITATION: Thisdesign is valid for one building, at specifid location.

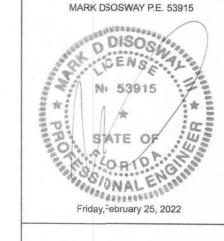

Mark Disosway P.E. 163 SWMidtown Place Suite 103 Lake City, Florida 32025 386.754.5419 disoswaydsign@gmail.com

JOBNUMBER: 220229 **S-3** 

**OF3 SHEETS**