

REVISIONS

SCFTPIAN ARCHITCTURAL DESIGN SOFTWARE

RESIDENCE

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5t. White, FL

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PRINTED DATE:

DRAWN BY: CHECKED BY:

DESIGNED BY:

FINAL: DATE:


JOB NUMBER:

A-1

SOFTPIAN ARCHITECTUR. DESIGN SOFTWARE

Electrical Plan Notes:

- E-1 Wire all appliances, HVAC units and other equiptent per manufactures specifications.
- E-2 Consult the owner for the number or seperate telephone lines to be installed. Owner is responsible for all overages not noted on plan.
- E-3 All installations shall be per national code 2008
- E-4 All smoke detectors shall be 120v with battery back-up of the photoelectric type, and shall be interlocked together. Install inside and near all bedrooms.
- E-5 Telephone, television and other low voltage devices or outlets shall be as per the owners directions and in accordance with applicable sections of the National Electric Codes latest edition. Owner is responsible for all overages not noted on plan.
- E-6 Electrical contractor shall be responssible for the design and sizing of electrical service and circuits.
- E-7 Entry of service (underground or overhead) to to be determined by contractor agreement.
- E-8 All outlets located in residential to be tamper-resistant per NEC.
- E-9 All outlets to be located above base flood elevation.
- E-10 All exterior GFI outlets shall be weatherproof.
- E-11 Overcurrent Protection device shall be installed on the exterior of structures on the load side of the meter to serve as a disconnecting means. Conductors used from the exterior disconnecting means to a panel or sub panel shall have four-wire conductors, of which one conductor shall be used as an equiptment ground.
- E-12 All 120-VOLT, single phase, 15 and 20 ampere branch circuits supplying outlets installed in dweing unit family rooms, dining rooms, living rooms, parlow, libraries, dens, bedrooms, sun rooms, recreation roms, closets, hallways, or similar rooms or areas shall be protected by a listed arc-fault circuit interrupte combination-type installed to provide protection the branch circuit.
- E-13 Carbon Monoxide alarms shall be required within 0' of all rooms for sleeping purposes in buildings hving a fossil-fuel burning heater or appliance, a firepice or attached garage.

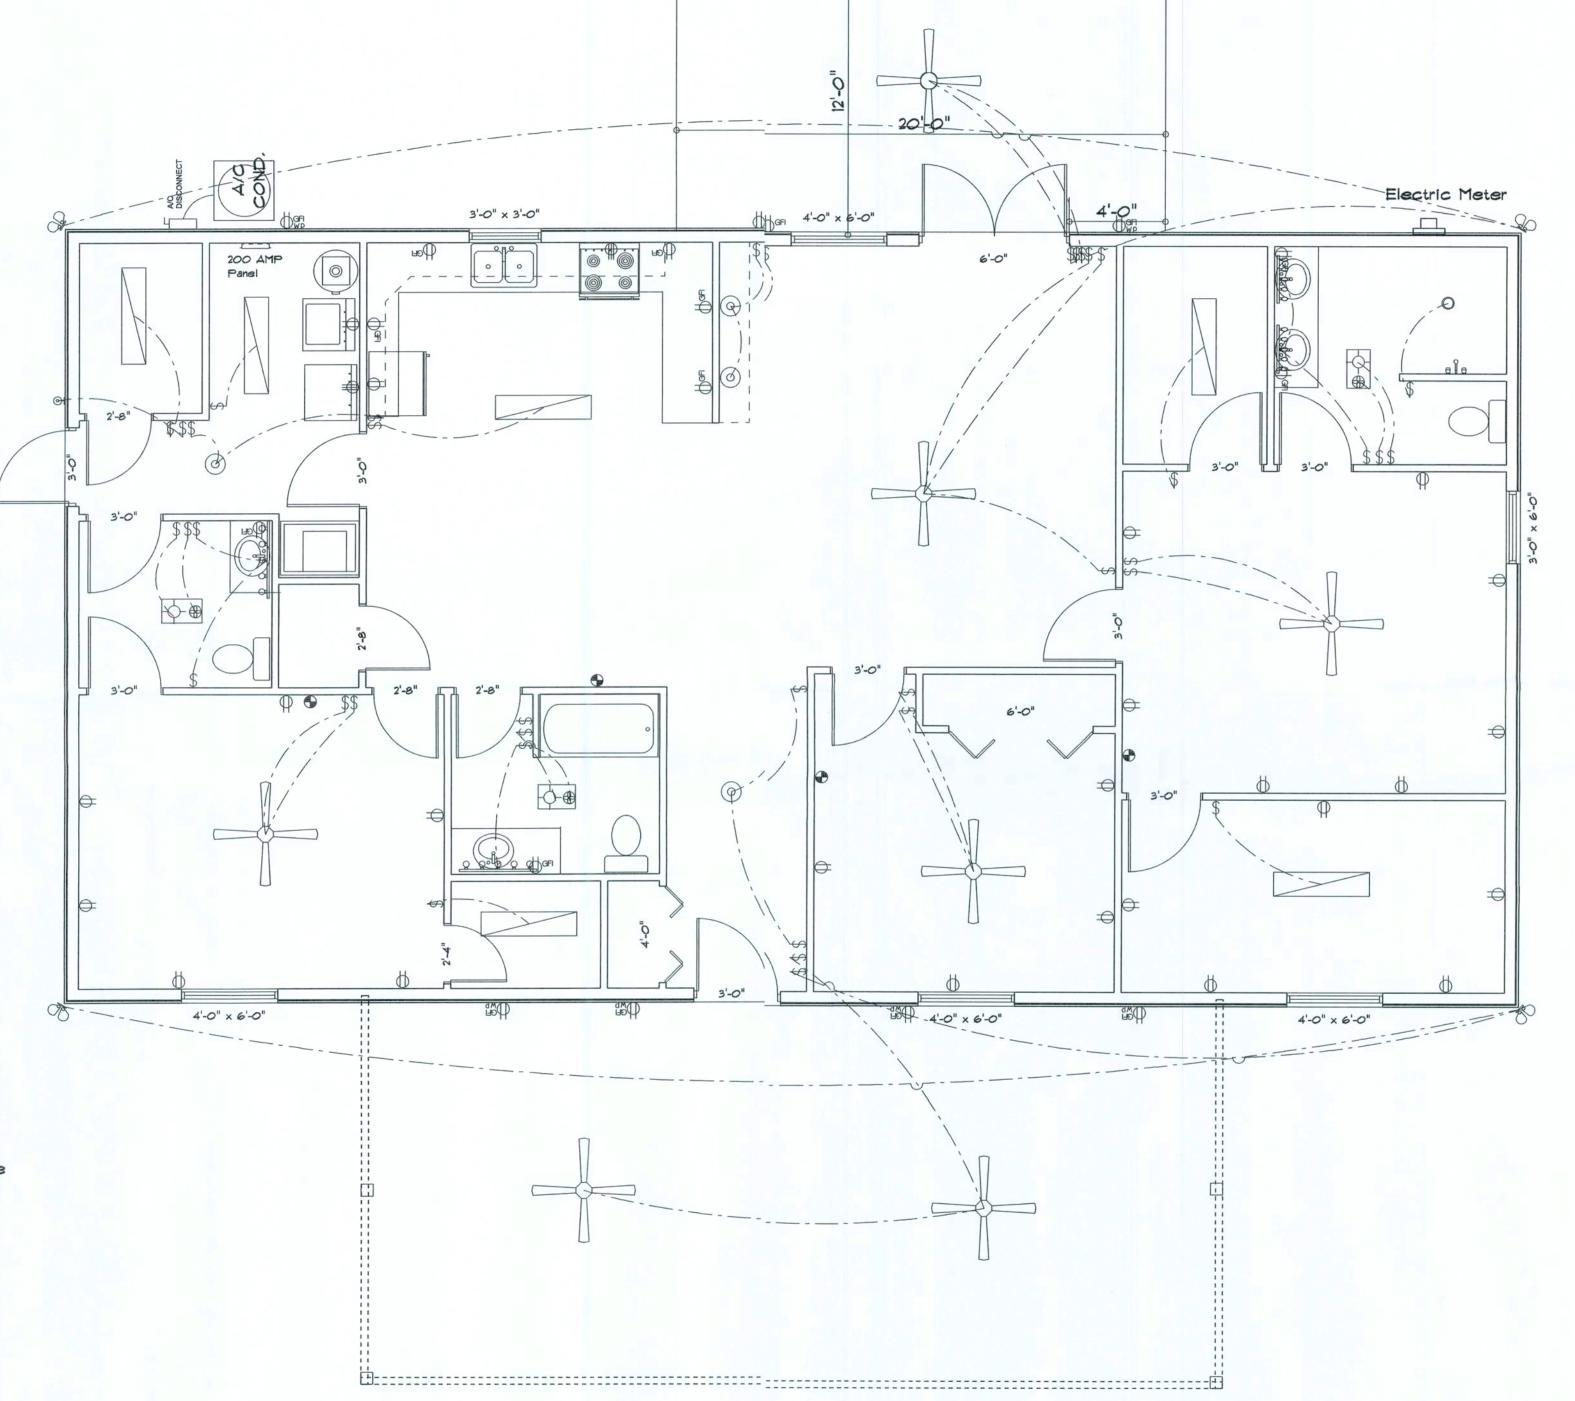

Electrical f	Plan
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ELECTRICAL	SYMBOL
ceiling fan	
ceiling globe light	<u></u>
double spotlight	QD
fluorescent fixture	
pot light	0
vanity bar light	<u> </u>
wall sconce	<u>©</u>
electrical panel	11
AC Disconnect	DISCONNECT
Outlet WP GFI	ØgFI ₩P
fan	₩
light	-\$-
outlet	Ф
outlet 220v	\(\bar{\pi} \)
outlet gfi	фан
smoke detector	•
switch	\$

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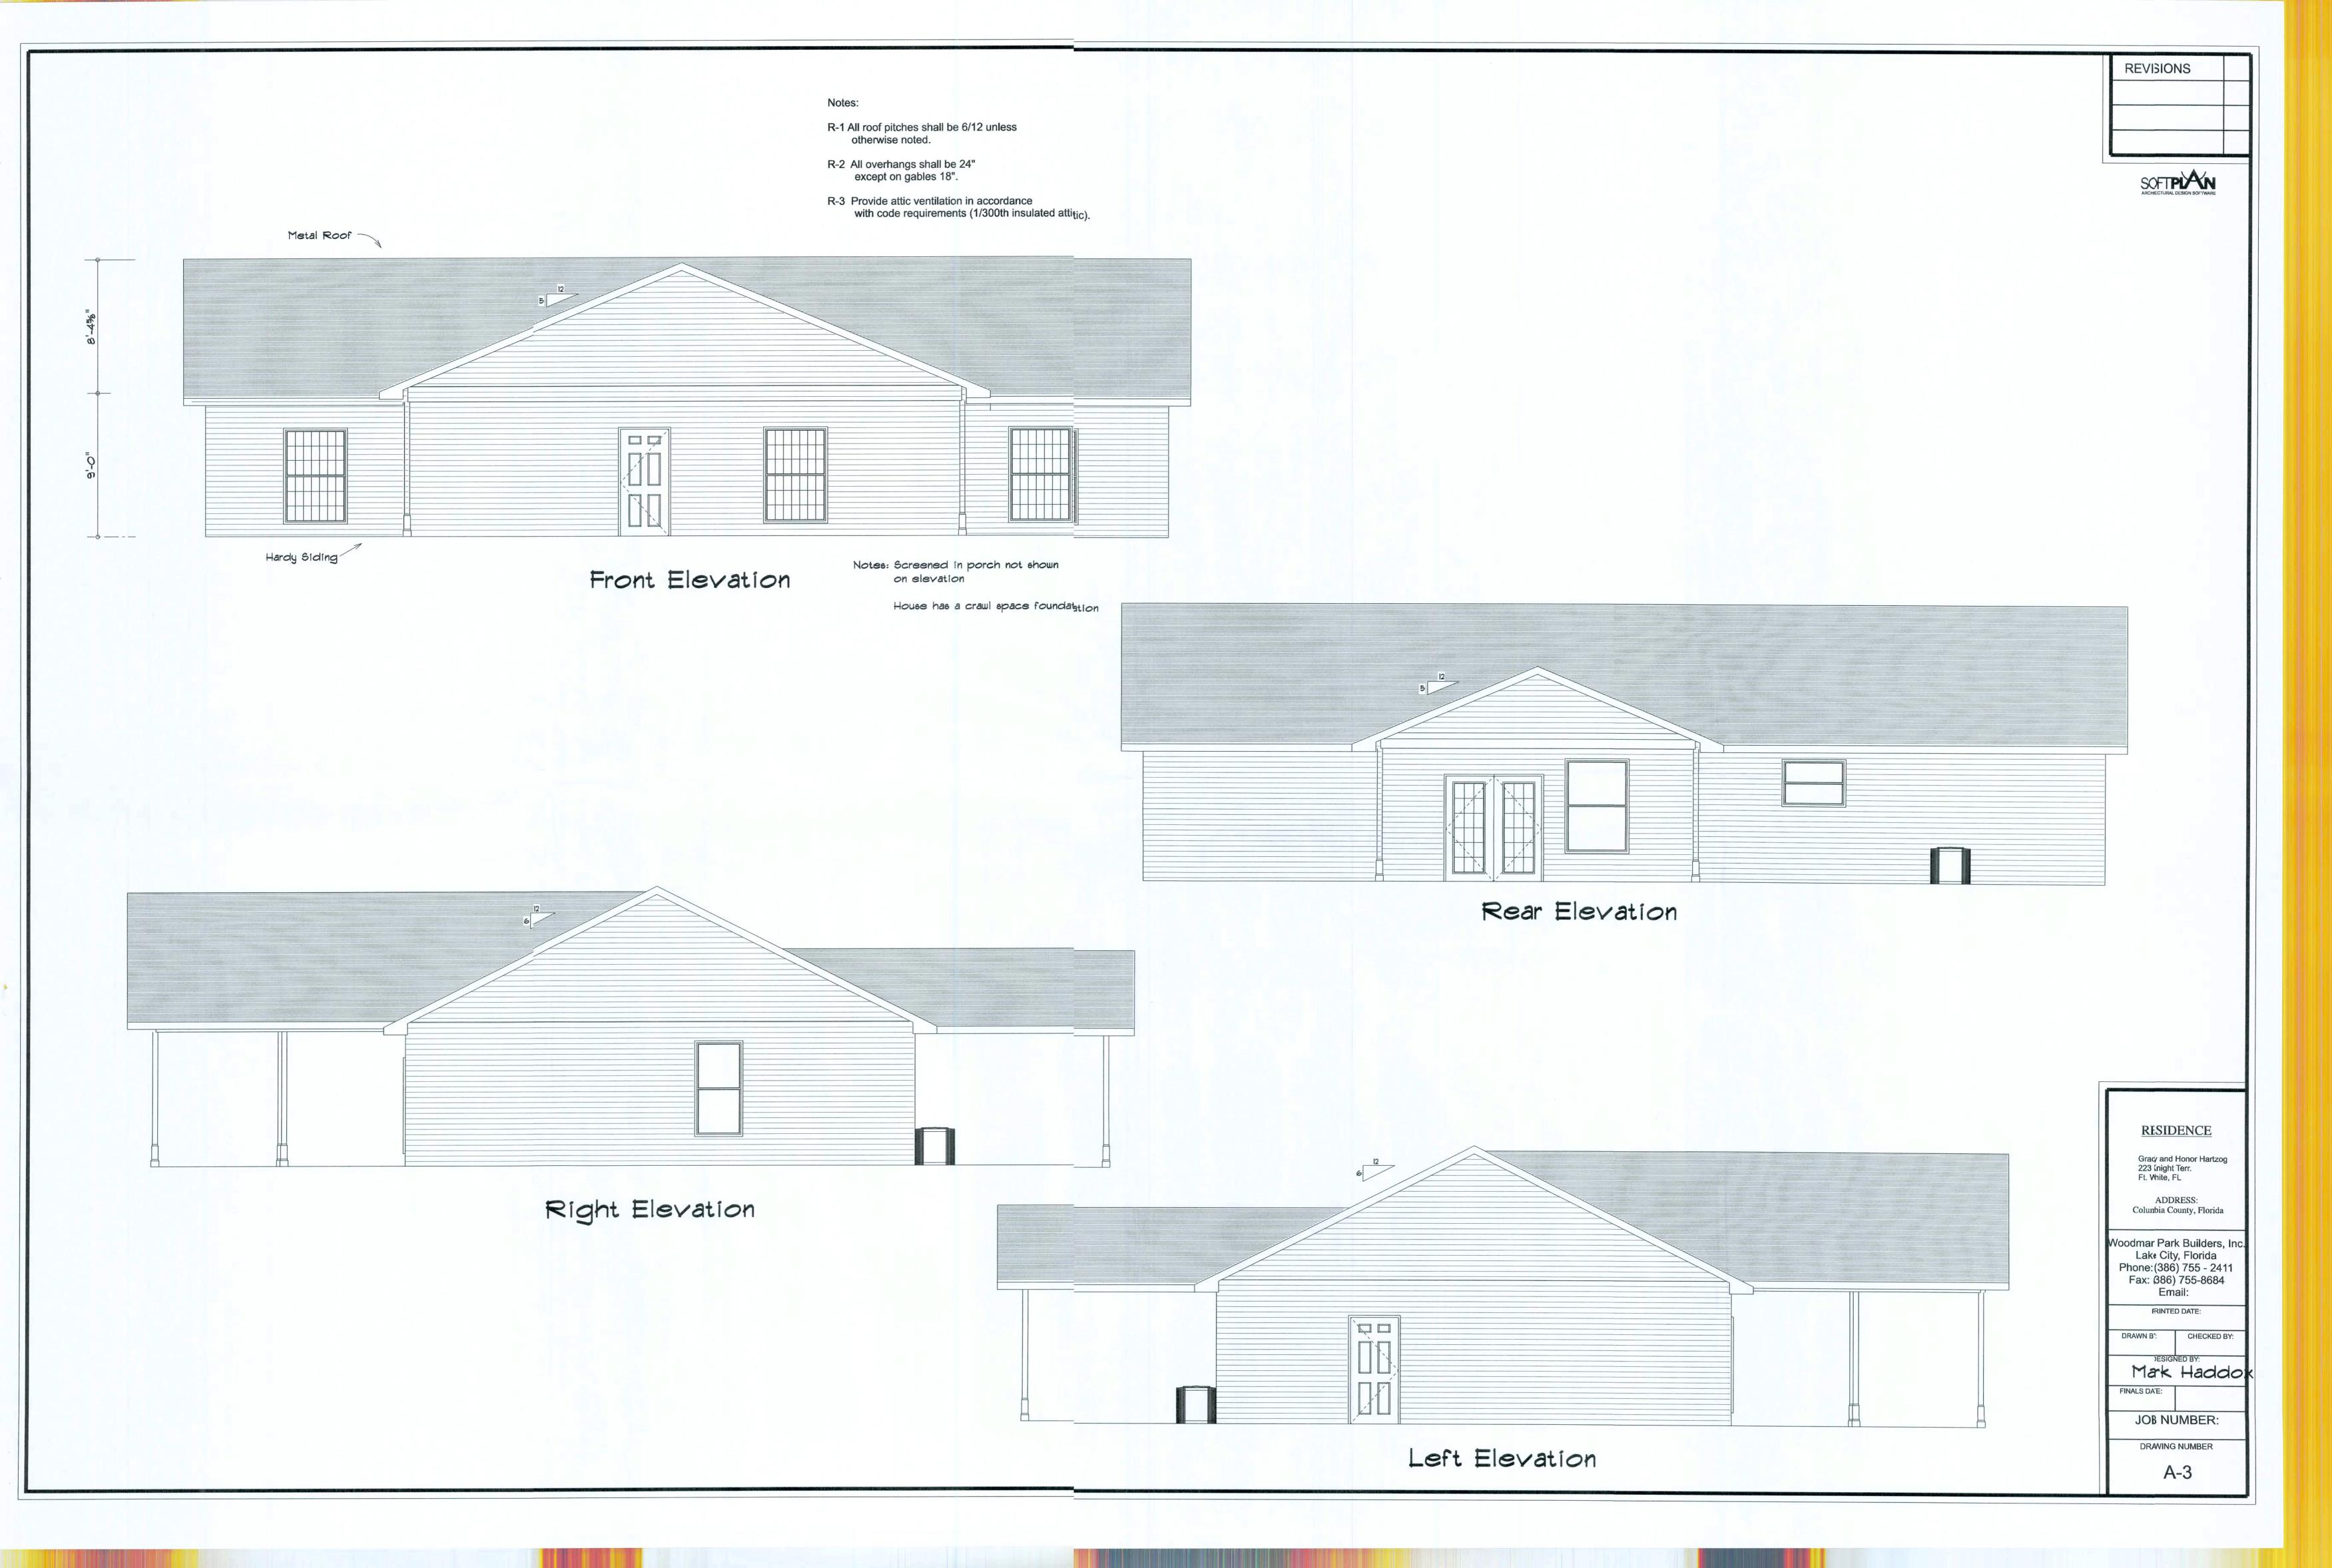
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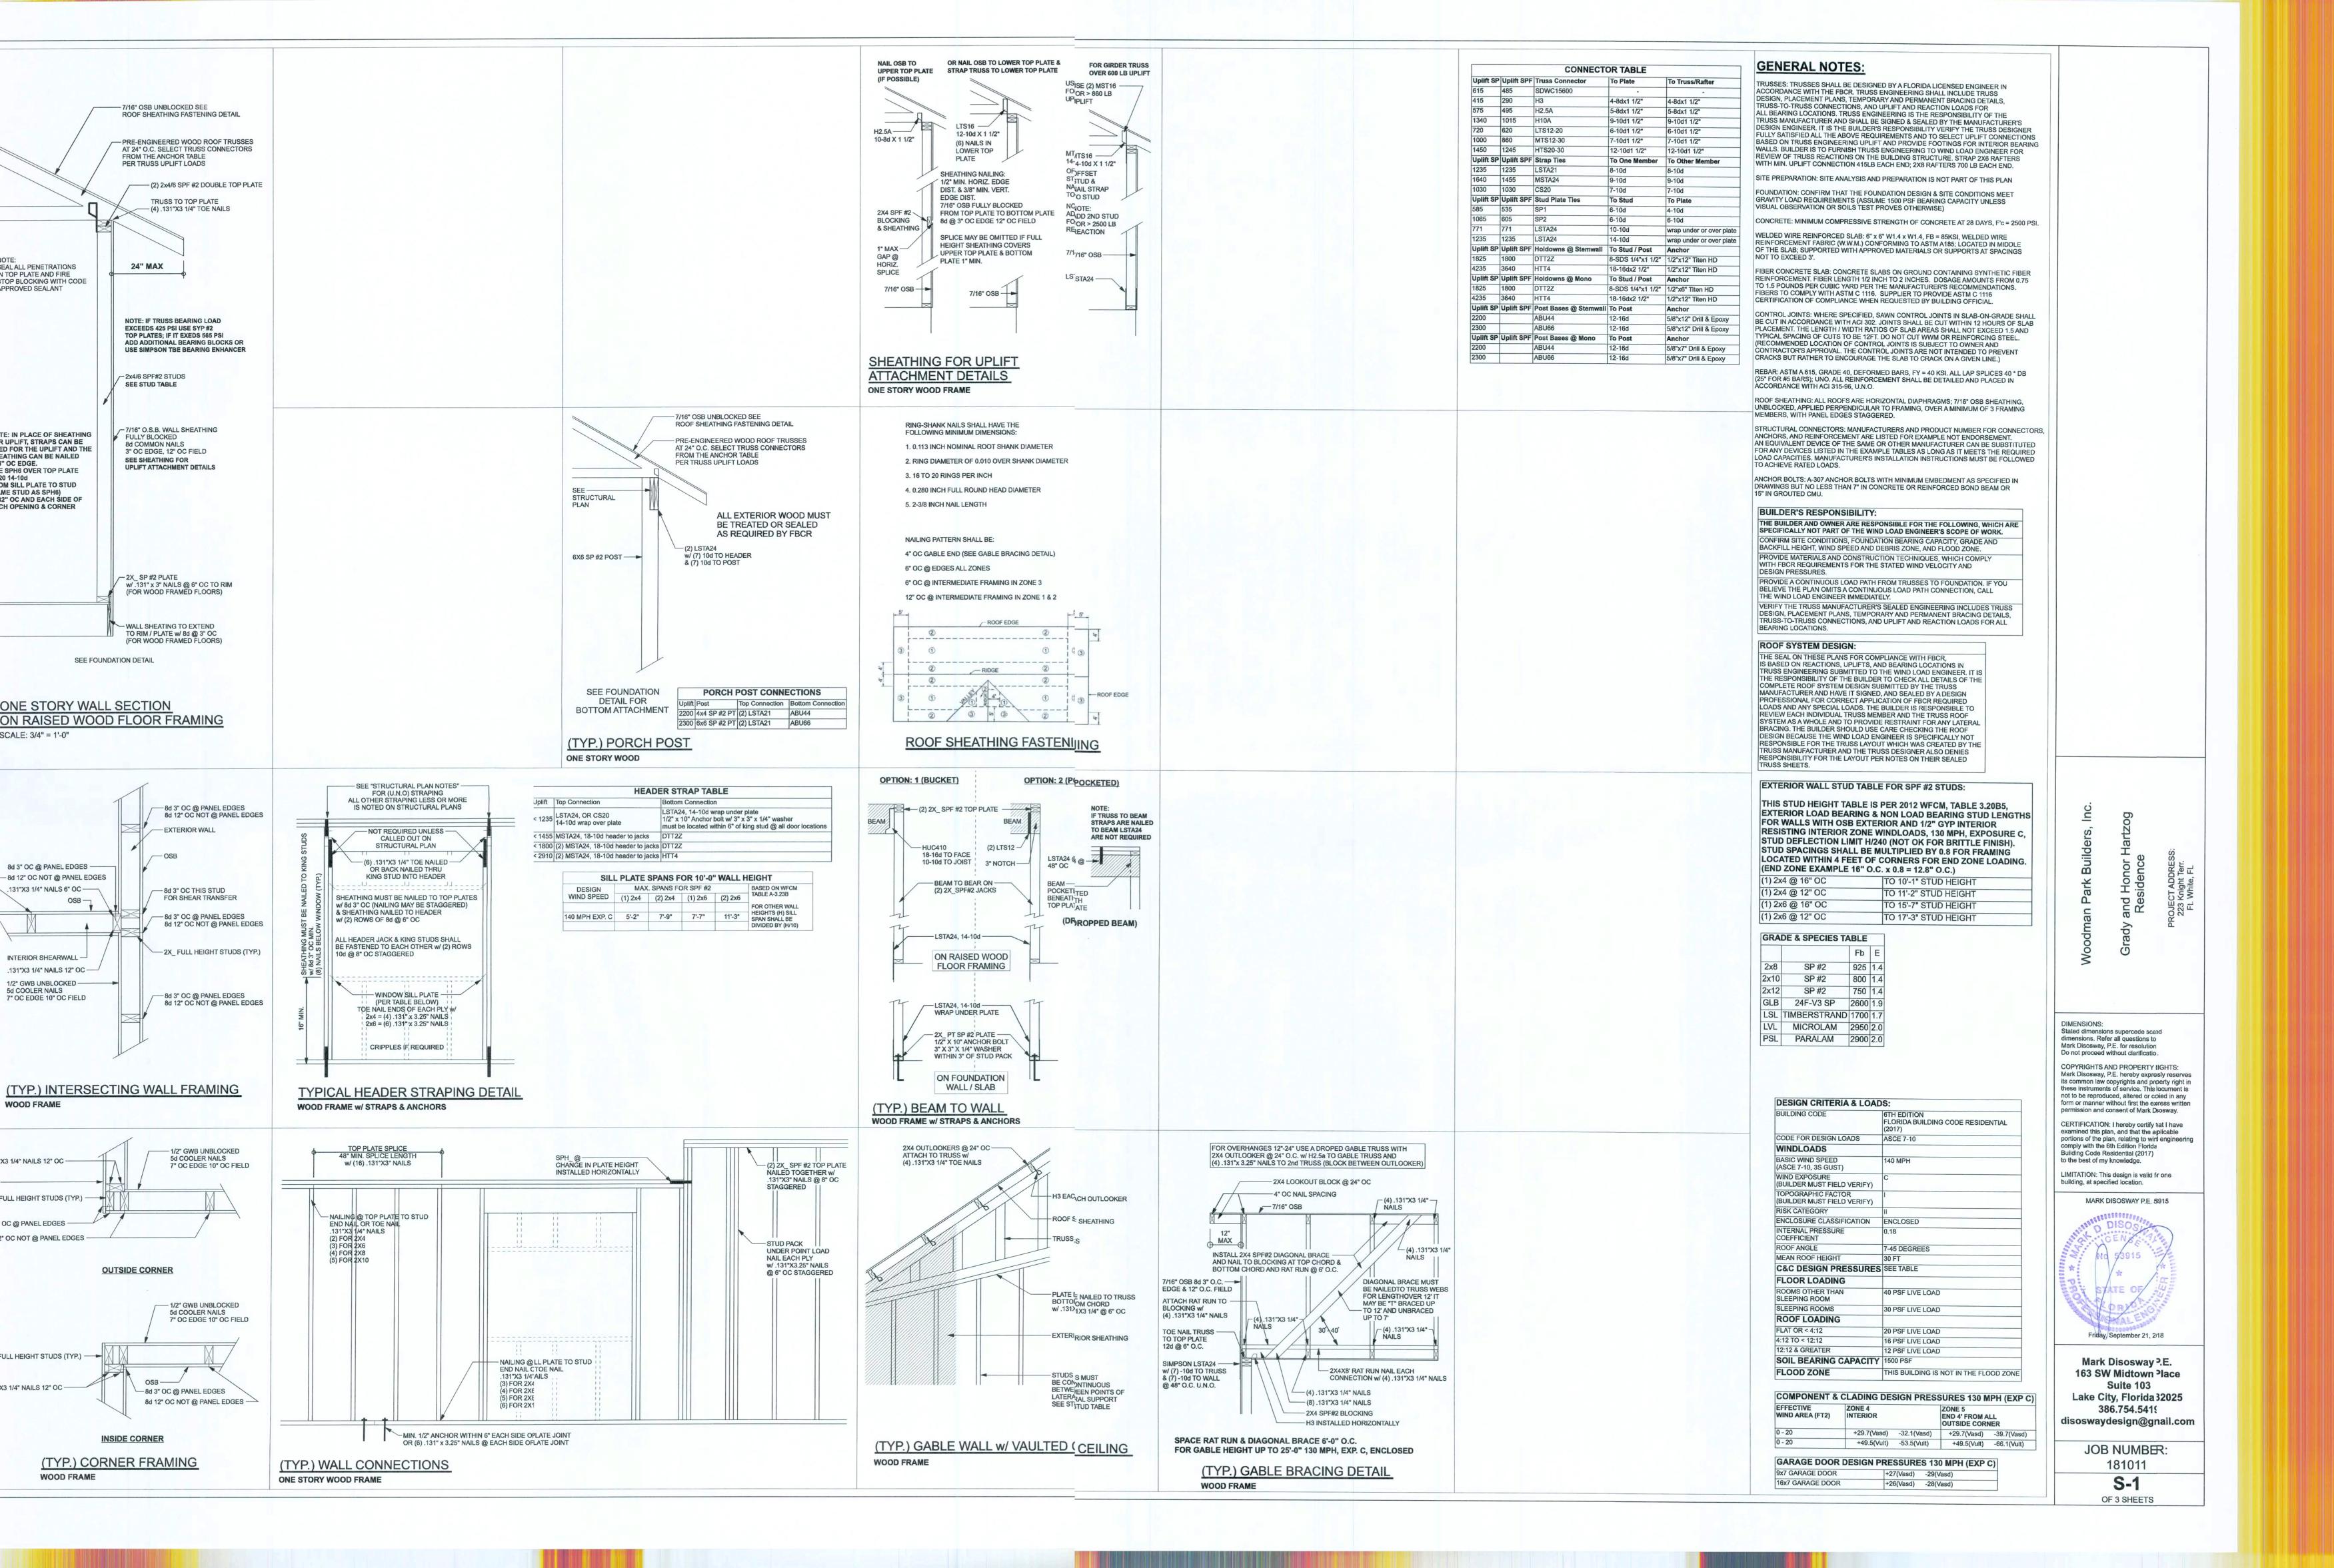
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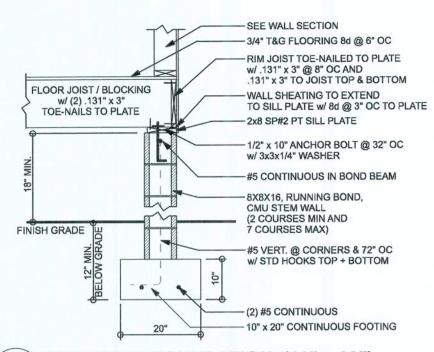
Mark Haddox

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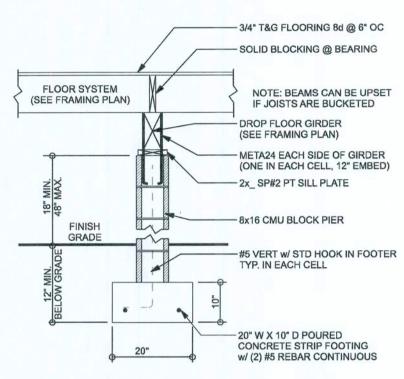
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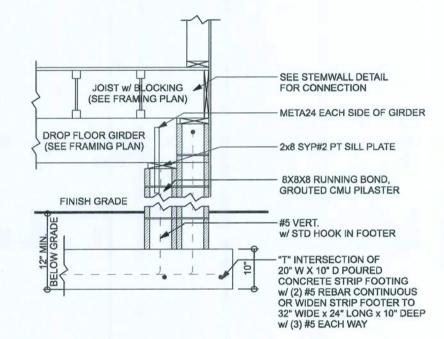





F1 STEMWALL FOUNDATION (10" x 20") S-2 WOOD FLOOR OVER CRAWLSPACE SCALE: 1/2" = 1'-0"




F2 PIER FOUNDATION (DROPPED BEAM) S-2 CMU PIER (DROPED GIRDER) SCALE: 1/2" = 1'-0"



8x8 PILASTER @ DROPPED BEAM WOOD FLOOR OVER CRAWLSPACE SCALE: 1/2" = 1'-0"

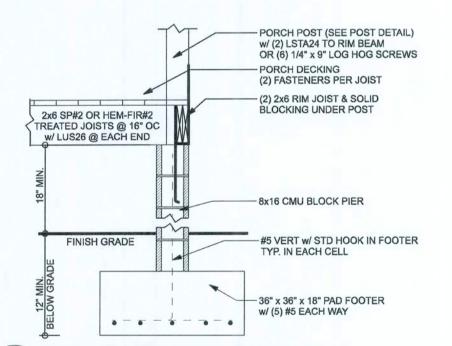

F4 FRONT PORCH PIER FOUNDATION S-2 WOOD FLOOR OVER CRAWLSPACE SCALE: 1/2" = 1'-0"

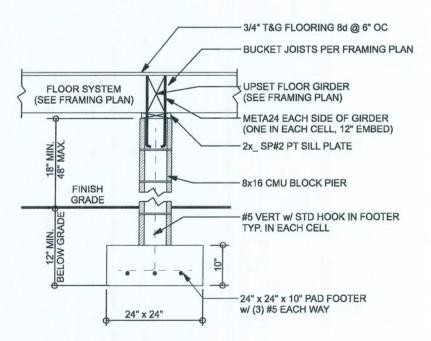

F5 PIER FOUNDATION (FULL HEIGHT @ UPSET BEAM) S-2 CMU PIER (DROPED GIRDER) SCALE: 1/2" = 1'-0"



BOTTOM OF EXERIOR FOOTINGS SHALL BE A MINIMUM OF

m2) of under-floor space area. One such ventilating opening shall be within 3 feet (914 mm) of each corner of the building.


Ventilation openings shall be covered for their height and width with any of the following materials provided that the least

dimension of the covering shall not exceed 1/4 inch (6.4 mm)

NOTE: CRAWLSPACE CAN BE SEALED WITH STEMWALL INS. AS PER FBCR

12" BELOW UNISTURBED SOIL OR ENGINEERED FILL

PER FBC 2017-ES. SECTION R403.1.4

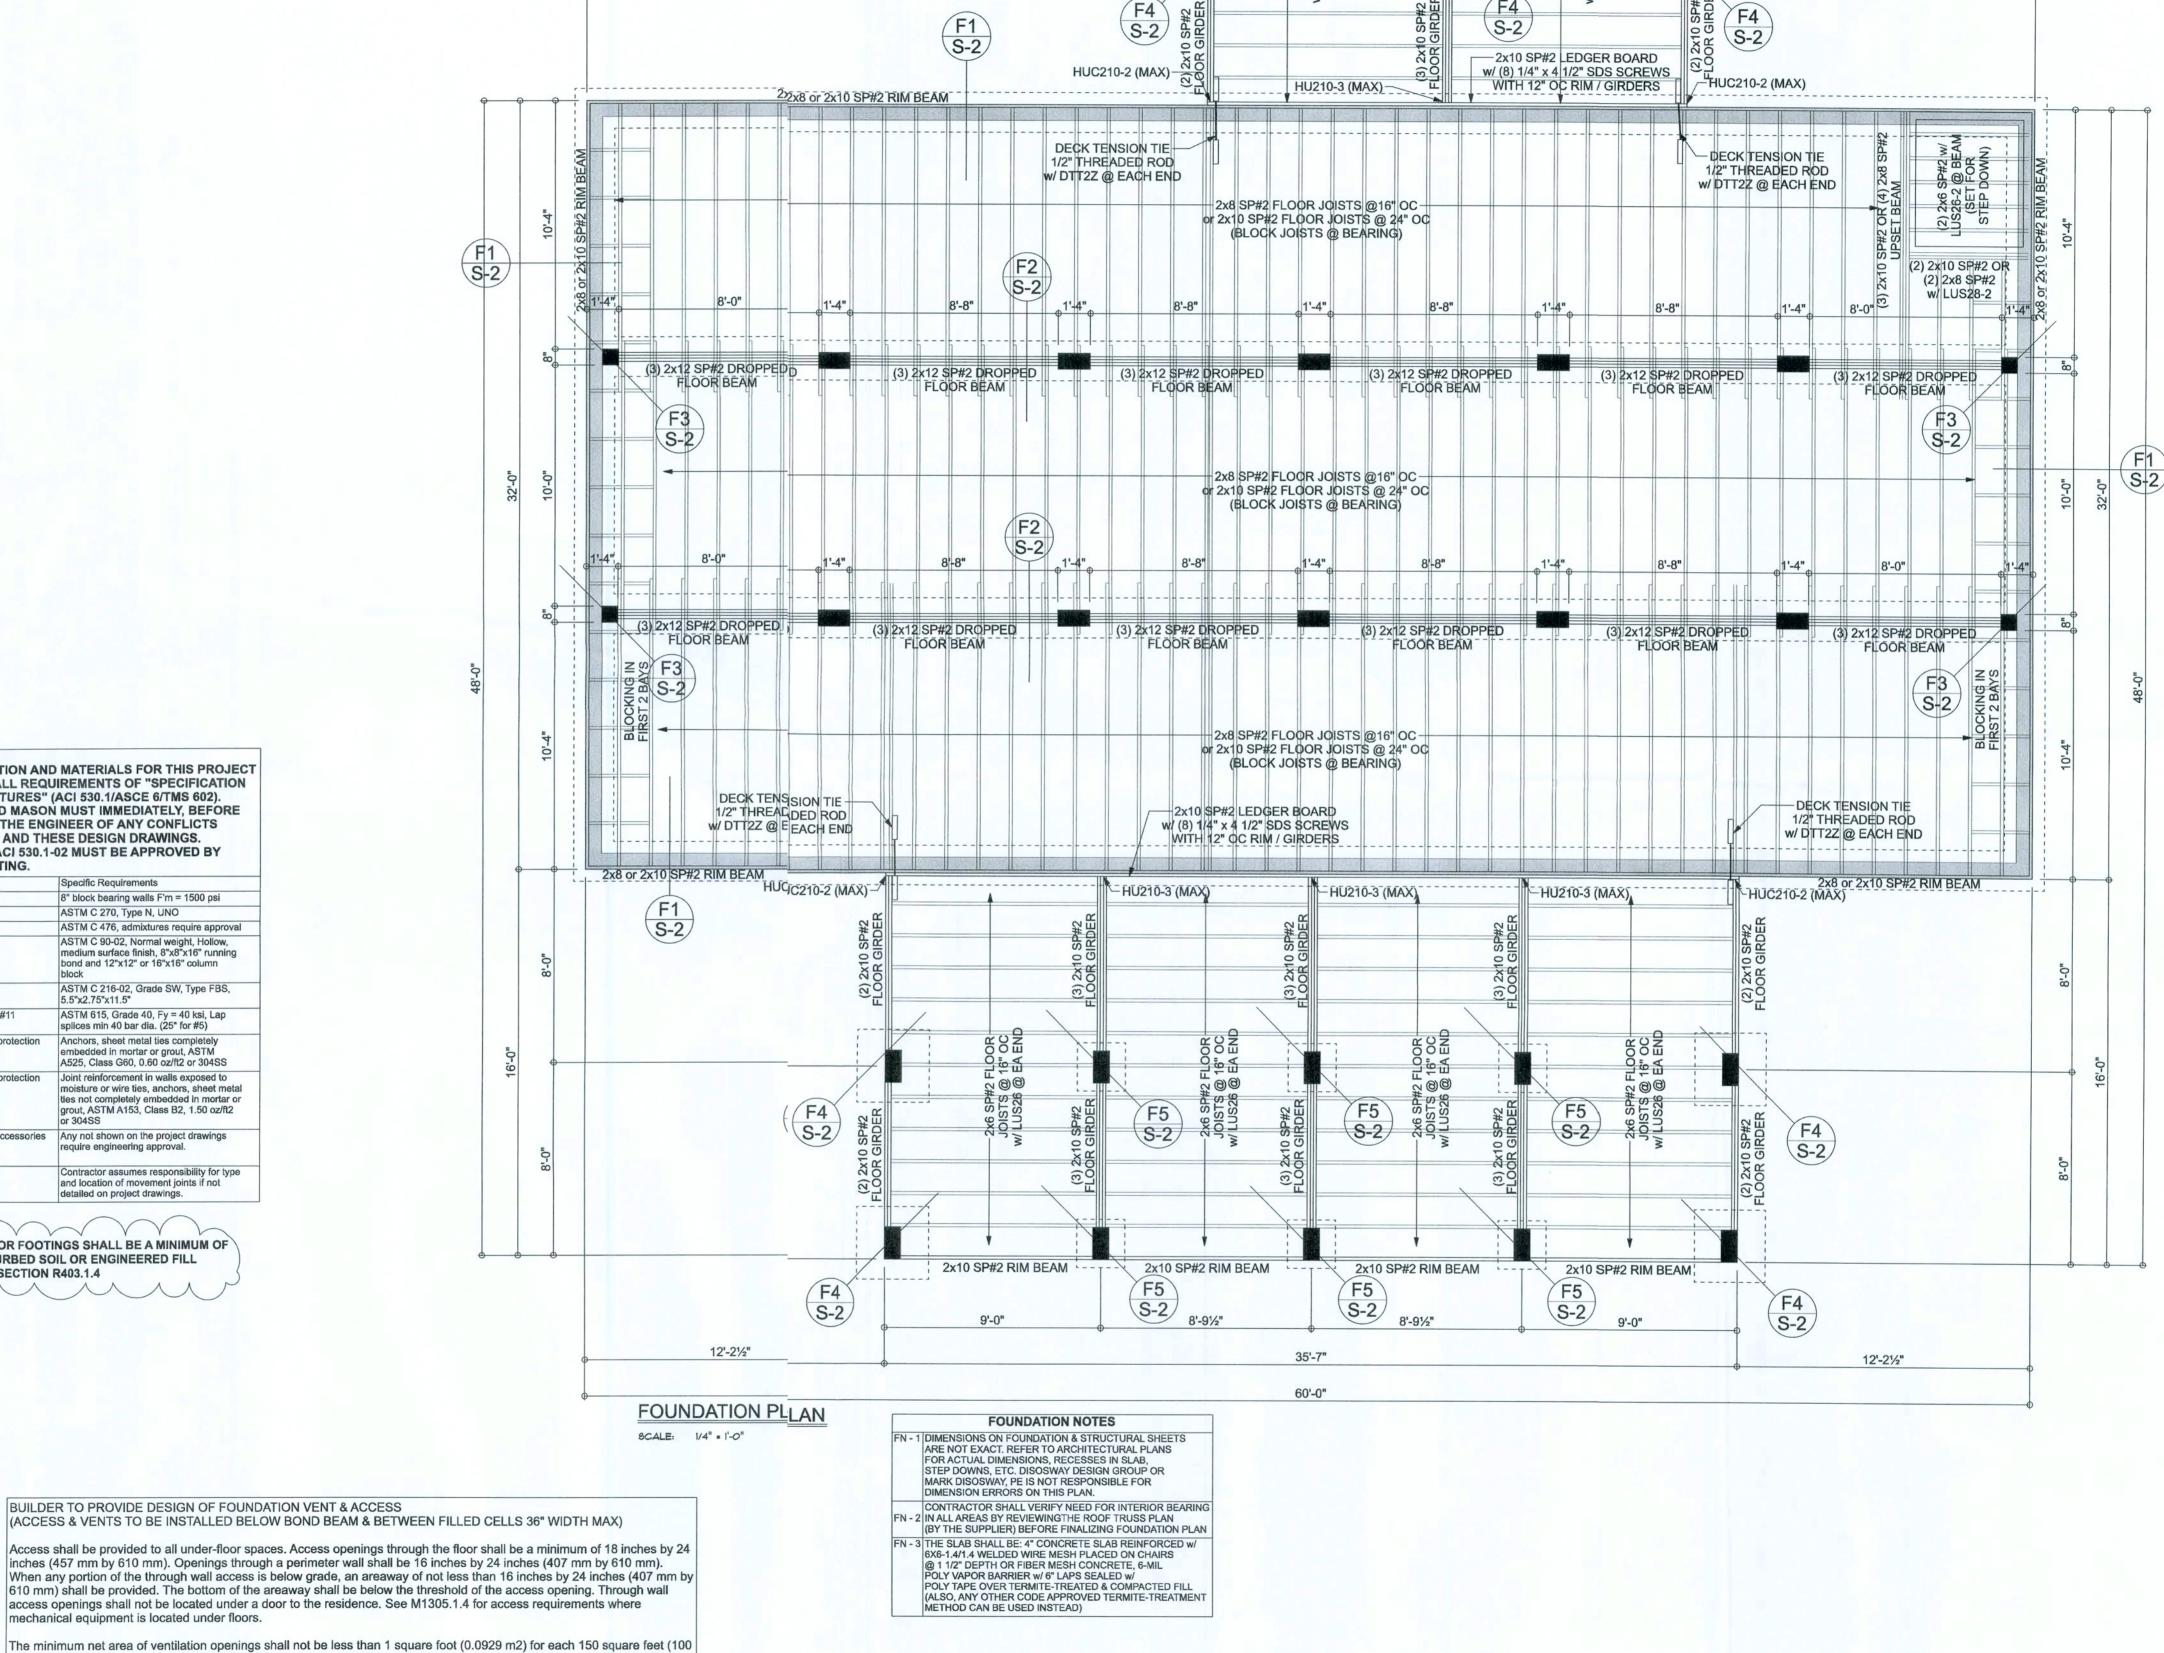

60'-0"

2x10 SP#2 RIM BEAM


S-2

223 Knight 7 Ft. White,

Stated dimensions supercee scaled dimensions. Refer all questions to Mark Disosway, P.E. for rescution. Do not proceed without clarication.

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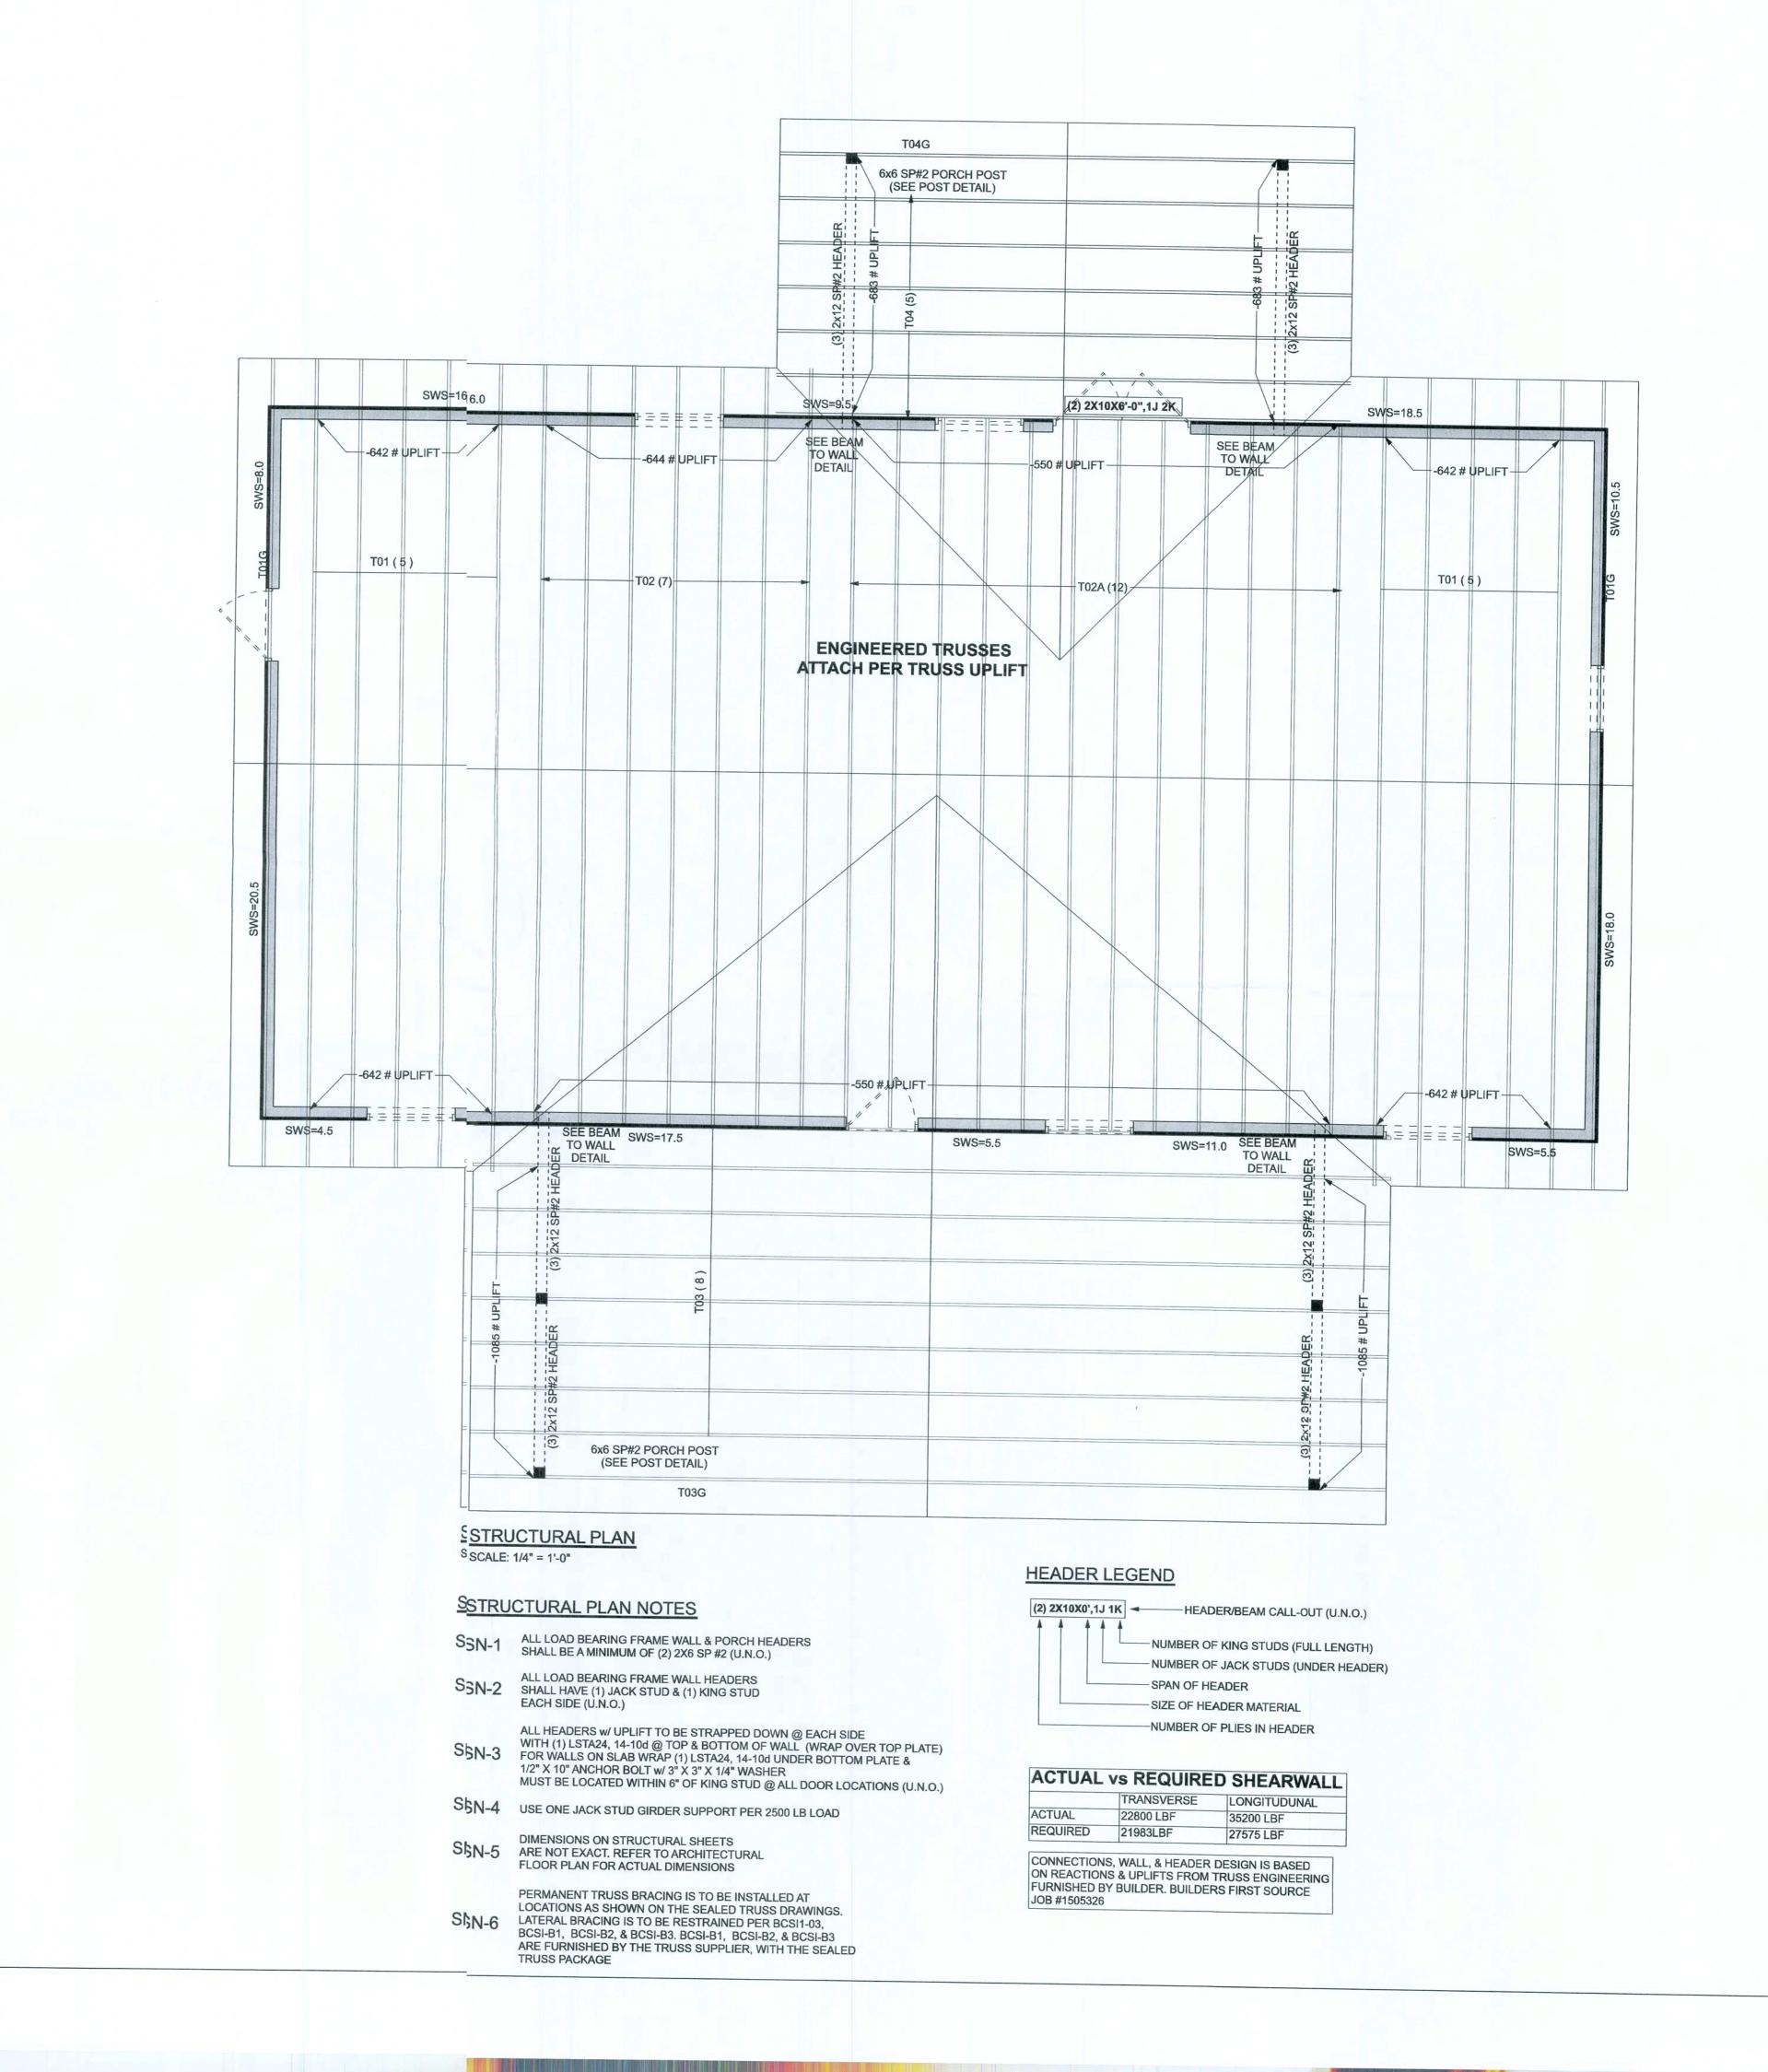
LIMITATION: This design is alid for one building, at specified location

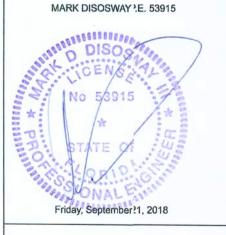

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JOB NUMBER: 181011 **S-2**

OF 3 SHEETS




Stated dimensions supercede saled dimensions. Refer all questions b Mark Disosway, P.E. for resolutio. Do not proceed without clarification.

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CERTIFICATION: I hereby certifythat I have examined this plan, and that the ipplicable portions of the plan, relating to wind engineering comply with the 6th Edition Florid Building Code Residential (2017) to the best of my knowledge.

LIMITATION: This design is valid or one building, at specified location.

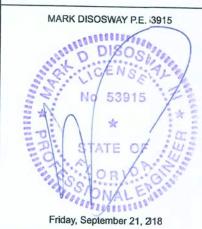

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S-3 OF 3 SHEETS