



REVISIONS	
15Feb06	

SOFTPLAN
ARCHITECTURAL DESIGN SOFTWARE

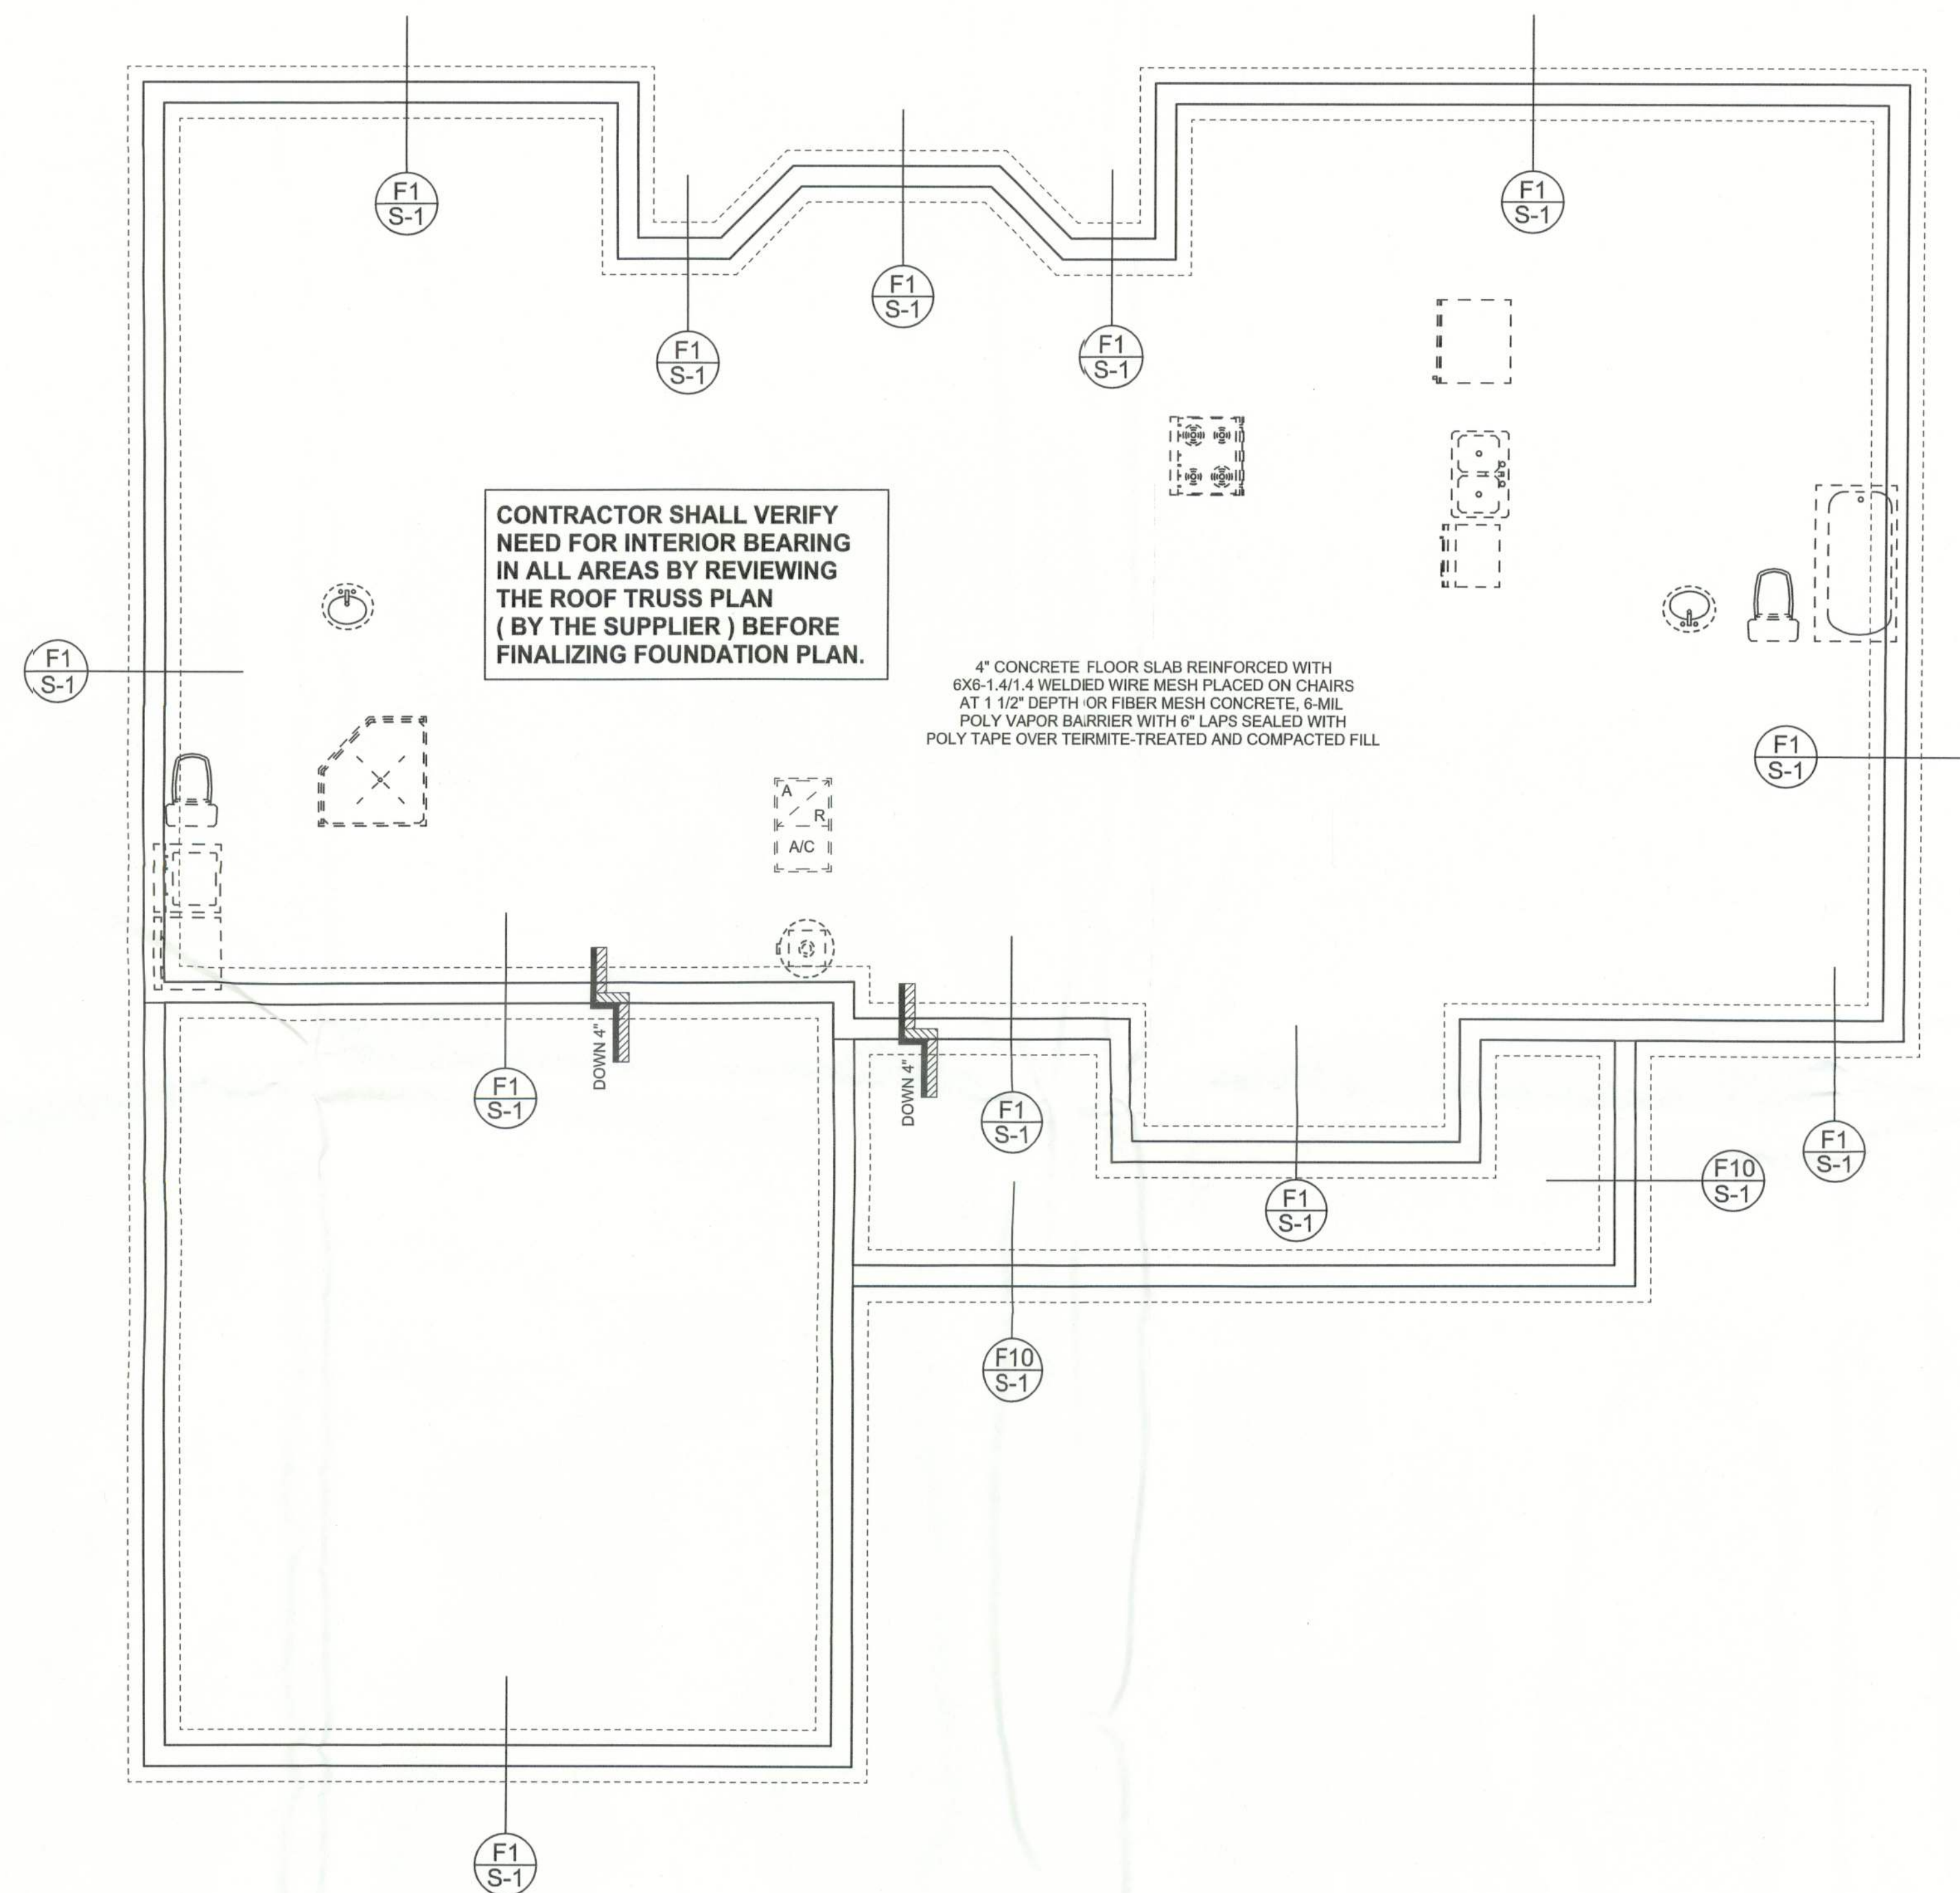

FOUNDATION PLAN
SCALE: 1/4" = 1'-0"

DIMENSIONS ON STRUCTURAL SHEETS
ARE NOT EXACT. REFER TO ARCHITECTURAL
FLOOR PLAN FOR ACTUAL DIMENSIONS

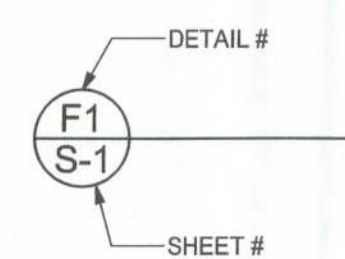

WINDLOAD ENGINEER: Mark Disoway,
P.E. No. 53915, P.O. Box 868, Lake City, FL
32056, 386-754-5419

DIMENSIONS:
Stated dimensions supercede scaled
dimensions. Refer all questions to
Mark Disoway, P.E. for resolution.
Do not proceed without clarification.

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permission and consent of Mark Disoway.

CERTIFICATION: These plans and
"Windload Engineering" Sheet S-1, attached,
comply with Florida Building Code 2001,
Section 1605 wind loads, to the best of my
knowledge.

LIMITATION: This design is valid for one
building at specified location. In case of conflict,
structural requirements, scope of work, and
builder responsibilities on sheet S-1 control.

MARK DISOWAY
P.E. 53915

Mark Disoway
15FEB06
SEAL

**PARNELL
RESIDENCE**

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PRINTED DATE:
February 15, 2006

DRAWN BY: Ben Sparks
CHECKED BY:

DESIGNED BY:
Ben Sparks

FINALS DATE:
JUL / 27 / 05

JOB NUMBER:
507084a

DRAWING NUMBER

A-4

OF 5 SHEETS