Cosh

### **Columbia County New Building Permit Application**

(838) Diability

For Office Use Only Application # 1906-71 Date Received 6 1819 By MG Permit # 3844/
Zoning Official 107 Date 6.23 17 Flood Zone 1 Land Use 70 Zoning 1110
FEMA Map # N/A Elevation N/A MFE River N/A Plans Examiner 1.C Date 6-26-19
Comments Non Habitable Storage Bldg.
DNOC JEH v Deed or PA Site Plan - State Road Info - Well letter - 911 Sheet - Parent Parcel #  Dev Permit # In Floodway - Letter of Auth. from Contractor - F W Comp. letter
□ Dev Permit # □ In Floodway ► Letter of Auth. from Contractor □ F W Comp. letter □ Owner Builder Disclosure Statement □ Land Owner Affidavit □ Ellisville Water ☑ App Fee Paid □ Sub VF Form
Septic Permit No. 19-0563 OR City Water Fax
Applicant (Who will sign/pickup the permit) RAM Al-Chace Phone 336) 756-1567
Address 820 Record DRIVE, Mt. Alay, NC 27030
Owners Name Andrew and Tammara Gill Phone 904-509-5373
911 Address 170 Taylor Magee PL, Lake City, FL 32055
Contractors Name Steel Buildings and Structures, Inc Phone 817-272-8276
Address 820 Reeves Drive, Mt. Airy, NC 27030
Contractor Email Sbspermitting @ Sbsing. Com ***Include to get updates on this job.
Fee Simple Owner Name & Address
Bonding Co. Name & Address
Architect/Engineer Name & Address Moore + Associates: 401 s. Main st, Ste 200, Mt. Airy, NC 27030
Mortgage Lenders Name & Address
Circle the correct power company FL Power & Light Clay Elec. Suwannee Valley Elec. Duke Energy
Property ID Number 30-35-17-04800-116 Estimated Construction Cost 4800.00
Subdivision NameLotBlockUnitPhase
Driving Directions from a Major Road N & Hernando Aue ( E. Dew D, ( B) 45-41 ( C)
NW Julling Greek, (R) NW Taylor Magre Pl.  41 N, L Mershon St, L Falling Creek, L Taylor Mag
Construction of 22x 26x 11 Accessory Structure Commercial OR Residential
Proposed Use/Occupancy Storage Number of Existing Dwellings on Property 1
Is the Building Fire Sprinkled? NO_ If Yes, blueprints included Or Explain
Circle Proposed Culvert Permit or Culvert Waiver or D.O.T. Permit or Have an Existing Drive
Actual Distance of Structure from Property Lines - Front Side Rear
Number of Stories Heated Floor Area N/A Total Floor Area 572 Acreage Acreage Acreage
Zoning Applications applied for (Site & Development Plan, Special Exception, etc.)
7/14 MG spoke w francis at Steel buildings - head alc leability, E/rt Page 1 of 2 (Both Pages must be submitted together.) Revised 7-1-15

### **Columbia County Building Permit Application**

### CODE: Florida Building Code 2017 and the 2014 National Electrical Code.

Application is hereby made to obtain a permit to do work and installations as indicated. I certify that no work or installation has commenced prior to the issuance of a permit and that all work be performed to meet the standards of all laws regulating construction in this jurisdiction.

TIME LIMITATIONS OF APPLICATION: An application for a permit for any proposed work shall be deemed to have been abandoned 180 days after the date of filing, unless pursued in good faith or a permit has been issued.

TIME LIMITATIONS OF PERMITS: Every permit issued shall become invalid unless the work authorized by such permit is commenced within 180 days after its issuance, or if the work authorized by such permit is suspended or abandoned for a period of 180 days after the time work is commenced. A valid permit receives an approved inspection every 180 days. Work shall be considered not suspended, abandoned or invalid when the permit has received an approved inspection within 180 days of the previous approved inspection.

FLORIDA'S CONSTRUCTION LIEN LAW: Protect Yourself and Your Investment: According to Florida Law, those who work on your property or provide materials, and are not paid-in-full, have a right to enforce their claim for payment against your property. This claim is known as a construction lien. If your contractor fails to pay subcontractors or material suppliers or neglects to make other legally required payments, the people who are owed money may look to your property for payment, even if you have paid your contractor in full. This means if a lien is filed against your property, it could be sold against your will to pay for labor, materials or other services which your contractor may have failed to pay.

NOTICE OF RESPONSIBILITY TO CONTRACTOR AND AGENT: YOU ARE HEREBY NOTIFIED as the recipient of a building permit from Columbia County, Florida, you will be held responsible to the County for any damage to sidewalks and/or road curbs and gutters, concrete features and structures, together with damage to drainage facilities, removal of sod, major changes to lot grades that result in ponding of water, or other damage to roadway and other public infrastructure facilities caused by you or your contractor, subcontractors, agents or representatives in the construction and/or improvement of the building and lot for which this permit is issued. No certificate of occupancy will be issued until all corrective work to these public infrastructures and facilities has been corrected.

WARNING TO OWNER: YOUR FAILURE TO RECORD A NOTICE OF COMMENCEMENT MAY RESULT IN YOU PAYING TWICE FOR IMPROVEMENTS TO YOUR PROPERTY. A NOTICE OF COMMENCEMENT MUST BE RECORDED AND POSTED ON THE JOB SITE BEFORE THE FIRST INSPECTION. IF YOU INTEND TO OBTAIN FINANCING, CONSULT WITH YOUR LENDER OR ATTORNEY BEFORE RECORDING YOUR NOTICE OF COMMENCEMENT.

OWNERS CERTIFICATION: I CERTIFY THAT ALL THE FOREGOING INFORMATION IS ACCURATE AND THAT ALL WORK WILL BE DONE IN COMPLIANCE WITH ALL APPLICABLE LAWS REGULATING CONSTRUCTION AND ZONING.

TICE TO OWNER: There are some properties that may have deed restrictions recorded upon them. These

NOTICE TO OWNER: There are some properties that i		
restrictions may limit or prohibit the work applied for in y		
encumbered by any restrictions or face possible litigation	n and or fin	<del>)</del> s.
Print Owners Name Owners Signature		**Property owners <u>must sign</u> here <u>before</u> any permit will be issued.
Print Owners Name Owners Signatur	e `	
**If this is an Owner Builder Permit Application then, ON	LY the own	er can sign the building permit when it is issued.
contractors affidavit: By my signature I unders written statement to the owner of all the above writt this Building Permit including all application and pe	en respon	sibilities in Columbia County for obtaining
Mula Contractor's Signature	0 - 1	ctor's License Number <u>CBC1860497</u> bia County
	Comp	etency Card Number 1838
Affirmed under penalty of perjury to by the <u>Contractor</u> an		
Personally known or Produced Identification		
Frances Darac	SEAL:	FRANCES GARCIA
State of Florida Notary Signature (For the Contractor)		NOTARY PUBLIC SURRY COUNTY
Page 2 of 2 (R	oth Pages	hust STATE OF NORTH GAROLINA Revised 7-1-17



# COLUMBIA COUNTY BUILDING DEPARTMENT 135 NE Hernando Ave, Suite B-21, Lake City, FL 32055 Phone: 386-758-1008 Fax: 386-758-2160

### LETTER OF AUTHORIZATION TO SIGN FOR PERMITS

1. Javier Lara	(license holder name), licensed qualifier
for Steel Buildings and Structur	company name), do certify that
the below referenced person(s) listed on this for	m is/are contracted/hired by me, the license ugh an employee leasing arrangement; or, is an in Florida Statutes Chapter 468, and the said dontrol and is/are authorized to purchase
Printed Name of Person Authorized	Signature of Anthorized Person
1. Pami Al-Chadar	1.
2.	2.
3.	3.
4.	4.
5.	5.
authority to discipline a license holder for violatic officers, or employees and that I have full respondent ordinances inherent in the privilege granted officer(s), you must notify this department in write authorization form, which will supersede all prevunauthorized persons to use your name and/or	hsibility for compliance with all statutes, codes by issuance of such permits.  I is/are no longer agents, employee(s), or ting of the changes and submit a new letter of vious lists. Failure to do so may allow
dilautionized persons to use your marine and/or	incernse number to obtain permiss.
hu Ma Vicense Holders Signature (Notarized)	CBCIQUOMAT Lo-14-19 License Number Date
personally appeared before me and is known by	avier Lara
Francol Loucie NOTARY'S SIGNATURE	FRANGES GARCIA  NOTARY PUBLIC SURRY COUNTY STATE OF NORTH CAROLINA

# Columbia County, FLA - Building & Zoning Property Map

Printed: Wed Jun 26 2019 13:25:32 GMT-0400 (Eastern Daylight Time)

Parcels Roads

Roads

others

Dirt

Interstate

Main

Other

Paved Private

Addressing:2018 Base Flood Elevations, Group 2018 Base Flood Elevations

**DEFAULT** 

Base Flood Elevations

2018 Base Flood Elevation Zones

0.2 PCT ANNUAL CHANCE

O A

■ AE AH

2018 Flood Zones

0.2 PCT ANNUAL CHANCE

■ A

O AE

AH

Contours

default(Contours.shp)

**DEFAULT** DevZones1

others

□ A-1

A-2

□ A-3 □ CG

□ CHI

□ CI

□ CN

CSV □ ESA-2

O ILW

■ MUD-I

PRD

PRRD

RMF-1 RMF-2

RO RO RR

RSF-1

RSF-2

RSF-3 RSF/MH-1

RSF/MH-2

RSF/MH-3

**DEFAULT** 

2018Aerials



### Parcel Information

Parcel No: 30-2S-17-04800-116 Owner: GILL ANDREW E &

Subdivision: PINES OF FALLING CREEK


Lot:

Acres: 1.70978057 Deed Acres: 1.75 Ac

District: District 1 Ronald Williams Future Land Uses: Agriculture - 3

Flood Zones:

Official Zoning Atlas: A-3, PRD

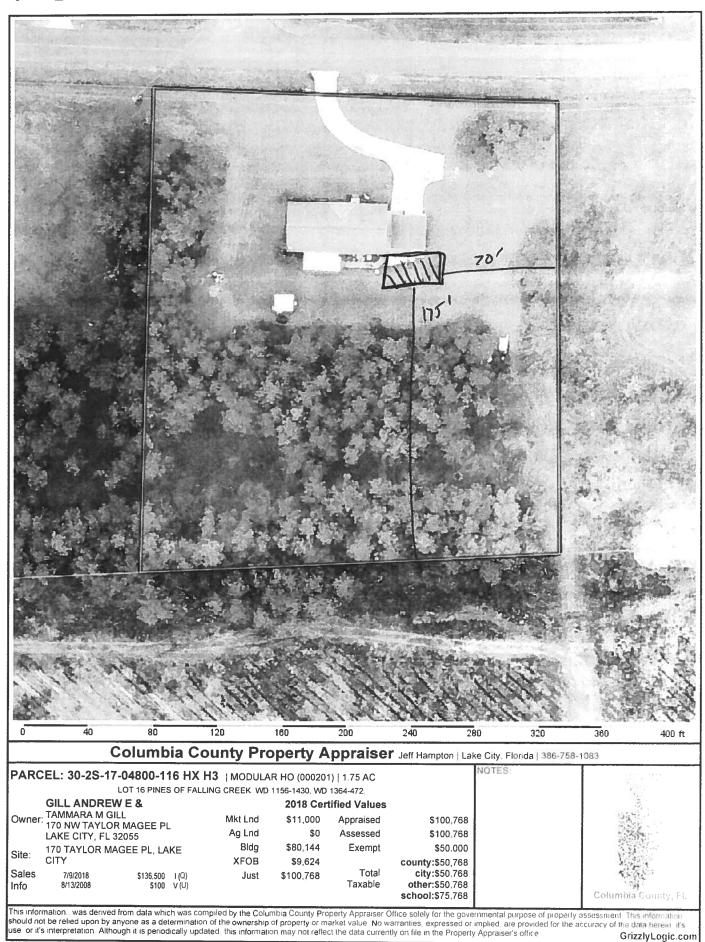



### STATE OF FLORIDA DEPARTMENT OF HEALTH ONSITE SEWAGE TREATMENT AND DISPOSAL System

1561
11/2
<del>2011</del> 0
֡


APPLICATION	FOR CONSTRUCTI	ON PERMIT			41 50
APPLICATION FOR:  [] New System [X] E.  [] Repair [] A  APPLICANT: APPLICANT:	xisting System	[ ] Hold	ling Tank corary	[ ] Innovativ	re
AGENT:  MAILING ADDRESS: 170 N	wtaylor	Magre Pl	TELE	PHONE: 90450	9537
TO BE COMPLETED BY APPLICANT BY A PERSON LICENSED PURSUANT APPLICANT'S RESPONSIBILITY TO PLATTED (MM/DD/YY) IF REQUES:	T TO 489.105(3) (m D PROVIDE DOCUMEN	) OR 489.552, TATION OF THE	FLORIDA ST	PATUTES. IT IS LOT WAS CREATED	THE
PROPERTY INFORMATION  LOT: 16 BLOCK:  PROPERTY ID #: 30-25-17  PROPERTY SIZE: 15 ACRES  IS SEWER AVAILABLE AS PER 381  PROPERTY ADDRESS: 170  DIRECTIONS TO PROPERTY:	WATER SUPPLY: [ 1.0065, FS? [ Y / NWTaylov	] PRIVATE P	UBLIC [ ]<	=2000GPD [ ]>2	000GPD
BUILDING INFORMATION  Unit Type of  No Establishment  2  3 4	No. of Build Area  34  2	ling Commerci	ial/Institu , Chapter 6	tional System De 4E-6, FAC	esign
[ ] Floor/Equipment Drains SIGNATURE:  DH 4015, 08/09 (Obsoletes Ore	[ ] Other (Sp		Da	TE: 7-23-1	9

015, 08/09 (Obsoletes previous editions which may not be used) Incorporated 64E-6.001, FAC

Page 1 of 4

# STATE OF FLORIDA DEPARTMENT OF HEALTH APPLICATION FOR CONSTRUCTION PERMIT

Permit Application Number 19-0564

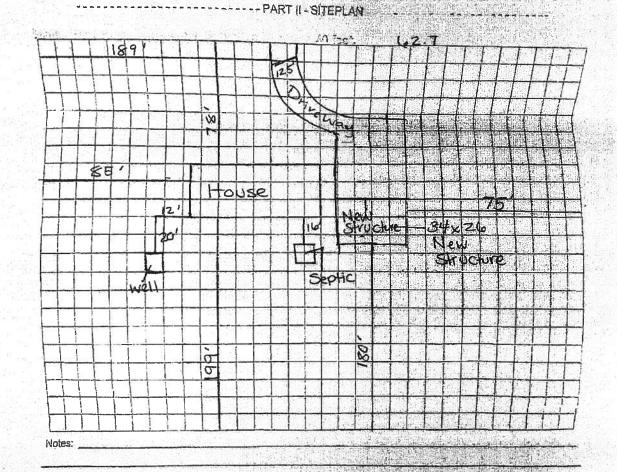

Site Plan submitted by:

Plan Approved

Not Approved

Not Approved

Columbia CHD Carrity Realth Department

ALL CHANGES MUST BE APPROVED BY THE COUNTY REALTH DEPARTMENT

DH 4015, 08/DQ (Obsoletos previous edillons which may not be used) Incorporated: 54E-5.001, FAC. (Stock Number: 5744-502-4015-5)

Tiens Talk

### **Columbia County Property Appraiser**

Jeff Hampton

Parcel: << 30-2S-17-04800-116 >>

2018 Tax Roll Year updated: 5/9/2019

Owner & Pi	operty Info	Result: 1 of 1		
Owner	GILL ANDREW I TAMMARA M GI 170 NW TAYLOR LAKE CITY, FL 3	LL R MAGEE PL		
Site	170 TAYLOR MAGEE PL, LAKE CITY			
Description*	LOT 16 PINES OF -1430, WD 1364-4		EK. WD 1156	
Area	1.75 AC	S/T/R	30-2S-17	
Use Code**	MODULAR HO (000201)	Tax District	3	

\*The Description above is not to be used as the Legal Description for this parcel in any legal transaction.

\*\*The Use Code is a FL Dept, of Revenue (DOR) code and is not maintained by the Property Appraiser's office. Please contact your city or county Planning & Zoning office for specific zoning information.

Aerial Viewer	Pictometery	Google Maps	
2019 2016	NW IAN CT	2018:09:12 \$15:600 WD:V-Q-03	PL
	2018-07-09 \$136-500 WD4-EQ-01		

2018 Cert	ified Values	2019 Wor	king Values
			King values
Mkt Land (1)	\$11,000	Mkt Land (1)	\$11,000
Ag Land (0)	\$0	Ag Land (0)	\$0
Building (1)	\$68,745	Building (1)	\$68,352
XFOB (3)	\$8,624	XFOB (3)	\$8,624
Just	\$88,369	Just	\$87,976
Class	\$0	Class	\$0
Appraised	\$88,369	Appraised	\$87,976
SOH Cap [?]	\$0	SOH Cap [?]	\$0
Assessed	\$88,369	Assessed	\$87,976
Exempt	\$0	Exempt	нх нз \$50,000
	county:\$88,369		county:\$37,976
Total	city:\$88,369	Total	city:\$37,976
Taxable	other:\$88,369	Taxable	other:\$37,976
	school:\$88,369		school:\$62,976

▼ Sales History							
Sale Date	Sale Price	Book/Page	Deed	V/I	Quality (Codes)	RCode	
7/9/2018	\$136,500	1364/0472	WD	1	Q	01	
8/13/2008	\$100	1156/1430	WD	V	U	01	

Building Cl	Building Characteristics								
Bldg Sketch	Bldg Item	Bldg Desc*	Year Blt	Base SF	Actual SF	Bldg Value			
Sketch	1	SFR MODULR (000201)	2008	1740	1860	\$68,352			

\*Bldg Desc determinations are used by the Property Appraisers office solely for the purpose of determining a property's Just Value for ad valorem tax purposes and should not be used for any other purpose.

Extra Features & Out Buildings (Codes)							
Code	Desc	Year Blt	Value	Units	Dims	Condition (% Good)	
0166	CONC,PAVMT	2008	\$6,624.00	2208.000	0 x 0 x 0	(000.00)	
0190	FPLC PF	2008	\$1,200.00	1.000	0 x 0 x 0	(000.00)	
0296	SHED METAL	2015	\$800.00	1.000	0 x 0 x 0	(000.00)	

As required by Florida Statute 553.842 and Florida Administrative Code 98-72, please provide the information and approval numbers on the building components listed below if they will be utilized on the construction project for which you are applying for a building permit. We recommend you contact your local product supplier should you not know the product approval number for any of the applicable listed products. Statewide approved products are listed online @ www.floridabuilding.org

Category/Subcategory	Manufacturer	Product Description	Approval Number(s)
1. EXTERIOR DOORS			
A. SWINGING			
B. SLIDING			
C. SECTIONAL/ROLL UP			
D. OTHER			
2. WINDOWS		UMBIA COUNT	
A. SINGLE/DOUBLE HUNG		(2) (1) 2 (0)	
B. HORIZONTAL SLIDER			
C. CASEMENT		200000000000000000000000000000000000000	
D. FIXED		(Z 38/Q) PA	
E. MULLION			
F. SKYLIGHTS		THEN THANKS	
G. OTHER		THEN THEM THE	
3. PANEL WALL			
A. SIDING			
B. SOFFITS			
C. STOREFRONTS			
D. GLASS BLOCK			
E. OTHER	Steel Buildings	AG Metal Wall	22568.
	3		
4. ROOFING PRODUCTS			
A. ASPHALT SHINGLES			
B. NON-STRUCT METAL			
C. ROOFING TILES			
D. SINGLE PLY ROOF			
E. OTHER			
5. STRUCT COMPONENTS			
A. WOOD CONNECTORS			
B. WOOD ANCHORS			
C. TRUSS PLATES			
D. INSULATION FORMS			
E. LINTELS			
F. OTHERS	Steel Buildings	AG Metal Roof	22541.1
	3		
6. NEW EXTERIOR			
ENVELOPE PRODUCTS			1

The products listed below did not demonstrate product approval at plan review. I understand that at the time of inspection of these products, the following information must be available to the inspector on the jobsite; 1) copy of the product approval, 2) performance characteristics which the product was tested and certified to comply with, 3) copy of the applicable manufacturers installation requirements.

Further, I understand these products may have to be removed if approval cannot be demonstrated during inspection.

NOTES:	-
***	
Name and Address of the Owner, where the	





# STRUCTURAL DESIGN ENCLOSED BUILDING

# MAXIMUM 30'-0" WIDE X 20'-0" EAVE HEIGHT- BOX EAVE FRAME

14 December 2018 Revision 7 M&A Project No. 16062S/16155S/16207S/17155S/17200S/18068S/18156S/18290S

### Prepared for:

Steel Buildings and Structures, Inc. P.O. Box 1287 Mt. Airy, NC 27030


Prepared by:

Moore and Associates Engineering and Consulting, Inc.

1009 East Avenue North Augusta, SC 29841

401 S. Main St., Suite 200 Mount Airy, NC 27030



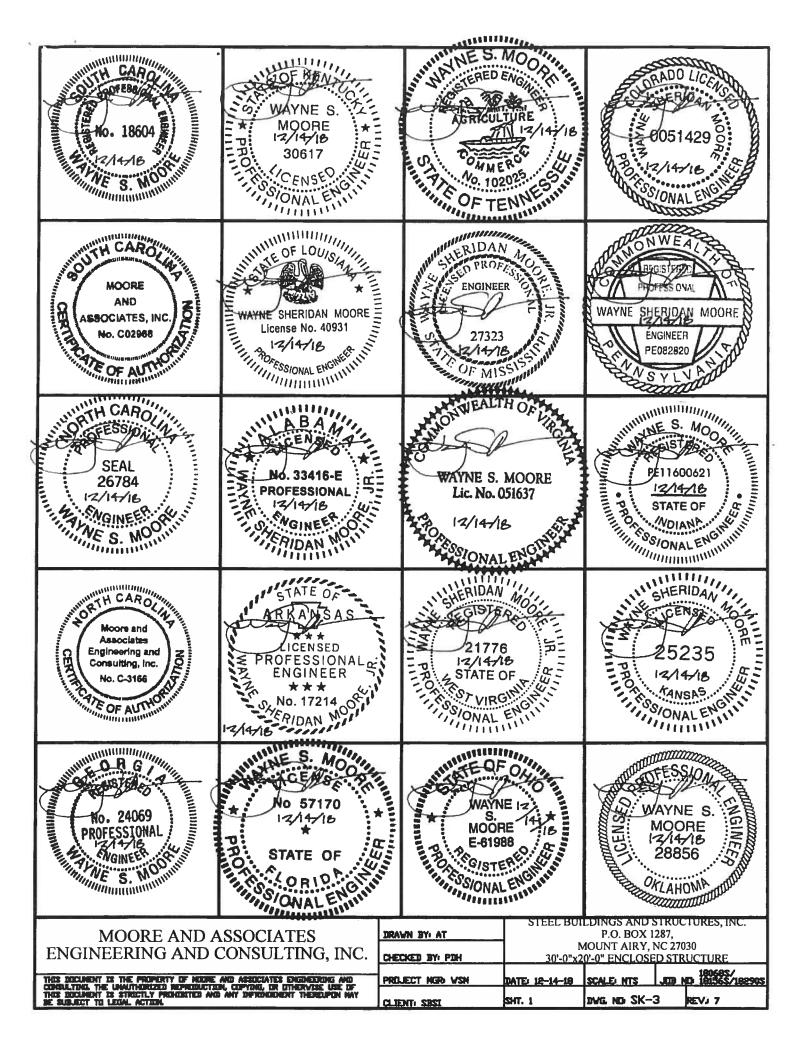

OF MARY  OF	Professional Certification I hereby certify that these documents were prepared approved by me, and that I a duly licensed professional engineer under the laws of the State of Maryland, License No. 49744, Expiration Date 6/6/20	or arn al			
WAYNE S.  WAYNE S.  MOORE  NUMBER  PE-2016030730  12/14/18  13/14/18	28				
SHERIDAN AND OR THE STATE OF TH	9				
WAYNE S. MOORE 120644 O. CENSED					
MOORE AND A ENGINEERING AND CONSULTANT THE INVANCED IN THE INVANCED IN THE SECRETARY OF HOUSE THE SECRETARY IN THE SECRETARY	CONSULTING, INC.	PROJECT NGR VSN	N 30'-0"x2	P.O. BOX 12 (OUNT AIRY, N 0'-0" ENCLOSEI SCALE NTS DVG. ND. SK-3	IC 27030 D STRUCTURE 180688/ JUB NO 181548/182908

# DRAWING INDEX

```
SHEET 1
             PE SEAL COVER SHEET (1 OF 2)
            PE SEAL COVER SHEET (2 OF 2)
SHEET 1A
SHEET 2
             DRAWING INDEX
             INSTALLATION NOTES AND SPECIFICATIONS
SHEET 3
             TYPICAL SIDE AND END ELEVATIONS
SHEET 3A
             TYPICAL SIDE AND END ELEVATIONS
SHEET 3B
            TYPICAL RAFTER/COLUMN FRAME AND SIDE FRAMING SECTION (BOX EAVE STRUCTURE)
SHEET 4
SHEET 4A
             TYPICAL RAFTER/COLUMN FRAME AND SIDE FRAMING SECTION (BOX EAVE STRUCTURE)
            TYPICAL RAFTER/COLUMN FRAME AND SIDE FRAMING SECTION (BOX EAVE STRUCTURE)
SHEET 4B
            TYPICAL RAFTER/COLUMN FRAME AND SIDE FRAMING SECTION (BOW EAVE STRUCTURE)
SHEET 4C
            TYPICAL RAFTER/COLUMN FRAME AND SIDE FRAMING SECTION (BOW EAVE STRUCTURE)
SHEET 4D
SHEET 4E
            TYPICAL RAFTER/COLUMN FRAME AND SIDE FRAMING SECTION (BOW EAVE STRUCTURE)
            COLUMN CONNECTION DETAILS (BOX EAVE STRUCTURE)
SHEET 5
            COLUMN CONNECTION DETAILS (BOX EAVE STRUCTURE)
SHEET 5A
SHEET 6
            COLUMN CONNECTION DETAILS (BOW EAVE STRUCTURE)
SHEET 6A
            COLUMN CONNECTION DETAILS (BOW EAVE STRUCTURE)
SHEET 7
            BASE RAIL ANCHORAGE OPTIONS
            TYPICAL END WALL AND SIDE WALL FRAMING SECTIONS
SHEET 8
            TYPICAL END WALL AND SIDE WALL FRAMING SECTIONS
SHEET 8A
SHEET 9
            CONNECTION DETAILS
SHEET 10
            CONNECTION DETAILS
SHEET 11
            LEAN-TO OPTIONS
SHEET 11A
            LEAN-TO OPTIONS
SHEET 12
            VERTICAL ROOF/SIDING OPTION END AND SIDE ELEVATION AND SECTION
SHEET 13
            OPTIONAL HEADER
SHEET 14
            ADDITIONAL BASE RAIL ANCHORAGE OPTION
            OPTIONAL BASE RAIL ON GRADE APPLICATION
SHEET 15
SHEET 16
            OPTIONAL BASE RAIL ON TIMBER BEAM
            OPTIONAL BASE RAIL ON TIMBER BEAM
SHEET 17
             WITH SDIL NAIL
SHEET 18
            OPTIONAL CONCRETE STRIP FOOTING
```

THUS DOCUMENT IS THE PROPERTY OF NUMBER AND ASSOCIATES ENGINEERING AND CHEGULTHAN THE UNAUTHORIZED REPRODUCTION, COPYDIG, OR OTHERVISE USE OF THUS DOCUMENT IS STRUCTLY PROFUNCTED AND ANY INFRINGEMENT THEREUPON MAY BE SUBJECT TO LEGAL ACTION.	CLIENT: SBSI	SHT. 2	DVG. ND SK-	3	REV. 7
THUS EXCLUSIVE IS THE PROPERTY OF HOUSE AND ASSOCIATES ENGINEERING AND	PREJECT NGR VSN	DATE: 12-14-18	SCALE: NTS	J00 N	18068\$/ D 18156\$/18290\$
ENGINEERING AND CONSULTING, INC.	CHECKED BY: PDH	1	AOUNT AIRY, 1 0'-0" ENCLOSE		
MOORE AND ASSOCIATES	DRAWN BY: AT	P.O. BOX 1287,			

### INSTALLATION NOTES AND SPECIFICATIONS

- 1. DESIGN IS FOR MAXIMUM 30'-0' WIDE x 20'-0' EAVE HEIGHT ENCLOSED STRUCTURES.
- 2. DESIGN WAS DONE IN ACCORDANCE WITH THE 2017 FLORIDA BUILDING CODE (FBC) 6TH EDITION, 2018 NORTH CAROLINA BUILDING CODE, 2006 INTERNATIONAL BUILDING CODE (IBC), 2009 IBC, 2012 IBC AND 2015 IBC.
- 3. DESIGN LOADS ARE AS FOLLOWS:

A) DEAD LOAD

= 1.5 PSF

B) LIVE LOAD

= 12 PSF

C) GROUND SNOW LOAD = 30 PSF (< 26'-0'), 35 PSF (26'-0' < W < 30'-0')

(UNBALANCED SNOW LOADS DUE TO DRIFTING HAVE NOT BEEN EVALUATED.)

- 4. 3-SECOND GUST ULTIMATE WIND SPEED (VULT) 105 TO 145 MPH (NOMINAL WIND SPEED 82 TO 112 MPH): MAXIMUM RAFTER/COLUMN AND END COLUMN SPACING = 5.0 FEET (UNLESS NOTED OTHERWISE).
- 5. END WALL COLUMNS (POST) ARE EQUIVALENT TO SIDE WALL POSTS UNLESS NOTED OTHERWISE.
- 6. RISK CATEGORY I.
- 7. WIND EXPOSURE CATEGORY B.
- 8 SPECIFICATIONS APPLICABLE TO 29 GAUGE METAL PANELS FASTENED DIRECTLY TO 2 1/2" x 2 1/2" 14 GAUGE TUBE STEEL (TS) FRAMING MEMBERS (UNLESS NOTED OTHERWISE).
- 9. AVERAGE FASTENER SPACING DN-CENTERS ALONG RAFTERS OR HAT CHANNELS, AND COLUMNS (INTERIOR OR END) = 8 INCHES.
- 10. FASTENERS CONSIST OF 1/4"x3/4" SELF-DRILLING FASTENER (SDF), USE CONTROL SEAL WASHER WITH EXTERIOR FASTENERS.
  SPECIFICATIONS APPLICABLE ONLY FOR MEAN ROOF HEIGHT OF 20 FEET OR LESS, AND ROOF SLOPES OF 14" (3:12 PITCH) OR LESS SPACING REGUIREMENTS FOR OTHER ROOF HEIGHTS AND/OR SLOPES MAY VARY.
- II GROUND ANCHORS SHALL BE INSTALLED THROUGH BASE RAIL WITHIN 6' OF EACH COLUMN.
- 12. GROUND ANCHORS CONSIST OF #4 REBAR W/ WELDED NUT x 36' LONG IN SUITABLE SOIL CONDITIONS. OPTIONAL ANCHORAGE MAY BE USED IN SUITABLE SOILS AND MUST BE USED IN UNSUITABLE SOILS AS NOTED.
- 13. WIND FORCES GOVERN OVER SEISMIC FORCES. SEISMIC PARAMETERS ANALYZED ARE:

SDIL SITE CLASS = D RISK CATEGORY I/II/III

R= 3.25

I<sub>E</sub>= 1.0

S<sub>DS</sub>= 2.039

 $V = C_S W$ 


Sp1= 1.258

14. WINDOW AND DOOR DESIGN PRESSURES ARE APPLICABLE TO THE STATE OF FLORIDA ONLY.

MOORE AND ASSOCIATES ENGINEERING AND CONSULTING, INC.	DRAVN BY: AT	STEEL BUILDINGS AND STRUCTURES, INC. P.O. BOX 1287, MOUNT AIRY, NC 27030 30'-0"x20'-0" ENCLOSED STRUCTURE		
THUS DOCUMENT IS THE PROPERTY OF MOURE AND ASSOCIATES ENGINEERING AND CONGILITING. THE UNAUTHORIZED REPRODUCTION, COPYING, OR OTHERWISE USE OF THUS DOCUMENT IS STRUCTURY PROFESSED AND ANY INFRINGEMENT THERELIPON MAY BE SUBJECT TO LEGIAL ACTION.	PROJECT NOW VSN	DATE: 12-14-18	1	.788081 JB 803.

# VINDOW (AS APPLICABLE) DESIGN PRESSURE (218 PSF. -236 PSF) 6' (TYP) FLASHING LEVST- VARIES DEPENDING ON NUMBER AND SPACING OF RAFTERS

TYPICAL SIDE ELEVATION
SCALE: NTS

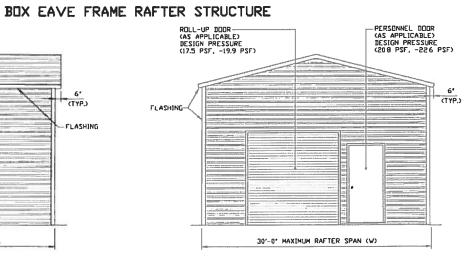

TYPICAL END ELEVATION
SCALE: NTS

MOORE AND ASSOCIATES
ENGINEERING AND CONSULTING, INC.
THE WALLEST TO THE RESIDENCE OF MARKET AND ASSESSMENT OF THE PROPERTY OF THE P

				· · · · · · · · · · · · · · · · · · ·
THES DECLMENT	IS THE PROPERTY	OF HOUSE AND	ASSOCIATES DI	ENEEDIG MO
CONSULTING. TH	E UNAUTHIRIZED F	SPICOUCTION, CO	PYNU, OR OTH	ervise use of
THES DOCUMENT	IS STREETLY PAGE	אוא מא מפוזצנט	INTRINGENERAL T	THEREUPON MAY
TE SUBJECT TO	LEGAL ACTION			


CLIENT: SBSI	SHT. 3A	DVG ND SK-3	}	REVJ 7				
 PROJECT HGR: VSH	DATE: 12-14-18	SCALE: NTS	JOB N	180685/ D 181565/182905				
CHECKED BY: PDH	MOUNT AIRY, NC 27030 30'-0"x20'-0" ENCLOSED STRUCTURE							
BRAWN BY: AT	P.O. BOX 1287,							

# VINDIDY (AS APPLICABLE) DESIGN PRESSURE (218 PSF. -236 PSF) FLASHING PERCONNEL DIDDR (AS APPLICABLE) DESIGN PRESSURE (173 PSF.) FLASHING FLASHING LENGTH VARIES DEPENDING ON RAFTERS 100-0" MAXIMUM RAFTER SPAN (V)

TYPICAL SIDE ELEVATION
SCALE: NTS


TYPICAL END ELEVATION
SCALE: NTS

MOORE AND ASSOCIATES ENGINEERING AND CONSULTING, INC.	DRAVN BY: AT	STEEL BUILDINGS AND STRUCTURES P.O. BOX 1287, MOUNT AIRY, NC 27030 30'-0"x20'-0" ENCLOSED STRUCTU			0
THIS DOCUMENT IS THE PROPERTY OF MODRE AND ASSOCIATES ENGINEERING AND CHESILITIES. THE UNAUTHORIZED REPRODUCTION, COPYING, OR STHEORYSE USE OF THIS DOCUMENT IS STREETLY PRODUCTION AND ANY DEPONDEMENT THERELIPON MAY BE SUBJECT TO LEGAL ACTION.	PROJECT MGR VSM	DATE: 12-14-18		JOB NO.	180685/ 181565/182905 EVJ 7

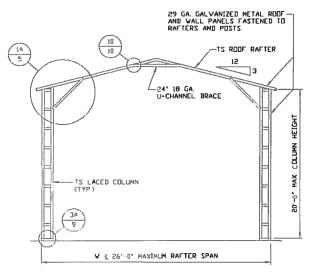

### TYPICAL RAFTER/COLUMN FRAME SECTION

SCALE: NTS

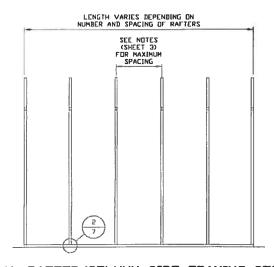

TYPICAL RAFTER/COLUMN SIDE FRAMING SECTION
SCALE: NTS


1A 5	TS RDDF RAFTER—  15'-0  TS COLLAR TIE  TS LACED COLUMN  (TYP)		ZO'-O" MAX. COLUMN HEIGHT
	560. < A < 300. HV	XIMUM RAFTER SPAN	<u> </u>

TYPICAL RAFTER/COLUMN FRAME SECTION
SCALE: NTS

MOORE AND ASSOCIATES
ENGINEERING AND CONSULTING, INC.

THUS DUCLIMENT IS THE PROPERTY OF NUMBER AND ASSECUATES ENGINEERING AND CONSULTING. THE UNAUTHERIZED REPRODUCTION, CUPYONG, OR OTHERVISE USE OF THUS EXCURRENT IS STRUCKLY PROBUSITED AND ANY ENTENDED THE THEORY MAY BE SUBJECT TO LEGIAL ACTION.

CLIENT: SBSI	SHT. 4	DVG. ND SK-		REV. 7				
PROLECT MGR VSM	DATE: 12-14-18	SCALE NTS	JCB 1	20925/18290S 18156\$/18290S				
CHECKED BY: PDH	MOUNT AIRY, NC 27030 30'-0"x20'-0" ENCLOSED STRUCTURE							
DRAWN BY AT	P.O. BOX 1287,							
T	STEEL BU	STEEL BUILDINGS AND STRUCTURES, INC.						

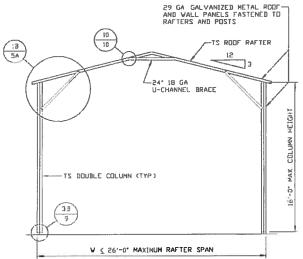

TYPICAL RAFTER/CULUMN FRAME SECTION
SCALE: NTS

29 GA GALVANIZED METAL REIEF
AND VALL PANELS FASTENED TO
RAFTERS AND POSTS

15 RODF RAFTER


11 10 12

15 COLLAR TIE

15 DRIUBLE COLUNN (17P)


26'-0' < V & 30'-0' MAXIMUM RAFTER SPAN

TYPICAL RAFTER/CULUMN FRAME SECTION
SCALE: NTS

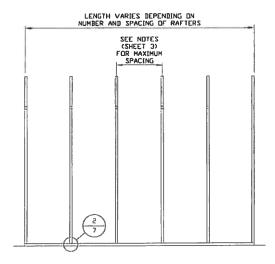

TYPICAL RAFTER/COLUMN SIDE FRAMING SECTION
SCALE: NTS

CONSULTING THE UNAUTHORIZED REPRODUCTION, COPYING, OR STREET, USE OF THIS DOCUMENT IS STREETLY PRODUCTED AND ANY DEPONDENENT THEREUPON MAY BE SUBJECT TO LEGAL ACTION.	CLIENT: SBSI	SHT. 4A	DVG. ND. SK-	3	REVJ 7
THUS DOCUMENT IS THE PROPERTY OF MODRE AND ASSOCIATES ENGINEERING AND CONSULTING. THE UNMUTHERIZED REPRIBUCTION, COPYING, OR OTHERVISE USE OF	PROJECT NOW VSH	DATE: 12-14-18	SCALE: NTS	J00 1	18068\$/ ID 18156\$/18290\$
ENGINEERING AND CONCULTING DIC	CHECKED BY: PDH	MOUNT AIRY, NC 27030 30'-0"x20'-0" ENCLOSED STRUCT			
MOORE AND ASSOCIATES	DRAWN BY: AT	STEEL BUI	TURES, INC.		

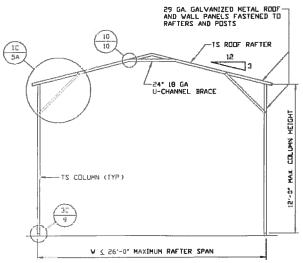


TYPICAL RAFTER/COLUMN FRAME SECTION
SCALE: NTS

29 GA GALVANIZED METAL ROOF
AND VALL PANELS FASTENED TO
RAFTERS AND POSTS

TS ROOF RAFTER


10
12
13
15'-0'
15 COLLAR TIE
12
10
12
15'-0'
27
27
28
29
20
20'-0' < V & 30'-0' MAXIMUM RAFTER SPAN

TYPICAL RAFTER/COLUMN FRAME SECTION
SCALE: NTS

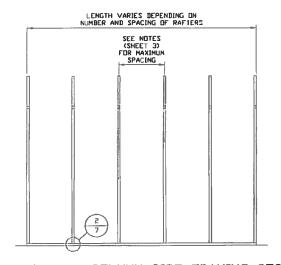

TYPICAL RAFTER/COLUMN SIDE FRAMING SECTION
SCALE: NTS

THIS INCLINENT IS THE PROPERTY OF HOME AND ASSOCIATES ENGINEERING AND COMMULTING. THE UNANTHORIZED REPRODUCTION, COPYING, OR OTHERWISE USE OF THIS ENGINEET IS STRUCTLY PRODUCTED AND ANY DIFROMEMENT THERELIPON MAY BE SUBJECT TO LOSAL ACTION.	CLIENT: SBSI	SHT. 438	DVG. NO SK-	3	REV. 7
THUS DUCLMENT IS THE PROPERTY OF HOUSE AND ASSOCIATES ENGINEERING AND	PREJECT NGO VSN	DATE: 12-14-18	SCALE: NTS	JEED N	18068\$/ D 18156\$/18290\$
ENGINEERING AND CONCULTING INC	CHECKED BY: PDH		AOUNT AIRY, I 0'-0" ENCLOSE		
MOORE AND ASSOCIATES	DRAVN BYLAT	1	P.O. BOX 1	287,	

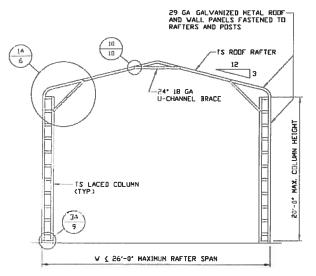

# TYPICAL RAFTER/COLUMN FRAME SECTION SCALE: NTS

29 GA GALVANIZED METAL RODF
AND WALL PANELS FASTENED TO
RAFTERS AND POSTS

TS ROOF RAFTER

10

12

15'-0'

TS COLLAR TIE

12

13


14

15'-0'

15 LACED COLUMN
(TYP)


26'-0' < V & 30'-0' MAXIMUM RAFTER SPAN

TYPICAL RAFTER/COLUMN FRAME SECTION
SCALE: NTS

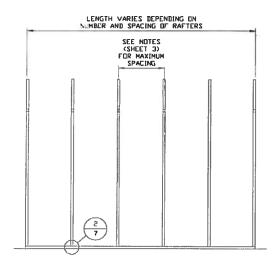


TYPICAL RAFTER/COLUMN SIDE FRAMING SECTION SCALE: NTS

MOODE AND ACCOUNTED	DRAWN BY: AT	STEEL BUI	LDINGS AND S P.O. BOX 1	TRUCTURES, INC.
MOORE AND ASSOCIATES ENGINEERING AND CONSULTING, INC.	CHECKED BY: PDH	1	MOUNT AIRY, N	
<u> </u>				\280081 200981\236181 GN BDL
CONSULTING THE UNAUTHORIZED REPRESENTING, COPYING, OR STHERWISE USE OF THIS SOCIEDIT IS STRUCTLY PROMINETED AND ANY DIFFERMEMENT THERESPON MAY BE SUBJECT TO LEGAL ACTION.			DWG ND SK-3	

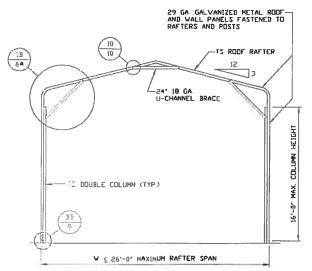

### TYPICAL RAFTER/COLUMN FRAME SECTION

TYPICAL RAFTER/CULUMN FRAME SECTION
SCALE: NTS

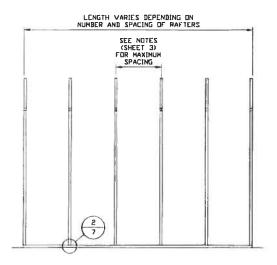


TYPICAL RAFTER/COLUMN SIDE FRAMING SECTION
SCALE: NTS


MOORE AND ASSOCIATES
ENGINEERING AND CONSULTING, INC.

THIS DOCUMENT IS THE PROPERTY OF MODIFIE AND ASSOCIATES ENGINEERING AND CONSULTING. THE UNMATHORIZED REPRODUCTION, CUPYING, OR STHERVISE USE OF THIS EDUCATION IS STRUCTLY PRODUCTED AND ANY DEPRINGEMENT THERELPON MAY BE SUBJECT TO LIGHA, ACTURA.


	CLIENT: SBSI	SHT. 4D	DWG. NO. SK-3 RE		REV. 7	
-	PROJECT NGR: VSN	DATE 12-14-18	SCALE NTS	JOB N	18068\$/ D 18156\$/18290\$	
	CHECKED BY: PDH		VC 270 D STR	30 UCTURE		
	DRAVN BY: AT	P.O. BOX 1287,				
		STEEL BUI	LDINGS AND S	TRUC	TURES, INC.	

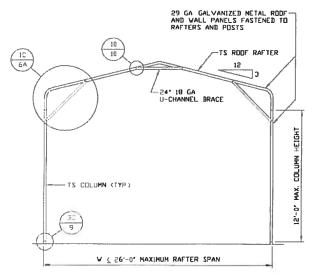

# TYPICAL RAFTER/COLUMN FRAME SECTION SCALE NTS

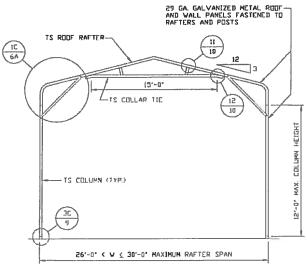


TYPICAL RAFTER/COLUMN FRAME SECTION
SCALE: NTS

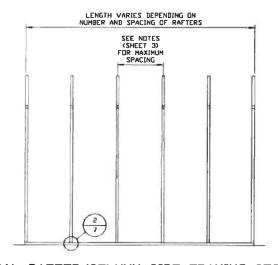


TYPICAL RAFTER/COLUMN SIDE FRAMING SECTION
SCALE: NTS

THE EDGLARM IS THE PROPERTY OF NEEDE AND ASSOCIATES ENGINEERING AND CONSULTING. THE UNAUTHORIZED REPRODUCTION, COPYDIG, OR DITHERVISE USE OF THES EDGLARM IS STRUCTLY PROPERTIES AND ANY INFROMEMENT THEREUPIN MAY BE SUBJECT TO LEGAL ACTION.			DVG ND SK-		
				JEB ND 18156\$/18290\$	
ENGINEERING AND CONSULTING, INC.	CHECKED BY: PDH		10UNT AIRY, 1 0'-0" ENCLOSE	NC 27030 ED STRUCTURE	
MOORE AND ASSOCIATES	DRAWN BY: AT	]	P.O. BOX 1287,		

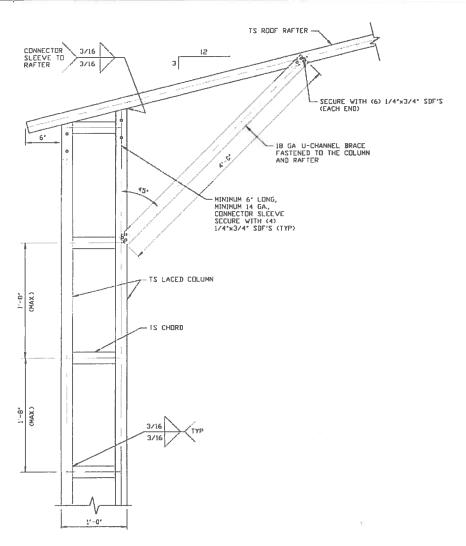


BOX EAVE RAFTER/CORNER POST CONNECTION DETAIL FOR HEIGHTS 16'-0' < TO & 20'-0"


SCALE: NTS

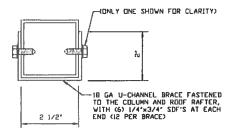

BRACE SECTION
SCALE: NTS


MOORE AND ASSOCIATES ENGINEERING AND CONSULTING, INC.	DRAWN BY: AT		P.O. BOX 1287, MOUNT AIRY, NC 27030 30'-0"x20'-0" ENCLOSED STRUCTURE			
,	PROJECT NGR VSN			18068\$/ JUB ND 18156\$/18290\$		
THIS DOCUMENT IS THE PROPERTY OF NEEDE AND ASSOCIATES ENGINEERING AND CONSULTING. THE UNAUTHERIZED REPRODUCTION, COPYING, OR OTHERWISE USE OF THIS DOCUMENT IS STRUCTLY PROBUSTED AND ANY INPRINGEMENT THERELIPON MAY BE SUBJECT TO LEGAL ACTION.	CLIENT: SBSI	SHT. 5	DVG. ND SK-	3 REV. 7		

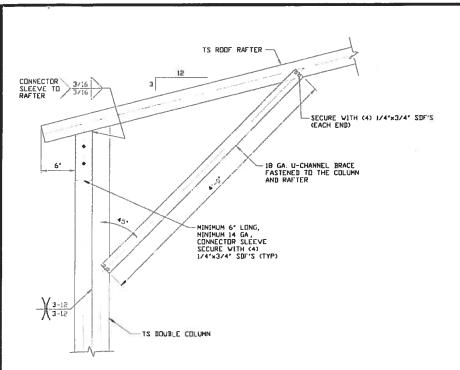

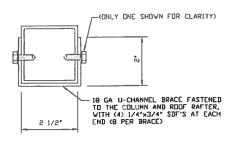

BRACE SECTION
SCALE: NTS

BOX EAVE RAFTER/CORNER POST CONNECTION DETAIL FOR HEIGHTS 12'-0' < TO < 16'-0'

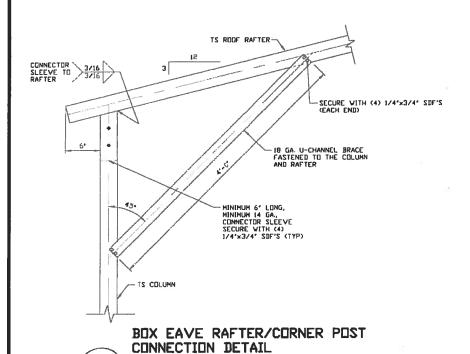

MOORE AND ASSOCIATES ENGINEERING AND CONSULTING, INC.


SCALE: NTS

1C

FOR HEIGHTS ≤ 12'-0"


THIS DOCUMENT IS THE PROPERTY OF NODE AND ASSOCIATES ENGINEERING AND CHROLLTING, THE UNMITHEREDED REPRODUCTION, COPYING, OR ITHERVISE USE OF THIS DOCUMENT IS STRUCTLY PRODUCTED AND ANY DEFENDMENT THERELPON MAY BE SUBJECT TO LEGAL ACTION.

PREJECT NGR: VSN		0'-0" ENCLOSE SCALE: NTS		
PROJECT NGR: VSN	DATE: 12-14-18	SCALE: NTS	JOB N	180685/ D 181565/182905
		DVG ND SK-3		REV: 7

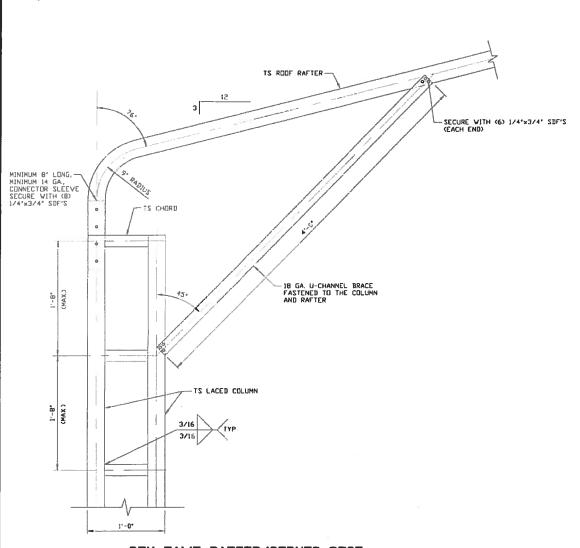

BOX EAVE RAFTER/CORNER POST CONNECTION DETAIL

FOR HEIGHTS 16'-0' < TO \( \) 20'-0'

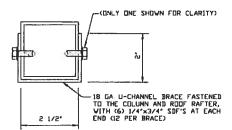



BRACE SECTION

	•
MOODE AND ACCOUNTED	
MOORE AND ASSOCIATES	
ENGINEEDING AND CONGULTING INC	
ENGINEERING AND CONSULTING, INC.	

THIS DOCUMENT IS THE PROPERTY OF MODE AND ASSOCIATES ENGINEERING AND CHROLLTENG. THE UNAUTHORIZED REPRODUCTION, COPYDIG, OR OTHERWISE USE OF THIS DOCUMENT IS STRUCTLY PROMURTED AND ANY DIFFRINGEMENT THERELIPON MAY BE SUBJECT TO LEGAL ACTION.

CLIENT) SEST	SHT	6	DVG ND SK-	3	REV. 7	
PROJECT MGR	WSM DATI	E 12-14-18	SCALE: NTS	M EDL	180685/ D 18156\$/18290\$	
CHECKED BY: P	DH		IOUNT AIRY, I 0'-0" ENCLOSE			
DRAWN BY AT		STEEL BUILDINGS AND STRUCTURES, INC. P.O. BOX 1287,				

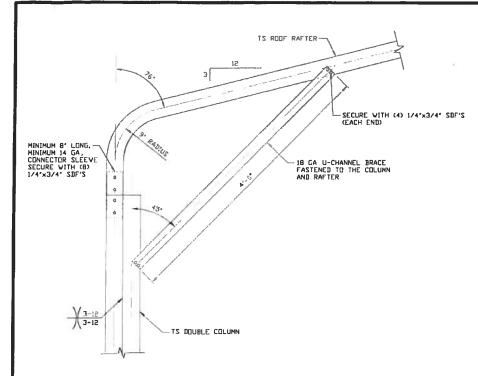


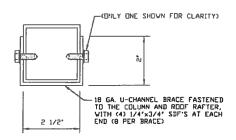

BRACE SECTION

SCALE: NTS

BOX EAVE RAFTER/CORNER POST CONNECTION DETAIL
FOR HEIGHTS 12'-0' < TO \( \) 16'-0'

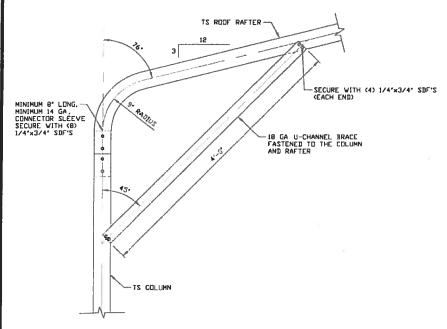

BOX EAVE RAFTER/CORNER POST CONNECTION DETAIL FOR HEIGHTS \( \) 12'-0'

MOORE AND ASSOCIATES

THIS DOCUMENT IS THE PROPERTY OF MODRE AND ASSISTATES ENGINEERING AND CONSULTING. THE UNAUTHORIZED REPREDUCTION, COPYING, OR DITHORYISE USE OF THIS DOCUMENT IS STRUCTLY PROMODED AND ANY INFRINGEMENT THEREUPON MAY BE SUBJECT TO LEGAL ACTION.


ENGINEERING AND CONSULTING, INC.

SCALE: NTS

1C

	DRAWN BY: AT		P.O. BOX 1287,			
		N	MOUNT AIRY, NC 27030			
.	CHECKED BY: PDH	30'-0"x20'-0" ENCLOSED STRUCTURE				
$\dashv$	PREJECT NGR VSN	DATE: 12-14-18	SCALE: NTS	JIDDB N	180685/ D 181565/182905	
			DWG. ND SK-		REVJ 7	

STEEL BUILDINGS AND STRUCTURES, INC.

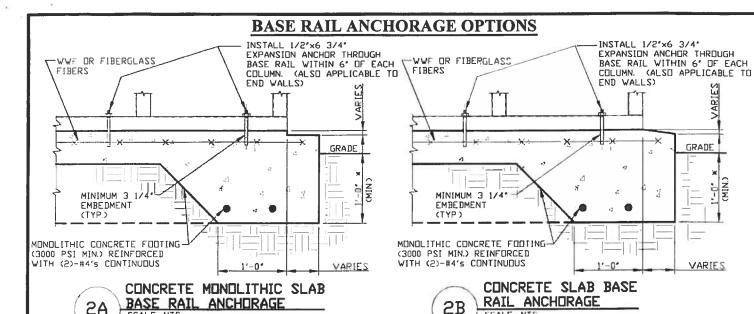

## GENERAL NOTES

NOTE: CONCRETE MONDLITHIC SLAB DESIGN BASED ON MINIMUM SDIL BEARING CAPACITY OF 1,500 PSF

MINIMUM ANCHOR EDGE DISTANCE IS 4" \* COORDINATE WITH LOCAL CODES/ORD.

CONCRETE SHALL HAVE A MINIMUM SPECIFIED COMPRESSIVE STRENGTH OF 3,000 PSI AT 28 DAYS.

### COVER OVER REINFORCING STEEL:

SCALE: NTS

FOR FOUNDATIONS, MINIMUM CONCRETE COVER OVER REINFORCING BARS SHALL BE PER ACI-318:

BARS SHALL BE FER ACI-SIO.

3' IN FOUNDATIONS WHERE THE CONCRETE IS CAST AGAINST AND PERMANENTLY IN CONTACT WITH THE EARTH OR EXPOSED TO THE EARTH OR WEATHER, AND 1 1/2' ELSEWHERE.

### REINFORCING STEEL:


THE TURNDOWN REINFORCING STEEL SHALL BE ASTM A615 GRADE THE SLAB REINFORCEMENT SHALL BE WELDED WIRE FABRIC MEETING ASTM A185 OR FIBERGLASS FIBER REINFÖRCEMENT.

### REINFORCEMENT MAY BE BENT IN THE SHOP OR THE FIELD PROVIDED

- 1. REINFORCEMENT IS BENT COLD.
  2. THE DIAMETER OF THE BEND, MEASURED ON THE INSIDE OF THE BAR, IS NOT LESS THAN SIX-BAR DIAMETERS.
- 3. REINFORCEMENT PARTIALLY EMBEDDED IN CONCRETE SHALL NOT BE FIFLD BENT.

### HELIX ANCHOR NOTES:

- FOR VERY DENSE AND/OR CEMENTED SANDS, COARSE GRAVEL AND COBBLES, CALICHE, PRELOADED SILTS AND CLAYS, USE MINIMUM (2) 4" HELICES WITH MINIMUM 30" EMBEDMENT OR SINGLE 6' HELIX WITH MINIMUM 50' EMBEDMENT
- FOR CORAL USE MINIMUM (2) 4' HELICES WITH MINIMUM 30' EMBEDMENT OR SINGLE 6' HELIX WITH MINIMUM 50' EMBEDMENT.
- 3. FOR MEDIUM DENSE COARSE SANDS, SANDY GRAVELS, VERY STIFF SILTS, AND CLAYS USE MINIMUM (2) 4" HELICES WITH MINIMUM 30 INCH EMBEDMENT OR SINGLE 6" HELIX WITH MINIMUM 50° EMBEDMENT.
- 4. FOR LODSE TO MEDIUM DENSE SANDS, FIRM TO STIFF CLAYS AND SILTS ALLUVIAL FILL, USE MINIMUM (2) 6° HELICES WITH MINIMUM
- 5. FOR VERY LOSE TO MEDIUM DENSE SANDS, FIRM TO STIFFER CLAYS AND SILTS, ALLUVIAL FILL, USE MINIMUM (2) 8' HELICES WITH MINIMUM 60' EMBEDMENT.

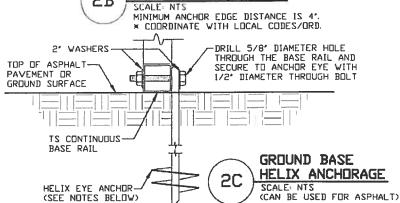

VARI

MIN

VARIES


GRADE

1

MOORE AND ASSOCIATES ENGINEERING AND CONSULTING, INC. THUS DUCLMENT IS THE PROPERTY OF HUDINE AND ASSOCIATES ENGINEERING AND CHRISLITIAN. THE UNAUTHORIZED REPRODUCTION, COPYING, OR OTHERWISE USE OF THUS ENGUNEET STRUCTLY PROMUNITIES AND ANY DEFRINGEMENT THERELIPON MAY BE SUBJECT TO LOUAL ACTION.


			DWG. ND SK-		REV. 7		
_	PREJECT NGR: VSN	DATE: 12-14-18	SCALE: NTS	JITTR N	18068\$/ D 18156\$/18290\$		
	CHECKED BY: PDH		10UNT AIRY, 1 0'-0" ENCLOSE				
	DRAWN BY: AT	P.O. BOX 1287,					

### BOX EAVE RAFTER END WALL AND SIDE WALL OPENINGS

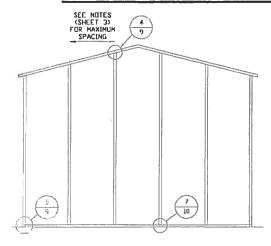


# TYPICAL BUX EAVE RAFTER END WALL FRAMING SECTION

SCALE: NTS

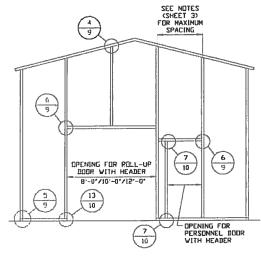

# TYPICAL BOX EAVE RAFTER END WALL OPENINGS FRAMING SECTION

SCALE: NTS

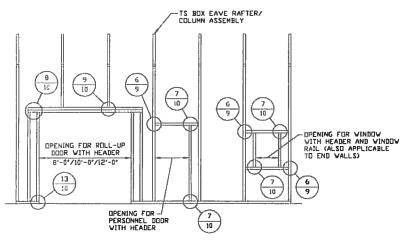

TYPICAL BOX EAVE RAFTER SIDE WALL OPENINGS FRAMING SECTION


SCALE: NTS

MOORE AND ASSOCIATES ENGINEERING AND CONSULTING, INC.

THIS EDUCATION IS THE PROPERTY OF HODRE AND ASSOCIATES ENGINEERING AND CONSELLIBRIC THE UNMATHORIZED REPRODUCTION, COPYRIGO, OR OTHERVISE USE OF THIS EDUCATION IS STRUCTLY PRODUCTED AND ANY DEPENDEERINT THERELIPON MAY BE SUBJECT TO LOGIAL ACTION.


### P.O. BOX 1287,  MOUNT AIRY, NC 27030  CHECKED BY: PDH 30'-0"x20'-0" ENCLOSED STRUCTURE  PROJECT MGR: VSM DATE 12-14-18 SCALE NTS JUB NO 161365/18290	CITEME CREE	SHT. 8	DVG ND SK-3 REV		REV. 7	
MOUNT AIRY, NC 27030	PROJECT MGR VSM	DATE: 12-14-18	SCALE: NTS	JDB	180685/ 2002905	
	CHECKED BY: PDH					
STEEL BUILDINGS AND STRUCTURES, INC.	DRAWN BY AT	P.O. BOX 1287,				

### BOX EAVE RAFTER END WALL AND SIDE WALL OPENINGS

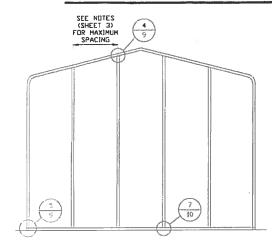


# TYPICAL BOX EAVE RAFTER END WALL FRAMING SECTION

SCALE: NTS

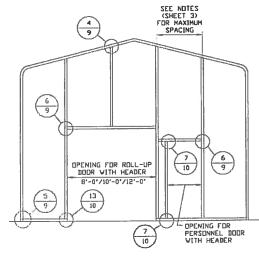

TYPICAL BOX EAVE RAFTER END WALL OPENINGS FRAMING SECTION

SCALE: NTS

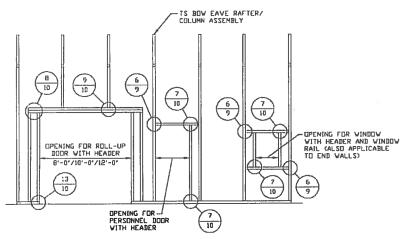


TYPICAL BOX EAVE RAFTER SIDE WALL OPENINGS FRAMING SECTION

SCALE: NTS


MOORE AND ASSOCIATES
ENGINEERING AND CONSULTING, INC.

THIS DECIMENT IS THE PROPERTY OF MEDIE AND ASSIGNATES ENGINEERING AND CONSULTING. THE UNAUTHORIZED REPRODUCTION, COPYING, OR DTHERVISE USE OF THIS EDCUMENT IS STRUCTLY PROPERTIES AND ANY DEPONDEMENT THEREUPON MAY BE SUBJECT TO LEGAL ACTION.

	CI TENTI: SRST	SHT. BA	JVG. NO SK-	3	REV. 7	
_	PREJECT NGO VSN	DATE: 12-14-18	SCALE) NTS	.00	18068\$/ @ 18156\$/18290\$	
	CHECKED BY: PDH	P.O. BOX 1287,  MOUNT AIRY, NC 27030  30'-0"x20'-0" ENCLOSED STRUCTURE				
	DRAVN BY: AT					
_		The state of the s	ENIMPS AND S	TIVE I	THIDES THE	

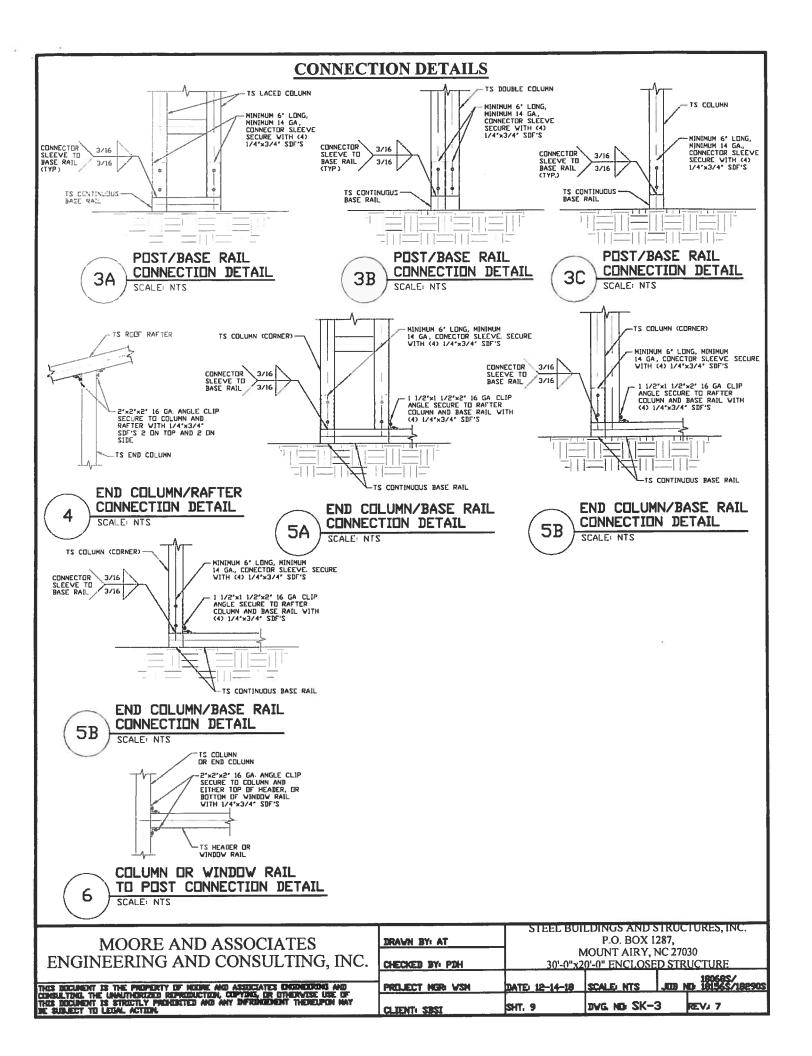

### **CONNECTION DETAILS**

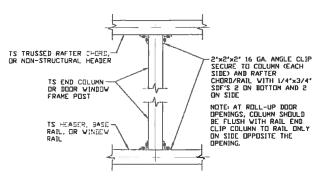

CONNECTOR 3/16

SLEEVE TO 3/16

TS DOUBLE HEADER

TS DOUBLE HEADER


MINIMUM 6' LONG, MINIMUM 14 GA, TS SLEEVE SECURE EACH WITH (4) 1/4'x3/4" SDF'S


TS COLUMN


7 COLUMN TO HEADER, BASE RAIL, OR WINDOW RAIL CONNECTION DETAIL

SCALE NTS

8 DOUBLE HEADER/COLUMN
CONNECTION DETAIL
SCALE NTS

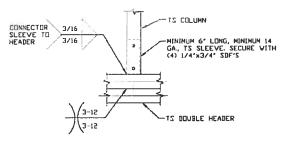

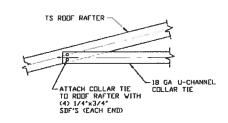


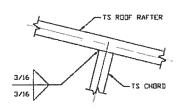


9 COLUMN/DOUBLE HEADER
CONNECTION DETAIL
SCALE NTS

10 COLLAR TIE CONNECTION DETAIL
SCALE: NTS

RAFTER TO CHORD CONNECTION DETAIL
SCALE NTS

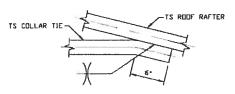

12 COLLAR TIE CONNECTION DETAIL
SCALE: NTS

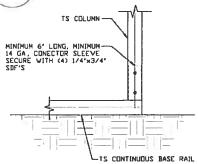


COLUMN/BASE RAIL
CONNECTION DETAIL
SCALE NTS

MOORE AND ASSOCIATES ENGINEERING AND CONSULTING, INC.

THIS EXCLUSION IS THE PROPERTY OF MODE AND ASSOCIATES ENGINEERING AND CONSULTING. THE UNMUTHORIZED REPRODUCTION, COPYING, OR OTHERWISE USE OF THIS EXCLUSION IS STRUCTLY PROBUSETED AND ANY DEFENDEMENT THERELIFON MAY BE SUBJECT TO LEGAL ACTUAL.


		DWG. ND: SK-3	REV. 7			
PROJECT NGR: VSN	DATE: 12-14-18	SCALE: NTS	JCB N	180685/ 18156\$/182905		
CHECKED BY: PDH		030 RUCTURE				
DRAWN BY: AT	P.O. BOX 1287.					

### **BOX EAVE RAFTER LEAN-TO OPTIONS**

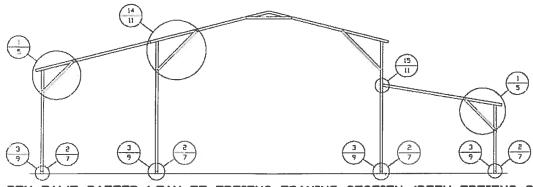


TYPICAL BOX EAVE RAFTER LEAN-TO OPTIONS FRAMING SECTION (BOTH OPTIONS SHOWN)

SCALE, NTS

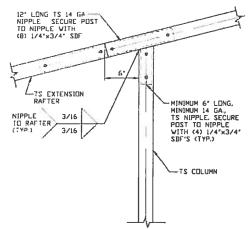

SIDE EXTENSION RAFTER/CURNER POST DETAIL
SCALE: NTS

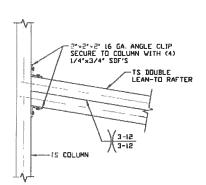

LEAN-TO RAFTER TO
RAFTER POST CONNECTION
DETAIL FOR WIDTHS
12'-0' < TO \( \) 16'-0'

15A

2'\*2'\*2' 16 GA. ANGLE CLIP SECURE TO COLUMN VITH (4) 1/4'\*3/4' SDF'S

TS LEAN-TO RAFTER

LEAN-TO RAFTER
TO RAFTER POST
CONNECTION DETAIL
FOR WIDTHS & 12'-0'

15B


MOORE AND ASSOCIATES ENGINEERING AND CONSULTING, INC.

THIS EXCLUDENT IS THE PROPERTY OF HOUSE AND ASSOCIATES ENGINEERING AND CHESIALTHIS. THE UNAUTHORIZED REPRODUCTION, CUPYING, UR OTHERWISE USE OF THIS EXCLUDENT IS STRUCTLY PROHIBITED AND ANY REPRODUCENT THEREUPON MAY BE SUBJECT TO LODAL ACTION.


STEEL BUILDINGS AND STRUCTURES, INC.
P.O. BOX 1287,
MOUNT AIRY, NC 27030
CHECKED BY: PDH 30'-0"x20'-0" ENCLOSED STRUCTURE

PRILECT MGB WSM DATE 12-14-19 SCALE NTS LIB ND 181365/18290S
CLIENT: SRSI SHT. 11 DWG. ND SK-3 REV. 7

### **BOW EAVE RAFTER LEAN-TO OPTIONS**

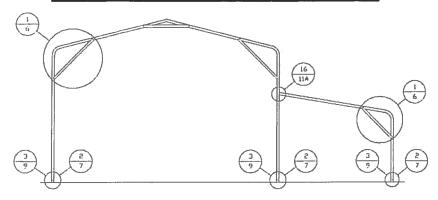


### TYPICAL BOW EAVE RAFTER LEAN-TO OPTIONS FRAMING SECTION

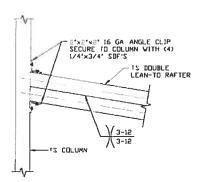

LEAN-TO RAFTER TO RAFTER POST CONNECTION DETAIL FOR WIDTHS
12'-0' < TO \( \) 16'-0'

SCALE NTS

16A

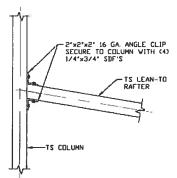


LEAN-TO RAFTER TO RAFTER POST CONNECTION DETAIL FOR WIDTHS & 12'-0"
SCALE: NTS

16B


MOORE AND ASSOCIATES ENGINEERING AND CONSULTING, INC.	DRAWN BY: AT: CHECKED BY: PDH	STEEL BUILDINGS AND STRUCTURES, INC. P.O. BOX 1287, MOUNT AIRY, NC 27030 30'-0"x20'-0" ENCLOSED STRUCTURE			
THUS SOCUMENT IS THE PROPERTY OF MODRE AND ASSOCIATES ENGINEERING AND CONSULTING THE UNAUTHORIZED REPRODUCTION, COPYING, OR OTHERWISE USE OF THES SOCIATION STRUCTURE AND ANY DEFINISHMENT THEREIPON MAY BE SUBJECT TO LOCAL ACTION.			SCALE NTS	JUD NO 181565/182905 3 REV, 7	

### BOX EAVE RAFTER VERTICAL ROOF/SIDING OPTION

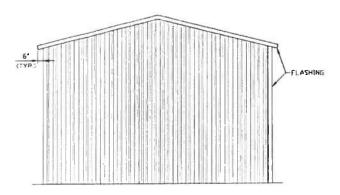


# TYPICAL END ELEVATION VERTICAL ROOF/SIDING

SCALE: NTS

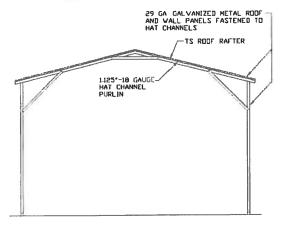

# TYPICAL SECTION VERTICAL ROOF/SIDING OPTION


SCALE: NTS

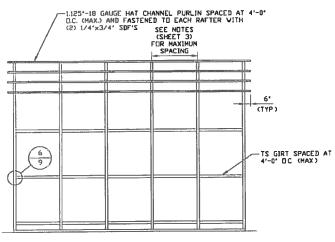

# 6. (TYP) FLASHING

# TYPICAL SIDE ELEVATION VERTICAL ROOF/SIDING

SCALE: NTS

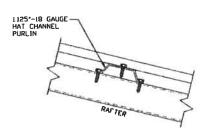


PANEL ATTACHMENT

(ALTERNATE FOR VERTICAL ROOF PANELS)
SCALE, NTS

TYPICAL FRAMING SECTION VERTICAL ROOF/SIDING OPTION SCALE: NTS

THIS DOCUMENT IS THE PROPERTY OF MODE AND ASSOCIATES ENGINEERING AND CONSIGNATION. THE UNAUTHORIZED REPRODUCTION, COPYDIG, OR OTHERWISE USE OF THIS DOCUMENT IS STRUCTLY PROMOBELED AND ANY INFROMEMENT THERESPIN MAY BE SUB-	CL TENTL SRST	SHT. 12	DVG. ND SK-	3 REVI 6A
THOS DOCUMENT IS THE PROPERTY OF NOONE AND ASSOCIATES ENGINEERING AND	PROJECT NGR VSN	DATE: 12-14-18	SCALE: NTS	\$289081 GM BELL
THE PRINCE AND CONCINETING DIC	CHECKED BY: PDH	MOUNT AIRY, NC 27030 30'-0"x20'-0" ENCLOSED STRUCTURE		
MOORE AND ASSOCIATES	DRAWN BYLAT		P.O. BOX 1	

# **OPTIONAL HEADER**

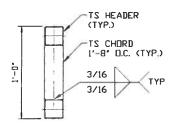


HEADER DETAIL FOR DOOR
OPENINGS 12'-0" < LENGTH < 20'-0"
SCALE: NTS

MOORE AND ASSOCIATES ENGINEERING AND CONSULTING, INC.


THE THE PROPERTY OF THE BUTHERTY HE METER AND AS	CHYATE'S EMERICATIONS AND
THE DECORAGE TO THE PROPERTY OF PERSONS AND THE	MODELLE MANAGEMENT AND
REPRESENTATIONS. THE UNMUTHEREZED REPRESENCED IN	THUL OR DIMERVALUE USE OF
THE THE BEST IS STREET Y BROWNITH AND ANY D	STREET, THE STREET, MAY
TIME DESCRIPTION OF STREET, LINE WAS ARE TO	d American (1985-sept set 1841)
THE DECEMENT IS THE PROPERTY OF NEIGHE AND AS CONSULTING. THE UMAINTHERIZED REPREDICTION, COPY THES DECEMENT IS STREETLY PROMINETED AND ANY D BE SUBJECT TO LEGAL ACTION.	

CLIENT: SBSI	sнт. 13	DAG" ND 2K-	3	REV. 7		
PROJECT HGR: VSH	DATE: 12-14-18	SCALE NTS	JED N	18068\$/ D 19156\$/18290\$		
CHECKED BY: PINH	30'-0"x20'-0" ENCLOSED STRUCTURE					
ZKATEN ZIVAI	MOUNT AIRY, NC 27030					
DRAWN BY AT	P.O. BOX 1287,					
	STEEL BUILDINGS AND STRUCTURES, INC.					


### ADDITIONAL BASE RAIL ANCHORAGE OPTION

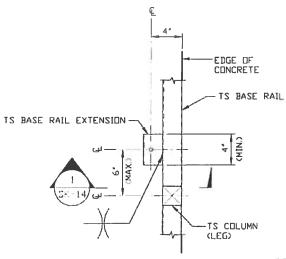


TYPICAL ANCHUR DETAIL WHEN BASE RAIL IS NEAR EDGE OF CONCRETE

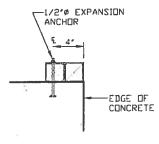

SECTION 1 SCALE: NTS SK-14

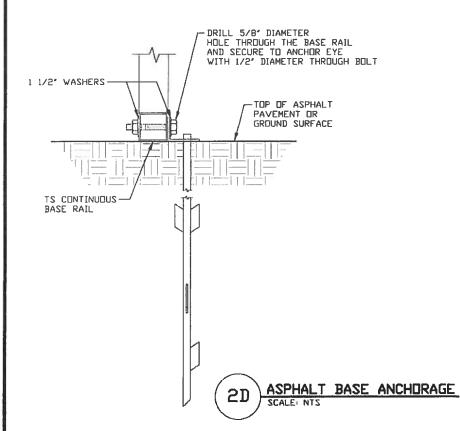



THE SCHOOL IS THE PROPERTY OF MEDIC AND ASSOCIATES ENGINEERING AND COMMUNITIES. THE UNANTHEREZED REPRODUCTION, COPYING, OR OTHERWISE USE OF THES EDUCURANT AS STRUCTLY PROPERTIES AND ANY INFRINGEMENT THERELIPON MAY BE SUBJECT TO LEGAL ACTION.		DATE: 12-14-18 SHT: 14	DVG ND SK-	
				JUB ND 180585/18290S
THE PREPARED AND CONTINUED IN DIS	CHECKED BY: PDH	1	10UNT AIRY, 1 10'-0" ENCLOSE	NC 27030 D STRUCTURE
MOORE AND ASSOCIATES	DRAVN BY: AT		P.O. BOX 1	

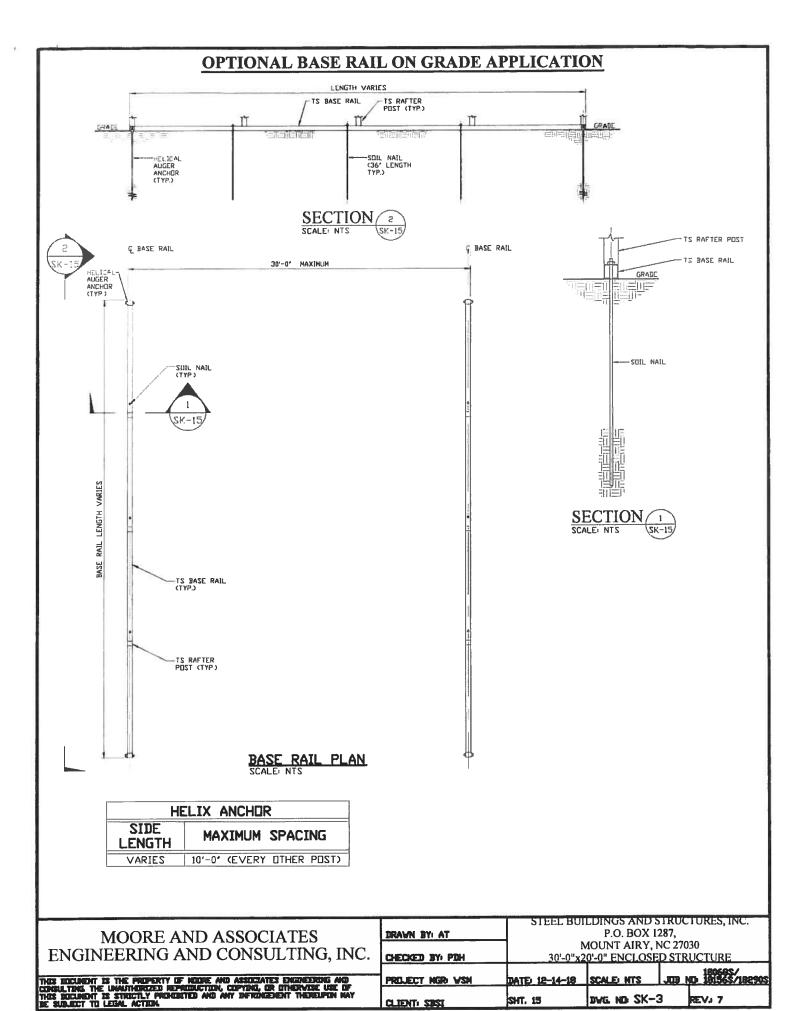

SHT. 15

CLIENT: SEST

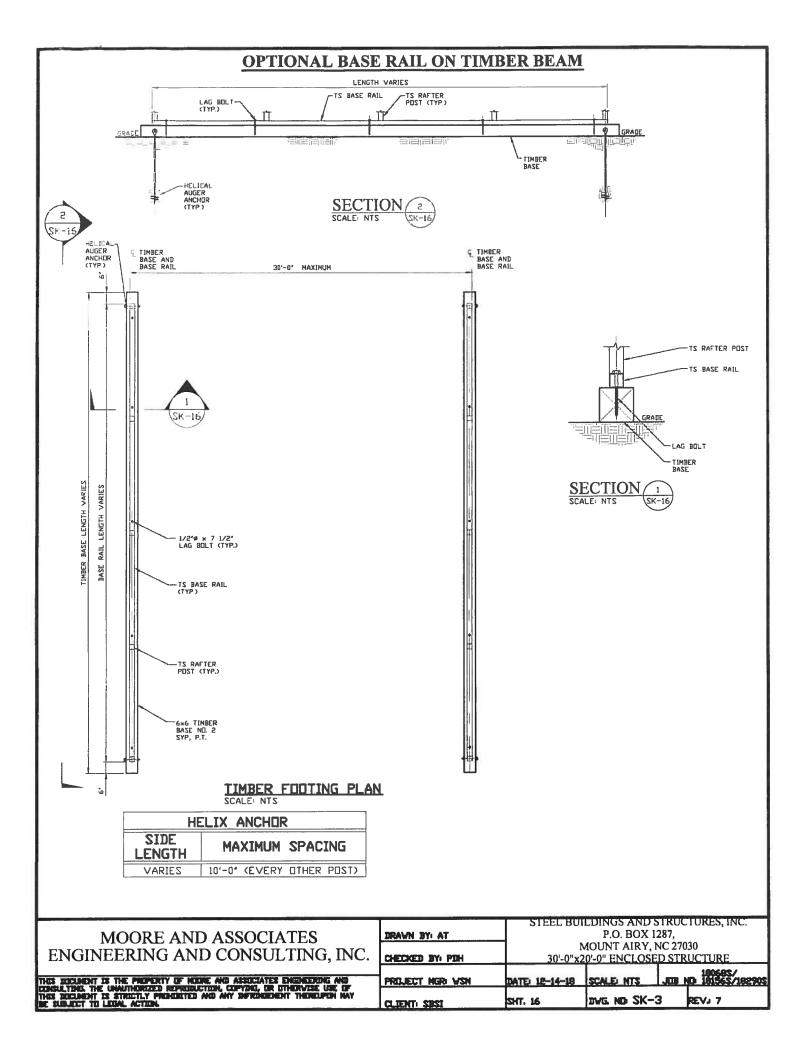

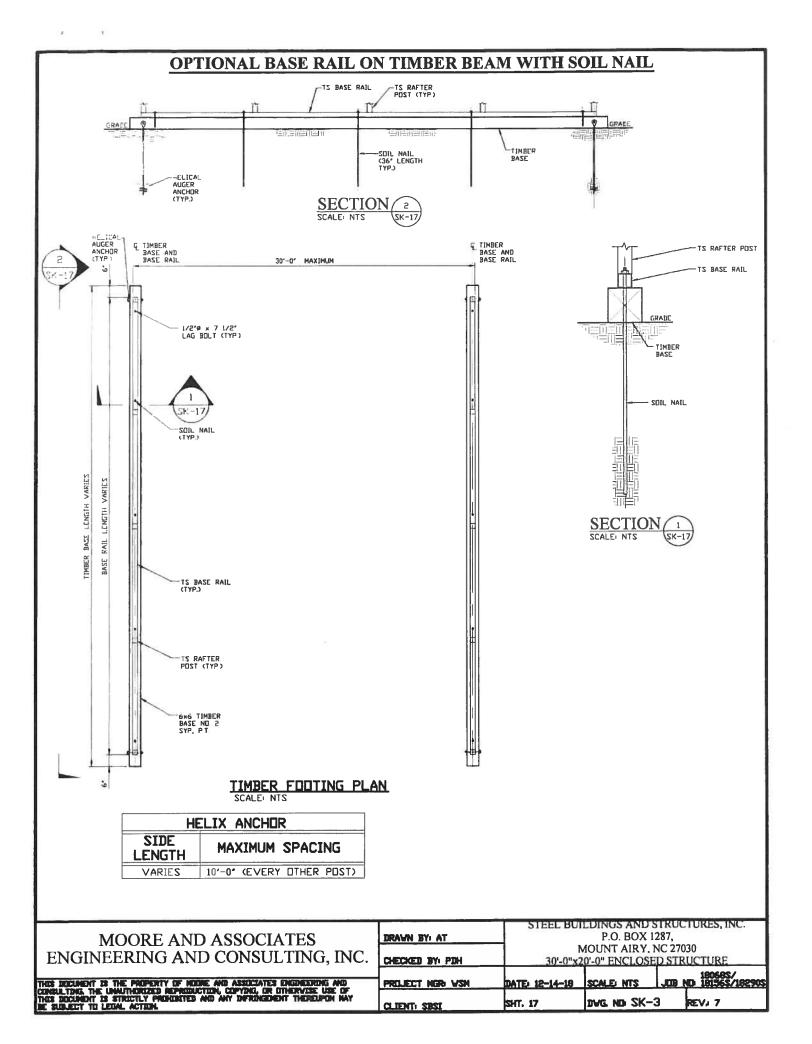

## **OPTIONAL CONCRETE STRIP FOOTING** & FOOTING AND BASE RAIL FODTING AND BASE RAIL 30'-0" MAXINUM LENGTH VARIES FODTING LENGTH VARIES 1/2'Ø EXPANSION ANCHOR (TYP.) RAIL BASE TS BASE RAIL TS RAFTER POST (TYP) CONCRETE STRIP FOOTING (3000 PSI MIN) CONCRETE STRIP FOOTING PLAN SCALE: NTS TS RAFTER POST TS BASE RAIL GRADE CHIR 2 84 T&B -INSTALL 1/2'x6 3/4' EXPANSION ANCHOR THROUGH BASE RAIL WITHIN 6' OF EACH COLUMN. MININUM 3 1/4' EMBEDMENT (TYP) 2º CLR C.R. SECTION (1 SCALE: NTS SK-18 \* COORDINATE WITH LOCAL CODES/ORD. STEEL BUILDINGS AND STRUCTURES, INC. MOORE AND ASSOCIATES P.O. BOX 1287, DRAWN BY AT MOUNT AIRY, NC 27030 ENGINEERING AND CONSULTING, INC. 30'-0"x20'-0" ENCLOSED STRUCTURE CHECKED BY: PDH 18068\$/ ND 18156\$/18290\$ THIS INCLINENT IS THE PROPERTY OF HOOSE AND ASSOCIATES ENGINEERING AND CONSULTING. THE UNMUTHORIZED REPRODUCTION, COPYING, OR OTHERVISE USE OF THES DECUMENT IS STRUCTLY PROMOBERED AND ANY INFRINGEMENT THEREUPON MAY BE SUBJECT TO LEGAL ACTION. PROJECT NGR VSH DATE: 12-14-18 SCALE: NTS DVG. ND SK-3 REV. 7 SHT. 18 CLIENT: SESI