

SCOTT'S GUNSMITHING

SCOTT & TAMMY CREWS


4201 S US HWY 441 LAKE CITY, FL. 32025

SITE DATA

APPLICABLE CODES:
2004 FLORIDA BUILDING CODE, BUILDING W/2006 REVISIONS
2004 FLORIDA BUILDING CODE, FUEL GAS W/2006 REVISIONS
2004 FLORIDA BUILDING CODE, MECHANICAL W/2006 REVISIONS
2004 FLORIDA BUILDING CODE, PLUMBING W/2006 REVISIONS
2004 FLORIDA FIRE PREVENTION CODE
2005 NATIONAL ELECTRIC CODE.

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PLANS PREPARED FOR:

SCOTT'S GUNSMITHING SCOTT & TAMMY CREWS 4201 S US HWY 441 LAKE CITY, FL. 32025

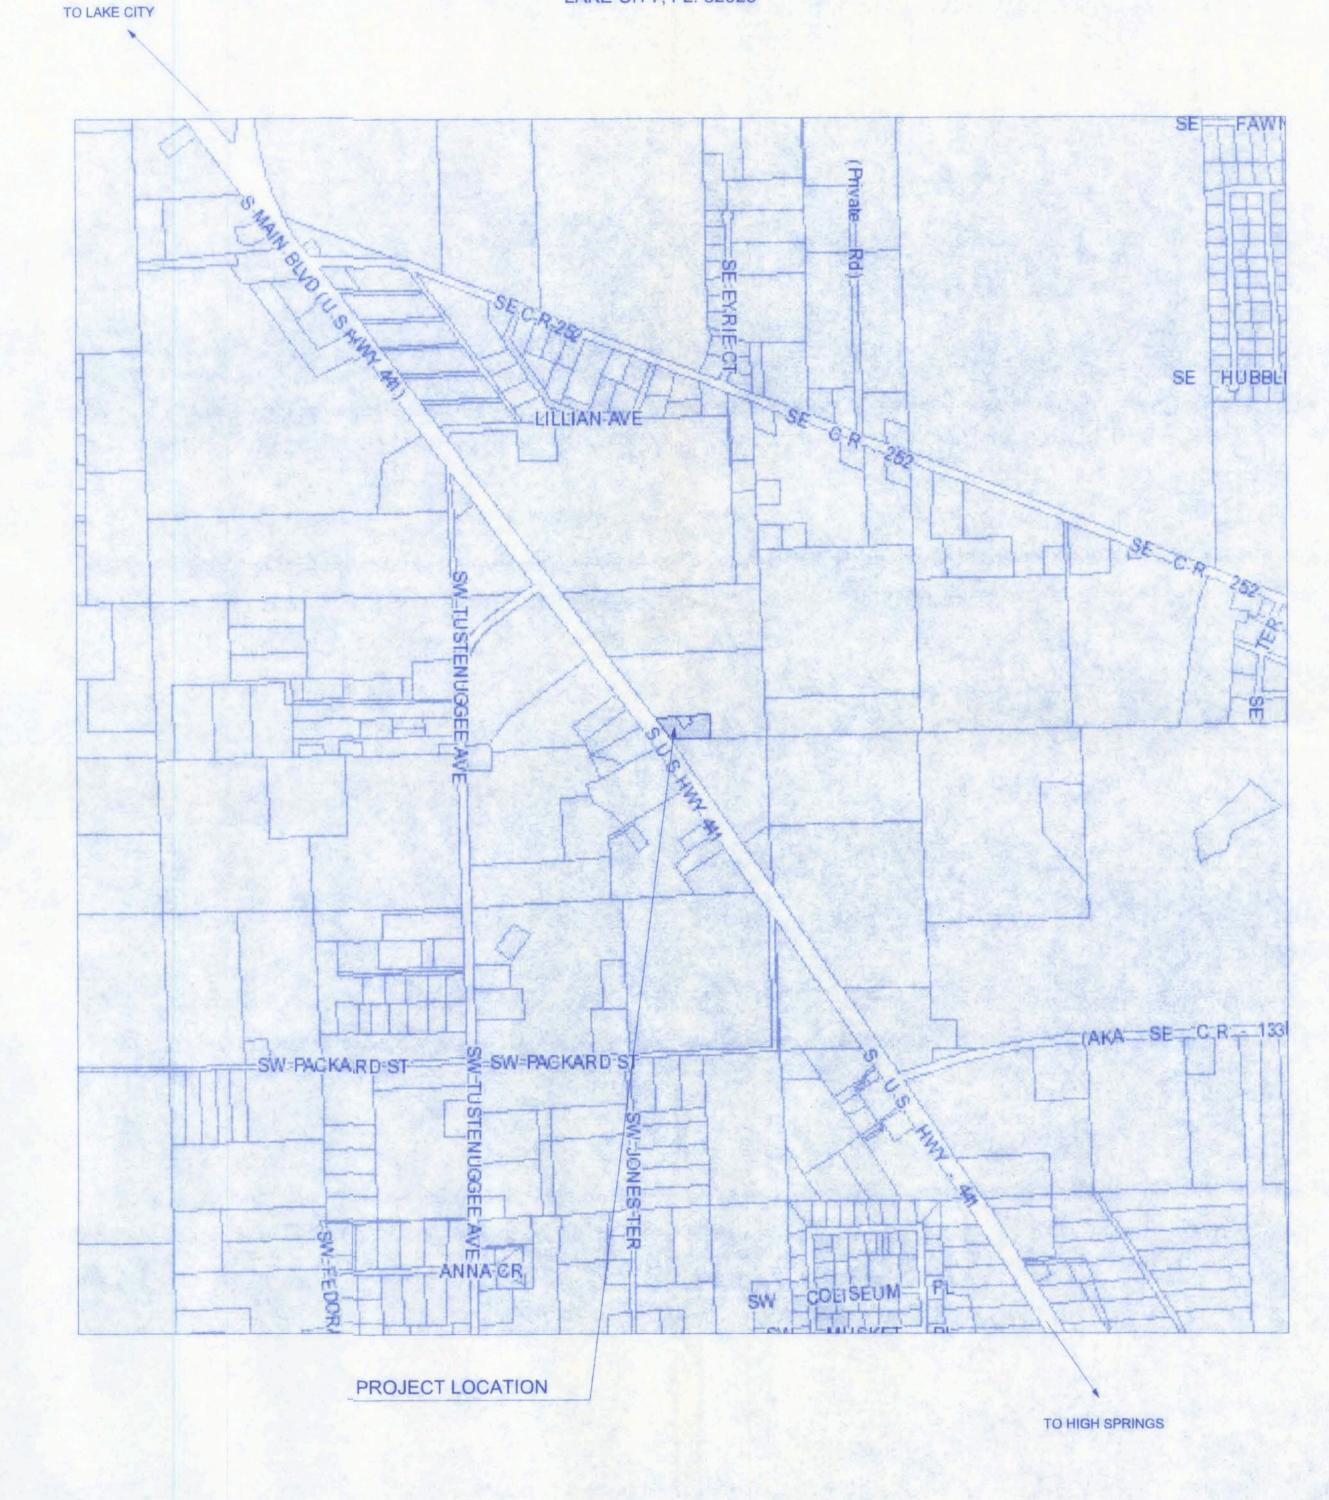PLANS PREPARED BY:



VICINITY MAP

1) Aller H. Fr. 9/2 2/07 P.E. 56001

GENERAL NOTES

DESIGN CRITERIA

ALL WORK SHALL CONFORM TO AT LEAST THE MINIMUM STANDARD OF THE FOLLOWING CODES:
2004 FLORIDA BUILDING CODE, BUILDING w/2006 REVISIONS
2004 FLORIDA BUILDING CODE, FUEL GAS w/2006 REVISIONS
2004 FLORIDA BUILDING CODE, MECHANICAL w/2006 REVISIONS
2004 FLORIDA BUILDING CODE, PLUMBING w/2006 REVISIONS
2004 FLORIDA FIRE PREVENTION CODE
2005 NATIONAL ELECTRIC CODE.

D2 DESIGN LOAD VALUES:

FLOOR LIVE LOADS

LOBBIES & CORRIDORS

OFFICES

FLOOR DEAD LOADS

ASSUMED ALLOWABLE SOIL BEARING CAPACITY

100 PSF

50 PSF

20 PSF

2000 PSF

D3 THE STRUCTURAL PLANS AND WIND SPEED HAVE BEEN
DESIGNED IN ACCORDANCE WITH SECTION 1609 OF THE FLORIDA BUILDING CODE
2004 EDITION.

GENERAL

- THE GENERAL CONTRACTOR SHALL REVIEW AND DETERMINE
 THAT DIMENSIONS ARE COORDINATED BETWEEN ARCHITECTURAL
 AND STRUCTURAL DRAWINGS PRIOR TO FABRICATION OR
 START OF CONSTRUCTION.
- THE GENERAL CONTRACTOR SHALL PROVIDE ALL MEASURES'
 NECESSARY TO PROTECT THE STRUCTURE, THE WORK PERSONS,
 AND OTHER PEOPLE DURING CONSTRUCTION. HE SHALL
 SUPERVISE AND DIRECT THE WORK AND BE RESPONSIBLE FOR
 ALL CONSTRUCTION & FOR ALL JOBSITE SAFETY.
- G3 NO STRUCTURAL MEMBER SHALL BE CUT NOTCHED OR OTHERWISE REDUCED IN STRENGTH.
- THE GENERAL CONTRACTOR SHALL COORDINATE ARCHITECTURAL,
 MECHANICAL, AND ELECTRICAL DRAWINGS FOR ANCHORED,
 EMBEDDED AND SUPPORTED ITEMS WHICH AFFECT THE STRUCTURAL
 DRAWINGS AND NOTIFY THE ARCHITECT/ENGINEER ON ANY
 DISCREPANCIES
- G5 ANY SUBMITTALS RECEIVED BY A/E THAT HAVE NOT BEEN CHECKED BY THE GC AND HIS SUBCONTRACTOR SHALL BE RETURNED WITHOUT REVIEW.
- G6 ALL SECTIONS AND DETAILS SHALL BE CONSTRUED TO BE
 TYPICAL OR SIMILAR UNLESS ANOTHER SECTION OR DETAIL
 IS NOTED.
- THE CONTRACTOR IS SOLELY RESPONSIBLE FOR VERIFYING ALL EXISTING CONDITIONS, ELEVATIONS, AND DIMENSIONS PRIOR TO COMMENCING CONSTRUCTION, INCLUDING FABRICATION. ALL DISCREPANCIES SHALL BE REPORTED TO THE A/E FOR RESOLUTION.

FOUNDATIONS

- A GEOTECHNICAL REPORT FOR THIS PROJECT WAS NOT PROVIDED BY THE OWNER.
 THESE PLANS ARE BASED UPON AN ASSUMED ALLOWABLE BEARING CAPACITY
 OF 2000 PSF. THE CONTRACTOR SHALL ENGAGE A QUALIFIED AND CERTIFIED
 GEOTECHNICAL ENGINEER TO DETERMINE THE ALLOWABLE SOIL BEARING CAPACITY.
 A COPY OF THE REPORT SHALL BE PROVIDED TO THE A/E. IF THE DETERMINED
 ALLOWABLE BEARING CAPACITY IS LESS THAN THE ASSUMED VALUE, MODIFICATIONS
 TO THE FOUNDATIONS MAY BE REQUIRED.
- THE GEOTECHNICAL ENGINEER SHALL MAKE A FIELD INVESTIGATION TO DETERMINE IF ANY SOIL CONDITIONS ARE PRESENT THAT MAY ADVERSELY AFFECT THE PROJECT. THE CONTRACTOR SHALL REMOVE ALL SUCH MATERIAL AND REPLACE IT WITH APPROVED FILL.
- SUBGRADE UNDER FOOTINGS AND SLABS SHALL BE COMPACTED TO AT LEAST 95% OF THE MODIFIED PROCTOR MAXMIMUM DRY DENSITY (ASTM D1557). SUBMIT DENSITY TESTS TO THE A/E.

SLABS ON GRADE

- S1 PROVIDE 6 MIL POLYETHYLENE SHEETING UNDER ALL SLABS ON GRADE.
- PROVIDE CONTROL JOINTS (1/4" WIDE BY 1 1/2" DEEP) AS INDICATED ON PLAN. FILL JOINTS WITH POURED RUBBER. IF JOINTS ARE SAWCUT, SAWCUTTING MUST BE DONE THE SAME DAY THE CONCRETE IS PLACED.
- PROVIDE 1/2" EXPANSION JOINTS AT ALL LOCATIONS WHERE SLABS
 ABUT STRUCTURES (WALLS, COLUMNS, ETC.)

CONCRETE AND REINFORCING

- THE GENERAL CONTRACTOR SHALL ENGAGE A CERTIFIED TESTING AGENCY TO PERFORM INDUSTRY STANDARD TESTING INCLUDING SLUMP TESTS AND CYLINDER BREAKS TO ENSURE CONFORMANCE WITH PLANS. SUBMIT REPORTS TO A/E.
- C2 CONCRETE WORK & MIX DESIGN SHALL CONFORM TO ACI 301 (LATEST EDITION)
 "SPECIFICATIONS FOR STRUCTURAL CONCRETE FOR BUILDINGS".
 MIXING SHALL BE IN ACCORDANCE WITH ASTM C94
- C3 MINIMUM 28-DAY COMPRESSIVE STRENGTH:

 FOOTINGS AND TIE BEAMS:

 COLUMNS AND SLABS:

 3,000 PSI
 3,000 PSI
- C4 SPLICES OF REINFORCING (EXCEPT AS SHOWN ON PLANS)

 #4 BARS

 #5 BARS

 WELDED WIRE MESH:

 20 INCHES

 27 INCHES

 6"
- C5 AT ALL CORNERS OF TIE BEAMS AND WALL FOOTINGS, PROVIDE CORNER BARS (30 INCH MINIMUM LEGS) TO MATCH HORIZONTAL BARS.
- C6 REINFORCING BARS SHALL CONFORM TO ASTM A615-96a GRADE 60.
 WELDED WIRE MESH SHALL CONFORM TO ASTM A-185. LAP WELDED
 WIRE MESH ON MESH + 2" WHERE SPLICED.
- C7 MINIMUM COVER FOR REINFORCING SHALL BE AS FOLLOWS UNLESS OTHEWISE NOTED.

	LOCATION	MIN. COVER
	SOTTOM OF FOOTINGS.	3"
C	COLUMNS	1 1/2" 1 1/2"
	SLABS	AS NOTED

MASONRY

MASONRY CONSTRUCTION SHALL CONFORM TO ACI STANDARD BUILDING CODE REQUIREMENTS FOR CONCRETE MASONRY STRUCTURES (ACI 530-88/ASCE 5-88)
AND SPECIFICATIONS FOR MASONRY STRUCTURES (ACI 530.1-88/ASCE 6-88)

NOTE:
ALL WIND LOADS ARE IN ACCORDANCE WITH SECTION
1609, FLORIDA BUILDING CODE, 2004 EDITION, AND IN
ACCORDANCE WITH ASCE-7

BASIC WIND SPEED		110 MPH
IMPORTANCE FACTOR		1.0
BUILDING CATEGORY		2
EXPOSURE	В	
INTERNAL PRESSURE COEFFICIENT		+/- 0.18
COMPONENT AND CLADDING PRESSURE	WALLS	+21.8/-29.1 PSF
	ROOF	+12.5/-29.1 PSF
	OVERHANGS	-71.6 PSF
TYPE OF STRUCTURE		ENCLOSED
ROOF DEAD LOAD		10 psf
ROOF LIVE LOAD	Last The	20 psf
FLOOR DEAD LOAD	Falls.	20 psf

ALLOWABLE DEFLECTION OF STRUCTURAL MEMBERS

FLOOR LIVE LOAD

40 psf

STRUCTURAL MEMBER	ALLOWABLE
rafters having slopes greater than 2/12 with no finished ceiling attached to rafters	L/180
interior walls and partitions	H/180
floors and plastered ceilings	L/360
all other structural members	L/240
exterior walls with plaster or stucco finish	H/360
exterior walls - wind loads with brittle finishes	L/240
exterior walls - wind loads with flexible finishes	L/120

AN APPROVED INDEPENDENT TESTING LABORATORY, AND BEAR AN AAMA OR WDMA OR OTHER APPROVED LABEL IDENTIFYING THE MANUFACTURER, PERFORMANCE CHARACTERISTICS AND APPROVED PRODUCT EVALUATION ENTITY TO INDICATE COMPLIANCE WITH THE REQUIREMENTS OF THE FOLLOWING SPECIFICATION:

ANSI/AAMA/NWWDA 101/IS2 2/97

THE CONSTRUCTION SHALL BE TESTED IN ACCORDANCE WITH ASTM E 330, STANDARD TEST METHODS FOR STRUCTURAL PERFORMANCE OF EXTERIOR WINDOWS, CURTAIN WALLS, AND DOORS BY UNIFORM STATIC AIR PRESSURE.

BUILDING GROUP OCCUPANCY		GROUP F-1
TABLE 503 TYPE OF CONSTRUCTION		TYPE HI B
TABLE 503 AREA/HEIGHT LIMITATIONS		12.0 KSF/2 STORY
OCCUPANCY DEER PROCESSING SHOP		

BUILDING GROUP OCCUPANCY	GROUP M
TABLE 503 TYPE OF CONSTRUCTION	TYPE III B
TABLE 503 AREA/HEIGHT LIMITATIONS	12.5 KSF/4 STORY
OCCUPANCY SCOTT'S GUNSMITHING	

AREA SUMMARY:

MERCANTILE (M) LOWER 2338 SF
MERCANTILE (M) UPPER 486 SF
FACTORY (F-1) 1162 SF

TOTAL AREA 3986 SF

NOTE:
provide a readily visible sign on or adjacent
to all egress doors stating: THIS EXIT TO
REMAIN UNLOCKED WHEN THIS BUILDING
IS OCCUPIED. the sign shall have 1" lettering
with contrasting background.

NOTE: SINCE THE OCCUPANT LOAD IS LESS THAN 50, & THE TRAVEL DISTANCE IS LESS THAN 75 FEET, 1-HR CORRIDORS ARE NOT REQUIRED.

FLOOR PLAN
SCALE: 1/4" = 1'-0"

58'-0"

70'-0"

70'-0"

15'-6"

3 HR FIRE

RESTROOM

2 1/2-HR FIRE

3-COMPARTMENT

SINK

CONC. WALKIWAY

RATEID DOOR

4" FLOOR

5' MIN. CLEARANCE

RATED WALL

50'-0"

GUN REPAIR ROOM 8' CLG.

MAX. TRAVEL DISTANCE = 52'

GLASS DISPLAY

TYPICAL 2x4 WALL:

TAPED & SANDED 2x4 STUDS @ 16" o.c.

TAPED & SANDED

10' HIGH TOP PLATE

1/2" DRYWALL

1/2" DRYWALL

CASES

31'-1 1/4"

3/4" hour rated door -

with self closure

TYPICAL 1 HR 2x4 FIRERATED WALL: 5/8" TYPE 'X' FIRERATED DRYWALL

5/8" TYPE 'X' FIRERATED DRYWALL

M

TAPED & SANDED 2x4 STUDS @ 16" o.c.

TAPED & SANDED

45'-4 3/4"

GUNSHOP OPEN CLG. 25'-0"

3/4" hour rated door -

with self closure

2x6 FRAMING -

CASES

UNDER CABINETS

& GLASS DISPLAY

EGRESS CAPACITY:

GLASS DISPLAY
CASES

2x6 FRAMING-UNDER CABINETS

CASES

EGRESS CAPACITY:

34"/0.2 = 170 PERSONS

& GLASS DISPLAY

6'-0" SECTION

GLASS DISPLAY

CASES F = =

12'-0"

OF CABINETS

70"/0.2 = 350 RERSONS

BICLG.

20'-0"

22'-0 3/4"

UNCONDITIONED

UNCONDITIONED

⊕ 4" FLOOR DRAIN

1/2" DRYWALL

1/2" DRYWALL

TAPED & SANDED

TAPED & SANDED

10' HIGH TOP PLATE

2x4 STUDS @ 16" o.c.

W/STRAINER

-TYPICAL 2x4 WALL: 3 HR FIRE -

RATED WALL

WALK-IN

FREEZER

8' CLG. 17'-6 3/4"

ductless mini-split

8' CLG.

heat pump wall

mounted

EGRESS GAPACITY:

46"/0.2 = 230 PERSONS

5'-0"

5'-0"

EGRESS CAPACITY:

34"/0.2 = 170 PERSONS

17'-6"

Freeman Suite #102 Suite #102 Design Group inc (386)758-420

DATE DRAWN BY
9/21/07 W.H.F.
REVISIONS

SHEET A-2

PROJECT NO. 07.C035

Freeman
Design Group inc

DATE DRAWN BY 9/21/07 W.H.F. REVISIONS

PROJECT NO. 07.C035

70'-0" 20'-0" 50'-0" 17'-6" 5'-0" 15'-6" 25'-0" EGRESS CAPACITY: 34"/0.2 = 170 PERSONS EGRESS CAPACITY: 70"/0.2 = 350 PERSONS 3 HR FIRE RATED WALL STORAGE SMOKE ROOM OPEN CLG. STOCK ROOM 8' CLG. 8' CLG. 22'-0 3/4" 31'-1 1/4" 14'-0" ⊕- 4" FLOOR DRAIN -- --_ UNCONDITIONED (MAX. TRAVEL DISTANCE = 52' UNCONDITIONED WALK-IN 5' MIN. CLEARANCE 4" FLOOR DRAIN 2x6 FRAMING GLASS DISPLAY——CASES UNDER CABINETS & GLASS DISPLAY CASES GLASS DISPLAY CASES | | | | | | | | COOLER 8' CLG. 17'-6 3/4" 45'-4 3/4" - UNCONDITIONED GUNSHOP OPEN CLG. 2x6 FRAMING-UNDER CABINETS & GLASS DISPLAY CASES heat pump wall 2 1/2-HR FIRE 5'-0" RATED DOOR ⊕ 4" FLOOR DRAIN W/STRAINER -3-COMPARTMENT 6'-0" SECTION OF CABINETS EGRESS CAPACITY: 46"/0.2 = 230 PERSONS TYPICAL 2x4 WALL: 1/2" DRYWALL TYPICAL 2x4 WALL: 3 HR FIRE TAPED & SANDED 1/2" DRYWALL RATED WALL 2x4 STUDS @ 16" o.c. TAPED & SANDED 1/2" DRYWALL 2x4 STUDS @ 16" o.c. TAPED & SANDED GLASS DISPLAY 1/2" DRYWALL 10' HIGH TOP PLATE TAPED & SANDED 10' HIGH TOP PLATE EGRESS CAPACITY: CASES 34"/0.2 = 170 PERSONS CONC. WALKWAY

FLOOR PLAN SCALE: 1/4" = 1'-0"

583'-0"

70'-0"

EXTERIOR WINDOWS AND GLASS DOORS SHALL BE TESTED BY AN APPROVED INDEPENDENT TESTING LABORATORY, AND BEAR AN AAMA OR WDMA OR OTHER APPROVED LABEL IDENTIFYING THE MANUFACTURER, PERFORMANCE CHARACTERISTICS AND APPROVED PRODUCT EVALUATION ENTITY TO INDICATE COMPLIANCE WITH THE REQUIREMENTS OF THE FOLLOWING SPECIFICATION:

ANSI/AAMA/NWWDA 101/IS2 2/97

THE CONSTRUCTION SHALL BE TESTED IN ACCORDANCE WITH ASTM E 330, STANDARD TEST METHODS FOR STRUCTURAL PERFORMANCE OF EXTERIOR WINDOWS, CURTAIN WALLS, AND DOORS BY UNIFORM STATIC AIR PRESSURE.

BUILDING GROUP OCC	CUPANCY	GROUP F-1
TABLE 503 TYPE OF C	ONSTRUCTION	TYPE III B
TABLE 503 AREA/HEIGHT LIMITATIONS		12.0 KSF/2 STOR
OCCUPANCY	DEER PROCESSIN	IG SHOP
OCCUPANCY LOAD CAPACITY:	DEER PROCESSIN	IG SHOP

BUILDING GROUP OCCUPANCY	GROUP M
TABLE 503 TYPE OF CONSTRUCTION	TYPE III B
TABLE 503 AREA/HEIGHT LIMITATIONS	12.5 KSF/4 STORY
OCCUPANCY SCOTT'S GUNSMITHING	
LOAD CAPACITY: 60/GROSS = 2,260 SF/60 = 37.67 100/GROSS = 450 SF/100 = 4.5 SF	43 OCCUPANTS

AREA SUMMARY:	
MERCANTILE (M) LOWER	2338 SF
MERCANTILE (M) UPPER	486 SF
FACTORY (F-1)	1162 SF
TOTAL AREA	3986 SF

NOTE: provide a readily visible sign on or adjacent to all egress doors stating: THIS EXIT TO REMAIN UNLOCKED WHEN THIS BUILDING IS OCCUPIED. the sign shall have 1" lettering with contrasting background.

12'-0"

SINCE THE OCCUPANT LOAD IS LESS THAN 50, & THE TRAVEL DISTANCE IS LESS THAN 75 FEET, 1-HR CORRIDORS ARE NOT REQUIRED.

DATE DRAWN B W.H.F.

REVISIONS

SHEET A-3

OF 12

PROJECT NO. 07.C035

DEFICE
TO DOT UP

STOLE

WINDOW SCHEDULE:

70'-0"

DESCRIPTION	SIZE	COUNT
72X30 ONE-WAY	6'-0" x 2'-6"	1

DOOR SHEDULE: SEE SHEET A-12

INTERIOR BRG. WALL DETAIL

SEE FOUNDATION PLANS FOR DETAILS

LIFE SAFETY NOTES

TOP PLATE

2x4 STUDS @ -16" O.C. MAX.

ALL EXIT AND EMERGENCY LIGHTING SHALL BE INSTALLED PER NEC 700-12, 2001 EDITION.

ACCESS TO EXITS SHALL BE MARKED BY APPROVED READILY VISIBLE SIGNS IN ALL CASES WHERE THE EXIT OR WAY TO REACH THE EXIT IS NOT READILY APPARENT TO THE OCCUPANTS. SIGN PLACEMENT SHALL BE SUCH THAT NO POINT IN THE EXIT ACCESS CORRIDOR IS MORE THAN 100 FT FROM THE NEAREST EXTERNALLY ILLUMINATED SIGN AND IS NOT IN EXCESS OT THE MARKED RATING FOR INTERNALLY ILLUMINATED SIGNS.

ALL FIRE EXTINGUISHERS SHALL BE TYPE 20AB AND SHALL BE LOCATED SO THAT NO POINT IN THE DIRECTION OF TRAVEL FROM ANY POINT IS MORE THAN 75 FT TO THE FIRE EXTINGUISHER.

STAIR INFO:

STAIR SPECIFICATIONS:
WIDTH = 3'-4"
STAIR RUN = 13'-9"

STAIR RUN = 13'-9" STAIR RISE = 9'-0" 16 RISERS @ 6 3/4" 15 TREADS @ 11"

24" <= 2R + 1T <= 25" 24" <= 2(6.75") + 11" <= 25" 24" <= 24.5" <= 25"

UPPER FLOOR PLAN
SCALE: 1/4" = 1'-0"

22'-0 3/4"/

System No. W-L-1001

Wall Assembly - The 1, 2, 3, or 4 hr fire-rated gypsum wallboard/stud wall assembly shall be constructed of the materials and in the manner described in Section 709 FBC 2001 edition and shall include the following construction features:

A. Studs - wall framing may consist of either wood studs (max. 2 h fire rated assemblies) or steel channel studs. Wood studs to consist of nom. 2x4 in. lumber and end plates and cross braces. Steel studs to be min. 3-5/8 in. wide by 1-3/8 in. deep channels spaced max. 24" o.c.

B. Gypsum Board - Nom. 1/2" or 5/8" thick, 4 ft. wide with square or tapered edges. The gypsum wall board type, thickness, number of layers, fastener type and sheet orientation shall be as specified in the individual U300 or U400 Series Design in the UL Fire Resistance Directory. Max. diameter of opening is 26 in.

2. Through Penetrant - One metallic pipe, conduit or tubing installed either concentrically or eccentrically within the firestop system. The annular space between pipe, conduit or tubing and periphery of opening shall be min. of 0 in. (point contact) to max. 2 in. Pipe, conduit or tubing to be rigidly supported on both sides of wall assembly. The following types of sizes and metallic pipes, conduits or tubing may be used:

A. Steel Pipe - Nom. 24 in. diam (or smaller) Schedule 10 (or heavier) Steel Pipe.

B. Iron Pipe - Nom. 24 in. diam. (or smaller) service weight (or heavier) cast iron soil pipe, nom 12 in. diam. (or smaller) or Class 50 (or heavier) ductile iron pipe.

C. Conduit - Nom. 6 in. diam (or smaller) steel conduit or nom. 4 in. diam. (or smaller) steel electrical metallic tubing.

D. Copper Tubing - Nom. 6 in diam (or smaller) Type L (or heavier) copper pipe.

E. Copper Pipe - Nom. 6 in. diam (or smaller) Regular (or heavier) copper pipe.

F. Through Penetration Product - Flexible Metal Piping the following types of steel flexible metal gas piping may be used:
1. Nom 2 in. diam. (or smaller) steel flexible metal gas piping. Plastic covering on piping may or may not be removed on both sides of floor or wall assembly.

OMEGA FLEX INC.

TITE FLEX CORP.

Nom. 1 in. diam (or smaller) steel flexible metal gas piping. Plastic covering on piping may or may not be removed on both sides of floor or wall assembly.


A BUNDY CO

Nom. 1 in. diam (or smaller) steel flexible metal gas piping. Plastic covering may or may not be removed on both sides of floor or wall assembly.

WARD MFG INC


3. Fill, Void or Cavity Material - Caulk or Sealant - Min 5/8. 1-1/4, 1-7/8 and 2-1/2 in thickness of caulk for 1,2,3 and 4 hr rated assemblies, respectively, applied within annulus, flush with both surfaces of wall. Min 1/4 in diam bead of caulk applied to gypsum board/penetrant interface at point of contact location on both sides of wall. The hourly F rating of the firestop is dependent upon the hourly fire rating of the wall assembly in which it is installed, as shown in the following table. The hourly T rating of the firestop system is dependent upon the type or size of the pipe or conduit and the hourly fire rating of the wall assembly in which it is installed, as tabulated below:

Max. Pipe or Conduit Diam. in.	F Rating Hr.	T Rating Hr.
1	1 or 2	0+, 1 or 2
1	3 or 4	3 or 4
4	1 or 2	0
6	3 or 4	0
12	1 or 2	0

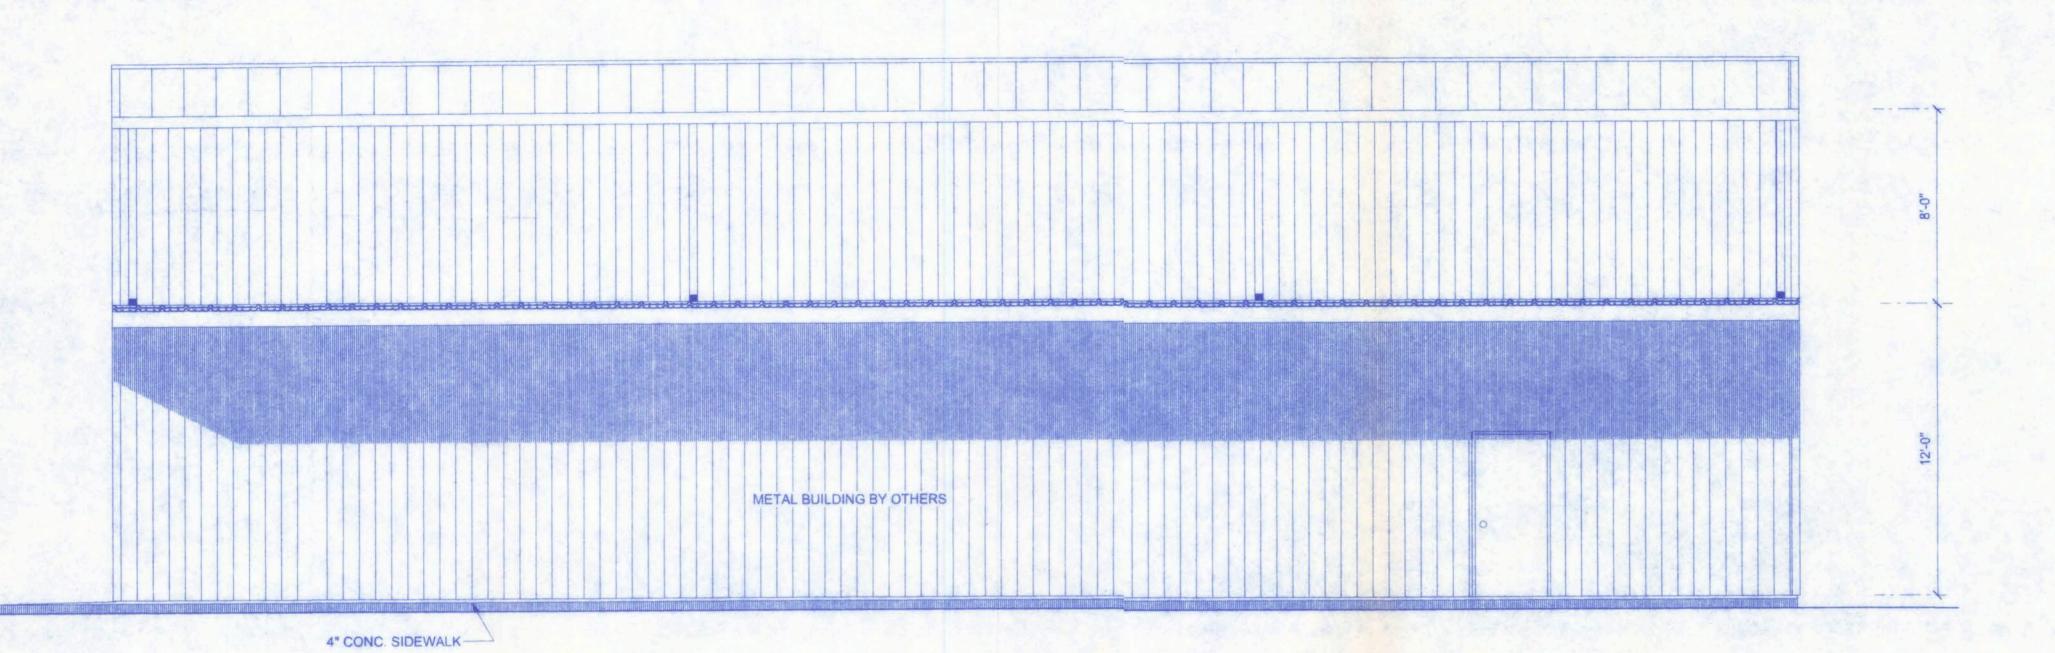

NORTH ELEVATION

SCALE: 1/4" = 1'-0"

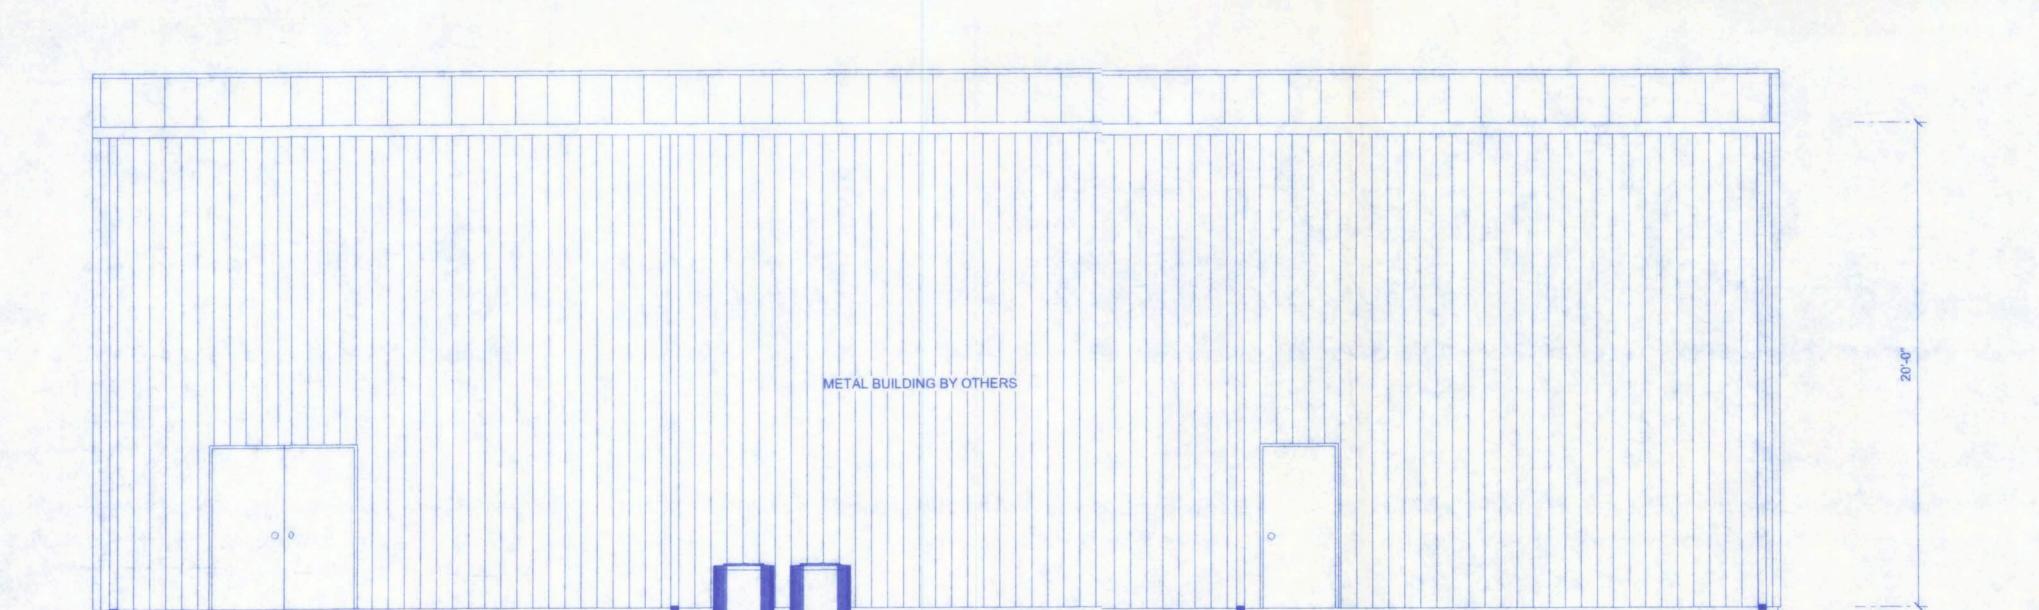

SCALE: 1/4" = 1'-0"

GUNSMITHING

SCOTT'S GUNS

Freeman
Suite #102
LAKE CITY, FL. 32055
(386)758-4209
CERTIFICATE OF AUTHORIZATION # 00008701

DATE 9/21/07 DRAWN BY W.H.F.

REVISIONS

A-4
12
PROJECT NO.

07.C035

161 NW MAL SUITE #102 LAKE CITY, (386)758-420

Freeman Design Group in

9/21/07 W.H.F.

REVISIONS

SHEET A-5

OF 12

PROJECT NO.

07.C035

DATE DRAWN BY

Lop of save

METAL BUILDING BY OTHERS

Top of canopy

Gr.0*


Conc. walk

elope 25

finished slab

EAST ELEVATION

SCALE: 1/4" = 1'-0"

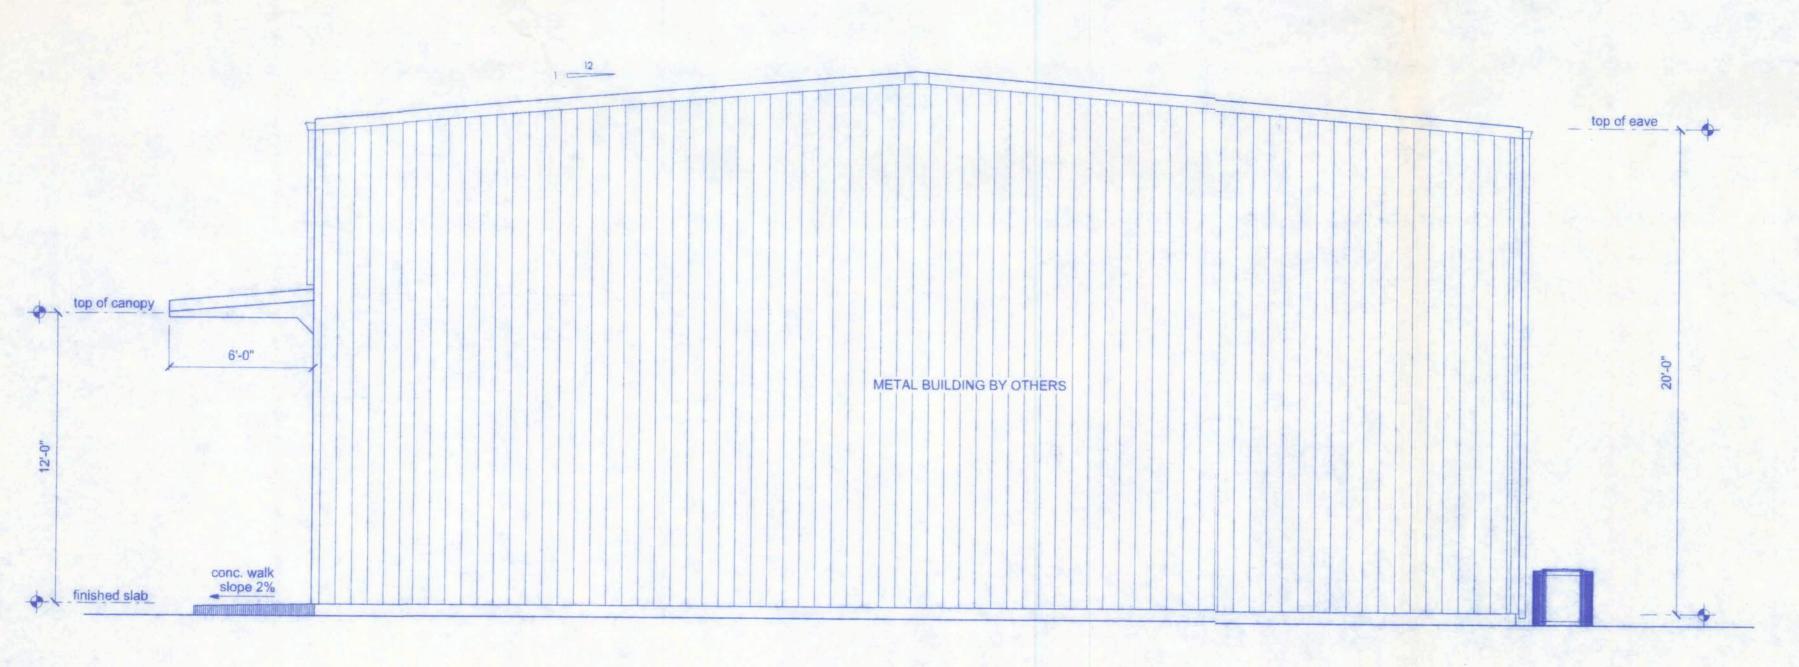

WEST ELEVATION
SCALE: 1/4" = 1'-0"

GENERAL NOTES:

- THE CONTRACTOR SHALL INDEMNIFY THE OWNER AGAINST ALL CLAIMS, WHETHER FROM PERSONAL INJURY OR PROPERTY DAMAGE, ARISING FORM EVENTS ASSOCIATED WITH THE WORK PERFORMED UNDER THE CONTRACT FOR THIS PROJECT.
- 2. THE CONTRACTOR AND/OR SUB-CONTRACTORS SHALL WARRANT ALL WORK FOR A PERIOD OF ONE YEAR FOLLOWING THE WORK DATE OF FINAL COMPLETION AND ACCEPTANCE BY THE OWNER DEFECTS IN MATERIALS, EQUIPMENT, COMPONENTS AND WORK-MANSHIP SHALL BE CORRECTED AT NO FURTHER COST TO THE OWNER DURING THE ONE YEAR WARRANTY PERIOD.
- 3. AT THE OWNER'S OPTION, A WARRANTY INSPECTION SHALL BE PERFORMED DURING THE ELEVENTH MONTH FOLLOWING THE COMMENCEMENT OF THE WARRANTY PERIOD, FOR THE PURPOSE OF DETERMINING ANY WARRANTY WORK THAT MAY BE REQUIRED. THE CONTRACTOR SHALL BE PRESENT DURING THIS INSPECTION IF REQUESTED BY THE OWNER.
- 4. THE CONTRACTOR SHALL PAY FOR ALL PERMITS, LICENSES, TESTS AND THE LIKE THAT MAY BE REQUIRED BY THE VARIOUS AUTHORITIES HAVING JURISDICTION OVER THIS PROJECT BE THEY CITY, COUNTY, STATE OR FEDERAL.
- THE OWNER SHALL FILE A "NOTICE OF COMMENCEMENT" PRIOR TO THE BEGINNING OF THE PROJECT AND THE CONTRACTOR(S) SHALL FILE "NOTICE TO OWNER" AND PROVIDE "RELEASE OF LIEN" FOR ALL PAYMENT REQUESTS PRIOR TO DISBURSEMENT OF ANY FUNDS.
- 6. ANY AND ALL DISPUTES ARISING FROM EVENTS ASSOCIATED WITH THE CONSTRUCTION OF THIS PROJECT BETWEEN THE OWNER, CONTACTOR(S) AND SUPPLIERS SHALL BE RESOLVED THROUGH BINDING ARBITRATION.
- 7. ALL WORK SHALL BE IN ACCORDANCE WITH APPLICABLE CODES AND LOCAL REGULATIONS, INCLUDING APPLICABLE ENERGY CODES. ALL COMPONENTS OF THE BUILDING SHALL MEET WITH THE MINIMUM ENERGY REQUIREMENTS OF THE BUILDING CODE. ANY DISCREPANCIES SHALL BE REPORTED TO THE ARCHITECT IN WRITING PRIOR TO THE COMMENCEMENT OF THE WORK.
- 8. ALL INSULATION SHALL BE LEFT EXPOSED AND ALL LABELS
 LEFT INTACT ON THE WINDOWS AND DOORS UNTIL INSPECTED
 BY THE BUILDING OFFICIAL.
- ALL WOOD IN CONTACT WITH CONCRETE SHALL BE PRESSURE TREATED.

CONSTRUCTION DOCUMENTS:


THE CUSTOMER IS RESPONSIBLE FOR DELIVERING THE REQUIRED SETS OF CONSTRUCTION DOCUMENTS TO THE PERMIT ISSUING AUTHORITY FOR THE ISSUANCE OF CONSTRUCTION PERMITS. THE CONTRACTOR IS SOLELY RESPONSIBLE FOR REVIEWING THE PLANS AND VERIFYING ALL EXISTING CONDITIONS, ELEVATIONS, AND DIMENSIONS PRIOR TO COMMENCING CONSTRUCTION INCLUDING FABRICATION. ALL DISCREPANCIES SHALL BE REPORTED TO THE ARCHITECT/ENGINEER FOR RESOLUTION.

DO NOT SCALE THESE PLANS:

AMPLE DIMENSIONS ARE SHOWN ON THE PLANS TO LOCATE ALL ITEMS.
SIMPLE ARITHMATIC MAY BE USED TO DETERMINE THE LOCATION OF THOSE ITEMS NOT DIMENSIONED.

CHANGES TO PLAN SETS:

PLEASE DO NOT MAKE ANY STRUCTURAL CHANGES TO THES PLANS WITHOUT CONSULTING WITH THE ARCHITECT/ENGINEER. THE OWNER SHALL ASSUME ANY AND ALL LIABILITY FOR STRUCTURAL DAMAGE RESULTING FROM CHANGES MADE TO THE PLANS OR BY SUBSTITUTION OF MATERIALS DIFFERENT FROM SPECIFICATIONS ON THE PLANS.

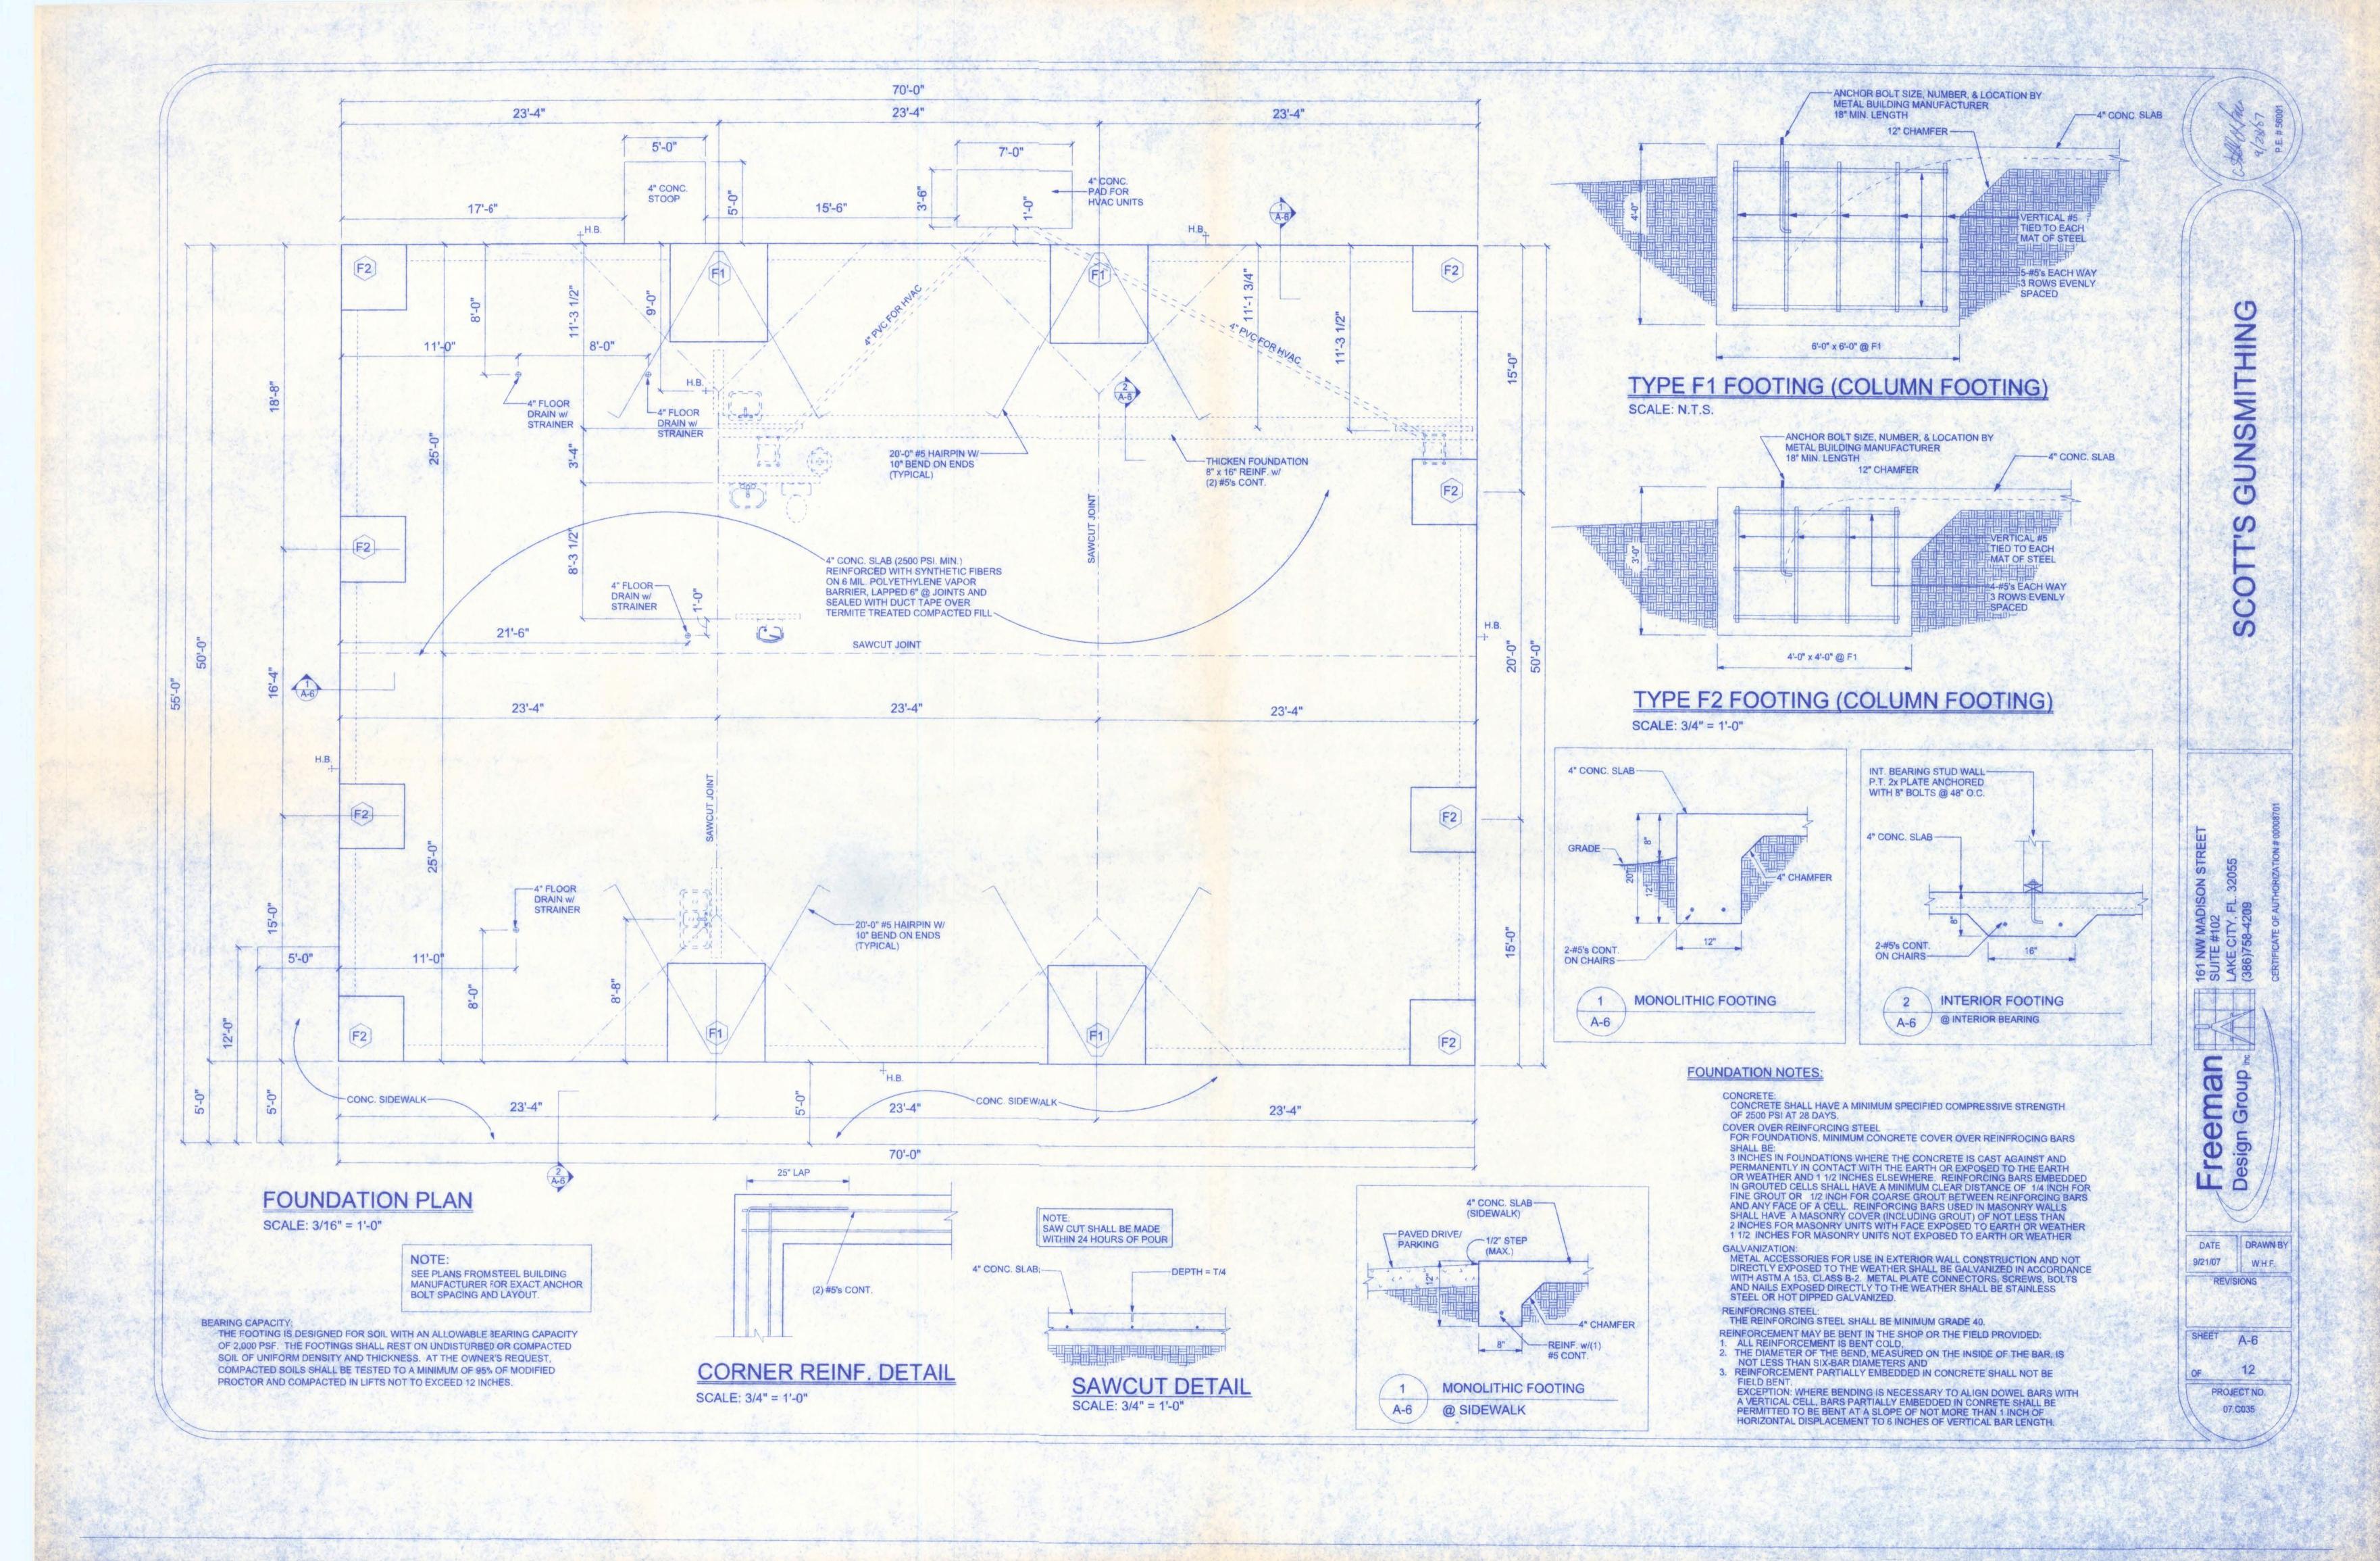

DATE DRAWN BY 9/21/07 W.H.F. REVISIONS

12

PROJECT NO. 07.C035

-400 AMP SERVICE w/DISCONNECT PNLB PNLA SMOKER 100 CFM-EXHAUST -200 AMP SUB-PANEL 30 AMP, 240V SINGLE PHASE FOR SMOKER DEDICATED CIRCUIT FOR LATHE, 3/4 HP, DEDICATED CIRCUIT FOR ULTRA SONIC CLEANER, HEATER, 16 AMPS @ 120V GENERATOR, 8 AMPS @ 120V 110V, 12 AMPS ductless mini-split heat pump wall 1 PHASE 8.1 AMPS mounted 9.6 AMPS

> **ELECTRICAL PLAN** SCALE: 1/4" = 1'-0"

EXIT AND EMERGENCY LIGHTING SHALL BE INSTALLED PER NEC 700-12, 2005 EDITION.

ELECTRICAL NOTES:

APPLICABLE LOCAL CODES AND ORDINANCES.

1. ALL WORK SHALL COMPLY WITH THE NATIONAL ELECTRIC CODE, LATEST EDITION, AND ALL OTHER

2. OPTIONAL SECURITY LIGHT SWITCH LOCATIONS TO BE MADE DURING CONSTRUCTION.

3. PREWIRE LOW VOLTAGE CONTROL WIRING FOR ELECTRIC GARAGE DOOR OPENERS.

4. PROVIDE WIRING AS REQUIRED FOR AIR COND-ITIONING, HEATING, AND WATER HEATING EQUIPMENT.

ALL SMOKE DETECTORS TO BE WIRED TOGETHER TO ACTUATE ALL ALARMS IF ANY ONE UNIT IS ACTUATED.

ngrit	-γ-
outlet	Ф
outlet 220v	•
outlet floor	da
outlet gfi	Фон
switch	\$
switch 3 way	\$,
switch 4 way	\$4
telephone	∇
weatherproof gfi	Ø₽!

ELECTRICAL

20" metal halide light

flourescent light 2x4

fluorescent fixture

50 cfm exhaust fan

electric motor

electrical panel

emergency light

fire extinguisher

meter can

main distribution panel

non-fused disconnect

50 cfm exhaust fan

LAN connection

cable tv outlet

SYMBOL

1-23

ELECTRICAL PLAN NOTES

WIRE ALL APPLIANCES, HVAC UNITS AND OTHER EQUIPMENT PER MANUF. SPECIFICATIONS.

CONSULT THE OWNER FOR THE NUMBER OF SEPERATE TELEPHONE LINES TO BE INSTALLED.

INSTALLATION SHALL BE PER NAT'L. ELECTRIC CODE.

ALL SMOKE DETECTORS SHALL BE 120V W/ BATTERY BACKUP OF THE PHOTOELECTRIC TYPE, AND SHALL BE INTERLOCKED TOGETHER. INSTALL INSIDE AND NEAR ALL BEDROOMS.

TELEPHONE, TELEVISION AND OTHER LOW VOLTAGE DEVICES OR OUTLETS SHALL BE AS PER THE OWNER'S DIRECTIONS, & IN ACCORDANCE W/ APPLICABLE SECTIONS OF NEC-LATEST EDITION.

ELECTRICAL CONT'R SHALL PREPARE "AS-BUILT" SHOP DWGS INDICATING ALL ELECTRICAL WORK, INCLUDING ANY CHANGES TO THE ELEC. PLAN, ADD'NS TO THE ELEC. PLAN. RISER DIAGRAM, AS-BUILT PANEL SCHEDULE W/ ALL CKTS IDENTIFIED W/ CKT Nr., DESCRIPTION & BRKR, SERVICE ENT. & ALL UNDERGROUND WIRE LOCATIONS/ROUTING/DEPTH. RISER DIA. SHALL INCLUDE WIRE SIZES/TYPE & EQUIPMENT TYPE W/ RATINGS & LOADS. CONTRACTOR SHALL PROVIDE 1 COPY OF AS-BUILT DWGS TO OWNER & 1 COPY TO THE PERMIT ISSUING AUTHORITY.

Freeman 161 NV SUITE Design Group Inc (386)75

DATE DRAWN BY REVISIONS

PROJECT NO.

07.C035

• • • •

ELECTRICAL	SYMBOL		
fluorescent fixture			
LAN connection	×		
cable tv outlet	TV		
light	\(\phi \)		
outlet	Ф		
smoke detector	•		
switch	\$		
telephone	∇		

UPPER ELECTRICAL PLAN


SCALE: 1/4" = 1'-0"

MERCANTILE AREA - PANEL A

	LOAD CALCUI	LATIONS:	
	CONNECTED LOAD	DEMAND FACTOR D	EMAND LOAD
CONTINUOUS LIGHTING OUTSIDE LIGHTING	4,500 VA 1,500 VA	1.25 1.25	5,625 VA 1,875 VA
NON-CONTINUOUS		CONT. TOTA	L; 7,500 VA
RECEPTACLES WATER HEATER MISCELLANEOUS HVAC	5,000 VA 4,500 VA 3,500 VA 24,000 VA	1.0 1.0 1.0 1.0	5,000 VA 4,500 VA 3,500 VA 24,000 VA
		NON-CONT. TOTAL	: 37,000 VA
	(CONT. + NON-CONT.)	OVERALL TOTAL	: 44,500 VA
		@ 120/	240 1 PHASE
		1	85.417 AMPS
THE RESERVE		PROVIDED SERVICE	200 AMPS

FACTORY AREA - PANEL B

0.111.10		LOAD CALCUI	ATIONS:	
1		CONNECTED LOAD	DEMAND FACTOR	EMAND LOAD
	CONTINUOUS LIGHTING OUTSIDE LIGHTING	1,500 VA 1,000 VA	1.25 1.25	1,875 VA 1,250 VA
j	MON CONTINUOUS		CONT. TOTA	AL: 3,125 VA
	NON-CONTINUOUS RECEPTACLES MISCELLANEOUS HVAC SMOKER CUBER	2,000 VA 3,500 VA 4,000 VA 4,500 VA 1,900 VA	1.0 1.0 1.0 1.0 1.0	2,000 VA 3,500 VA 4,000 VA 4,500 VA 1,900 VA
			NON-CONT. TOTAL	: 15,900 VA
100		(CONT. + NON-CONT.)		240 1 PHASE
1			PROVIDED SERVICE	79.27 AMPS 150 AMPS

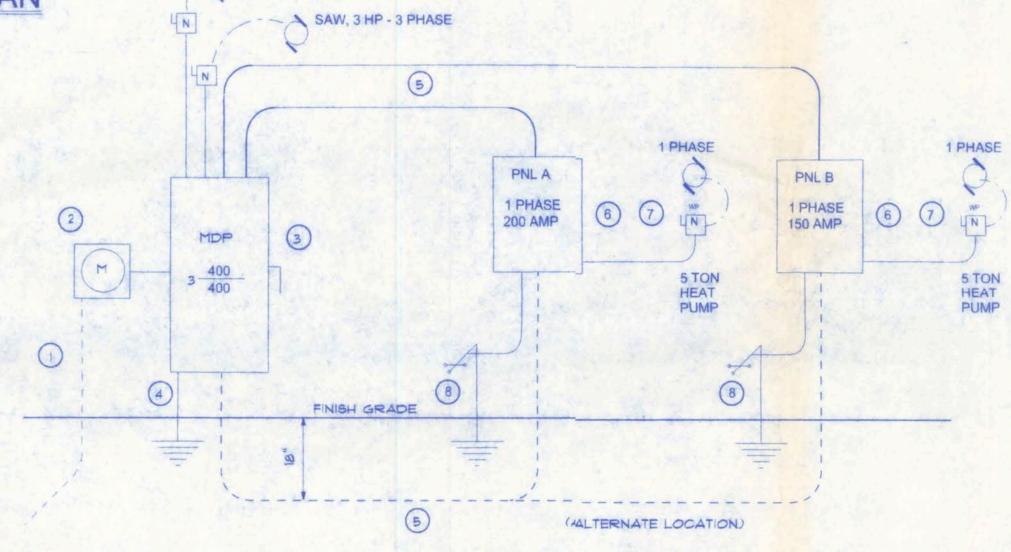

- Service/Feeder Entrance Conductors: 2 1/2" rigid conduit, min 18" deep, w. continuous ground bonding conductor, Service/ Entrance Conductors shall not be spliced except that bolted conections at the Meter, Disconnections Devices and Panel shall be allowed. shall be allowed.
- Existing Meter Enclosure, weatherproof, U.L. Listed.
- Main Disconnect Switch: fused or Main Breaker, weatherproof, U.L. Listed.
- Service entrance ground: 5/8" diameter iron/steel rod x 8'-0" long and/or concrete encased foundation steel rebar x 20'-0" long. Grounding conductor shall be bounded to each piece of Service/Entrance Equipment, and shall be sized per Item *5 below.
- 200 Ampere Feeder: 3-3/0-THW-Cu, 1-*2-ICu-GND, 2 1/2" Conduit. 150 Ampere Feeder 3-2/0- THW-Cu, 1-*2-Cu-GND, 2" Conduit
 - House Panel (PNL), U.L. Listed, sized per schedule.
- Equipment Disconnect Switch: non-fused, in weather proof enclosure, size according to Panel Scheidule loads.
- Provide Ground Bond Wire to metal pipping, size in accordance with the Service Ground Conductor.


ELECTRICAL DETAILS

SCALE: 1/4" = 1'-0"

	TYPE VOLTS		PNL A 2.D. 'NQOD' 120/240	MAIN LUI	GS	OCATION			BREAKER	X AMPS	200		
	A.I.C. RATING 2Z,000 KVA			FEEDER S	IZE	3 - 4/0 TW	W 200 1 2						
	c	MOUNTING / STAROTAL KW LO	ANDARD X		FEED/T		X		воттом				
WIRE	GND.	COND.	APPLICATION	LOAD	CIR	BRK	BRK	CIR.	LOAD	APPLICATION	COND.	GND.	WIRE
8	10	1"	5 TON	177	1	40/2	30/2	2		WATER	1/2"	10	10
			HEAT PUMP		3			4		HEATER	133		
4	10	1"	AIR HANDLER		5	60/2	20/2	6			1/2"	10	12
			AINTIANDLEN		7			8		WELL PUMP			
12	12	1/2"	SM. APPLIANCE		9	20/1	20/1	10			1/2"	12	12
12	12	1/2"	LIGHTING		11	20/1	20/1	12		BATHROOM	1/2"	12	12
12	12	1/2"	LIGHTING		13	20/1	20/1	14		SM. APPLIANCE	1/2"	12	12
12	12	1/2"	RECEPT.		15	20/1	20/1	16		LIGHTING	1/2"	12	12
12	12	1/2"	RECEPT.		17	20/1	20/1	18		LIGHTING	1/2"	12	12
12	12	1/2"	RECEPT.		19	20/1	20/1	20		LIGHTING	1/2"	12	12
12	12	1/2"	EM. LIGHTS		21	20/1	20/1	22		RECEPT.	1/2"	12	12
			SPACE		23		20/1	24		RECEPT.	1/2"	12	12
								26		SPACE			
		A. I		7 7			VI.						
			SPACE		39			40		SPACE			

PANEL BOARD SCHEDULE

							4						
	PANEL		PNL 8			OCATION		SMOKE R	7				
	TYPE	-	0.D. NOOD' 120/240	MAIN LUI		ONLY			BREAKER	X AMPS	150		
		A.I.C. RATING	23 000 9070		FEEDER S		3 - 4/0 TW			NGLE POLES 4			
					FEED/T	OP	Х		воттом				
	,	MOUNTING / S	SURFACE		FLU	SH	X						
		CABINET /ST/											
		TOTAL KW LO	AD 19.9										
WIRE	GND.	COND.	APPLICATION	LOAD	CIR.	BRK.	BRK	CIR.	LOAD	APPLICATION	COND.	GND.	WIRE
8	10	1"	5 TON		1	40/2	60/2	2			1"	10	4
			HEAT PUMP		3			4		AIR HANDLER			
12	12	1/2"	SM. APPLIANCE		5	20/1	20/1	6		BATHROOM	1/2"	12	1
12	12	1/2"	LIGHTING		7	20/1	20/1	8		SM. APPLIANCE	1/2"	12	1
12	12	1/2"	LIGHTING		9	20/1	20/1	10	77.	LIGHTING	1/2"	12	1
12	12	1/2"	RECEPT.		11	20/1	20/1	12		LIGHTING	1/2"	12	1
12	12	1/2"	RECEPT.		13	20/1	20/1	14		LIGHTING	1/2"	12	1
12	12	1/2"	RECEPT.		15	20/1	20/1	16		RECEPT.	1/2"	12	1
12	12	1/2"	EM. LIGHTS		17	20/1	20/1	18		RECEPT.	1/2"	12	1.
12	12	1/2"	USC - HEATER		19	20/1	20/1	20		CUBER	1/2"	12	1
12	12	1/2"	USC - GENERATOR		21	20/1	30/1	22		SMOKER	1/2"	12	_1
12	12	1/2"	LATHE		23	20/1		24					
341			SPACE		25		20/1	26		SPACE	+		

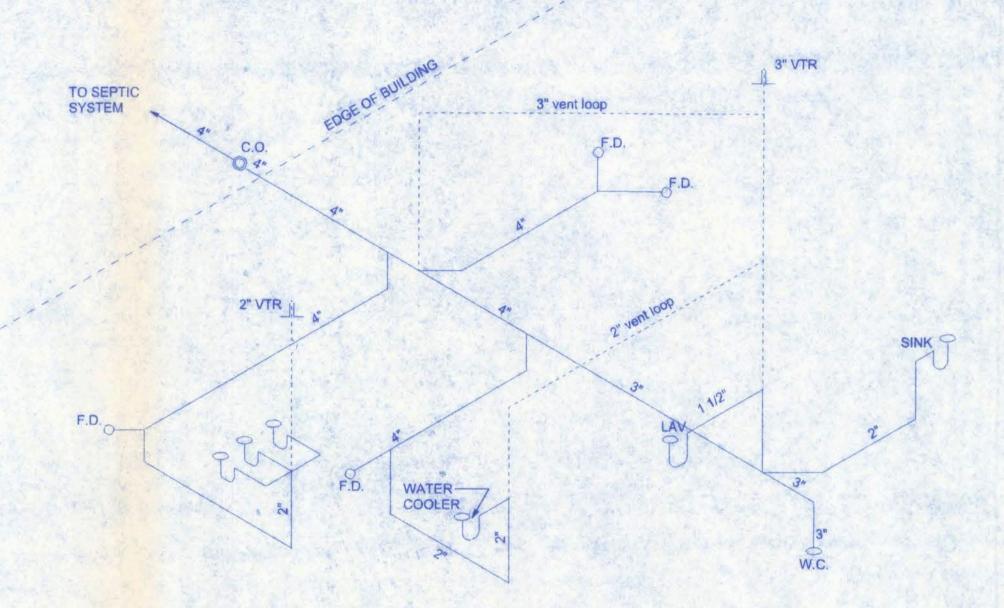

PLUMBING RISER

TO EXISTING

SCALE: 1/4" = 1'-0"


PROVIDE PLUMBING CLEAN-OUTS AT THE BASE OF ALL STACKS, A MAXIMUM OF 75' O.C. ALONG ALL MAIN DRAIN RUNS AND THE UP-STREAM ENDS OF MAIN DRAIN RUNS, WHERE THE MAIN BUILDING DRAIN EXITS THE BUILDING AND AT 75' INTERVALS TO THE DISPOSAL SITE.


NOTE!
PLUMBING CONTRACTOR SHALL PREPARE "AS-BUILT" SHOP
DRAWINGS INDICATING ALL PLUMBING WORK, INCLUDING ALL
PLUMBING LINE LOCATIONS AND RISER DIAGRAM - CONT'R
SHALL PROVIDE 1 COPY OF AS-BUILT DWGS TO OWNER AND
1 COPY TO THE PERMIT ISSUING AUTHORITY.

NOTE!

ADDED FILL SHALL BE APPLIED IN 8" LIFT'S EA. LIFT SHALL BE CONPACTED TO 95% DRY
COMPACTION PER THE "MODIFIED PROCTOR"
METHOD.

NOTE!
PROVIDE TRAP PRIMERS FOR ALL FLOOR DRAINS PRIME EACH F.D. INDIVIDUALLY, DO NOT MANIFOLD

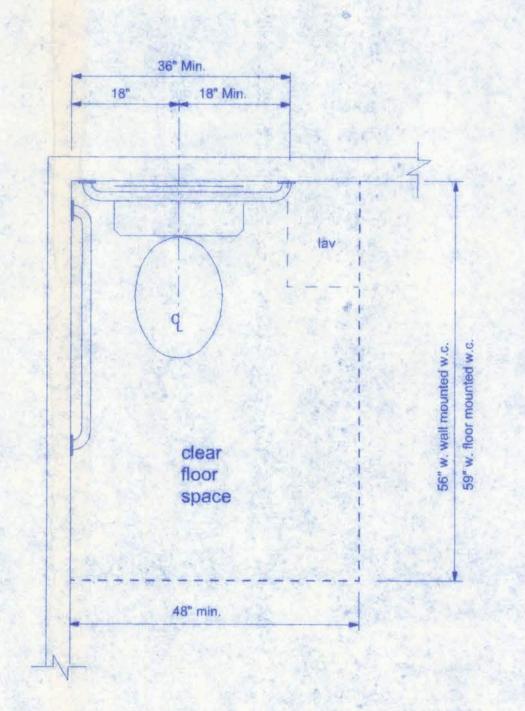

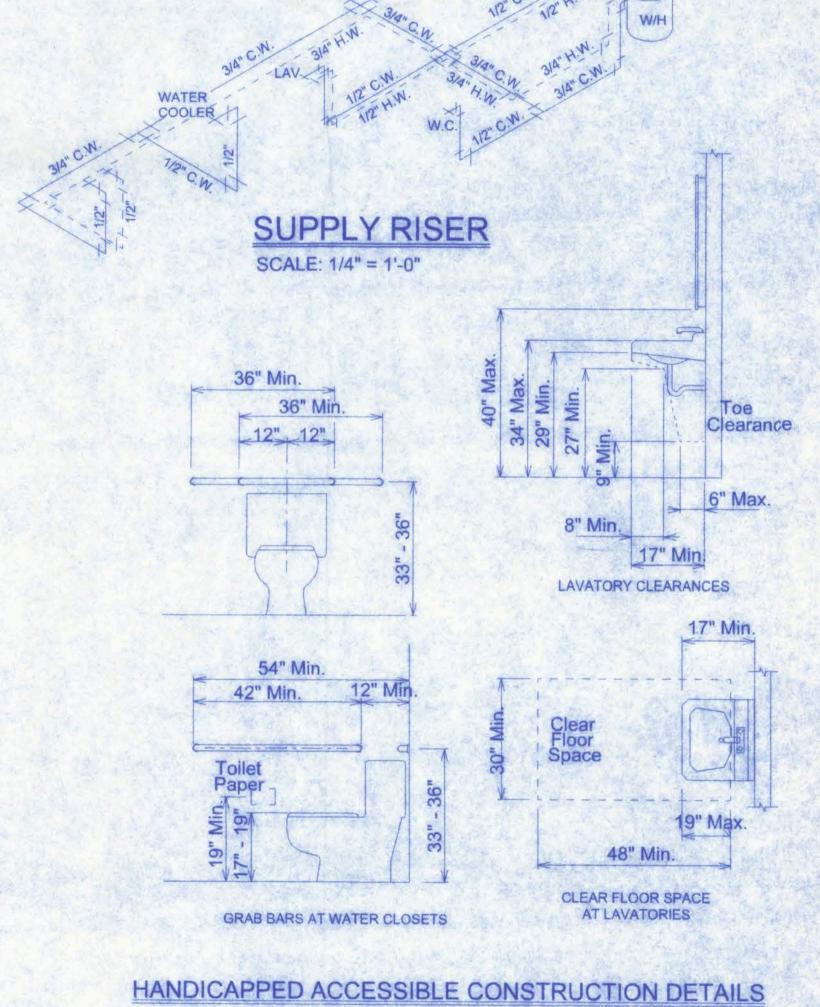

92807 92807 P.E.#560

COTT'S GUNSMITHING

Freeman 161 NW MADISON STREET SUITE #102

Design Group in (386)758-4209

SHEET A-9
OF 12

PROJECT NO. 07.C035

W.H.F.

HVAC UNITS SHALL BE MOUNTED TO CONCRETE PAD w/ #14 SCREWS w/ GASKETED WASHERS. (3) PER SIDE built-in exhaust system for smoker 220cfm through wall (LOCATION TO UPSTAIRS MATCH OWER) - UPSTAIRS /(LOCATION TO MATCH LOWER) -UPSTAIRS 6" ¢ 200cfm 6" ¢ 6" φ 6" ¢ 6" ¢ 6" φ 6" ¢ -ONLY THIS ROOM CONDITIONED

HVAC PLAN

SCALE: 1/4" = 1'-0"

HVAC NOTES:


- SUB-CONTRACTORS PROVIDING HVAC INSTALLATION SHALL BE SUJECT TO THE PROVISIONS OF NOTES 1 THRU 6, GENERAL NOTES.
- 2. HVAC SUB-CONTRACTOR SHALL PROVIDE ALL LABOR, MATERIAL, TOOLS AND EQUIPMENT TO INSTALL A COMPLETE HVAC
- HVAC SYSTEM SHALL BE AS DETAILED IN THE PLANS (IF INCLUDED)
 OR SHALL BE AS DIRECTED BY THE OWNER IN CONSULTATION WITH THE
 HVAC SUB-CONTRACTOR.
- HVAC SUB-CONTRACTOR SHALL FURNISH SHOP DRAWINGS FOR DUCTWORK, CONDENSING UNIT & AIR HANDLER, EXHAUST FANS AND AIR DEVICES.
- 5. IT IS THE HVAC SUB-CONTRACTOR'S RESPONSIBILITY TO COMPLY WITH NFPA-90A AND ALL APPLICABLE CODES.
- 6. FLEXIBLE DUCT SHALL BE FULLY ANNEALED, CORRUGATED ALUMINUM W/ 1 3/4 LB. DENSITY FIRBERGLASS INSULATION AND SHALL BE U.L. LISTED. SHEET METAL DUCT SHALL BE LINED W/ 1" MATFACED DUCT LINER & WRAPPED W/ 1 3/4 L. FOILFACED FIBERGLASS INSULATION. ALL FIBERGLASS DUCT SHALL BE FOILFACED, R4.3/R6.0 DUCTBOARD.
- ALL EXHAUST AND OUTSIDE AIR DUCT SHALL BE GALVANIZED SHEET METAL CONSTRUCTED AND INSTALLED IN ACCORDANCE WITH ASHREA AND SMACNA STANDARDS.
- 8. ALL AIR DEVICES SHALL BE OF ALUMINUM CONSTRUCTION FOR WALL AND CEILING APPLICATIONS AND STEEL CONSTRUCTION IN FLOOR APPLICATIONS. ACCEPTABLE MANUFACTURERS SHALL BE TITUS, METALAIRE, NAILORHART, HART & COOLIE OR AS DIRECTED BY THE OWNER.
- 9. IF REQUIRED BY THE OWNER, THE HVAC SUB-CONTRACTOR SHALL SUPPLY A TEST AND BALANCE REPORT IN ACCORDANCE WITH AIR BALANCE COUNCIL STANDARDS, SIGNED AND SEALED BY A REGISTERED ENGINEER.
- 10. HVAC SUB-CONTRACTOR SHALL SUPPLY ALL CONTRACTORS, RELAYS AND THERMOSTATS. THE ELECTRICAL SUB-CONTRACTOR SHALL PROVIDE ALL SWITCHES, DISCONNECTS & CONTROL WIRING. THERMOSTATS SHALL BE APPROVED BY THE EQUIPMENT MANUFACTURER.
- 11. ALL DUCT SIZES INDICATED IN THE PLANS (IF INCLUDED) ARE NET INSIDE DIMENSION.
- 12. ALL EQUIPMENT SHALL BE FULLY WARRANTED FOR 1 YEAR AND THE COMPRESSOR(S) SHALL BE WARRANTED 5 YEARS FROM DATE OF FINAL ACCEPTANCE, BY THE OWNER.
- 13. ALL WORK IN THIS TRADE SHALL BE COORDINATED WITH ALL OTHER TRADES SO AS TO AVOID CONFLICTS OR HINDRANCE TO COMPLETION OF THE JOB
- CONDENSATE DRAIN PIPING SHALL BE INSULATED WITH 1.2" THICK ARMAFLEC INSULATION.
- 15. FILTERS SHALL BE DISPOSABLE TYPE AND HAVE INITIAL SHARE WEIGHT ARRESTANCE OF 10% AND A CLEAN PRESSURE DROP OF 0.15 PROVIDE 2 SETS, ONE DURING CONSTRUCTION AND ONE FOR USE AT FINAL ACCEPTANCE.
- 16. HVAC SUB-CONTRACTOR SHALL PROVIDE & INSTALL ALL NECESSARY OFFSETS, TRANSITIONS & BENDS REQUIRED TO PROVIDE A COMPLETE SYSTEM AT NO ADDITIONAL COST TO THE OWNER.
- 17. IT IS THE RESPONSIBILITY OF THE HVAC SUB-CONTRACTOR TO COORDINATE LOCATION OF CEILING DIFFUSERS, GRILLES AND REGISTERS IN THE FIELD WITH THE ELECTRICIAN, LIGHTS AND ARCHITECTURAL ELEMENTS.
- 18. COORDINATE W/ THE ELECTRICIAN, TO ASSURE SUITABLE SIZES OF BREAKER, SWITCHES AND WIRING.

NOTE:
BATHROOM EXHAUST SHALL BE DIRECTED TO OUTSIDE OF BUILDING.
EXHAUST AIR SHALL NOT BE DIRECTED ONTO WALKWAYS. AIR
EXHAUST OPENINGS SHALL BE PROTECTED WITH CORROSION-RESISTANT
SCREENS, LOUVERS OR GRILLS IF TERMINATING OUT DOORS.

	DI	FFUSER :	SCHEDULE	
VIK	MAX. CFM	SIZE	PATTERN	LOCATION
D1	280	24" x 24"	4W	CLG.
D2	170	8" x 12"	1W	CLG.
D3	70	4" x 8"	1W	CLG.

REQUIRED OUTDOOR VENTILATION PER TABLE 403.3 FMC.

LOCATION	CFM/PERSON	TOTAL CFM
TOILET AREA	50 CFM/W.C.	50
OFFICE AREA	25 CFM/PERSON 43 OCCUPANTS	1,075
GRAND TOTAL		1,125

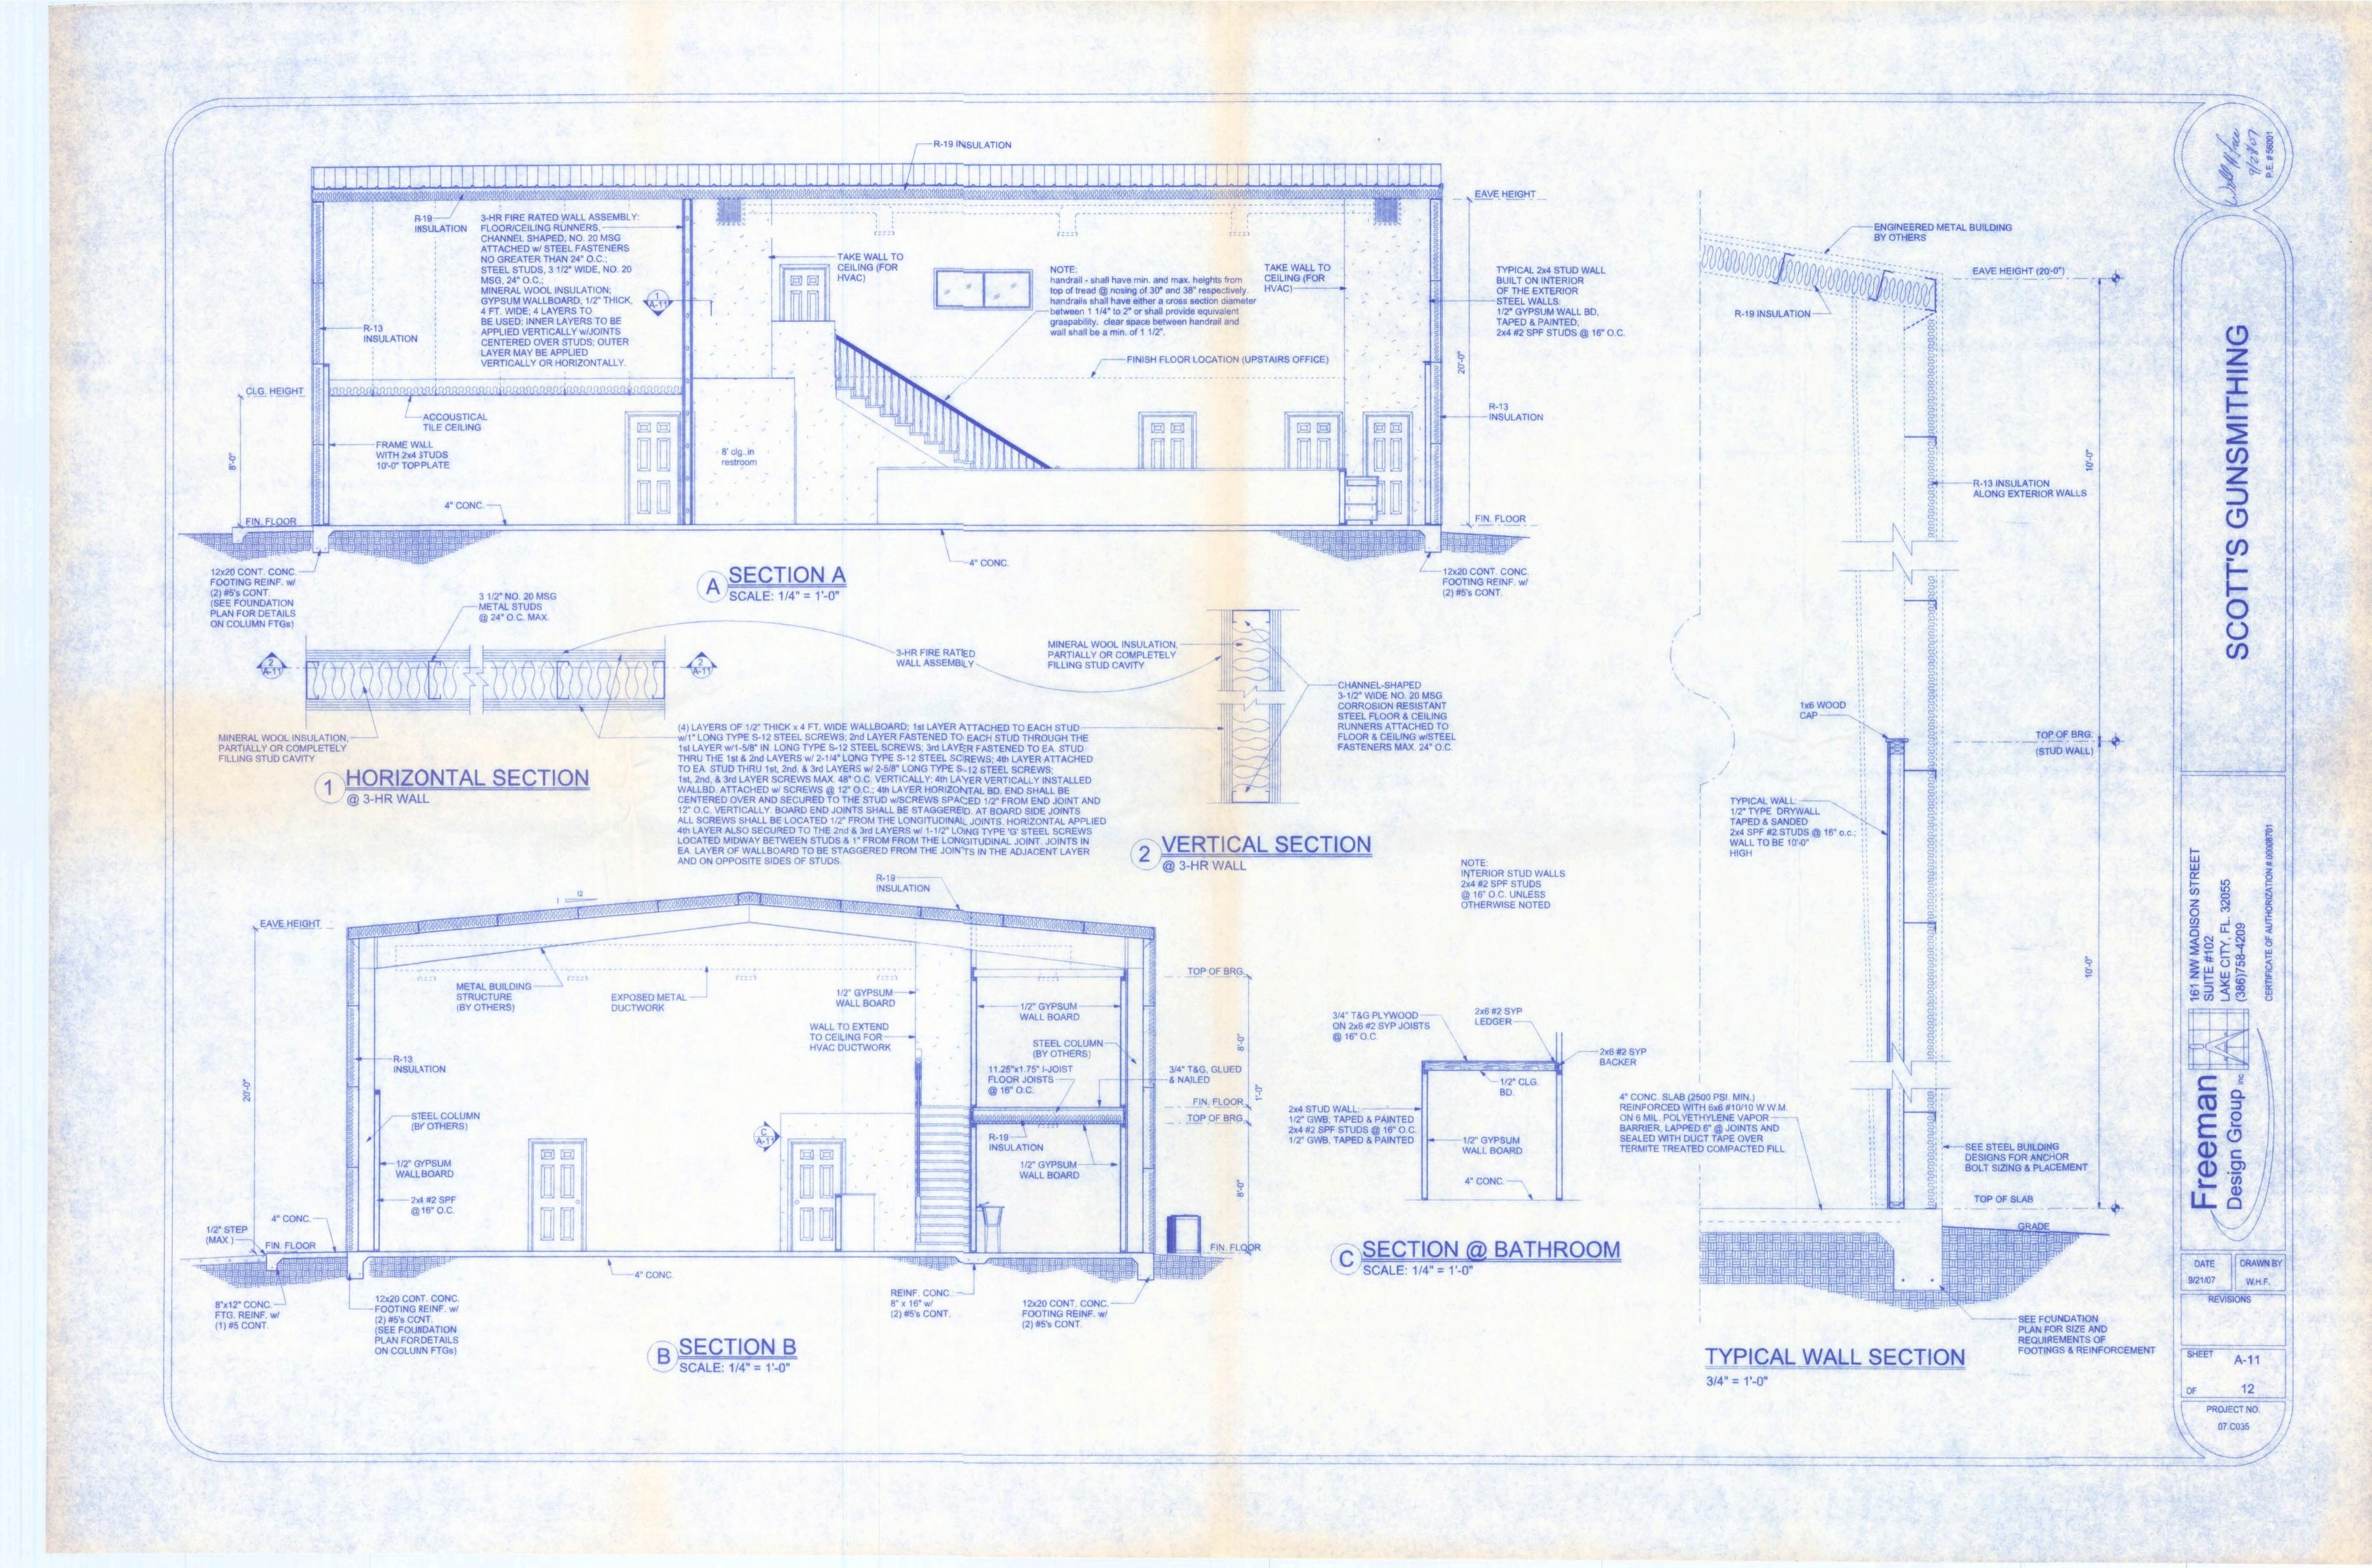

DATE DRAWN BY

9/21/07 W.H.F.

REVISIONS

SHEET A-12

PROJECT NO.

07.C035

		NTERIOR FINI	SH SCHEDULE		
ROOM	FLOORING	BASE	WALLS	CEILING	CLG. HEIGHT
GUNSHOP	12" VCT	4" WOOD, P/G	SMOOTH/PAINTED	UNFINISHED	OPEN
BATHROOM	12" VCT	4" WOOD, P/G	SMOOTH/PAINTED	PAINTED	8'-0"
STOCK ROOM	12" VCT	4" WOOD, P/G	SMOOTH/PAINTED	PAINTED	8'-0"
STORAGE	12" VCT	4" WOOD, P/G	SMOOTH/PAINTED	PAINTED	8'-0"
SMOKE ROOM	12" VCT	4" WOOD, P/G	SMOOTH/PAINTED	UNFINISHED	OPEN
PROCESSING ROOM	12" VCT	4" WOOD, P/G	SMOOTH/PAINTED	ACC. TILE	8'-0"
OFFICES (UPSTAIRS)	12" VCT	4" WOOD, P/G	SMOOTH/PAINTED	PAINTED	8'-0"
ENTRY	CONCRETE	N/A	N/A	METAL SOFFIT	12'-0"

ALL WALLS SHALL RECEIVE ONE PRIMER COAT AND 2 FINISH COATS OF LATEX PAINT. COLORS BY OWNER.


FIXTURE SCHEDULE

- 14.3. a. 11.	
	H.C. ACCESSIBLE RESTROOM
QTY.	DESCRIPTION
1 3	GERBER #21-718, 17" HIGH ELONGATED BOWL, WHITE.
1	GERBER #22-554 24"x20" LAV. W/ PEDESTAL, WHITE.
1	GERBER 44-051 SERIES LAVATORY FAUCETS W/
1 12 2 14	WRIST BLADE HANDLES.
1	1 1/2" X 36" GRAB BAR ON WALL BEHING TOILET.
1	1 1/2" X 42" GRAB BAR ON WALL LEFT SDE OF TOILET.


	PROCESSING ROOM
QTY.	DESCRIPTION
1	KOHLER STAINLESS STEEL TRIPLE SINK #K-3222-3 STERLING KITCHEN FAUCET #C826R W/ WRIST BLADE HANDLES.

	<u>UTILITY ROOM</u>
QTY.	DESCRIPTION
1	STERLING STAINLESS STEEL UTILITY SINK. STERLING KITCHEN FAUCET #C826R W/ WRIST BLADE HANDLES.


WATER COOLER - OASIS MODEL PLF8FPM RECESSED WATER COOLER

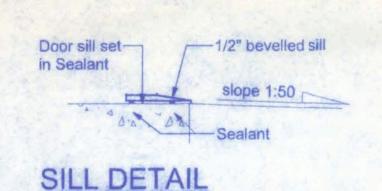


SCALE: 1 1/2" = 1'-0"

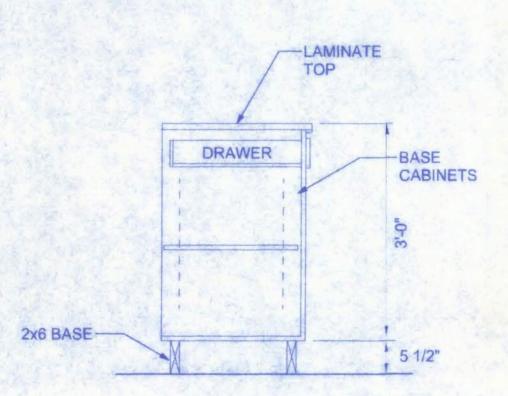

CABINET SECTION, TYP. SCALE: 3/4" = 1'-0"

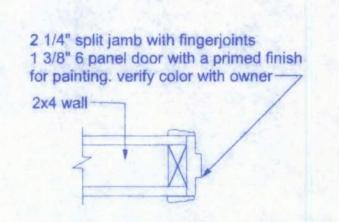


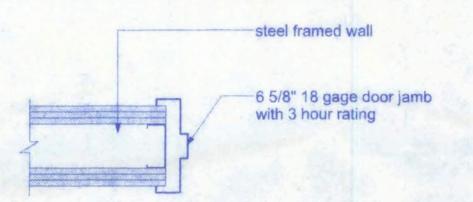

JAMB DETAIL SCALE: 1 1/2" = 1'-0"

FINAL DESIGN OF GLASS DISPLAY -GLASS TOP CASE TO BE DETERMINED BY THE OWNER AND THE GENERAL CONTRACTOR. THIS DETAIL SHOWS ONLY A GENERALIZED DESIGN. GLASS SLIDING GLASS-DOORS FRONT 2x6 BASE -5 1/2"

GLASS DISPLAY CASE, TYP. SCALE: 3/4" = 1'-0"

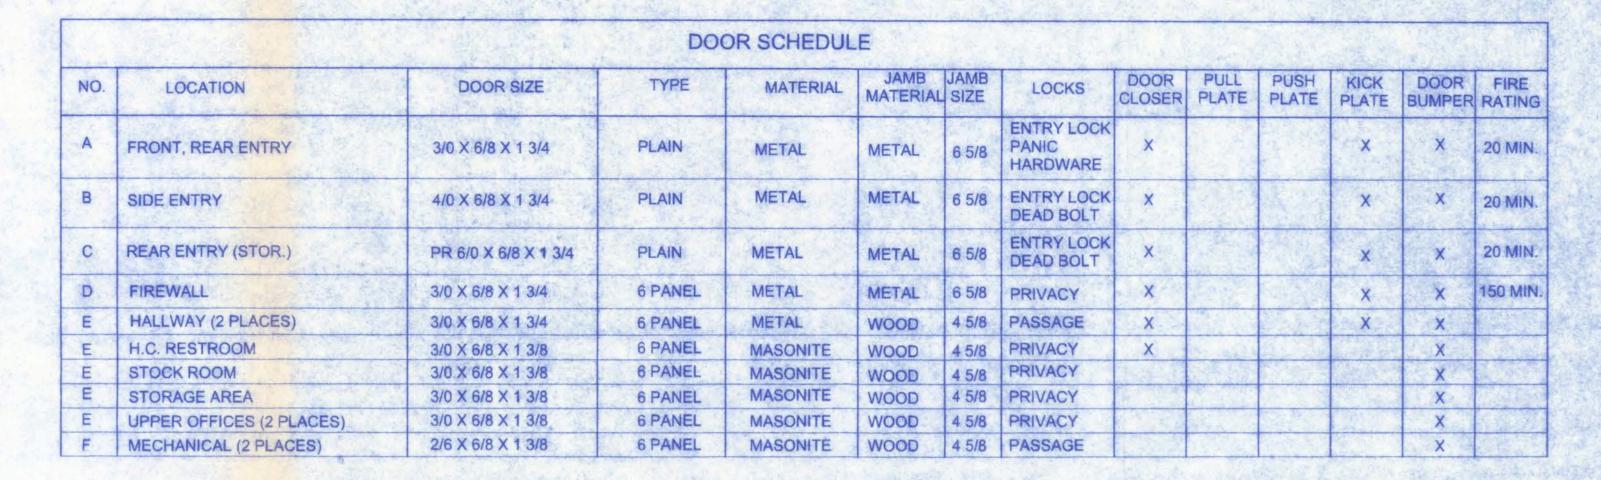

BATHROOM DOORS SHALL BE DESIGNED TO ALLOW OPENING OF LOCKED DOOR FROM OUTSIDE BY OPENING DEVICE READILY ACCESSIBLE BY STAFF.

PUSH PLATE - 4"X16" BB PULL PLATE - 4"X16" #132X70C BB WAILL DOOR BUMPER #407 1/2 - BB - ALL DOOR HANDLESETS AND LOCKS SHALL BE KWIK-SET OR EQUAL, COLOR AND STYLE DESIGN BY OWNER ALL LEVER TYPE HARDWARE SHALL BE MOUNTED AND INSTALLED IN ACCORDANCE WITH

GENERAL NOTES - DOORS

1. ALL INTERIOR DOORS SHALL BE 6 PANEL MASONITE 6/8 x 1 3/8" PREHUNG

THE MANUFACTURER'S RECOMMENDED HANDICAP MOUNTING HEIGHT

UNLESS NOTED OTHERWISE. 2. ALL EXTERIOR DOORS SHALL BE 6 PANEL METAL, PREHUNG 6/8 X 1 3/4" - STEEL JAMBS WIEATHERSTRIPPING, AND THRESHOLD FACTORY INSTALLED UNLESS NOTED OTHERWISE.


3. IF REQUIRED, UNDERCUT DOORS FOR RETURN AIR. COORDINATE WITH MECHANICAL SUB-CONTRACTOR AS PER FINAL DESIGN.

4. CONFIRM DEPTHS OF ALL WOOD FLAT JAMBS. COORDINATE WITH CORRESPONDING WALL SECTIONS, PARTITION TYPES, AND WALL MODIFICATION DETAILS. 5. PAINT ALL EXTERIOR SURFACES OF EXTERIOR METAL DOORS AND THE SOLID WOOD

DOOR FRAME. COLOR SELECTION BY OWNER. 6. PAINT ALL INTERIOR SURFACES OF EXTERNAL METAL DOORS AND THE SOLID WOOD

DOOR FRAME. COLOR SELECTION BY OWNER. 7. PAINT ALL INTERIOR WOOD FLAT JAMBS. COLOR SELECTION BY OWNER.

8. PAINT ALL INTERIOR DOORS. COLOR SELECTION BY OWNER.

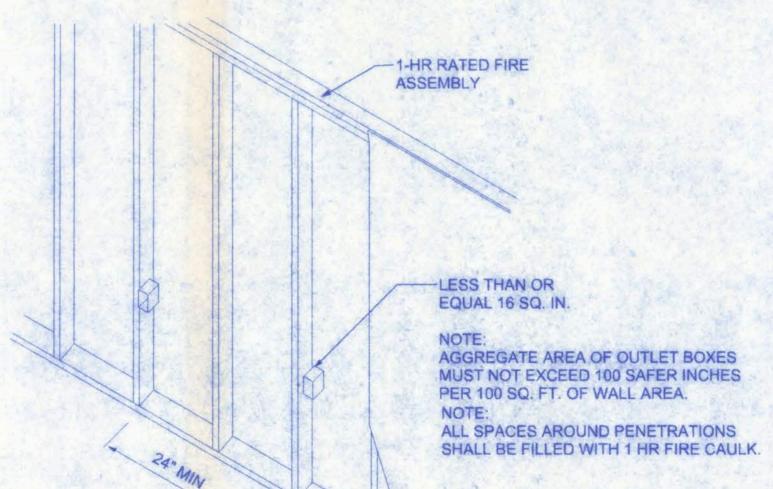

WIRING NOTES:

WIRING, DISTRIBUTION EQUIPMENT AND DEVICES

A. CONDUCTORS: Copper, in accordance with ASTM Standards, size reference AWG. Conductors No. 10 and smaller size solid, No. 8 and Larger, Stranded. Insulation of conductor thermoplastic, type THHN (min. size No. 12) any wire installed outside, underground, in slabs or exposed to moisture shall have THWN insulation.

B. RACEWAYS: RIGID STEEL CONDUIT, full weight pipe galvanized, threaded, and minimum 1/2 Inch except as noted or required for wiring. ELECTRICAL METALLIC TUBING (EMT), thin wall pipe, galvanized, threadless, compression fittings, and minim 1/2" size except as noted or required for wiring. FLEXIBLE STEEL CONDUIT: continuous single strip, galvanized, and minimum 1/2" size except as noted or required for wiring. PVC CONDUIT, heavy duty type, size as indicated. Separate raceways shall be used for each voltage system.

C: DISCONNECT SWITCHES: General Duty, horsepower rated for motor loads 250 volt rating, fused or non-fused as noted; number of poles as indicated. Enclosure NEMA 1 for indoor use and NEMA 3R

for weatherproof applications. Switch to be Square "D" or equal. D: CIRCUIT BREAKERS: molded case, thermal-magnetic, quick make, quick break, bolt-on type with manually operated insulated trip-free handle. Multi-pole types with internal common trip bar. Terminals suitable for copper or aluminum conductors. Interrupting capacity minimum 10,000 RMS symmetrical amperes circuit circuit breakers to be Square "D", Siemens or equal, type as required. E: PANELBOARDS: Voltage, phasing, and ampere ratings as indicated, circuit breaker type as indicated, buss bars of hard drawn copper, minimum 98% conductivity, galvanized steel back box, door and trim. All corners lapped and welded, hardware chrome plated with flush lock and catch Hinges semi-concealed, 5 knuckles steel with nonferrous pins. 180 degree openings. Minimum gutter space 5-3/4" sides, top and bottom. Increase size where required by code. Directory holder complete with clear plastic transparent cover indicating typwritten list of feeder cables, conduit sizes, circuit number, outlets of equipment supplied, and their location. Circuit breaker type panelboards to be Square "D" type NQOD or I-Line, or equal. A plastic label shall be located on exterior of panelboard identifying the system voltage, phase, and current rating. F: WIRING DEVICES: All devices their product of the same manufacturer. Wall switches and receptacles to be 20 amp, 125 volt, unless noted otherwise. Color to be selected by Architect. G: DEVICE PLATES: provide for all outlets where devices are installed. Provide engraved marking

GROUNDING SYSTEM:

a. EQUIPMENT: Ground non-current carrying metal parts of panel board, receways and all lighting fixtures. All conduit shall have equipment grounding conductors.

for special outlets (where noted). Provide blank plates for empty or future outlet boxes. DEVICE

AND DEVICE PLATE COLORS TO BE VERIFIED WITH ARCHITECT AND OWNER.

INSTALLATION:

A. Secure all supports to building structure as specified under raceways. Support horizontal runs of metallic conduit not more than 10 feet apart. Run exposed raceways parallel with or at right angles. to walls.

B. Pass raceways over water, steam or other piping when pull boxes are not required. no raceway within 3 inches of steam or hot water pipes, or appliances. expect crossing where the raceway shall be at least 2 inches from pipe cover.

C. Cut conduit ends square, ream smooth. Paint male threads of field threaded conduit with Graphite based pip compound. Draw up tight with conduit couplings. D. Leave wire sufficiently long to permit making final connections. In raceway over 50 feet in which

wiring is not installed, furnish pull wire. E. Verify locations of outlets and switches.

F. Support panel, junction and pull boxes independently to building structure with no weight bearing

H. This contractor shall provide a temporary electrical distribution system as required: 120/208 volt, 1 phase, 100 amp, for new construction. All temporary work shall be installed in a neat and safe manner.

I. Contractor to remove and salvage all abandoned electrical equipment. J. This contractor shall warrant all labor and materials for one year from date of final

