
DGMM PROTOTYPE "B" 10,640 SF WITH LEFT REAR DELIVERY STORE NUMBER TBD

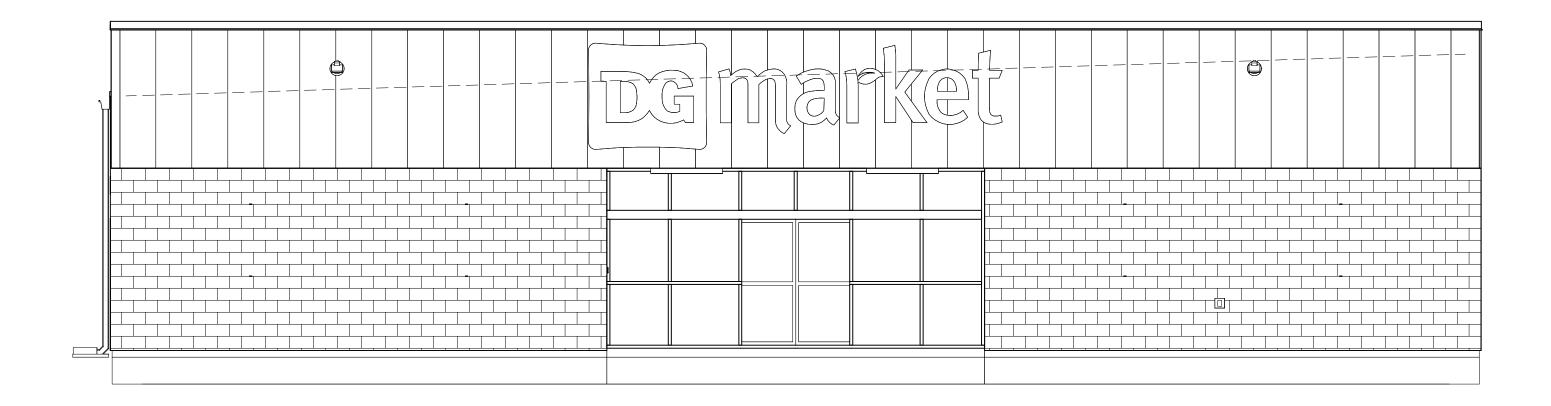



CI.0 SI	TLE SHEET TE PLAN AND DETAILS FE SAFETY PLAN	Rev. 01	Rev. 02	Rev. 03	Rev. 04	Rev. 05
CI.0 SI	TE PLAN AND DETAILS			т_	4	ш.
LSI.0 LI						
LSI.0 LI						
	FE SAFETY PLAN					
FI.O FI						
	XTURE PLAN					
AI.0 FL	OOR PLAN					
	NLARGED PLANS AND ELEVATIONS					
-	EFLECTED CEILING AND CABLE TRAY PLANS					
AI.3 R	OOF PLAN AND PHOTO KEY PLAN					
A2.0 E	KTERIOR ELEVATIONS					
A3.0 SE	ECTIONS					
A3.1 V	VALL SECTIONS					
A3.2 FF	RAMING DETAILS					
A4.0 D	OOR SCHEDULE AND DETAILS					
A4.I IN	ITERIOR ELEVATIONS AND FINISHES					
A5.0 SI	GN ELEVATIONS AND DETAILS					
A5. I SI	GN DETAILS					
SI.O FO	DUNDATION PLAN					
S2.0 FC	DUNDATION DETAILS					
S3.0 S7	TEEL DETAILS					
	OWER PLAN					
-	EFRIGERATION POWER & CABLE TRAY PLAN					
	OOF POWER PLAN					
-	EGISTER POWER POLE					
	GHTING PLAN					
	ECTRICAL PANELS					
	MERGENCY PHOTOMETRIC PLAN MS LOW VOLTAGE PLAN					
	MS PANEL CONTROLS					
_	ADIO TEST GRID PLAN					
i di	-DO IBI GND IDAN					
MI M	ECHANICAL PLAN					
M2 M	ECHANICAL DETAILS					
DO 1	OTTS AND DETAILS					
	OTES AND DETAILS ANITARY PLAN					
	ATER PLAN					

		COMPANY	CONTACT	PHONE / EMAIL	REQUIRED ITEMS					
		RAINBIRD IRRIGATION	LOCAL RAINBIRD DISTRIBUTOR	WWW.RAINBIRD.COM	IRRIGATION SYSTEMS					
	RETE	EUCLID CHEMICAL COMPANY	PHIL BRANDT	877-438-3826 PBrandt@euclidchemical.com	CONCRETE POLISHING SYSTEMS					
	CONCRETE POLISHING	RETRO-PLATE SYSTEMS	SCOTT MAXFIELD	801-641-6796 scott.maxfield@retroplatesystem.com	CONCRETE POLISHING SYSTEMS					
		RECORD DOOR SYSTEMS	MARK DUGO	704-292-5373 dollargeneral@recorddoors.com	MODEL #5100 SERIES AR,DC,DE,IA,IL,IN,KS,KY,LA,MD,MI,MN,MO,ND,NE,NJ,OH,OK,PA,SD,TX,VA,WI,WV					
	STOREFRONT ENTRANCE	STANLEY ACCESS TECHNOLOGIES	THOM CASEY	480-261-1510 DGDOORS@sbdinc.com	MODEL #DG2000 AZ,CA,CO,ID,MT,NM,NV,OR,UT,WA,WY					
	STOR	ASSA ABLOY ENTRANCE SYSTEMS	ROSS MERKLING	609-528-2580 dollargeneral.besam.us@assaabloy.com	MODEL #SL500 AL,CT,FL,GA,MA,ME,MS,NC,NH,NY,RI,SC,TN,VT					
RIOR	RS RS	COOK & BOARDMAN GROUP	JUNE THOMPSON	615-964-6000 ext. 4527 dgteam@cookandboardman.com	INTERIOR DOORS AND FRAMES AND RESTROOM ACCESSORIES AL,AR,AZ,CA,CO,FL,GA,IA,KS,LA,MS,MN,MO,NE,NM,NV,OK,OR,SC,SD,TN,TX,WA,WI,WY					
	INTERIOR DOORS	COOK & BOARDMAN GROUP	JOE HARRELL	336-837-0673 dgteam@cookandboardman.com	INTERIOR DOORS AND FRAMES AND RESTROOM ACCESSORIES CT,DE,IL,IN,KY,MA,MD,ME,MI,NC,NH,NJ,NY,OH,PA,RI,VA,VT,WV					
		SHERWIN WILLIAMS	LOCAL SHERWIN WILLIAMS STORE	678-492-4026 koneill@mccue.com	PAINT, PRIMER, CONCRETE SEALER AND BLOCK FILLER					
		MC CUE CORPORATION	MELISSA HOOD	978-219-5310 mhood@mccue.com	TRIM KIT INCLUDES BUMPER GUARDS AND CART STOP					
		YORK	BOBBY DOYLE	202-380-6430 york-dollargeneral-be@jci.com	HVAC UNITS AR,CA,CO,DC,IL,IN,KY,KS,MO,NV,OH,OK,UT,VA,WV					
	တ	CARRIER	BOB ECKWELLER	973-222-6742 bob.eckweller@carrier.com	HVAC UNITS AL,GA,ID,LA,MS,MT,NC,OR,SC,TN,WA,WY					
	STINU	LENNOX	GARRY BAKER	972-497-6665 lennoxnationalaccounts@lennoxind.com	HVAC UNITS CT,DE,IA,MA,MD,ME,MI,MN,ND,NE,NH,NJ,NY,PA,RI,SD,VT,WI					
	HVAC	DAIKIN NORTH AMERICA	GUY GARCIA	daikinnatlaccts@daikincomfort.com	HVAC UNITS AX,NM,TX					
	တ	ROOF CURB SYSTEMS	CLIFTON REASOR	800-683-5848 DollarGeneral@roofcurb.com	RTU CURB					
	CURBS	CURBS PLUS INC.	ALLAN THRAILKILL	888-639-2872 alan.thrailkill@curbs-plus.com	RTU CURB					
	RTU	KCC INTERNATIONAL INC.	GREG CONRAD	800-382-2872 gconrad@kcccurbs.com	RTU CURB					
	, 플 ~	CED - CONSOLIDATED ELECTRICAL DISTRIBUTORS	TRAVIS LOWE AND HUNTER JURGENS	270-781-2229 travisl or hunterj@cedbgky.com	ELECTRICAL SWITCH GEAR AR,AZ,CA,CO,IA,IL,IN,LA,KS,KY,MI,MN,MO,MS,ND,NE,NM,NV,OK,OR,SD,TX,WA,WI,WY					
	ELEC SWITCH GEAR		ANNE-MARIE SHIAVITTI-SMITH	800-244-6980 dollargeneral@wescodist.com	ELECTRICAL SWITCH GEAR AL,CT,DE,FL,GA,MA,MD,ME,NC,NH,NJ,NY,OH,PA,RI,SC,TN,VA,VT,WV					
		USLED	ROD LEEK	DGUSLED@usled.com	ELECTRICAL LIGHTING SUPPLIES CT,LA,MA,ME,NH,NJ,NY,PA,RI,TX,VT					
		NLES	KYLE KNAPP	920-915-4010 ORDERS@nlesinc.com	ELECTRICAL LIGHTING SUPPLIES DC,DE,FL,GA,IA,IL,IN,KY,MD,MI,MN,MT,NC,ND,OH,SC,SD,TN,VA,WI,WV					
	LIGHTING	CUMBERLAND DISTRIBUTORS	RICHARD MATTHEW	orderfrom@cumberlanddist.com	ELECTRICAL LIGHTING SUPPLIES AL,AR,AZ,CA,CO,ID,KS,MO,MS,NE,NM,NV,OK,OR,UT,WA,WY					
	LIGH	D&P CUSTOM LIGHTING	NATIONAL ACCOUNT SALES	800-251-2200	CUSTOM POWER POLES					
	AGE EM	CROSSCOM NATIONAL	KEN MILLER	847-850-6298 dollargeneral@crosscomnational.com	LOW VOLTAGE & VOICE/DATA CO,DE,FL,IA,ID,IL,IN,KS,MD,ME,MI,MN,MO,ND,NE,NH,NJ,NY,OH,SD,VT,WI,WV,WY					
	LOW VOLTAGE SYSTEM	ASD	KENNY ONDESKO	828-624-1046 dollargeneral@asd-usa.com	LOW VOLTAGE & VOICE/DATA AL,AR,AZ,CA,CT,GA,KY,LA,MA,MS,NC,NM,NV,OK,OR,PA,RI,SC,TN,TX,VA,WA					
L		GRAYBAR	JEROME BANNISTER	615-743-3202 office, 615-924-2135 cell dollargeneral@graybar.com	CABLE TRAY					
		EMERSON CLIMATE TECHNOLOGIES	BRAD KYLE NATIONAL ACCOUNT EXECUTIVE WEBSITE: dollargeneralbid.emerson.com	USER NAME: dollargeneralbid PASSWORD: \$General1	EMS SUPPLIER NOTE: CUSTOMIZED DOLLAR GENERAL EMS PANEL REQUIRES STORE CITY, STATE, ZIP CODE & QTY. OF HVAC UNITS OF THE INSTALL SITE WHEN ORDERING					
		STANLEY CONVERGENT SECURITY SOLUTIONS	D'ETTA NEAVES	858-752-7821 Detta.Neaves@sbdinc.com (pre-sale bid) Al.Maier@sbdinc.com (post-award)	INTERIOR FIRE ALARM PANELS					

NATIONAL ACCOUNT AND CONTACT INFORMATION SUBJECT TO CHANGE

NOTE: DIRECT QUESTIONS ABOUT PROTOTYPE DESIGN CRITERIA TO PROTOTYPE MANAGEMENT TEAM AT MJM ARCHITECTS, 615-244-8170, dg@mjmarch.com AND g.conway@mjmarch.com. SEE www.mjmarch.com AND www.entechtn.com FOR MORE INFORMATION ON PROTOTYPE MANAGEMENT TEAM.

PROJECT TEAM

ARCHITECT:

ARCHITECTURE + INTERIORS

LEVEL ARCHITECTURE + INTERIORS

1459 SW 74TH DR

LEVEL ARCHITECTURE + INTERIORS 1459 SW 74TH DR GAINESVILLE, FL 32607 P: 352.448.7788

GENERAL CONTRACTOR:



CONCEPT CONSTRUCTION OF NORTH FLORIDA, DBA THEORY CONSTRUCTION 3324 W. UNIVERSITY AVE., PMB 151 GAINESVILLE, FL 32607 P: 352.333.3233



Professional Consultants
CHW, PROFESSIONAL CONSULTANTS DBA
11801 RESEARCH DR
ALACHUA, FL 32615
P: 352.331.1976

STRUCTURAL ENGINEER:



BELT EGINEERING 1503-A WEST BUSCH BLVD TAMPA, FL 33612 P: 813.961.3075

MECHANIAL/ELECTRICAL/PLUMBING ENGINEER:



HUNTER DESIGN & CONSULTING 696 1ST AVE N.; STE 200 ST PETERSBURG, FL 33701 P: 352.238.6366


OCCUPANCY CLASSIFICATION	MERCANTILE GROUP
CONSTRUCTION TYPE	(II
WIND LOAD CRITERIA (PER 1603.1.4)	
BASIC WIND SPEED	120 VUI
RISK CATEGORY	
EXPOSURE TYPE	
EXPOSURE CLASSIFICATION	CLOSE
COMPONENTS AND CLADDING	
WIND IMPORTANCE FACTOR	1.0 (21'-0" BLDG HEIGH
INTERNAL PRESSURE COEFFICIENT	± 0.
CODES TO BE ADHERED TO AT TIME OF CON	STRUCTION
2023 FL BUILDING CODE, BUILDING	8TH EDITIC
2023 FL BUILDING CODE, FUEL GAS	8TH EDITIC
2023 FL BUILDING CODE, MECHANICAL	8TH EDITIC
2023 FL BUILDING CODE, PLUMBING	8TH EDITIC
2023 FL BUILDING CODE, ACCESSIBILITY	8TH EDITIC
2023 FL BUILDING CODE, ENERGY CONSERVA	ATION 8TH EDITIC
FLORIDA FIRE PREVENTION CODE	7TH EDITIC
2017 NATIONAL ELECTRIC CODE	NFPA 70-


NOTES:

- THIS IS A MIXED OCCUPANCY, NON-SEPARATED BUILDING
 THIS BUILDING DOES NOT REQUIRE A FIRE SPRINKLER SYSTEM.
 THE ROOF CONSTRUCTION IS A LIGHT GAUGE STEEL FRAME
 METAL BUILDING AND IS THEREFORE CONSIDERED A LIGHTFRAME TRUSS TYPE CONSTRUCTION.
- FRAME TRUSS TYPE CONSTRUCTION.
 BUILDING MUST COMPLY WITH ALL BUILDING (FEDERAL, STATE
 & LOCAL), FIRE, ADA, AND HEALTH DEPARTMENT CODES.
- NO TAPERED COLUMNS ALLOWED.

 MAINTAIN INTERIOR CLEAR SALES SPACE AS REQUIRED ON PLANS.



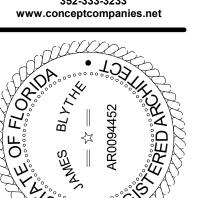

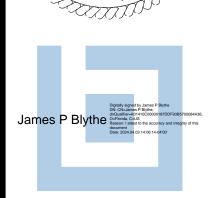





FORT WHITE, FL 32038

REVISIONS
D: DATE: REF:

DRAWING STATUS:
PERMIT SET


| ISSUE DATE: 04.05.2024 | | CHECKED BY: |

PROJECT NUMBER:
4000.249

DRAWING TITLE:
TITLE SHEET

T1.0

3/29/2024 7:57:15 AM

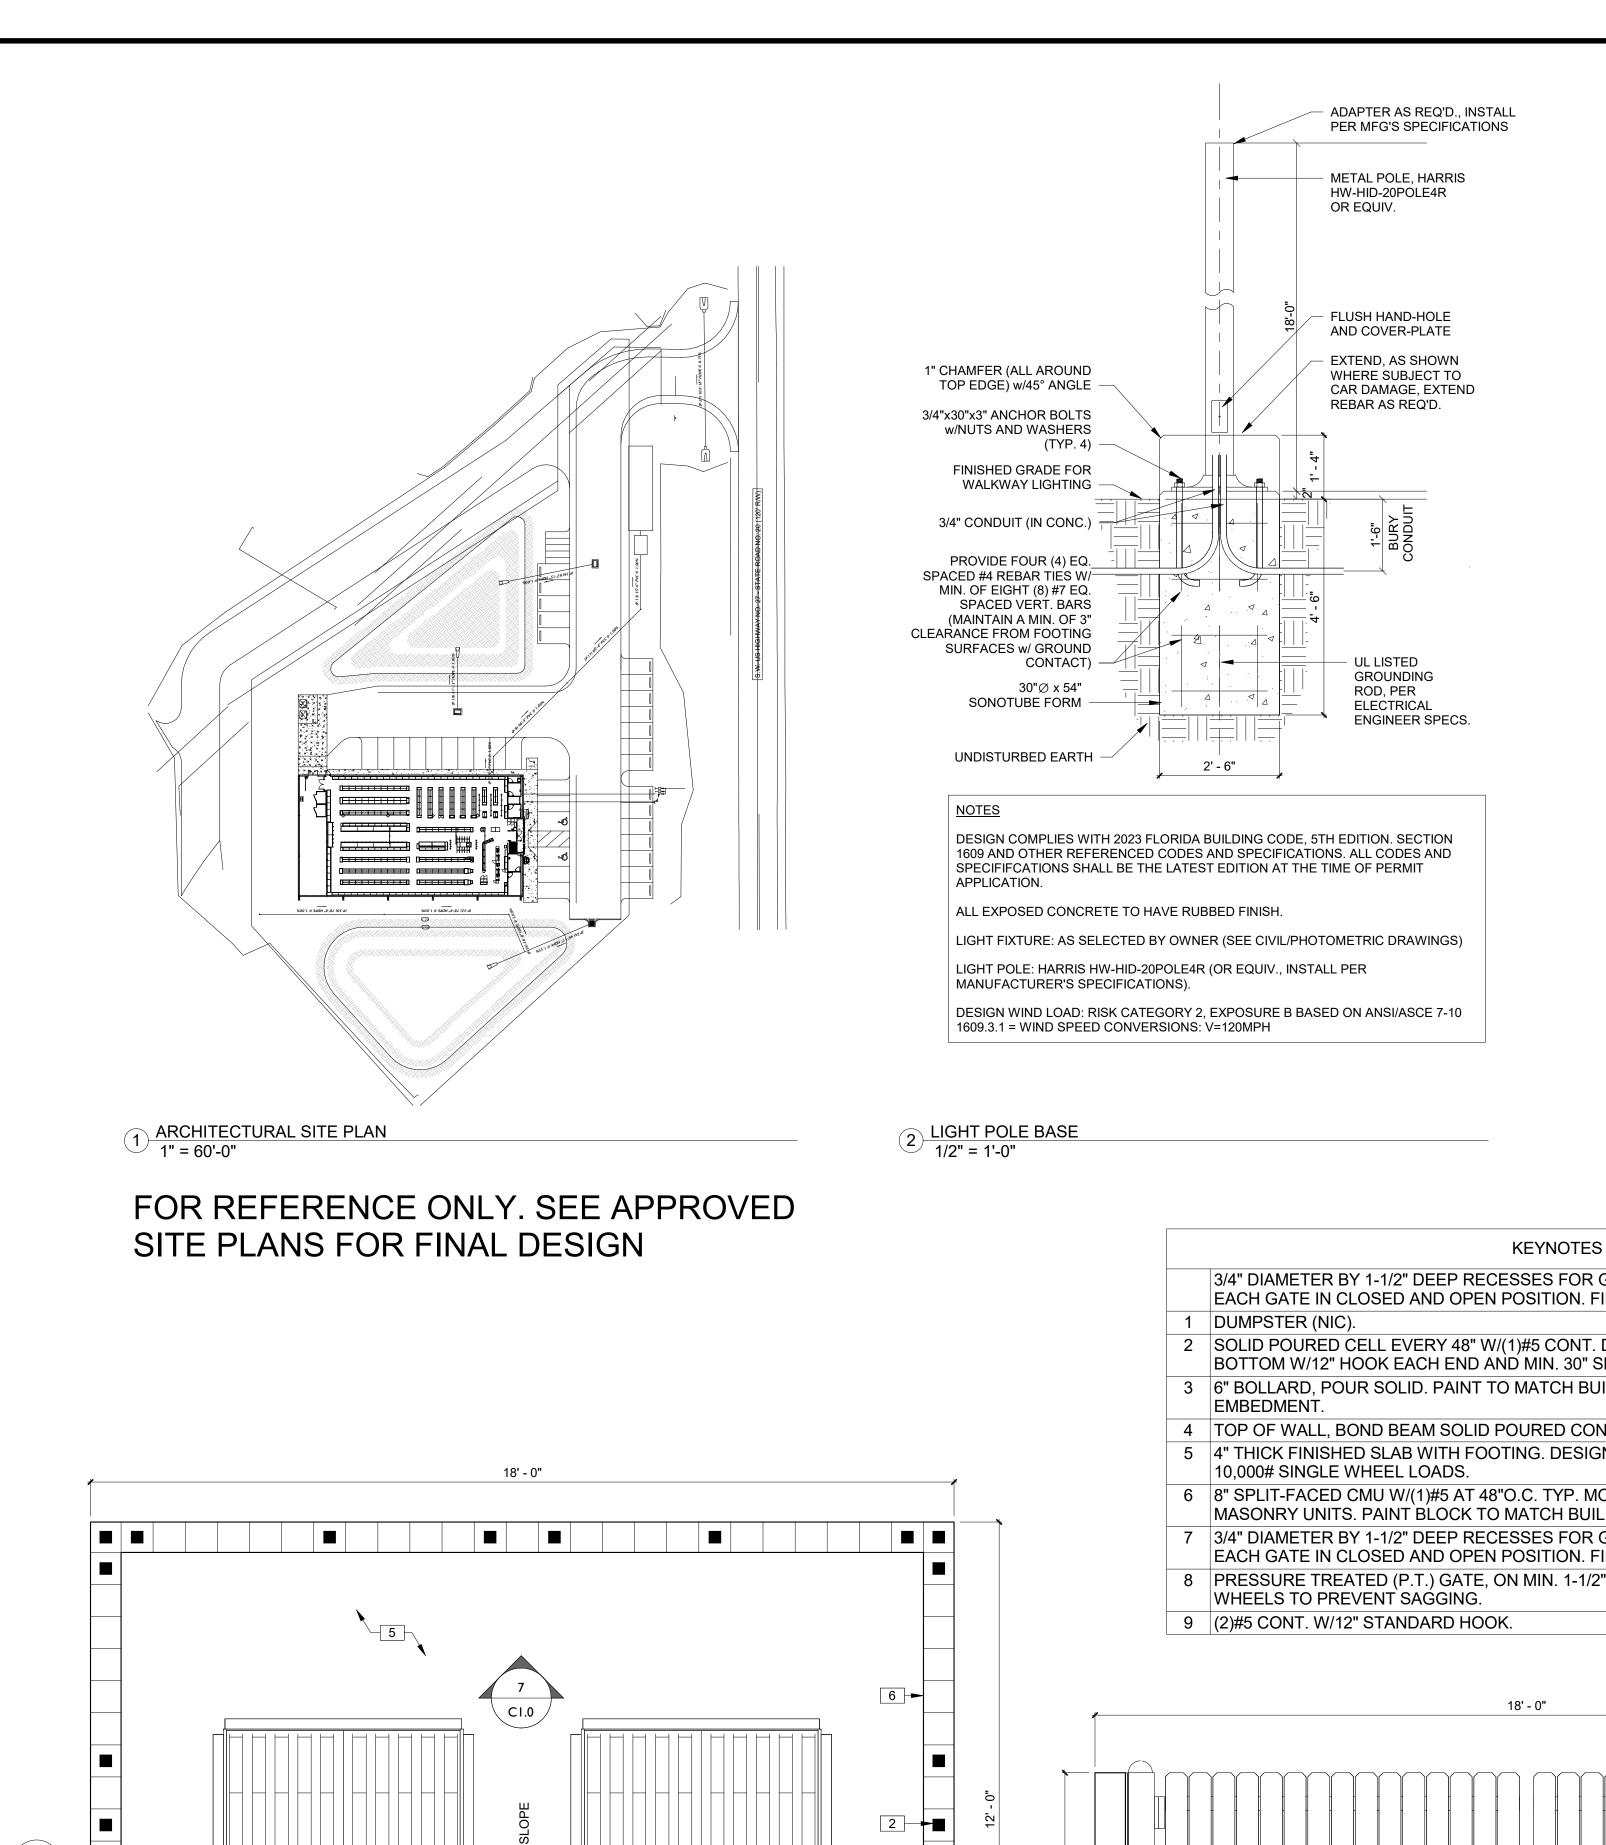


4 DUMPSTER ENCLOSURE PLAN

1/2" = 1'-0"

1' - 8"

1/2" = 1'-0"


5 DUMPSTER ELEVATION

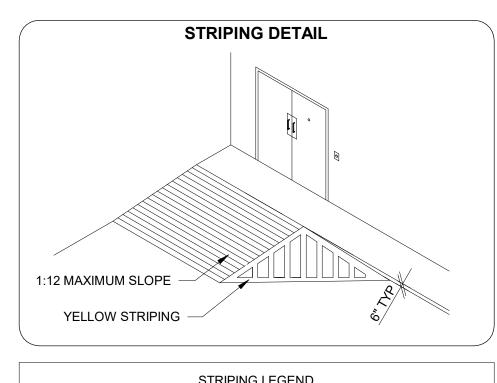

	STRIPING LEGEND
YELLOW CURBING AND BOLLARDS - PARKING LOT	SURFACES SHOULD BE CLEAN, DRY, AND METAL SURFACES FREE OF HEAVY RUST. TWO COATS SHERWIN WILLIAMS KEM4000 ACRYLIC ALKYD ENAMEL SAFETY YELLOW B55Y300.
STRIPING - PARKING LOT	SURFACES SHOULD BE CLEAN, DRY. TOP COAT SHERWIN WILLIAMS PROMAR TRAFFIC MARKING PAINT YELLOW TM5495.
HANDICAP STRIPING - PARKING LOT	SURFACES SHOULD BE CLEAN, DRY. TOP COAT SHERWIN WILLIAMS PROMAR TRAFFIC MARKING PAINT "H.C." BLUE.

CONTRACTOR IS RESPONSIBLE FOR ALL PUBLIC UTILITY CONNECTIONS (ELECTRIC, WATER, GAS, SEPTIC, SEWER) AS WELL AS PROVIDING ALL INFRASTRUCTURES REQUIRED BY UTILITY COMPANY.

FOR REFERENCE ONLY. SEE SIGNED AND SEALED CIVIL ENGINEERING PLANS.

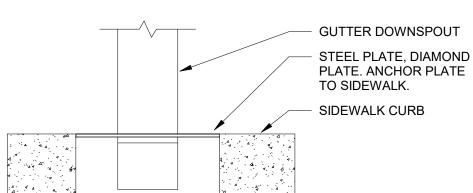

1' - 8"

1' - 8"

6 DUMPSTER SECTION


DOWNSPOUT AT SIDEWALK



CONCRETE SHALL BE STANDARD MIX F'c=3000 PSI FOR ALL FOOTINGS AND SLABS OR SHALL BE STANDARD PUMP MIX F'x=3000 PSI. STRENGTH SHALL BE ATTAINED WITHIN 28 DAYS OF PLACEMENT. MIXING, PLACING, AND FINISHING SHALL BE PER ACI STANDARDS.

CONCRETE SHALL BE PER MANUFACTURER'S PRODUCT GUIDE ASTM C-90 REQUIREMENTS WITH MEDIUM SURFACE FINISH.

MORTAR SHALL BE TYPE 'M' OR 'N' FOR ALL MASONRY UNITS.

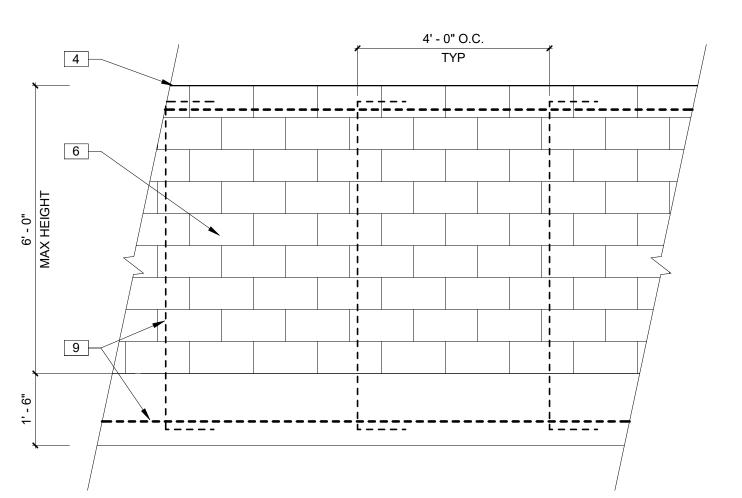

REBAR ELEVATION 1/2" = 1'-0"

REVISIONS

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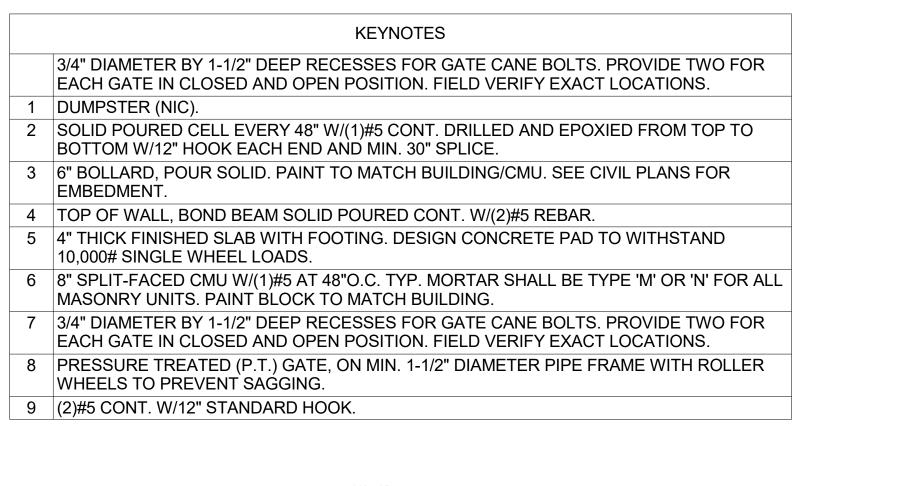
ISSUE DATE: 04.05.2024 DRAWN BY: CHECKED BY

PROJECT NUMBER: 4000.249 **DRAWING TITLE:**


SITE PLAN AND DETAILS

SHEET NO.

3/29/2024 7:57:19 AM



14' - 8"

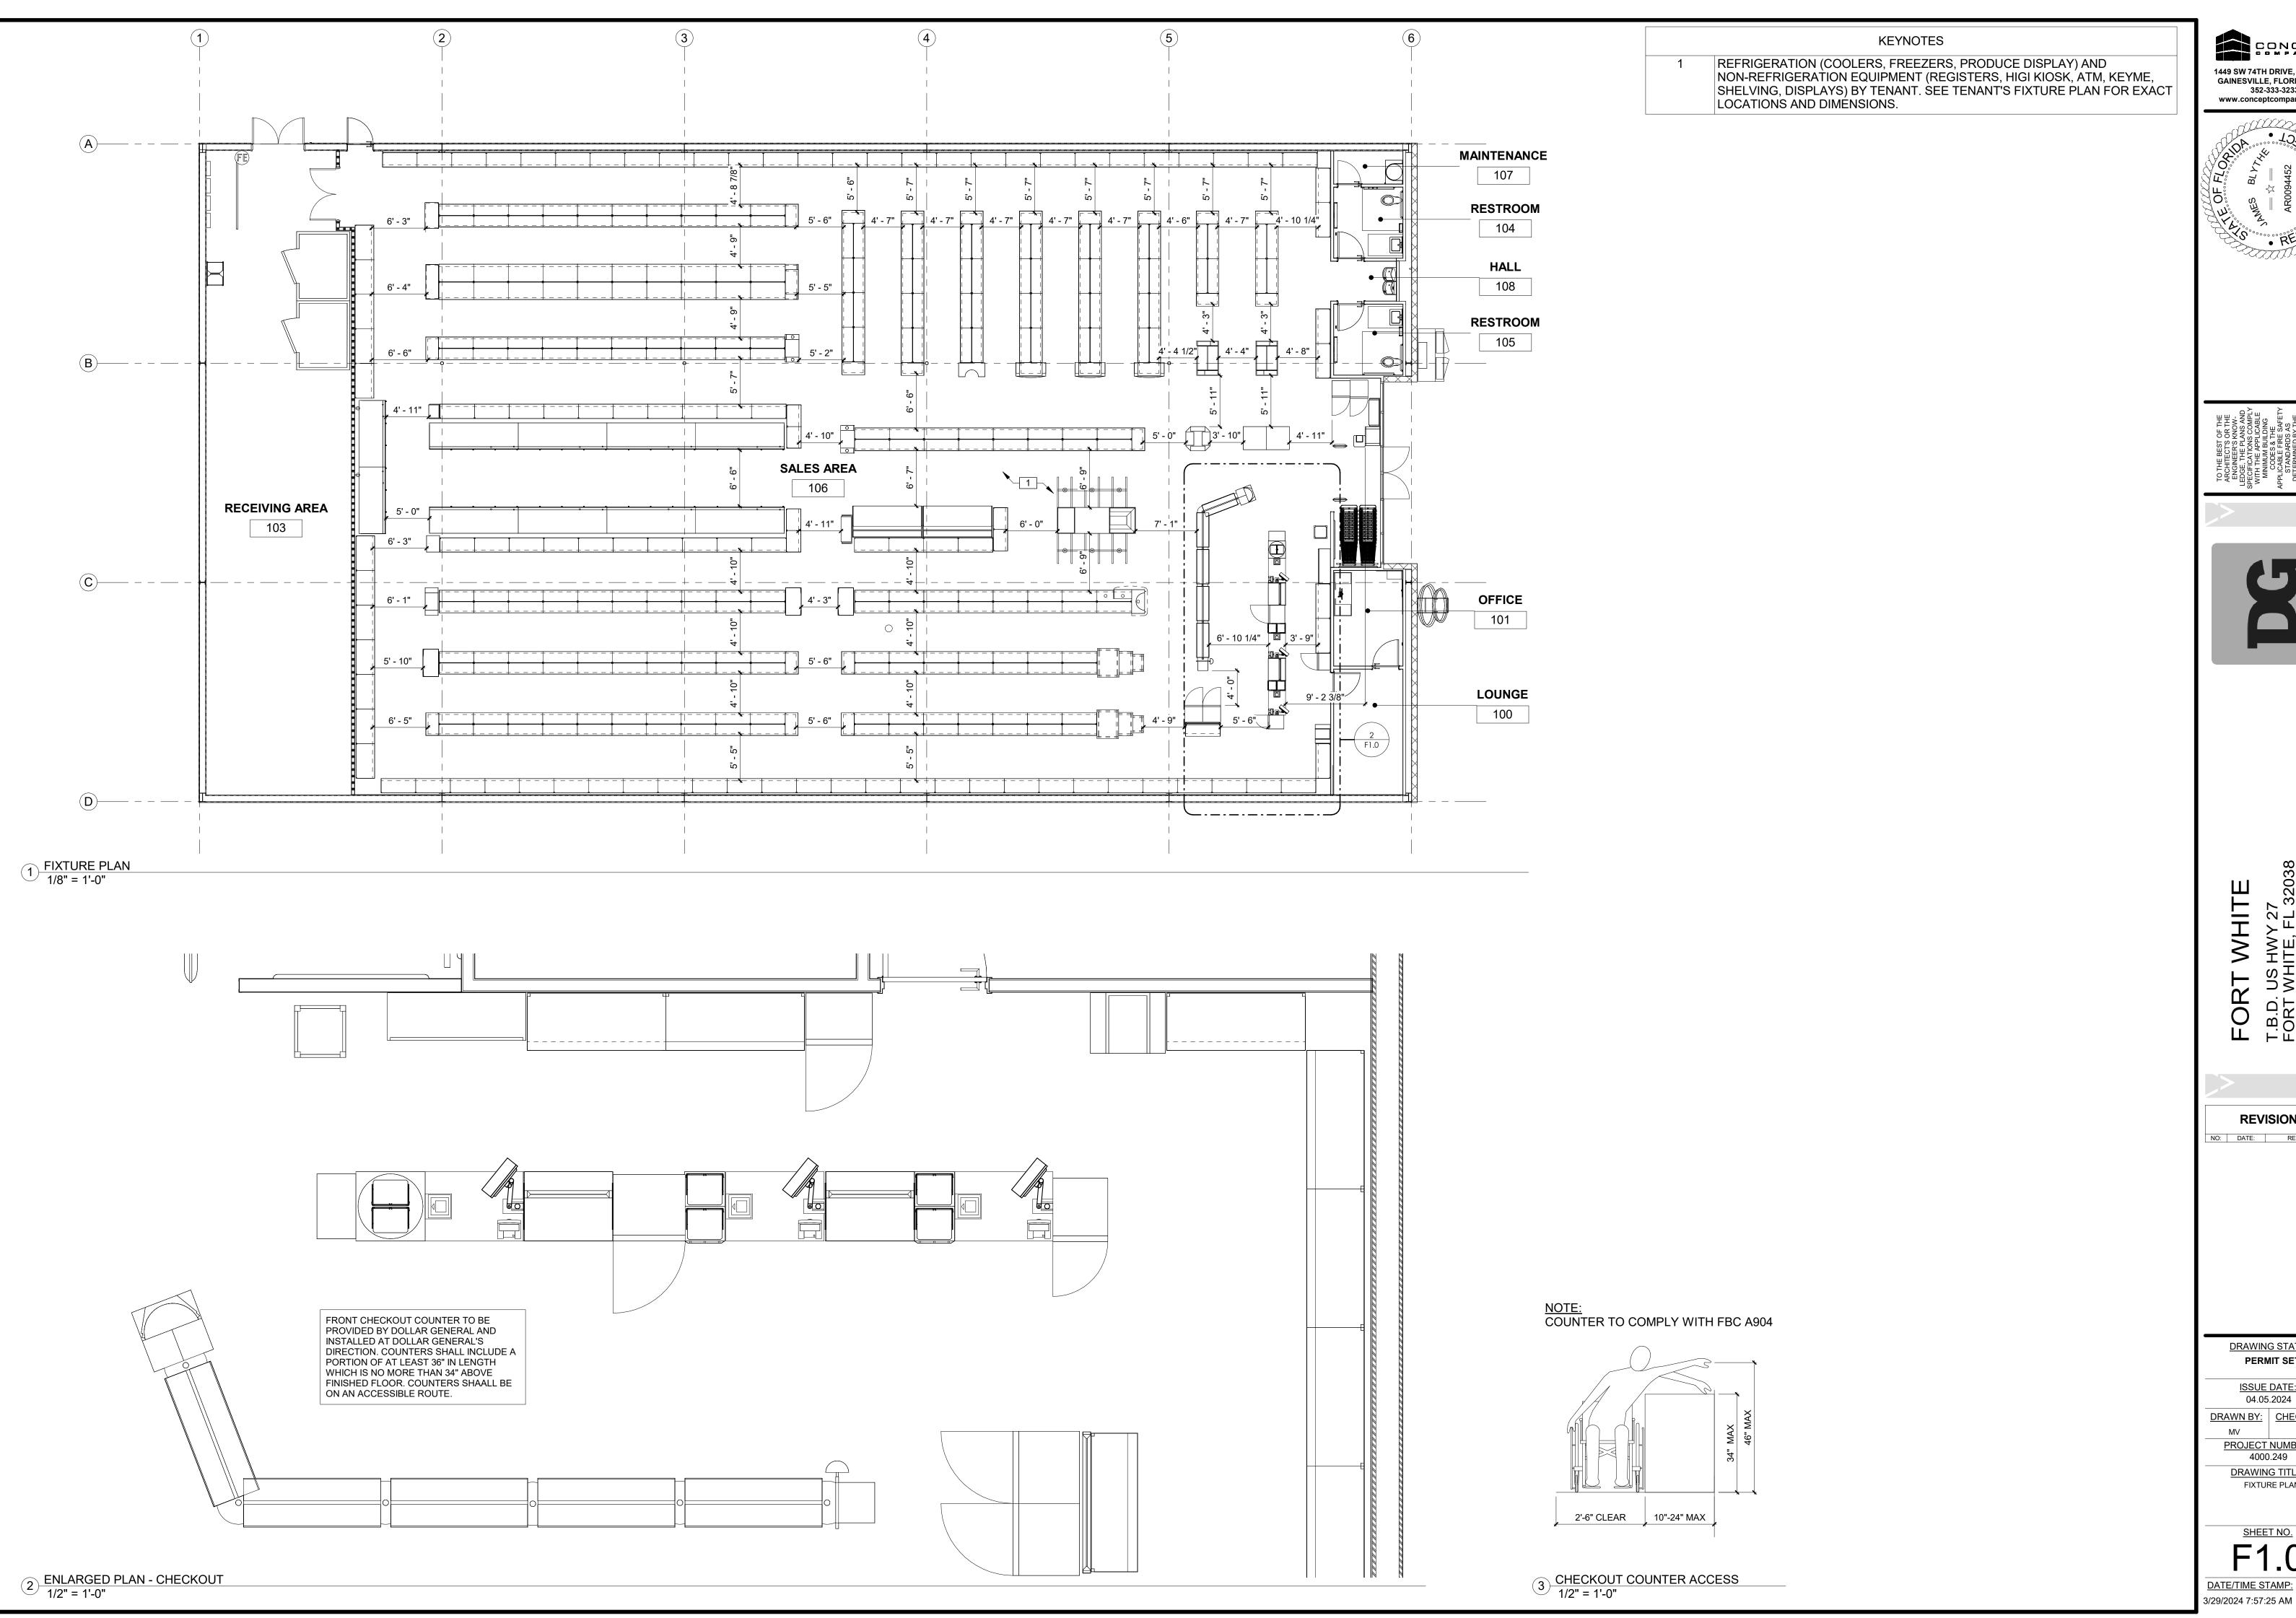

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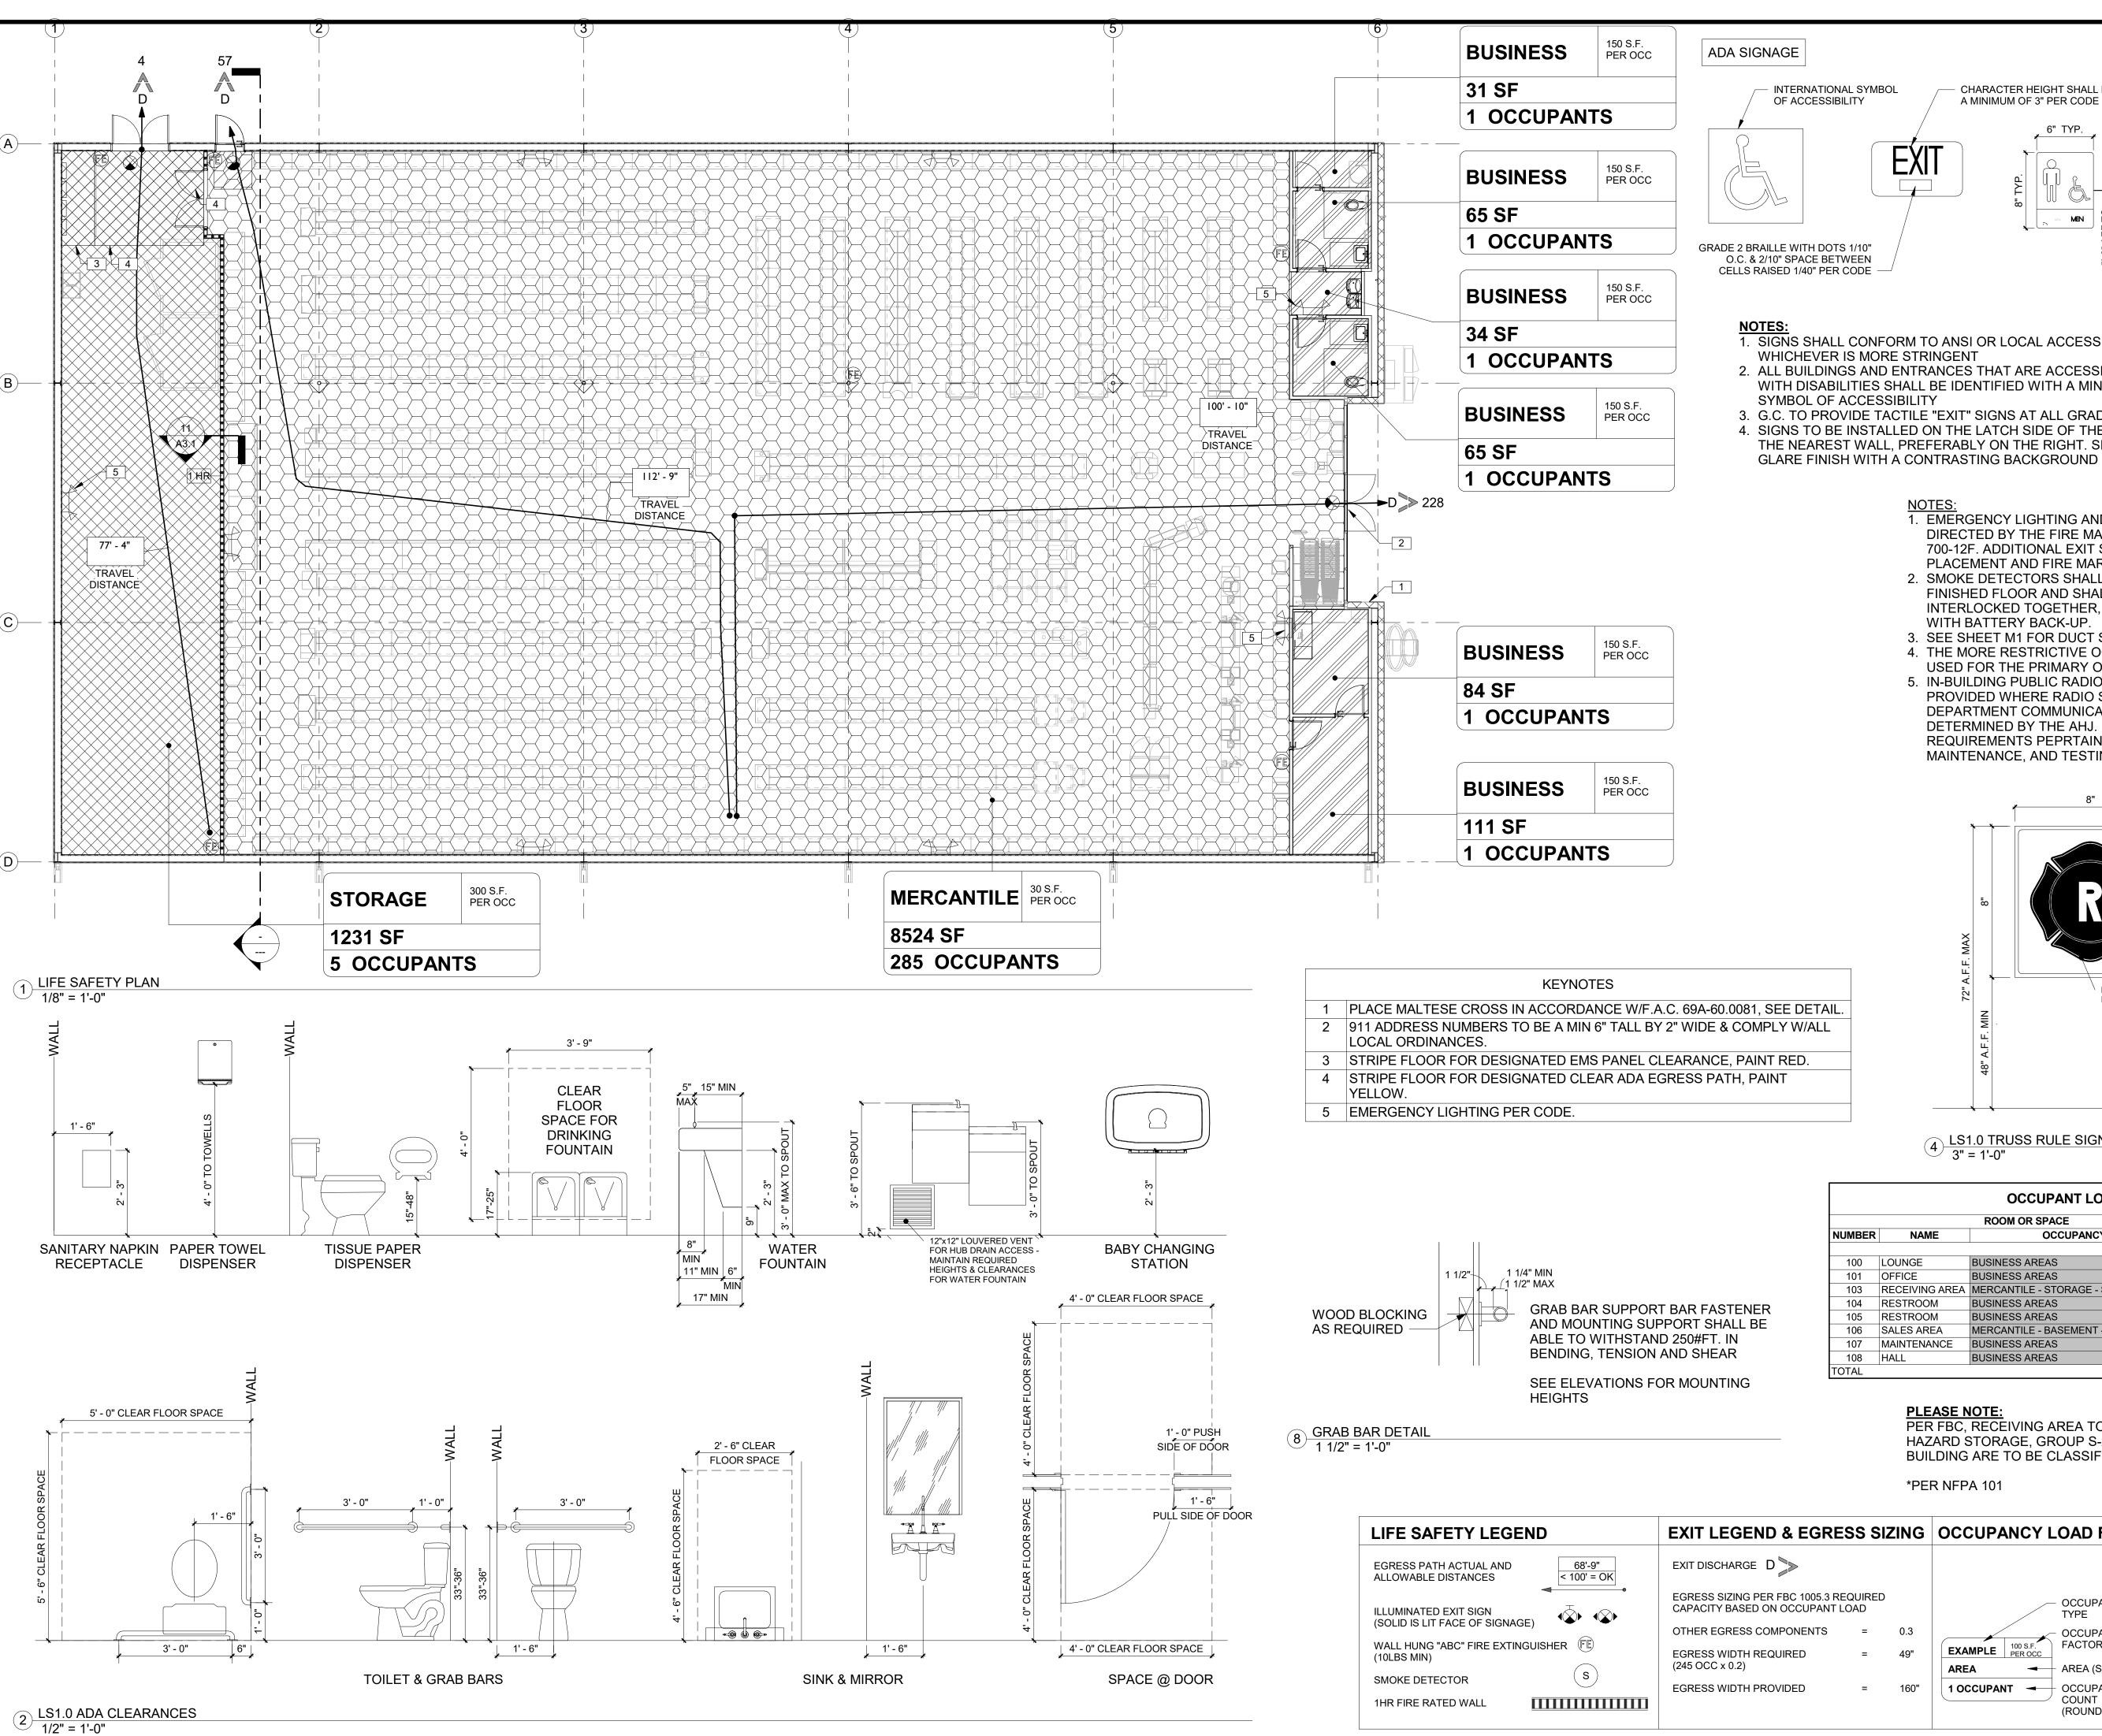
ISSUE DATE:

04.05.2024 DRAWN BY: CHECKED BY:

PROJECT NUMBER: 4000.249

DRAWING TITLE: FIXTURE PLAN

SHEET NO.



INTERNATIONAL SYMBOL CHARACTER HEIGHT SHALL BE A MINIMUM OF 3" PER CODE **RAISED GENDER** SYMBOLS (TYP) RAISED DISABLED SYMBOLS (TYP) RAISED GENDER TEXT (TYP) - RAISED BRAILLE GENDER TEXT (TYP) 9" FROM DOOR FRAME TO CENTER OF SIGN


1. SIGNS SHALL CONFORM TO ANSI OR LOCAL ACCESSIBILITY GUIDELINES WHICHEVER IS MORE STRINGENT

- 2. ALL BUILDINGS AND ENTRANCES THAT ARE ACCESSIBLE & USABLE BY PERSONS WITH DISABILITIES SHALL BE IDENTIFIED WITH A MINIMUM OF ONE INTERNATIONAL
- 3. G.C. TO PROVIDE TACTILE "EXIT" SIGNS AT ALL GRADE LEVEL DOORS 4. SIGNS TO BE INSTALLED ON THE LATCH SIDE OF THE DOOR OR IF NO SPACE, ON THE NEAREST WALL, PREFERABLY ON THE RIGHT. SIGNAGE SHALL HAVE A NON-

- 1. EMERGENCY LIGHTING AND EXIT SIGNS SHALL BE PROVIDED AS DIRECTED BY THE FIRE MARSHALL AND SHALL BE WIRE PER NEC 700-12F. ADDITIONAL EXIT SIGNS MAY BE ADDED AFTER FIXTURE PLACEMENT AND FIRE MARSHALL INSPECTION.
- 2. SMOKE DETECTORS SHALL BE MOUNTED NOT LESS THAN 90" ABOVE FINISHED FLOOR AND SHALL BE THE IONIZATION TYPE, INTERLOCKED TOGETHER, POWERED FROM EACH STORE PANEL WITH BATTERY BACK-UP.

3. SEE SHEET M1 FOR DUCT SMOKE DETECTORS.

- 4. THE MORE RESTRICTIVE OCCUPANT LOAD PER THE FBC WILL BE USED FOR THE PRIMARY OCCUPANT LOAD.
- 5. IN-BUILDING PUBLIC RADIO ENHANCEMENT SYSTEM SHALL BE PROVIDED WHERE RADIO SIGNAL STRENGTH FOR FIRE DEPARTMENT COMMUNICATION IS NOT ACHIEVED AT A LEVEL DETERMINED BY THE AHJ. FOR ADDITIONAL SPECIFIC REQUIREMENTS PEPRTAINING TO SIGNAL STRENGTH, COVERAGE MAINTENANCE, AND TESTING REFER TO NFPA 72-14.4.12 AND 24.5.2

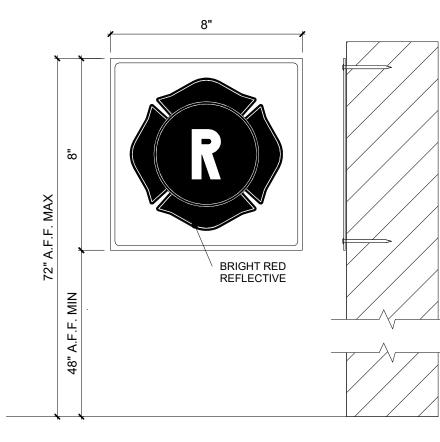

4 LS1.0 TRUSS RULE SIGN 3" = 1'-0"

	OCCUPANT LOAD TABLE											
ROOM OR SPACE OCCUP												
NUMBER	NAME	OCCUPANCY	AREA	DENSITY	CALCULATED							
100	LOUNGE	BUSINESS AREAS	115 SF	150 SF	1							
101	OFFICE	BUSINESS AREAS	88 SF	150 SF	1							
103	RECEIVING AREA	MERCANTILE - STORAGE - STOCK	1,231 SF	300 SF	5							
104	RESTROOM	BUSINESS AREAS	65 SF	150 SF	1							
105	RESTROOM	BUSINESS AREAS	65 SF	150 SF	1							
106	SALES AREA	MERCANTILE - BASEMENT - GRADE	8,524 SF	30 SF	285							
107	MAINTENANCE	BUSINESS AREAS	30 SF	150 SF	1							
108	HALL	BUSINESS AREAS	34 SF	150 SF	1							
TOTAL			•		296							

PLEASE NOTE:

PER FBC, RECEIVING AREA TO BE CLASSIFIED AS LOW HAZARD STORAGE, GROUP S-2. ALL NON-SALES AREA OF THE BUILDING ARE TO BE CLASSIFIED AS BUSSINESS, GROUP B

*PER NFPA 101

LIFE SAFETY LEGEND	EXIT LEGEND & EGRESS SIZING	OCCUPANCY LOAD FACTOR	OCCUPANCY TYPE:
EGRESS PATH ACTUAL AND ALLOWABLE DISTANCES 68'-9" < 100' = OK	EXIT DISCHARGE D		PHOINT OF (D)
ILLUMINATED EXIT SIGN (SOLID IS LIT FACE OF SIGNAGE)	EGRESS SIZING PER FBC 1005.3 REQUIRED CAPACITY BASED ON OCCUPANT LOAD	OCCUPANCY TYPE	BUSINESS (B) 1/100 gsf
WALL HUNG "ABC" FIRE EXTINGUISHER (10LBS MIN)	OTHER EGRESS COMPONENTS = 0.3 EGRESS WIDTH REQUIRED = 49"	EXAMPLE 100 S.F. PER OCC PANT LOAD FACTOR	STORAGE (S) 1/300 gsf
SMOKE DETECTOR S	(245 OCC x 0.2) EGRESS WIDTH PROVIDED = 160"	AREA AREA (SQ FT) 1 OCCUPANT OCCUPANCY	MERCANTILE (M) 1/30 gsf
1HR FIRE RATED WALL		COUNT (ROUNDED)	

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WHITE ORT

REVISIONS NO: DATE:

> **DRAWING STATUS:** PERMIT SET


ISSUE DATE: 04.05.2024

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DRAWING TITLE: LIFE SAFETY PLAN

SHEET NO.

3/29/2024 7:58:15 AM

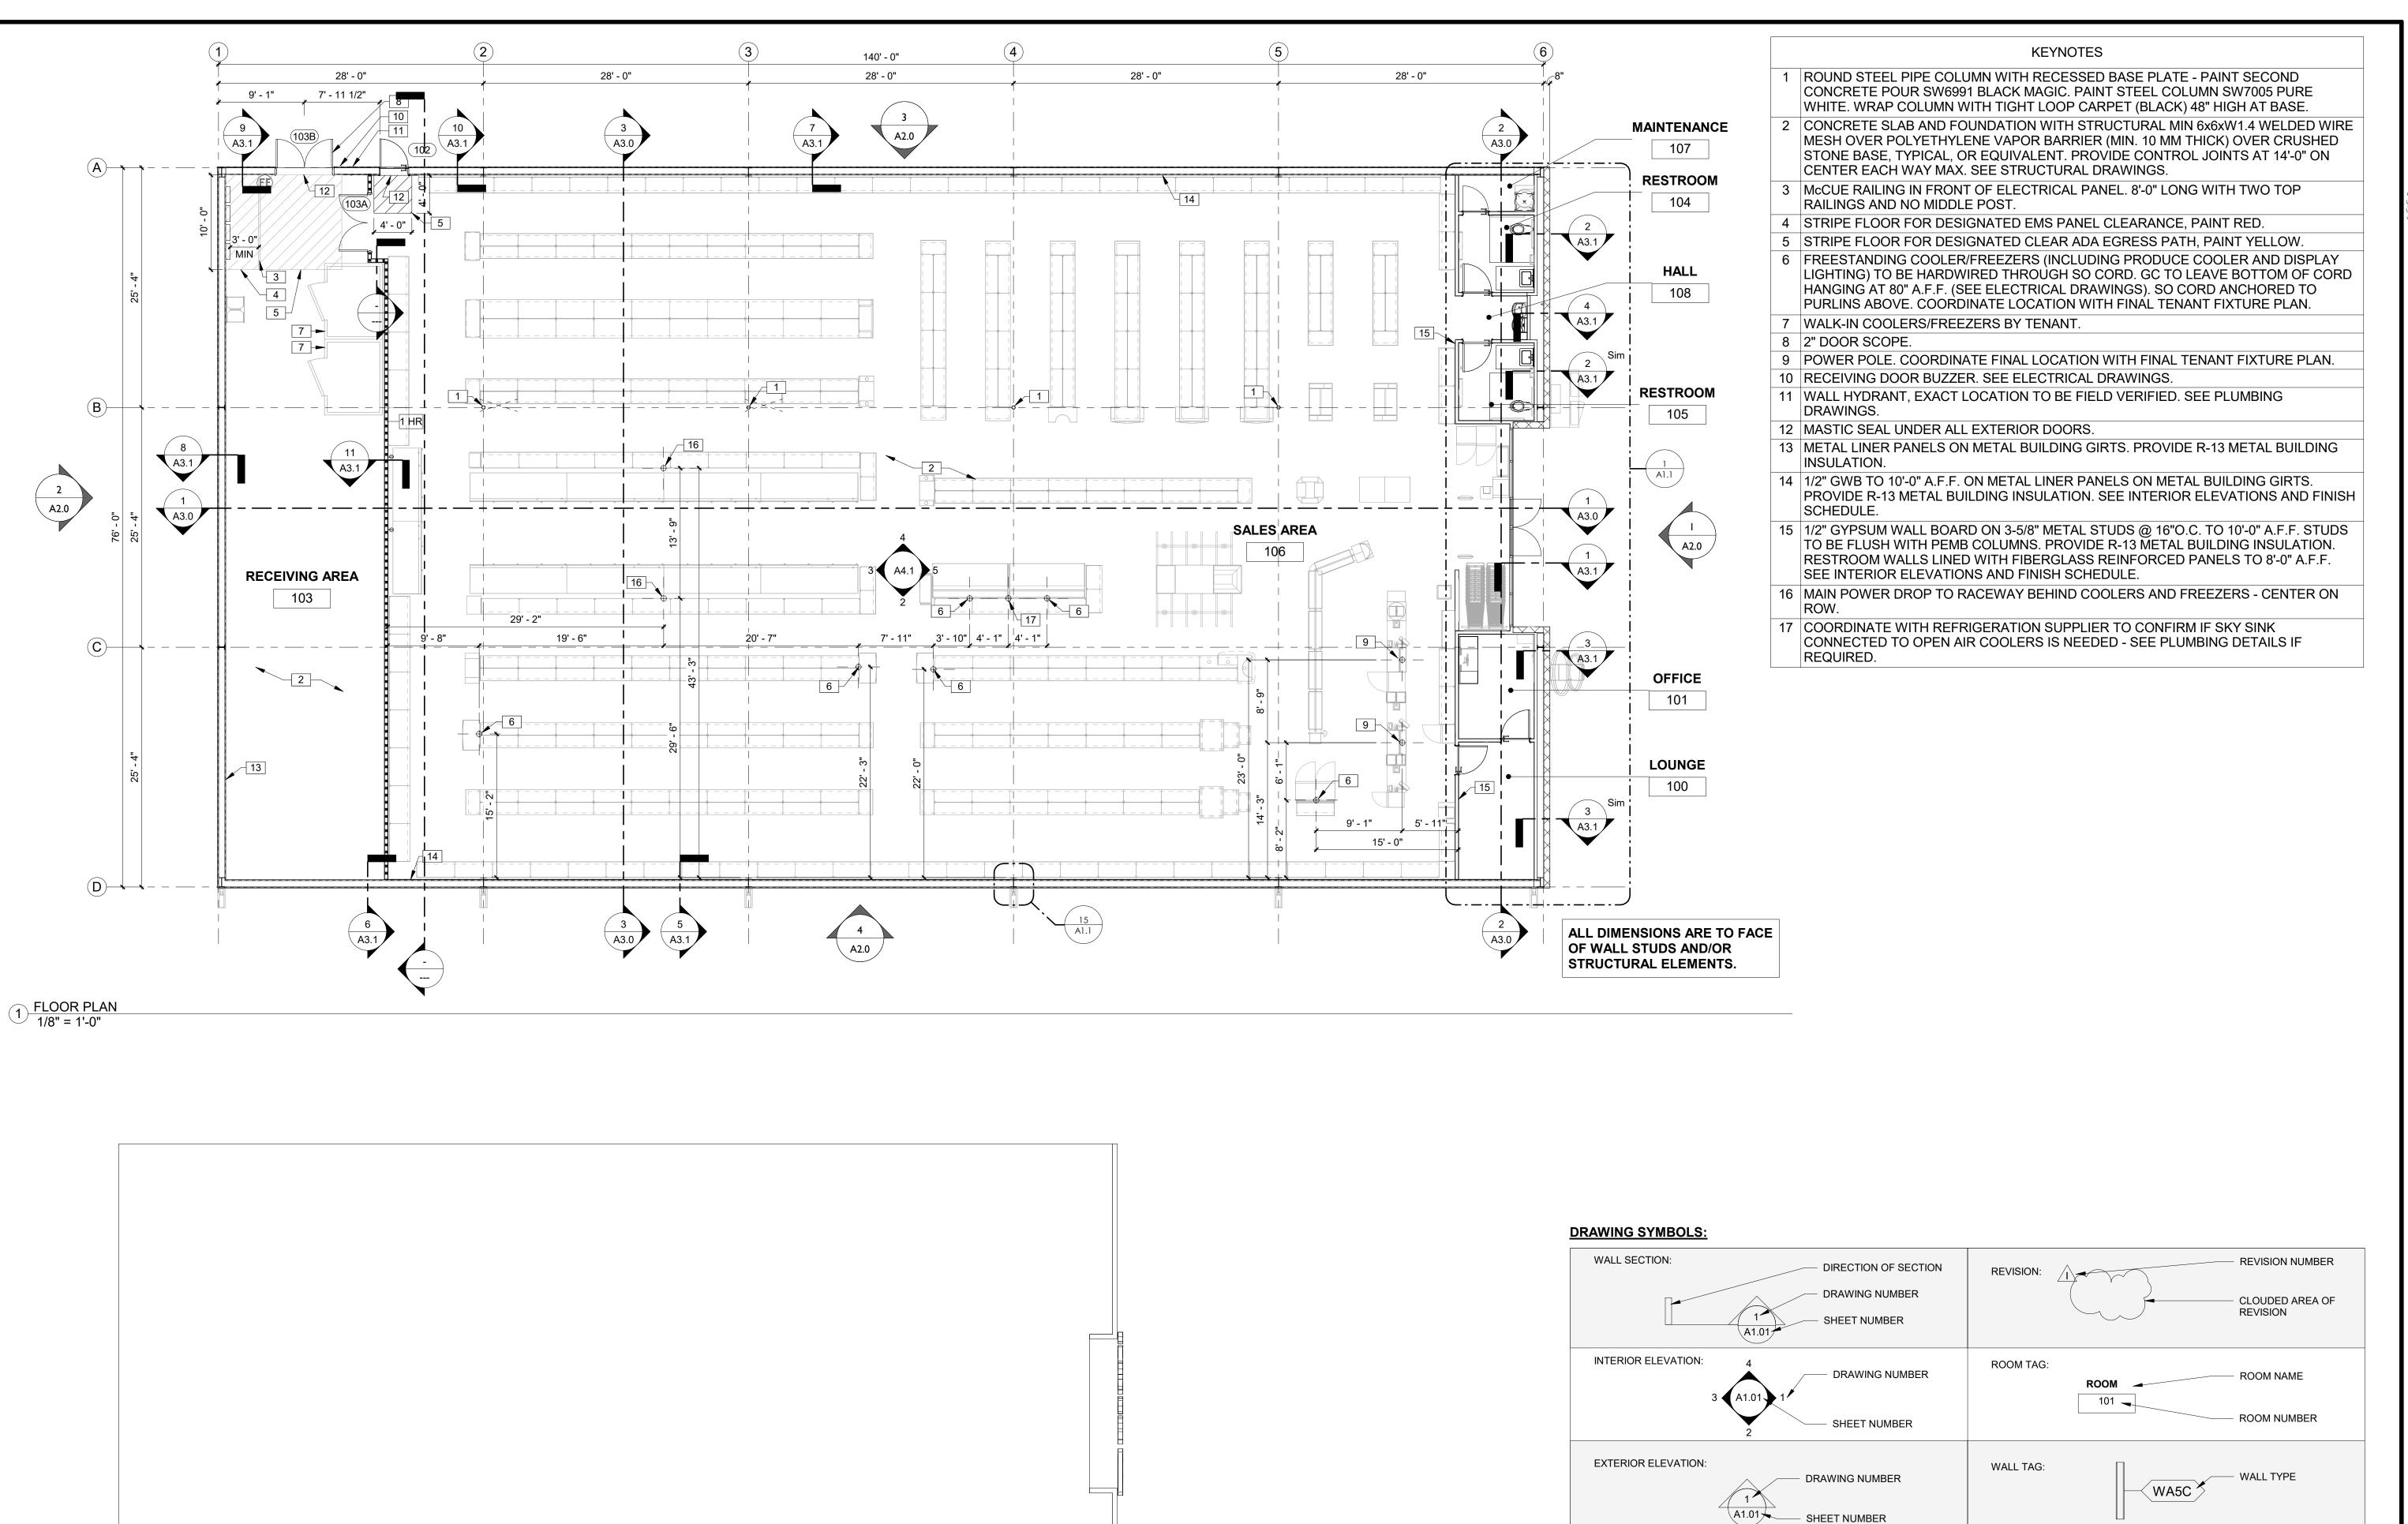

2) FIELD VERIFICATION PLAN

ELEVATION REFERENCE:

ENLARGED PLAN OR

LEVEL 1 🛶


LEVEL DESCRIPTION

DRAWING NUMBER

A1.01 SHEET NUMBER

DOOR ASSEMBLY TAG:

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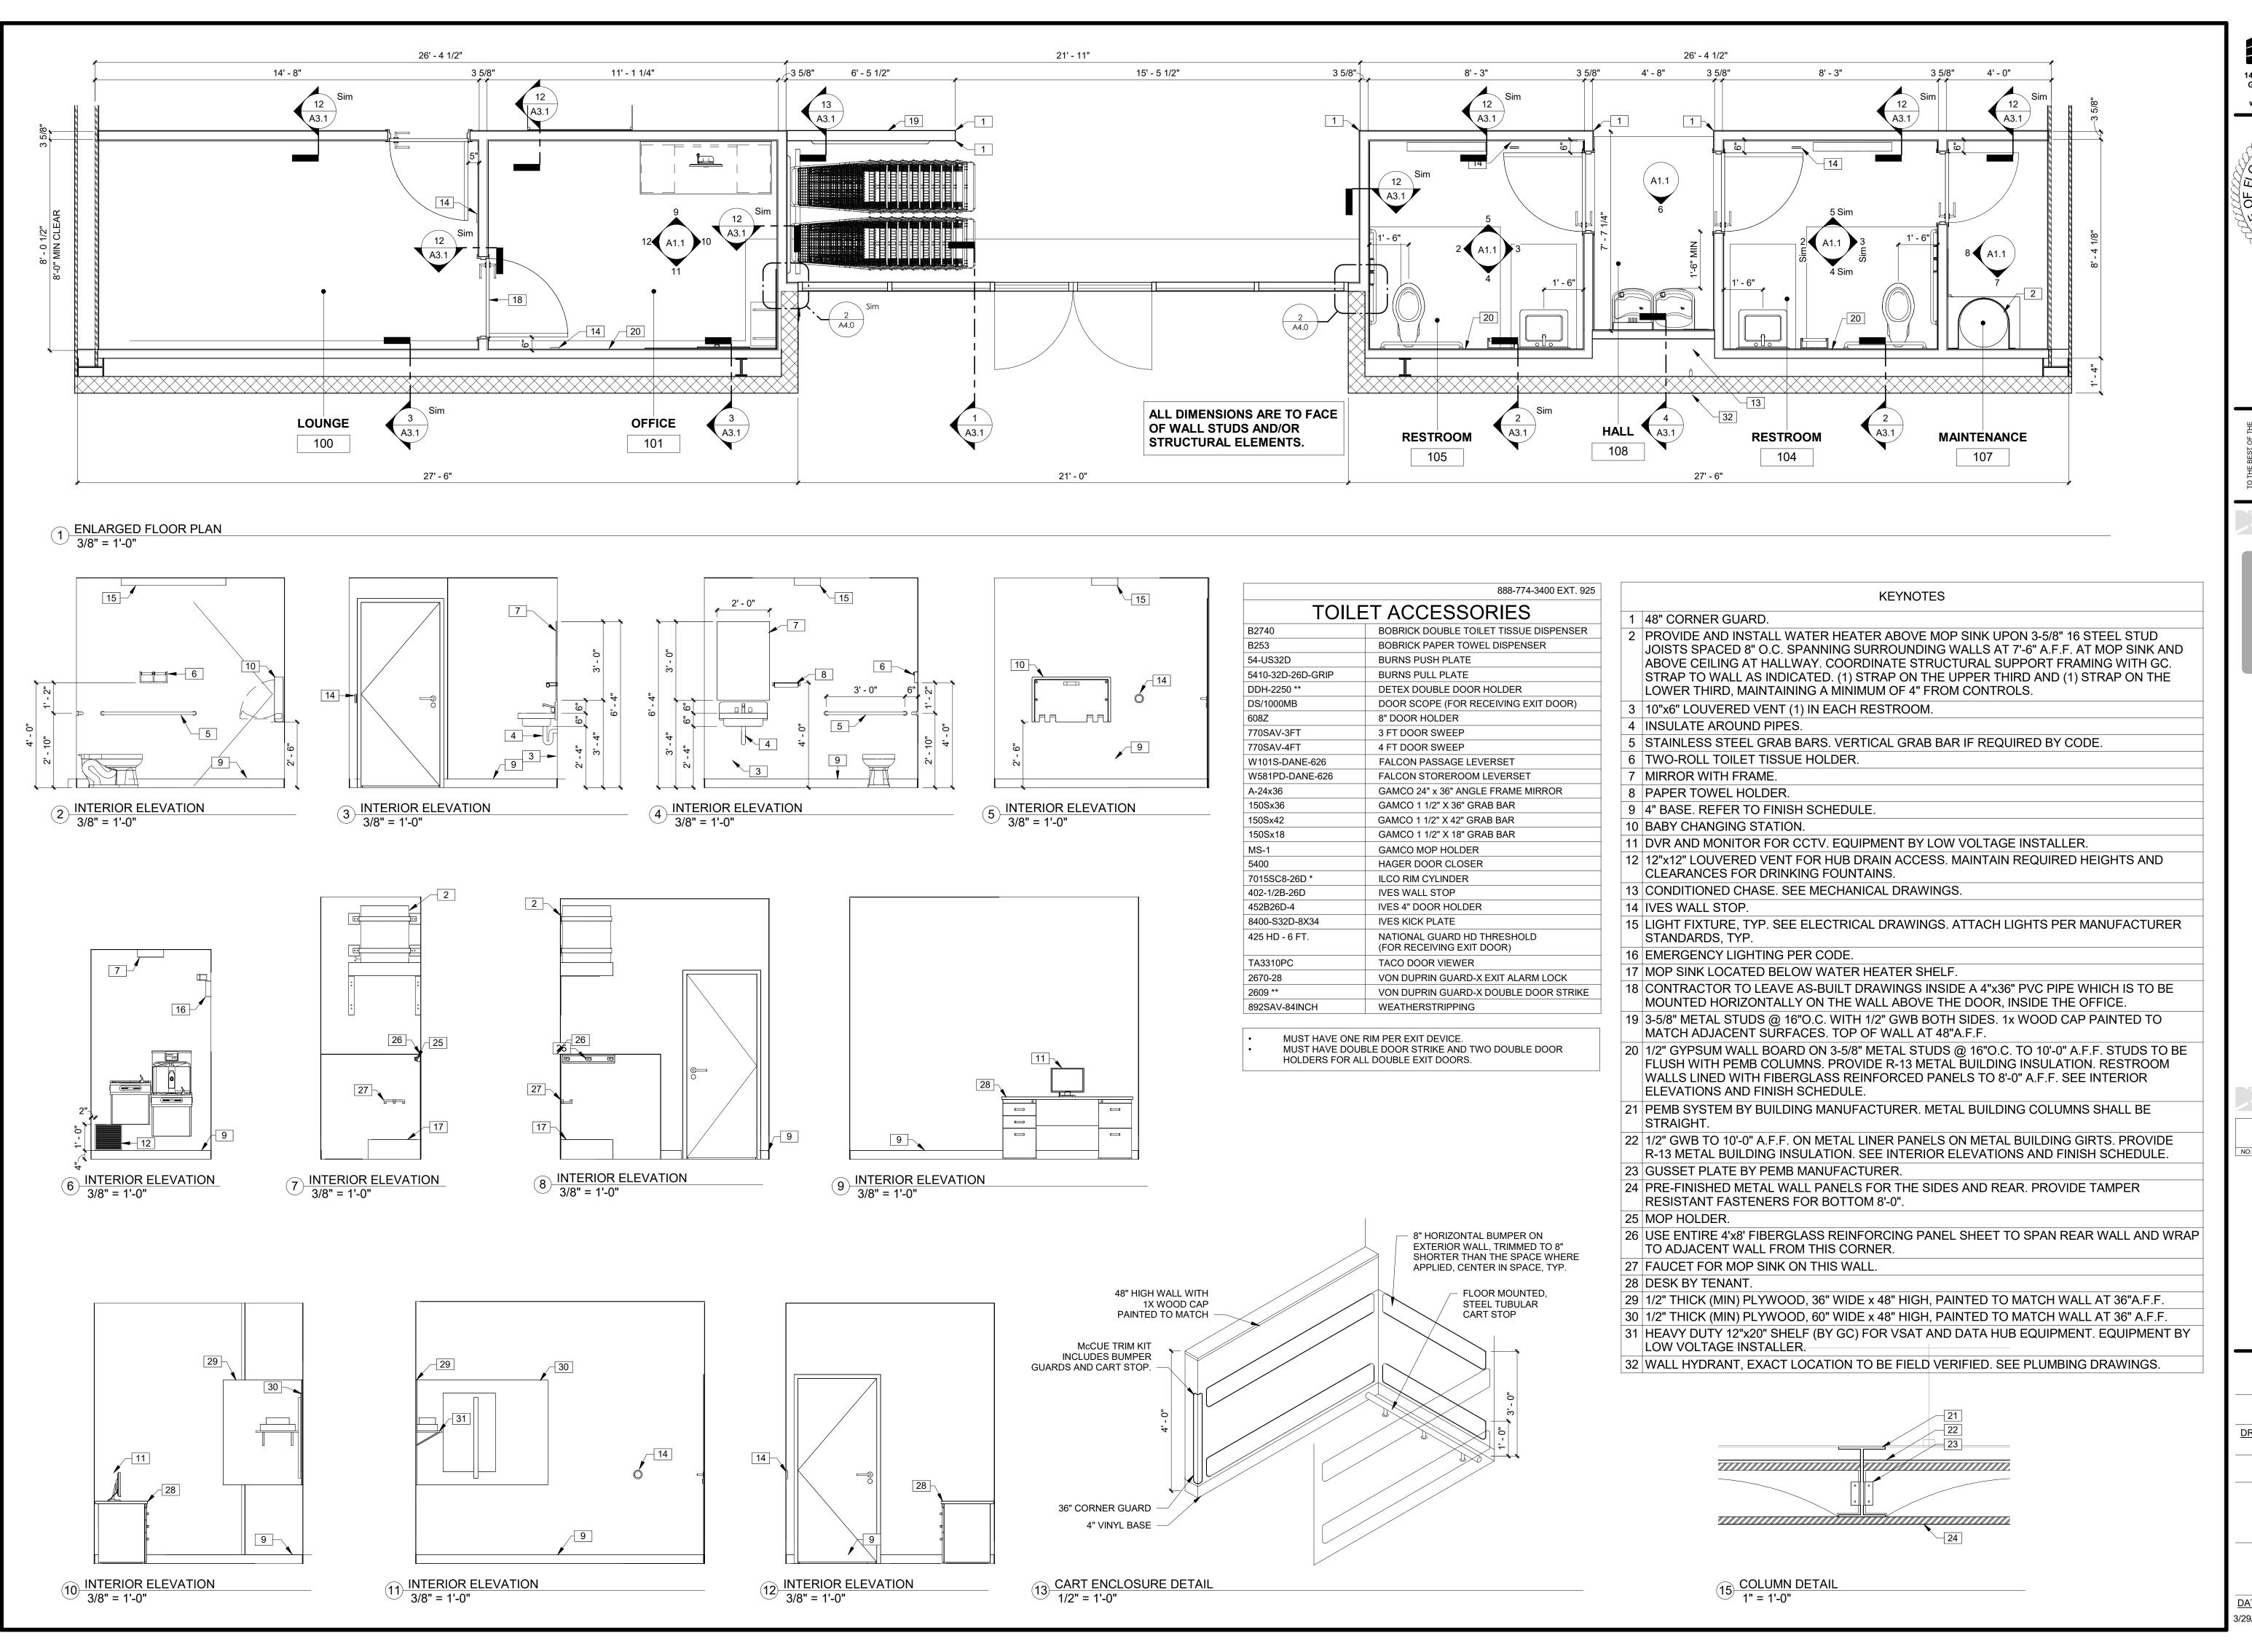
04.05.2024 DRAWN BY: CHECKED BY:
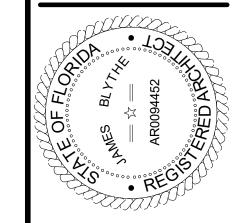
> PROJECT NUMBER: 4000.249

DRAWING TITLE: FLOOR PLAN

SHEET NO.

3/29/2024 7:59:04 AM



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ISSUE DATE: 04.05.2024

DRAWN BY: CHECKED BY


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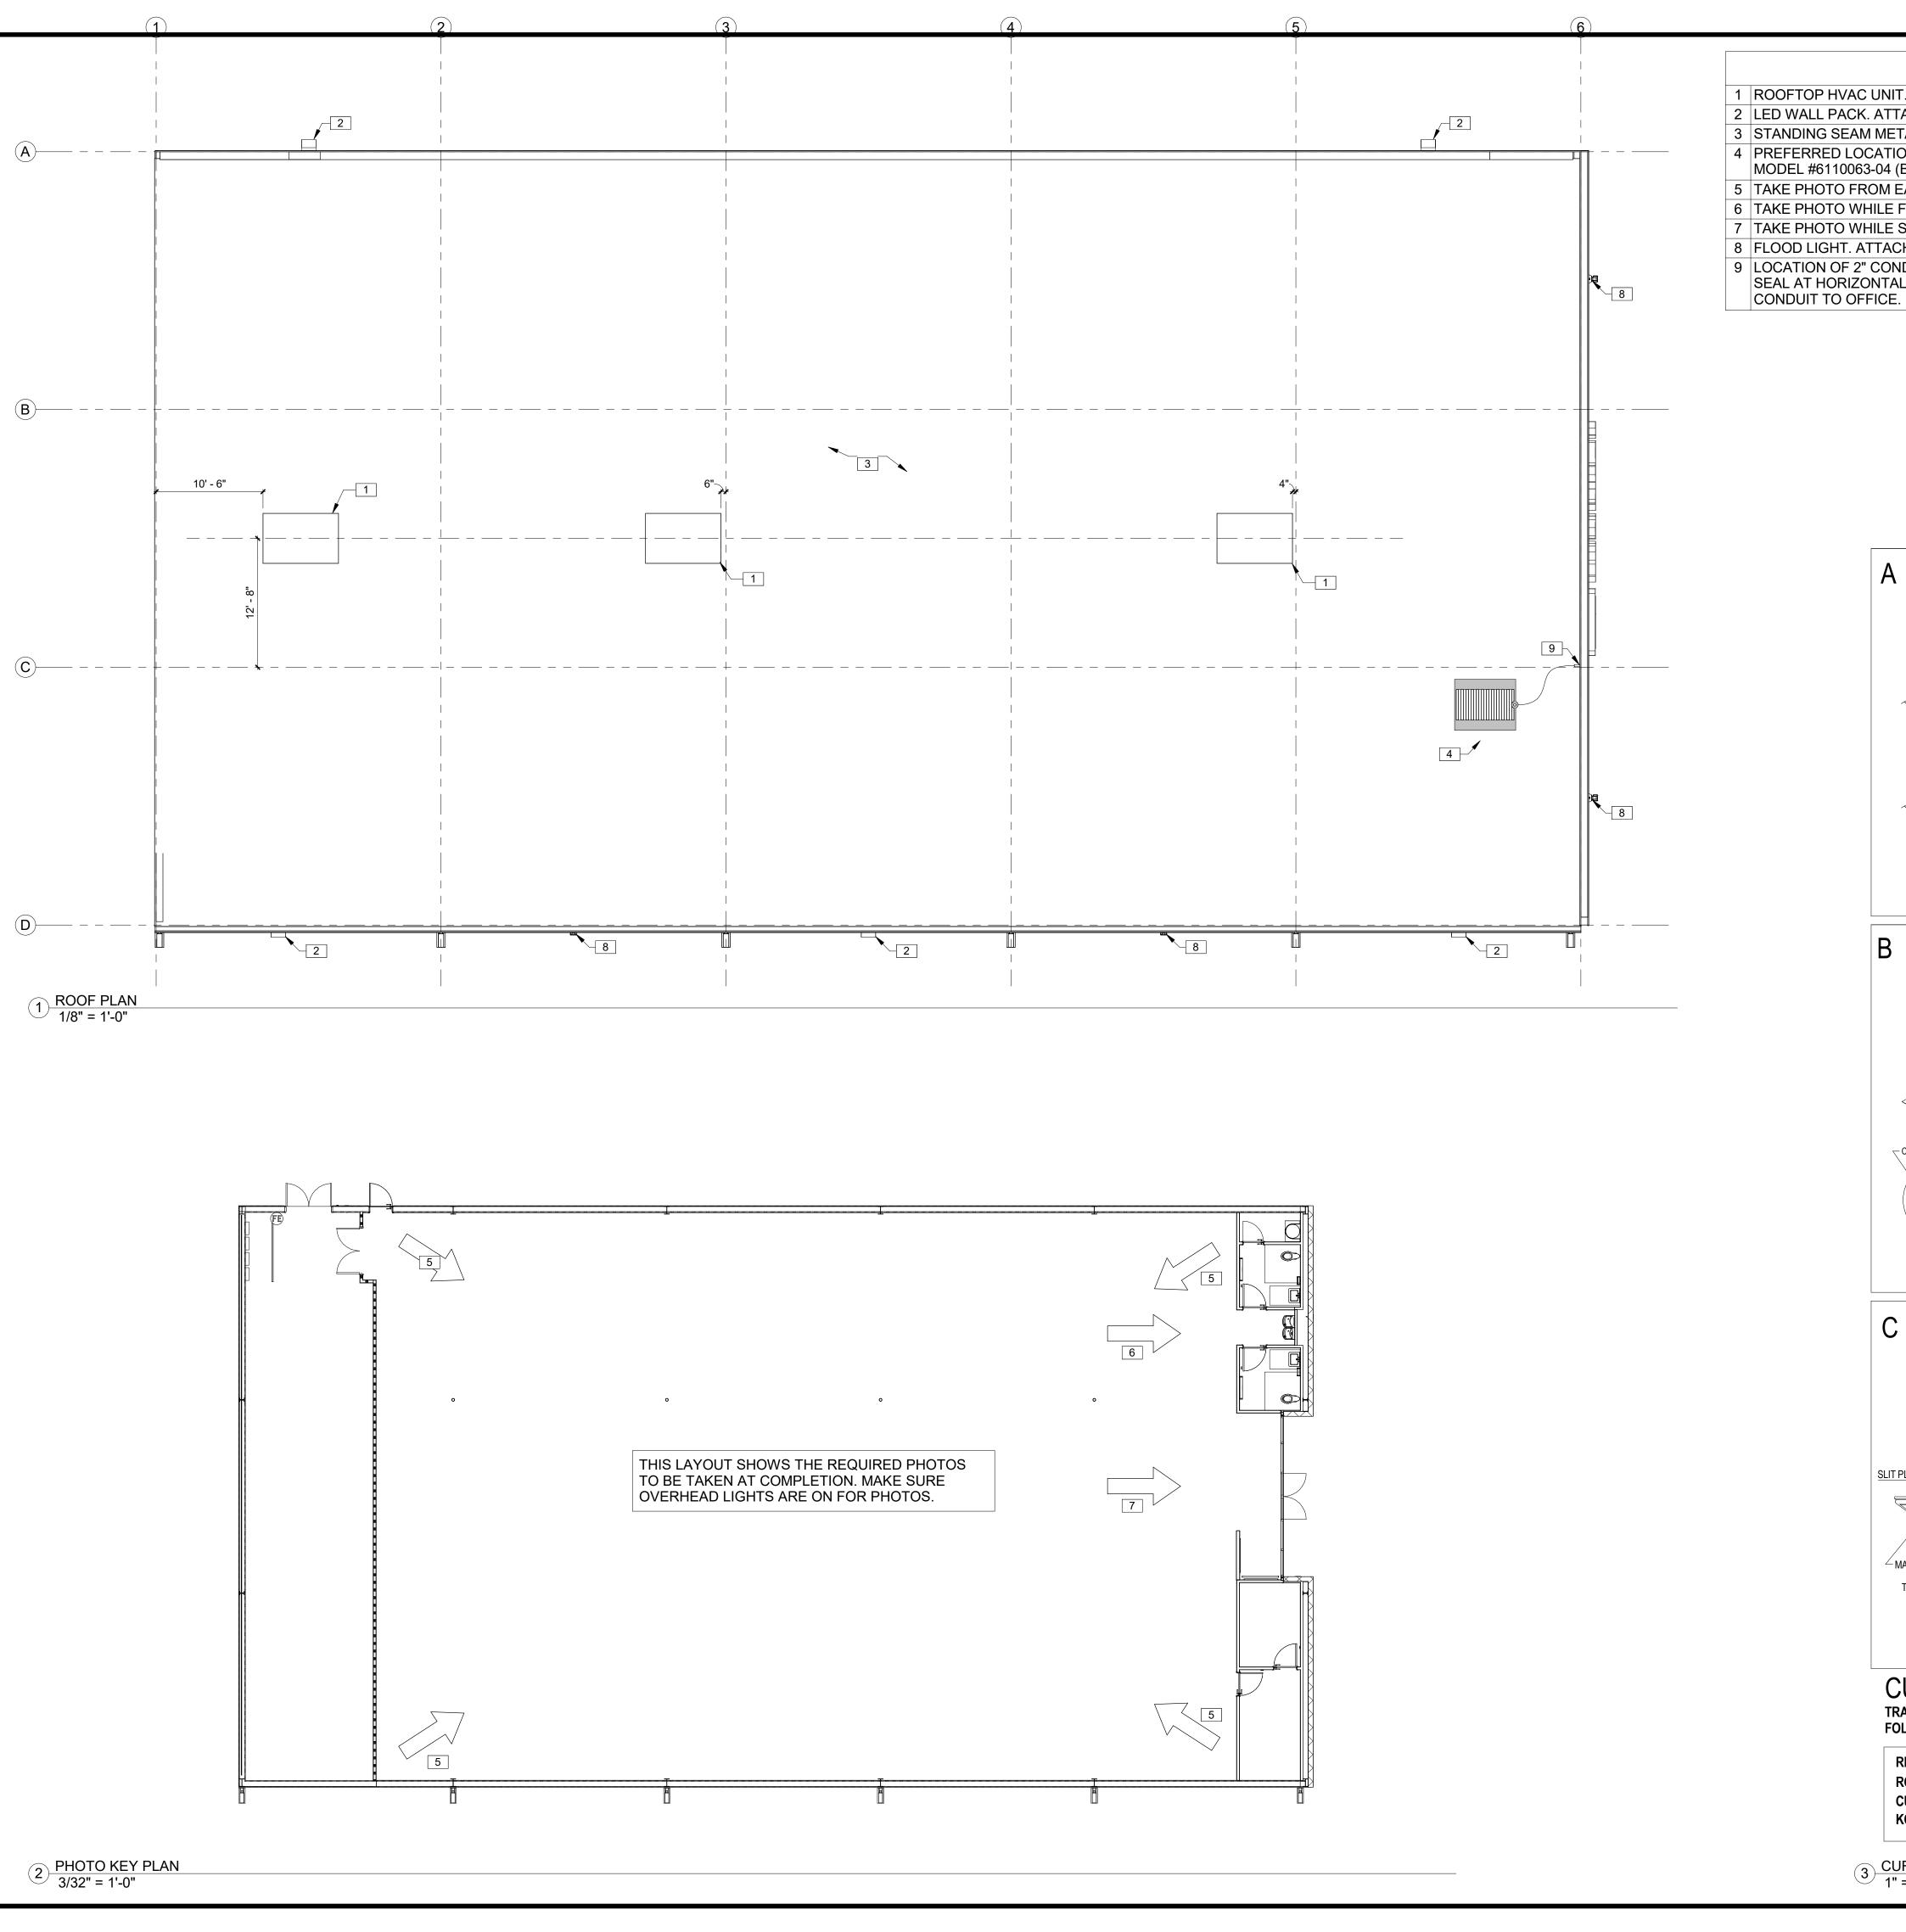
4000.249

DRAWING TITLE:
ENLARGED PLANS AND
ELEVATIONS

A1.1


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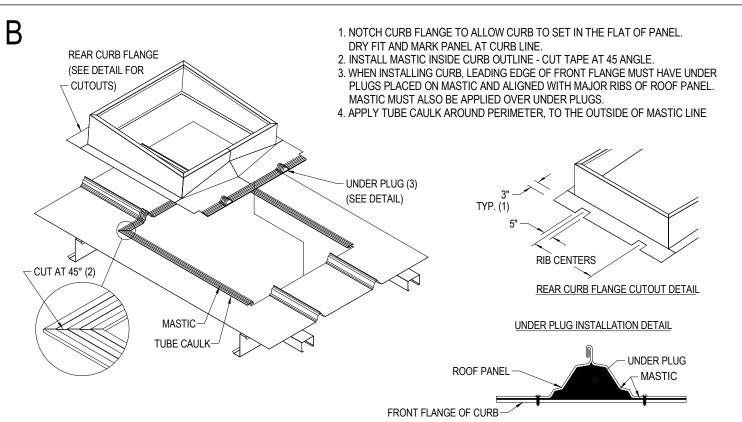


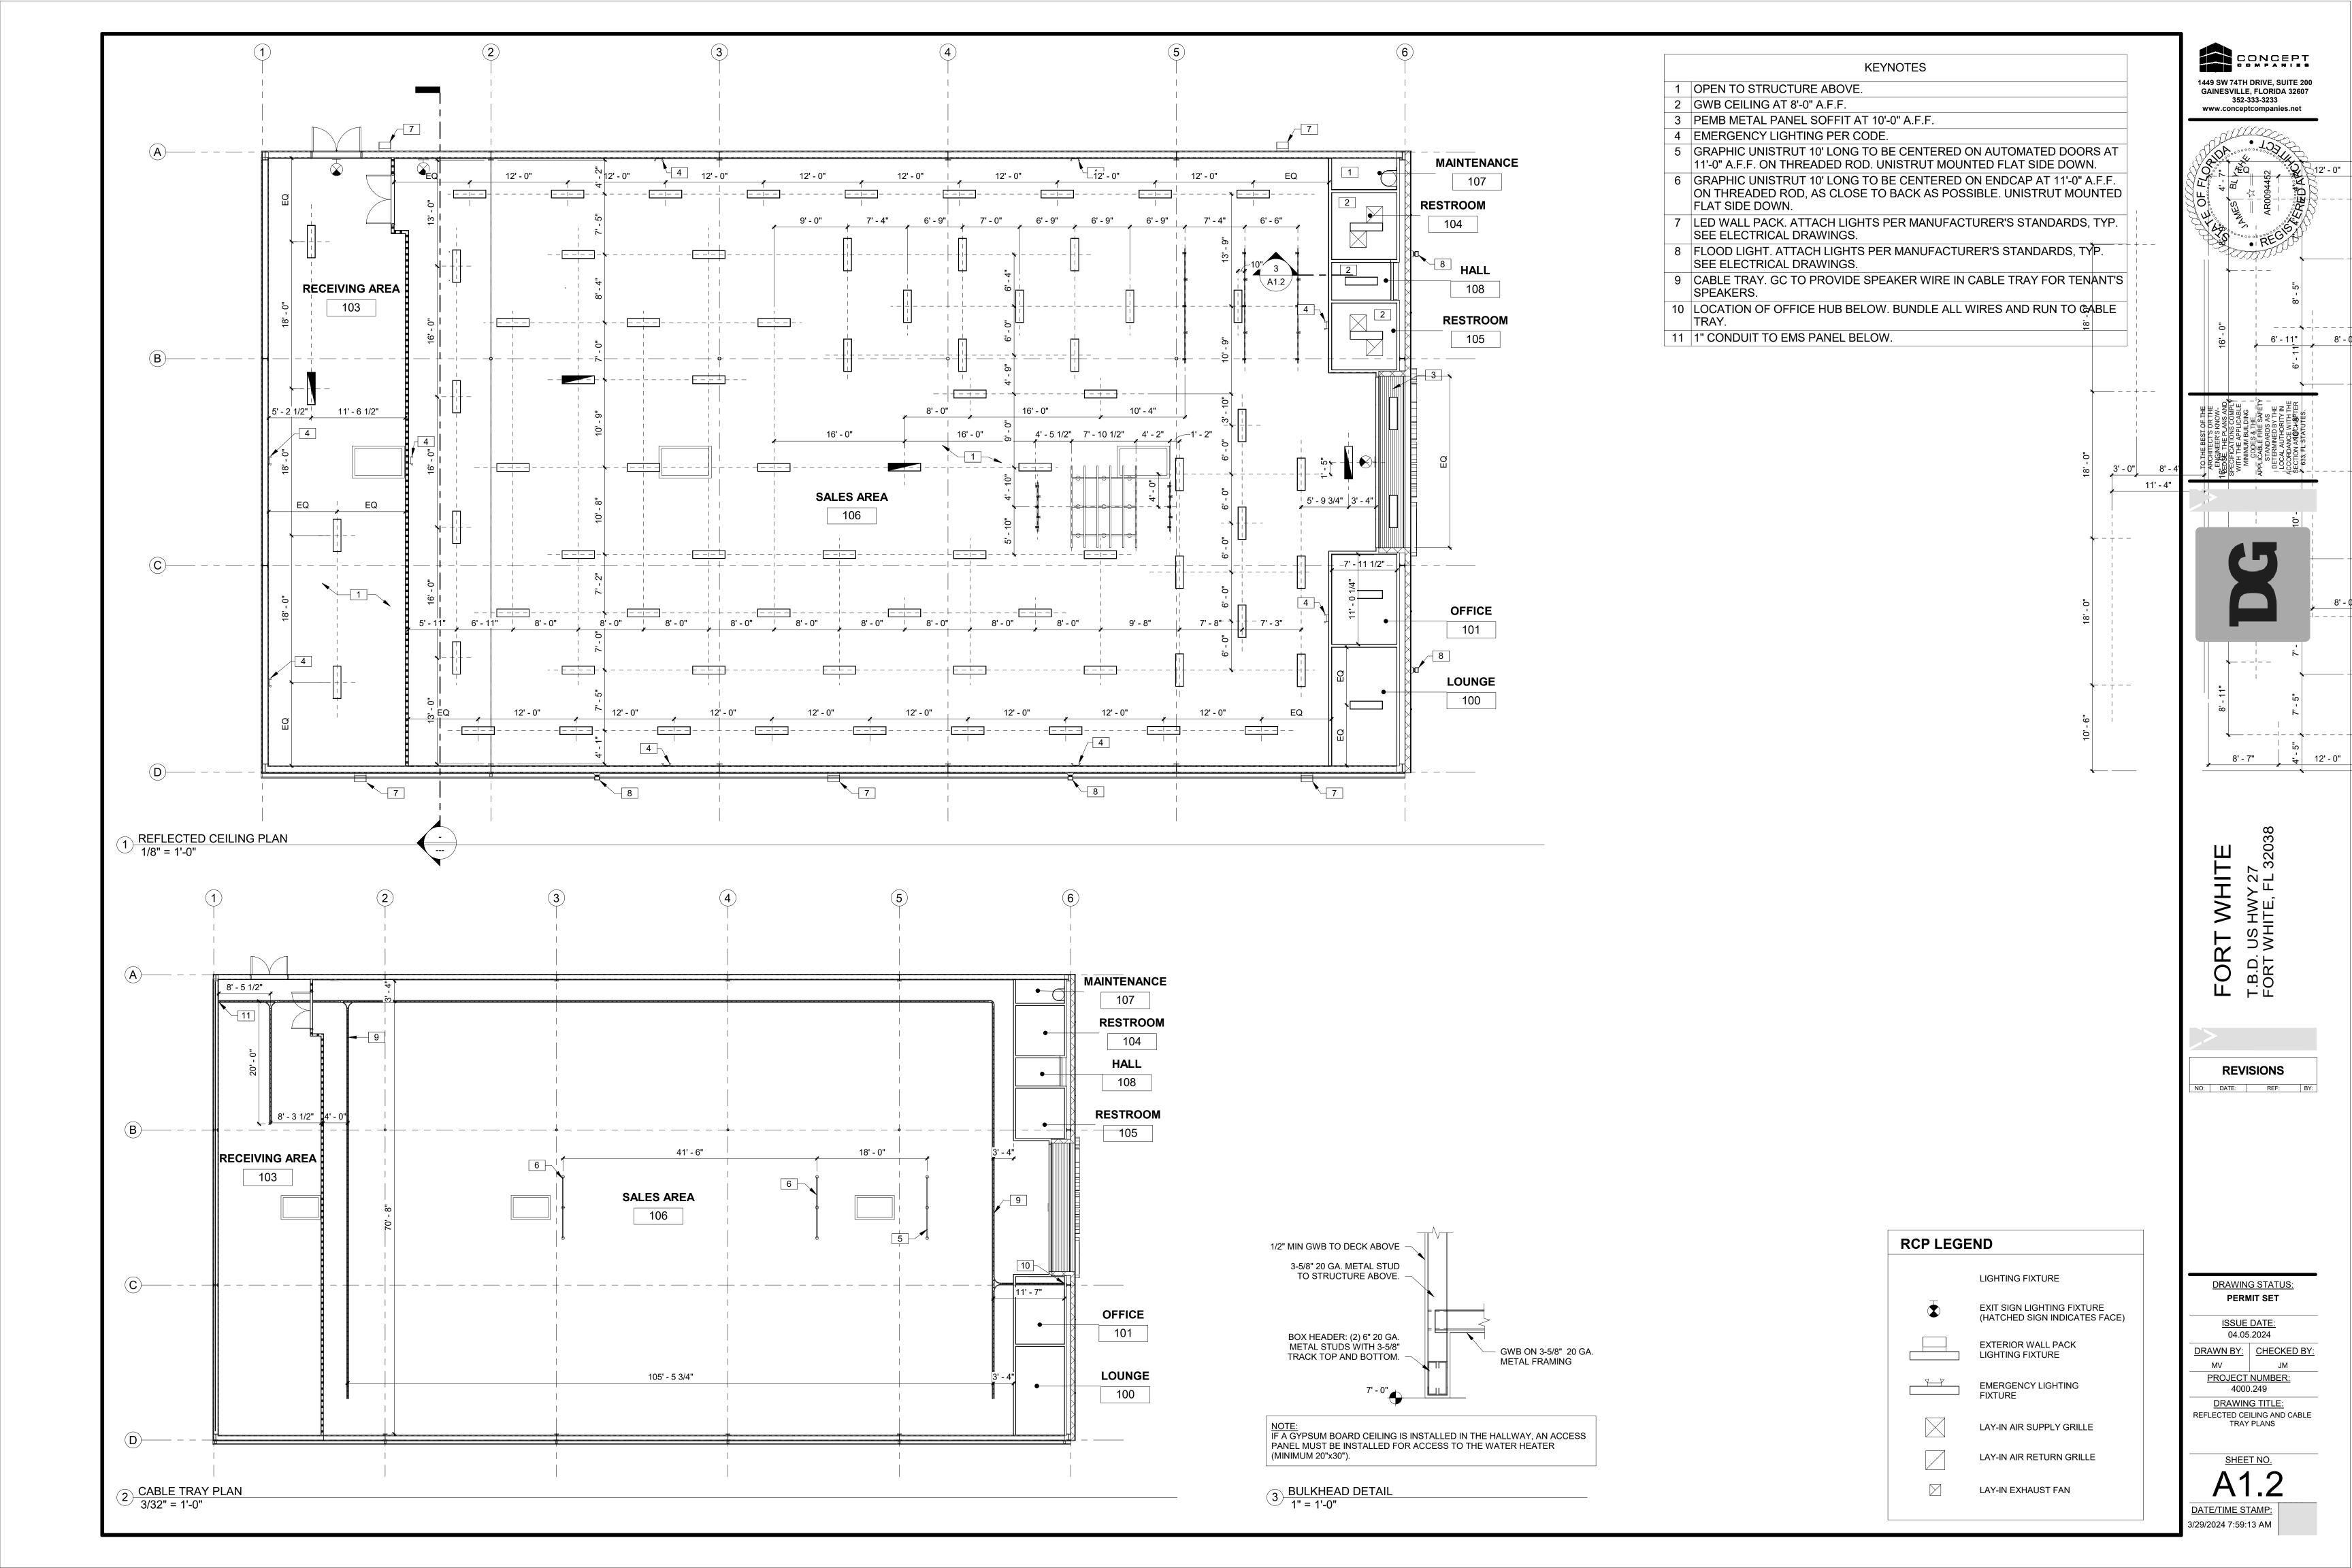


KEYNOTES

- 1 ROOFTOP HVAC UNIT. SEE MECHANICAL DRAWINGS.
- 2 LED WALL PACK. ATTACH LIGHTS PER MANUFACTURER'S STANDARDS, TYP. SEE ELECTRICAL DRAWINGS.
- 3 STANDING SEAM METAL ROOF BY PEMB MANUFACTURER, GALVALUME FINISH.
- 4 PREFERRED LOCATION OF NON-PENETRATING SATELLITE MOUNT (ABOVE OFFICE): SKYWARE GLOBAL, MODEL #6110063-04 (BY OTHERS).
- 5 TAKE PHOTO FROM EACH CORNER OF THE SALES FLOOR, FACING THE OPPOSITE CORNER.
- 6 TAKE PHOTO WHILE FACING HALL (INSIDE ENTRANCE STORES, ONE PICTURE FROM EACH END OF THE HALL).
- 7 TAKE PHOTO WHILE STANDING 10' FROM THE ENTRANCE, FACING THE ENTRANCE.
- 8 FLOOD LIGHT. ATTACH LIGHTS PER MANUFACTURER'S STANDARDS, TYP. SEE ELECTRICAL DRAWINGS.
- 9 LOCATION OF 2" CONDUIT WITH PULLSTRING (ABOVE OFFICE) FOR SATELLITE LINE. PROVIDE WEATHERTIGHT SEAL AT HORIZONTAL PENETRATION. CONTRACTOR RESPONSIBLE FOR INSTALLATION OF CONDUIT. EXTEND CONDUIT TO OFFICE



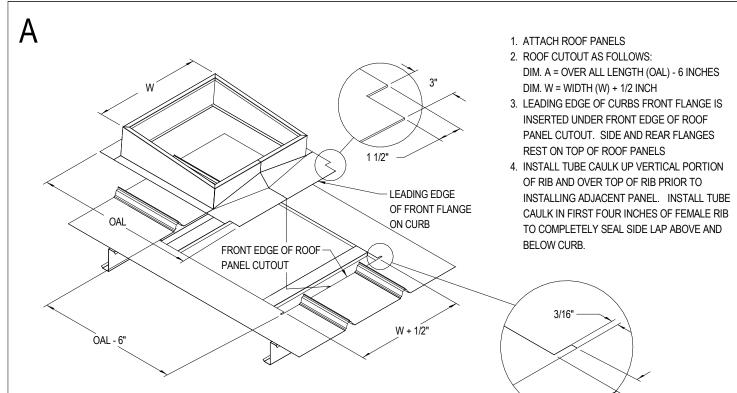

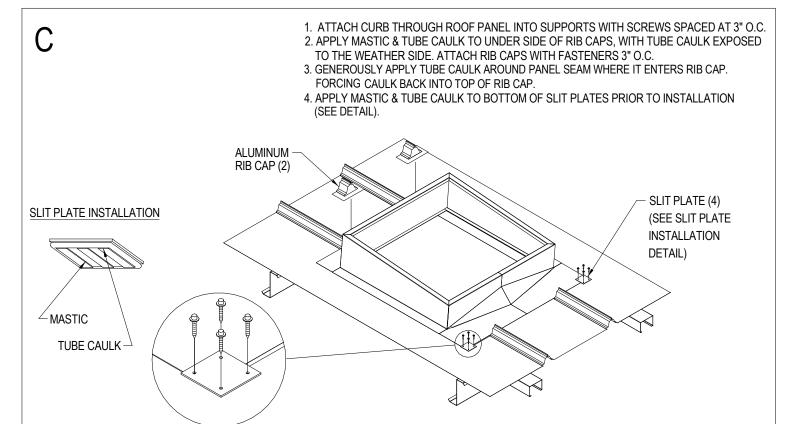

CURB INSTALLATION INSTRUCTIONS TRAPEZOIDAL STANDING SEAM PANEL - UNDER / OVER


FOLLOW MANUFACTURER'S SPECIFICATIONS

REQUIRED NATIONAL ACCOUNT ROOF CURB DG VENDORS:

ROOF CURB SYSTEMS GREG SMYTH 800-683CURBS PLUS INC. ALAN THRAILKILL 888-639KCC INTERNATIONAL INC. GREG CONRAD 800-382-

GREG SMYTH 800-683-5848 GSMYTH@ROOFCURB.COM
ALAN THRAILKILL 888-639-2872 ALAN.THRAILKILL@CURBS-PLUS.COM
GREG CONRAD 800-382-2872 GCONRAD@KCCCURBS.COM

3 CURB INSTALLATION INSTRUCTIONS 1" = 1'-0" 1449 SW 74TH DRIVE, SUITE 200 GAINESVILLE, FLORIDA 32607 352-333-3233 www.conceptcompanies.net

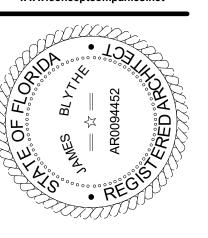

TO THE BEST OF THE ARCHITECT'S OR THE ENGINEER'S KNOW-LEDGE, THE PLANS AND PECIFICATIONS COMPLY WITH THE APPLICABLE MINIMUM BUILDING CODES & THE SAFETY STANDARDS AS TANDARDS AS LOCAL AUTHORITY IN ACCORDANCE WITH THE SECTION AND CHAPTER 633, FL STATUTES.



FORT WHITE T.B.D. US HWY 27 FORT WHITE, FL 32038

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04.05.2024

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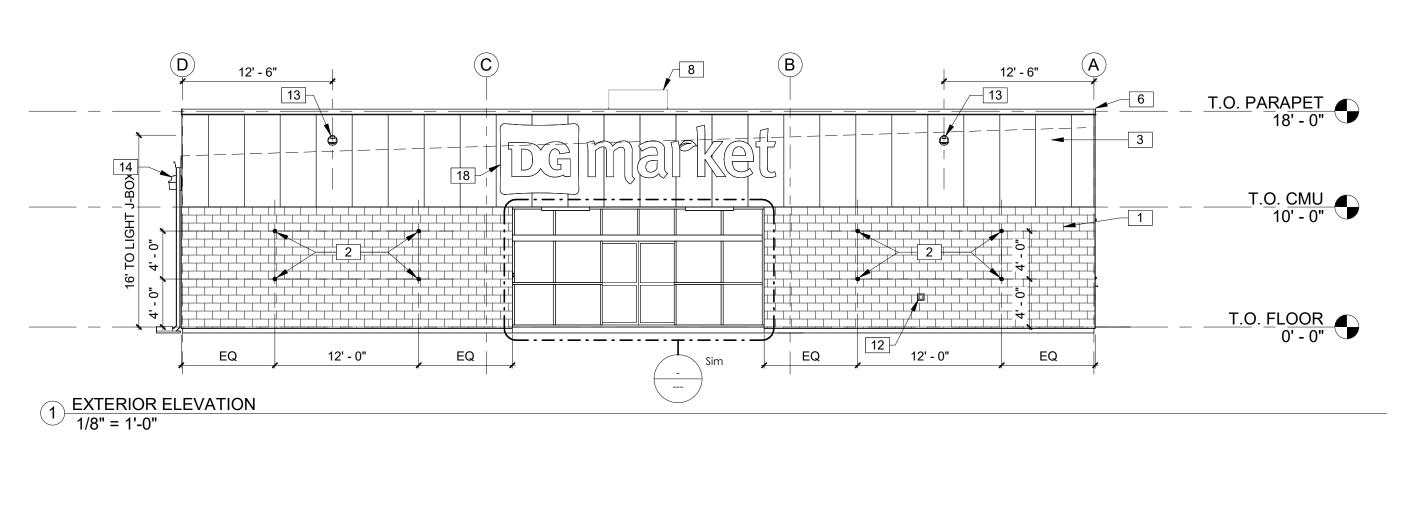
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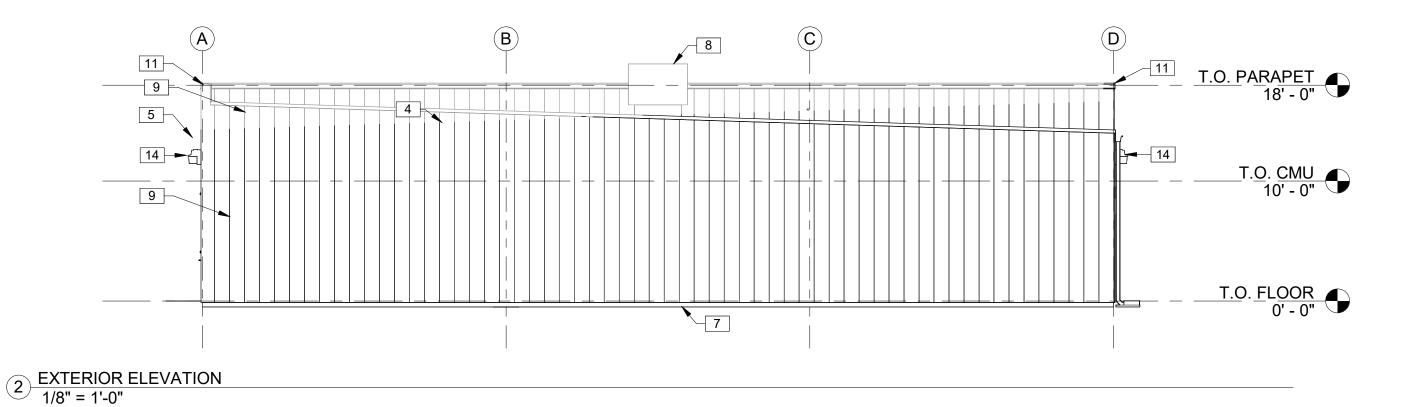
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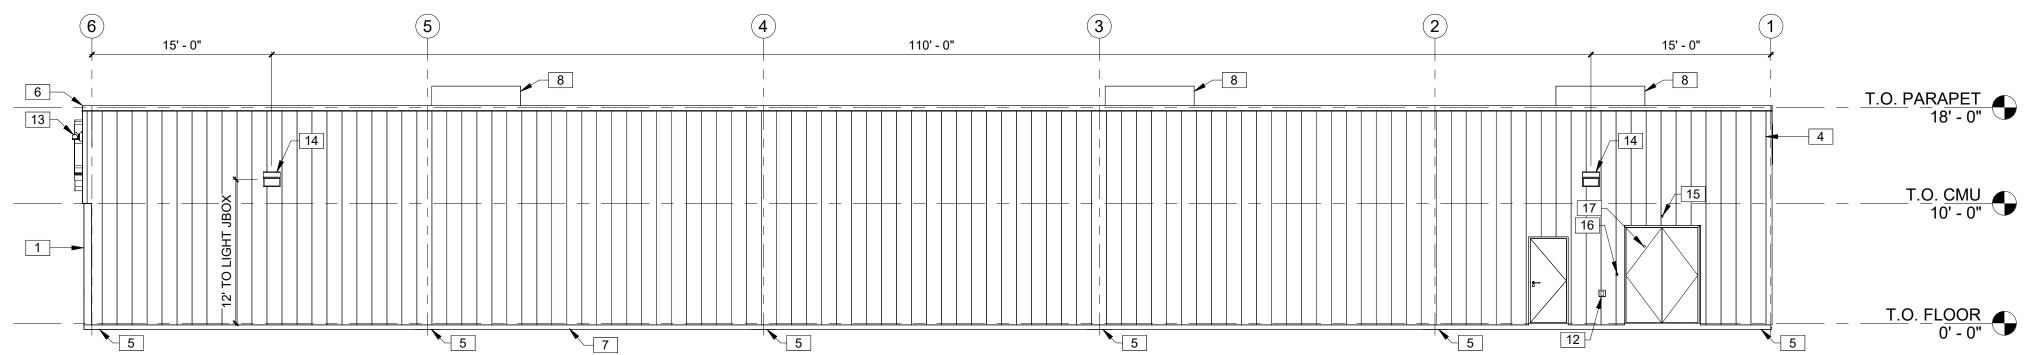
ROOF PLAN AND PHOTO KEY PLAN

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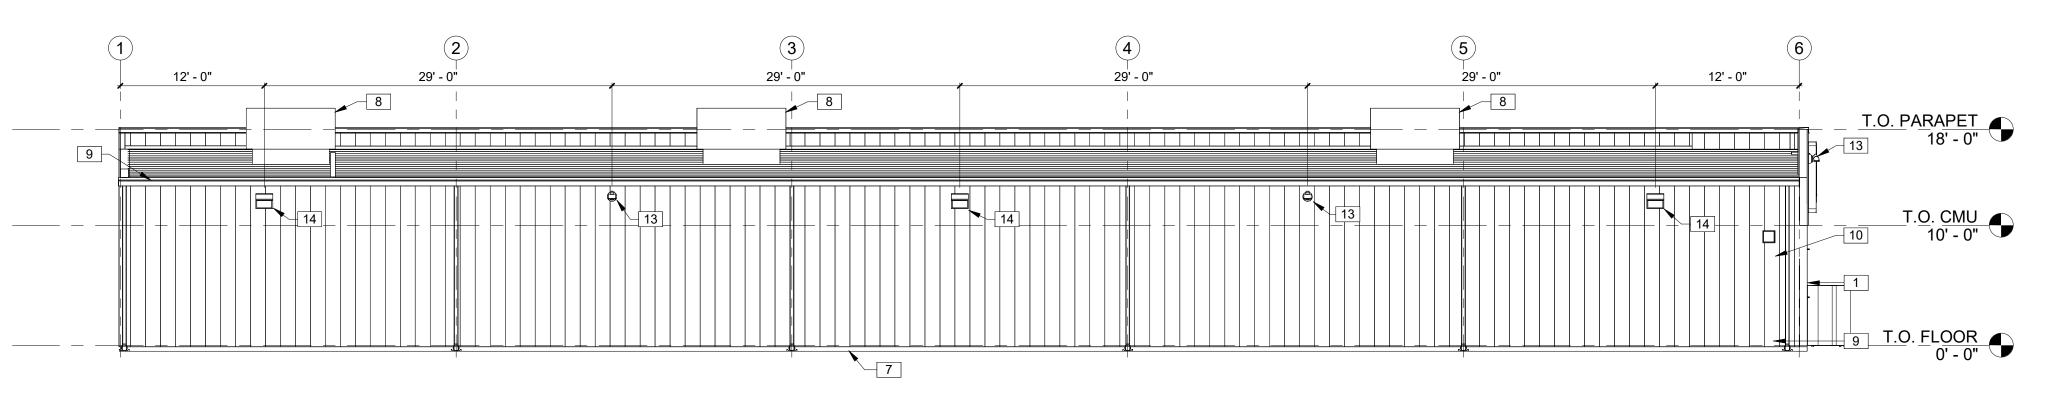
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3 EXTERIOR ELEVATION
1/8" = 1'-0"




4 EXTERIOR ELEVATION 1/8" = 1'-0"

	E-ENGINEERED METAL LDING VENDOR	DAVI	JILDING D ENGLI 568-453	SH		ROD	R BUILDIN NEY BUR)-879-7827	Τ	EMS	вов	OR BUI BARRY)-622-44	′			E	BUILDIN KEVIN E	E STEE NGS, IN BUSLEF 33-3378	C. ₹	ERIN	EF BUI N SULL))-845-1	LIVAN			EXT	ERIOR	ED COLOR: MATERIAL METAL PAN	LS
EXTERIOR FINISHES																								ш	OWN		
EXTERIOR FINISHES ARE TO MATCH OR BE EQUAL TO VP METAL BUILDING FINISH SELECTION UNLESSS AUTHORITY HAVING JURISDICTION DOES NO		COOL EGYPTIAN WHITE	COOL DARK BRONZE	BRONZE COOL COTTON	GALVALUME	LIGHTSTONE	MEDIUM BRONZE KYNAR 500 BRONZE	POLAR WHITE	GALVALUME	LIGHTSTONE	MEDIUM BRONZE KYNAR 500	BRONZE	POLAR WHITE	GALVALUME	SANDS LONE	5	POLAR WHITE	GALVALUME	PARCHMENT	ANTIQUE BRONZE	BRONZE	POLAR WHITE	GALVALUME	SHERWIN WILLIAMS #7037 - "BALANCED BEIGE"	l 🗠 l	BRONZE WHITE BY PEMB MANUFACTURER	MANOTACIONEN
GUTTERS		•				•				•					•				•					•			
DOWN SPOUTS		•				•				•					•				•					•			\dagger
SIDE AND REAR METAL WALL PANELS & TRIM, RECEIVING & EMERGENCY DOORS (EXTERIOR OF DOORS TO BE PAINTED, REFER TO DOOR SCHEDU		•				•				•					•				•					•			
ARCHITECTURAL BLOCK AT BUILDING FACADE TO BE PRE-FINISHED OR P MASONRY COATING A24W400 SERIES) TO MATCH THE SIDE AND REAR M		•				•				•					•				•					•			
LAT METAL SOFFIT AT STOREFRONT VESTIBULE AREA				•				•					•				•					•				•	T
BUILDING FASCIA WALL, PARAPET OVER ENTRANCE, AND CANOPY			•				•				•									•					•		T
STOREFRONT SYSTEM				•				,				•				•					•					•	
STANDING SEAM METAL ROOF PANELS					•				•					•				•					•				\dagger
INER PANELS (INTERIOR SALES AND RECEIVING FLOOR)				•				•					•				•					•				•	\dagger

KEYNOTES

- 1 8" SPLIT FACE CMU PAINTED SW #7037 BALANCED BEIGE. ALIGN FACE OF BLOCK WITH STEEL GIRT. PROVIDE PROPER ANCHORAGE TO STRUCTURE. CMU WALL TO BE REINFORCED W/#5 VERT. @ 48"O.C. TYP. DUROWALL 2 16"O.C. BOND BEAMS TO HAVE (2)#5s FLASHING ONLY BETWEEN GROUTED CELLS. PAN FLASHING IS AN ACCEPTABLE ÀLTERNATE. MORTAR SHALL BE TYPE 'M' OR 'N' FOR ALL MASONRY UNITS. TOP COURSE TO BE SMOOTH. GROUT CELL @ ANCHOR BOLT LOCATIONS. MESH AT BASE OF CMU TO CONFINE GROUT. SEE STRUCTURAL DRAWINGS.
- 1/2"DIA x 6" LONG STAINLESS STEEL EYE BOLTS (CLOSED) WITH 1"DIA OPENINGS. DRILL AND EPOXY INTO BLOCK WALL. (4) BOLTS TO BE LOCATED AS SHOWN EACH SIDE OF ENTRY. (8) TOTAL BOLTS.
- 3 PRE-FINISHED METAL WALL PANELS FOR THE FASCIA AND PARAPET OVER THE ENTRANCE. REVERSE RIB PROFILE.
- 4 STANDING SEAM METAL ROOF BY PEMB MANUFACTURER, GALVALUME FINISH.
- 5 PRE-FINISHED GUTTER AND DOWNSPOUT. PROVIDE LEAF GUARDS IF LOCATED WITHIN 25'-0" OF A TREE. WHERE NO SIDEWALK EXISTS, MIN. 5' 4" PERFORATED LANDSCAPE PIPE, STRAPPED TO A 12"X24" CONCRETE SPLASHBLOCK. SEE EXTERIOR FINISH SCHEDULE FOR COLOR.
- 6 PRE-FINISHED METAL COPING
- 7 CONCRETE SLAB AND FOUNDATION WITH STRUCTURAL MIN 6x6xW1.4 WELDED WIRE MESH OVER POLYETHYLENE VAPOR BARRIER (MIN. 10 MM THICK) OVER CRUSHED STONE BASE, TYPICAL, OR EQUIVALENT. PROVIDE CONTROL JOINTS AT 14'-0" ON CENTER EACH WAY MAX. SEE STRUCTURAL DRAWINGS.
- 8 ROOFTOP HVAC UNIT. SEE MECHANICAL DRAWINGS.
- 9 PRE-FINISHED METAL WALL PANELS FOR THE SIDES AND REAR. PROVIDE TAMPER RESISTANT FASTENERS FOR BOTTOM 8'-0".
- 10 VENT FOR BATHROOM EXHAUST. SEE MECHANICAL DRAWINGS.
- 11 PARAPET BEYOND.
- 12 WALL HYDRANT, EXACT LOCATION TO BE FIELD VERIFIED. SEE PLUMBING DRAWINGS.
- 13 FLOOD LIGHT. ATTACH LIGHTS PER MANUFACTURER'S STANDARDS, TYP. SEE ELECTRICAL DRAWINGS.
- 14 LED WALL PACK. ATTACH LIGHTS PER MANUFACTURER'S STANDARDS, TYP. SEE ELECTRICAL DRAWINGS.
- 15 OUTSIDE AIR TEMPERATURE SENSOR MOUNTED ABOVE RECEIVING DOORS.
- 16 RECEIVING DOOR BUZZER. SEE ELECTRICAL DRAWINGS.
- 17 2" DOOR SCOPE.
- 18 SIGN FURNISHED AND SUPPLIED BY TENANT WITH CIRCUIT AS NOTED ON ELECTRICAL PLAN. CONTRACTOR TO PROVIDE BLOCKING AS REQUIRED BY SIGN MANUFACTURER TO SUPPORT SIGN WEIGHT UP TO 1,400 LBS. EXTERIOR CANOPY SIGN SHALL BE SUPPORTED BY THE FACE OF THE CANOPY. COORDINATE THE PROPER SIGNAGE TO BE USED WITH TENANT.

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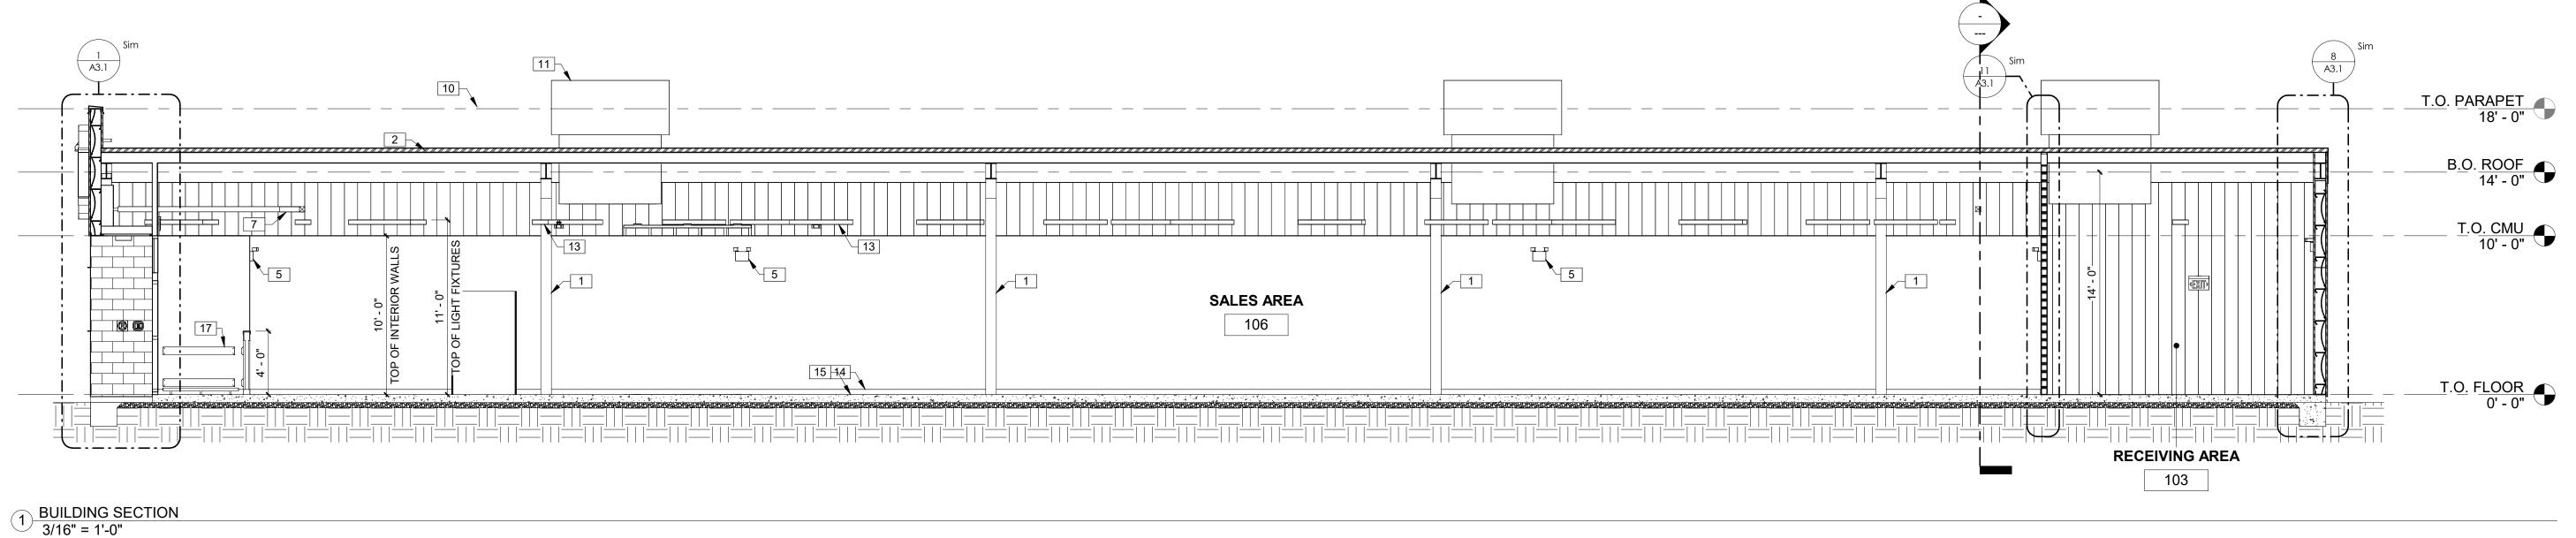
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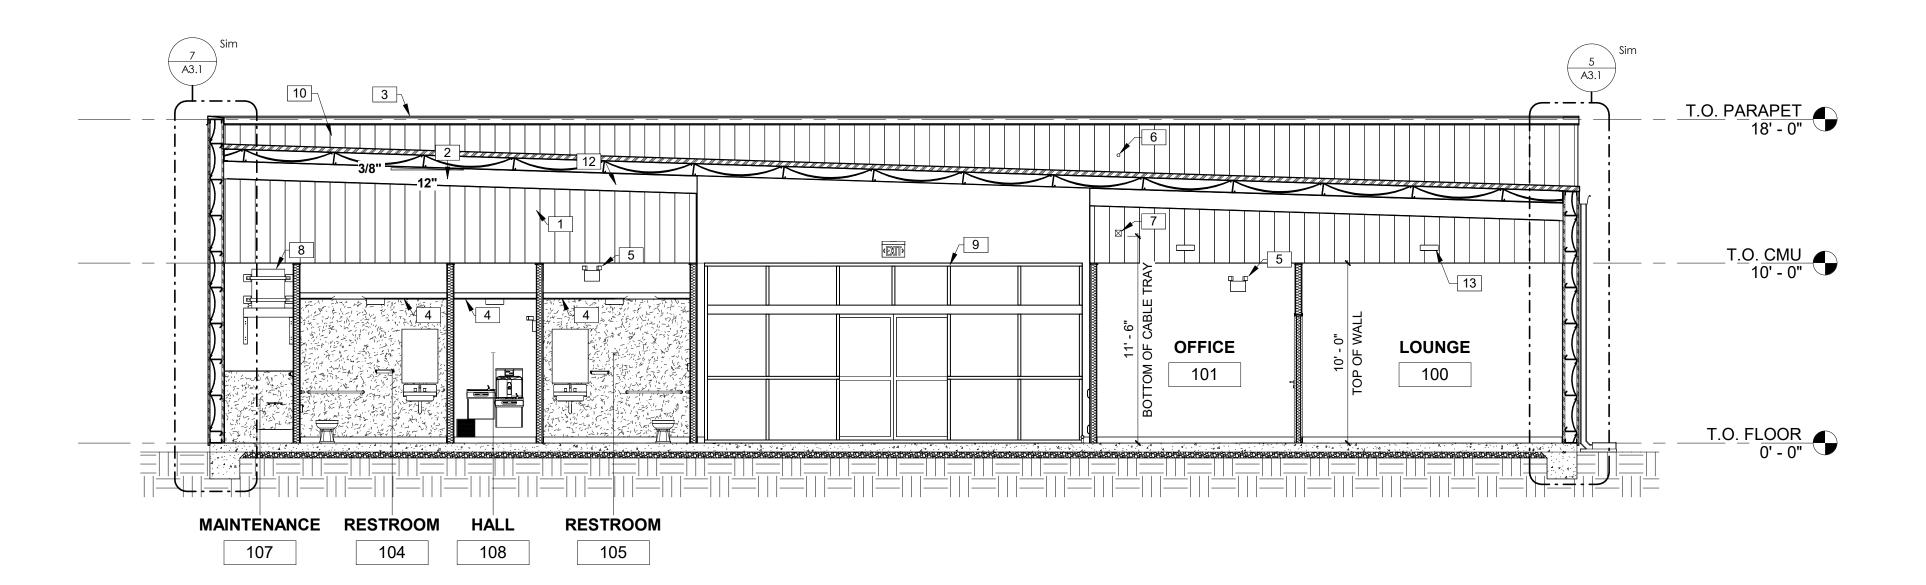
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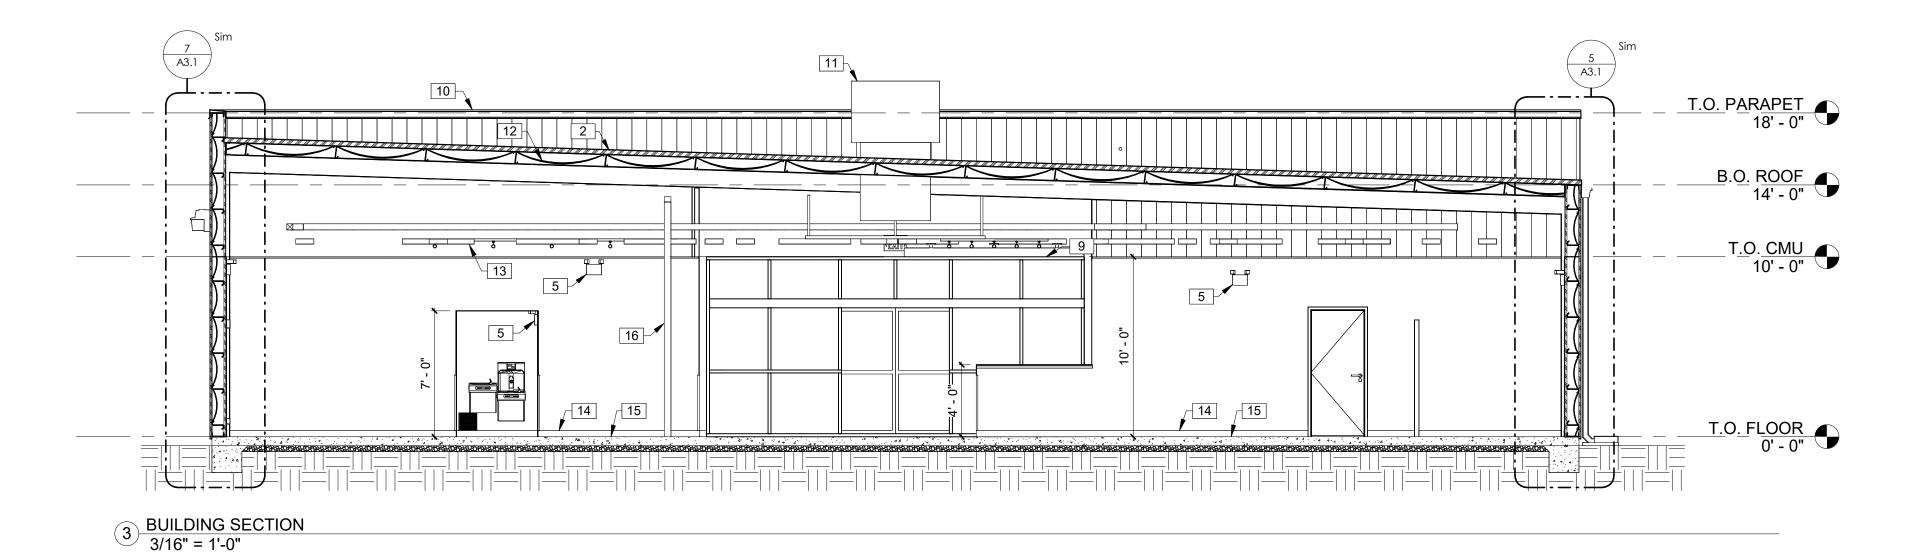
REFER TO SHEET T1.0 FOR ADDITIONAL INFORMATION ON RECOMMENDED NATIONAL ACCOUNT VENDORS.

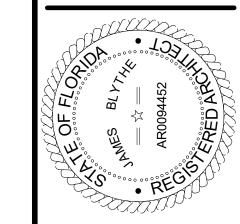NATIONAL ACCOUNT AND CONTACT INFORMATION SUBJECT TO CHANGE.






2 BUILDING SECTION
3/16" = 1'-0"



KEYNOTES

- 1 PEMB SYSTEM BY BUILDING MANUFACTURER. METAL BUILDING COLUMNS SHALL BE STRAIGHT.
- 2 STANDING SEAM METAL ROOF BY PEMB MANUFACTURER, GALVALUME FINISH.
- 3 PRE-FINISHED METAL COPING.
- 4 GWB CEILING AT 8'-0" A.F.F.
- 5 EMERGENCY LIGHTING PER CODE.
- 6 LOCATION OF 2" CONDUIT WITH PULLSTRING (ABOVE OFFICE) FOR SATELLITE LINE. PROVIDE WEATHERTIGHT SEAL AT HORIZONTAL PENETRATION. CONTRACTOR RESPONSIBLE FOR INSTALLATION OF CONDUIT. EXTEND CONDUIT TO OFFICE.
- 7 CABLE TRAY. GC TO PROVIDE SPEAKER WIRE IN CABLE TRAY FOR TENANT'S SPEAKERS.
- PROVIDE AND INSTALL WATER HEATER ABOVE MOP SINK UPON 3-5/8" 16 STEEL STUD JOISTS SPACED 8" O.C. SPANNING SURROUNDING WALLS AT 7'-6" A.F.F. AT MOP SINK AND ABOVE CEILING AT HALLWAY. COORDINATE STRUCTURAL SUPPORT FRAMING WITH GC. STRAP TO WALL AS INDICATED. (1) STRAP ON THE UPPER THIRD AND (1) STRAP ON THE LOWER THIRD, MAINTAINING A MINIMUM OF 4" FROM CONTROLS.
- 9 21'x10' ALUMINUM BI-PART DOOR AND STOREFRONT GLAZING SYSTEM, BRONZE FINISH. SEE SHEET A4.0 FOR ADDITIONAL INFORMATION. CONTINUE METAL LINER PANELS TO DECK.
- 10 PARAPET BEYOND.
- 11 ROOFTOP HVAC UNIT. SEE MECHANICAL DRAWINGS.
- 12 INSULATION AT ROOF (MINIMUM R-19 PER ENERGY CODE REQUIREMENTS). ADD INSULATION BAFFLES AS NEEDED AND VAPOR BARRIER PER LOCAL CLIMATE REQUIREMENTS.
- 13 LIGHT FIXTURE, TYP. SEE ELECTRICAL DRAWINGS. ATTACH LIGHTS PER MANUFACTURER STANDARDS, TYP.
- 14 4" BASE. REFER TO FINISH SCHEDULE.
- 15 CONCRETE SLAB AND FOUNDATION WITH STRUCTURAL MIN 6x6xW1.4 WELDED WIRE MESH OVER POLYETHYLENE VAPOR BARRIER (MIN. 10 MM THICK) OVER CRUSHED STONE BASE, TYPICAL, OR EQUIVALENT. PROVIDE CONTROL JOINTS AT 14'-0" ON CENTER EACH WAY MAX. SEE STRUCTURAL DRAWINGS.
- 16 ROUND STEEL PIPE COLUMN WITH RECESSED BASE PLATE PAINT SECOND CONCRETE POUR SW6991 BLACK MAGIC. PAINT STEEL COLUMN SW7005 PURE WHITE. WRAP COLUMN WITH TIGHT LOOP CARPET (BLACK) 48" HIGH AT BASE.
- 17 McCUE CART AND BUMPER GUARDS 3'-5" A.F.F.; ORDER TRIM KIT FOR THIS PROTOTYPE.

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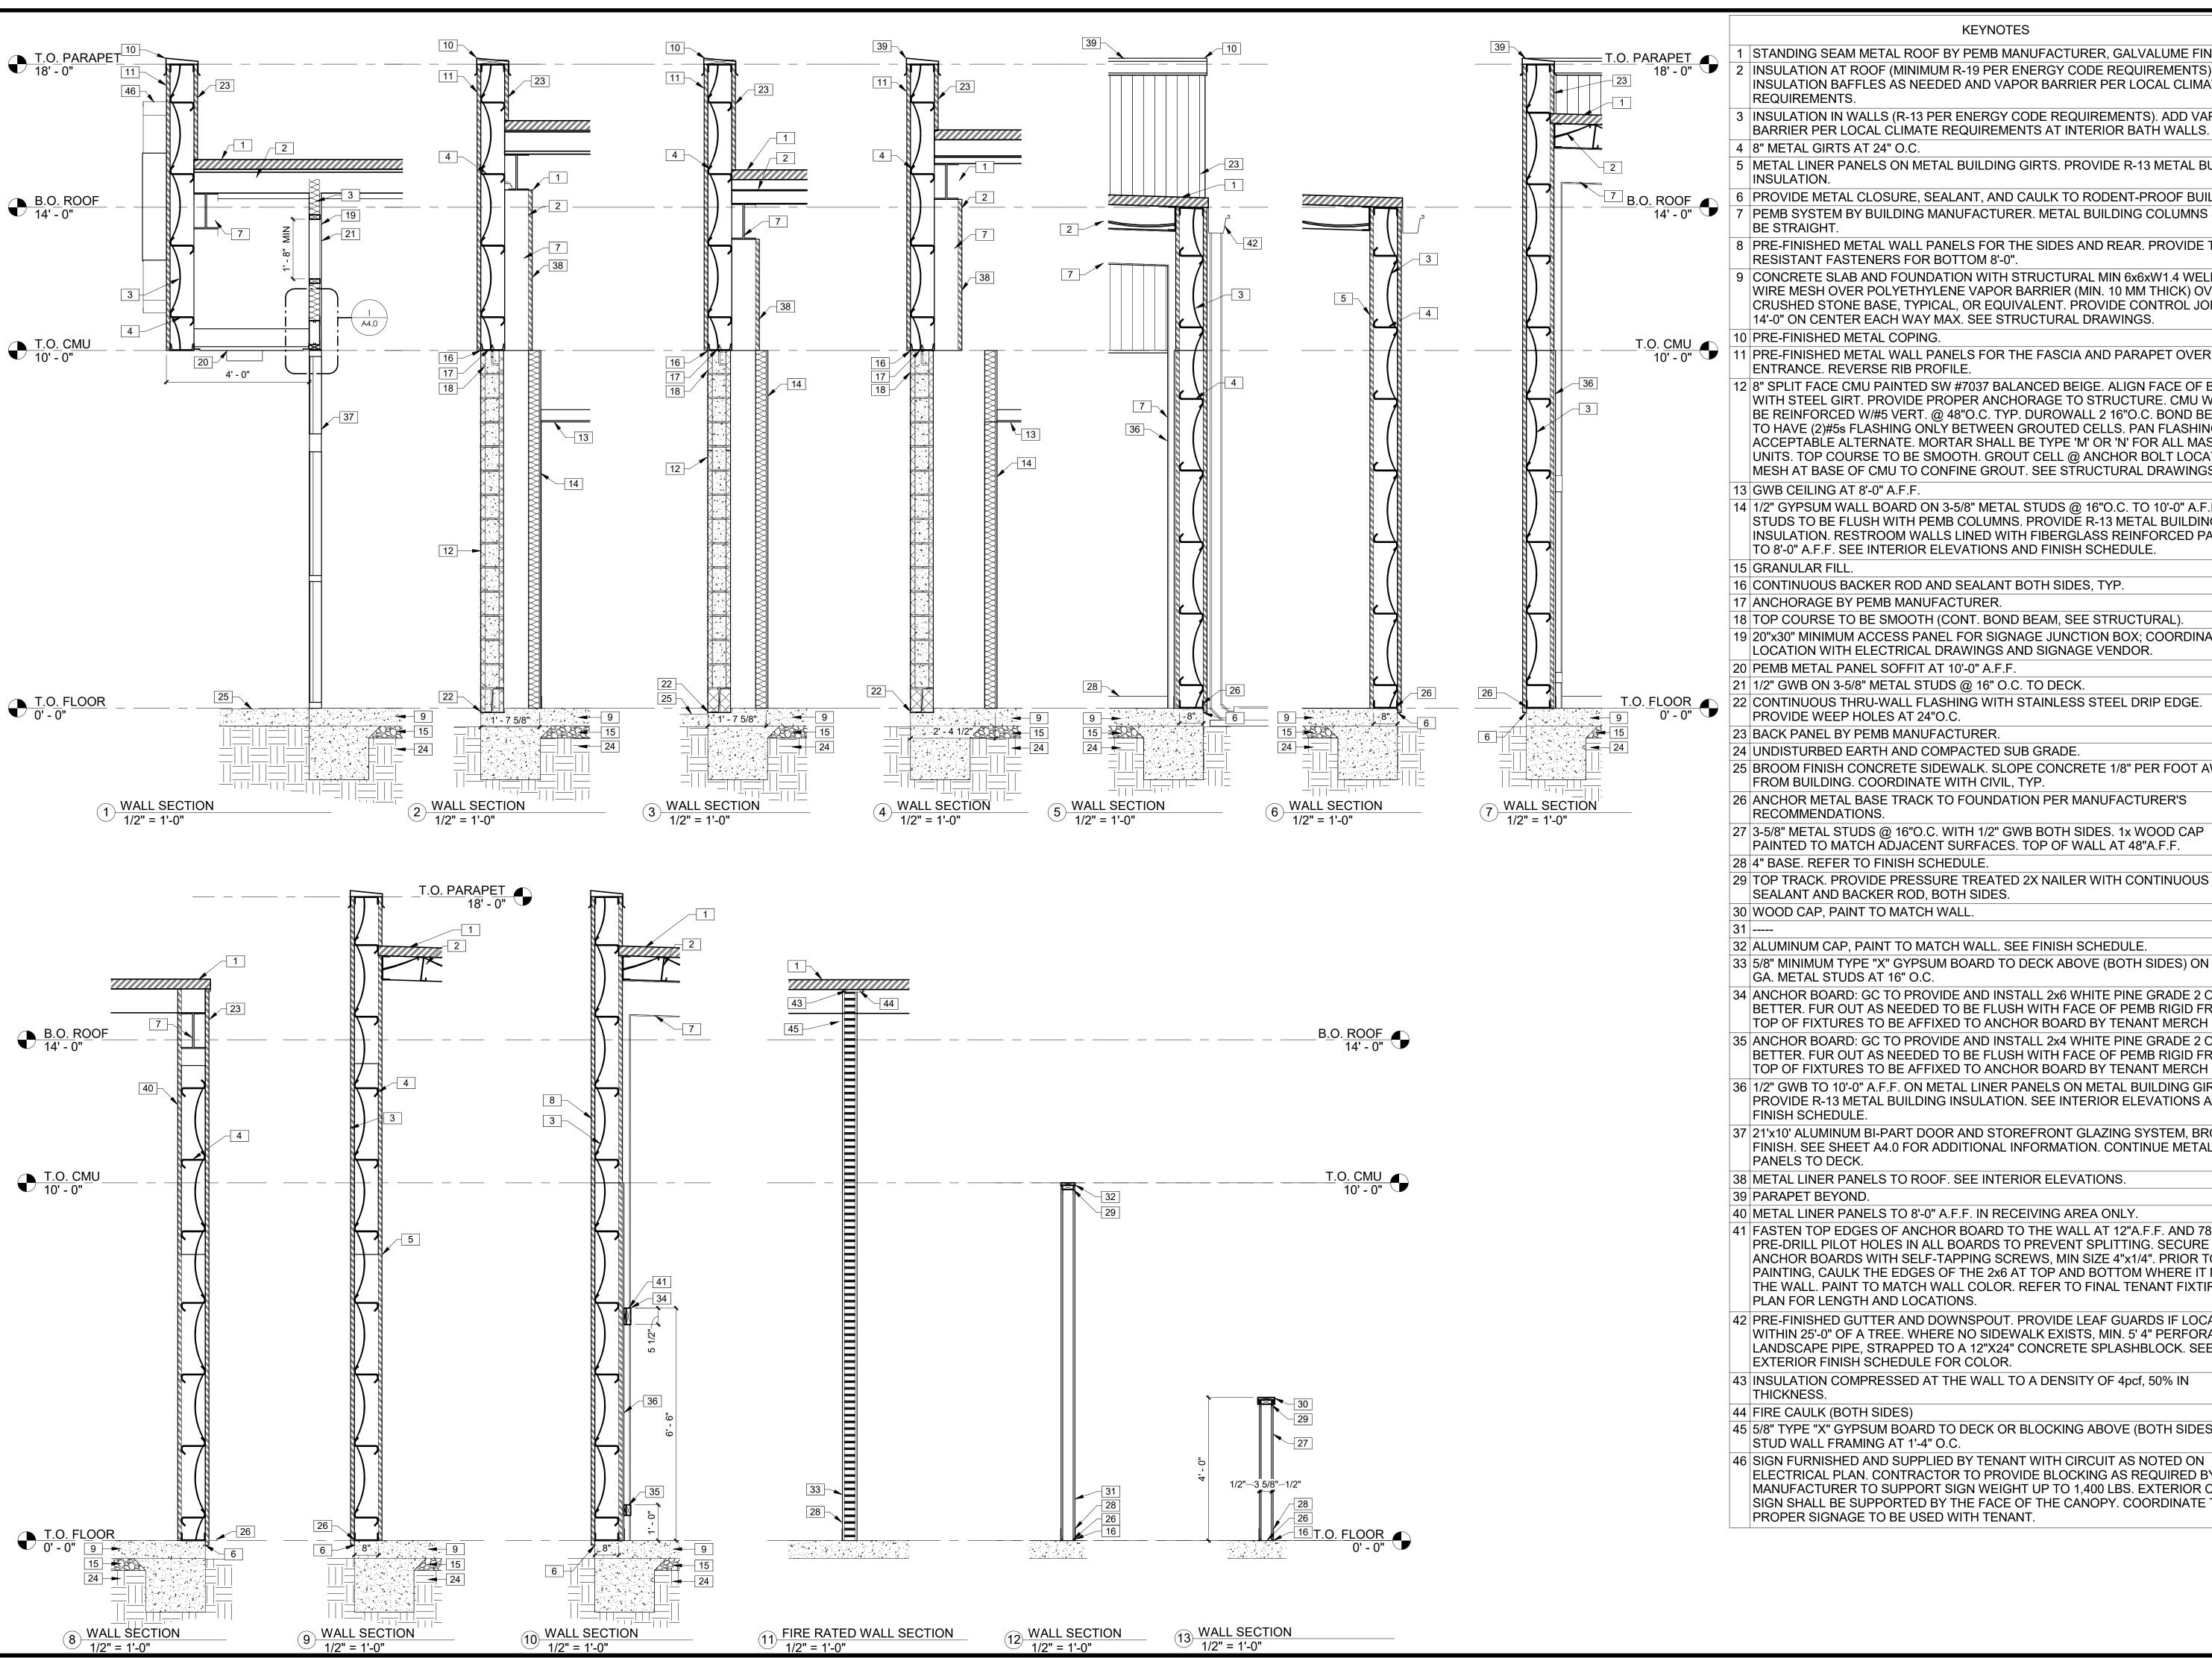
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STANDING SEAM METAL ROOF BY PEMB MANUFACTURER, GALVALUME FINISH INSULATION AT ROOF (MINIMUM R-19 PER ENERGY CODE REQUIREMENTS). ADD INSULATION BAFFLES AS NEEDED AND VAPOR BARRIER PER LOCAL CLIMATE

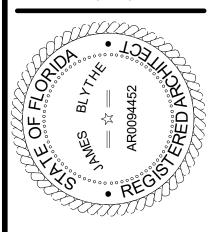3 INSULATION IN WALLS (R-13 PER ENERGY CODE REQUIREMENTS). ADD VAPOR

5 METAL LINER PANELS ON METAL BUILDING GIRTS. PROVIDE R-13 METAL BUILDING

6 PROVIDE METAL CLOSURE, SEALANT, AND CAULK TO RODENT-PROOF BUILDING. PEMB SYSTEM BY BUILDING MANUFACTURER. METAL BUILDING COLUMNS SHALL

8 PRE-FINISHED METAL WALL PANELS FOR THE SIDES AND REAR. PROVIDE TAMPER

9 CONCRETE SLAB AND FOUNDATION WITH STRUCTURAL MIN 6x6xW1.4 WELDED WIRE MESH OVER POLYETHYLENE VAPOR BARRIER (MIN. 10 MM THICK) OVER CRUSHED STONE BASE, TYPICAL, OR EQUIVALENT. PROVIDE CONTROL JOINTS AT

11 PRE-FINISHED METAL WALL PANELS FOR THE FASCIA AND PARAPET OVER THE

12 8" SPLIT FACE CMU PAINTED SW #7037 BALANCED BEIGE. ALIGN FACE OF BLOCK WITH STEEL GIRT. PROVIDE PROPER ANCHORAGE TO STRUCTURE. CMU WALL TO BE REINFORCED W/#5 VERT. @ 48"O.C. TYP. DUROWALL 2 16"O.C. BOND BEAMS TO HAVE (2)#5s FLASHING ONLY BETWEEN GROUTED CELLS. PAN FLASHING IS AN ACCEPTABLE ALTERNATE. MORTAR SHALL BE TYPE 'M' OR 'N' FOR ALL MASONRY UNITS. TOP COURSE TO BE SMOOTH. GROUT CELL @ ANCHOR BOLT LOCATIONS. MESH AT BASE OF CMU TO CONFINE GROUT. SEE STRUCTURAL DRAWINGS.

14 1/2" GYPSUM WALL BOARD ON 3-5/8" METAL STUDS @ 16"O.C. TO 10'-0" A.F.F. STUDS TO BE FLUSH WITH PEMB COLUMNS. PROVIDE R-13 METAL BUILDING INSULATION. RESTROOM WALLS LINED WITH FIBERGLASS REINFORCED PANELS TO 8'-0" A.F.F. SEE INTERIOR ELEVATIONS AND FINISH SCHEDULE.

16 CONTINUOUS BACKER ROD AND SEALANT BOTH SIDES, TYP.

18 TOP COURSE TO BE SMOOTH (CONT. BOND BEAM, SEE STRUCTURAL).

19 20"x30" MINIMUM ACCESS PANEL FOR SIGNAGE JUNCTION BOX; COORDINATE LOCATION WITH ELECTRICAL DRAWINGS AND SIGNAGE VENDOR.

22 CONTINUOUS THRU-WALL FLASHING WITH STAINLESS STEEL DRIP EDGE.

25 BROOM FINISH CONCRETE SIDEWALK. SLOPE CONCRETE 1/8" PER FOOT AWAY

26 ANCHOR METAL BASE TRACK TO FOUNDATION PER MANUFACTURER'S

27 3-5/8" METAL STUDS @ 16"O.C. WITH 1/2" GWB BOTH SIDES. 1x WOOD CAP

29 TOP TRACK. PROVIDE PRESSURE TREATED 2X NAILER WITH CONTINUOUS

33 5/8" MINIMUM TYPE "X" GYPSUM BOARD TO DECK ABOVE (BOTH SIDES) ON 6", 20

34 ANCHOR BOARD: GC TO PROVIDE AND INSTALL 2x6 WHITE PINE GRADE 2 OR BETTER. FUR OUT AS NEEDED TO BE FLUSH WITH FACE OF PEMB RIGID FRAME TOP OF FIXTURES TO BE AFFIXED TO ANCHOR BOARD BY TENANT MERCH DEPT

35 ANCHOR BOARD: GC TO PROVIDE AND INSTALL 2x4 WHITE PINE GRADE 2 OR BETTER. FUR OUT AS NEEDED TO BE FLUSH WITH FACE OF PEMB RIGID FRAME TOP OF FIXTURES TO BE AFFIXED TO ANCHOR BOARD BY TENANT MERCH DEPT

36 1/2" GWB TO 10'-0" A.F.F. ON METAL LINER PANELS ON METAL BUILDING GIRTS PROVIDE R-13 METAL BUILDING INSULATION. SEE INTERIOR ELEVATIONS AND

37 21'x10' ALUMINUM BI-PART DOOR AND STOREFRONT GLAZING SYSTEM, BRONZE FINISH. SEE SHEET A4.0 FOR ADDITIONAL INFORMATION. CONTINUE METAL LINER

38 METAL LINER PANELS TO ROOF. SEE INTERIOR ELEVATIONS.

40 METAL LINER PANELS TO 8'-0" A.F.F. IN RECEIVING AREA ONLY.

41 FASTEN TOP EDGES OF ANCHOR BOARD TO THE WALL AT 12"A.F.F. AND 78"A.F.F. PRE-DRILL PILOT HOLES IN ALL BOARDS TO PREVENT SPLITTING. SECURE ANCHOR BOARDS WITH SELF-TAPPING SCREWS, MIN SIZE 4"x1/4". PRIOR TO PAINTING, CAULK THE EDGES OF THE 2x6 AT TOP AND BOTTOM WHERE IT MEETS THE WALL. PAINT TO MATCH WALL COLOR. REFER TO FINAL TENANT FIXTIRE

42 PRE-FINISHED GUTTER AND DOWNSPOUT. PROVIDE LEAF GUARDS IF LOCATED WITHIN 25'-0" OF A TREE. WHERE NO SIDEWALK EXISTS, MIN. 5' 4" PERFORATED LANDSCAPE PIPE, STRAPPED TO A 12"X24" CONCRETE SPLASHBLOCK. SEE

43 INSULATION COMPRESSED AT THE WALL TO A DENSITY OF 4pcf, 50% IN

45 5/8" TYPE "X" GYPSUM BOARD TO DECK OR BLOCKING ABOVE (BOTH SIDES) ON 6"

46 SIGN FURNISHED AND SUPPLIED BY TENANT WITH CIRCUIT AS NOTED ON ELECTRICAL PLAN. CONTRACTOR TO PROVIDE BLOCKING AS REQUIRED BY SIGN MANUFACTURER TO SUPPORT SIGN WEIGHT UP TO 1,400 LBS. EXTERIOR CANOPY SIGN SHALL BE SUPPORTED BY THE FACE OF THE CANOPY. COORDINATE THE

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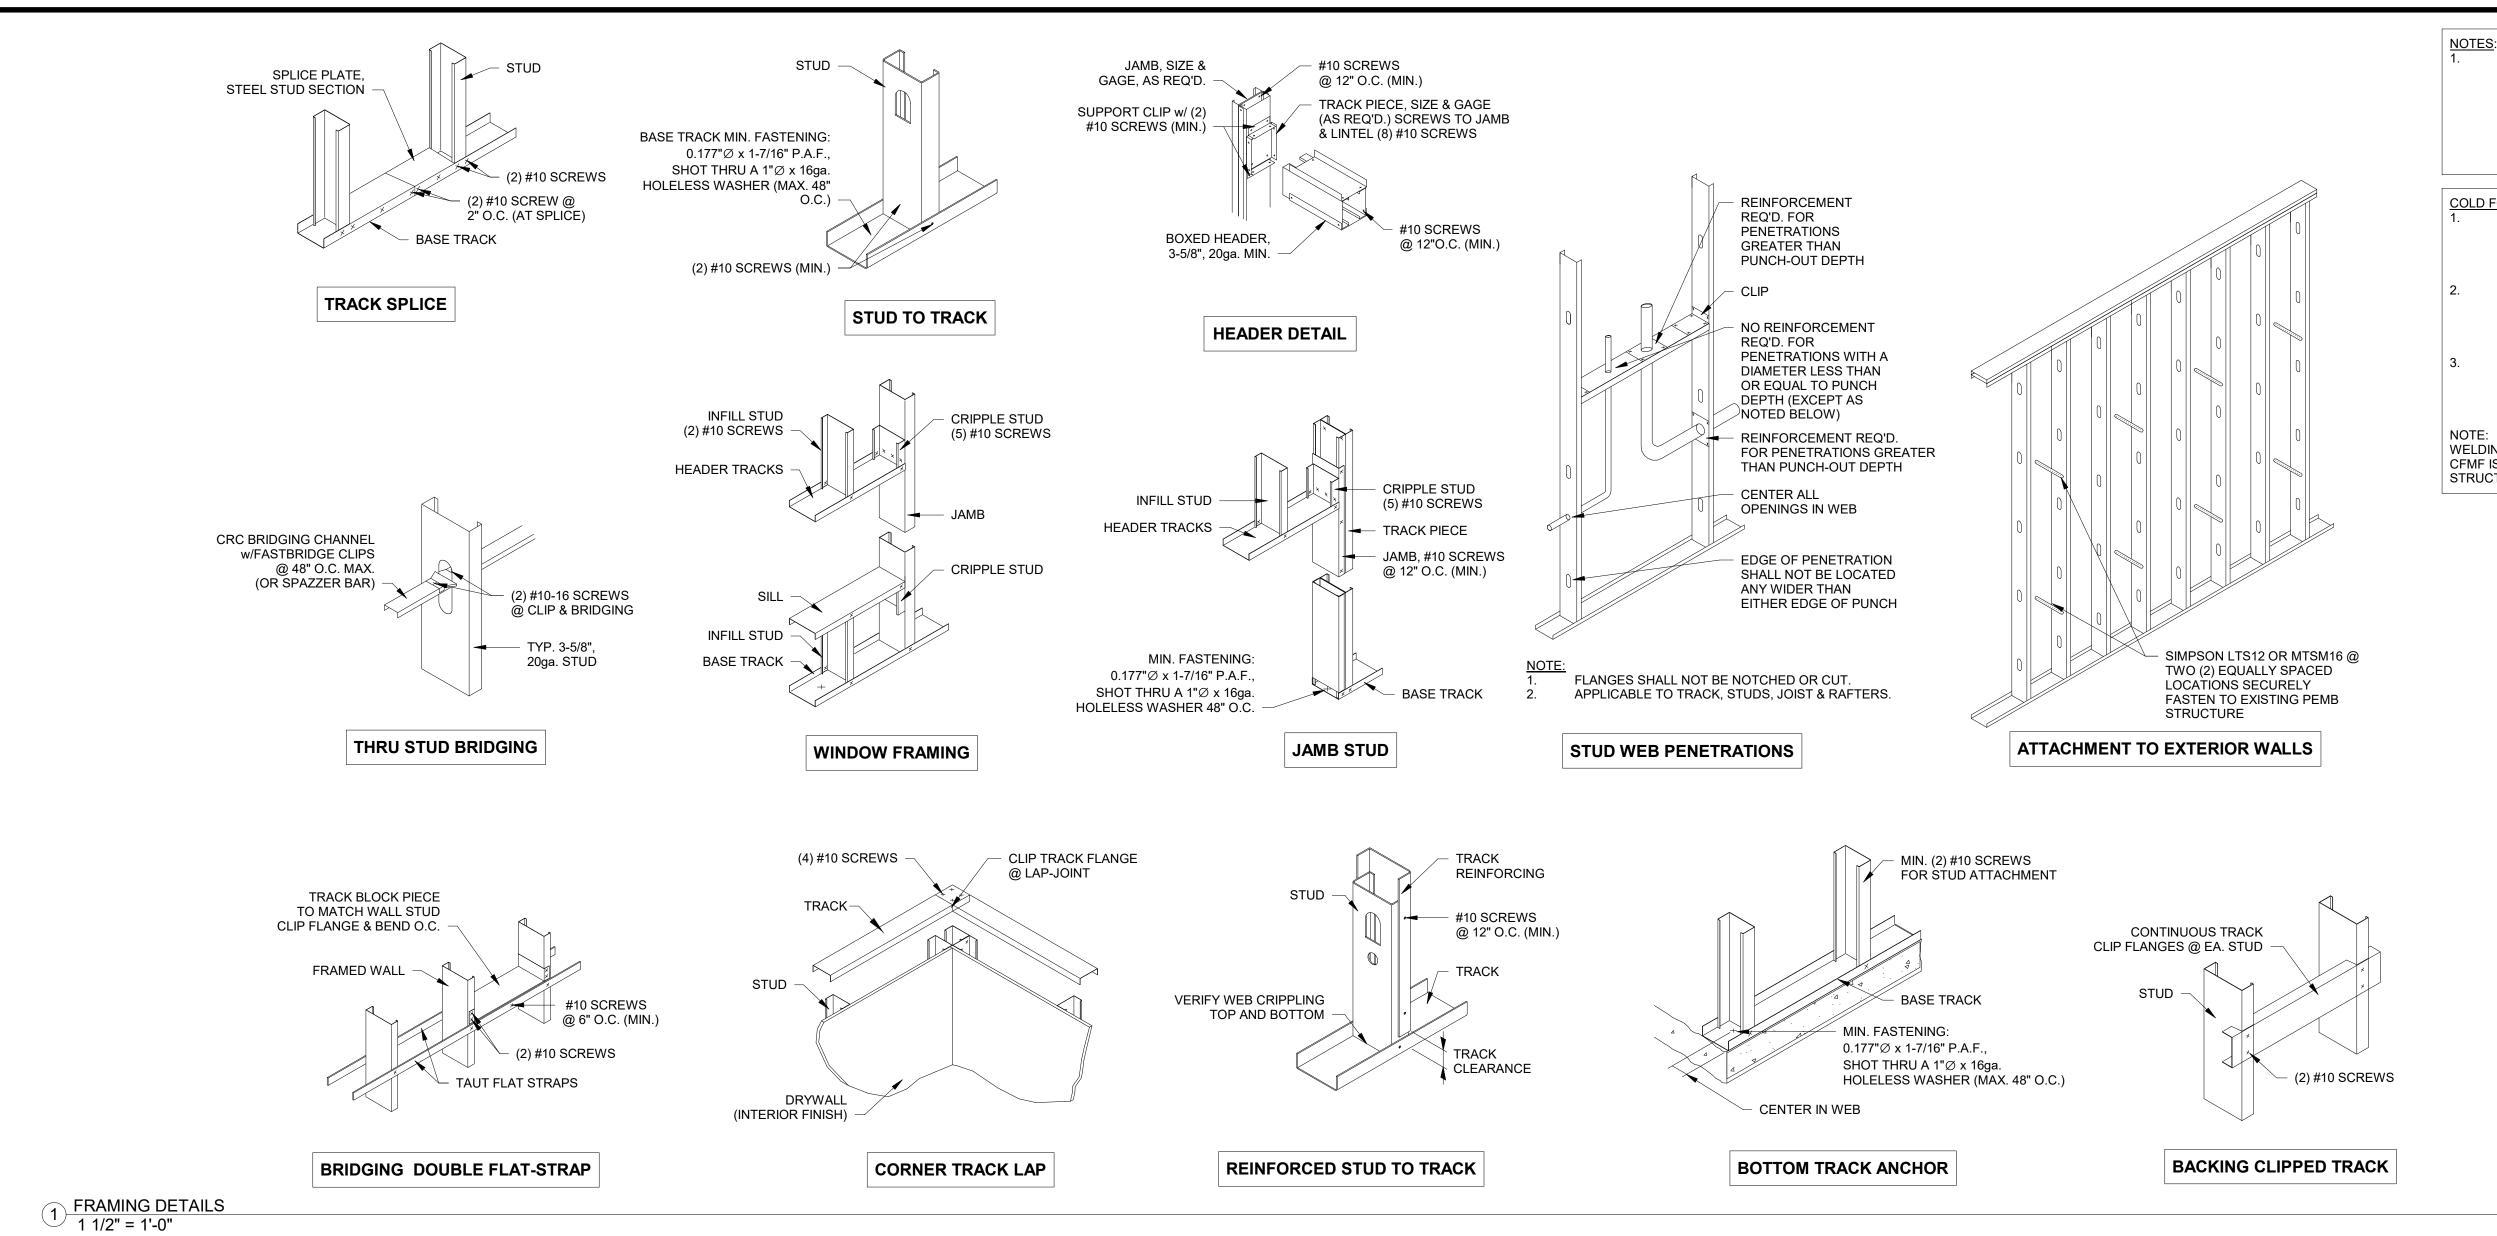
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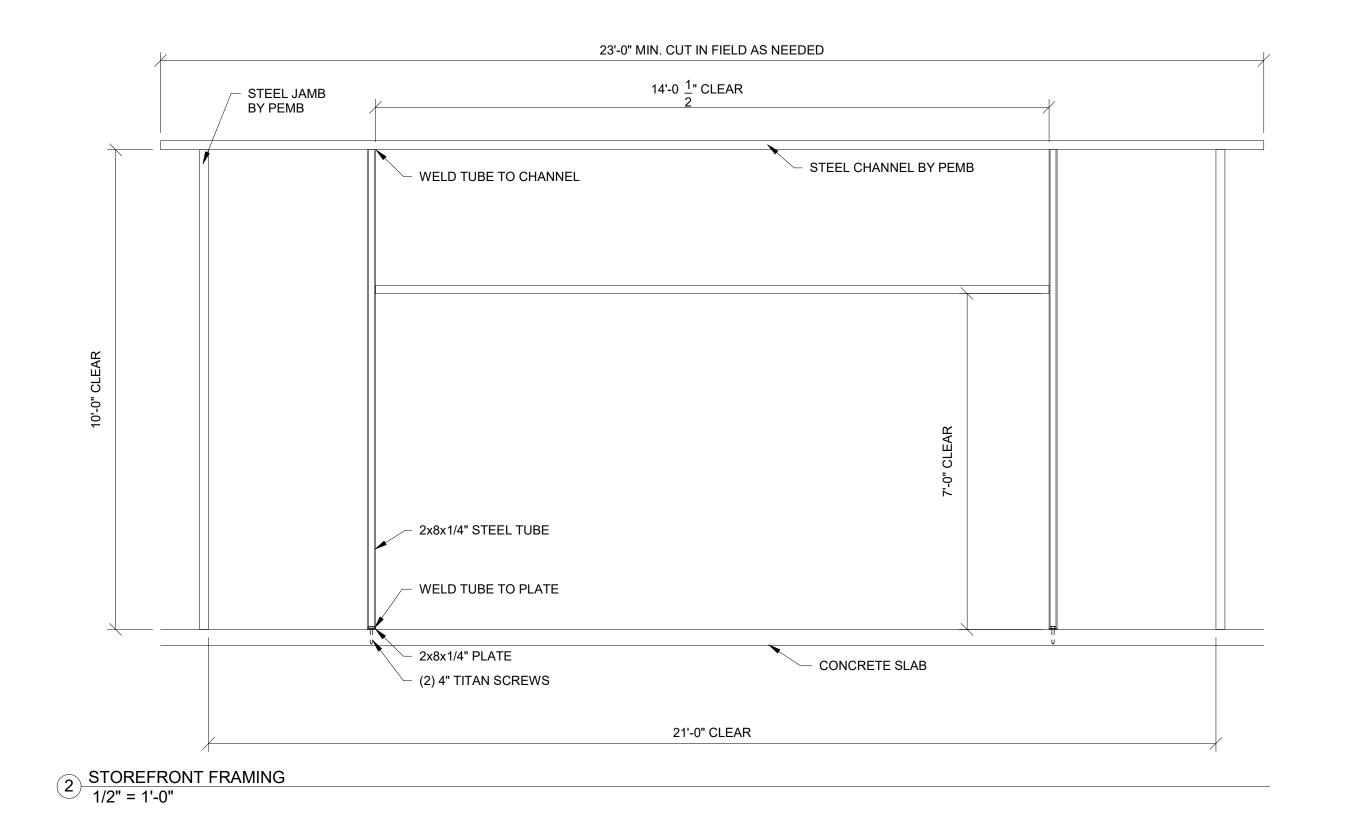
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RIGID FACING MATERIAL APPLIED TO BOTH STUD FLANGES MAY BE UTILIZED IN LIEU OF U-CHANNEL, PROVIDED THE FOLLOWING CRITERIA:

STUD HEIGHT DOES NOT EXCEED 16'

SHEATHING APPLIED TO BOTH STUD FLANGES FULL HEIGHT

PER APPLICABLE ASTM STANDARDS. STUD SHALL BE BRACED IF ONE FLANGE IS TEMPORARILY UNSHEATHED.

COLD FORMED METAL FRAMING:

ALL COLD FORMED METAL FRAMING SHALL BE DOMESTIC ASTM A653 (Fy=33ksi) STEEL AND DESIGNED IN ACCORDANCE WITH THE LATEST SSMA SPECIFICATIONS FOR DESIGN, FABRICATION, AND ERECTION OF COLD FORMED METAL FRAMING AND THE SSMA

CODE OF STANDARD PRACTICE. ALL CFMF COMPONENTS SHALL BE MANUFACTURED AS PER ASTM C955 AND BE GALVANIZED WITH A MIN. G-60 COATING PER ASTM C955. ALL PRODUCTS SHALL BE FREE OF RUST, DENTS, BENDS AND TWISTS, AND STORED ON A FLAT PLANE PRIOR TO INCLUSION IN


BOTTOM TRACK SHALL BE SECURED TO THE CONCRETE FOUNDATION WITH A MIN. 0.177" DIAMETER x 1-7/16" PAF (POWDER ACTUATED FASTENER), SHOT THROUGH A 1" DIAMETER x 16GA HOLELESS WASHER.

WELDING IS AN ALTERNATE TO THE CONNECTIONS SHOWN. NONE OF THE CFMF IS LOAD BEARING, PEMB (PRE-ENGINEERED METAL BUILDING) IS THE STRUCTURAL SUPPORT AND DESIGN FOR THE ENTIRE BUILDING.

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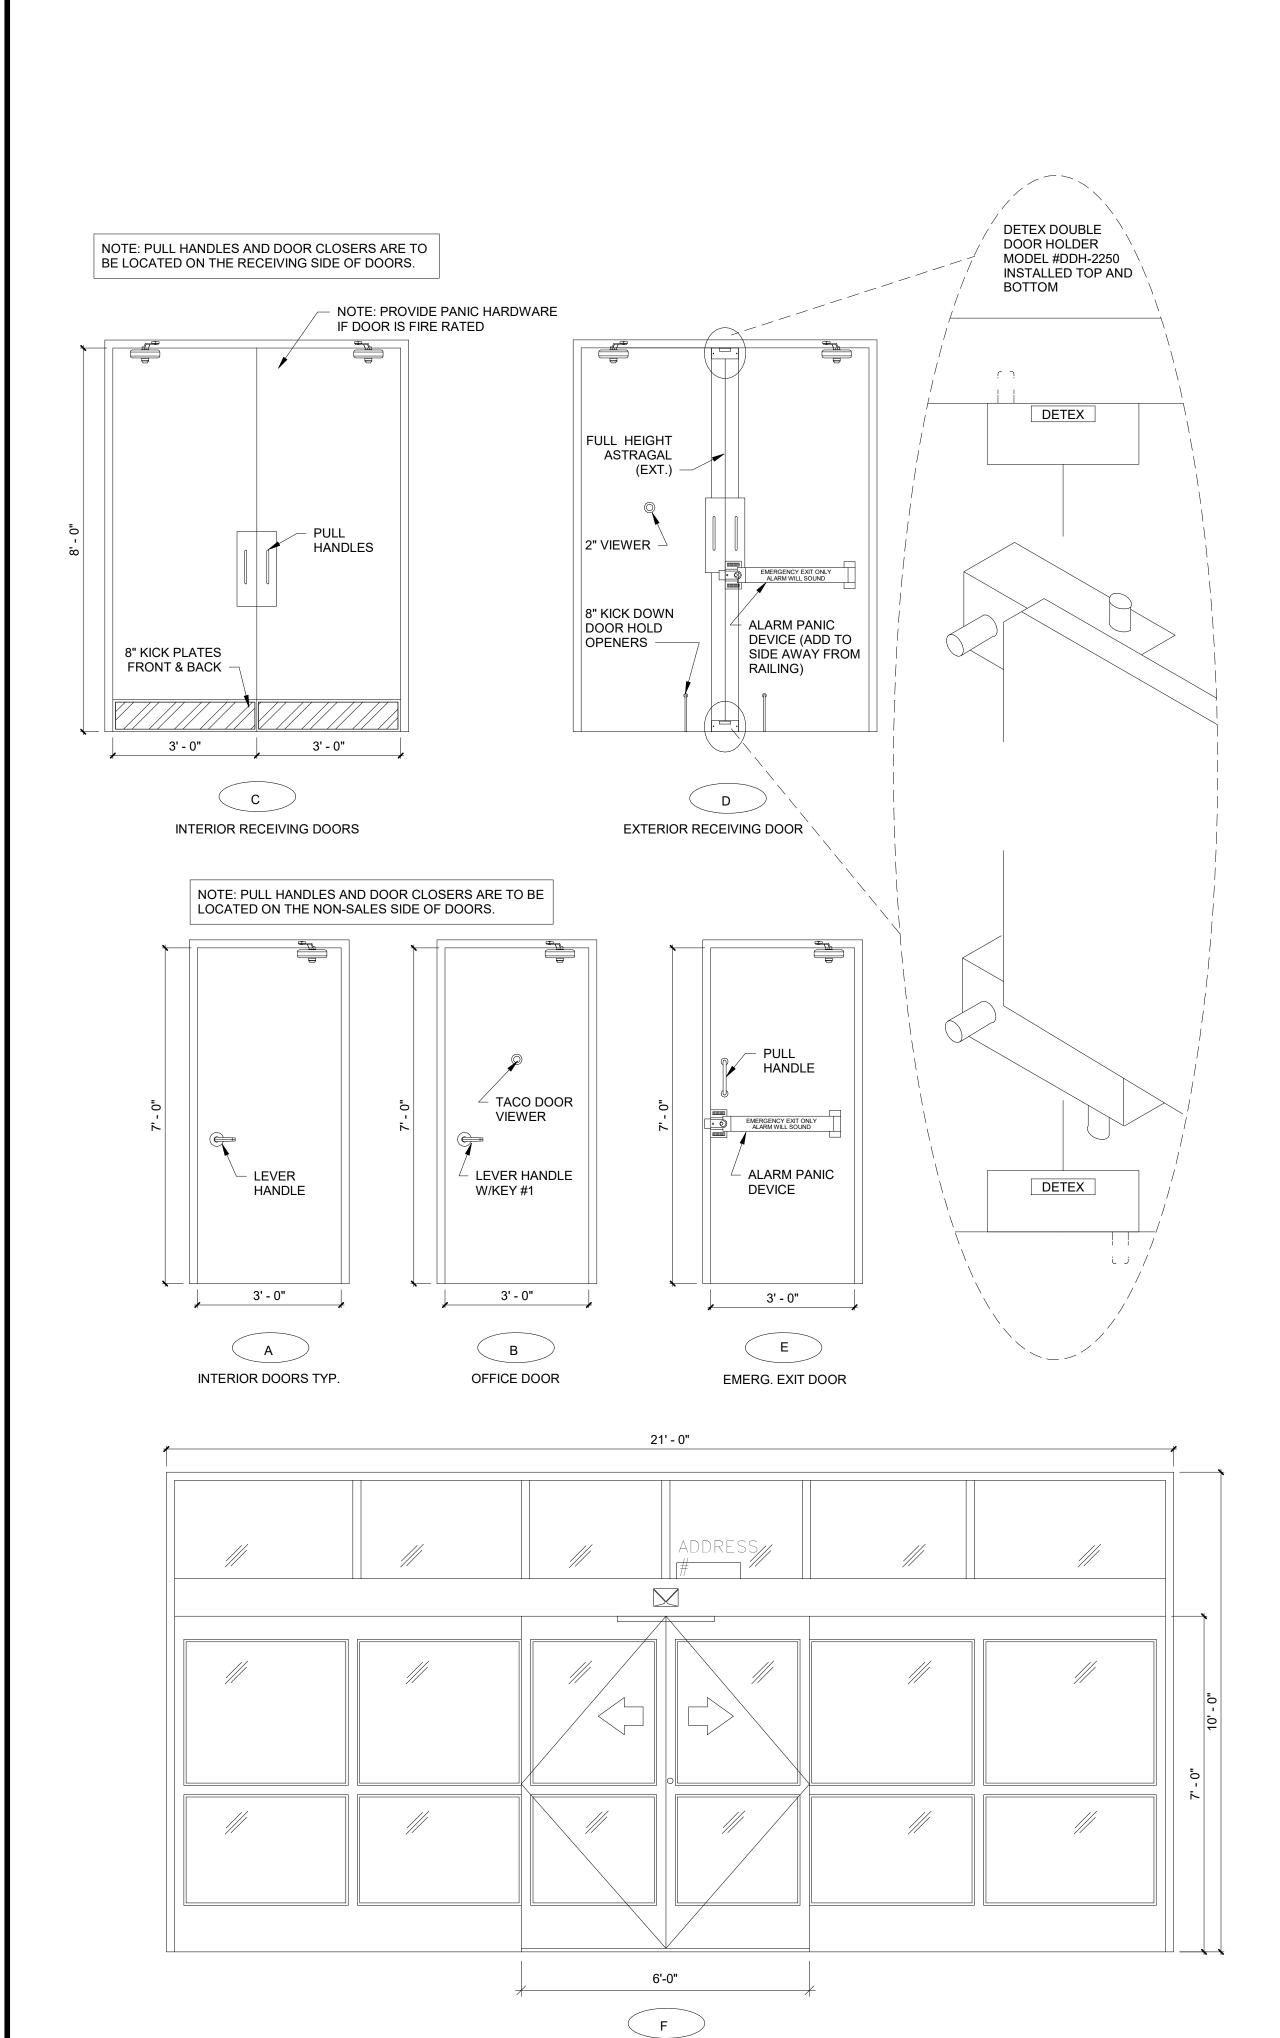
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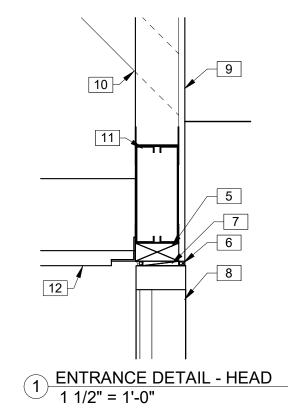
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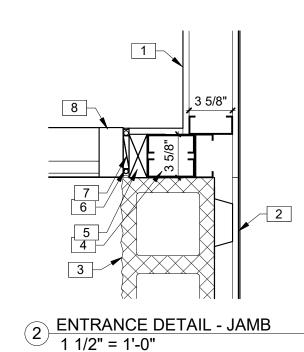
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STOREFRONT ENTRANCE




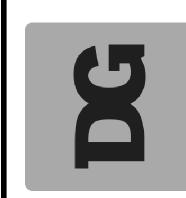

KEYNOTES

- 1 1/2" GWB ON METAL STUDS TO 10'-0" A.F.F.
- 2 1/2" GWB ON FURRING STRIPS ON 8" CMU.
- 3 8" SPLIT FACE CMU PAINTED SW #7037 BALANCED BEIGE. ALIGN FACE OF BLOCK WITH STEEL GIRT. PROVIDE PROPER ANCHORAGE TO STRUCTURE. CMU WALL TO BE REINFORCED W/#5 VERT. @ 48"O.C. TYP. DUROWALL 2 16"O.C. BOND BEAMS TO HAVE (2)#5s FLASHING ONLY BETWEEN GROUTED CELLS. PAN FLASHING IS AN ACCEPTABLE ALTERNATE. MORTAR SHALL BE TYPE 'M' OR 'N' FOR ALL MASONRY UNITS. TOP COURSE TO BE SMOOTH. GROUT CELL @ ANCHOR BOLT LOCATIONS. MESH AT BASE OF CMU TO CONFINE GROUT. SEE STRUCTURAL DRAWINGS.
- 4 POST:(2) 400S162-16 WITH (2) 400T125-16 FULL HEIGHT.
- 5 2X WOOD NAILER AS REQUIRED.
- 6 CONTINUOUS BACKER ROD AND SEALANT BOTH SIDES, TYP.
- 7 SHIM AS NEEDED.
- 8 21'x10' ALUMINUM BI-PART DOOR AND STOREFRONT GLAZING SYSTEM, BRONZE FINISH. SEE SHEET A4.0 FOR ADDITIONAL INFORMATION. CONTINUE METAL LINER PANELS TO DECK.
- 9 1/2" GWB ON 3-5/8" METAL STUDS @ 16" O.C. TO DECK.
- 10 DIAGONAL BRACING TO STRUCTURE ABOVE AS REQUIRED (TYP) 4'-0" O.C. FOR LATERAL SUPPORT ONLY.
- 11 BOX HEADER, (2) 800S200-16 AND 400T126-16 (TOP AND BOTTOM).

 12 PEMB METAL PANEL SOFFIT AT 10'-0" A.F.F.

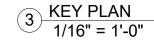

DOOR SCHEDULE										
Door	Туре	Width	Height	Description	HW Set	Comments				
100	Α	3' - 0"	7' - 0"	SOLID CORE WOOD DOOR OR HOLLOW METAL DOOR. PAINTED	1					
101	В	3' - 0"	7' - 0"	SOLID CORE WOOD DOOR OR HOLLOW METAL DOOR. PAINTED	2					
102	Е	3' - 0"	7' - 0"	INSULATED METAL DOOR, PAINTED.	3					
103A	С	6' - 0"	8' - 0"	SOLID CORE WOOD DOOR OR HOLLOW METAL DOOR, PAINTED. PROVIDE FIRE RATED DOORS IF REQUIRED.	4/9	HARDWARE SET 9 IF FIRE RATED				
103B	D	6' - 0"	8' - 0"	SOLID CORE WOOD DOOR OR HOLLOW METAL DOOR, PAINTED.	5					
104	Α	3' - 0"	7' - 0"	SOLID CORE WOOD DOOR OR HOLLOW METAL DOOR, PAINTED	6					
105	Α	3' - 0"	7' - 0"	SOLID CORE WOOD DOOR OR HOLLOW METAL DOOR, PAINTED.	6					
106	F	6' - 0"	7' - 0"	21'-0" BI-PART WITH TRANSOM AND GLASS BRONZE FINISH	7					
107	Α	2' - 8"	7' - 0"	SOLID CORE WOOD DOOR OR HOLLOW METAL DOOR, PAINTED.	8					

HARDWARE SETS:

- (1-1/2 PAIR HINGES). (1) FALCON PASSAGE LEVERSET #W101S-DANE-626-NO KEY REQ'D, (1) HAGER DOOR CLOSER #5400, (1) IVES WALL STOP, #402-1/2B-26D
- (1-1/2 PAIR HINGES). (1) FALCON PASSAGE LEVERSET #581PD-DANE-626-KEY #1, (1) HAGER DOOR CLOSER #5400, (1) IVES WALL STOP, #402-1/2B-26D, (1) TACO DOOR VIEWER #TA3310PC
- (1-1/2 PAIR HINGES). (1) VON DUPRIN GUARD-X EXIT ALARM LOCK #2670-28, (1) HAGER DOOR CLOSER #5400, (1) DOOR SWEEP, WEATHERSTRIPPING, (1) 7015SCB-26D RIM CYLNIDER, (1) HAGER 8N PULL
- (3 PAIR HINGES), (2) BURNS PULL PLATES #5410-32D-26D-GRIP, (2) BURNS PUSH PLATES #54-US32D, (4) IVES KICK PLATES #8400-S32D-8X34, (2) HAGER DOOR CLOSERS #5400, (2) IVES 4" DOOR HOLDER #452B26D-4, (1) IVES WALL STOP #402-1/2B-26D; (PROVIDE PANIC HARDWARE IF DOR IS FIRE RATED)(NO DOOR HOLDERS IF FIRE RATED)
- 5. (3 PAIR HINGES), (1) VON DUPRIN GUARD-X EXIT ALARM LOCK #2670-28, (1) VON DUPRIN GUARD-X DOUBLE DOOR STRIKE #2609, (1) DETEX DOUBLE DOOR HOLDER #DDH-2250 TOP & BOTTOM, (2) HAGER DOOR CLOSERS #5400, (2) BURNS PULL PLATES #5410-32D-26D-GRIP, (1) 2" DOOR SCOPE #DS/1000MB, (2) 8" DOOR HOLDERS #608Z, (1) NATIONAL GUARD HD THRESHOLD #425 HD-6 FT, (2) DOOR SWEEPS #770SAV-3FT, WEATHER STRIPPING HAGER # 892SAV, (1) 7015SCB-26D RIM CYLINDER
- (1-1/2 PAIR HINGES). (1) FALCON PASSAGE LEVERSET #W581PD-DANE-626-KEY #2, (1) HAGER DOOR CLOSER #5400, (1) IVES WALL STOP, #402-1/2B-26D
- BY MANUFACTURER TO BE REKEYED BY TENANT AREA MANAGER WITH (1) ILCO RIM CYLINDER #7015SC8-26D
- (1-1/2 PAIR HINGES). (1) FALCON PASSAGE LEVERSET #W581PD-DANE-626-KEY #2, (1) HAGER DOOR CLOSER #5400, (1) IVES DOOR HOLDER #452B26D-4 (1) IVES WALL STOP, # 402-1/2B-26D
- (3) HINGES COMPATIBLE WITH FIRE RATING, (2) SVR EXIT QED316-36"-7FT-689, (1) EXIT TRIM QRT330-E-SC-KD-689. (2) BURNS PULL PLATES #5410-32D-26D-GRIP, (2) BURNS PUSH PLATES #54-US32D, (4) IVES KICK PLATES #8400-S32D-8X34. (2) STANLEY DOOR CLOSERS QDC311-689

NOTES

- 1. INTERIOR HOLLOW METAL FRAMES AND INTERIOR DOORS TO BE PAINTED SW6991 BLACK MAGIC (SEMI-GLOSS).
- 2. EXTERIOR HOLLOW METAL DOORS AND FRAMES TO BE PAINTED SW7041 VAN DYKE BROWN. INTERIOR SIDE TO BE PAINTED SW6991 BLACK MAGIC.
- 3. ALL EXTERIOR MATERIALS SHALL BE RATED FOR 160 MPH HURRICANE FORCE WINDS. RISK CATEGORY 2.

DRAWING STATUS:

REVISIONS

ISSUE DATE: 04.05.2024

PERMIT SET

DRAWN BY: CHECKED BY:

PROJECT NUMBER: 4000.249

4000.249


DRAWING TITLE:

DOOR SCHEDULE AND DETAILS

<u>SHEET NO.</u> **44.0**

DATE/TIME STAMP: 3/29/2024 7:59:27 AM



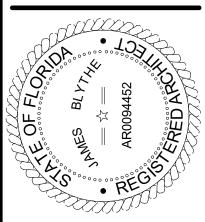





ROOM FLOORS BASE														
	FINIS		S	A WALL B WALL C WALL						D WALL				
NO. NAME	MATERIAL	FINISH	MATERIAL H	MATERIAL	FINISH	MATERIAL	FINISH	MATERIAL	FINISH	MATERIAL	FINISH	MATERIAL	FINISH	COMMENTS
100 LOUNGE	SEALED CONCRETE	CONCRETE WITH SEALER	4" RUBBER/VINYL BLACK		SHERWIN WILLIAMS SW7005 PURE WHITE, E PRO-MAR LATEX SEMI-GLOSS	GWB TO 10'-0" A.F.F.	SHERWIN WILLIAMS SW7005 PURE WHITE, PRO-MAR LATEX SEMI-GLOSS	GWB TO 10'-0" A.F.F.	SHERWIN WILLIAMS SW7005 PURE WHITE, PRO-MAR LATEX SEMI-GLOSS				PAINT EXPOSED STRUCTURE SHERWIN WILLIAMS SW7005 PURE WHITE	
101 OFFICE	SEALED CONCRETE	POLISHED CONCRETE WITH SEALER	R 4" RUBBER/VINYL BLACK	GWB TO 10'-0" A.F.F.	SHERWIN WILLIAMS SW7005 PURE WHITE, PRO-MAR LATEX SEMI-GLOSS	GWB TO 10'-0" A.F.F.	SHERWIN WILLIAMS SW7005 PURE WHITE, PRO-MAR LATEX SEMI-GLOSS		SHERWIN WILLIAMS SW7005 PURE WHITE, PRO-MAR LATEX SEMI-GLOSS				PAINT EXPOSED STRUCTURE SHERWIN WILLIAMS SW7005 PURE WHITE	SEE INTERIOR ELEVATIONS
103 RECEIVING AREA	SEALED CONCRETE	CONCRETE WITH SEALER	N/A N/A	METAL LINER PANEL TO 8'-0" A.F.F.	WHITE	METAL LINER PANELS TO 8'-0" A.F.F.	WHITE	METAL LINER PANELS TO 8'-0" A.F.F.	WHITE		TAPED, PAINTED AS REQUIRED BY CODE. METAL LINER PANEL TO DECK AS ALTERNATE.		PAINT EXPOSED STRUCTURE SHERWIN WILLIAMS SW7005 PURE WHITE	FINISH ALL WALLS T ROOF DECK
104 RESTROOM	SEALED CONCRETE	SHERWIN WILLIAMS ACRYLIC SILICONE SILK CHOCOLATE HC-117	4" RUBBER/VINYL BLACK	GWB TO ROOF DECK	8'-0" HIGH FIBERGLASS REINFORCED PANEL, WHITE	GWB TO ROOF DECK	8'-0" HIGH FIBERGLASS REINFORCED PANEL, WHITE	GWB TO 8'-0" A.F.F.	8'-0" HIGH FIBERGLASS REINFORCED PANEL, WHITE		8'-0" HIGH FIBERGLASS REINFORCED PANEL, WHITE	GWB AT 8'-0" A.F.F.	WHITE	
05 RESTROOM	SEALED CONCRETE	SHERWIN WILLIAMS ACRYLIC SILICONE SILK CHOCOLATE HC-117	4" RUBBER/VINYL BLACK	GWB TO 8'-0" A.F.F.	8'-0" HIGH FIBERGLASS REINFORCED PANEL, WHITE	GWB TO ROOF DECK	8'-0" HIGH FIBERGLASS REINFORCED PANEL, WHITE	GWB TO 8'-0" A.F.F.	8'-0" HIGH FIBERGLASS REINFORCED PANEL, WHITE		8'-0" HIGH FIBERGLASS REINFORCED PANEL, WHITE	GWB AT 8'-0" A.F.F.	WHITE	
106 SALES AREA	POLISHED CONCRETE (STEPS 1-9)	POLISHED CONCRETE WITH SEALER	R 4" RUBBER/VINYL BLACK	SEE INTERIOR ELEVATIONS	SEE INTERIOR ELEVATIONS	SEE INTERIOR ELEVATIONS	SEE INTERIOR ELEVATIONS	SEE INTERIOR ELEVATIONS	SEE INTERIOR ELEVATIONS	SEE INTERIOR ELEVATIONS			PAINT EXPOSED STRUCTURE SHERWIN WILLIAMS SW7005 PURE WHITE	
07 MAINTENANCE	SEALED CONCRETE	SHERWIN WILLIAMS ACRYLIC SILICONE SILK CHOCOLATE HC-117	4" RUBBER/VINYL BLACK	GWB TO 8'-0" A.F.F.	4'-0" HIGH FIBERGLASS REINFORCED PANEL, WHITE	GWB TO ROOF DECK	4'-0" HIGH FIBERGLASS REINFORCED PANEL, WHITE	GWB TO 8'-0" A.F.F.	SHERWIN WILLIAMS SW6991 BLACK MAGIC, PRO-MAR LATEX SSEMI-GLOSS TO 4'-0" A.F.F, SHERWIN WILLIAMS SW7005 PURE WHITE, PRO-MAR LATEX SEMI-GLOSS ABOVE 4'-0" A.F.F		SHERWIN WILLIAMS SW6991 BLACK MAGIC, PRO-MAR LATEX SSEMI-GLOSS TO 4'-0" A.F.F, SHERWIN WILLIAMS SW7005 PURE WHITE, PRO-MAR LATEX SEMI-GLOSS ABOVE 4'-0" A.F.F	STRUCTURE ABOVE	PAINT EXPOSED STRUCTURE SHERWIN WILLIAMS SW7005 PURE WHITE	
	POLISHED CONCRETE (STEPS 1-9)	POLISHED CONCRETE WITH SEALER	R 4" RUBBER/VINYL BLACK	GWB TO 8'-0" A.F.F.	SHERWIN WILLIAMS SW6991 BLACK MAGIC, PRO-MAR LATEX SEMI-GLOSS TO 4'-0" A.F.F. SHERWIN WILLIAMS SW7005 PURE WHITE, PRO-MAR LATEX SEMI-GLOSS ABOVE 4'-0" A.F.F	GWB TO 8'-0" A.F.F.	SHERWIN WILLIAMS SW7005 PURE WHITE, PRO-MAR LATEX SEMI-GLOSS	GWB TO 8'-0" A.F.F.	SHERWIN WILLIAMS SW6991 BLACK MAGIC, PRO-MAR LATEX SSEMI-GLOSS TO 4'-0" A.F.F, SHERWIN WILLIAMS SW7005 PURE WHITE, PRO-MAR LATEX SEMI-GLOSS ABOVE 4'-0" A.F.F		SHERWIN WILLIAMS SW6991 BLACK MAGIC, PRO-MAR LATEX SSEMI-GLOSS TO 4'-0" A.F.F, SHERWIN WILLIAMS SW7005 PURE WHITE, PRO-MAR LATEX SEMI-GLOSS ABOVE 4'-0" A.F.F		WHITE	
09 CART AREA	POLISHED CONCRETE (STEPS 1-9)	POLISHED CONCRETE WITH SEALER	R 4" RUBBER/VINYL BLACK	GWB TO 4'-0" A.F.F.	SHERWIN WILLIAMS SW6991 BLACK MAGIC, PRO-MAR LATEX SEMI-GLOSS	GWB TO 10'-0" A.F.F.	SHERWIN WILLIAMS SW6991 BLACK MAGIC, PRO-MAR LATEX SEMI-GLOSS TO 4'-0" A.F.F, SHERWIN WILLIAMS SW7005 PURE WHITE, PRO-MAR LATEX SEMI-GLOSS ABOVE 4'-0" A.F.F.	GWB TO ROOF DECK	SHERWIN WILLIAMS SW6991 BLACK MAGIC, PRO-MAR LATEX SSEMI-GLOSS TO 4'-0" A.F.F, SHERWIN WILLIAMS SW7005 PURE WHITE, PRO-MAR LATEX SEMI-GLOSS ABOVE 4'-0" A.F.F	N/A	N/A		PAINT EXPOSED STRUCTURE SHERWIN WILLIAMS SW7005 PURE WHITE	


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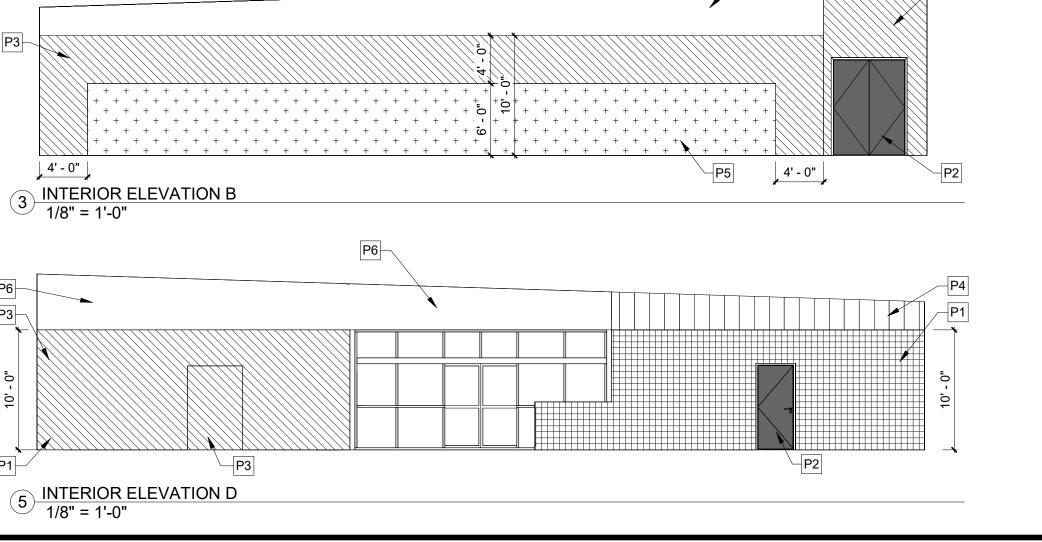
INTERIOR HOLLOW METAL FRAMES AND INTERIOR DOORS TO BE PAINTED SW 6991 BLACK MAGIC (SIME-GLOSS).

EXTERIOR HOLLOW METAL DOORS AND FRAMES TO BE PAINTED SW 7041 VAN DYKE BROWN. THE INTERIOR SIDE TO BE PAINTED SW 6991 BLACK MAGIC.


DOOR 103A-FIRE-RATED DOOR HARDWARE:
(2) SVR EXIT QED316-36"-7FT-689
(1) EXIT TRIM QRT330-E-SC-KD-689
(2) BURNS PULL PLATES #5410-32D-26D-GRIP
(2) BURNS PUSH PLATES #54-US32D
(4) IVES KICK PLATES #8400-S32D-8X34
(2) STANLEY DOOR CLOSERS QDC311-689

MAINTENANCE RESTROOM 104 **RECEIVING AREA** 103 108 RESTROOM P1 SW 6910 "DAISY" - DGP 105 SW 6921 "ELECTRIC LIME" - DGMM P2 SW 6991 "BLACK MAGIC" WALL PAINT LEGEND P3 SW 7065 "ARGOS" - SALES FLOOR P1 SW 6910 "DAISY" - DGP P4 EXPOSED PREFINISHED METAL LINER PANEL SW 6921 "ELECTRIC LIME" - DGMM P5 DENOTES GYPSUM BOARD, TAPED AND MUDDED ONLY P2 SW 6991 "BLACK MAGIC" P6 SW 7005 "PURE WHITE" P3 SW 7065 "ARGOS" - SALES FLOOR 101 P4 EXPOSED PREFINISHED METAL LINER PANEL LOUNGE P5 DENOTES GYPSUM BOARD, TAPED AND MUDDED ONLY P6 SW 7005 "PURE WHITE" 100 1. PAINT EXPOSED STRUCTURE SW7005 PURE WHITE 2. 1'-0" GWB BEHIND FIXTURES ON EXTERIOR METAL WALLS 1 FINISH PLAN 1/16" = 1'-0" 3. 2'-0" MIN GWB ON EACH SIDE OF DOORS



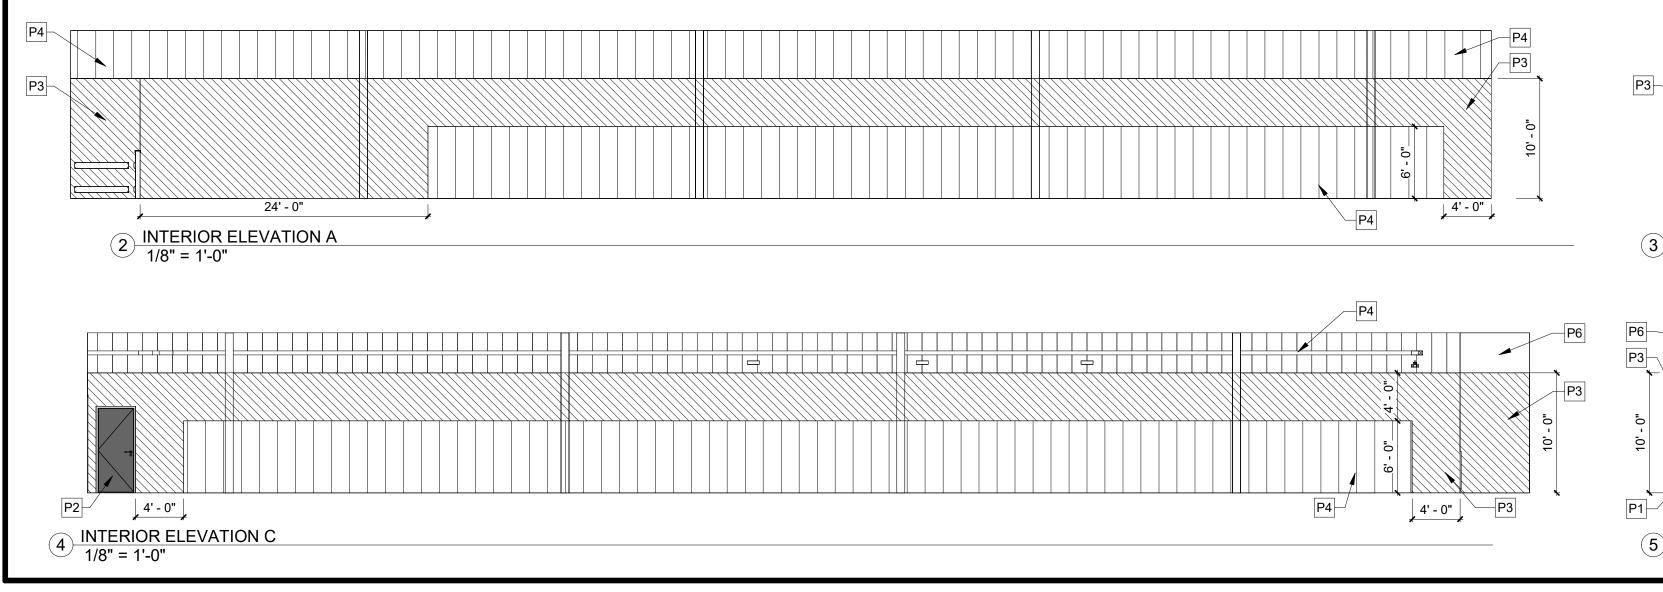

1449 SW 74TH DRIVE, SUITE 200
GAINESVILLE, FLORIDA 32607
352-333-3233
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TO THE BEST OF THE ARCHITECTS OR THE ENGINEER'S KNOW-EDGE, THE PLANS AND PECIFICATIONS COMPLY WITH THE APPLICABLE MINIMUM BUILDING CODES & THE PPLICABLE FIRE SAFETY STANDARDS AS DETERMINED BY THE LOCAL ANTHORITY IN CCORDANCE WITH THE ECTION AND CHAPTER 633, FL STATUTES.

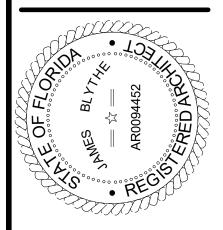

FORT WHITE
T.B.D. US HWY 27

REVISIONS

DATE: REF:

DRAWING STATUS: PERMIT SET

ISSUE DATE: 04.05.2024

DRAWN BY: CHECKED BY:
MV JM

PROJECT NUMBER:
4000.249

DRAWING TITLE:
INTERIOR ELEVATIONS AND


INTERIOR ELEVATIONS AND FINISHES


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DATE/TIME STAMP: 3/29/2024 8:00:04 AM

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REVISIONS




DRAWING STATUS: PERMIT SET ISSUE DATE:

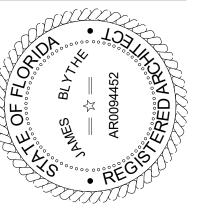04.05.2024

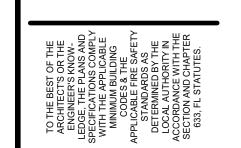
PROJECT NUMBER: 4000.249 **DRAWING TITLE:**


SIGN ELEVATIONS AND DETAILS

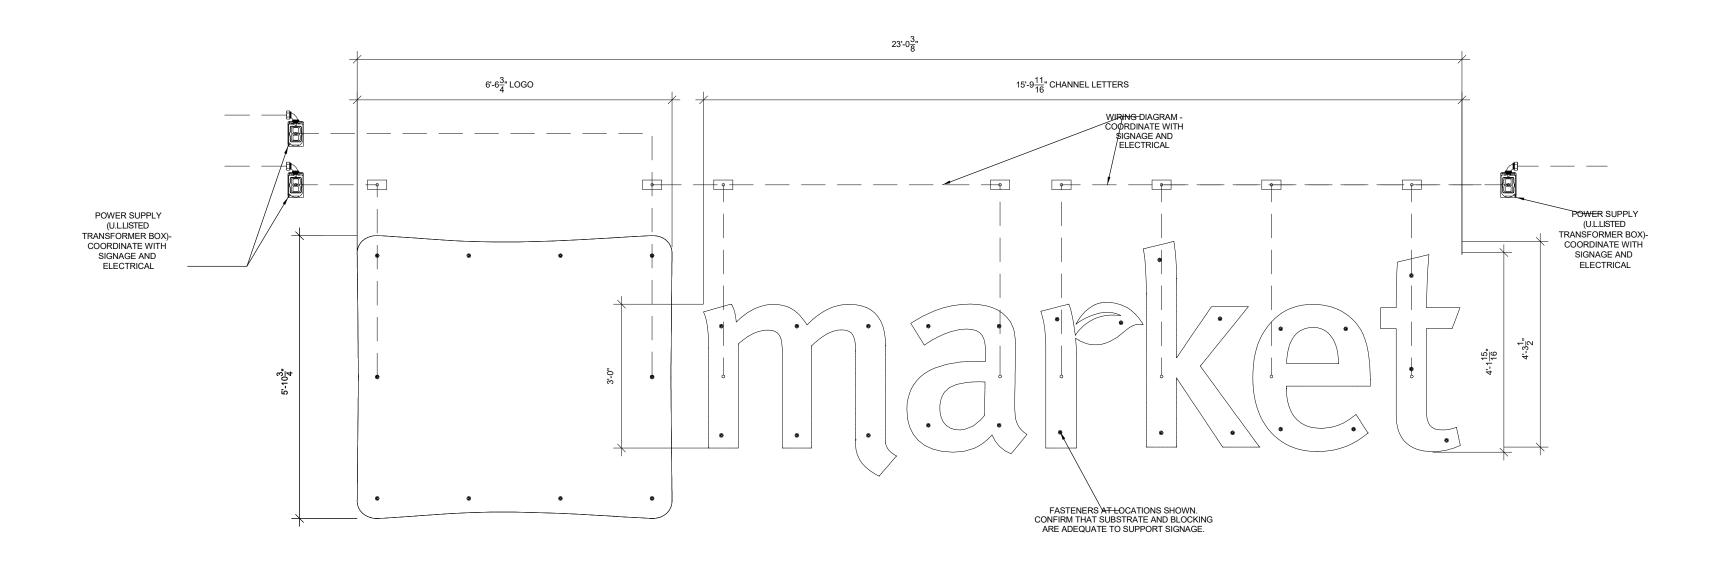



THIS SIGN IS TO BE PROVIDED AND INSTALLED BY THE DEVELOPER OR CONTRACTOR AT THE BEGINNING OF CONSTRUCTION PROJECT.

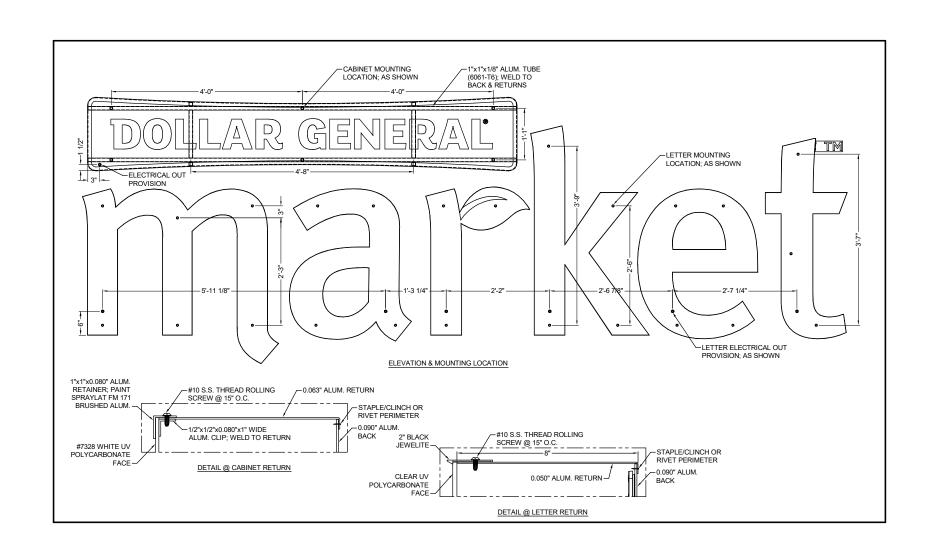

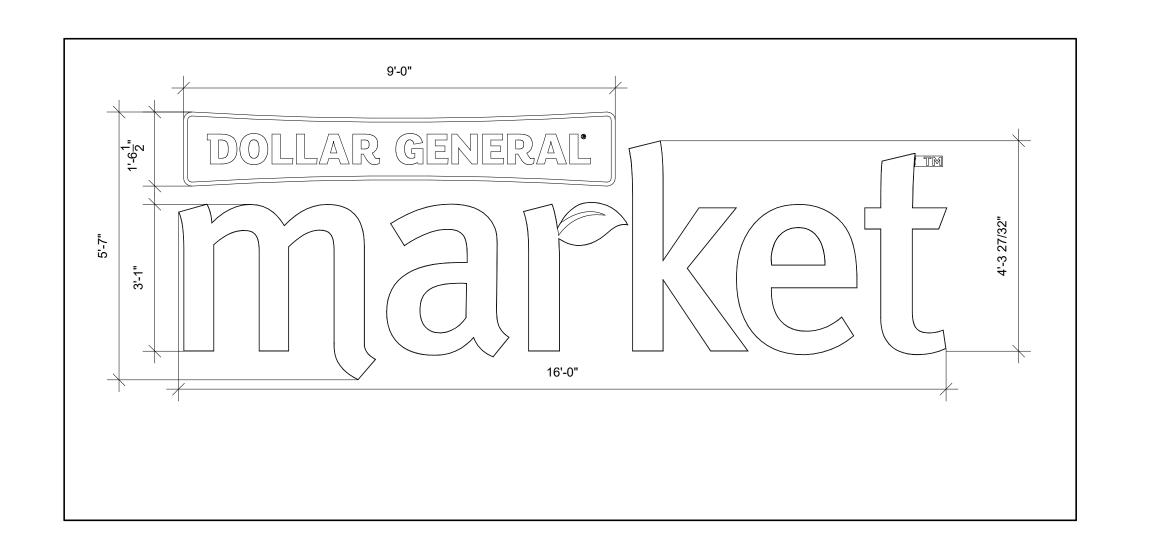

SIGN SPECIFICATIONS

1. BUILDING SIGNS: PROVIDE CONDUIT AND WIRE FROM ELECTRICAL PANEL TO THE SIGN CANOPY. THE CONDUIT IS TO BE 1" AND HAVE ONE SET OF 10/2 WIRE WITH GROUND. BUILDING CANOPY MUST BE SUFFICIENTLY BUILT TO SUPPORT THE DOLLAR GENERAL SIGN

2. PYLON SIGNS: PROVIDE CONDUIT FROM ELECTRICAL PANEL TO LOCATION OF THE HAVE ONE SET OF 10/2 WIRE WITH GROUND.

3. FINAL ELECTRICAL CONNECTIONS FOR SIGN SHALL BE THE SIGN VENDORS RESPONSIBILITY SINCE THE 'J' BOX AND WIRES ARE IN PLACE.


THIS SIGN IS FOR SPECIALTY


USE ONLY.


4. CONFIRM SIGN SPECIFICATIONS WITH DOLLAR GENERAL.

5. SEE SHEET A8 FOR SIGN CONNECTION DETAILS.

6. PYLON SIGN CABINETS TO CLEAR 15' FROM GRADE AND EDGE SHALL BE LOCATED NO CLOSER THAN 10' TO ANY OVERHEAD UTILITY LINES.

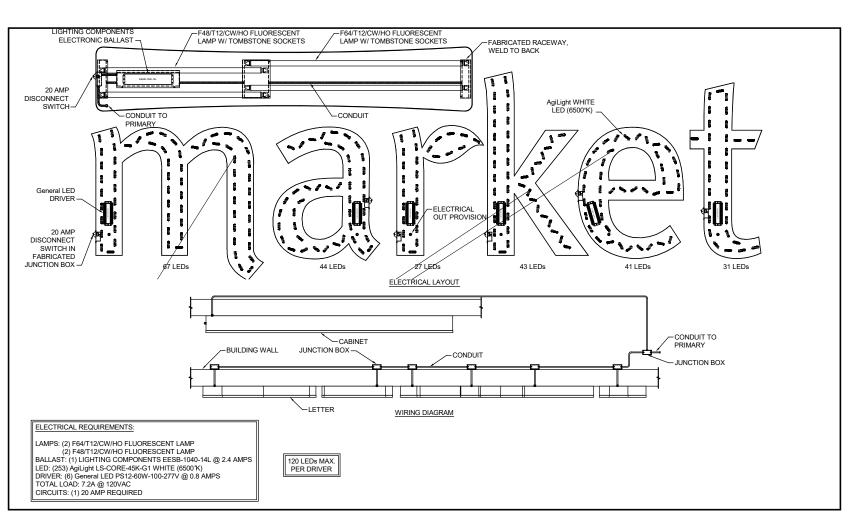


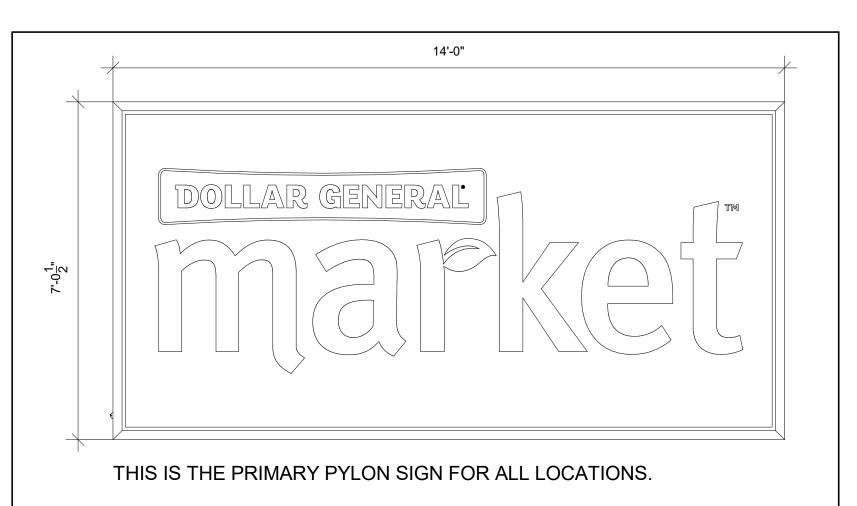

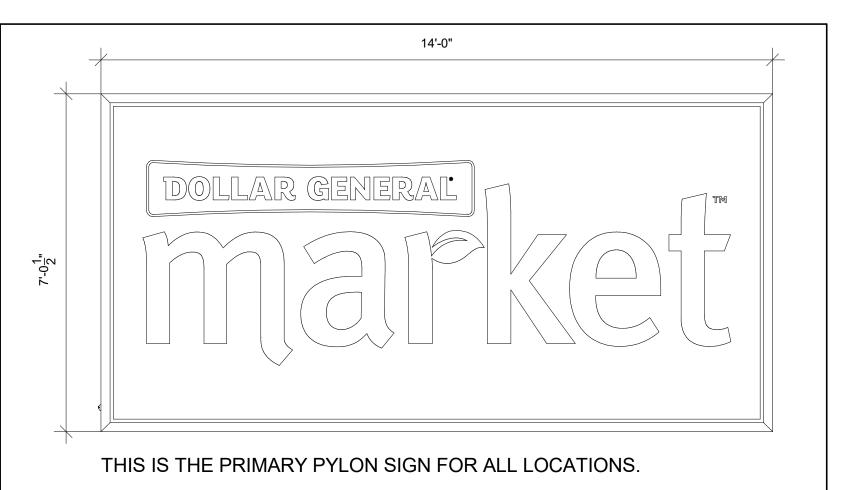


SIGN ELEVATIONS 1/2" = 1'-0"


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FORT WHITE FL 32038

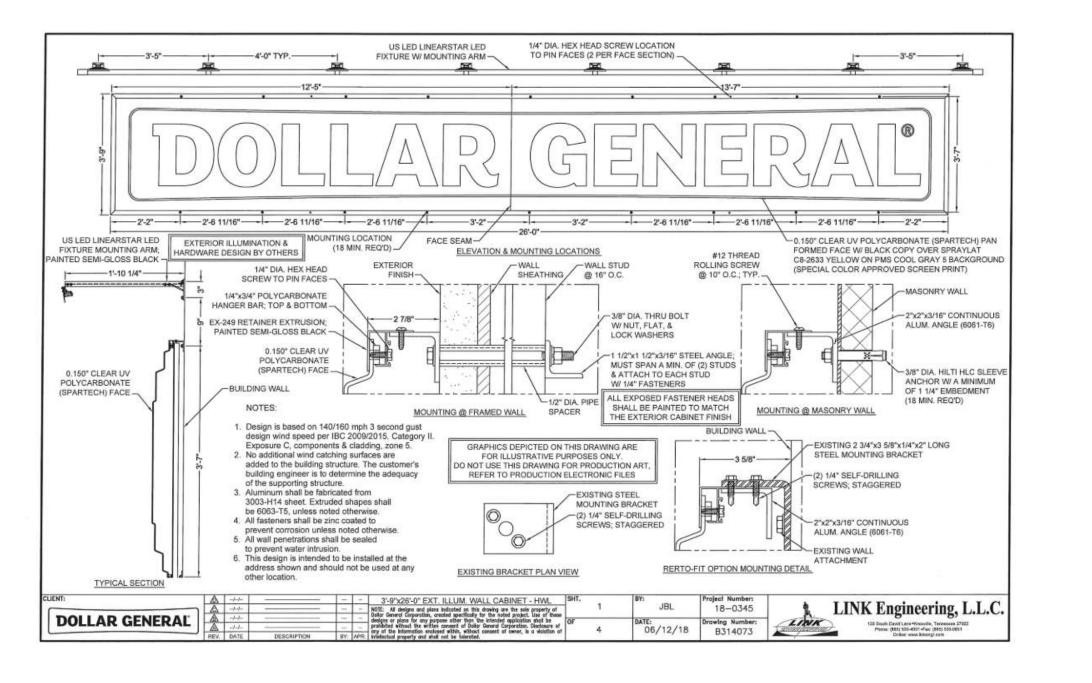 REVISIONS

 NO:
 DATE:
 REF:
 BY:

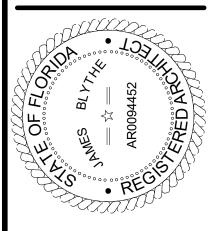 1
 Date 1
 Revision 1

DRAWING STATUS:
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| ISSUE DATE: | 04.05.2024 | | DRAWN BY: | CHECKED BY: |

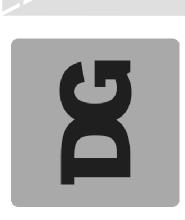PROJECT NUMBER:
4000.249

DRAWING TITLE:
SIGN DETAILS

SIGN DETAILS

SHEET NO.

SHEET NO.

A5.1

DATE/TIME STAMP: