



MONOLITHIC FOOTING S-2 SCALE: 1/2" = 1'-0"

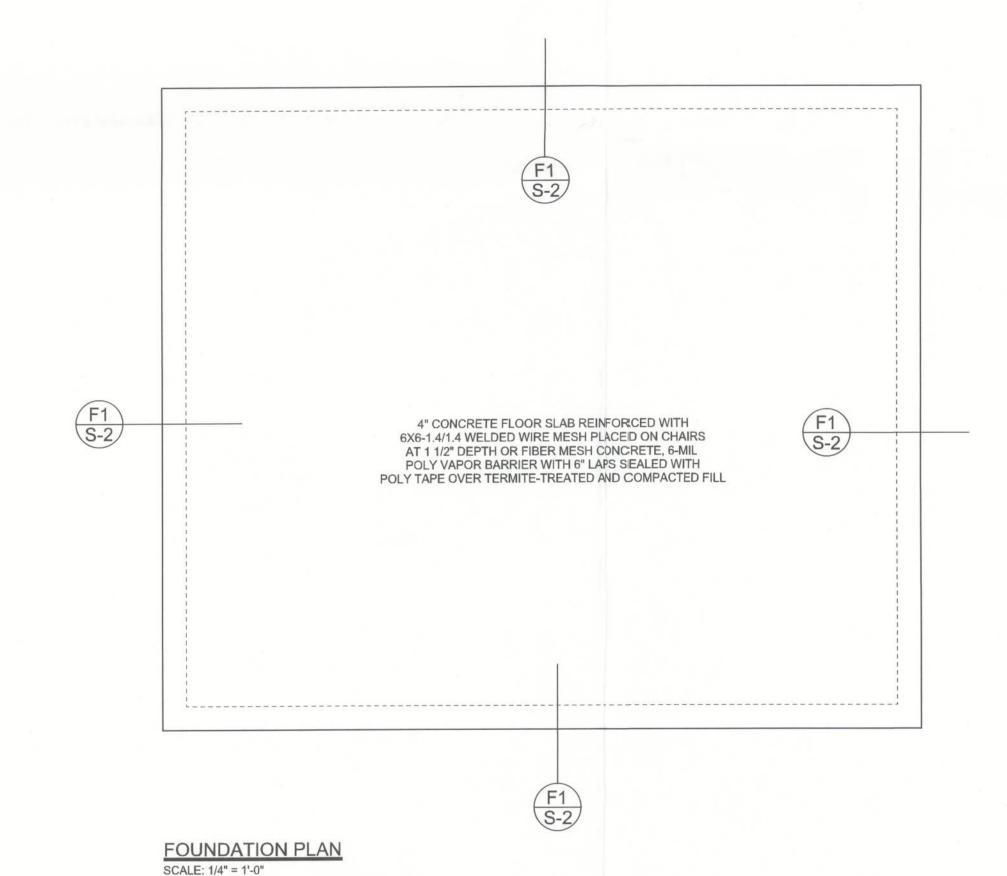

DIMENSIONS ON STRUCTURAL SHEETS ARE NOT EXACT. REFER TO ARCHITECTURAL

FLOOR PLAN FOR ACTUAL DIMENSIONS

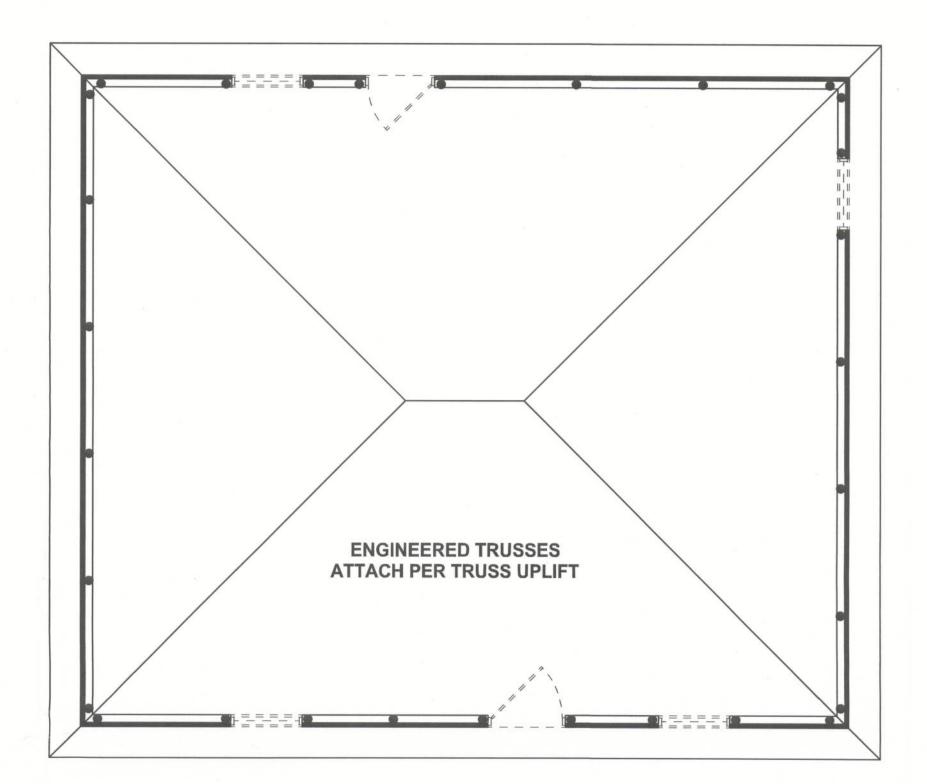

STRUCTURAL PLAN SCALE: 1/4" = 1'-0"

STRUCTURAL PLAN NOTES

SN-1 ALL LOAD BEARING FRAME WALL & PORCH HEADERS SHALL BE A MINIMUM OF (2) 2X12 SYP#2 (U.N.O.)


SN-2 ALL LOAD BEARING FRAME WALL HEADERS SHALL HAVE (1) JACK STUD & (1) KING STUD EACH SIDE (U.N.O.)

DIMENSIONS ON STRUCTURAL SHEETS SN-3 ARE NOT EXACT. REFER TO ARCHITECTURAL FLOOR PLAN FOR ACTUAL DIMENSIONS

PERMANENT TRUSS BRACING IS TO BE INSTALLED AT LOCATIONS AS SHOWN ON THE SEALED TRUSS DRAWINGS. SN-4

LATERAL BRACING IS TO BE RESTRAINED PER BCSI1-03,
BCSI-B1, BCSI-B2, & BCSI-B3. BCSI-B1, BCSI-B2, & BCSI-B3
ARE FURNISHED BY THE TRUSS SUPPLIER, WITH THE SEALED TRUSS PACKAGE

THREADED ROD LEGEND

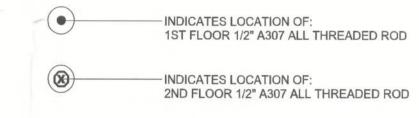

HEADER LEGEND

(2) 2X12X0',1J 1K	HEADER/BEAM CALL-OUT (U.N.O.)
	-NUMBER OF KING STUDS (FULL LENGTH)
	-NUMBER OF JACK STUDS (UNDER HEADER
	—SPAN OF HEADER
L	SIZE OF HEADER MATERIAL
	-NUMBER OF PLIES IN HEADER

TOTAL SHEAR WALL SEGMENTS

INDICATES SHEAR WALL SEGMENTS

	REQUIRED	ACTUAL
TRANSVERSE	24.8'	40.8'
LONGITUDINAL	12.8'	61.5'

WALL LEGEND

] = = = = = 1	EXTERIOR WALL
	INTERIOR NON-LOAD BEARING WALL
	INTERIOR LOAD BEARING WALL w/ NO UPLIFT
	INTERIOR LOAD BEARING WALL w/ UPLIFT

REVISIONS

SOFTPIAN ARCHITECTURAL DISSION ACCURATE

WINDLOAD ENGINEER: Mark Disosway, PE No.53915, POB 868, Lake City, FL 32056,

Stated dimensions supercede scaled dimensions. Refer all questions to Mark Disosway, P.E. for resolution. Do not proceed without clarification.

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CERTIFICATION: I hereby certify that I have examined this plan, and that the applicable portions of the plan, relating to wind engineering comply with section R301.2.1, florida building code residential 2007, to the best of my knowledge.



Hometown Homes

Murphy Residence

ADDRESS:

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Columbia County, FL

PRINTED DATE: January 31, 2012

DRAWN BY: STRUCTURAL BY: David Disosway David Disosway

FINALS DATE: 30Jan12

> JOB NUMBER: 1201073 DRAWING NUMBER

> > **S-2** OF 2 SHEETS