


F4 GARAGE DOOR FOOTING S-2 SCALE: 1/2" = 1'-0"

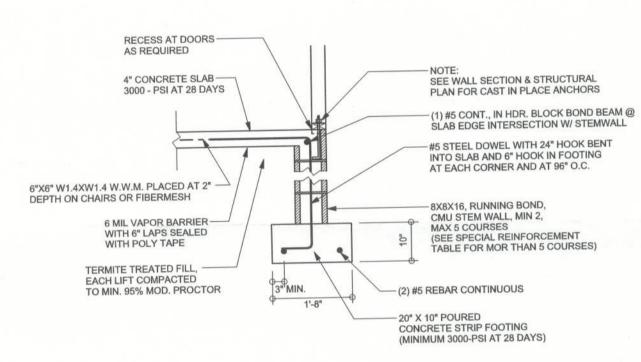


F9 STEM WALL FOOTING
S-2 SCALE: 1/2" = 1'-0"


TALL STEM WALL TABLE

The table assumes 60 ksi reinforcing bars with 6" hook in the footing and bent 24" into the reinforced slab at the top. The vertical steel is to be placed toward the tension side of the CMU wall (away from the soil pressure, within 2" of the exterior side of the wall). If the wall is over 8' high, add Durowall ladder reinforcement at 16"OC vertically or a horizontal bond beam with 1#5 continuous at mid height. For higher parts of the wall 12" CMU may be used with reinforcement as shown in the table below.


STEMWALL HEIGHT (FEET)	UNBALANCED BACKFILL HEIGHT	VERTICAL REINFORCEMENT FOR 8" CMU STEMWALL (INCHES O.C.)			VERTICAL REINFORCEMENT FOR 12" CMU STEMWALL (INCHES O.C.)		
		#5	#7	#8	#5	#7	#8
3.3	3.0	96	96	96	96	96	96
4.0	3.7	96	96	96	96	96	96
4.7	4.3	88	96	96	96	96	96
5.3	5.0	56	96	96	96	96	96
6.0	5.7	40	80	96	80	96	96
6.7	6.3	32	56	80	56	96	96
7.3	7.0	24	40	56	40	80	96
8.0	7.7	16	32	48	32	64	80
8.7	8.3	8	24	32	24	48	64
9.3	9.0	8	16	24	16	40	48

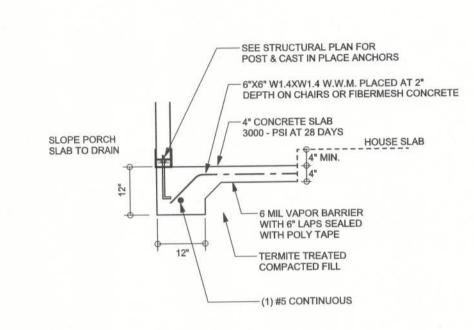

F5 PORCH FOOTING S-2 SCALE: 1/2" = 1'-0"

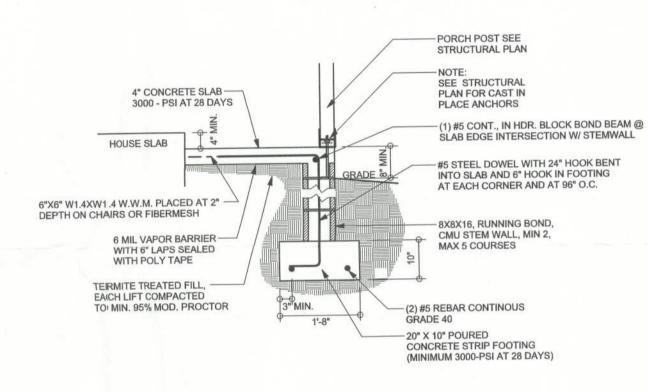

F12 ALT. STEM WALL PORCH FOOTING
S-2 SCALE: 1/2" = 1'-0"

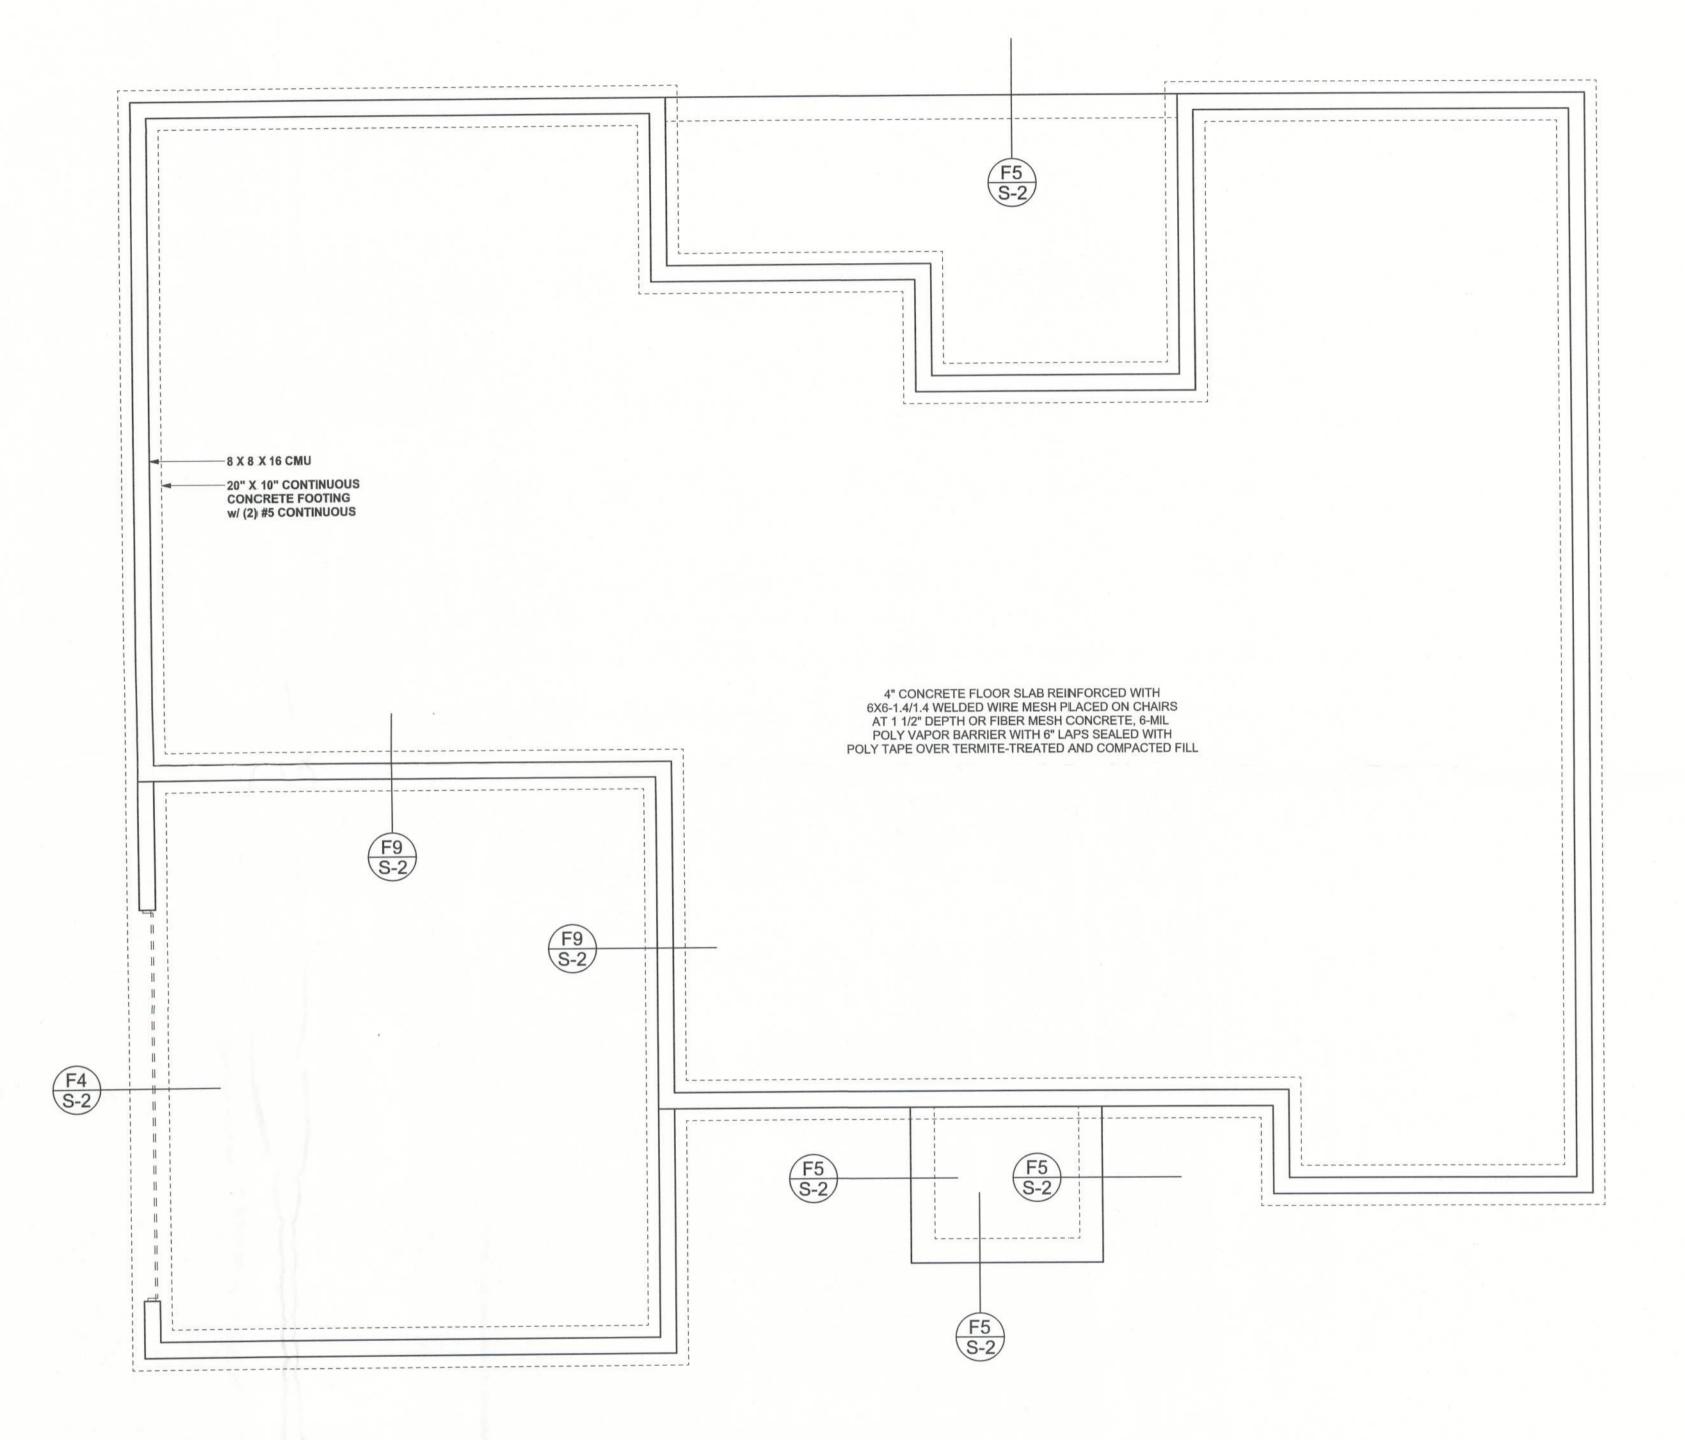

FOUNDATION PLAN

SCALE: 1/4" = 1'-0"

DIMENSIONS ON STRUCTURAL SHEETS
ARE NOT EXACT. REFER TO ARCHITECTURAL
FLOOR PLAN FOR ACTUAL DIMENSIONS

REFER TO ARCHITECTURAL PLANS
FOR ALL SLAB ELEVATIONS & NON BEARING STEPS

Sparks Construction

Mark Disosway, PE No.53915, POB 868, Lake City, FL 32056,

COPYRIGHTS AND PROPERTY RIGHTS: Mark Disosway, P.E. hereby expressly

reserves its common law copyrights and property right in these instruments of service. This document is not to be reproduced, altered

or copied in any form or manner without first the express written permission and consent of Mark Disosway.

CERTIFICATION: I hereby certify that I have

examined this plan, and that the applicable portions of the plan, relating to wind engineering comply with section R301.2.1, florida building code

LIMITATION: This design is valid for one building, at specified location.

P.E. 53915

residential 2007, to the best of my knowledge.

Stated dimensions supercede scaled dimensions. Refer all questions to Mark Disosway, P.E. for resolution. Do not proceed without clarification.

386-754-5419

Don Barth Residence

ADDRESS: 10-6S-16-03814-102 Columbia County, Florida

Mark Disosway P.E. P.O. Box 868 Lake City, Florida 32056 Phone: (386) 754 - 5419 Fax: (386) 269 - 4871

PRINTED DATE: January 28, 2010

DRAWN BY: STRUCTURAL BY:
David Disosway

FINALS DATE: 28Jan10

JOB NUMBER: 1001064

DRAWING NUMBER

S-2 OF 3 SHEETS