


September 18, 2001



ARCHITECTURAL
© DESIGN
P.O. Box 273
LAKE CITY FL. 32056
(386) 754-0181


CONSTRUCTION
DOCUMENTS BY:

A CUSTOM HOME BY DON REED CONSTRUCTION:
CHRISTENSEN
RESIDENCE
COPYRIGHT: 2001 DDS STUDIOS INC

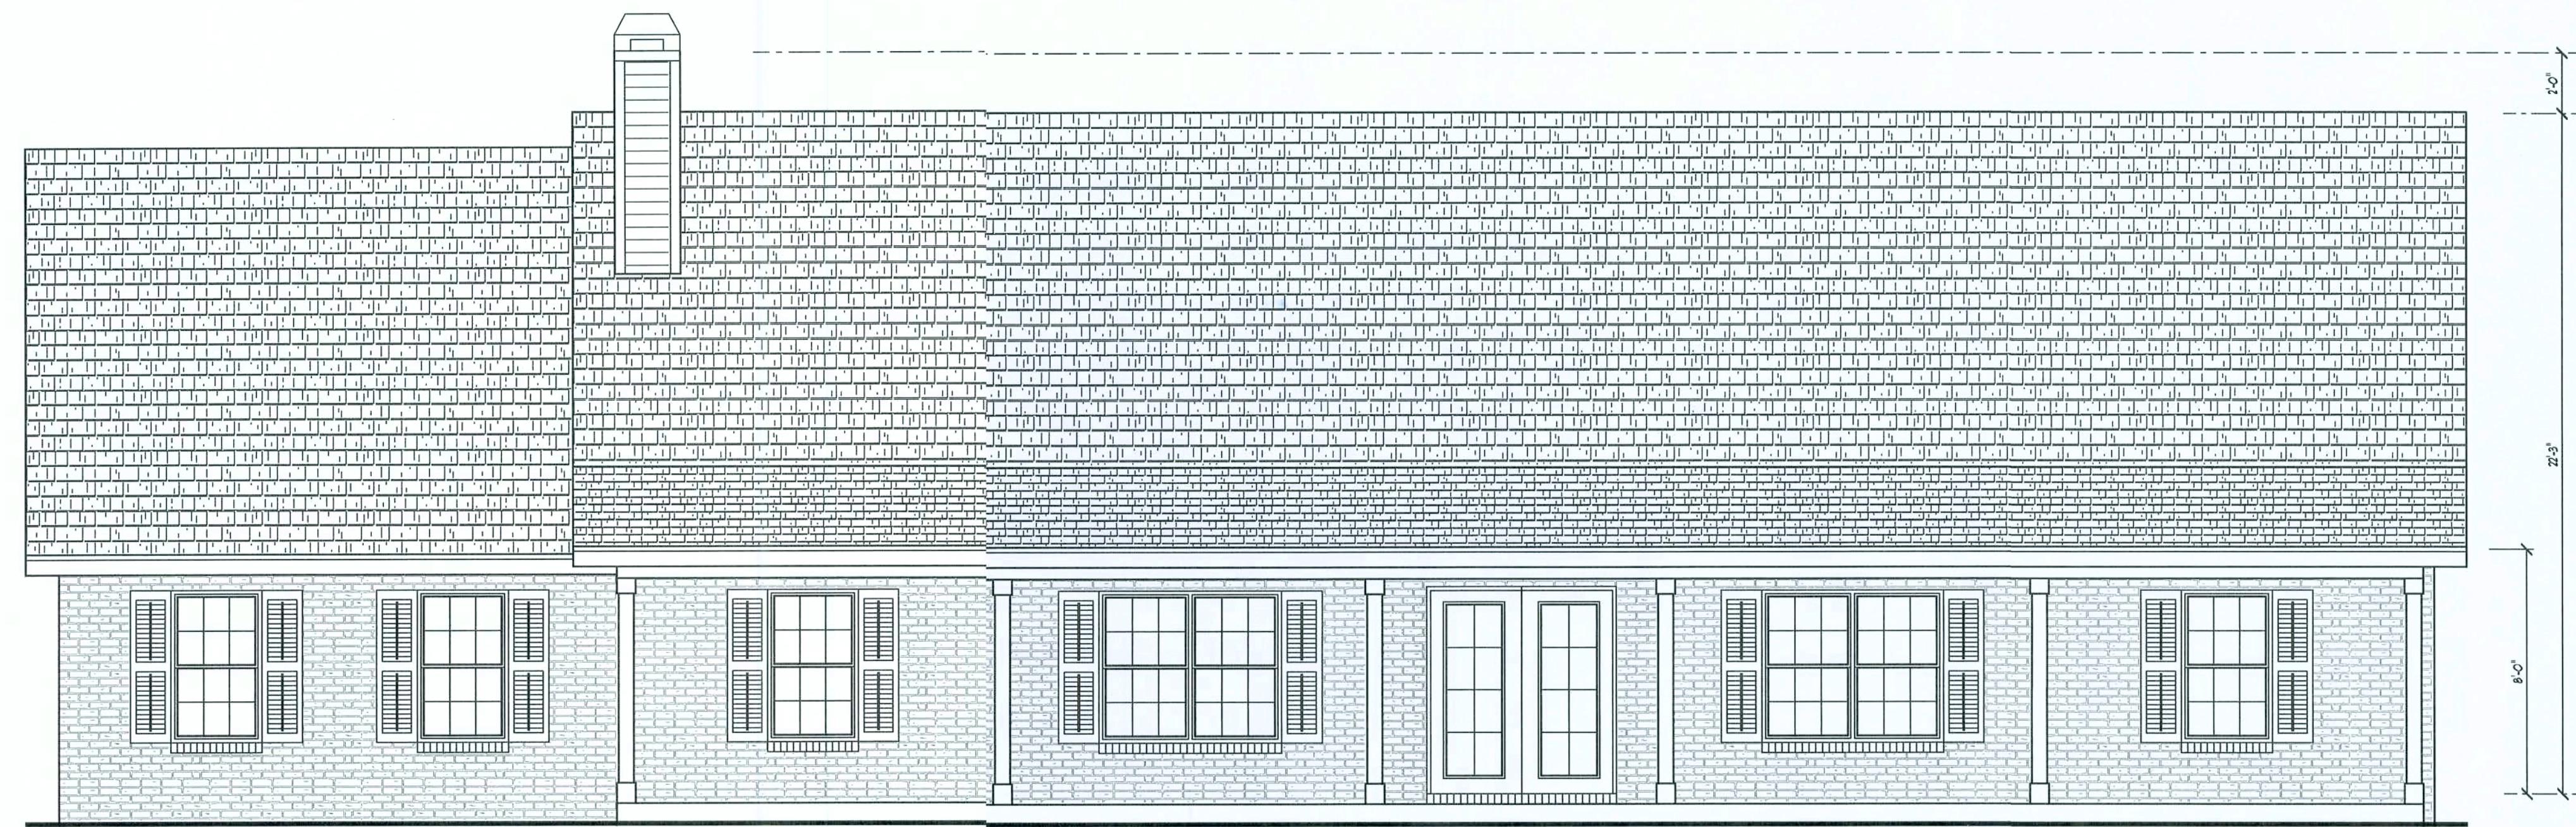

FRONT ELEVATION

SCALE: 1/4" = 1'

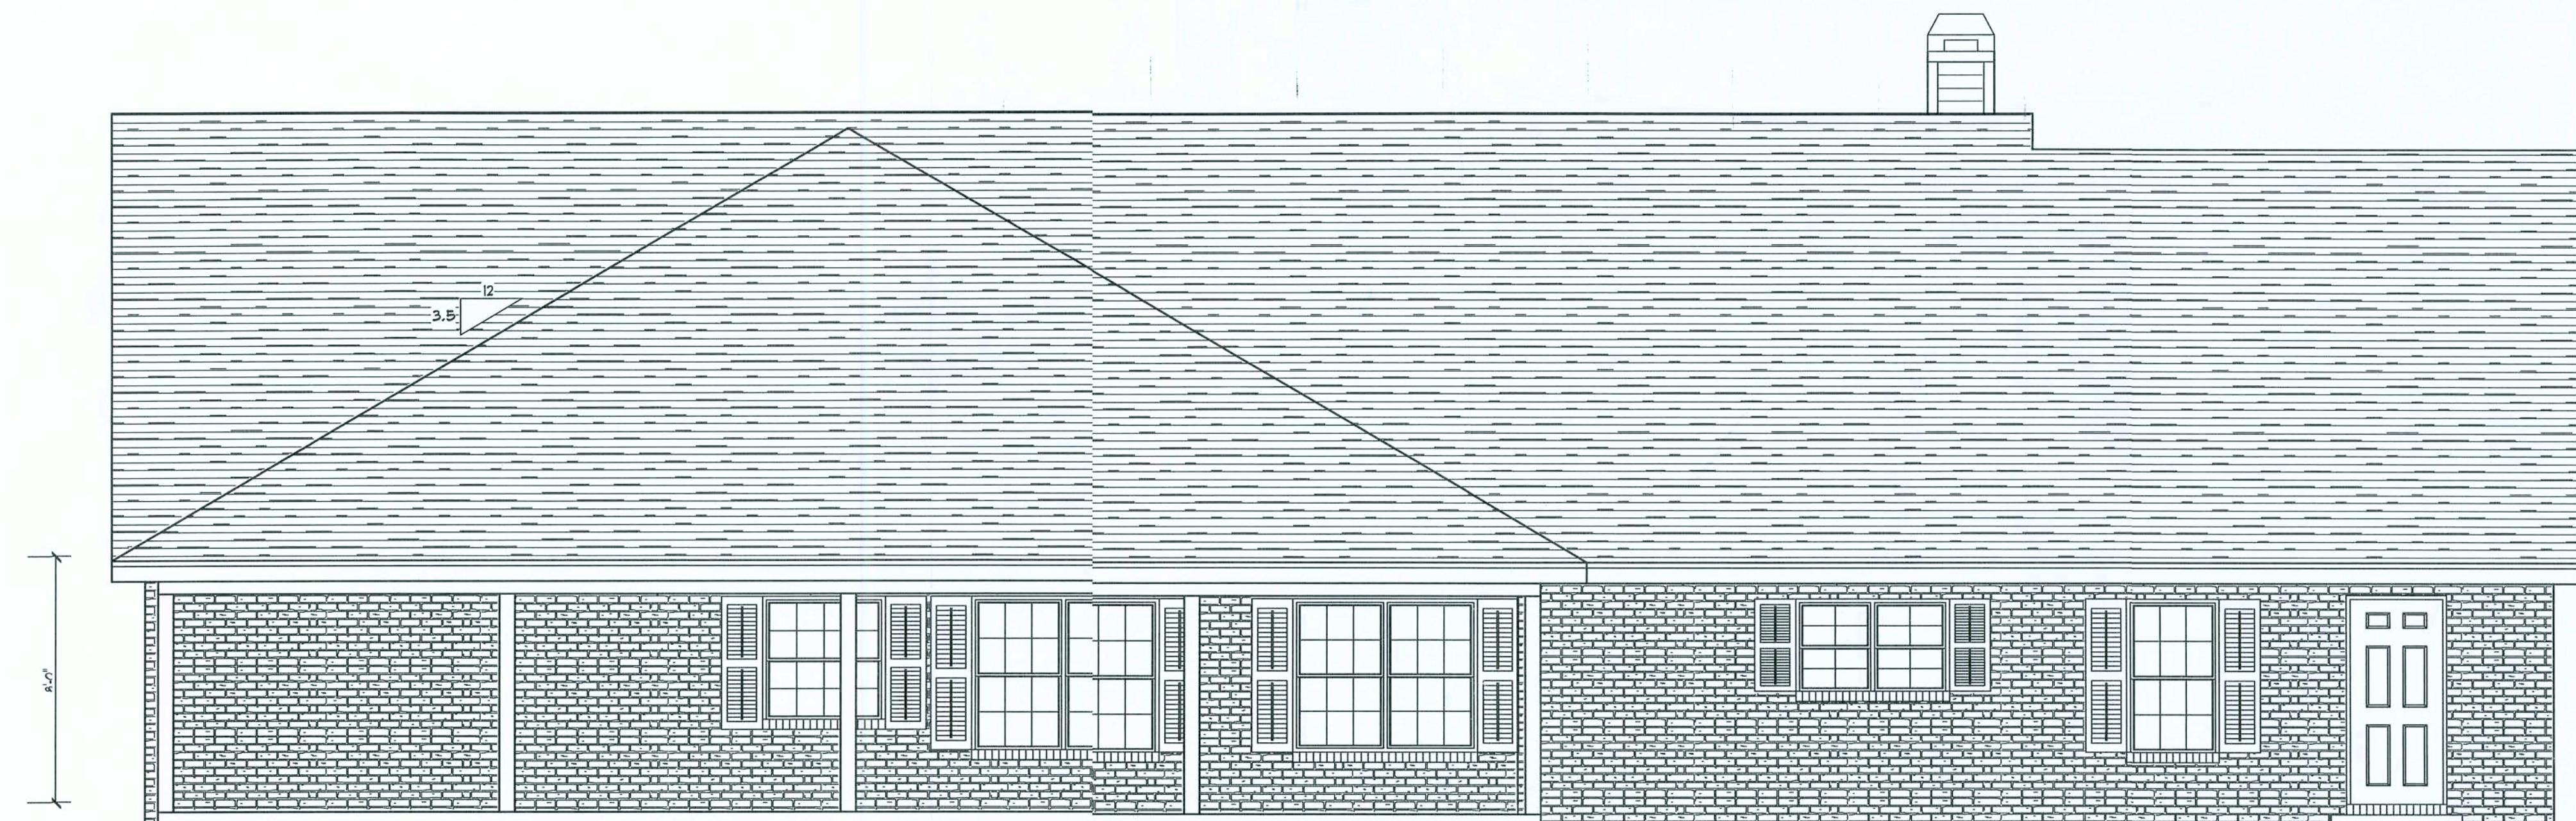

REAR ELEVATION

SCALE: 1/4" = 1'

EXTERIOR ELEVATIONS

SHEET NUMBER
1 of 4

All work shall comply with the standard building code, and all applicable local codes and ordinances.
Contractor shall verify all dimensions prior to commencing construction.

September 18, 2001

D.D.S.
Studios


ARCHITECTURAL
DESIGN
P.O. Box 273
LAKE CITY FL 32056
(386) 754-0181

CONSTRUCTION
DOCUMENTS BY:

A CUSTOM HOME BY DON REED CONSTRUCTION.
CHRISTENSEN
RESIDENCE

COPYRIGHT: 2001 DDS STUDIOS INC


Daniel Shaeen

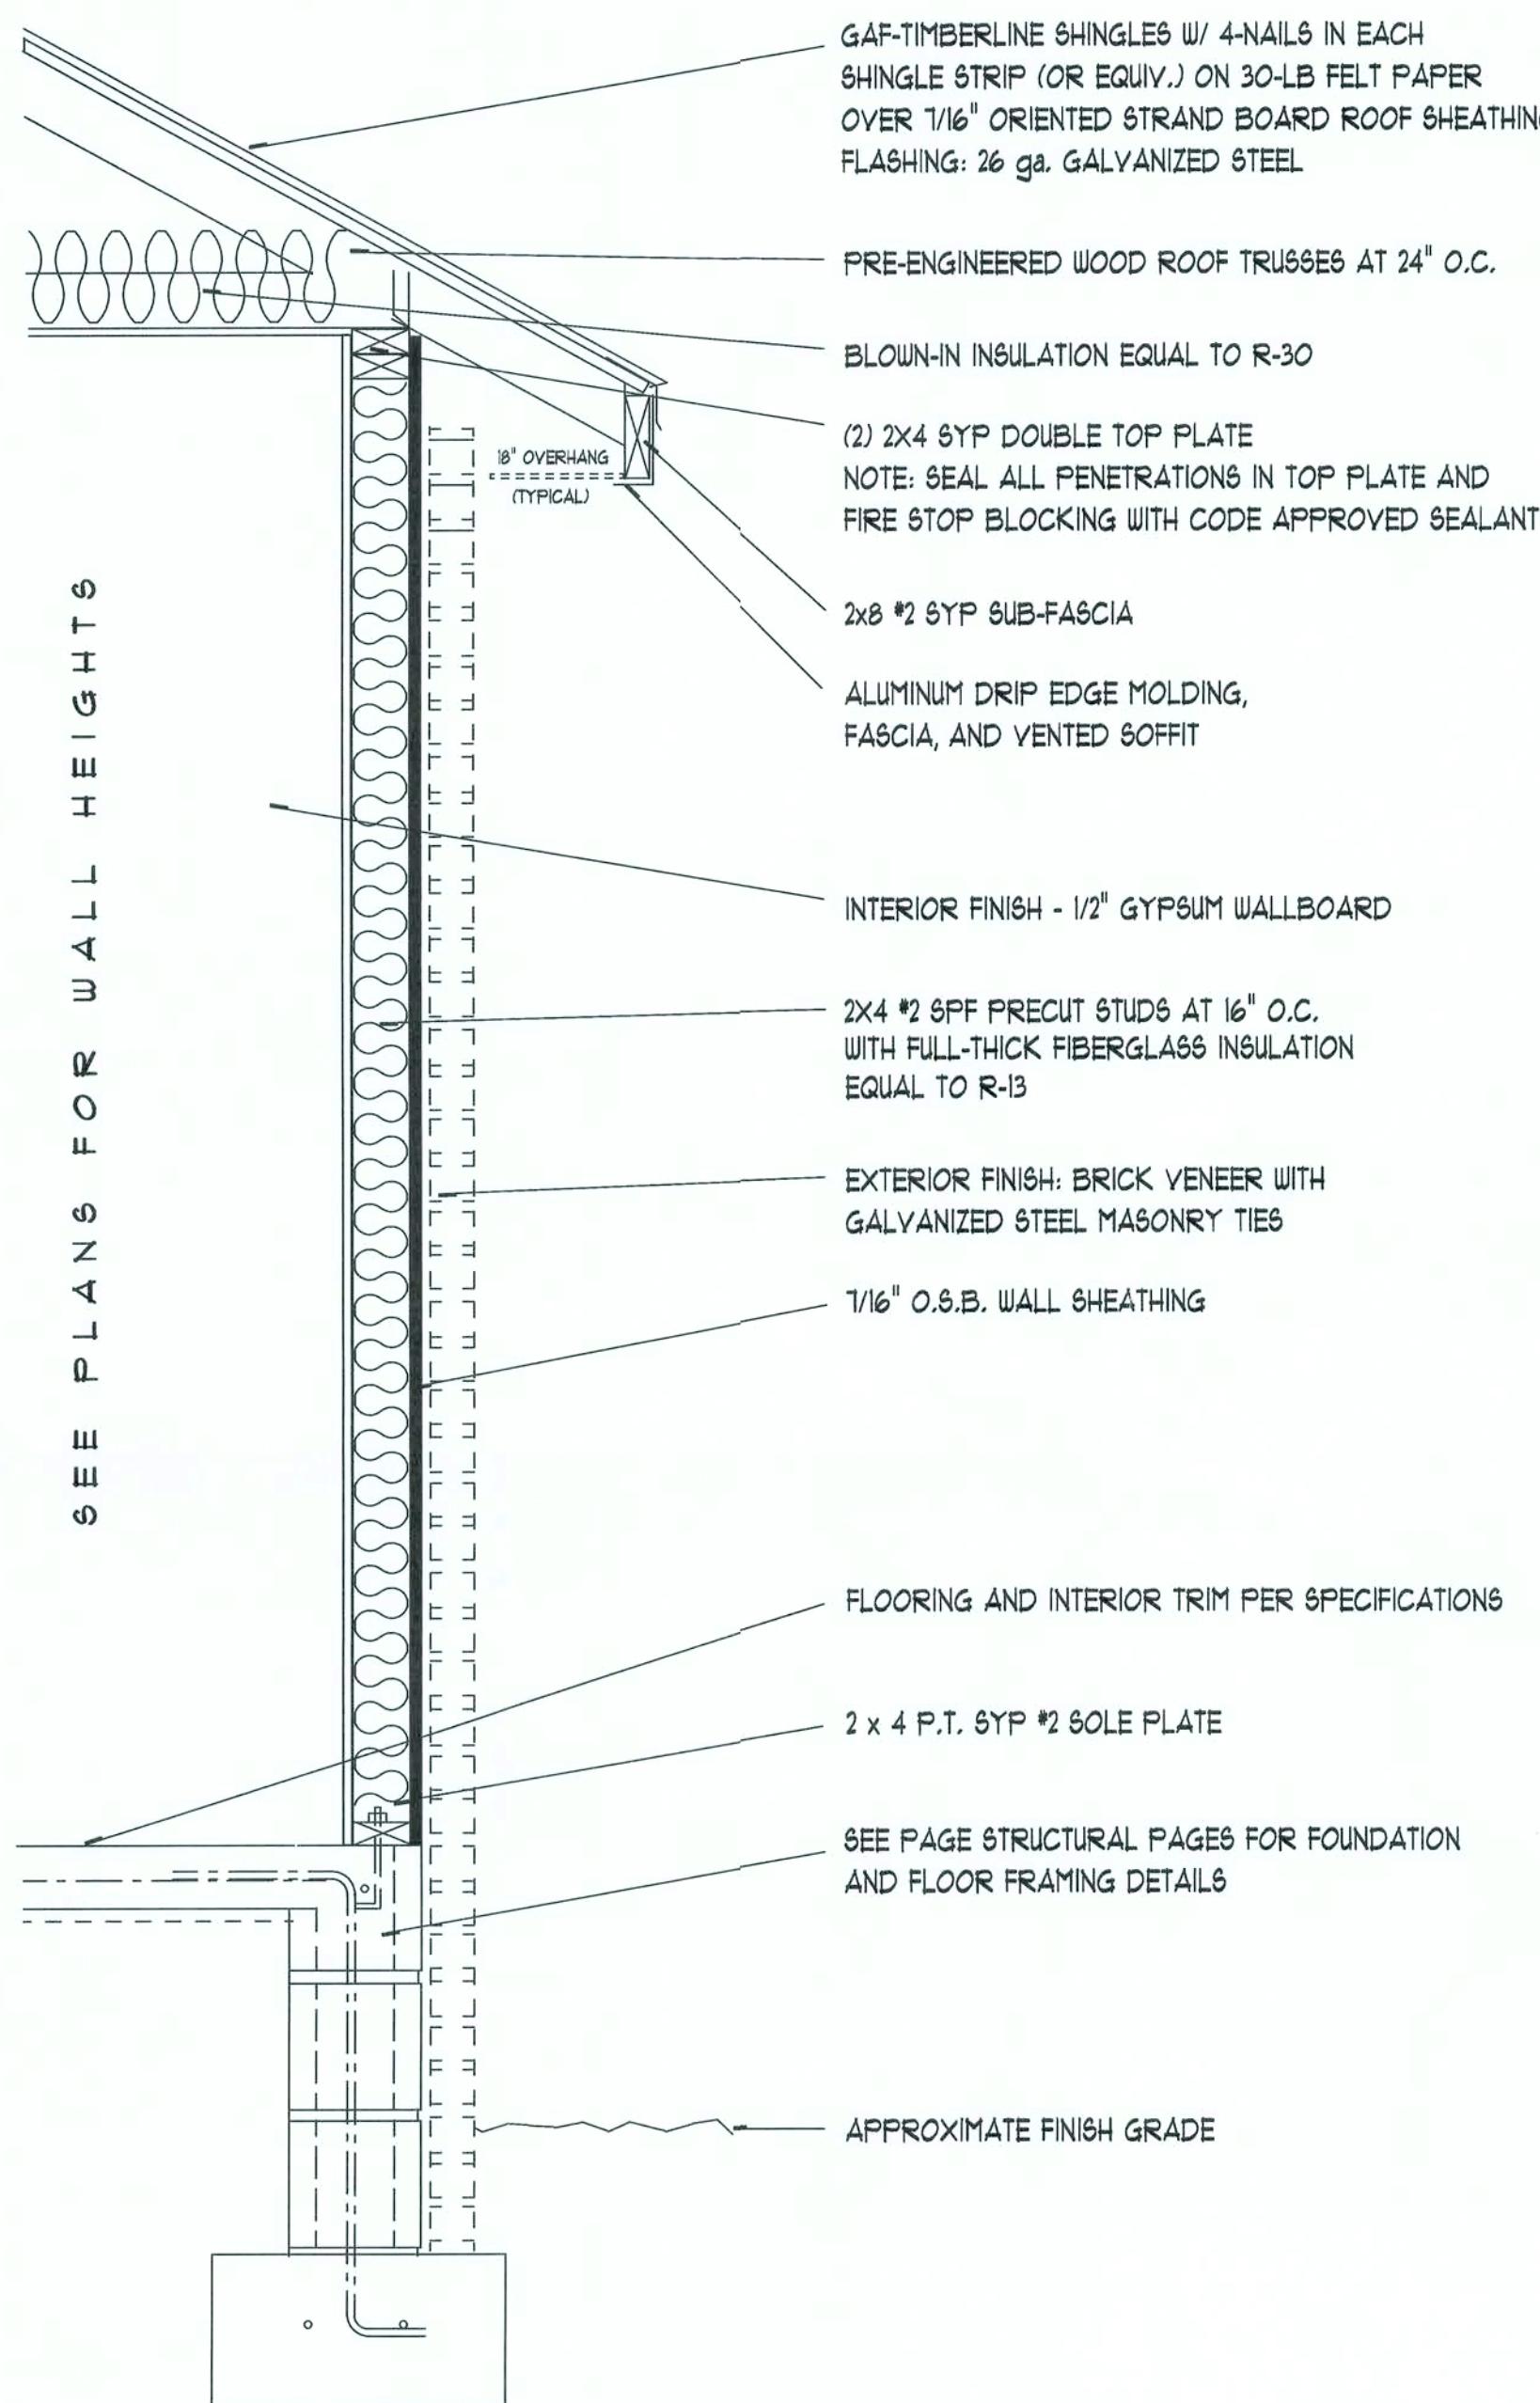

TYPICAL WALL SECTION


SCALE: 1" = 1'0"

REFER TO STRUCTURAL PAGE FOR
STRUCTURAL SPECIFICATIONS



LEFT ELEVATION

SCALE: 1/4" = 1'

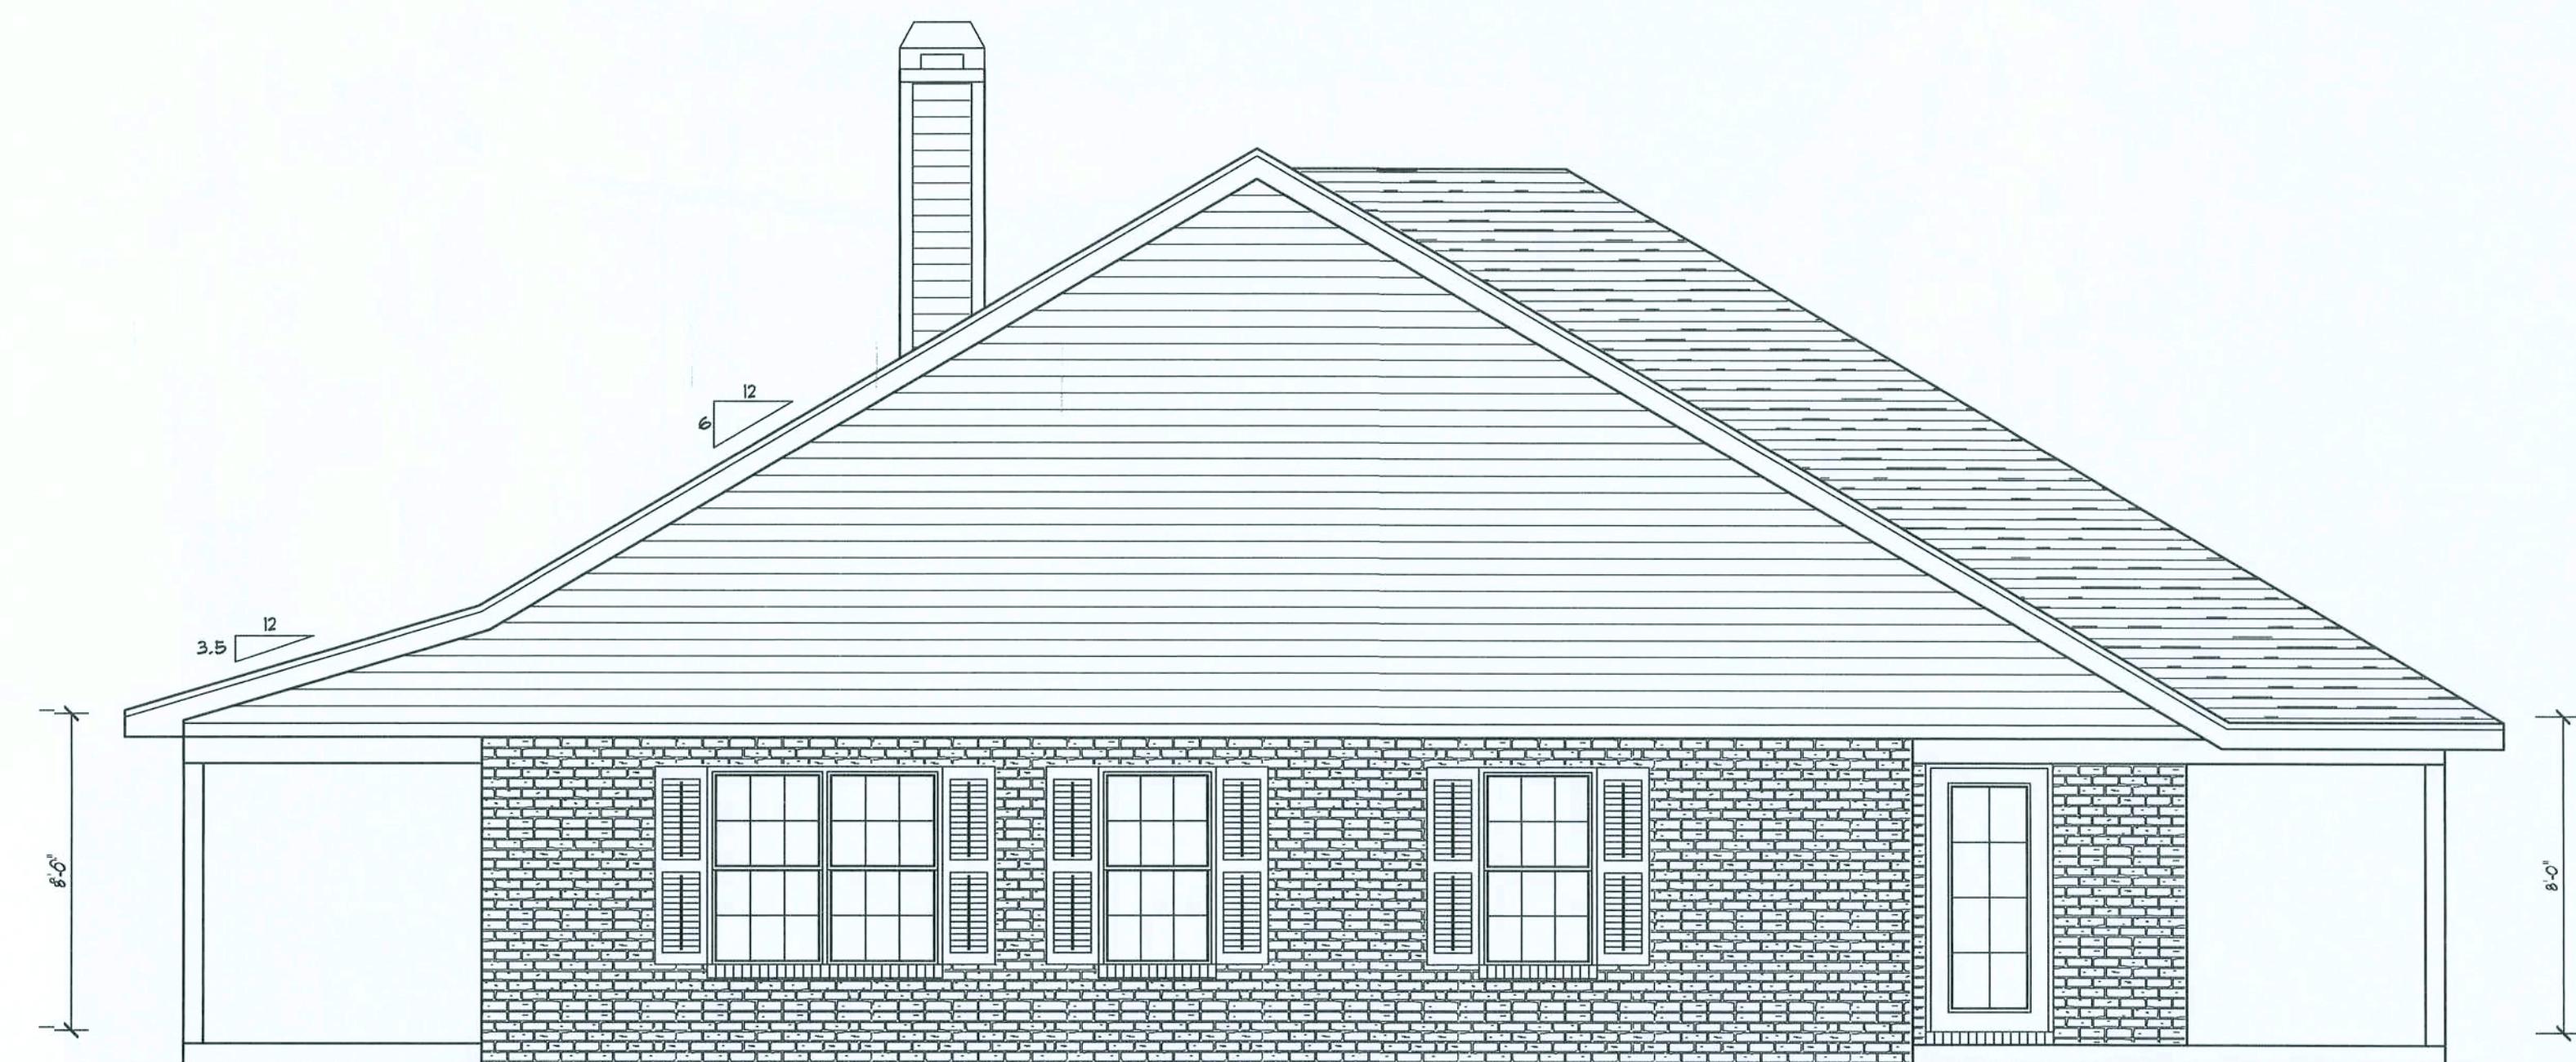

RIGHT ELEVATION

SCALE: 1/4" = 1'

EXTERIOR ELEVATIONS

TYPICAL WALL SECTION

SHEET NUMBER
2 of 4

All work shall comply with
the standard building code,
and all applicable local
codes and ordinances.

Contractor shall verify all
dimensions prior to
commencing construction.

September 18, 2001




© DESIGN
P.O. Box 273
LAKE CITY FL 32056
(386) 754-0181

CONSTRUCTION DOCUMENTS BY:

CHRISTENSEN RESIDENCE
COPYRIGHT: 2001 DDS STUDIOS INC

Daniel Shaheen

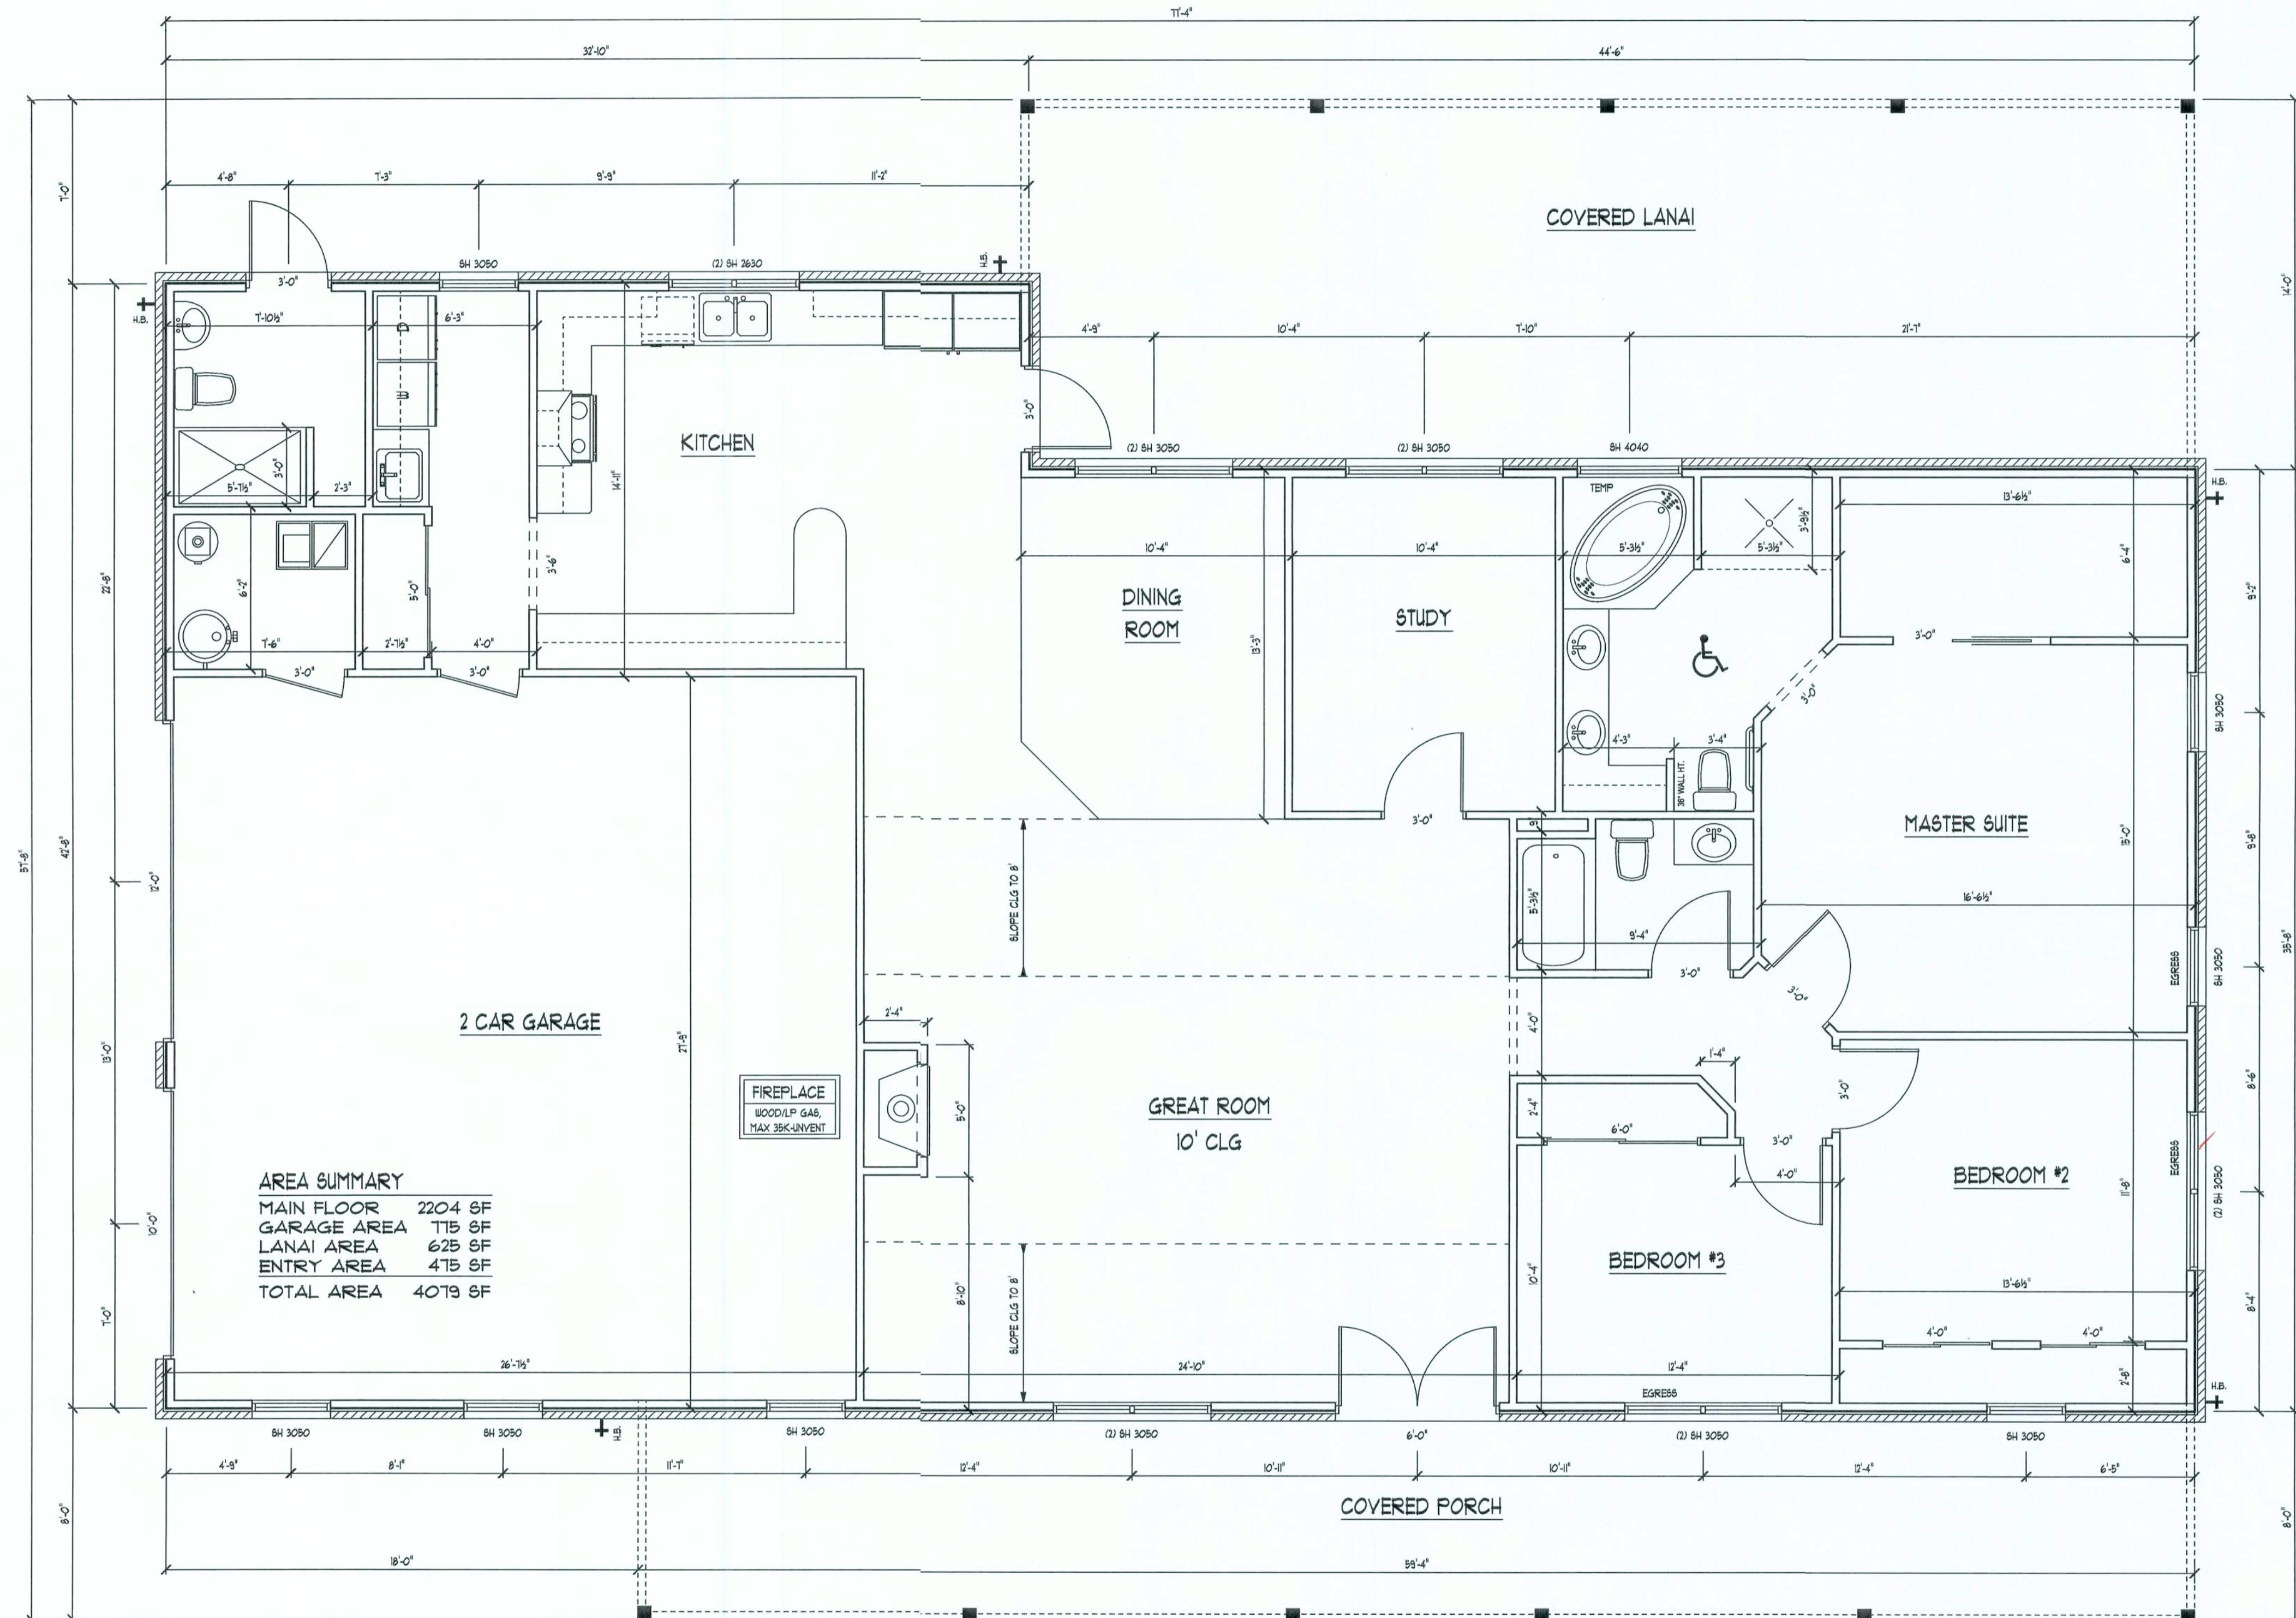

FLOOR PLAN



SCALE: 1/4" = 1'

FLOOR PLAN

SHEET NUMBER
2 of 4

All work shall comply with the standard building code, and all applicable local codes and ordinances.
Contractor shall verify all dimensions prior to commencing construction.

September 18, 2007

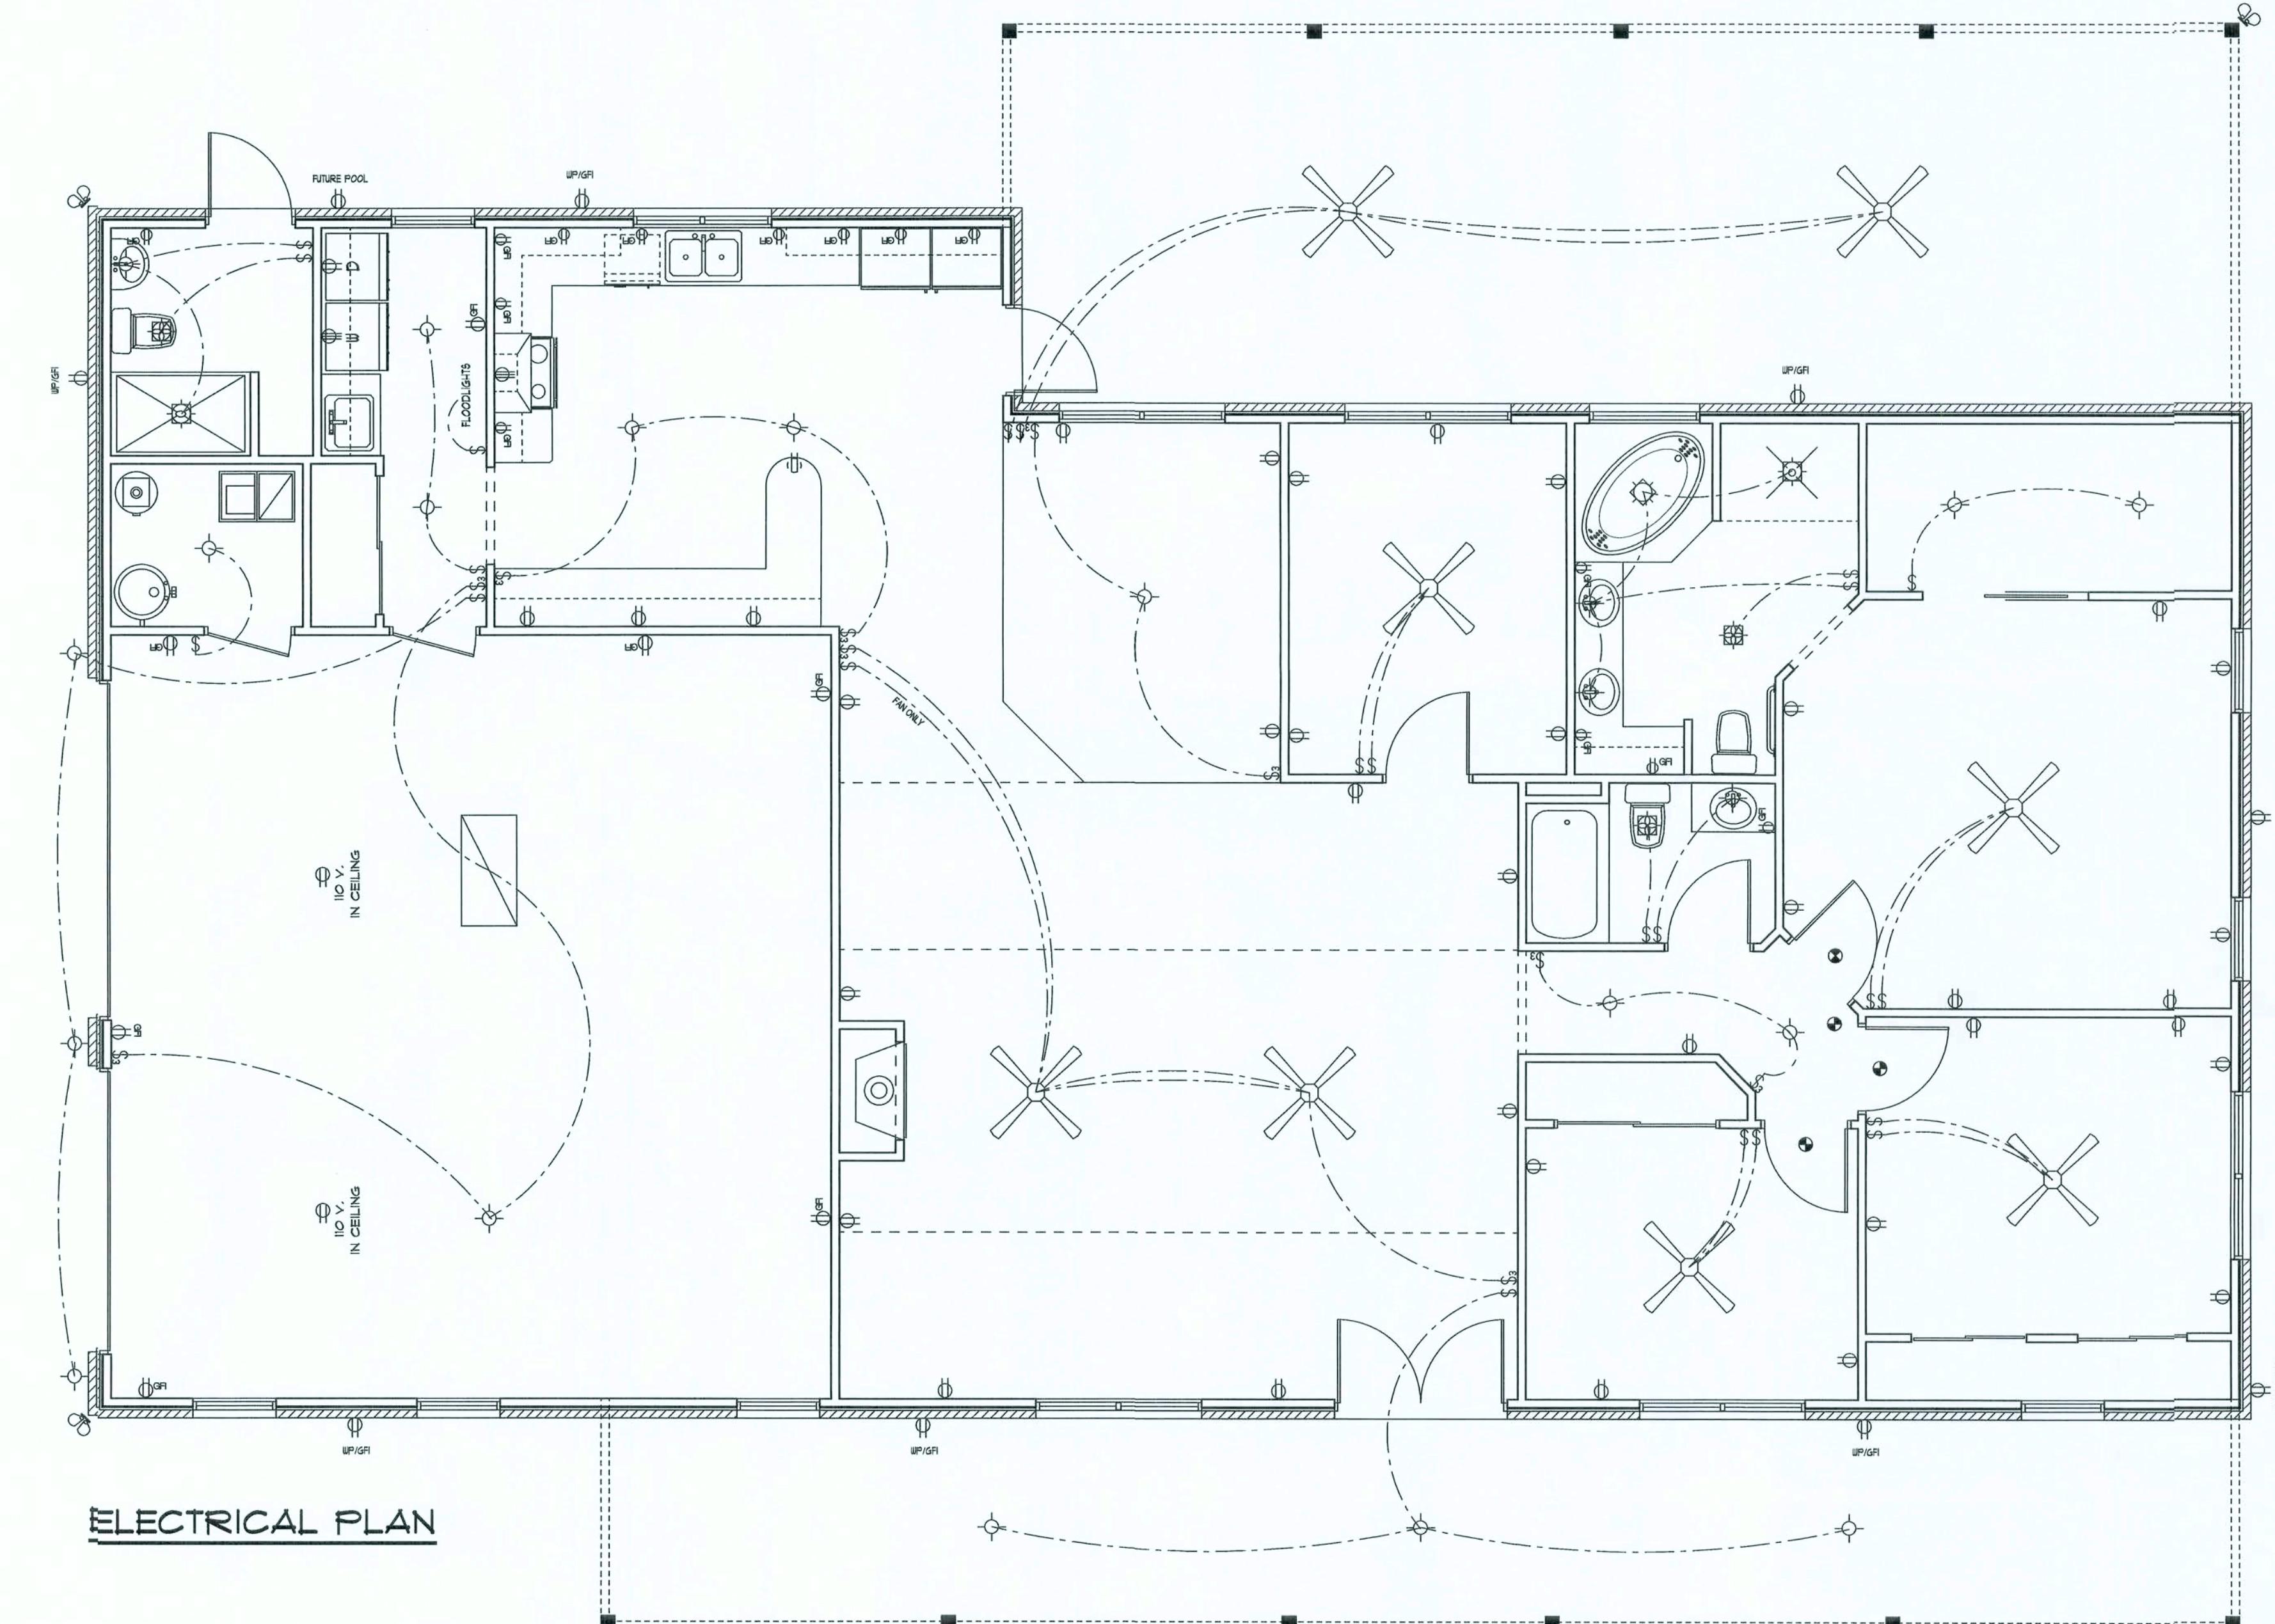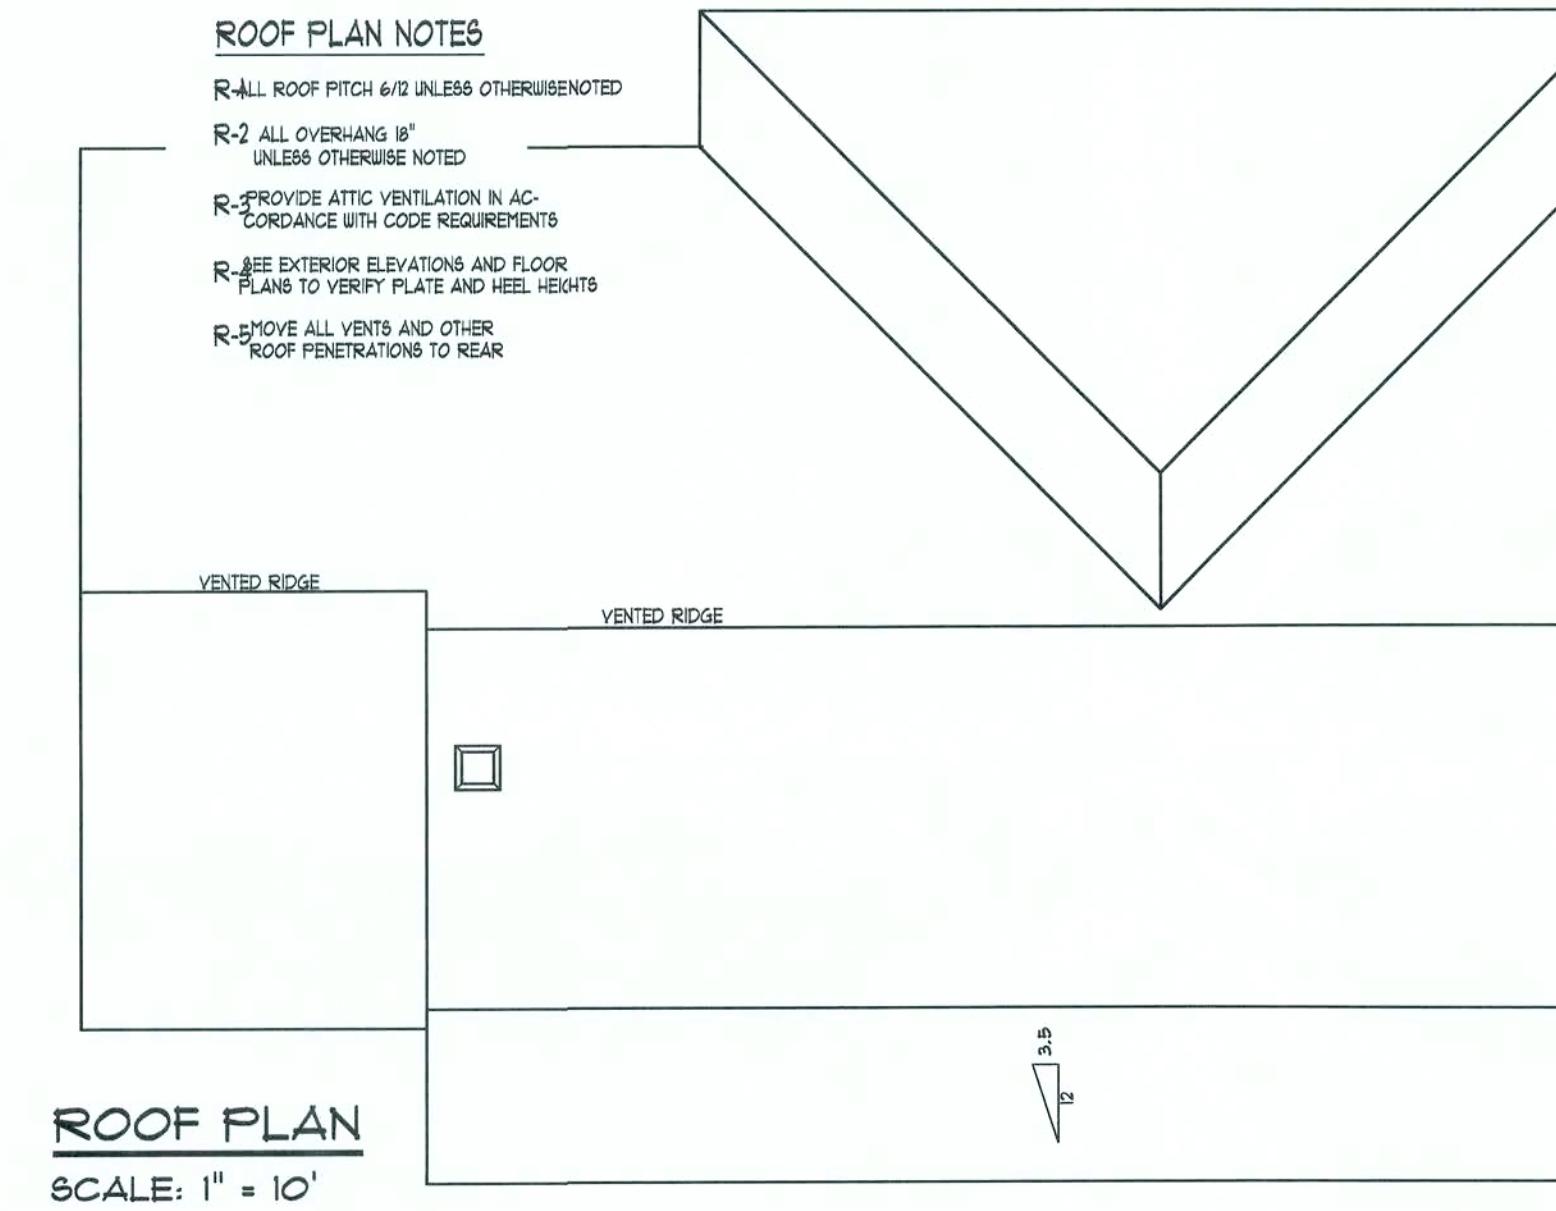D.D.S.
StudiosARCHITECTURAL
DESIGN
P.O. Box 273
LAKE CITY FL. 32056
(386) 754-0181CONSTRUCTION
DOCUMENTS BY:CHRISTENSEN
RESIDENCE
A CUSTOM HOME BY DON REED CONSTRUCTION
COPYRIGHT: 2007 DDS STUDIOS INC*Daniel Shafeen*
Daniel Shafeen

ALL DRAWINGS NOT TO BE SCALED, WRITTEN DIMENSIONS TAKE PRECEDENCE OVER SCALED DIMENSIONS

ELECTRICAL PLAN NOTES

E-1 ALL WORK SHALL COMPLY WITH THE NATIONAL ELECTRICAL CODE, LATEST EDITION, AND ALL OTHER APPLICABLE LOCAL CODES AND ORDINANCES.

E-2 NOTE: ALL SMOKE DETECTORS TO BE WIRED TOGETHER TO ACTIVATE ALL ALARMS IF ANY ONE UNIT IS ACTUATED.

E-3 PROVIDE WIRING AS REQUIRED FOR APPLIANCES, AIR CONDITIONING, HEATING AND WATER HEATING EQUIPMENT.

E-4 ALL BEDROOM RECEPTACLES SHALL BE ARC. (ARC FAULT CIRCUIT INTERRUPT)

NOTE:
THIS ELECTRICAL PLAN IS A SCHEMATIC
AND NOT DRAWN TO SCALE. ROOM LOCATIONS,
AND LIGHT FIXTURE LOCATIONS, DUE TO
VARYING LOCAL AND STATE CODES,
REGULATIONS, AND STATUTES, IT IS THE
RESPONSIBILITY OF THE OWNER AND/OR
CONTRACTOR TO COMPLY WITH ALL LOCAL
AND STATE CODES, REGULATIONS AND
STATUTES.


ELECTRICAL SERVICE PROVIDED BY

[Redacted]


ELECTRICAL PLAN
ROOF PLAN
TYPICAL WALL SECTION

SHEET NUMBER
3 of 4

All work shall comply with the standard building code, and all applicable local codes and ordinances.
Contractor shall verify all dimensions prior to commencing construction.

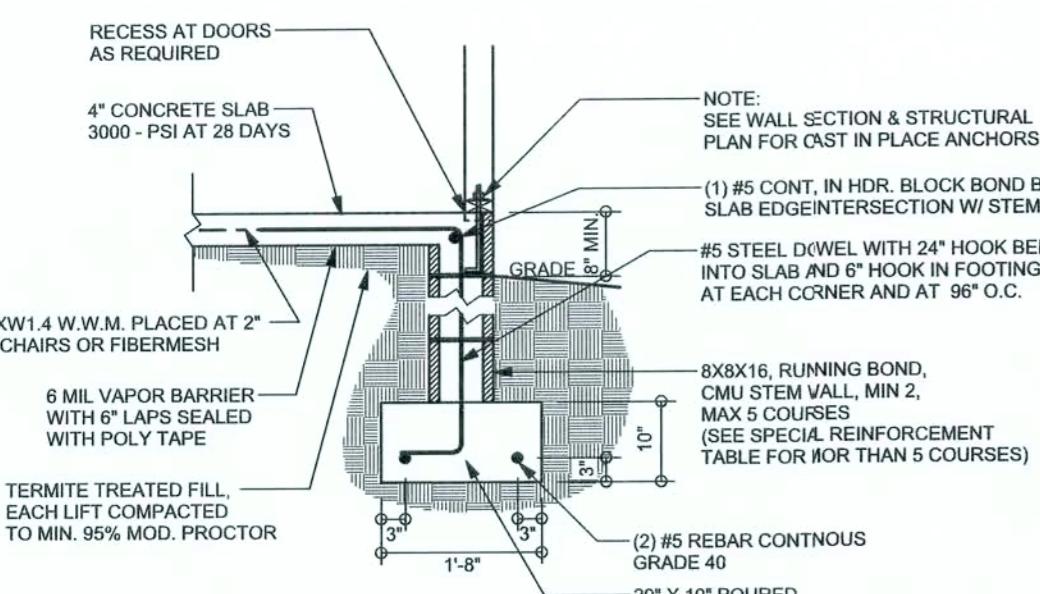


STEM WALL FOOTING
SCALE: 1/2" = 1'-0"

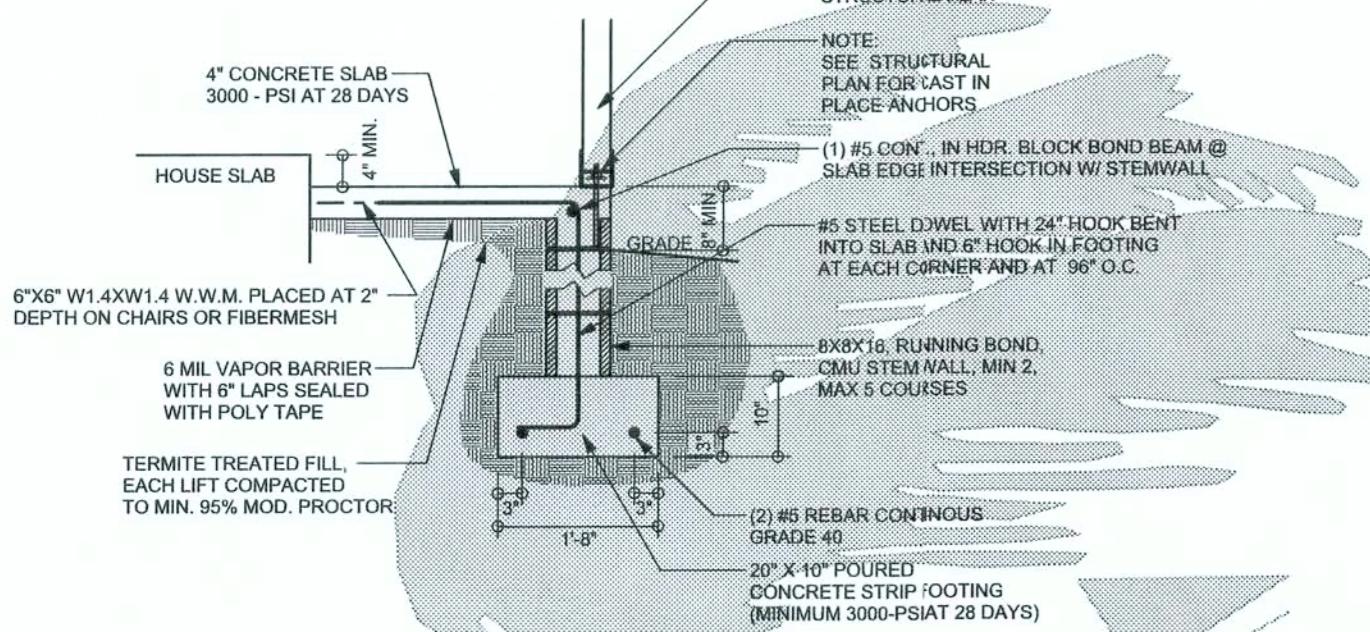

ALT. STEM WALL PORCH FOOTING
SCALE: 1/2" = 1'-0"


TALL STEM WALL TABLE

| STEMWALL UNBALANCED HEIGHT (FEET) | VERTICAL REINFORCEMENT FOR 8" CMU STEMWALL (INCHES O.C.) | | | VERTICAL REINFORCEMENT FOR 12" CMU STEMWALL (INCHES O.C.) | | |
|-----------------------------------|--|----|----|---|----|----|
| | #5 | #7 | #8 | #5 | #7 | #8 |
| 3.3 | 3.0 | 96 | 96 | 96 | 96 | 96 |
| 4.0 | 3.7 | 96 | 96 | 96 | 96 | 96 |
| 4.7 | 4.3 | 88 | 96 | 96 | 96 | 96 |
| 5.3 | 5.0 | 56 | 96 | 96 | 96 | 96 |
| 6.0 | 5.7 | 40 | 80 | 96 | 80 | 96 |
| 6.7 | 6.3 | 32 | 56 | 80 | 56 | 96 |
| 7.3 | 7.0 | 24 | 40 | 56 | 40 | 80 |
| 8.0 | 7.7 | 16 | 32 | 48 | 32 | 64 |
| 8.7 | 8.3 | 8 | 24 | 32 | 24 | 48 |
| 9.3 | 9.0 | 6 | 16 | 24 | 16 | 40 |

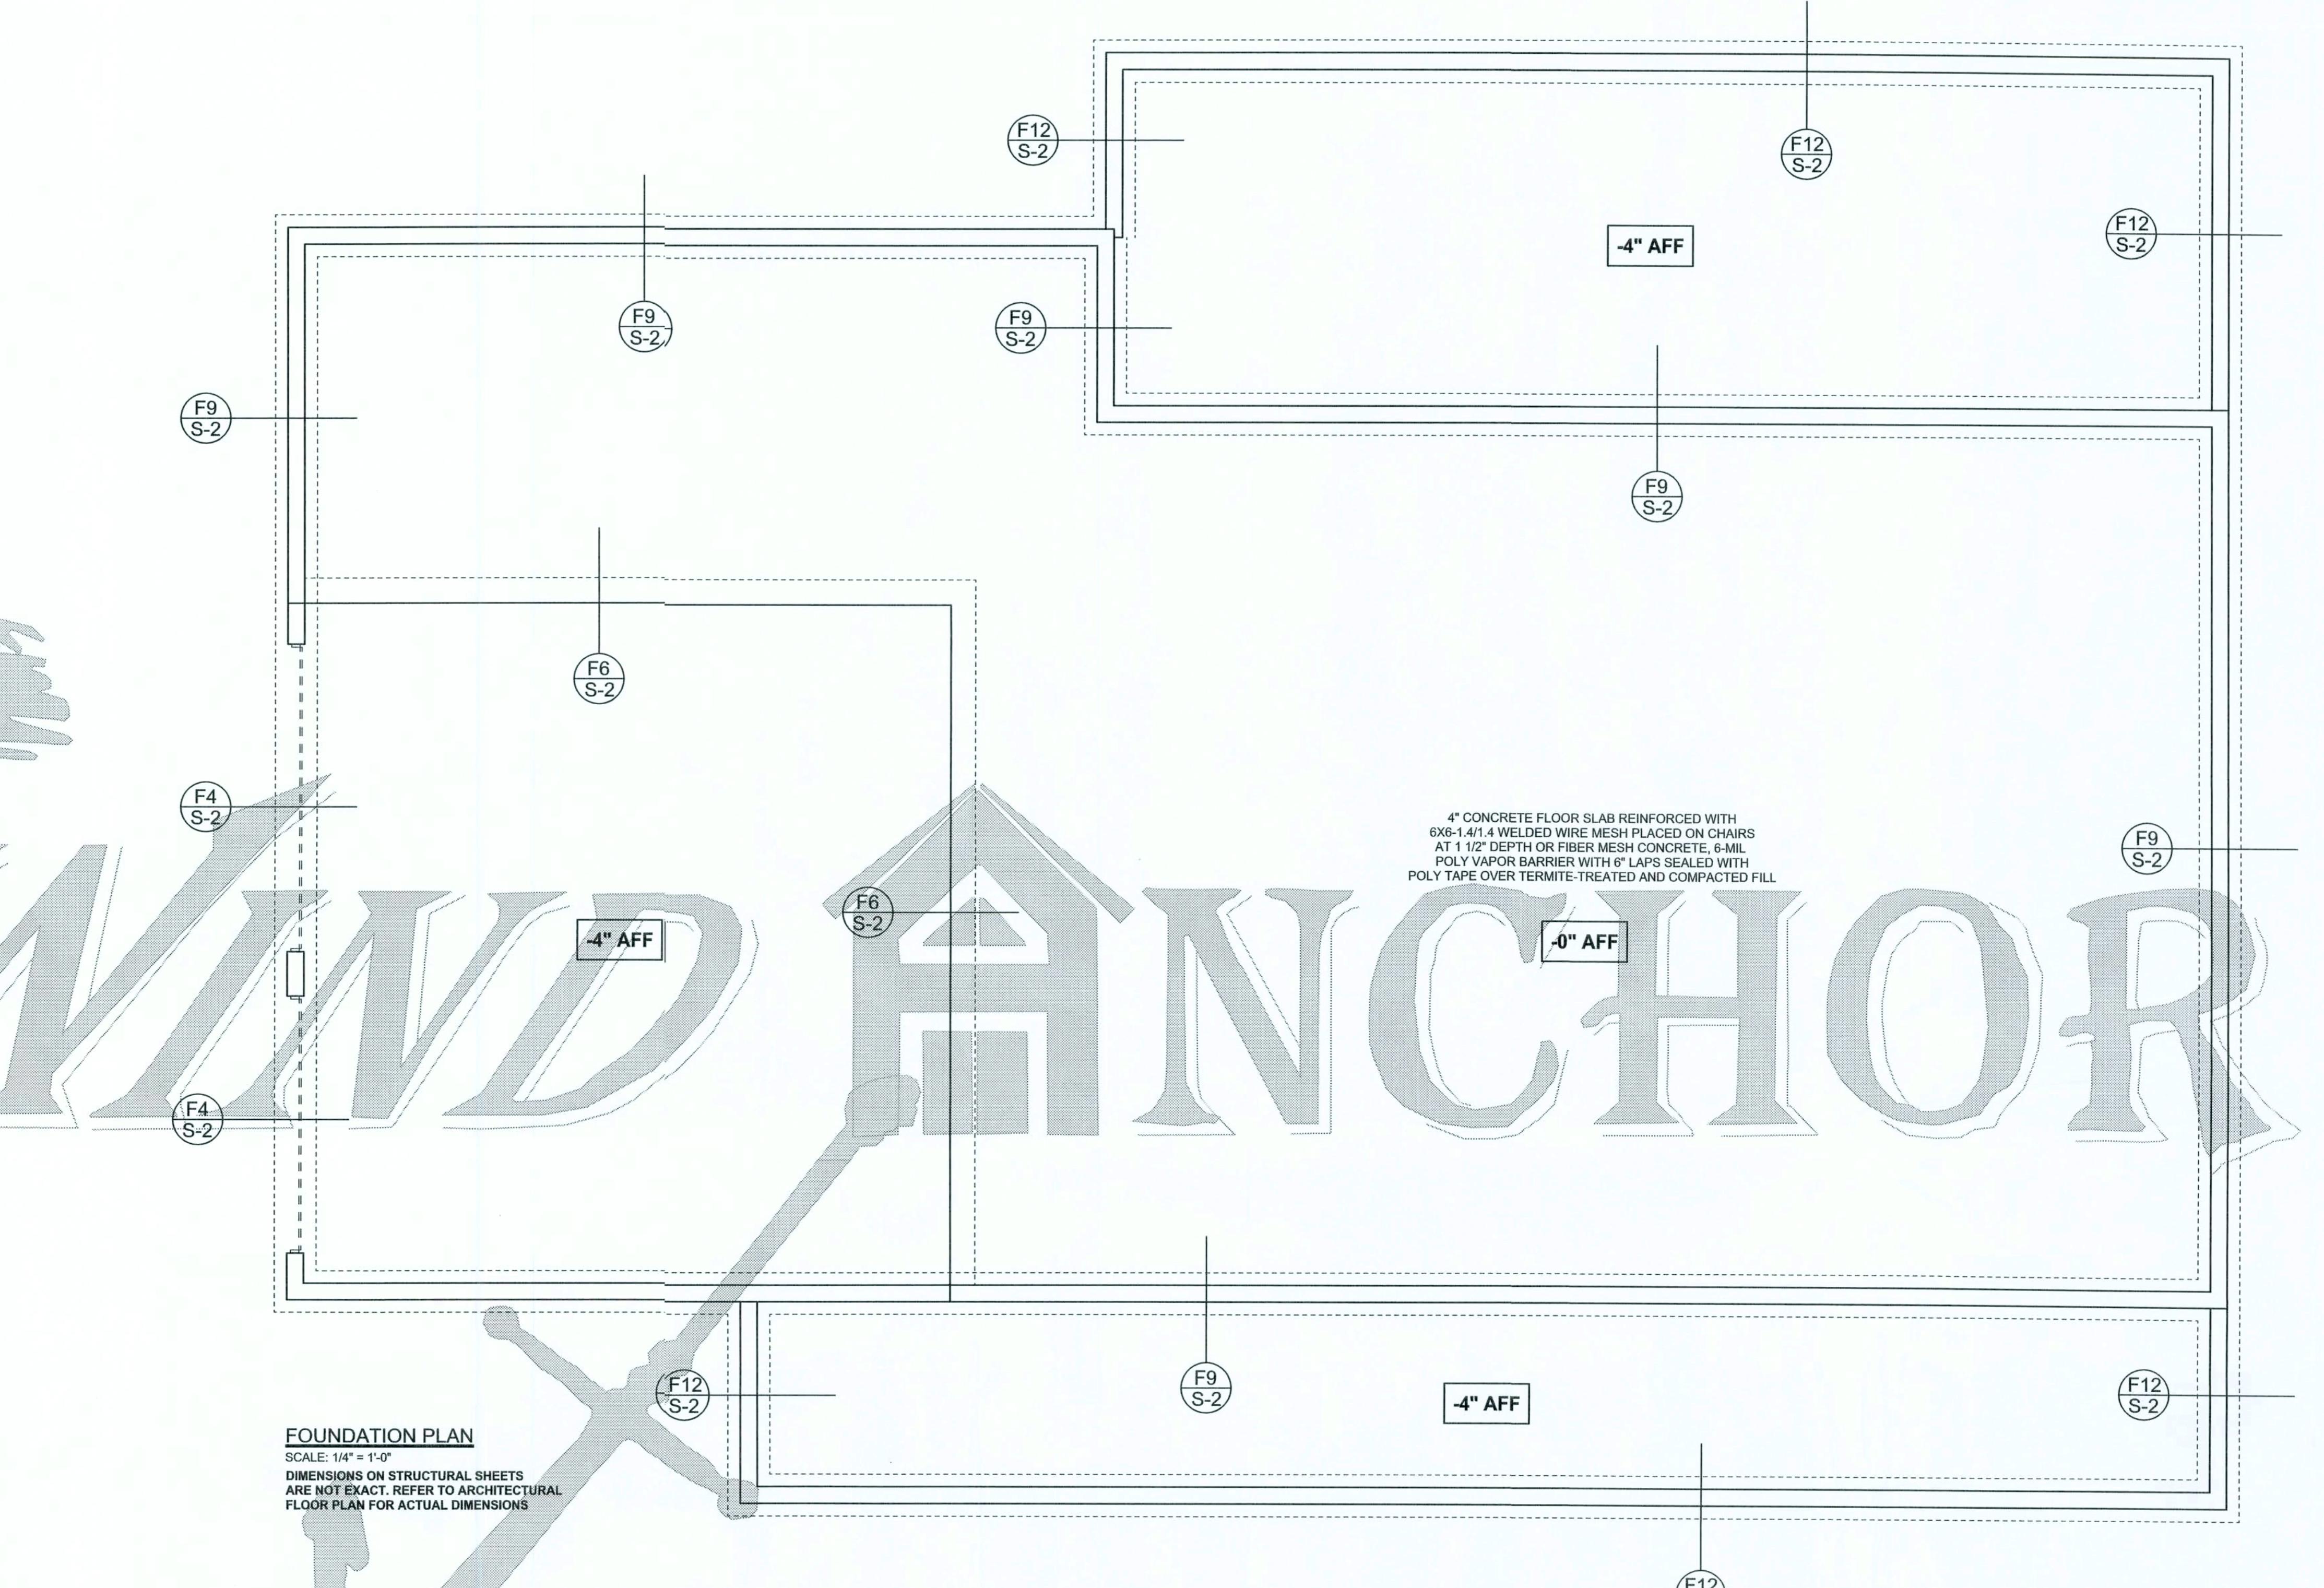


FOUNDATION PLAN


SCALE: 1/4" = 1'-0"
DIMENSIONS ON STRUCTURAL SHEETS ARE NOT EXACT. REFER TO ARCHITECTURAL FLOOR PLAN FOR ACTUAL DIMENSIONS

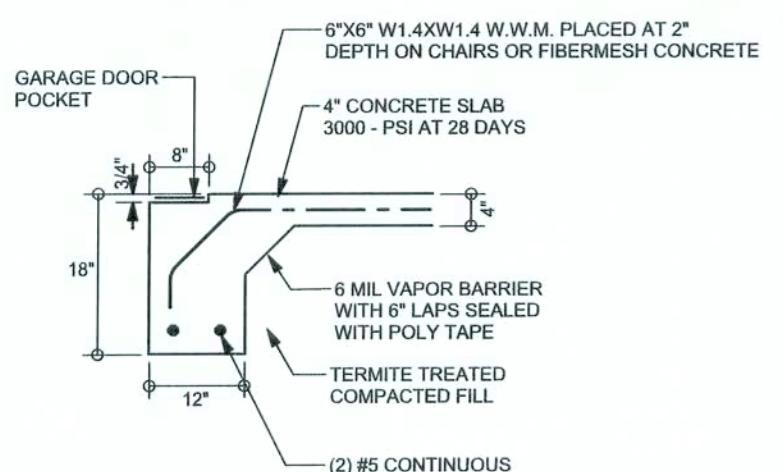

GARAGE DOOR FOOTING
SCALE: 1/2" = 1'-0"

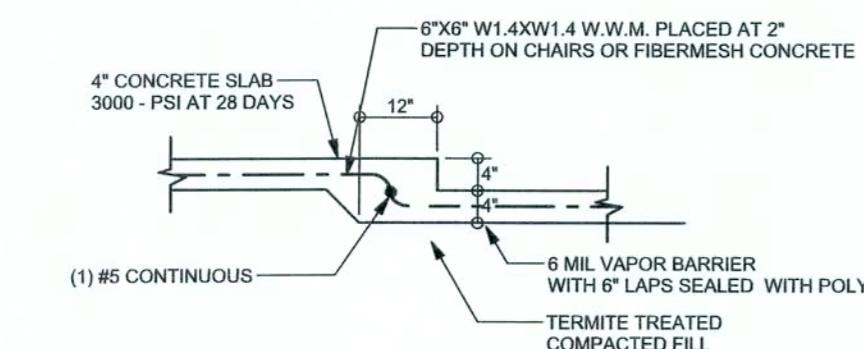

TYPICAL NON-BEARING STEP FOOTING
SCALE: 1/2" = 1'-0"

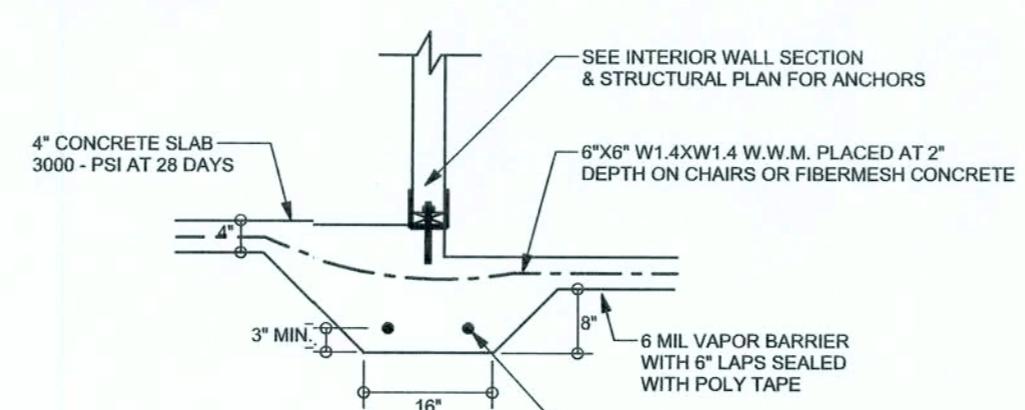

INTERIOR BEARING STEP FOOTING
SCALE: 1/2" = 1'-0"

WIND CAD ENGINEER: Mark Disosway,
PE No. SCD-000, POB 668, Lake City, FL
32055, 386-754-5419

DIMENSIONS:
Stated dimensions supersede scaled dimensions. Refer all questions to Mark Disosway, P.E. for answers.
Do not proceed without clearance.

COPYRIGHTS AND PROPERTY RIGHTS:
Mark Disosway, P.E. hereby expressly reserves its common law copyrights and property right in these materials. No part of this document is to be reproduced, altered, or copied in any form or manner without first the express written permission and consent of Mark Disosway.

CERTIFICATION: I hereby certify that I have examined the plan and find that it complies with the applicable codes and standards in the portions of the plan, relating to wind engineering, comply with section R301.2.1, Florida building code, International 2004, to the best of my knowledge.

LIMITATION: This design is valid for one building, at specified location.

MARK DISOSWAY
P.E. 53915

*Mark Disosway
2/28/07*
SEAL

Don Reed Construction

Christensen Residence

ADDRESS:
Hwy 240
Columbia County, Florida

Mark Disosway P.E.,
P.O. Box 868
Lake City, Florida 32056
Phone: (386) 754 - 4871
Fax: (386) 269 - 4871

PRINTED DATE:
October 27, 2007

DRAWN BY: David Disosway

CHECKED BY:


FINALS DATE:
27 Oct / 07

JOB NUMBER:
709278


DRAWING NUMBER:

S-2

OF 3 SHEETS

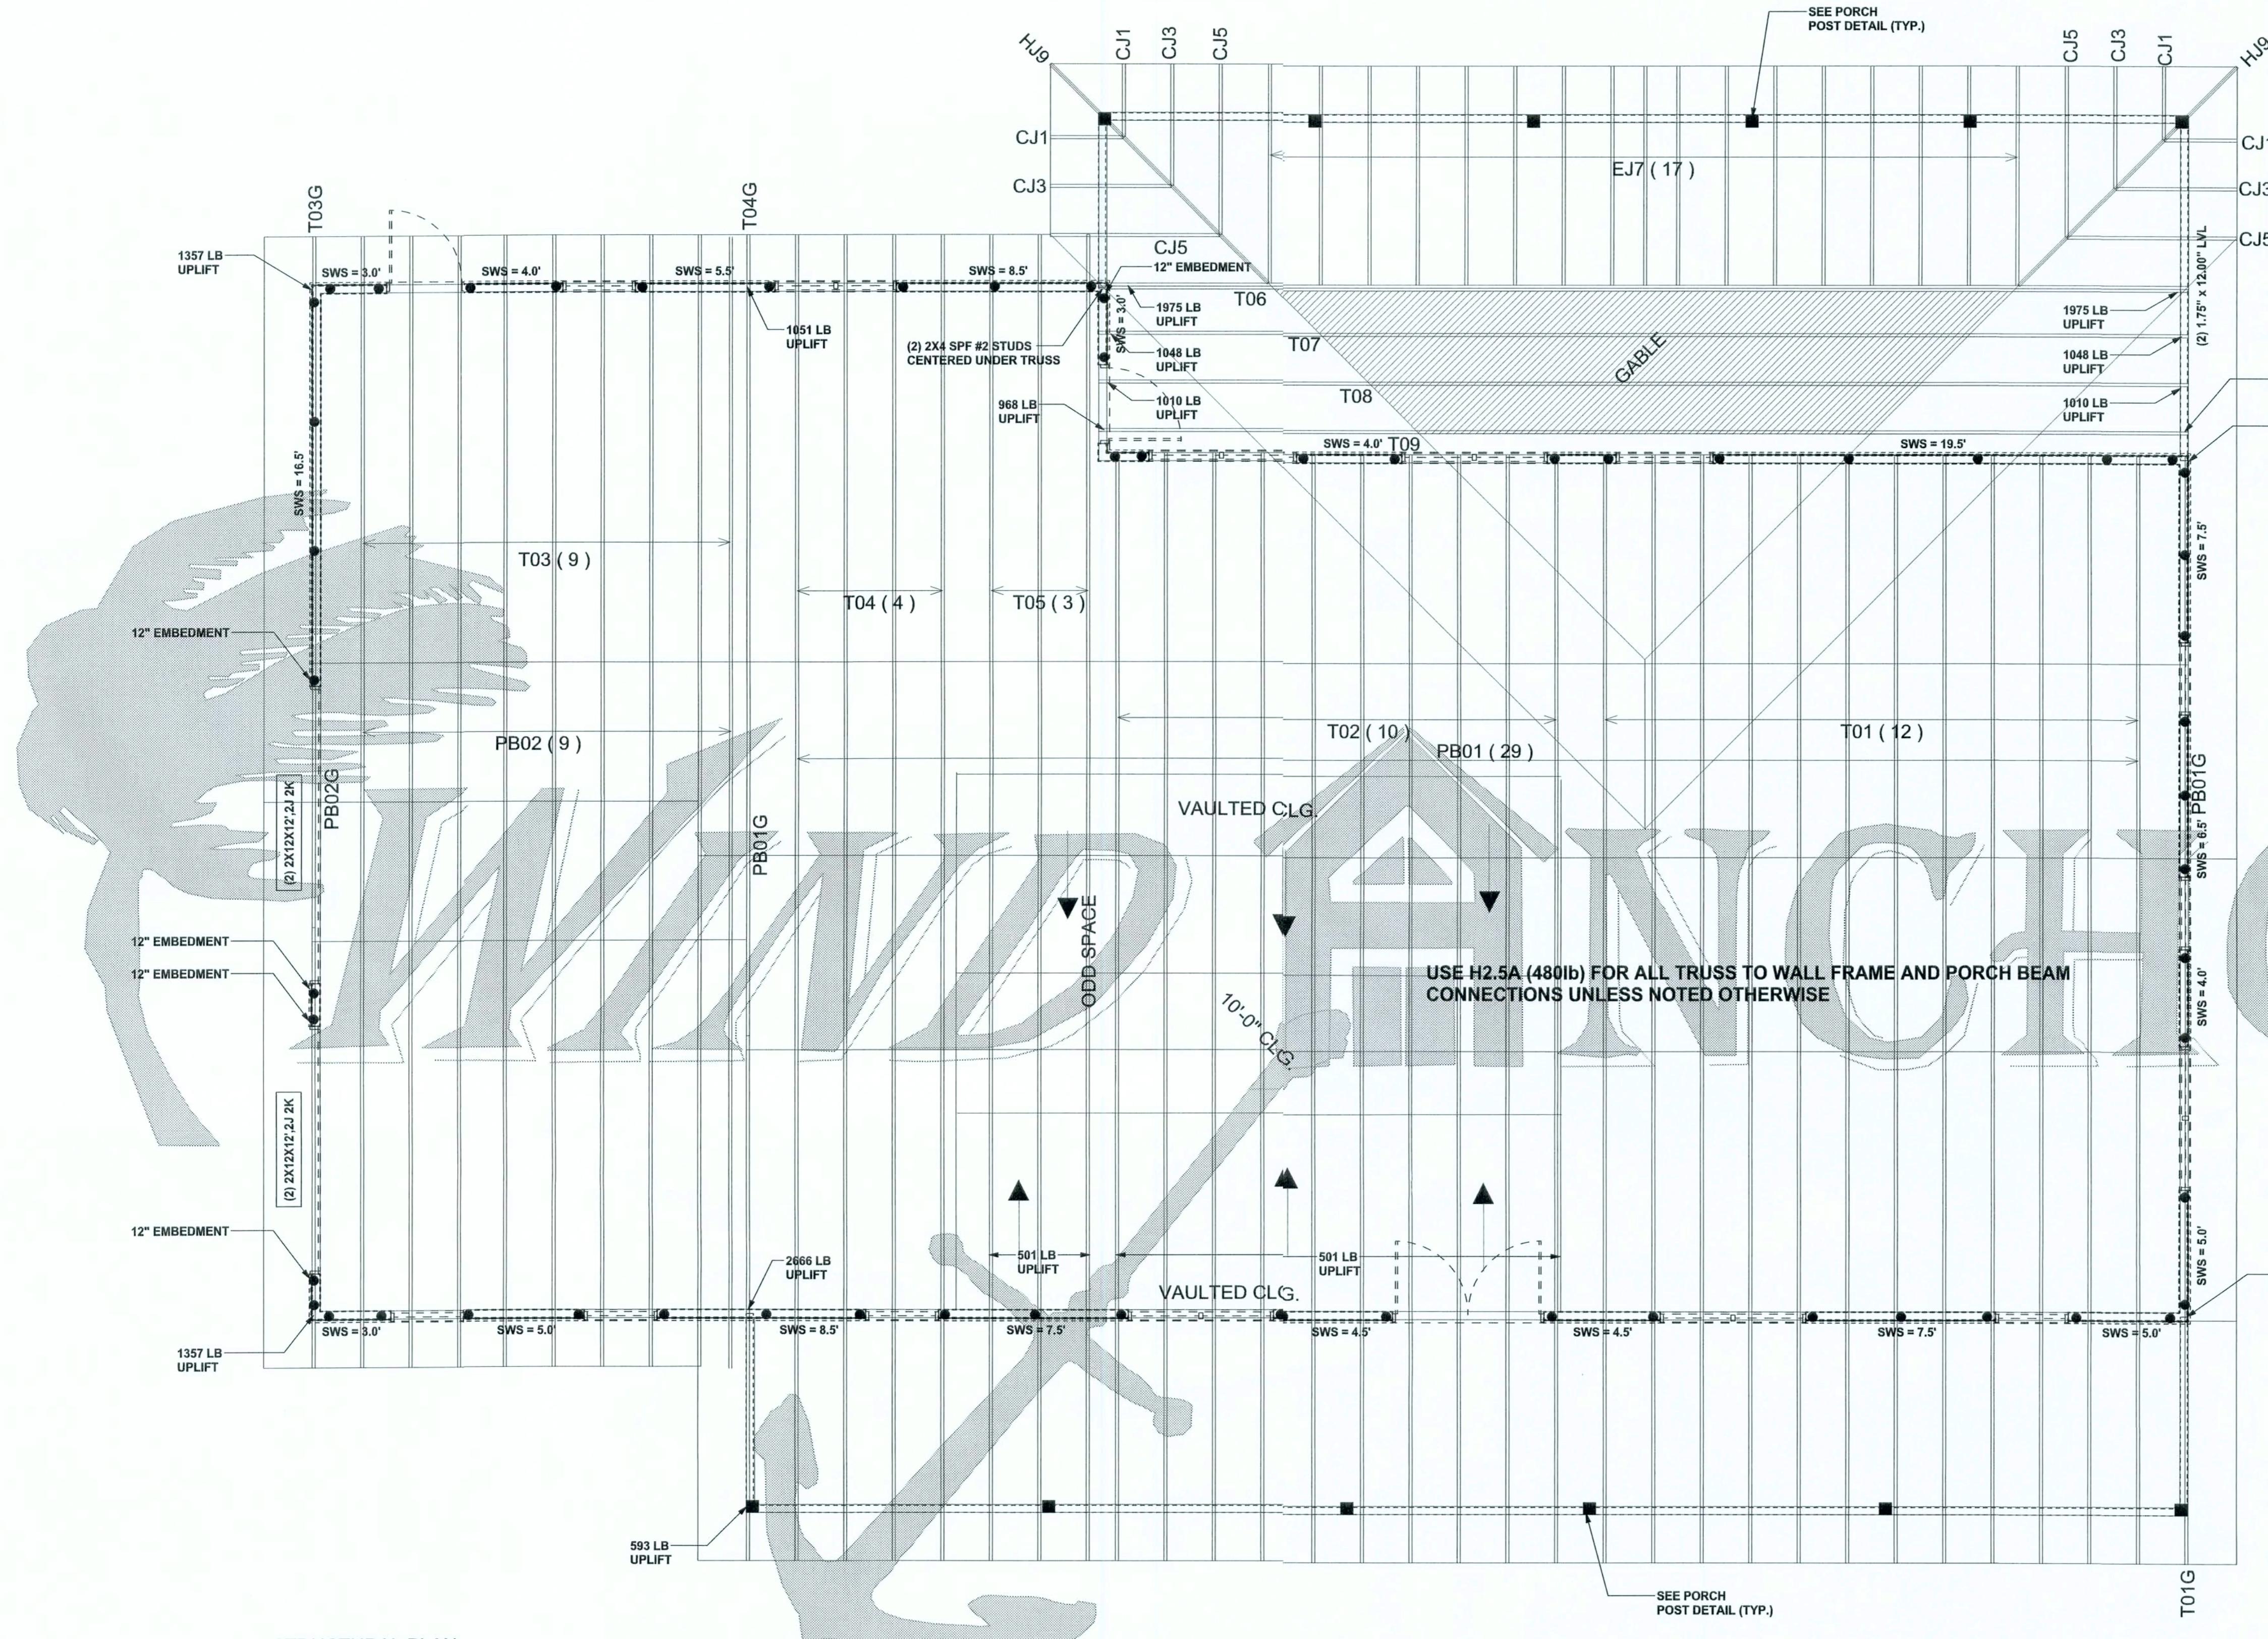

MSTA30, 10-16d (1750b)
(5) NAILS EACH SIDE OF STUD
(OR STRAP STUD TO HEADER 20-10d)

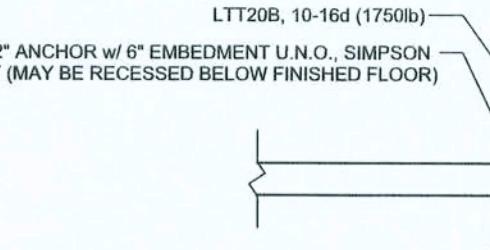

ALTERNATE WALL TIE CONNECTION WHERE
THREADED ROD CANNOT BE PLACED IN WALL.
SCALE: 1/2" = 1'-0"

LOAD ENGINEER: Mark Disosway,
PE No.53915, POB 868, Lake City, FL
32056-5419


DIMENSIONS:
Dimensions are uncheckered scaled
dimensions. Refer all questions to
Mark Disosway, P.E. for resolution.
Do not proceed without clarification.

COPYRIGHTS AND PROPERTY RIGHTS:
Mark Disosway, P.E. hereby reserves
all rights to this document and its property right in
these instruments of service. This document is
not to be reproduced, altered or copied in any
form or manner without written express written
permission and consent of the author.

CERTIFICATION: I hereby certify that I have
examined this plan, and that the applicable
portions of the plan, relating to wind engineering
comply with section R301.2.1, Florida building
code (FBC) 2004, to the best of my
knowledge.

LIMITATION: This design is valid for one
building, at specified location.

MARK DISOSWAY
P.E. 53915

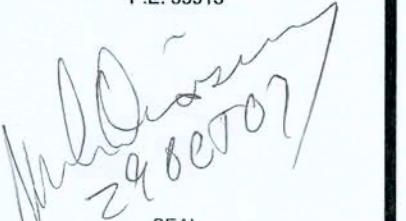
SEAL

Don Reed Construction

Christensen Residence

ADDRESS:
Hwy 240
Columbia County, Florida

Mark Disosway P.E.
P.O. Box 868
Lake City, Florida 32056
Phone: (386) 754 - 4871
Fax: (386) 269 - 4871

PRINTED DATE:
October 27, 2007

DRAWN BY: David Disosway

CHECKED BY:

FINAL DATE:
27 / Oct / 07

JOB NUMBER:
709278

DRAWING NUMBER

S-3

OF 3 SHEETS

CONNECTIONS: WALL & HEADER DESIGN IS BASED
ON REACTIONS & UPLIFTS FROM TRUSS ENGINEERING
FURNISHED BY BUILDER. BUILDERS FIRST SOURCE
JOB #L256777