

76 North Meadowbrook Drive Alpine, UT 84004 office (201) 874-3483 swyssling@wysslingconsulting.com

April 24, 2023 Revised June 9, 2023

Lumio Solar 12600 Challenger Parkway, Suite 200 Orlando, FL 32826

Re: Engineering Services Johnson Residence 615 Southwest Oleander Place, Lake City FL 15.600 kW System

### To Whom It May Concern:

We have received information regarding solar panel installation on the roof of the above referenced structure. Our evaluation of the structure is to verify the existing capacity of the roof system and its ability to support the additional loads imposed by the proposed solar system.

### A. Site Assessment Information

- Site visit documentation identifying attic information including size and spacing of framing for the existing roof structure.
- Design drawings of the proposed system including a site plan, roof plan and connection details for the solar panels. This information will be utilized for approval and construction of the proposed system.

### B. Description of Structure:

**Roof Framing:** 2x6 dimensional lumber at 24" on center.

Roof Material: Metal Roofing 14.04 degrees Attic Access: Accessible Permanent

### C. Loading Criteria Used

- Dead Load
  - Existing Roofing and framing = 7 psf
  - New Solar Panels and Racking = 3 psf
  - TOTAL = 10 PSF
- Live Load = 20 psf (reducible) 0 psf at locations of solar panels
- Ground Snow Load = 0 psf
- Wind Load based on ASCE 7-16
  - Ultimate Wind Speed = 130 mph (based on Risk Category II)
  - Exposure Category B

Analysis performed of the existing roof structure utilizing the above loading criteria is in accordance with the FBC 2020 7th Edition, including provisions allowing existing structures to not require strengthening if the new loads do not exceed existing design loads by 105% for gravity elements and 110% for seismic elements. This analysis indicates that the existing framing will support the additional panel loading without damage, if installed correctly.

### D. Solar Panel Anchorage

- 1. The solar panels shall be mounted in accordance with the most recent S-5! Installation manual. If during solar panel installation, the roof framing members appear unstable or deflect non-uniformly, our office should be notified before proceeding with the installation.
- 2. System will be attached to the metal roofing material utilizing the patented S-5! Connection. Installation of the connections shall be in accordance with the manufacturer's recommendations.
- 3. Considering the wind speed, roof slopes, size and spacing of framing members, and condition of the roof, the panel supports shall be placed no greater than 48" on center.

Based on the above evaluation, this office certifies that with the racking and mounting specified, the existing roof system will adequately support the additional loading imposed by the solar system. This evaluation is in conformance with the *FBC 2020 7<sup>th</sup> Edition*, current industry standards and practice, and is based on information supplied to us at the time of this report.

Should you have any questions regarding the above or if you require further information do not hesitate to contact me.

164 E. Nys

Scott E. Wyssling, PE Florida License No. 8 1538 Florida COA No. RY34912 THIS PLAN HAS BEEN ELECTRONICALLY SIGNED AND SEALED BY SCOTT WYSSLING, PE USING A DIGITAL SIGNATURE AND DATE. PRINTED COPIES OF THIS DOCUMENT ARE NOT CONSIDERED SIGNED AND SEALED AND THE SIGNATURE MUST BE VERIFIED ON ANY ELECTRONIC COPIES

No. 8155

No. 8155

Wyssling Consulting, PLLC 76 N Meadowbrook Drive Alpine UT 84004

Florida License & R734912

Date Signed 6/9/2023



<u> </u>	<b>V V V</b>	Y Y Y	<b>Y Y Y</b>	Y Y Y	Y Y Y	Y Y Y Y	
ARRAY DESCRIPTION							
ROOF	# OF MODULES	AZIMUTH	TILT	TRUSS SIZE	TRUSS SPACING	ROOF MATERIAL	
#1	6	360	3/12 (14.04°)	2X4	24"O.C.	METAL	
#2	7	270	3/12 (14.04°)	2X4	24"O.C.	METAL	
#3	8	180	3/12 (14.04°)	2X4	24"O.C.	METAL	
#4	7	90	3/12 (14.04°)	2X4	24"O.C.	METAL	
#5	11	180	3/12 (14.04°)	2X4	24"O.C.	METAL	

FRONT OF RESIDENCE

DESIGN SPECIFICATION				
RISK CATEGORY	II			
CONSTRUCTION	SFD			
ZONING	RESIDENTIAL			
SNOW LOAD (ASCE 7-16)	0 PSF			
EXPOSURE CATEGORY	В			
WIND SPEED (ASCE 7-16)	130 MPH			


6'-10" (N) S-5! PRO (N) UNIRAC RA **ROOF #2** ROOF #3 Wyssling Consulting, PLLC 76 N Meadowbrook Drive Alpine UT 84004 Florida License # RY34912

ROOF #4

ROOF #1

### ROOF'S GENERAL NOTES

- CONTRACTOR/INSTALLER TO VERIFY ROOF CONDITIONS FOR PROPER
- INSTALLATION OF THE PV SYSTEM.
  CONTRACTOR/INSTALLER TO NOTIFY THE OWNER IMMEDIATELY OF ANY ROOF DEFICIENCIES AND/OR REPAIR REQUIRED TO INSTALL THE PV SYSTEM.
  EOR DOES NOT, ASSUME ANY RESPONSIBILITY FOR THE INSTALLATION OF
  ANY PVS. STEM ON DEFICIENT BROSES
- MANUFACTURER STANDARDS.

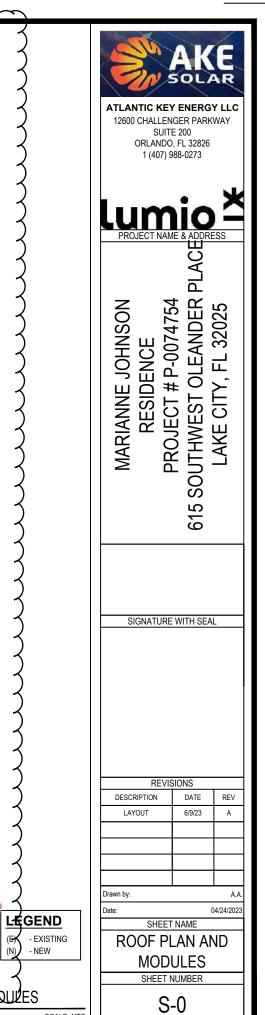

BACK OF RESIDENCE

ROOF #5

SONAL ENGINEER

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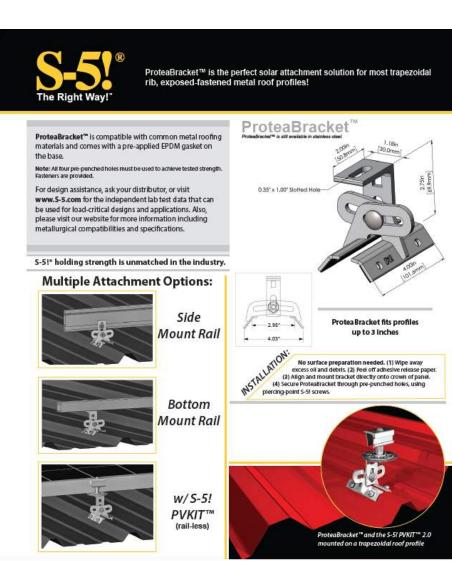
SEALED AND THE SIGNATURE MUST BE VERIFIED

NOTE TO THE ROOF PLANAND MODULES

- NEW

SCALE: NTS







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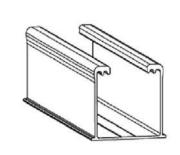
S-51\* Warning! Please use this product responsibly!


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Products are protected by multiple U.S. and foreign patents. For published data regar strength, bolt torque, patents, and trademarks, visit the S-Si website at www.S-S.com.





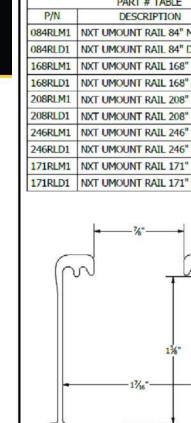

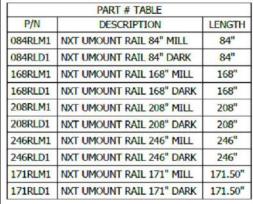

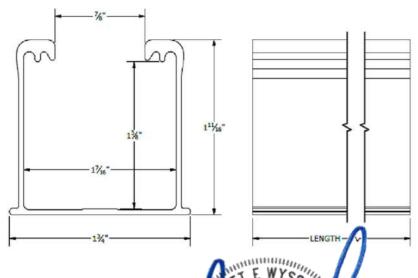**#UNIRA** 1411 BROADWAY BLVD. NE ALBUQUERQUE, NM 87102 USA PHONE: 505.242.6411 WWW.UNIRAC.COM

PRODUCT LINE: DRAWING TYPE: DESCRIPTION: REVISION DATE:

NU-P01 ARE **FED BY** ONE OR 19 E US ATENTS SSIONAL ENGINE

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Signed 6/09/2023

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SUITE 200 ORLANDO, FL 32826 1 (407) 988-0273 ACE 굽 PROJECT # P-0074754 SOUTHWEST OLEANDER MARIANNE JOHNSON RESIDENCE LAKE CITY, FL 2 SIGNATURE WITH SEAL REVISIONS DESCRIPTION DATE RFV Drawn by:

04/24/2023

SHEET NAME

**EQUIPMENT** 

**SPECIFICATIONS** 

SHEET NUMBER

S-1

ATLANTIC KEY ENERGY LLC 12600 CHALLENGER PARKWAY





# 25 YEAR

WARRANTY


## DISCOVER YOUR NXT HORIZON


The culmination of over two decades of experience. Thoughtful design, rigorous engineering, world-class support, and a reliable supply chain are the foundation of what makes us confident that NXT HORIZON° is the NXT Level of DESIGN, SIMPLICITY, and VALUE.



DARK: SHCLMPD1 MILL: SHCLMPM1

Adaptable rail connection to attachments allows click-in feature compatibility with almost all of Unirac's attachments.

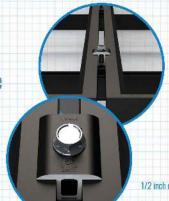

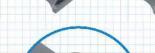

1/2 inch module spacing for efficiency.

DARK: CCLAMPD1 MILL: CCLAMPM1

there are cables!)

Clicks into rail anywhere feven when

combines as both mid and end clamp

Self-standing clamp with spring

Clamps 30-40 mm modules

Unirac-quality bonding that works both as



Make the install look clean with the end cap kit designed to complement the module end clamp and rail ends.





FlashLoc technology combined with new features: click-in rail & open slot L-Foot for the best flash-less install experience.

STRONGHOLD" ATTACHMENT KIT

DARK: SHCPKTD1 MILL: SHCPKTM1

Rail clicks into the clamps attached to the Stronghold \*\* base, Open slot in L-foot allows drop-in rail clamp.

Alternative attachment options



PLASHRIT PRO
DARK: 1040550
MILL: 004055A



DARK: 168RLD1 MILL: 168RLM1

Strong, lightweight open channel rail with invisible, easy, unfailing and integrated wire management system.

NXT HORIZON' RAIL SPLICE

RESPECM

Structural Internal splice that does not interfere with roof connection nor module connection. Pre-assembled thread cutting bolts.



WIRE MANAGEMENT OPTONS

### NXT HORIZON' MLPE & LUG CLAMP

LUGMLPET

Works as either MLPE Mount or Grounding Lug connection to the rail. Why source two parts when one can do the job?



### NXT HORIZON WIRE MANAGEMENT CLIP

WRMCLPD1

Aesthetic, yet functional accessory that works to help installers keep wires inside the rail. No zip-ties required, Optional zip tie loop for extra wire management capabilities!



### NXT HORIZON' HORTH/SOUTH WIRE MANAGEMENT CUP

WRMCNSD1

An elegant solution to help installers get to the home run. The same hardware works to provide both easy entry to rail and adjustability for cable thickness.

ALL NXT HORIZON' SYSTEMS INCLUDE A FREE PERMITTING PLANSET DESIGN - FOR QUESTIONS OR CUSTOMER SERVICE VISIT UNIRAC.COM OR EMAIL NXTPERMITS@UNIRAC.COM



ATLANTIC KEY ENERGY LLC

12600 CHALLENGER PARKWAY SUITE 200 ORLANDO, FL 32826 1 (407) 988-0273

Lumio PROJECT NAME & ADDRESS

MARIANNE JOHNSON RESIDENCE PROJECT # P-0074754 SOUTHWEST OLEANDER PLACE LAKE CITY, FL 32025

SIGNATURE WITH SEAL

615

REVISIONS

DESCRIPTION DATE REV

o4/24/2023
SHEET NAME

EQUIPMENT SPECIFICATIONS

SHEET NUMBER

S-1