

NOTE: ALL WALLS SHALL BE 9'-0" UNLESS OTHERWISE NOTED.

Garage fire separations shall comply with the following:

1. The private garage shall be separated from the dwelling unit and its attic area by means of a minimum ½-inch (12.7 mm) gypsum board applied to the garage side. Garages beneath habitable rooms shall be separated from all habitable rooms above by not less than 5/8-inch Type X gypsum board or equivalent. Door openings between a private graage and the dwelling unit shall be equipped with either solid wood doors, or solid or honeycomb core steel doors not less than 13/8 inches (34.9 mm) thick, or doors in compliance with Section 715.3.3. Openings from a private garage directly into a room used for sleeping purposes shall not be permitted.

- Ducts in a private garage and ducts penetrating the walls or ceilings separating the dwelling unit from the garage shall be constructed of a minimum 0.019-inch (0.48 mm) sheet steel and shall have no openings into the garage.
- A separation is not required between a Group R-3 and U carport provided the carport is entirely open on two or more sides and there are not enclosed areas above.
- 4. When installing an attic access and/or pull-down stair unit in the garage, devise shall have a minimum 20 min. fire rating.

AREA SUMMARY

LIVING AREA 2,245 S.F. **GARAGE AREA** 595 S.F. COVERED PORCH AREA **ENTRY PORCH AREA**

TOTAL AREA

206 S.F. 20190926 163 S.F.

3,209 S.F. SHEET NUMBER

NOTE: ALL DRAWINGS NOT TO BE SCALED, WRITTEN DIMENSIONS TAKE PRECEDENCE OVER SCALED DIMENSIONS

DIMENSIONED FLOOR PLAN

CONTRACTIN RINGS, FLORIDA CKBERRY A A BL

GIBRALTAR (LIC# 1259633 HIGH SPF LOT Propert © WM DESIGN & LAKE CITY, FL 32025

21, 21, idress:

ASSOCIATES, INC. 426 SW COMMERCE DR, STE 130 (386) 758-8406 will@willmyers.net

JOB NUMBER

OF 3 SHEETS


	ELECTRICAL LEGEND
	CEILING FAN (PRE-WRE FOR LIGHT KIT)
QP	DOUBLE SECURITY LIGHT
0	RECESSED CAN LIGHT
₩	BATH EXHAUST FAN
	LIGHT FXTURE
Ф	DUPLEXOUTLET (AFCI & TAMPER RESISTANT)
₩	220v OLTLET
Б ся	GFI DUFLEX OUTLET (PER NEC 406.8)
TV †	TELEVISION JACK
PH ▽	TELEPHONE JACK
•	SMOKE [/] CARBON MONOXIDE DETECTOR (see note below)
\$	WALL SVITCH
\$3	3 WAY VALL SWITCH
₩P/GFI	WATERPROOF GFI OUTLET
48" FLOUR.	2 OR 4 1UB FLUORESCENT FIXTURE

ALL INTERIOR RECEPTACLESSHALL BE AFCI (ARC FAULT CIRCUIT INTERRIPT) PER NEC 210.12 & TAMPER RESISTANT PER NEC 406.11

ALL SMOKE DETECTORS BE # COMBO SMOKE & CARBON MONOXIDE DETECTOR AND SHALL HAVE BATTERY BACKUP POWER AND ALL WIRED TOGETHER SO IF ANY ONE UNIT IS ACTUATED THEY ALL ACTIVATE.

THE ELECTRICAL SERVICE OVERCURRENT PROTECTION DEVICE SHALL BE INSTALLED ON THE EXTERIOR OF STRUCTURES TO SERVE AS A DISCONNECT MEANS. CONDUCTORS USED FROM THE EXTERIOR DISCONNECTING MEANS TO A PANEL OR SUB PANEL SHALL HAVE FOUR-WRE CONDUCTORS, OF WHICH ONE CONDUCTOR SHALL BE USED AS AN EQUIPMENT GROUND.

IT IS THE LICENSED ELECTRICAL CONTRACTORS RESPONSIBILITY TO INSURE THAT ALL WORK PERFORMED AND EQUPMENT INSTALLED MEETS OR EXCEEDS THE NFPA70 2014 NATIONAL ELECTRIC CODE AND ALL OTHER LOCAL CODES AND ORDINANCES.

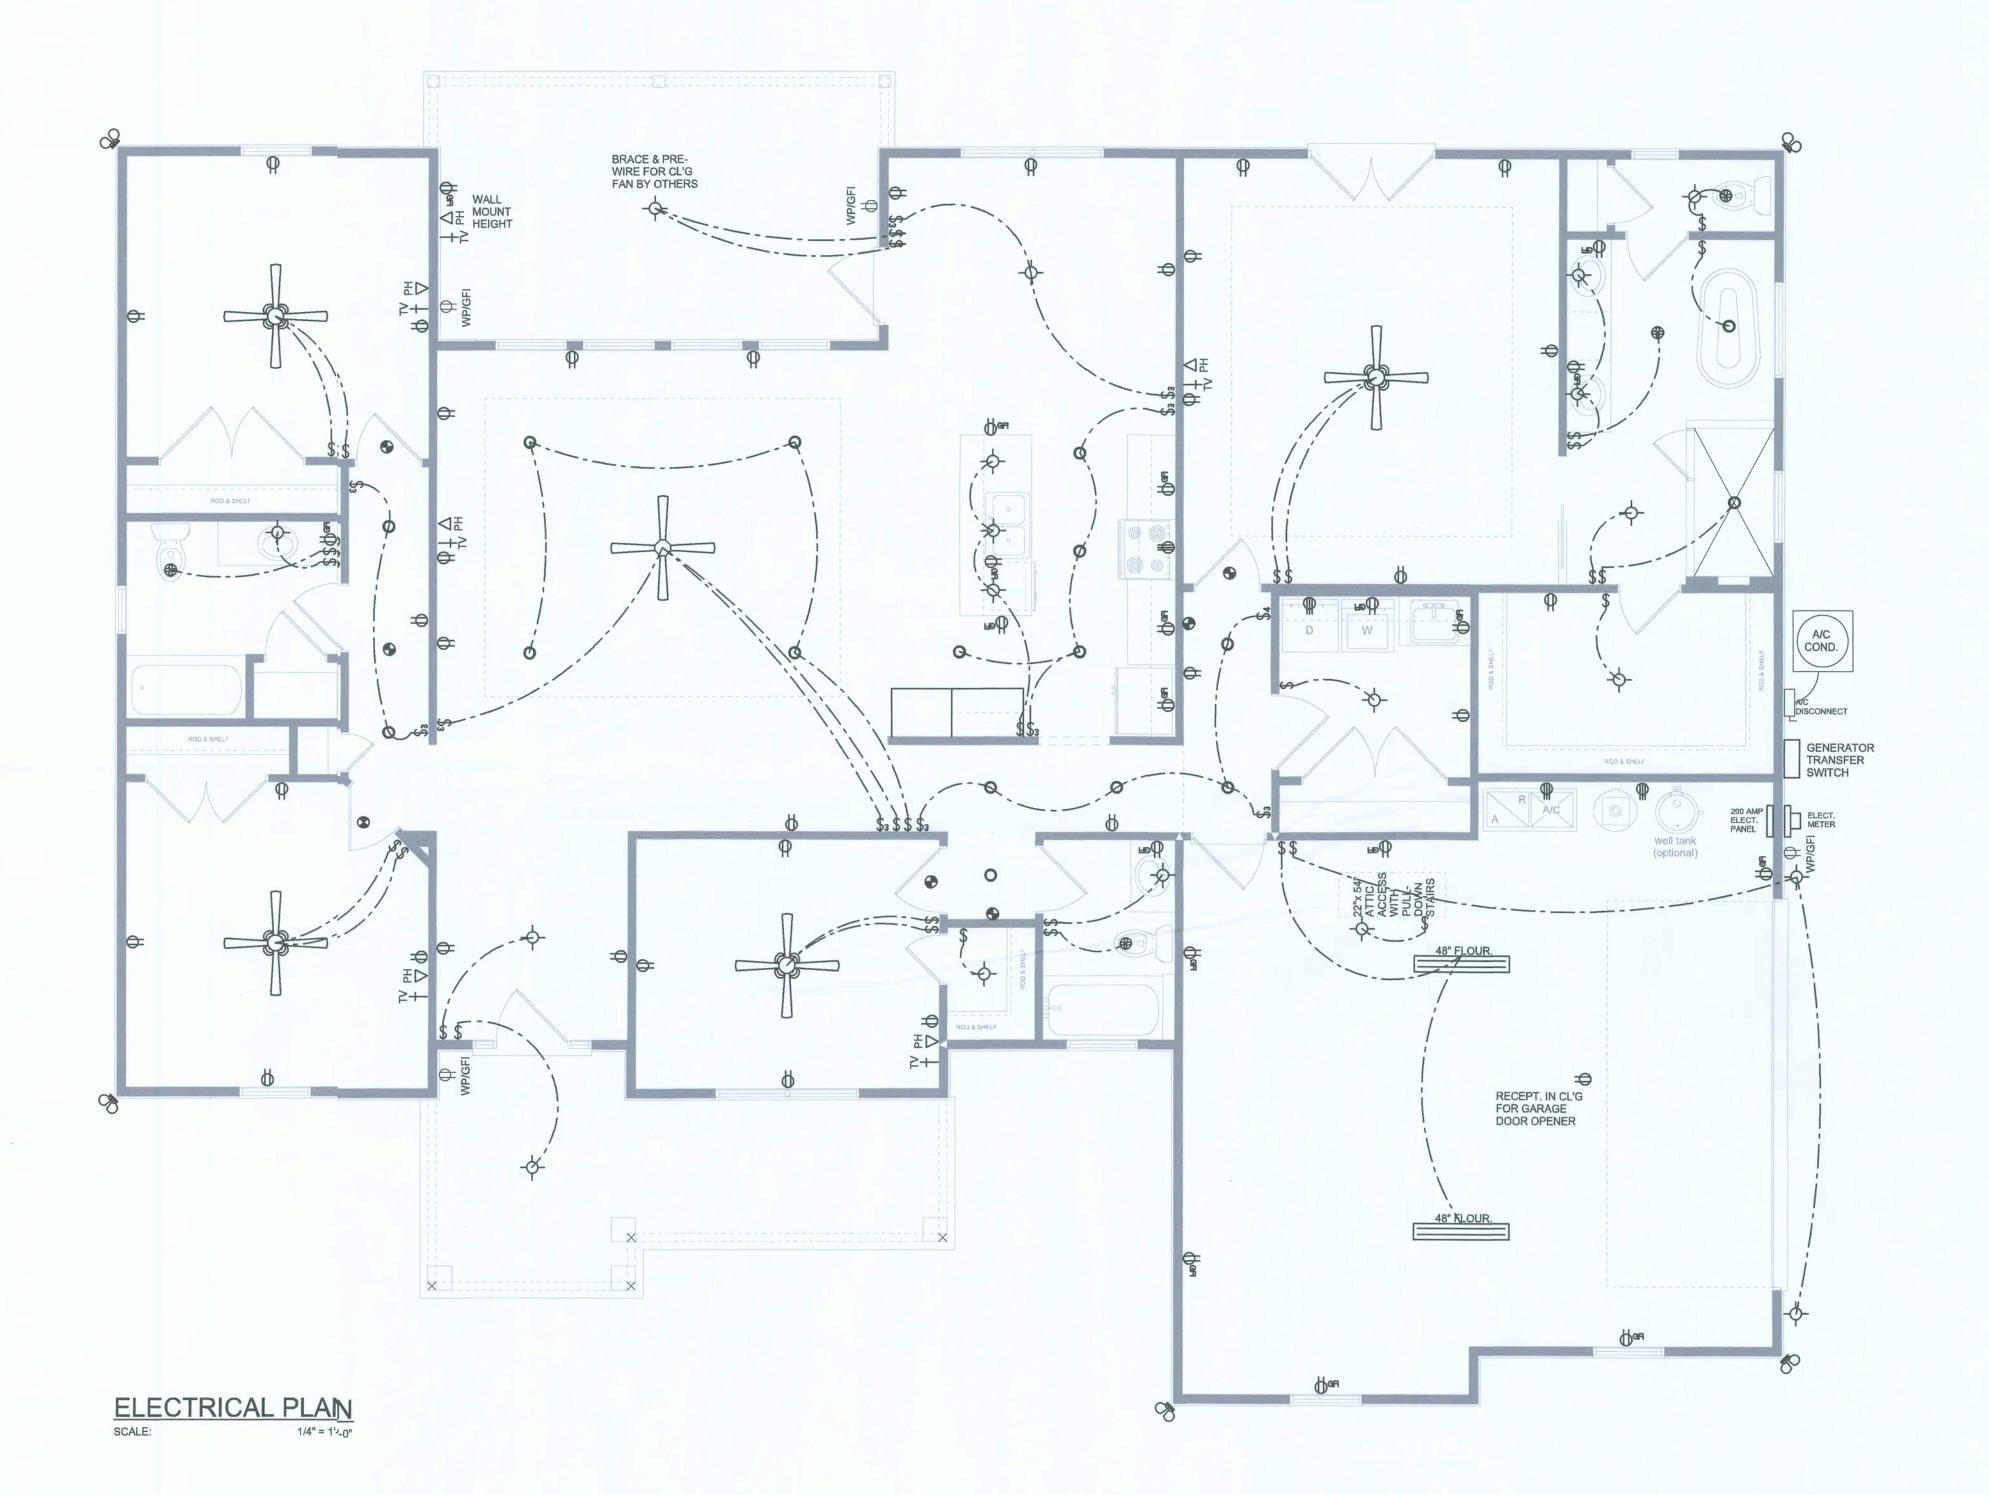


SOFTPIAN ARCHITECTURAL DESIGN SOFTMARE

ELECTRICAL PLAN SCALE: 1/4" = 1'0"

ACKBERRY AR GIBRALT/ 21, 21,

© WM DEJGN & A 5 50 CIATE 5, INC. 426 SW COMMERCE DR, STE 130 LAKE CITY, FL 32025 (386) 758-8406 will@willmyers.net

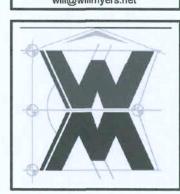



JOB NUMBER 20190926


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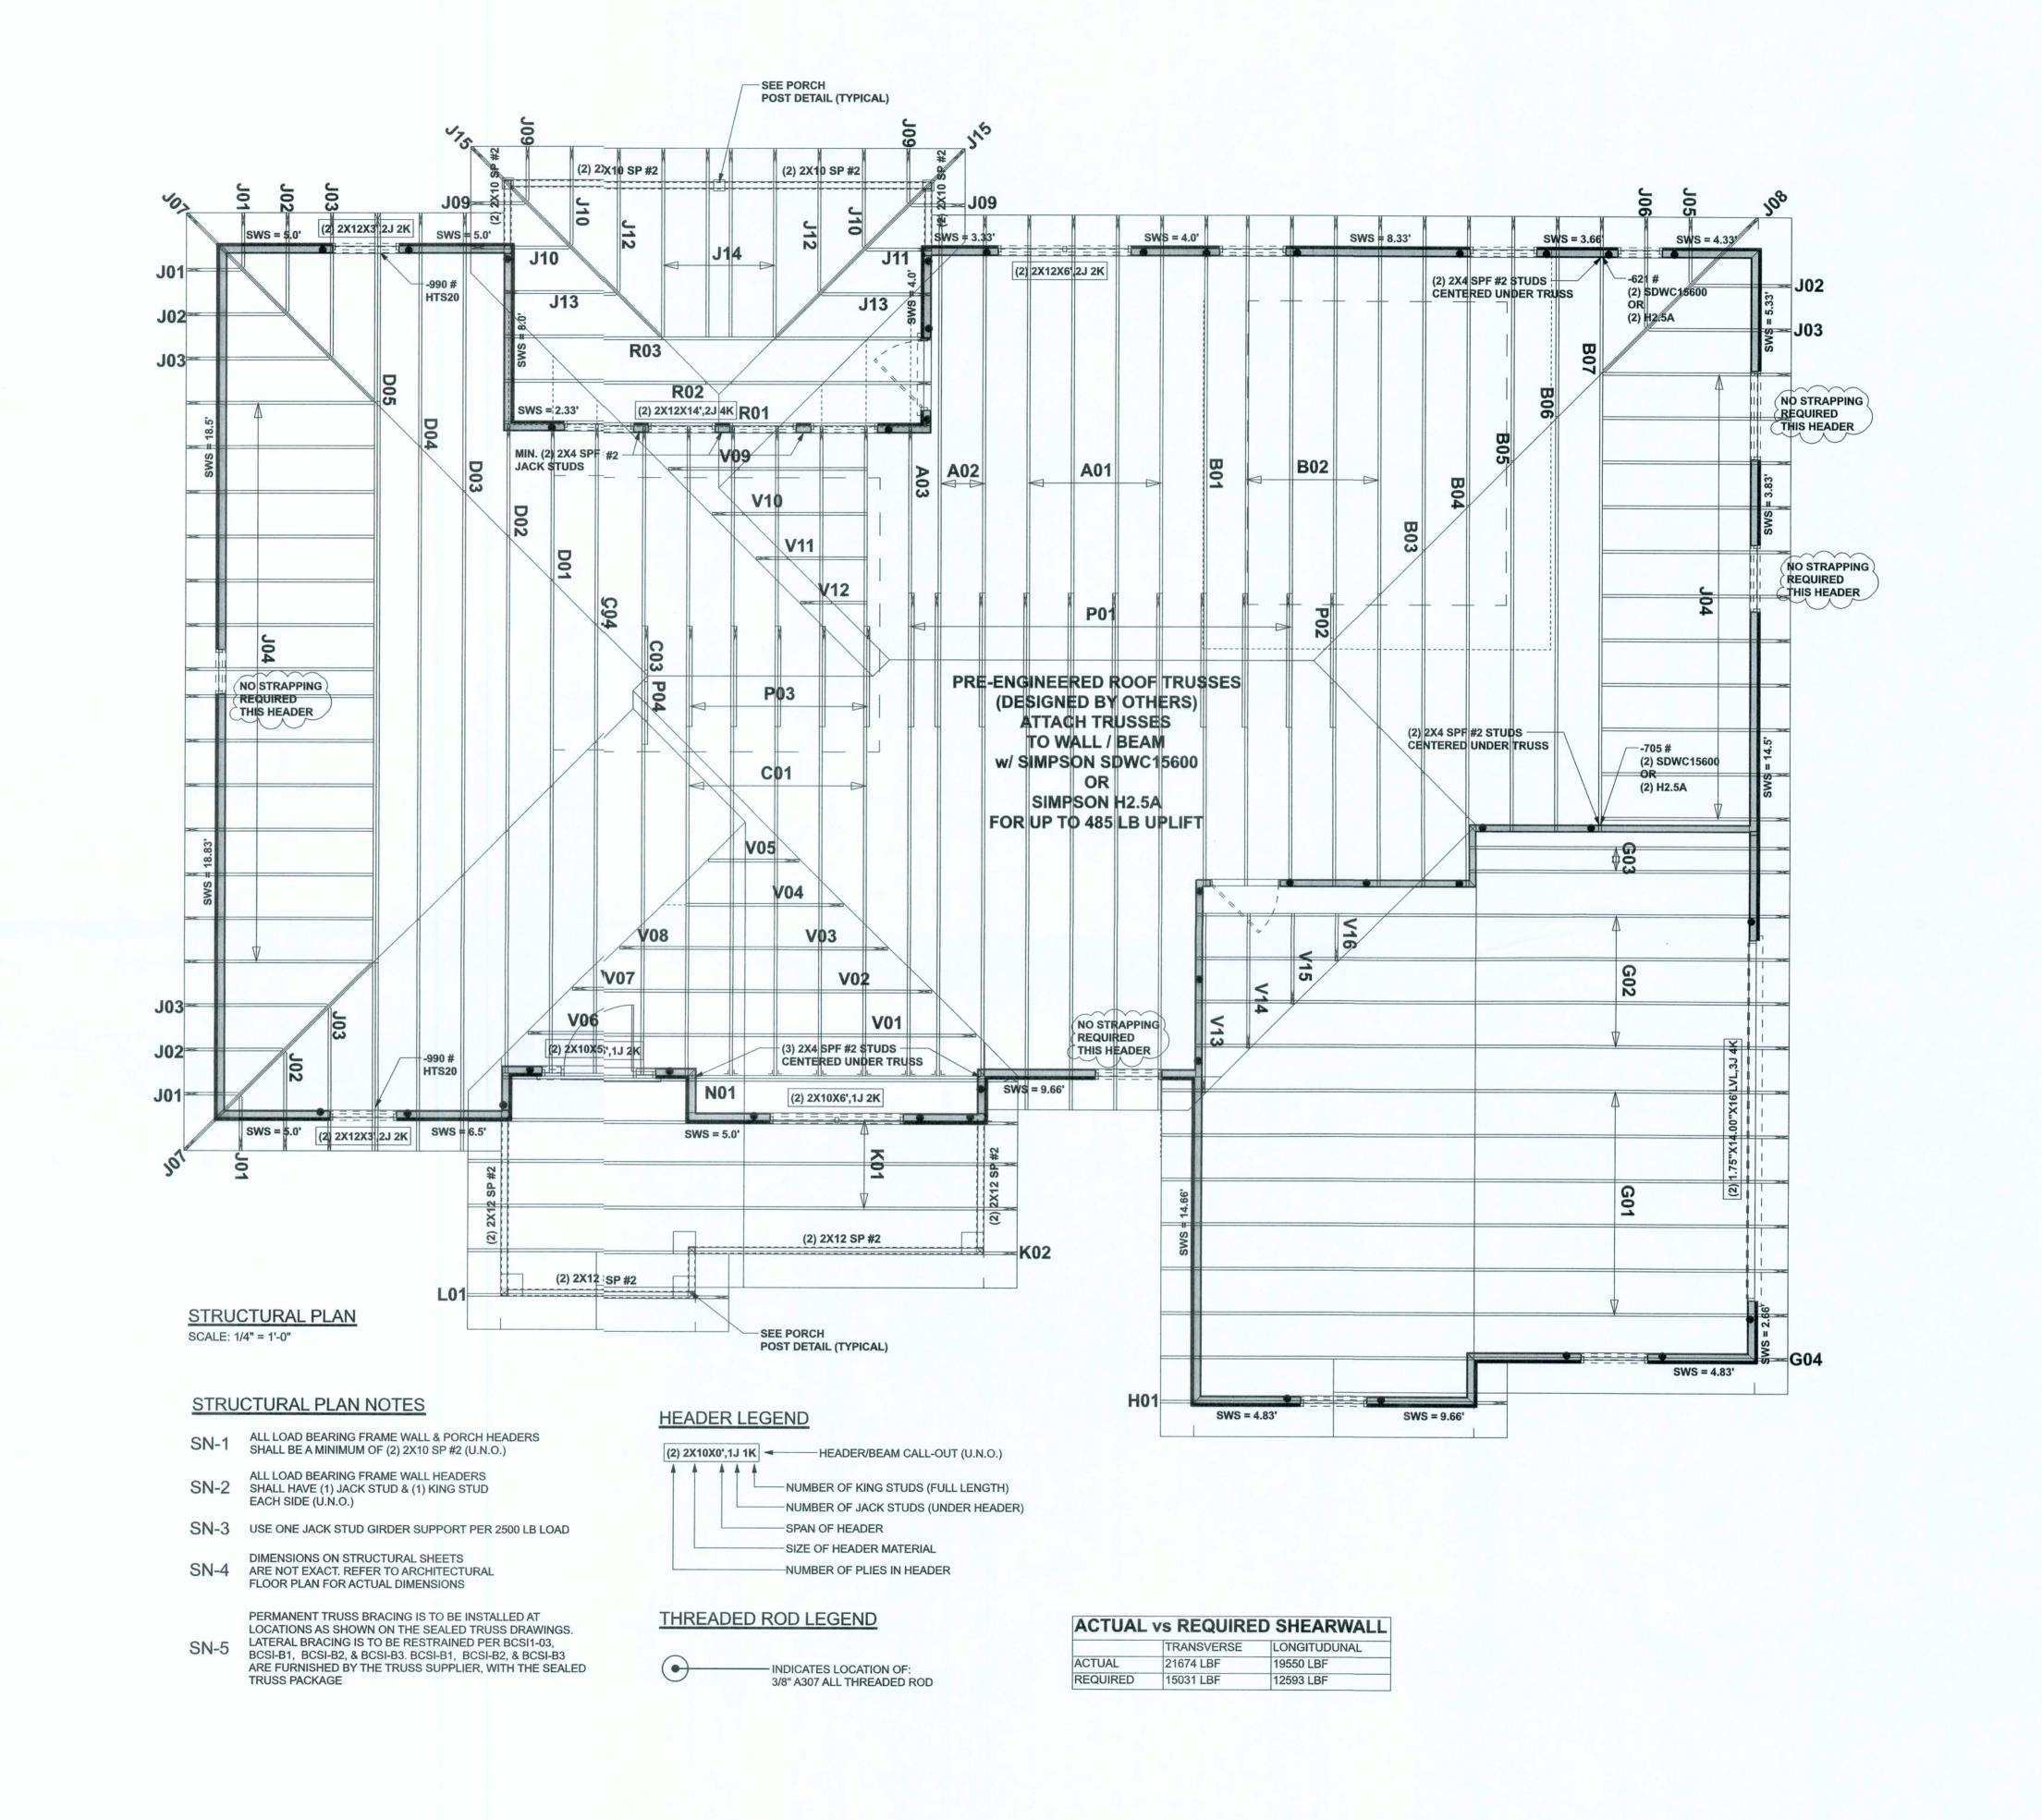
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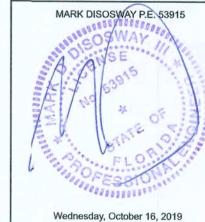
CONNECTIONS, WALL, & HEADER DESIGN IS BASED ON REACTIONS & UPLIFTS FROM TRUSS ENGINEERING FURNISHED BY BUILDER. W.B. HOWLAND TRUSS CO. JOB #18-2846

Stited dimensions supercede scaled dinensions. Refer all questions to Mark Disosway, P.E. for resolution.

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CERTIFICATION: I hereby certify that I have examined this plan, and that the applicable potions of the plan, relating to wind engineering comply with the 6th Edition Florida Building Code Residential (2017) to he best of my knowledge.

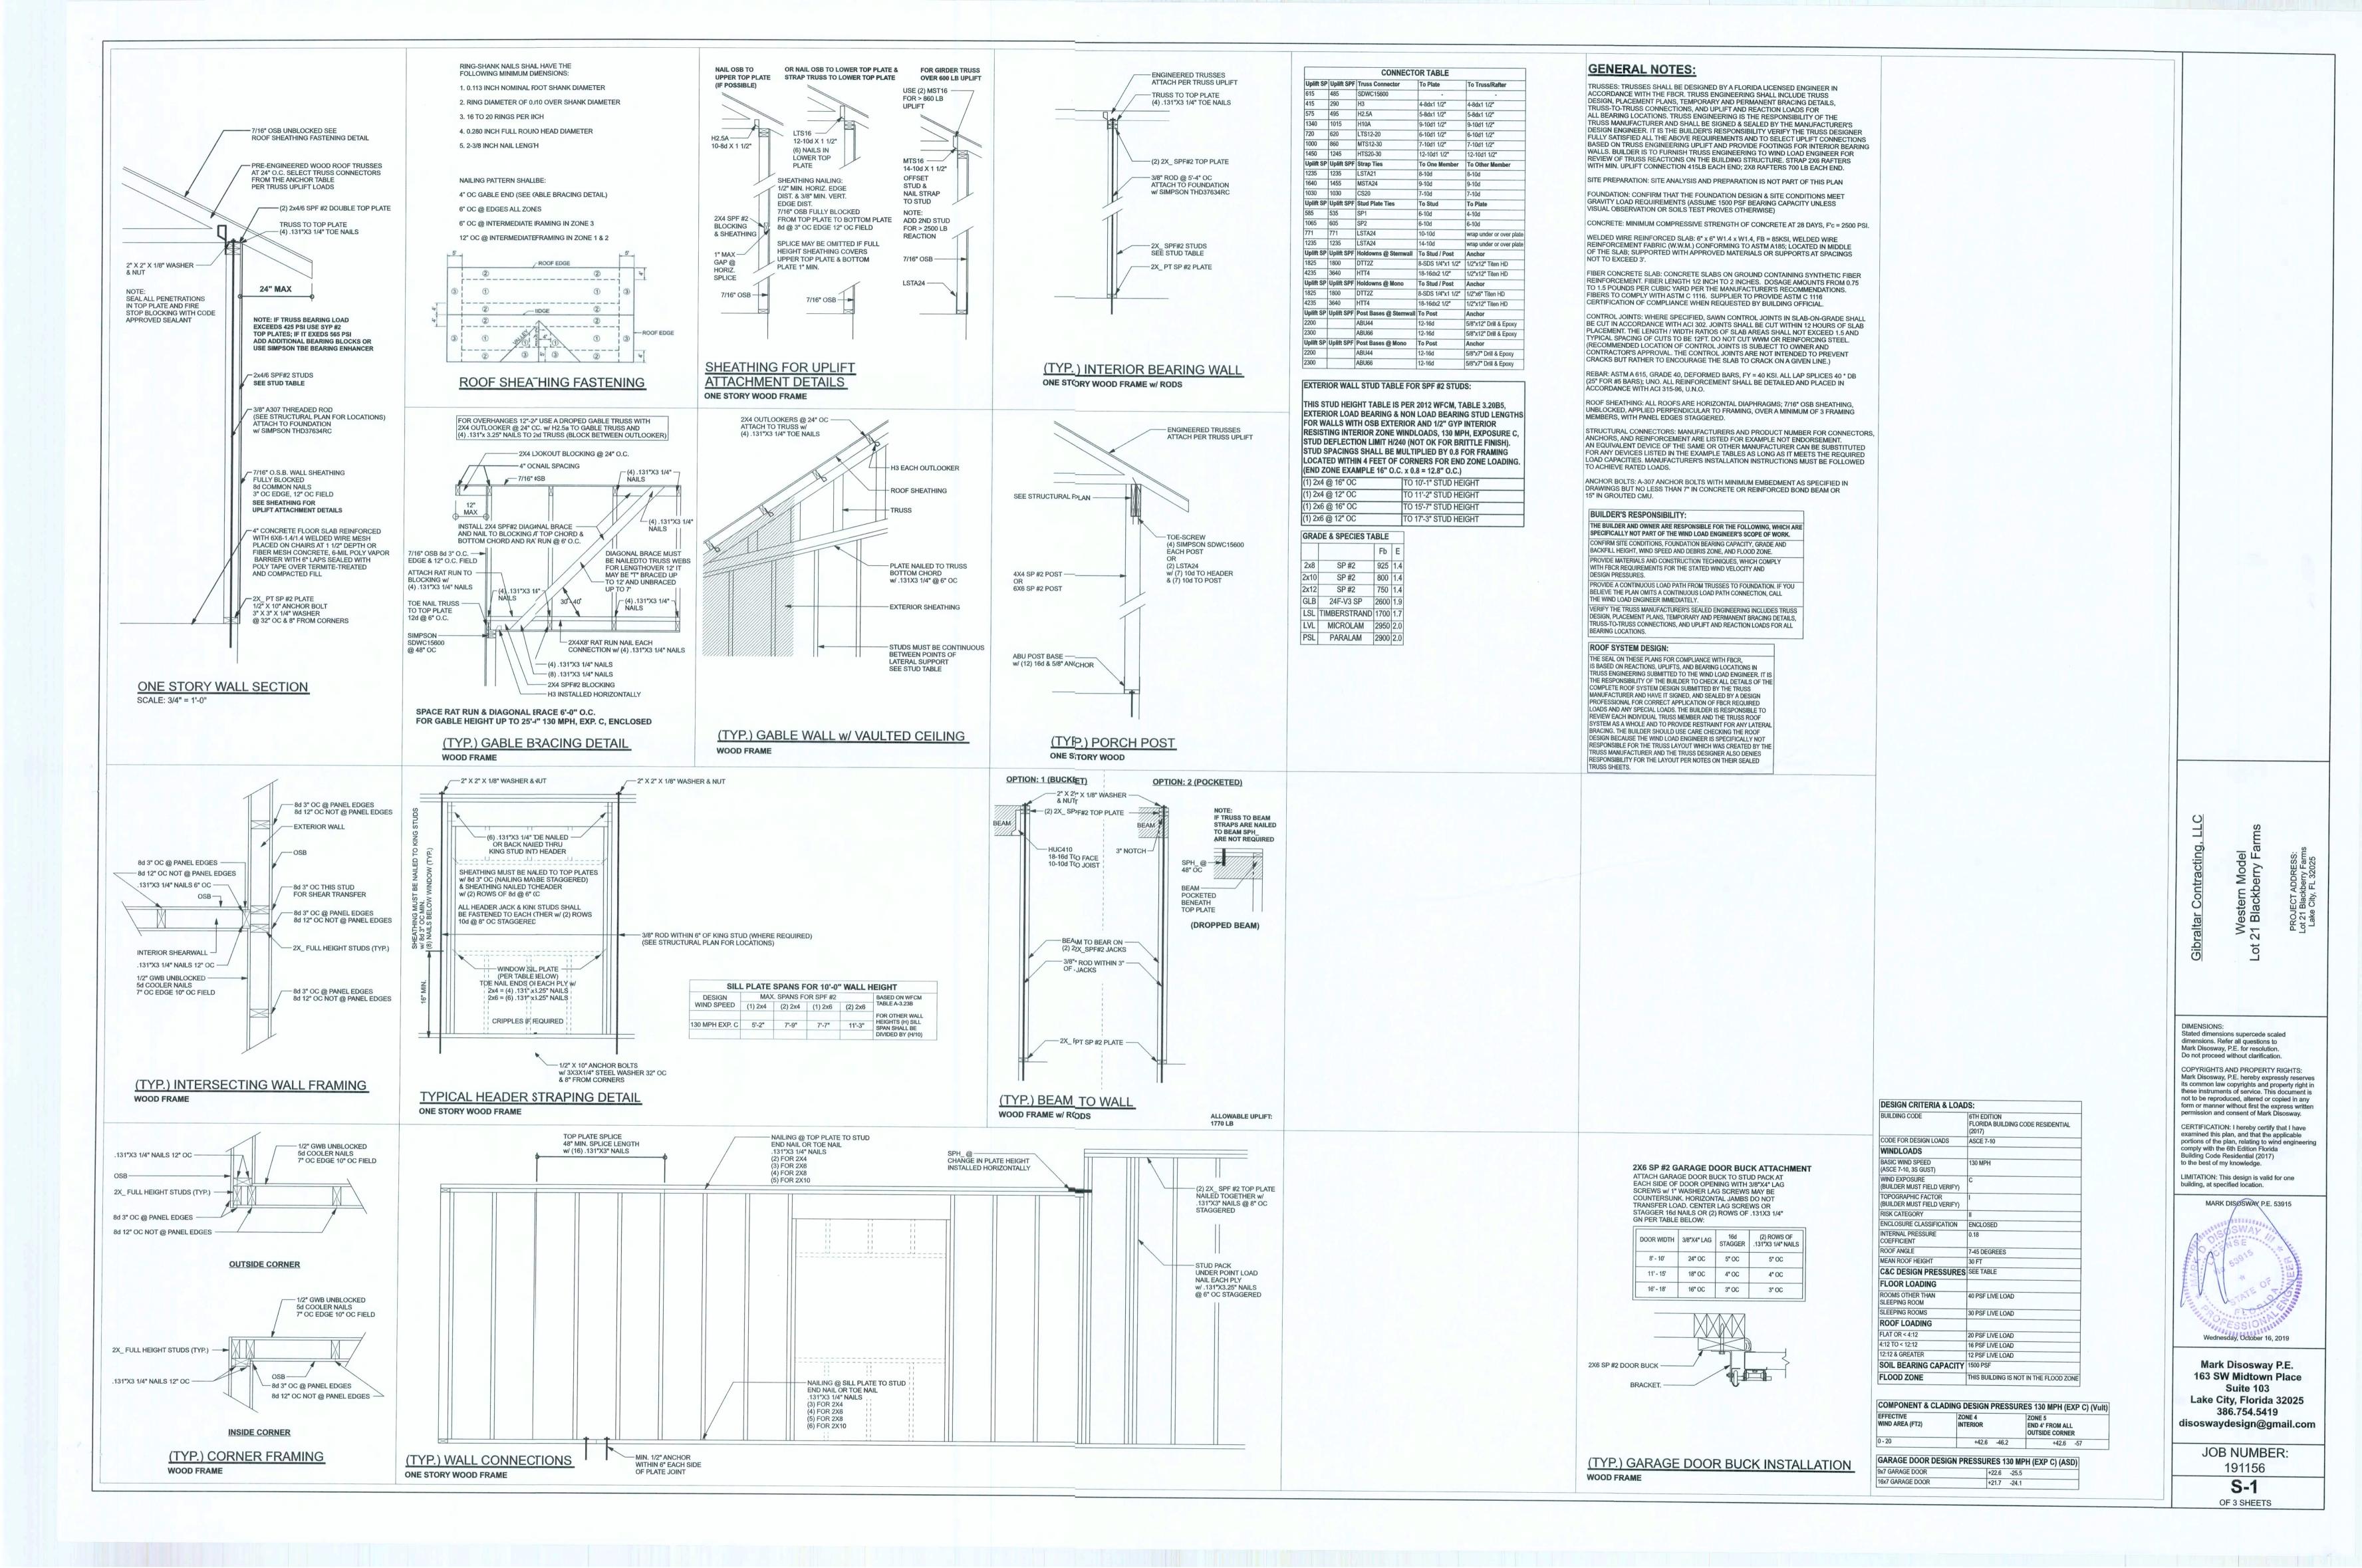LIMITATION: This design is valid for one bulding, at specified location.

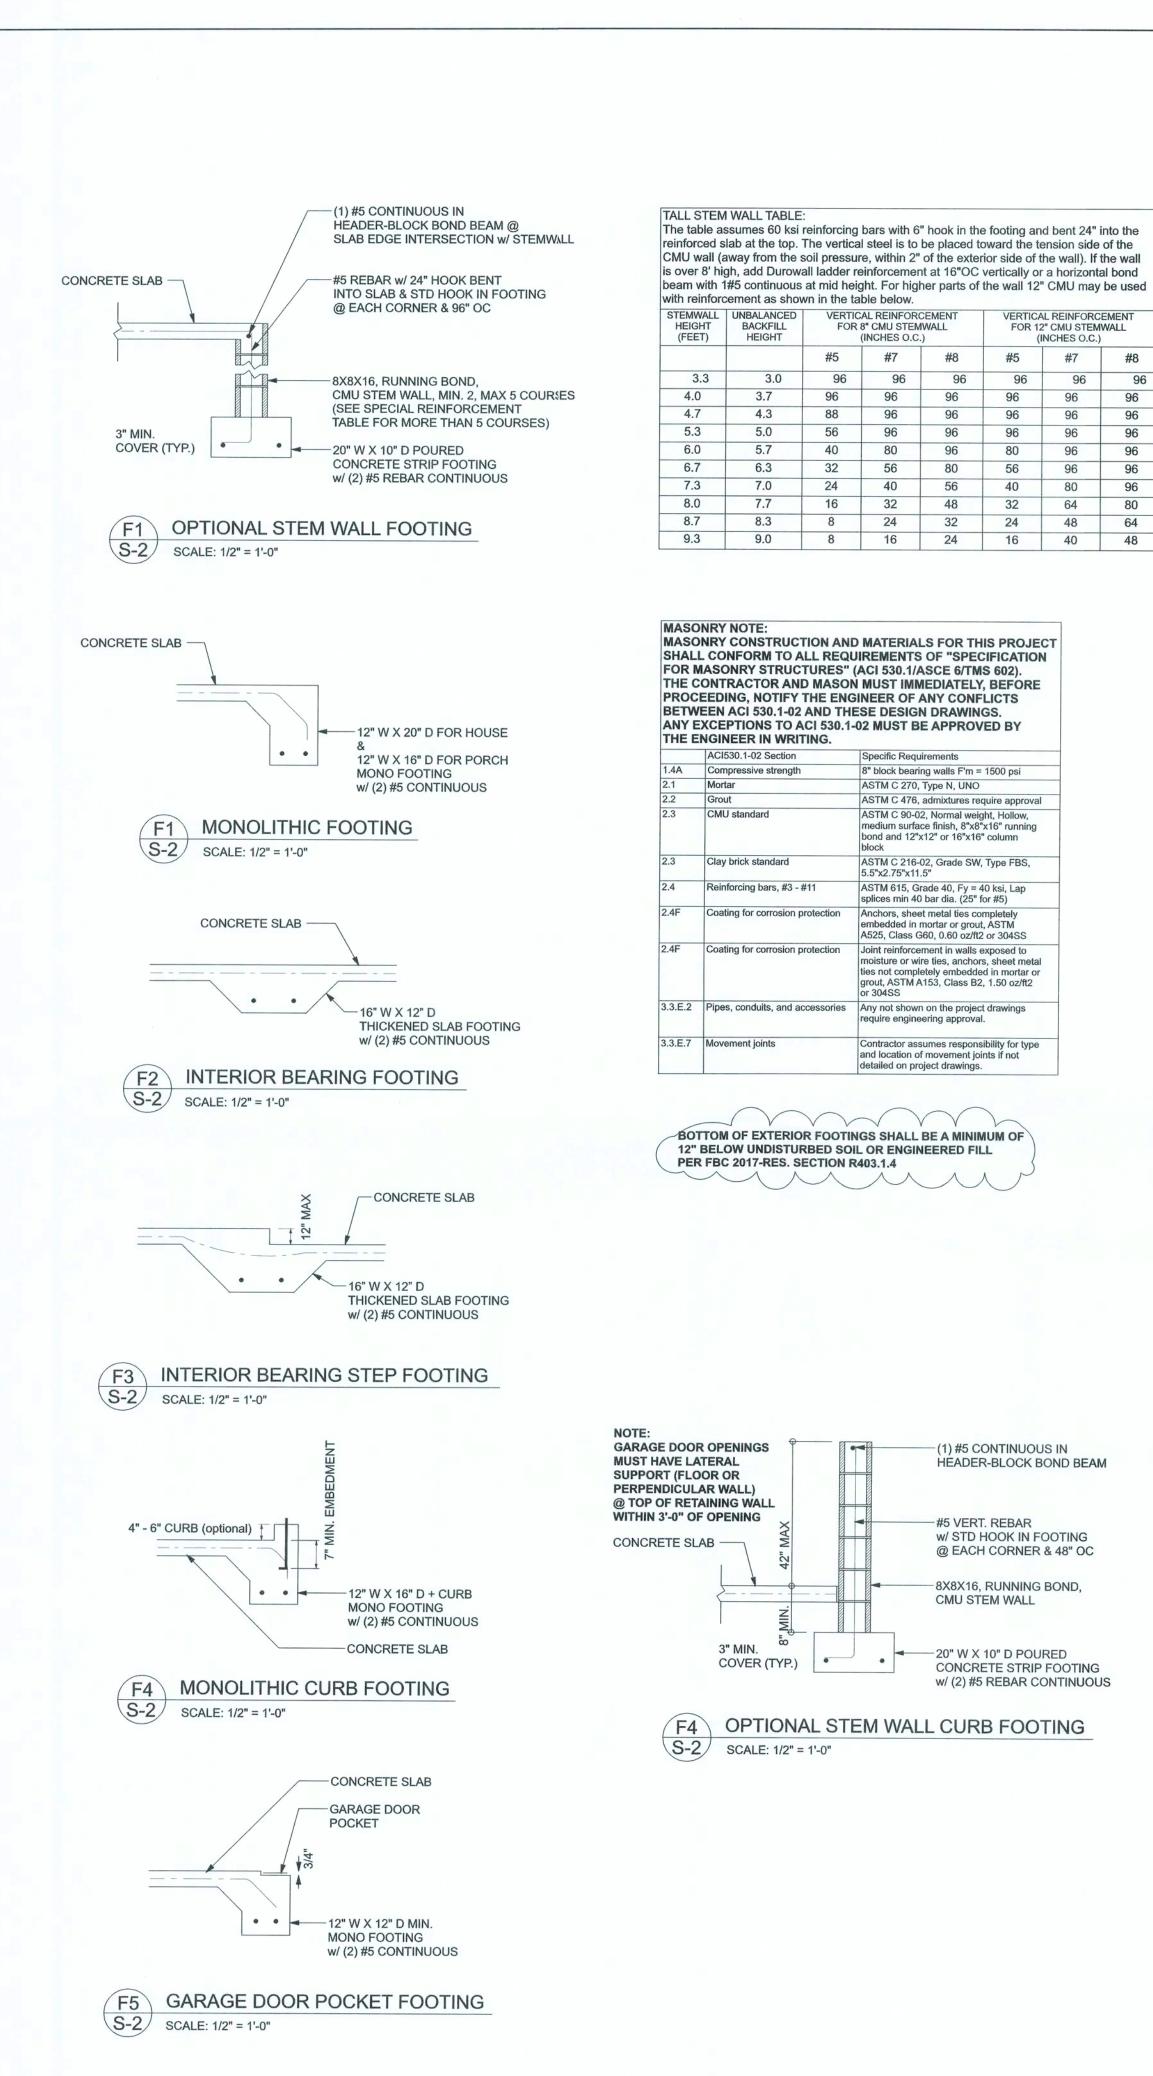
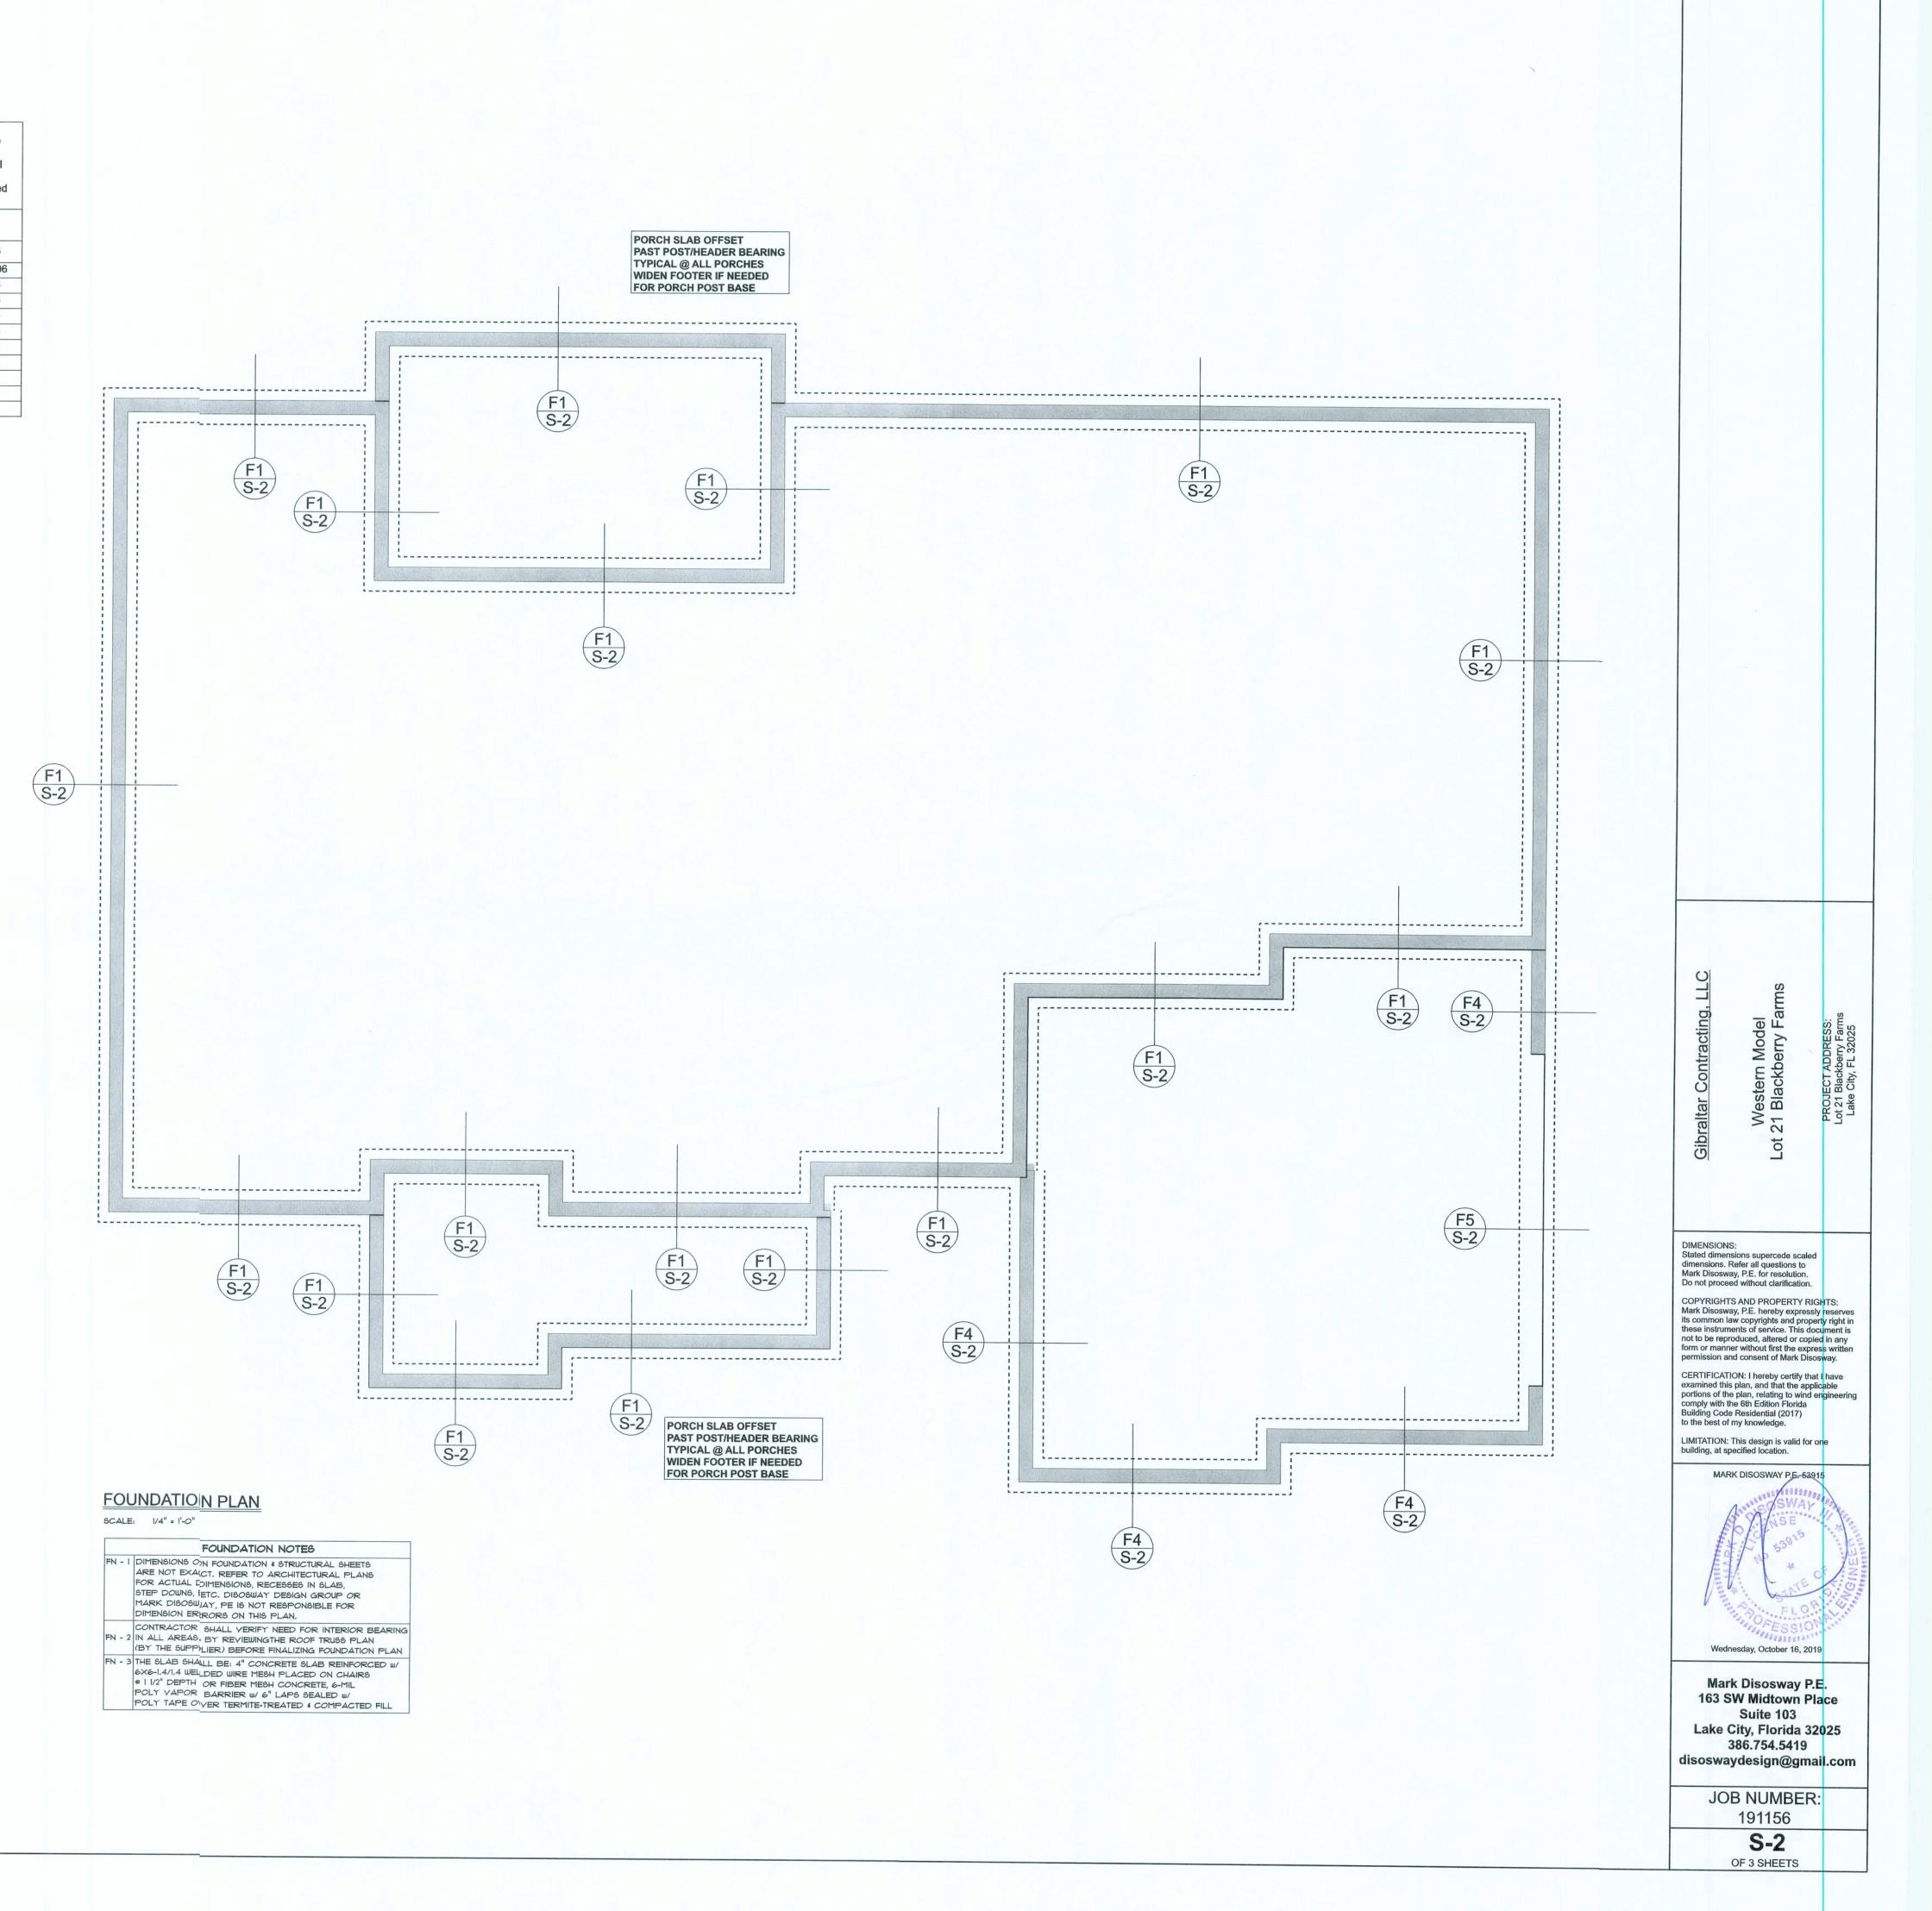
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> JOB NUMBER: 191156

S-3 OF 3 SHEETS