




### OPTIONAL STEM WALL FOOTING S-2 SCALE: 1/2" = 1'-0"

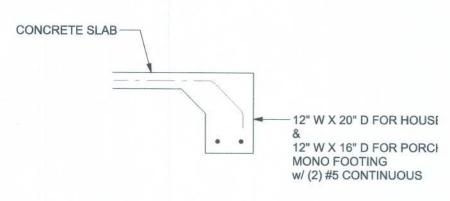


# MONOLITHIC FOOTING S-2 SCALE: 1/2" = 1'-0"

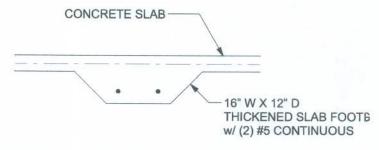


F2 INTERIOR BEARING FOOTING S-2 SCALE: 1/2" = 1'-0"

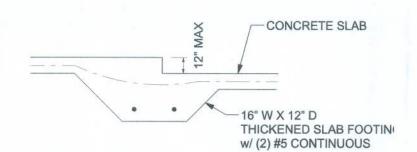

#### INTERIOR BEARING STEP FOOTING S-2 SCALE: 1/2" = 1'-0"

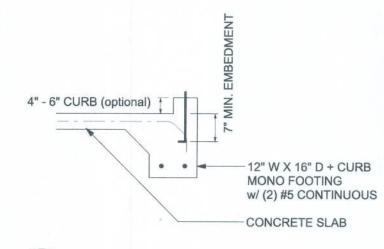

# F4 MONOLITHIC CURB FOOTING S-2 SCALE: 1/2" = 1'-0"

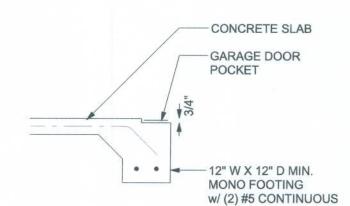


GARAGE DOOR POCKET FOOTING S-2 SCALE: 1/2" = 1'-0"

reinforced s CMU wall (a is over 8' hi	ssumes 60 ksi re slab at the top. T away from the so gh, add Durowal	he vertical oil pressure Il ladder re	steel is to be, within 2" inforcement	oe placed to of the exteri t at 16"OC	ward the te for side of the vertically or	nsion side ne wall). If t a horizonta	of the he wall I bond
		at mid height. For higher parts of in in the table below.  VERTICAL REINFORCEMENT FOR 8" CMU STEMWALL (INCHES O.C.)		VERTICAL REINFORCEMENT FOR 12" CMU STEMWALL (INCHES O.C.)			
		#5	#7	#8	#5	#7	#8
3.3	3.0	96	96	96	96	96	96
4.0	3.7	96	96	96	96	96	96
4.7	4.3	88	96	96	96	96	96
5.3	5.0	56	96	96	96	96	96
6.0	5.7	40	80	96	80	96	96
6.7	6.3	32	56	80	56	96	96
7.3	7.0	24	40	56	40	80	96
8.0	7.7	16	32	48	32	64	80
8.7	8.3	8	24	32	24	48	64
9.3	9.0	8	16	24	16	40	48


	TION AND MATERIALS FOR THIS PROJECT	ī
SHALL CONFORM T	ALL REQUIREMENTS OF "SPECIFICATION	
FOR MASONRY STR	TURES" (ACI 530.1/ASCE 6/TMS 602).	
	D MASON MUST IMMEDIATELY, BEFORE	
	THE ENGINEER OF ANY CONFLICTS	
BETWEEN ACI 530.1	AND THESE DESIGN DRAWINGS.	
	ACI 530.1-02 MUST BE APPROVED BY	
ACI530.1-02 Sect	Specific Requirements	_

	ACI530.1-02 Section	Specific Requirements
1.4A	Compressive strength	8" block bearing walls F'm = 1500 psi
2.1	Mortar	ASTM C 270, Type N, UNO
2.2	Grout	ASTM C 476, admixtures require approval
2.3	CMU standard	ASTM C 90-02, Normal weight, Hollow, medium surface finish, 8"x8"x16" running bond and 12"x12" or 16"x16" column block
2.3	Clay brick standard	ASTM C 216-02, Grade SW, Type FBS, 5.5"x2.75"x11.5"
2.4	Reinforcing bars, #3 - #11	ASTM 615, Grade 40, Fy = 40 ksi, Lap splices min 40 bar dia. (25" for #5)
2.4F	Coating for corrosion protection	Anchors, sheet metal ties completely embedded in mortar or grout, ASTM A525, Class G60, 0.60 oz/ft2 or 304SS
2.4F	Coating for corrosion protection	Joint reinforcement in walls exposed to moisture or wire ties, anchors, sheet metal ties not completely embedded in mortar or grout, ASTM A153, Class B2, 1.50 oz/ft2 or 304SS
3.3.E.2	Pipes, conduits, and accessories	Any not shown on the project drawings require engineering approval.
3.3.E.7	Movement joints	Contractor assumes responsibility for type and location of movement joints if not detailed on project drawings.

# BOTTOM OF EXTERIOR FOOTINGS SHALL BE A MINIMUM OF 12" BELOW UNDISTURBED SOIL OR ENGINEERED FILL

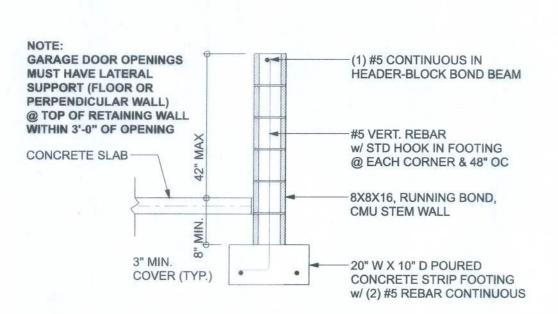

OPTIONAL STEM WALL CURB FOOTING S-2 SCALE: 1/2" = 1'-0"

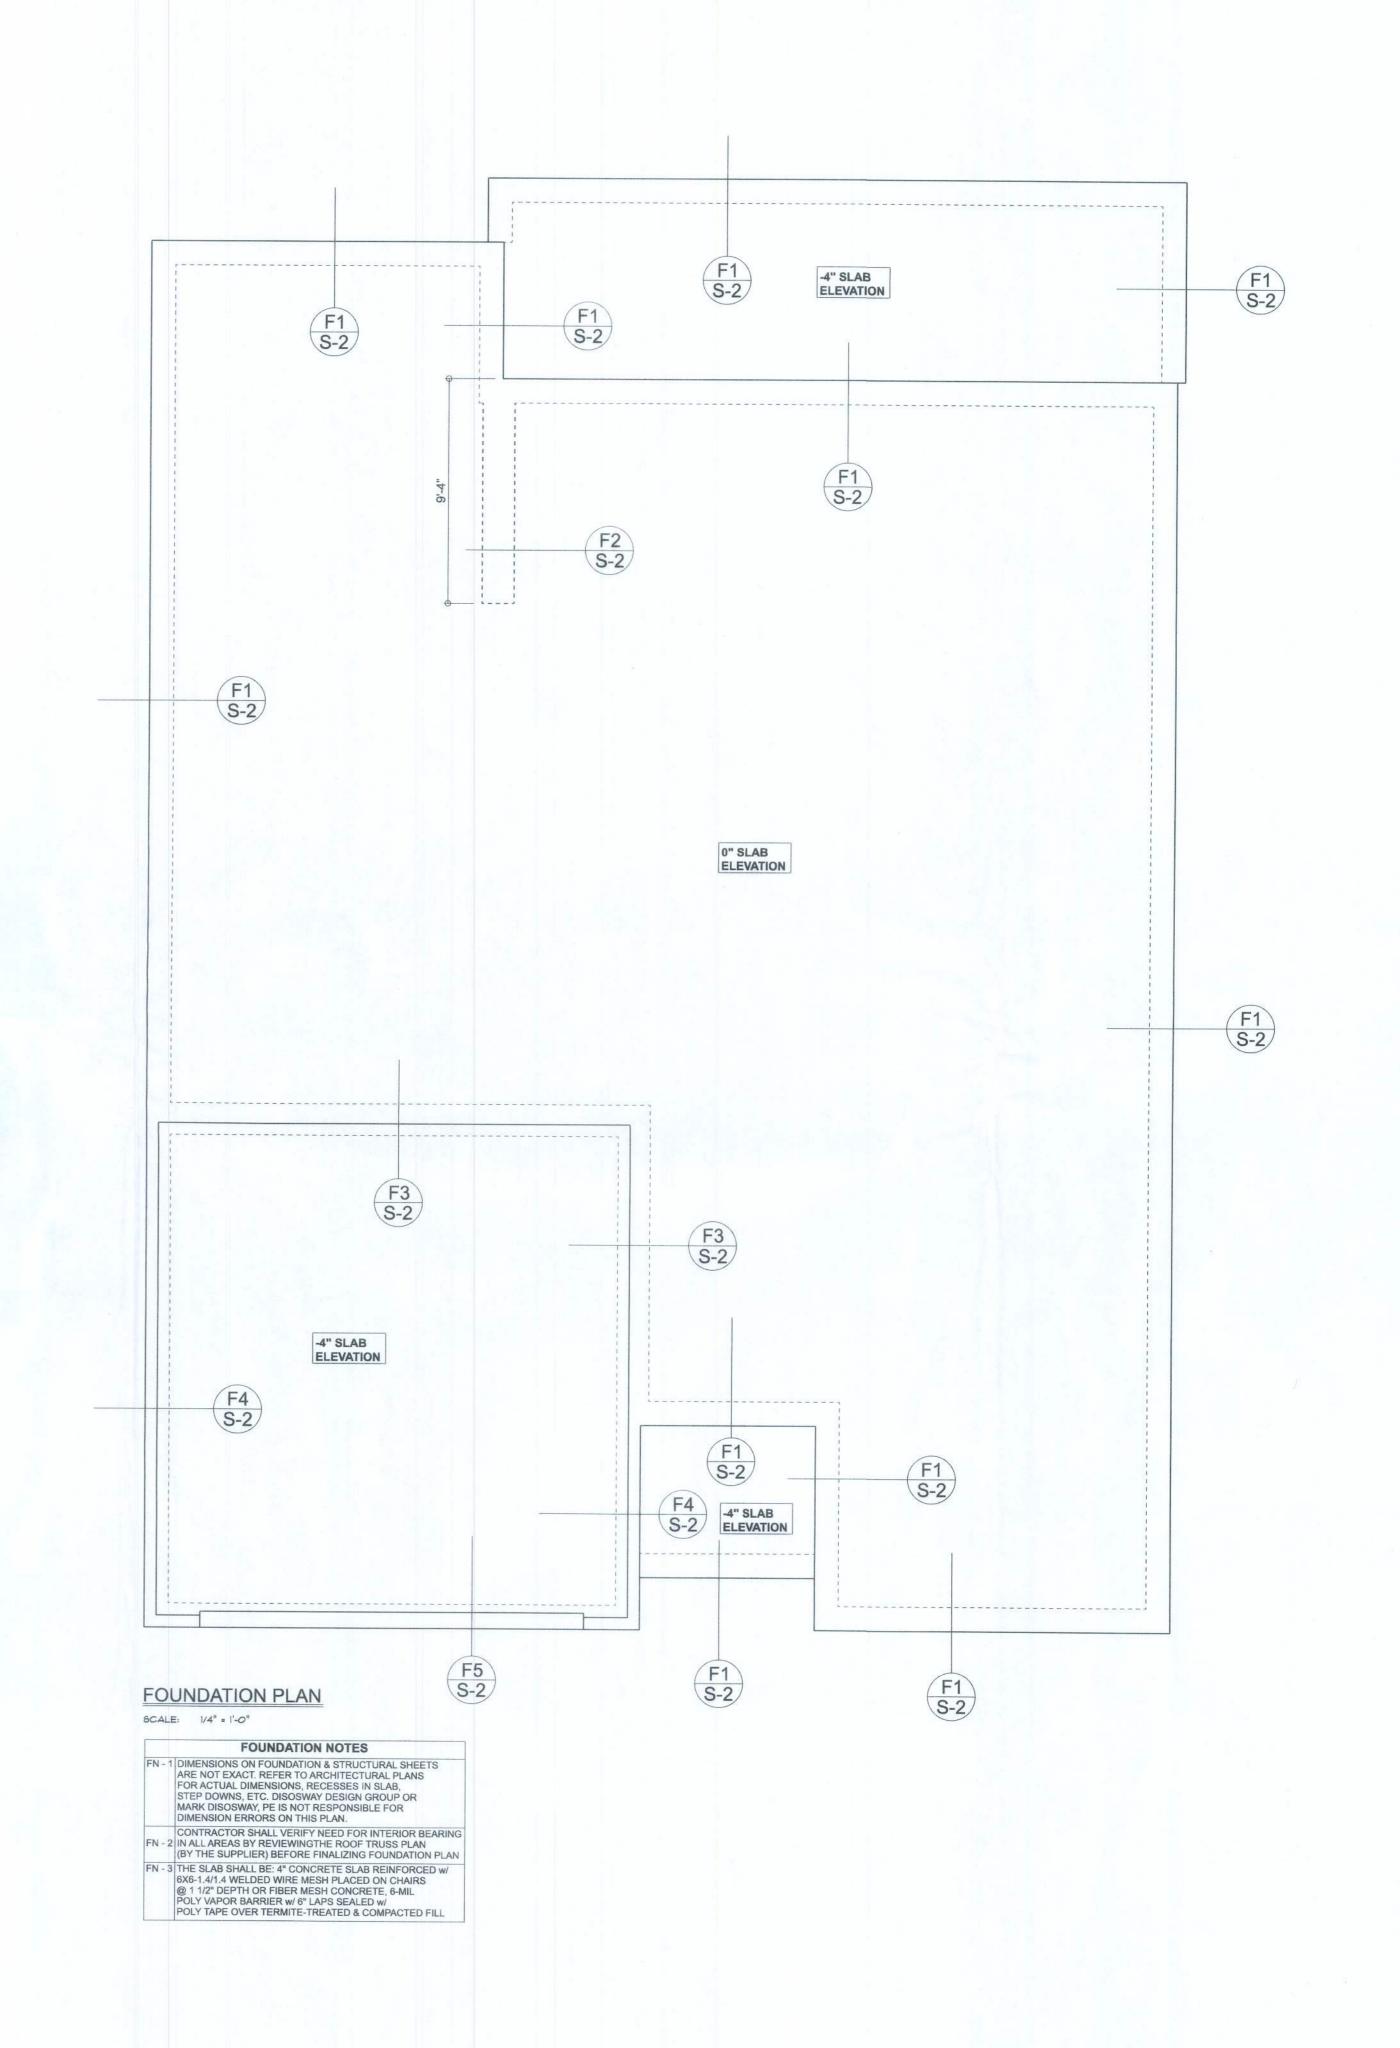

Stated dimensions upercede scaled dimensions. Refer Il questions to Mark Disosway, P.E for resolution. Do not proceed witbut clarification. COPYRIGHTS ANI PROPERTY RIGHTS:

Mark Disosway, P.E hereby expressly reserves its common law coprights and property right in these instruments c service. This document is not to be reproduce, altered or copied in any form or manner witbut first the express written permission and conent of Mark Disosway. CERTIFICATION: Liereby certify that I have examined this plan, and that the applicable portions of the plan relating to wind engineering comply with the 7th-Edition Florida Building Code Resiential (2020)

to the best of my knwledge. LIMITATION: This design is valid for one building, at specific location.


MARK DISDSWAY P.E. 53915 Wednesay, May 5, 2021

Mark Dsosway P.E.


163 SW Midtown Place Stite 103 Lake City Florida 32025 386754.5419 disoswaydesign@gmail.com

> JOB NUMBER: 210665

> > 5-2 OF (SHEETS

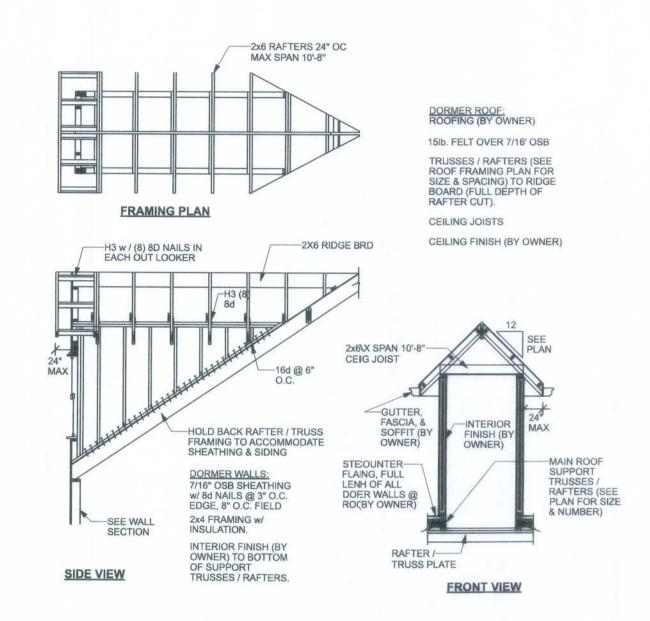

DORMER ANCHORING DETAILON ROOF)
SCALE: N.T.S.

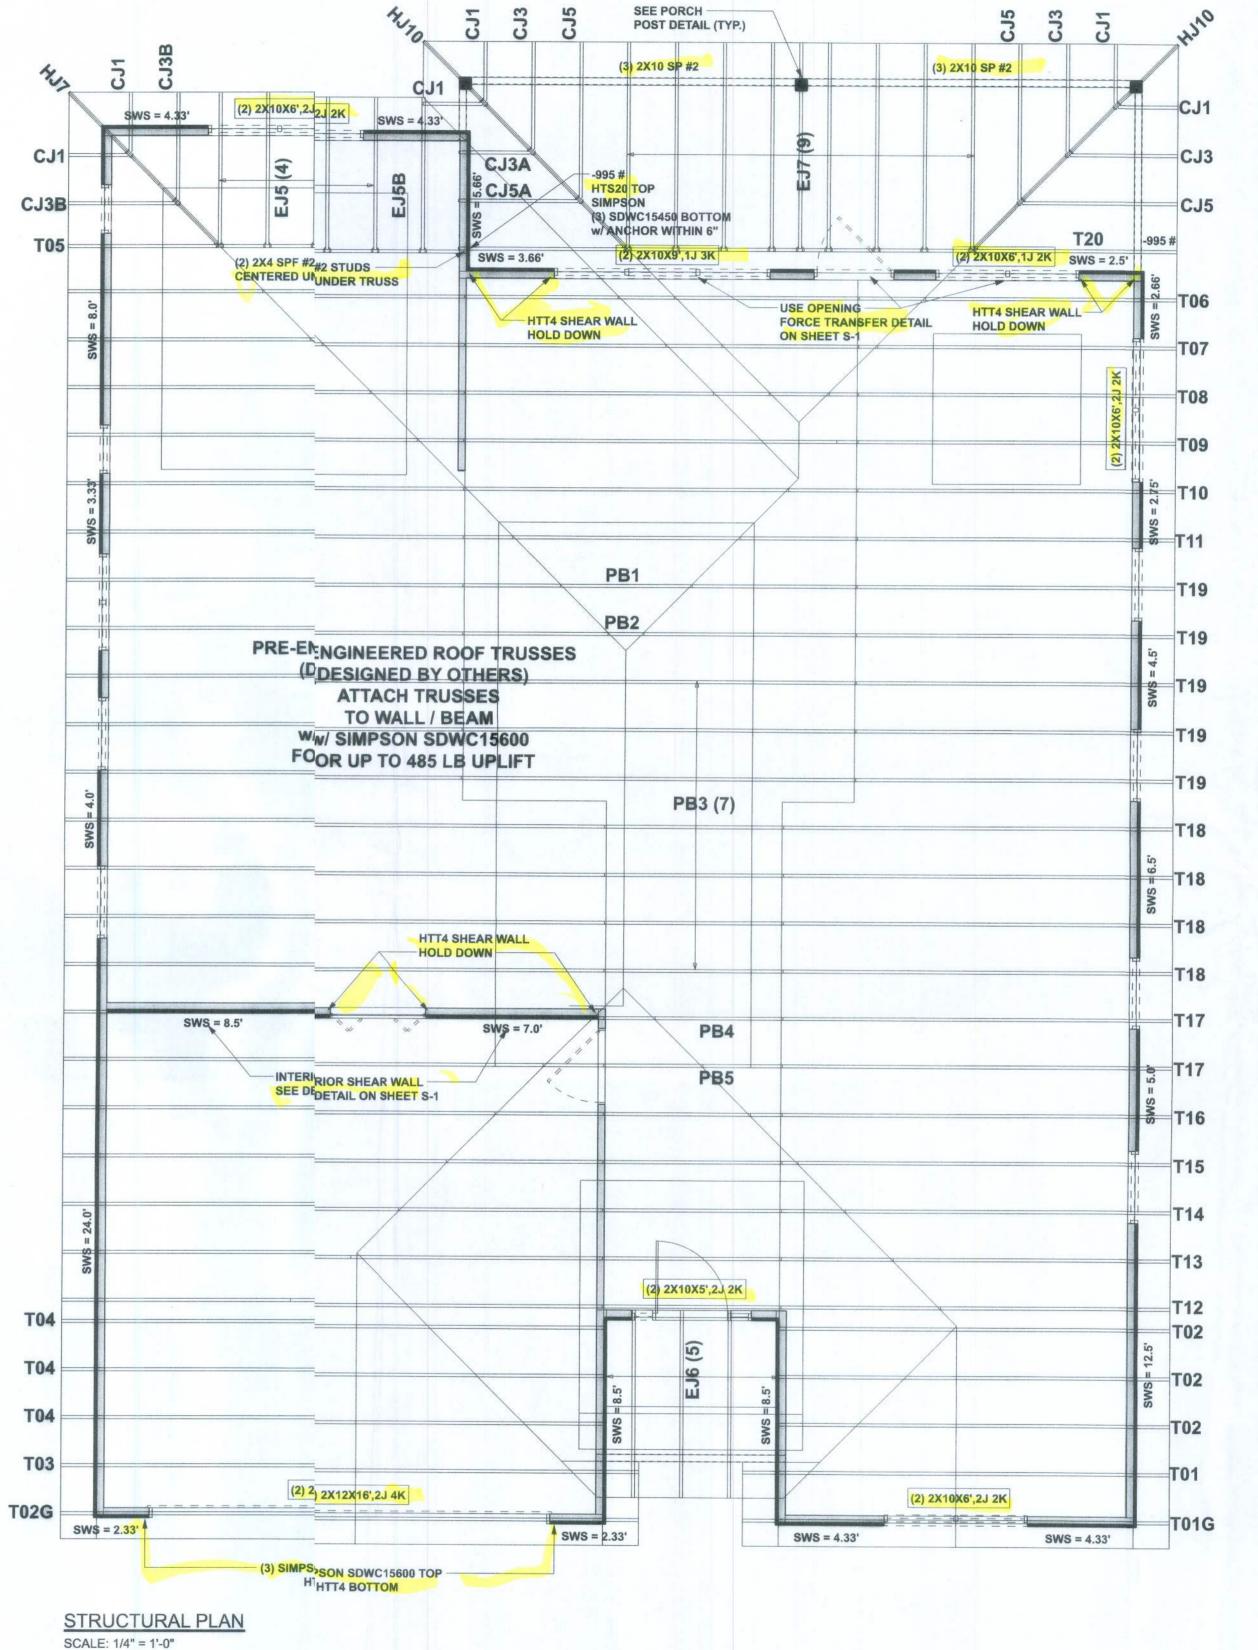

# STRUCTURAL PLAN NOTES

SN-1 ALL LOAD BEARING FRAME WALL & PORCH HEADERS SHALL BE A MINIMUM OF (2) 2X10 SP #2 (U.N.O.)

SN-2 ALL LOAD BEARING FRAME WALL HEADERS SHALL HAVE (1) JACK STUD & (1) KING STUD

EACH SIDE (U.N.O.)

SN-3 USE ONE JACK STUD GIRDER SUPPORT PER 2500 LB LOAD


SN-4 DIMENSIONS ON STRUCTURAL SHEETS ARE NOT EXACT. REFER TO ARCHITECTURAL FLOOR PLAN FOR ACTUAL DIMENSIONS

SN-5

PERMANENT TRUSS BRACING IS TO BE INSTALLED AT LOCATIONS AS SHOWN ON THE SEALED TRUSS DRAWINGS.

LATERAL BRACING IS TO BE RESTRAINED PER BCSI1-03, BCSI-B1, BCSI-B2, & BCSI-B3. BCSI-B1, BCSI-B2, & BCSI-B3 ARE FURNISHED BY THE TRUSS SUPPLIER, WITH THE SEALED TRUSS PACKAGE

## **HEADER LEGEND**

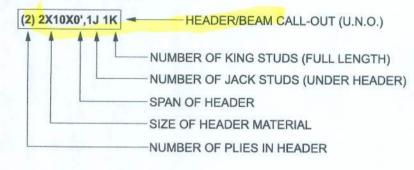

# ACTUAL vs REQUIRED SHEARWALL TRANSVERSE LONGITUDUNAL ACTUAL 17456 LBF 23016 LBF REQUIRED 14466 LBF 8924 LBF

CONNECTIONS, WALL, & HEADER DESIGN IS BASED ON REACTIONS & UPLIFTS FROM TRUSS ENGINEERING FURNISHED BY BUILDER. BUILDERS FIRST SOURCE JOB #1047051

- Lot 147 The Preserves

DIMENSIONS: Stated dimensions upercede scaled dimensions. Refer a questions to Mark Dissoway, P.Efor resolution.

Do not proceed witbut clarification.

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permission and conent of Mark Disosway.

CERTIFICATION: Hereby certify that I have examined this plan, and that the applicable portions of the plan, relating to wind engineering comply with the 7th Edition Florida Building Code Resiential (2020) to the best of my knwledge.

LIMITATION: This disign is valid for one building, at specifie location.





Wednesay, May 5, 2021

Mark Disosway P.E. 163 SW Nidtown Place Suite 103 Lake City,Florida 32025 386/54.5419 disoswaydesign@gmail.com

JOB NUMBER: 210665

OF SHEETS

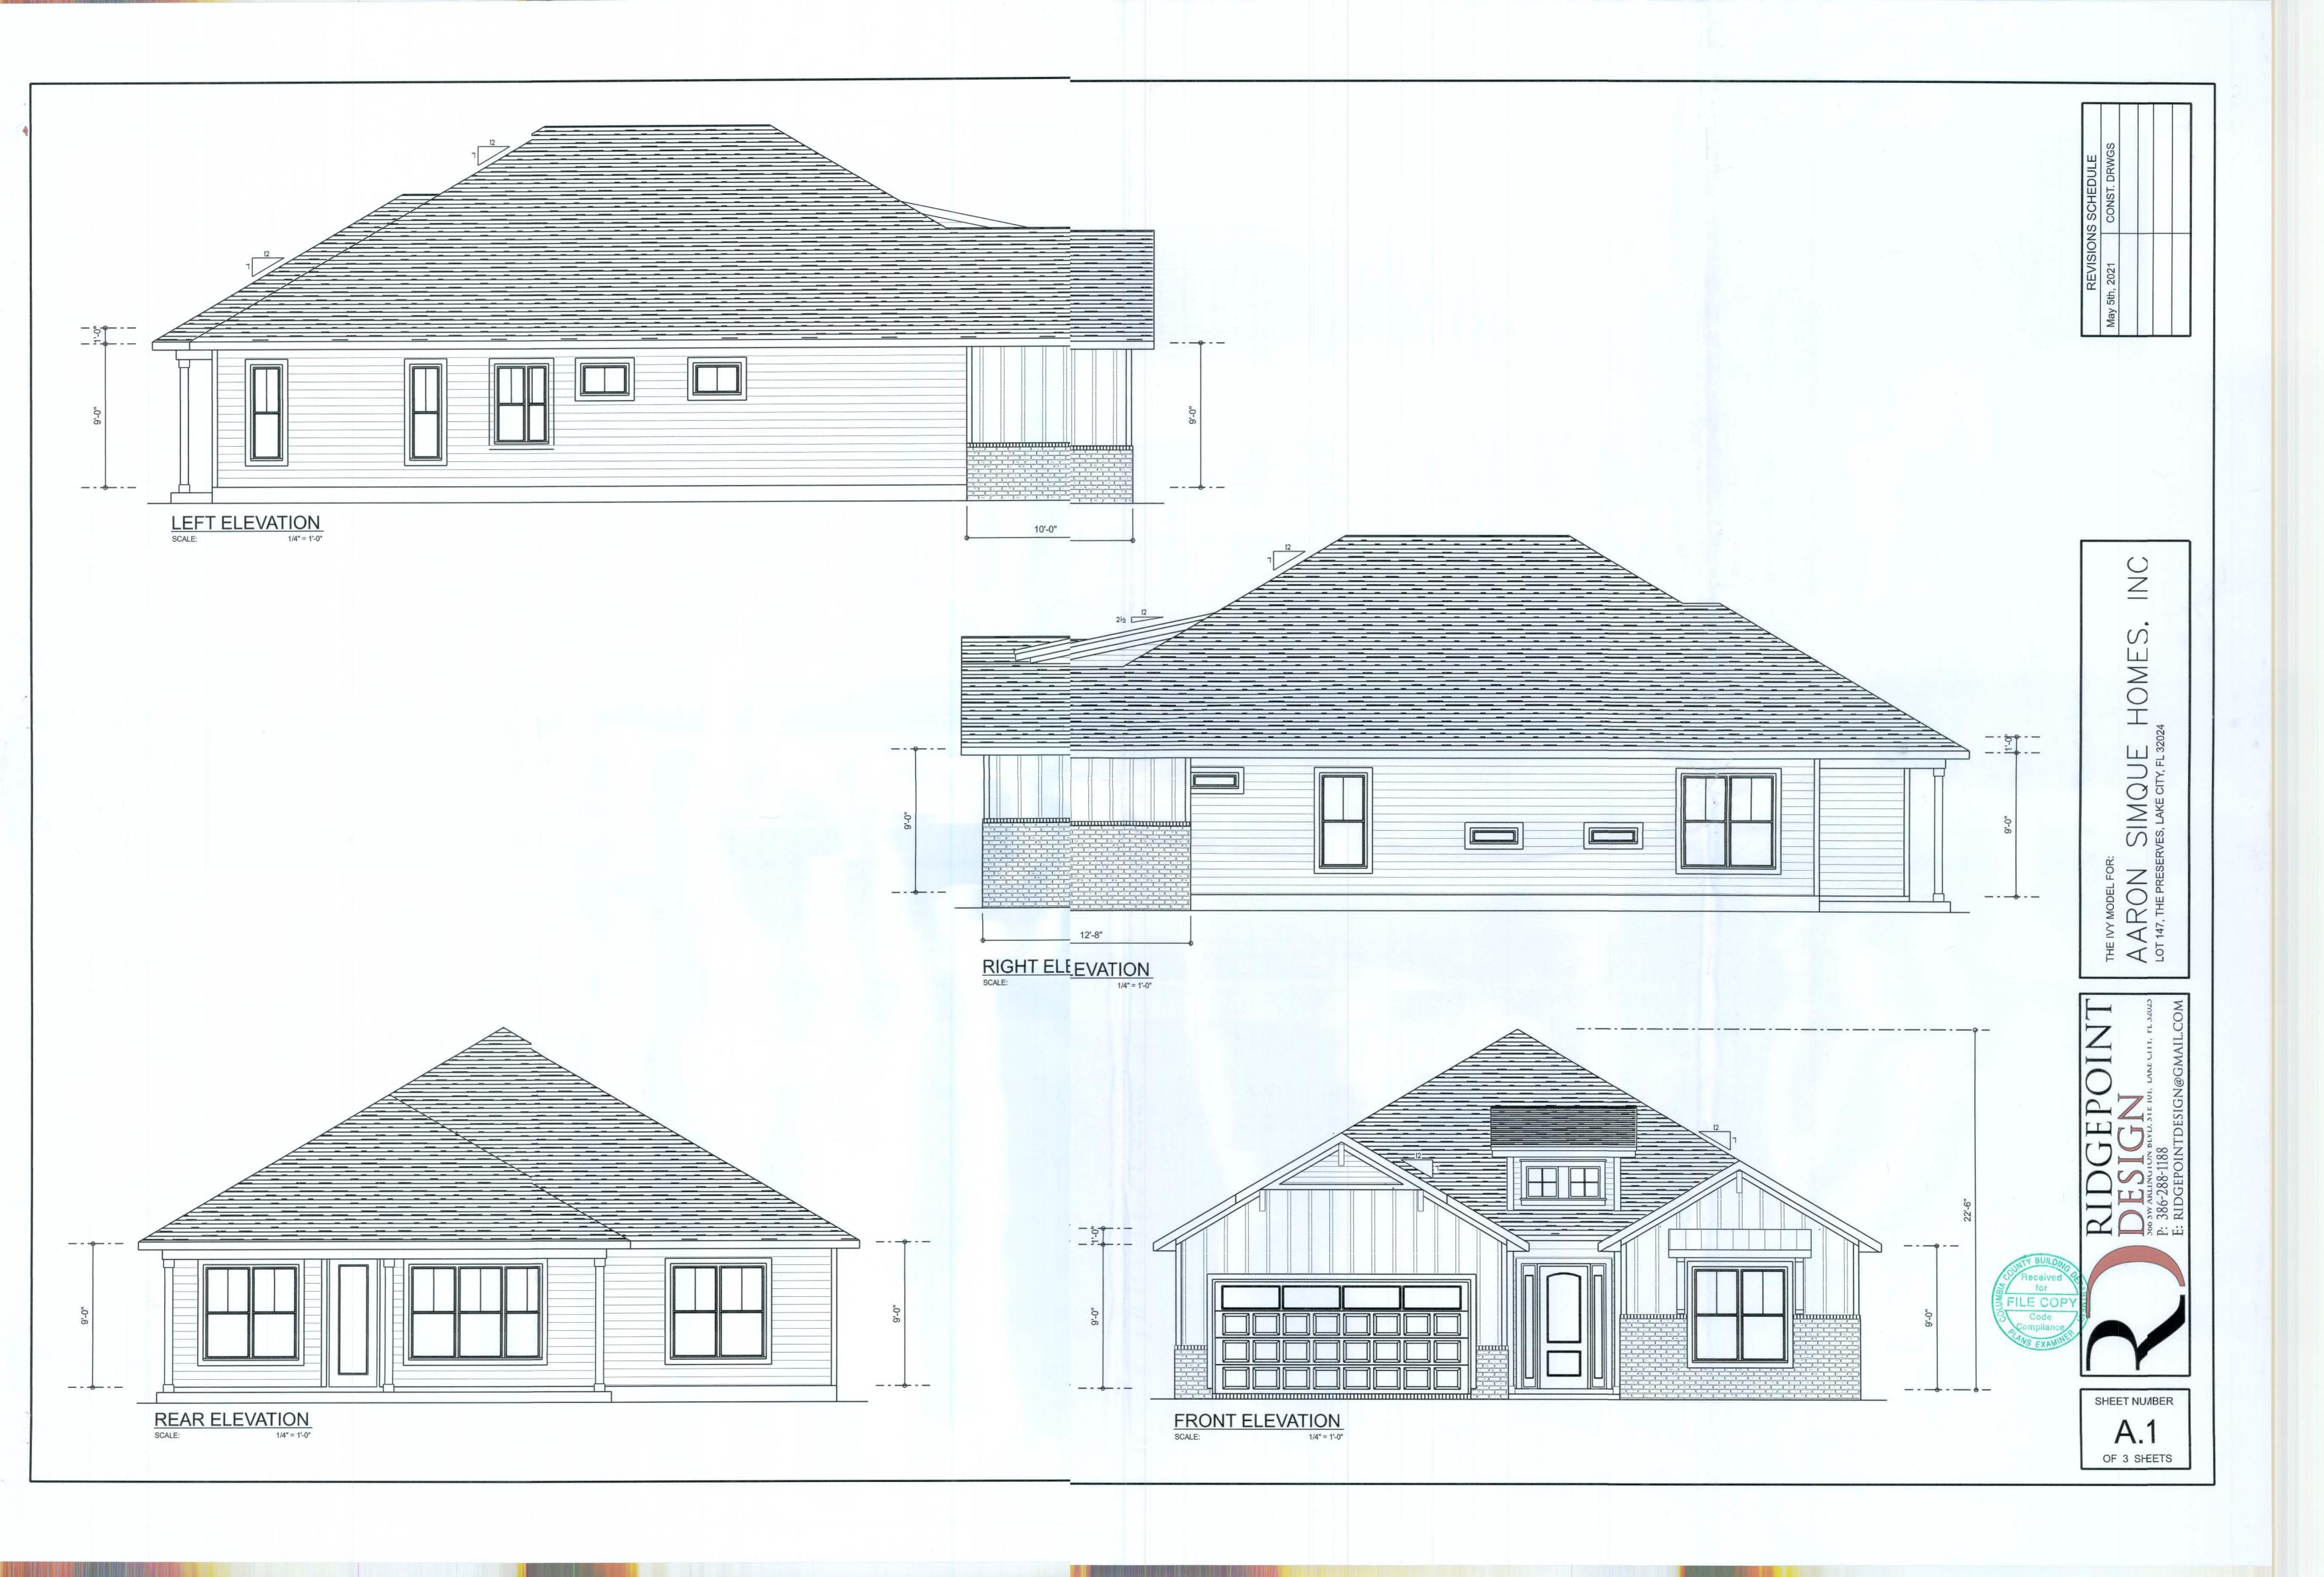


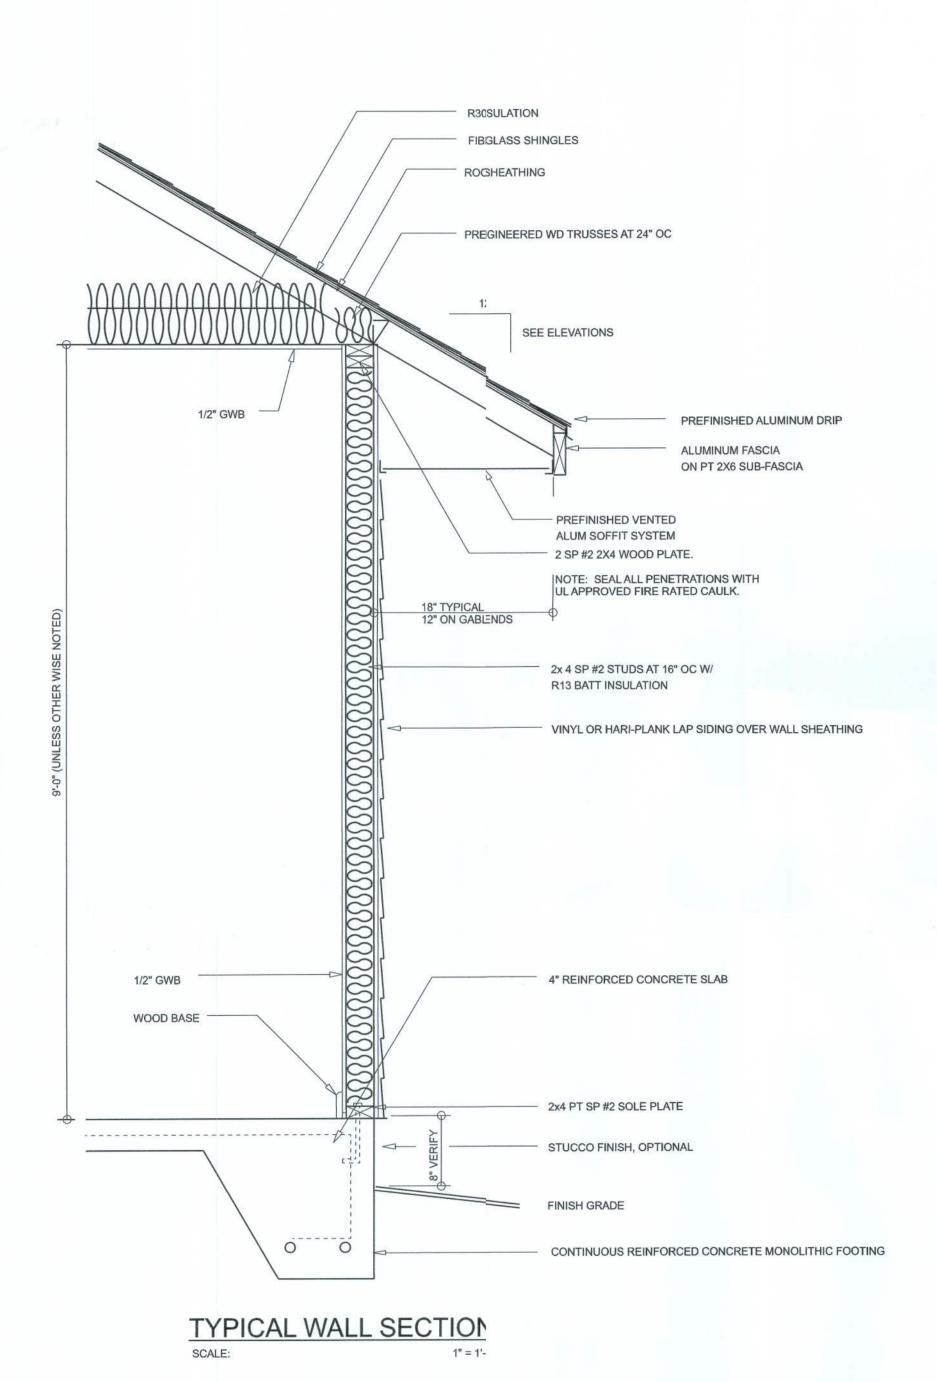


AREA SUMMARY

		3 8 8
HEATED & COOLED	1,807	S.F.
ENTRY PORCH	38	S.F.
REAR COVERED PORCH	226	S.F.
GARAGE	441	S.F.
TOTAL AREA	2,512	S.F.

TOTAL CUBIC FOOTAGE OF CONDITIONED SPACE IS: 16,263

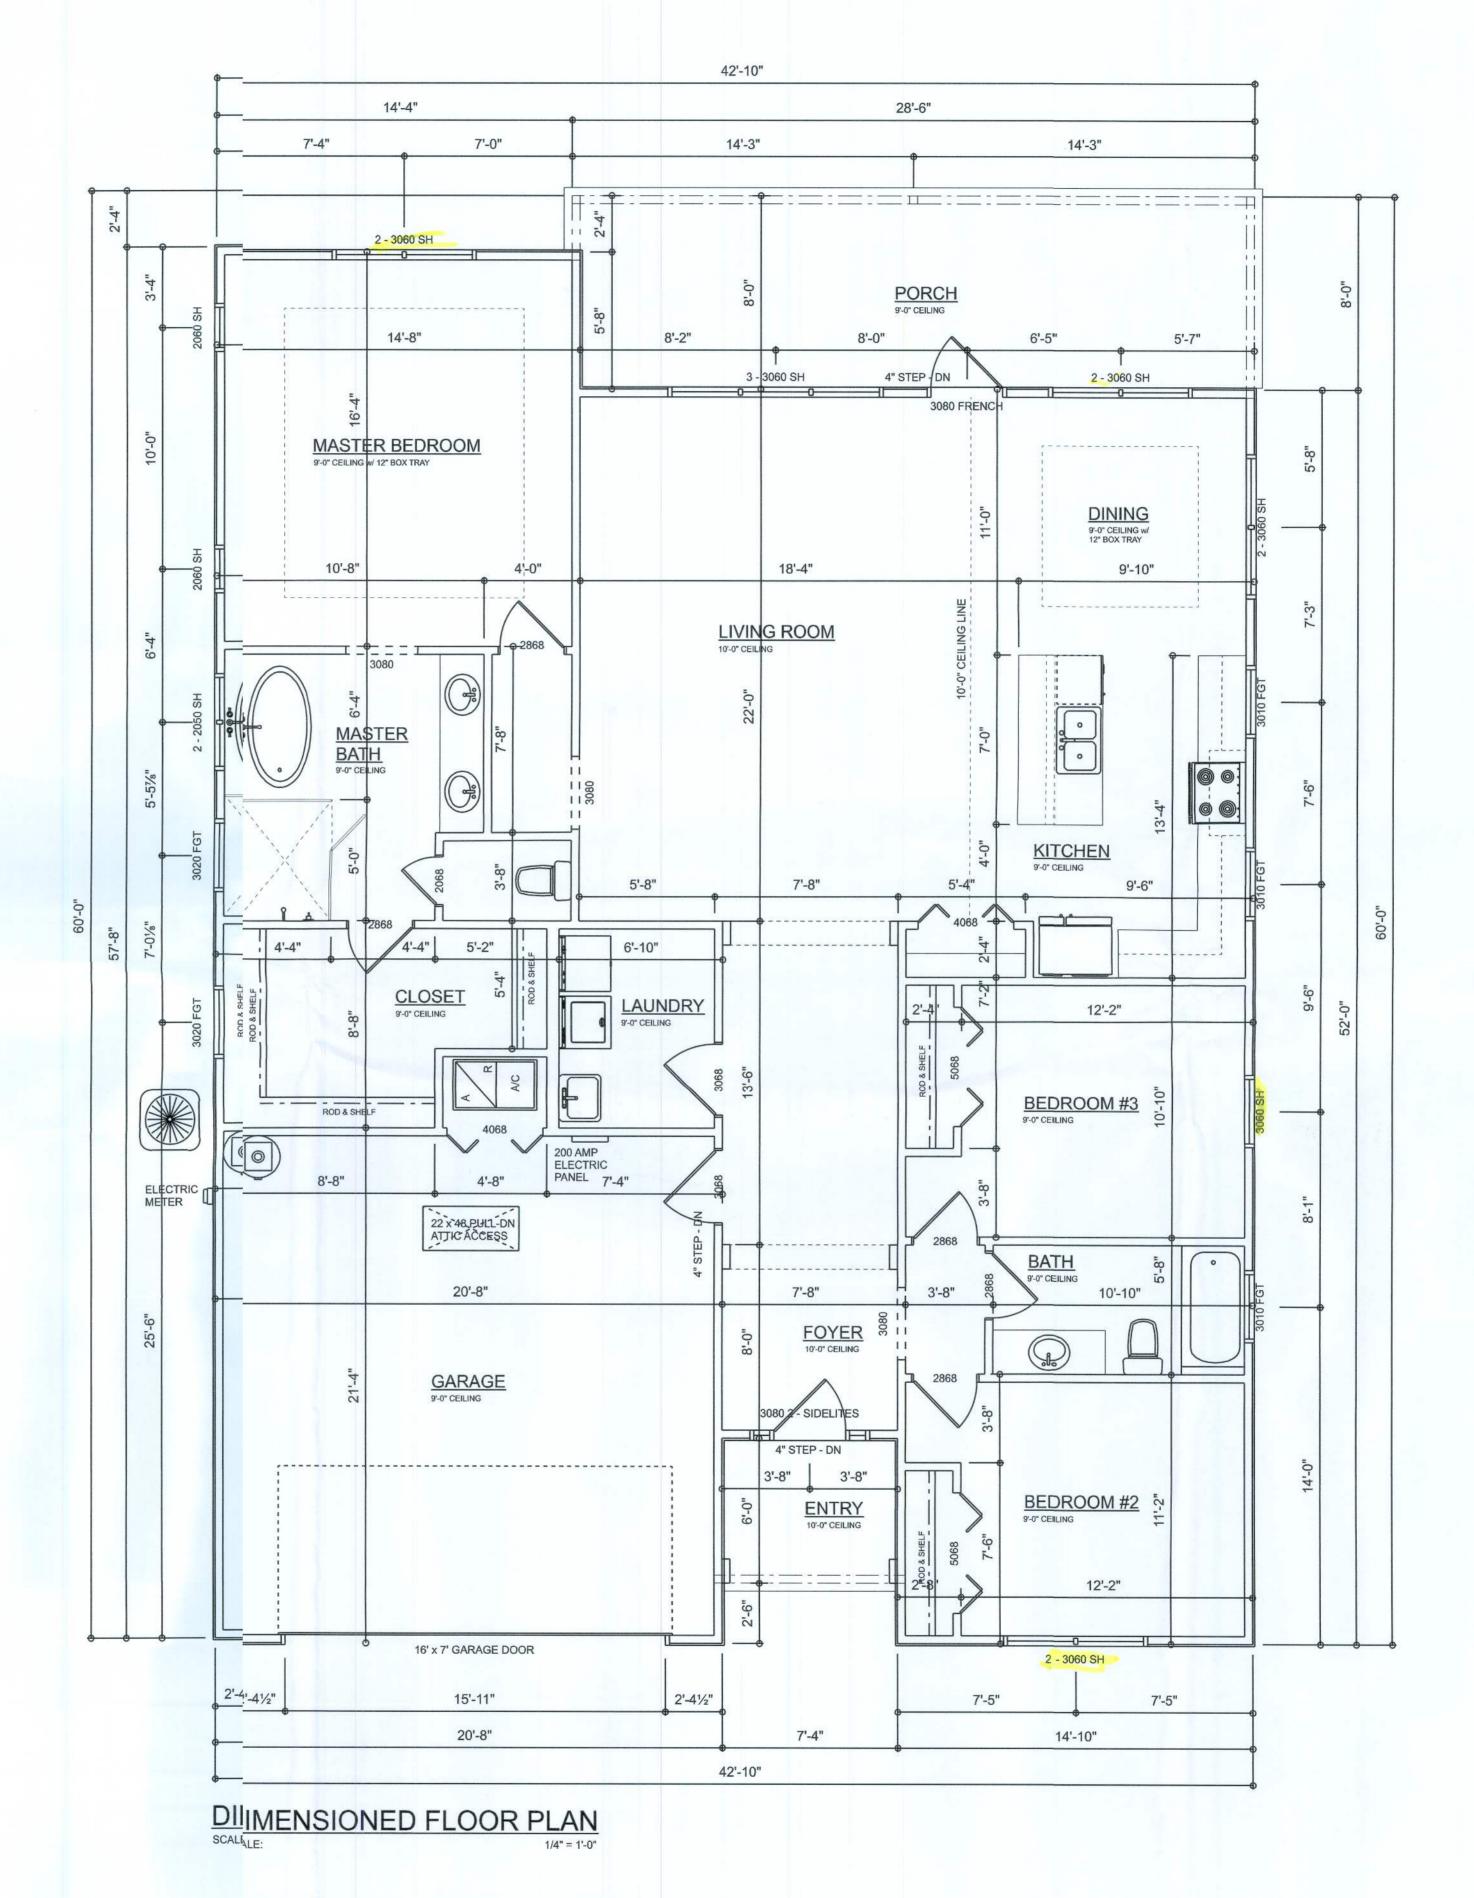


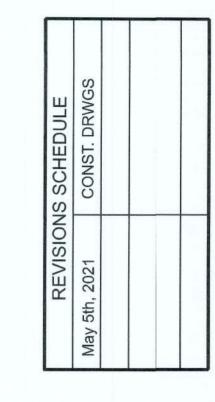

THE IVY MODEL FOR:

AARON SIMQUE HOMES, INC

LOT 147, THE PRESERVES, LAKE CITY, FL 32024

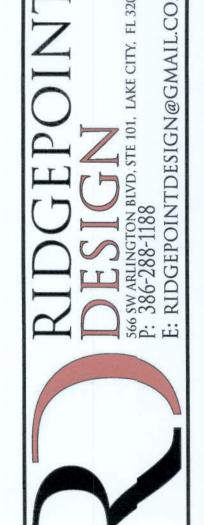

SHEET NUMBER

A.2

OF 3 SHEETS

ELECTRICALEGEND						
ELECTRICAL COUNT SYMBOL						
		STINDOL				
ceiling fan 4 bladed 01	1 6					
can light 6inch	27	0				
ceiling light 14	3	000				
fluorescent light 1 x 4	2					
pendant cube	3	0				
exterior light 02	2	Ø				
spotlight double	4	₫₽				
electrical meter	1	8				
cable tv outlet	4	τν				
fan	3	₩				
light	6	<b></b>				
outlet	24	Ф				
outlet 220v	4	Ф				
outlet gfi	15	Дея				
outlet wp	3	Øw₽.				
smoke detector	5	•				
switch	30	\$				
switch 3 way	12	\$3				
vanity bar light 02	3	000				

# ELECTRICAL PLAN NOTES

INSTALLATION SHALL BE PER LATEST NA. ELECTRIC CODE.

WIRE ALL APPLIANCES, HVAC UNITS ANDTHER EQUIPMENT PER MANUF. SPECIFICATIONS

CONSULT WITH THE OWNER FOR THE NUBER OF SEPERATE TELEPHONE LINES TO BE INSTALLED

ALL SMOKE DETECTORS SHALL BE 120v 1 BATTERY BACKUP OF THE PHOTOELECTRIC TYPE,ND SHALL BE INTERLOCKED TOGETHER. INSTALL INDE AND NEAR ALL BEDROOMS

TELEPHONE, TELEVISION AND OTHER LO VOLTAGE DEVICES OR OUTLETS SHALL BE AS PERHE OWNER'S DIRECTIONS, & IN ACCORDANCE W/ APPCABLE SECTIONS OF NEC-LATEST EDITION.


ALL RECEPTICALS, NOT OTHERWISE NO.D, SHALL BE ARC FAULT INTERRUPTER TYPE, EXCEPT DECATED OUTLETS

ALL RECEPTICALS IN WET AREAS SHALLE GROUND FAULT INTERRUPTER TYPE (GFI)


ALL EXTERIOR RECEPTICALS SHALL BE FATHERPROOF GROUD FAULT INTERRUPTER TYPE (WP/FI)

ELECTRICAL CONT'R SHALL PREPARE "ABUILT" SHOP DWGS INDICATING ALL ELECTRICAL WOK, INCLUDING ANY CHANGES TO THE ELEC. PLAN, ADD'NS THE ELEC. PLAN, RISER DIAGRAM, AS-BUILT PANEL SCHEULE W/ ALL CKTS
IDENTIFIED W/ CKT Nr. DESCRIPTION & EKR, SERVICE ENT.
& ALL UNDERGROUND WIRE LOCATIONSOUTING / DEPTH. RISER DIA. SHALL INCLUDE WIRE SIZES/PE & EQUIPMENT TYPE W/ RATINGS & LOADS.
CONTRACTOR SHALL PROVIDE 1 COPY FAS-BUILT DWGS


TO OWNER & 1 COPY TO THE PERMIT ISJING AUTHORITY

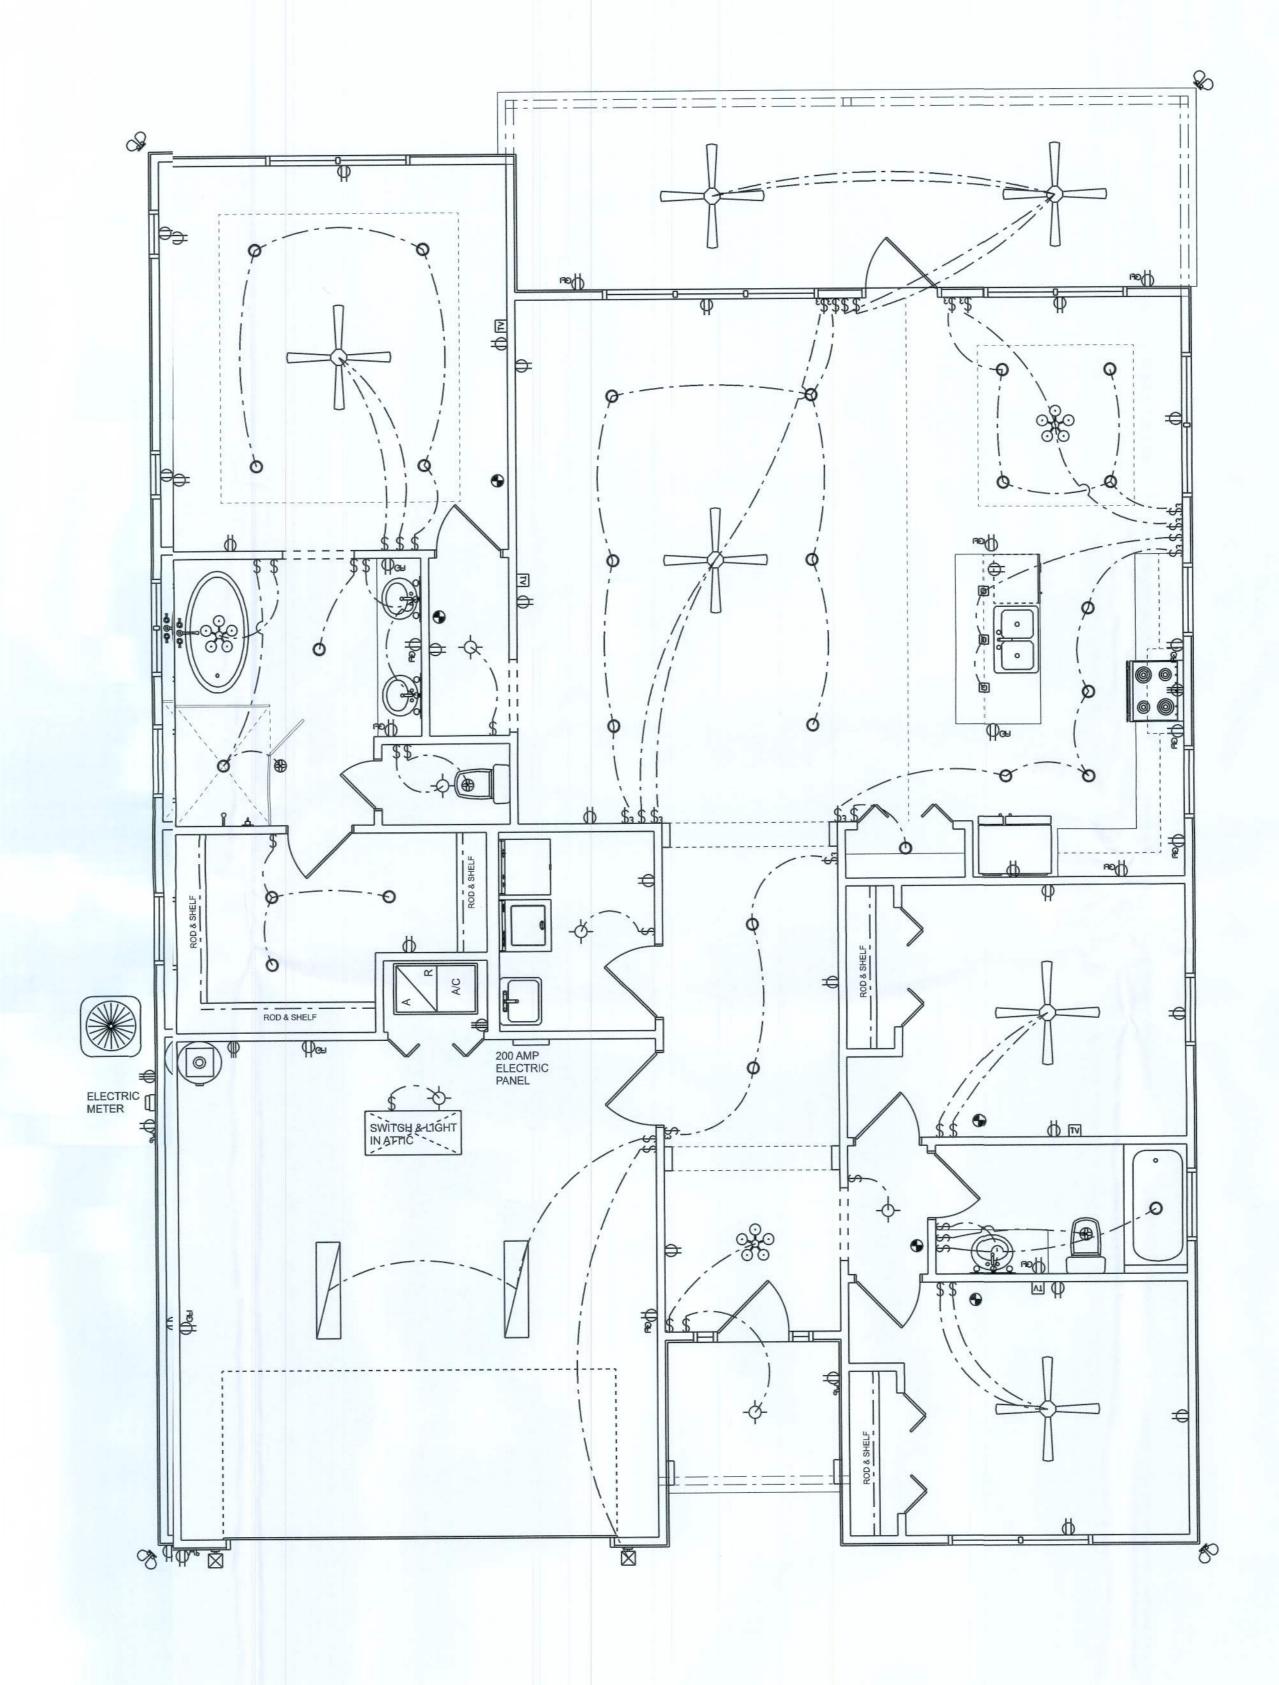



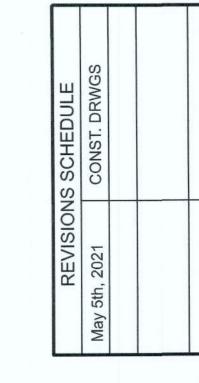

Y MODEL.
RON

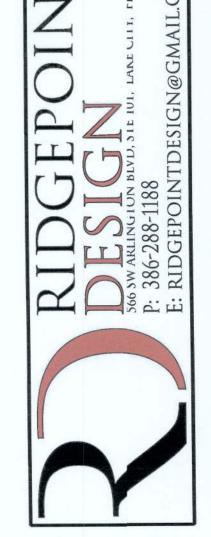

SHEET NUMBER OF 3 SHEETS