PROPOSED RESIDENCE ANITA AND JERRY WEST

463 LAKE HARRIS DRIVE, LAKE CITY, FLORIDA

| 26-3S-16-02307-005 - COLUMBIA COUNTY, FLORIDA | | |
|--|--|------------|
| LEGAL DESCRIPTION | | |
| LOT 4 OF FAIRWAY VIEW 'UNIT 2' PER THE PLAT THEREOF RECORDED | PLAT BOOK 4, PAGE 114 OF THE PUBLIC RECORDS OF COLUMBIA COUNTY | Y, FLORIDA |
| SCOPE OF WORK | | |

THIS PROJECT HAS BEEN DESIGNED IN ACCORDANCE WITH 2010 FLORIDA BUILDING CODE, RESIDENTIAL EDITION, SEC. R301 CRITERIA AND ASCE 7-10. TO THE BEST OF MY KNOWLEDGE THESE CONTRACT

THE EXISTING CONDITIONS AS SHOWN ON THIS SITE PLAN AND OTHER DRAWINGS AND DETAILS IN THIS PLAN SET ARE FROM SURVEY PLATS AND VERIFIED BY FIELD MEASUREMENTS. THE ENGINEER OF RECORD TAKES NO RESPONSIBILITY AS TO THE ACCURACY OR COMPLETENESS OF THE REPRESENTATIONS.

ROOF =

FLOORS, STAIRS =

WITH STORAGE =

WALLBOARD, ROOFING WILL METAL. FLOORING AND TRIM SHALL BE PER OWNER'S SPECIFICATION.

| | DESIGN CRITERIA |
|---|------------------------------------|
| _ | CONSTRUCTION TYPE: V-B |
| | WIND SPEED = 120 MPH (3 SEC. GUST) |
| | RISK CATEGORY = II |
| | WIND EXPOSURE = C |
| | INTERNAL PRESSURE COEFF. = 0.18 |

| 20 PSF | |
|--------|--|
| | |
| 40 PSF | |

+28.0/-30.7 +26.6/-29.3 50-100 SF =

DESIGN WIND PRESSURES

+23.4/-26.0

ROOF SHEATHING FASTENING SCHEDULE

- * USE 15/32" CDX OR 7/16" OSB SHEATHING (WOOD STRUCTURAL PANEL = W.S.P.)
- * SHEATHING SHALL BE FASTENED WITH 8d FULL-HEAD RINGSHANK NAILS
- * REFER TO SHEET S-2.4 FOR ROOF SHEATHING NAILING ZONE SCHEMATIC ZONE 1 EDGES @ TRUSSES 6" O.C. AND INTERMEDIATE TRUSSES 12" O.C. ZONE 2 EDGES @ TRUSSES 6" O.C. AND INTERMEDIATE TRUSSES 6" O.C.

WALL SHEATHING FASTENING SCHEDULE

- * USE 15/32* CDX OR 7/16* OSB SHEATHING (WOOD STRUCTURAL PANEL = W.S.P.)
- * STANDARD EXTERIOR WALL: USE MIN. 8d HAND DRIVEN OR GUN NAILS SPACED AT EDGES AT 6" O.C. AND INTERIOR FIELD AT 12" O.C. * EXTERIOR SHEARWALLS: USE MIN. 8d RING-SHANK GUN NAILS AT 4" O.C. ON EDGES AND ENDS AND

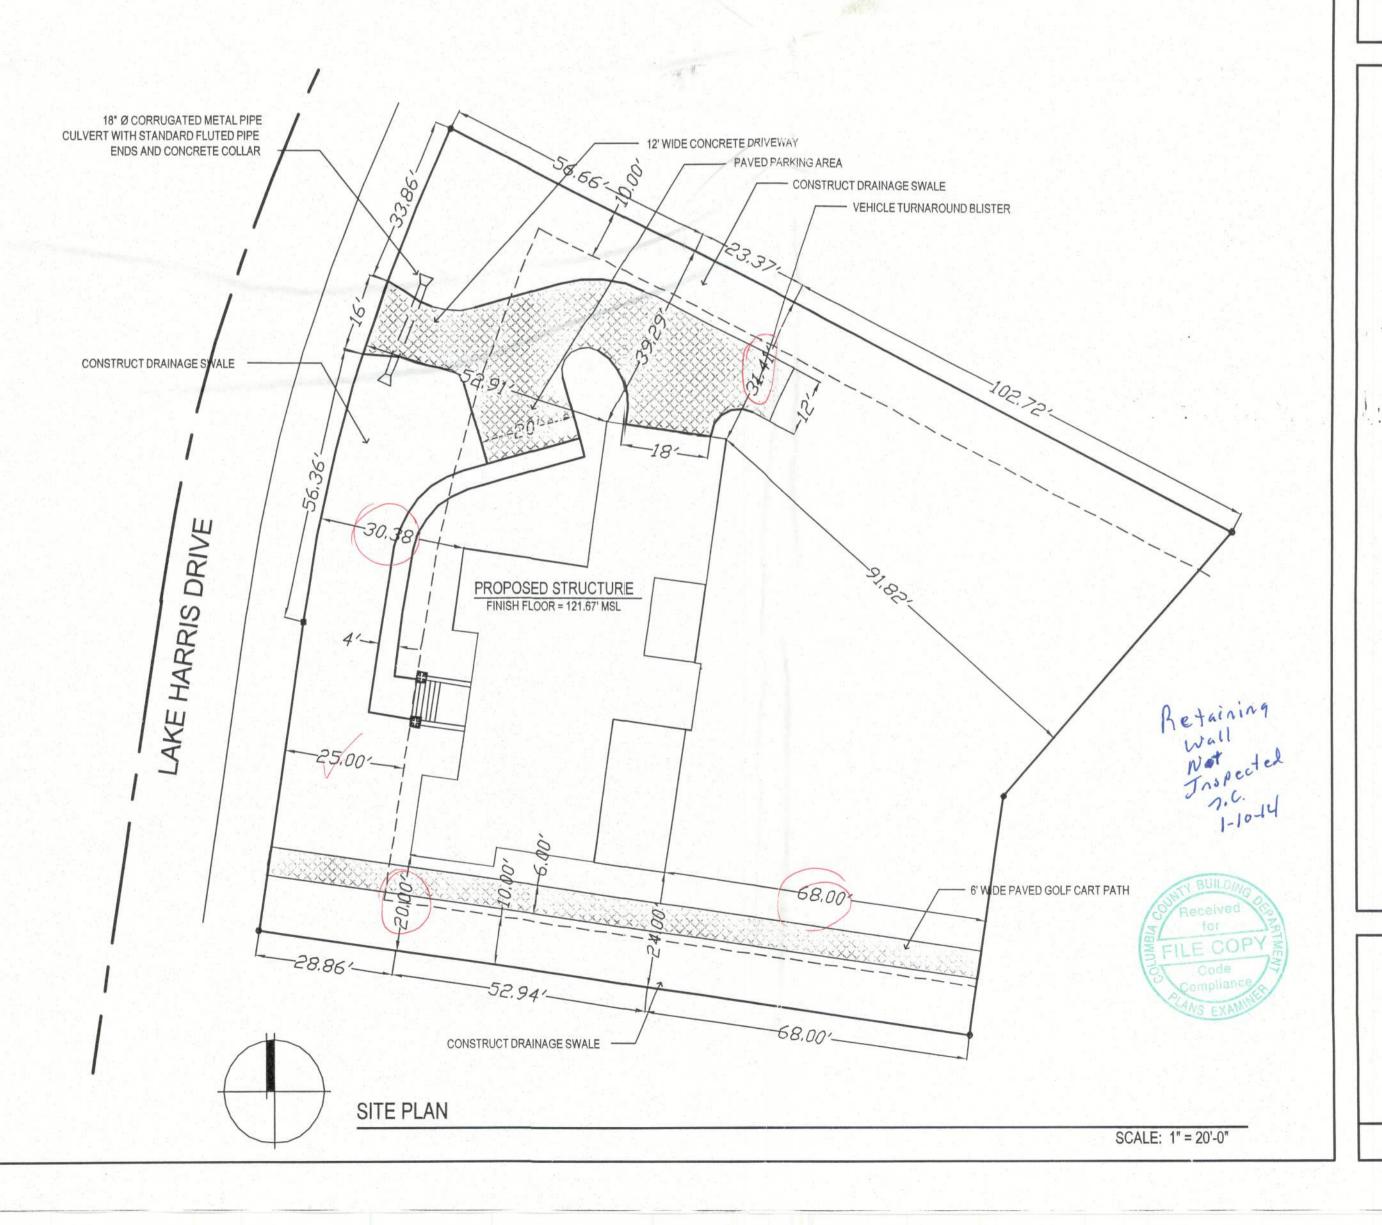
SHEET INDEX

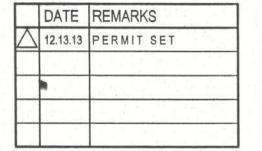
- PROJECT DATA, GENERAL NOTES, DESIGN CRITERIA, SITE PLAN
- DIMENSIONED FLOOR PLAN

AREA SUMMARY

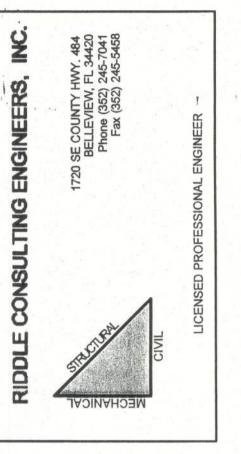
| CONDITIONED AREA | 2370 S.F. | |
|----------------------------|-----------|----|
| TOTAL CONDITIONED AREA | 2370 5 | .F |
| GARAGE AREA | 753 S.F. | |
| COVERED PORCH AREAS | 712 S.F. | |
| TOTAL NON-CONDITIONED AREA | 1285 9 | .F |
| TOTALAREA | 3655 \$ | .F |
| | | |

NOTED FLOOR PLAN. CUPOLA PLANS EXTERIOR ELEVATIONS EXTERIOR ELEVATIONS, TYPICAL ARCHITECTURAL WALL SECTION ELECTRICAL PLAN HVAC DUCTWORK SCHEMATIC GENERAL NOTES, STRUCTURAL NOTES FOUNDATION PLAN, SCHEDULES SLAB AND 'GO BOLTS' PLAN BEAMS, HEADERS AND SHEARWALL PLAN ROOF FRAMING PLANS ROOF DECKING NAILING PLANS SECTIONS AND DETAILS SECTIONS AND DETAILS SECTIONS AND DETAILS









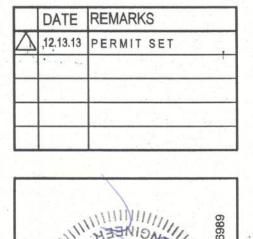
PLANS PREPARED BY AND UNDER THE DIRECT SUPERVISION OF RIDDLE CONSULTING ENGINEERS, INC.

PETER WOODS, RESIDENTIAL DESIGNER 5524 PECAN RD., OCALA, FL 34472 peter.woods@redesignguru.com

SIDENCE RY WEST F, LAKE CITY, FL S-16-02307-005

SHEET NUMBER

TYPICAL NOTES: ANY NOTE DESCRIBING A TYPICAL CONDITION SHALL APPLY TO ALL SIMILAR CONDITIONS UNLESS NOTED OTHERWISE. ALL INTERIOR PARTITIONS ARE 2x4 STUDS UNLESS OTHERWISE NOTED. DIMENSION STRINGS BALANCE WITH 3 1 STUD DIMENSIONS. STANDARD STUD DIMENSIONS ARE OMITTED FOR CLARITY. ALL NON-STANDARD PARTITION WIDTHS ARE





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POSED RESIDENCE

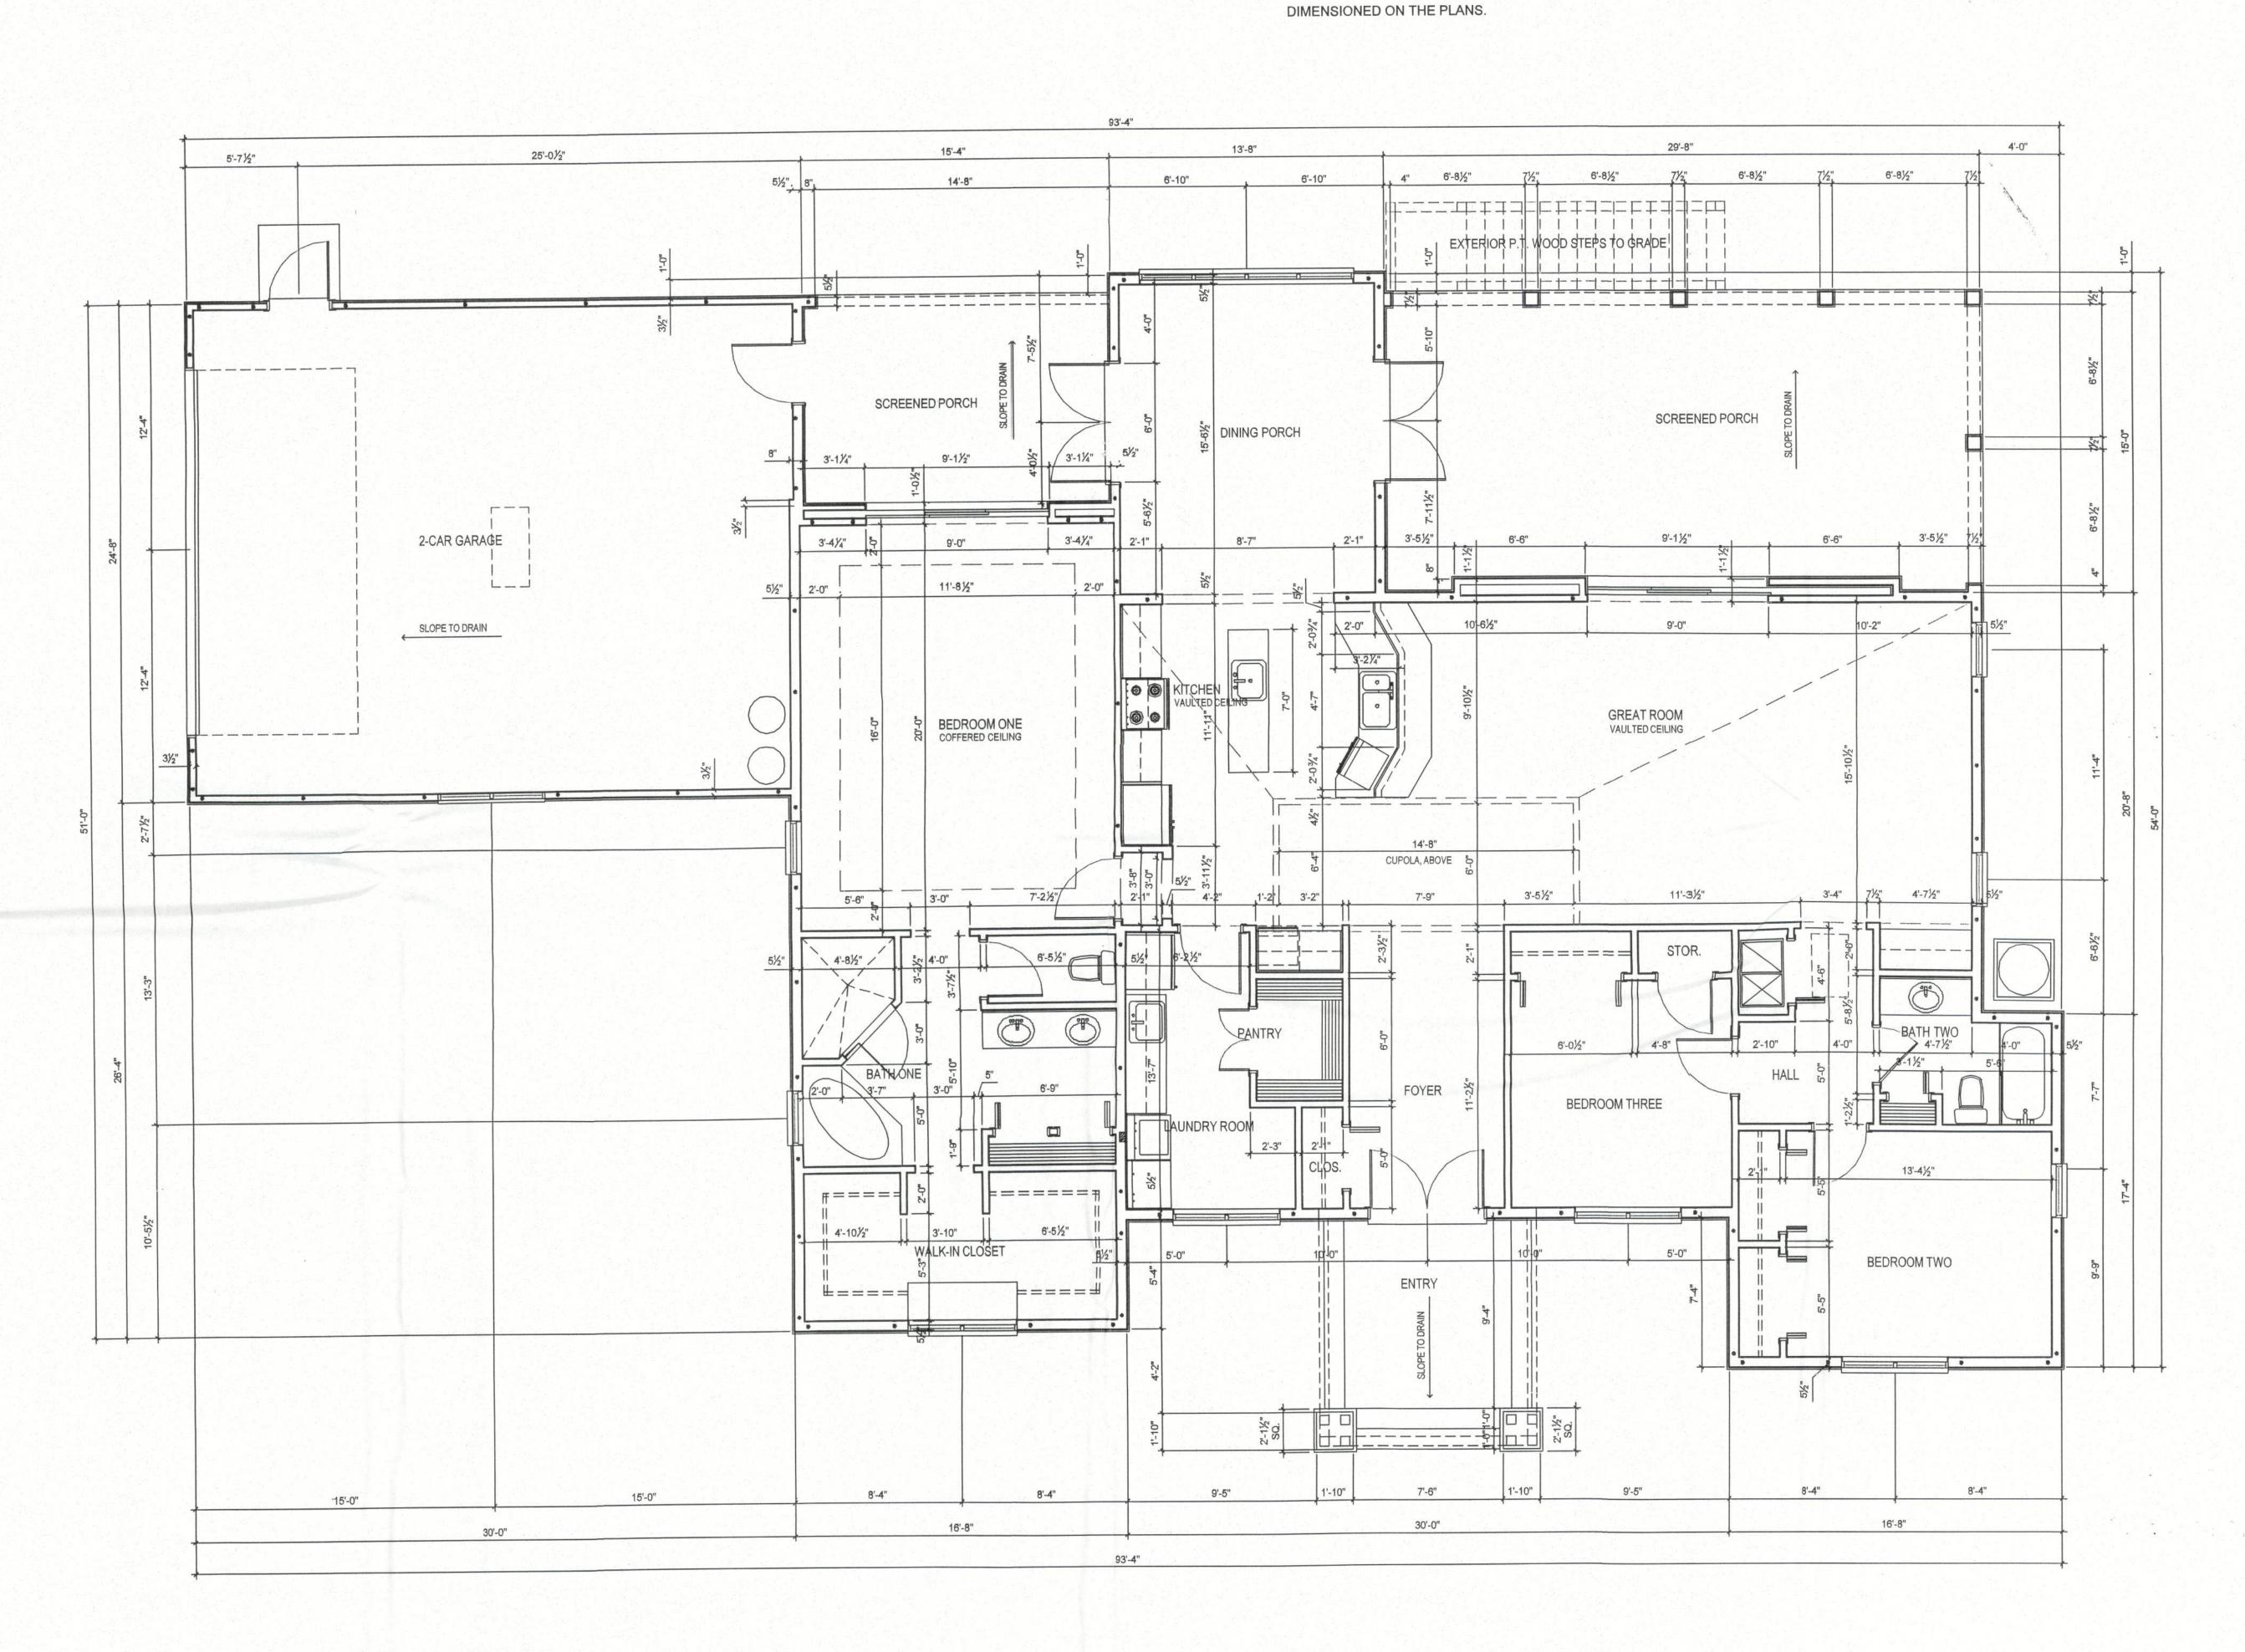
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DATE REMARKS 12.13.13 PERMIT SET



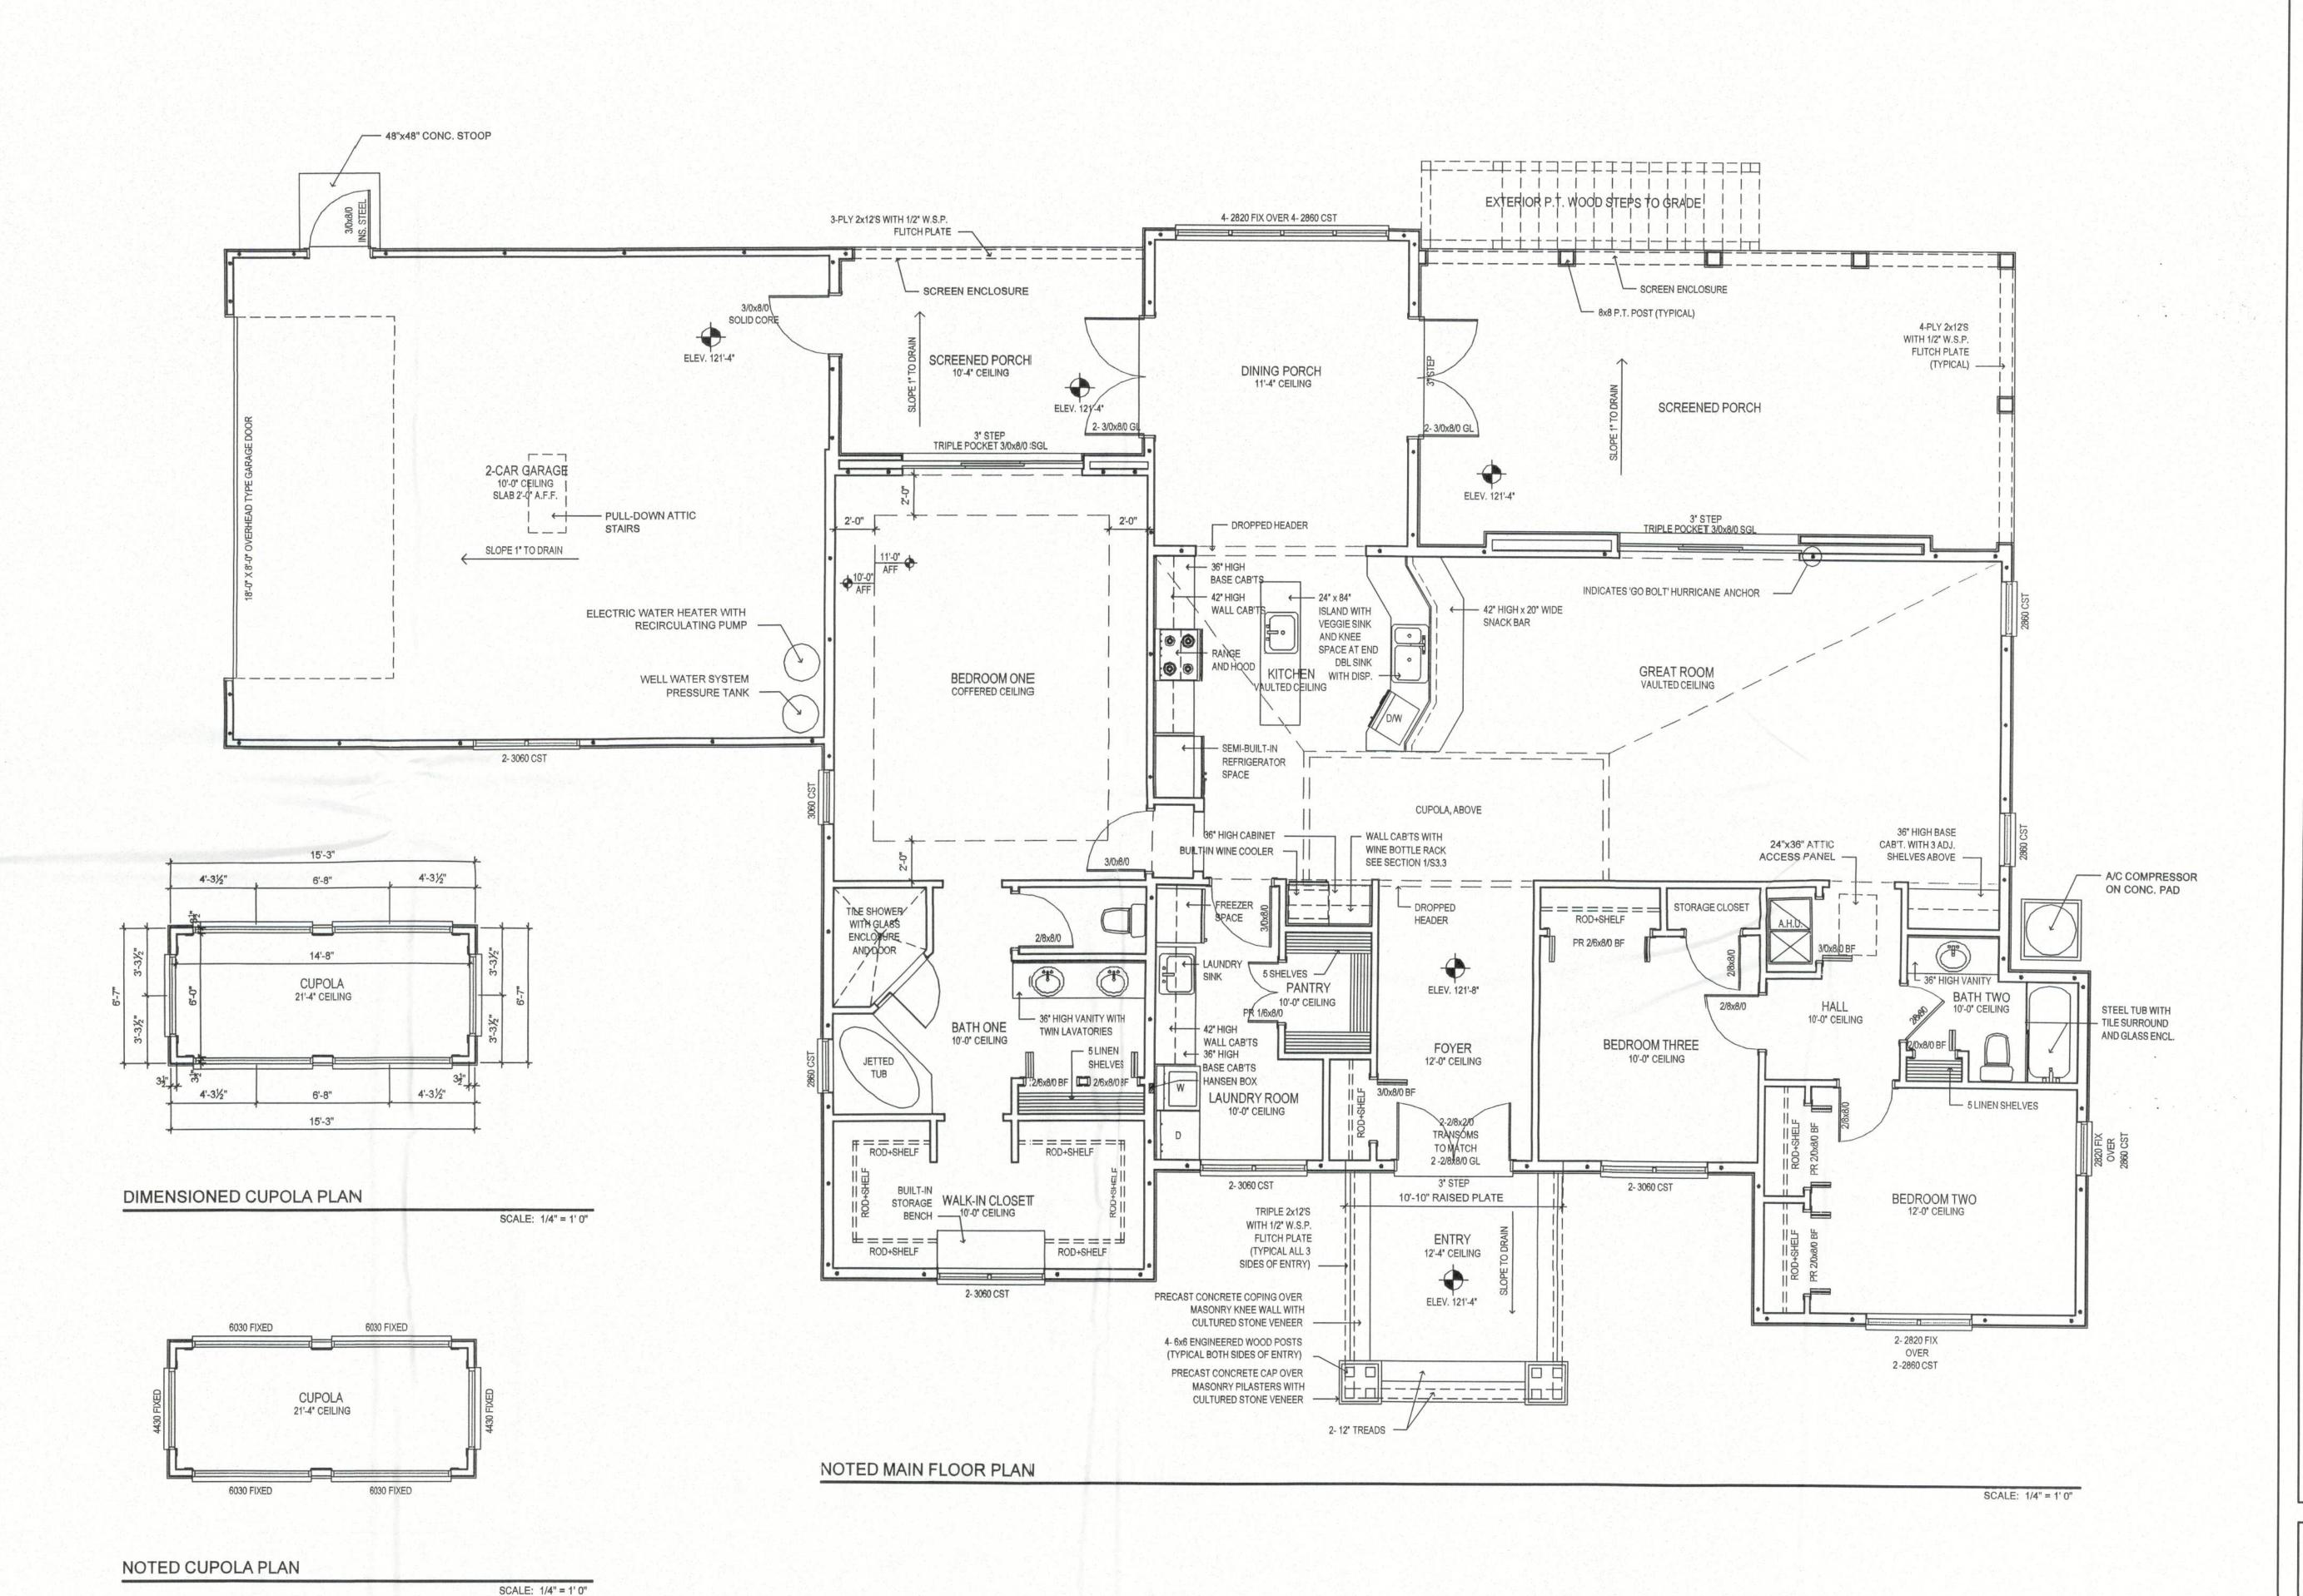
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PROP(ANITA



DIMENSIONS. STANDARD STUD DIMENSIONS ARE OMITTED FOR CLARITY. ALL NON-STANDARD PARTITION WIDTHS ARE DIMENSIONED ON THE PLANS. 4'-01/2" 7'-11½" SEE DETAIL BELOW LEFT `≻−−−F0R−−−− ´ CUPOLA ROOF PLAN 26'-0" 4'-0" ROOF PLAN NOTES: 1. ALL ROOF FRAMING TO BE PRE-ENGINEERED CANTILIEVER WOOD ROOF TRUSSES WITH A 4 / 12 PITCH EXCEPT AS SHOWN 2. HATCHED SECTION OF THE ROOF TO HAVE A 2 / 12 PITCH 3'-0" 15'-3" 4'-0" 4'-0" 4'-0" 4'-0" 16'-8" 4'-0" 21'-3" 24'-8" 18'-10" 24'-8" **ROOF PLAN CUPOLA ROOF PLAN** SCALE: 1/4" = 1' 0" SCALE: 1/4" = 1' 0"

TYPICAL NOTES:

ANY NOTE DESCRIBING A TYPICAL CONDITION SHALL APPLY TO ALL SIMILAR CONDITIONS UNLESS NOTED OTHERWISE.

ALL INTERIOR PARTITIONS ARE 2x4 STUDS UNLESS OTHERWISE NOTED. DIMENSION STRINGS BALANCE WITH 3 1/2" STUD

DATE REMARKS

12.13.13 PERMIT SET



1720 SE COUNTY HWY. 484
BELLEVIEW, FL 34420
Phone (352) 245-7041
Fax (352) 245-5458

String Strings

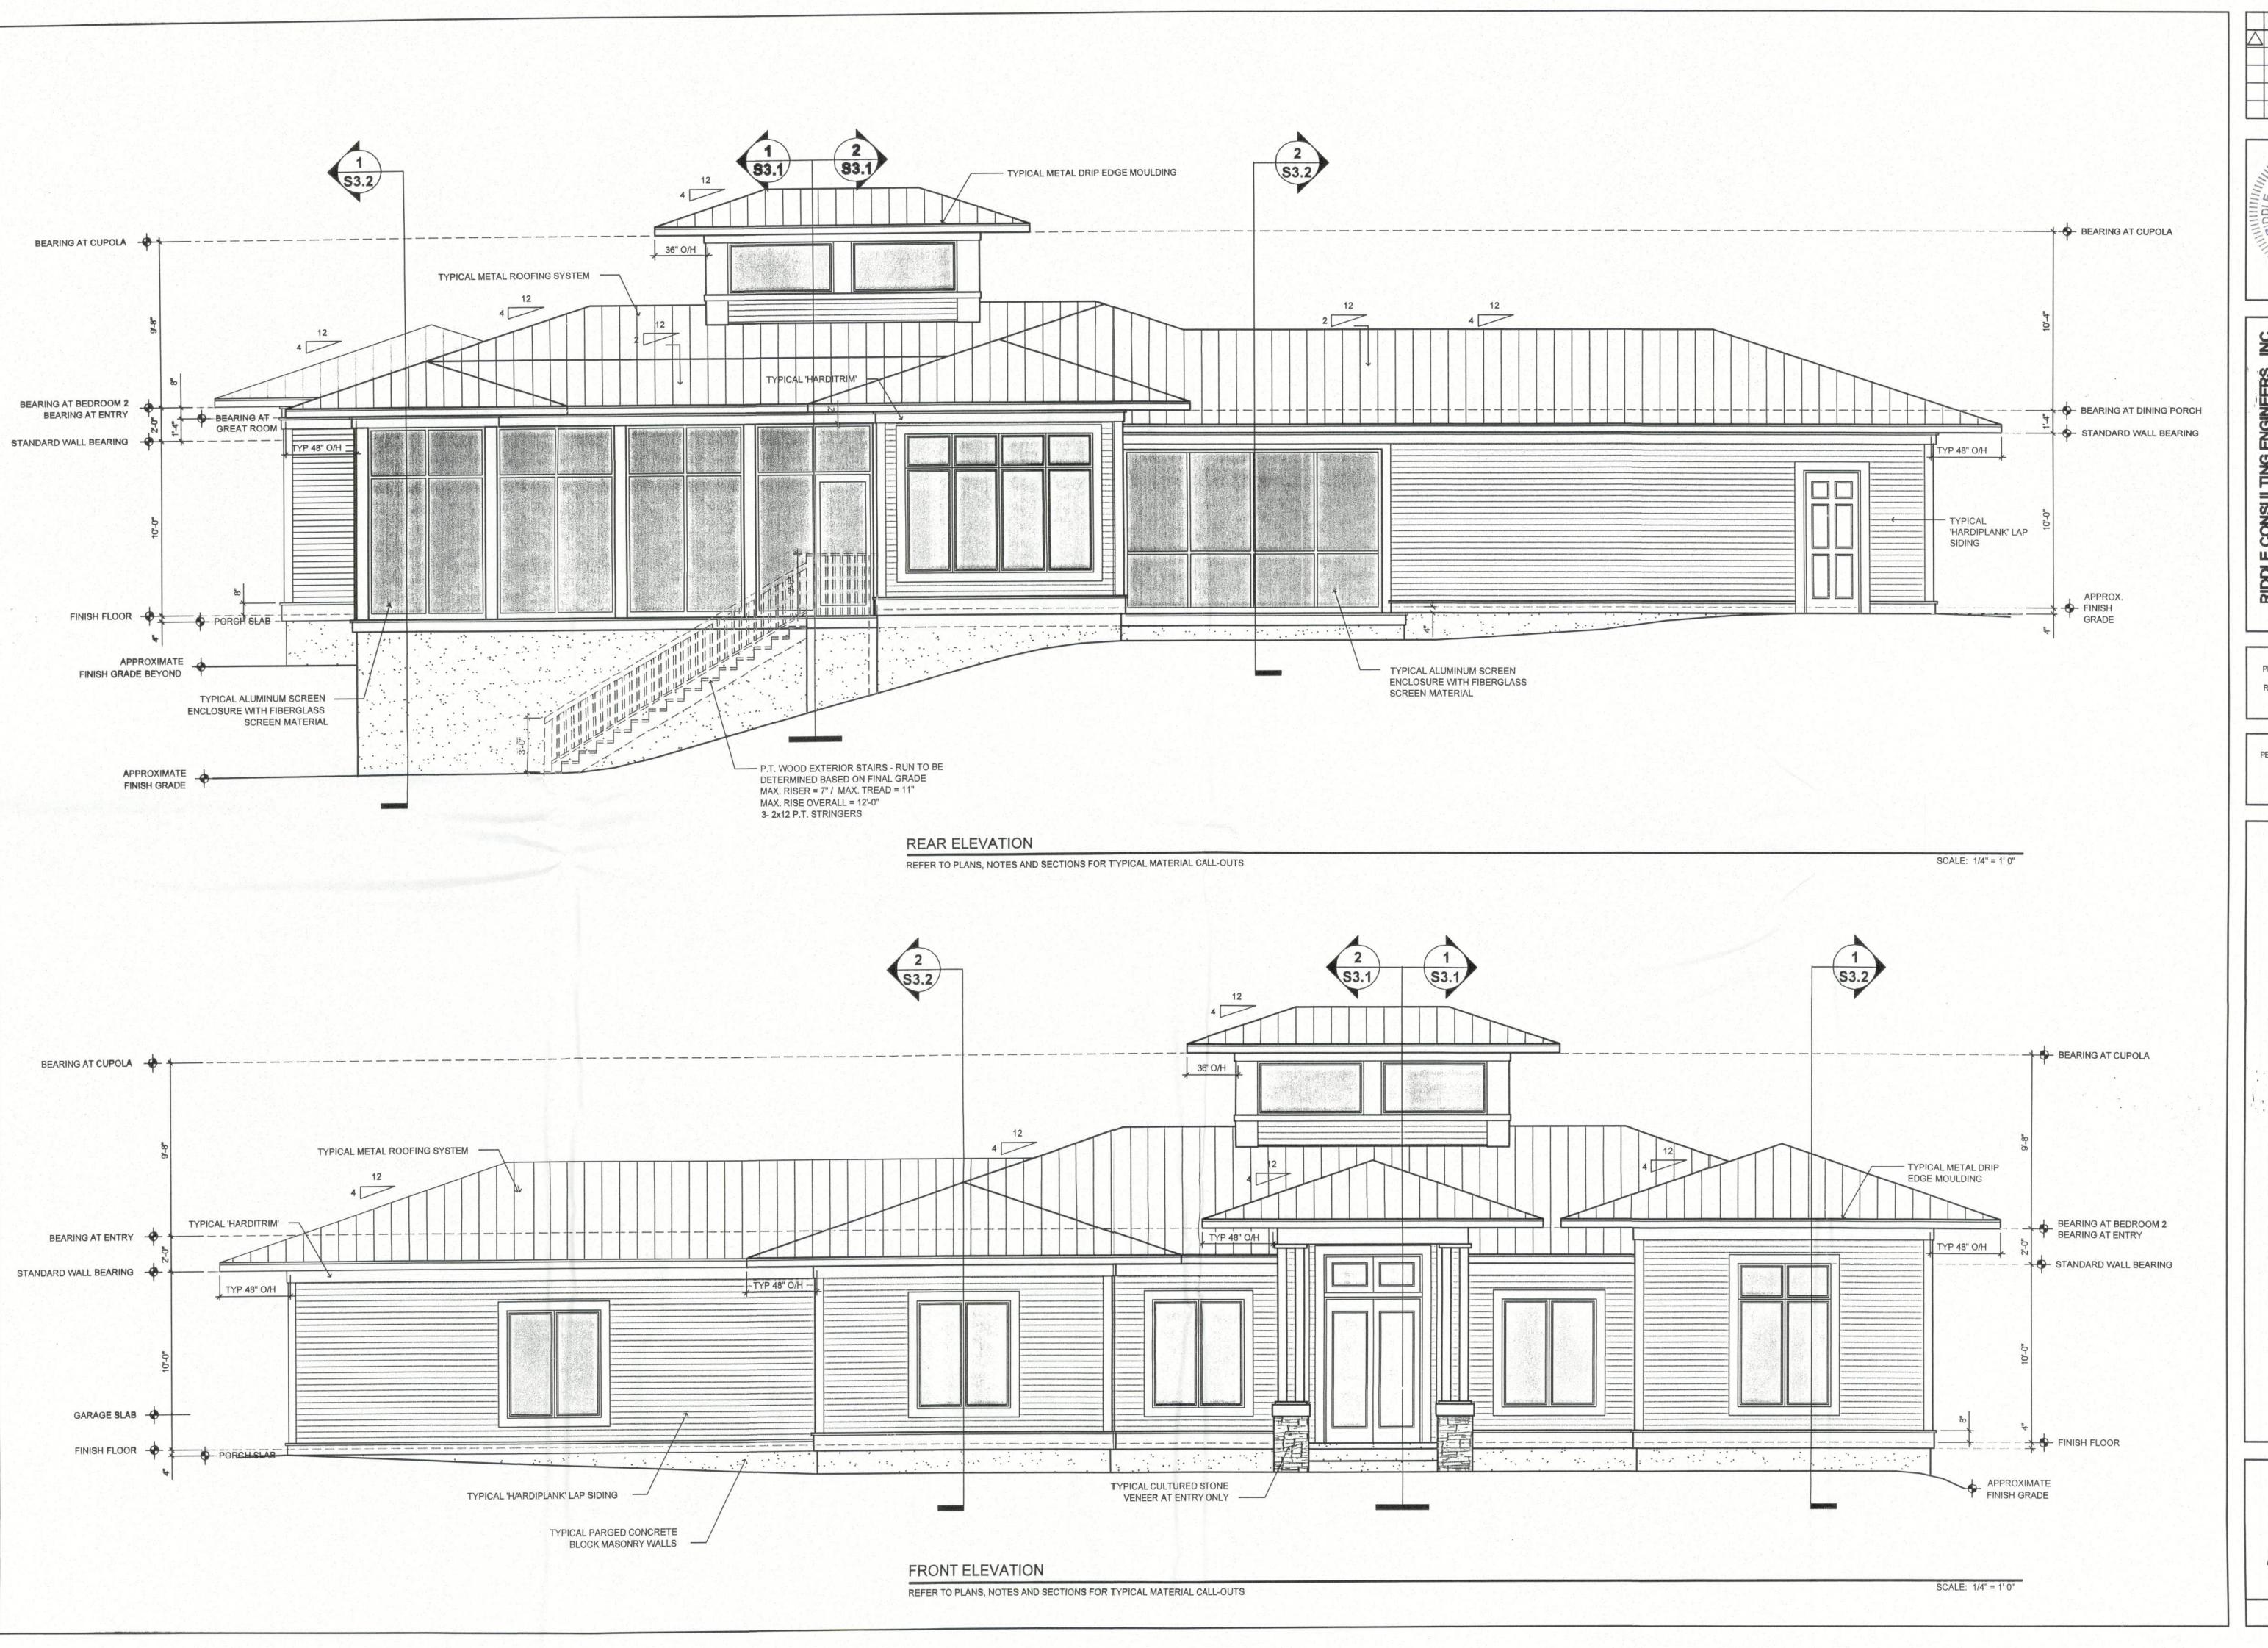
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SHEET NUMBER

A2.3



DATE REMARKS

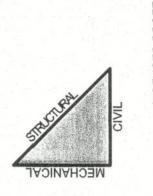
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IWY. 484 FL 34420 245-7041 245-5458

TOL TING ENGINEERS, III

1720 SE COUNTY HWY. SELLEVIEW, FL 34
Phone (352) 245-7
Fax (352) 245-5



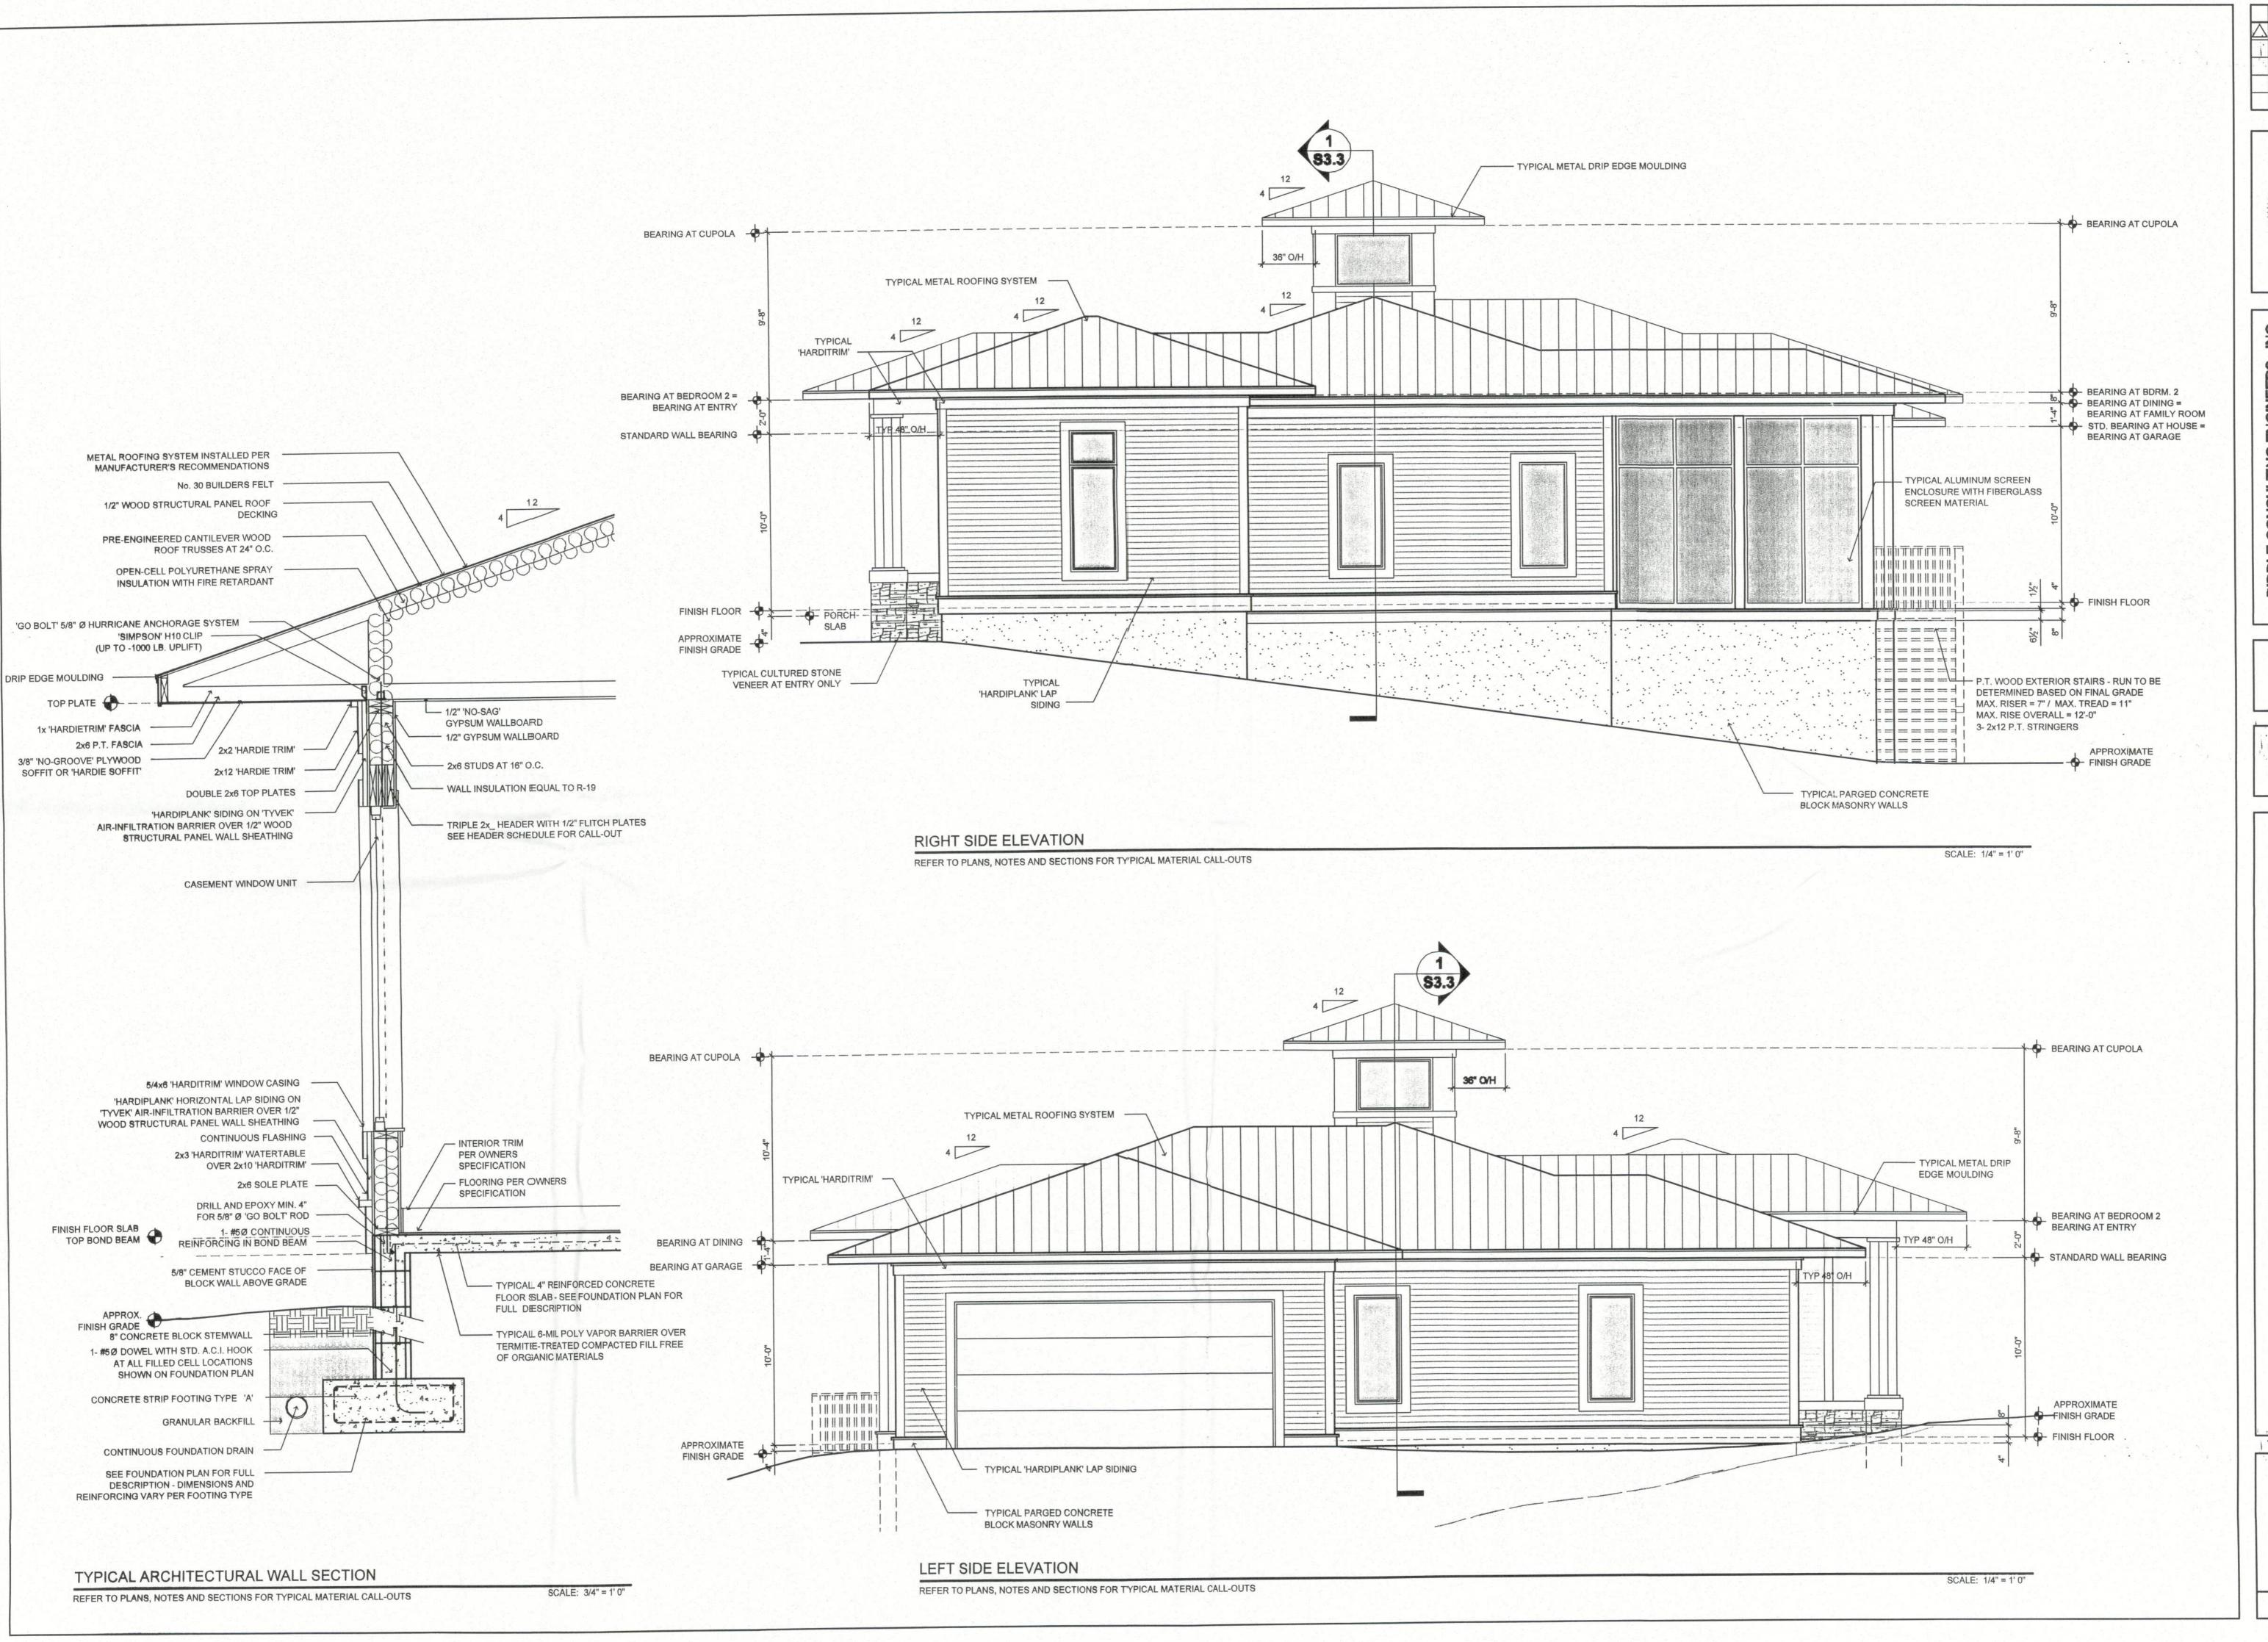
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D RESIDENCE JERRY WEST PROPOSED ANITA AND J

SHEET NUMBER

DIMENSIONS. STANDARD STUD DIMENSIONS ARE OMITTED FOR CLARITY. ALL NON-STANDARD PARTITION WIDTHS ARE

DIMENSIONED ON THE PLANS.

DATE REMARKS

12.13.13 PERMIT SET

Paul D. Riddle, PE No. 36989

ONSULTING ENGINEERS, INC.

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BELLEVIEW, FL 34420
Phone (352) 245-7041
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PLANS PREPARED BY AND UNDER THE DIRECT SUPERVISION OF RIDDLE CONSULTING ENGINEERS, INC. AND PAUL D. RIDDLE, P.E.

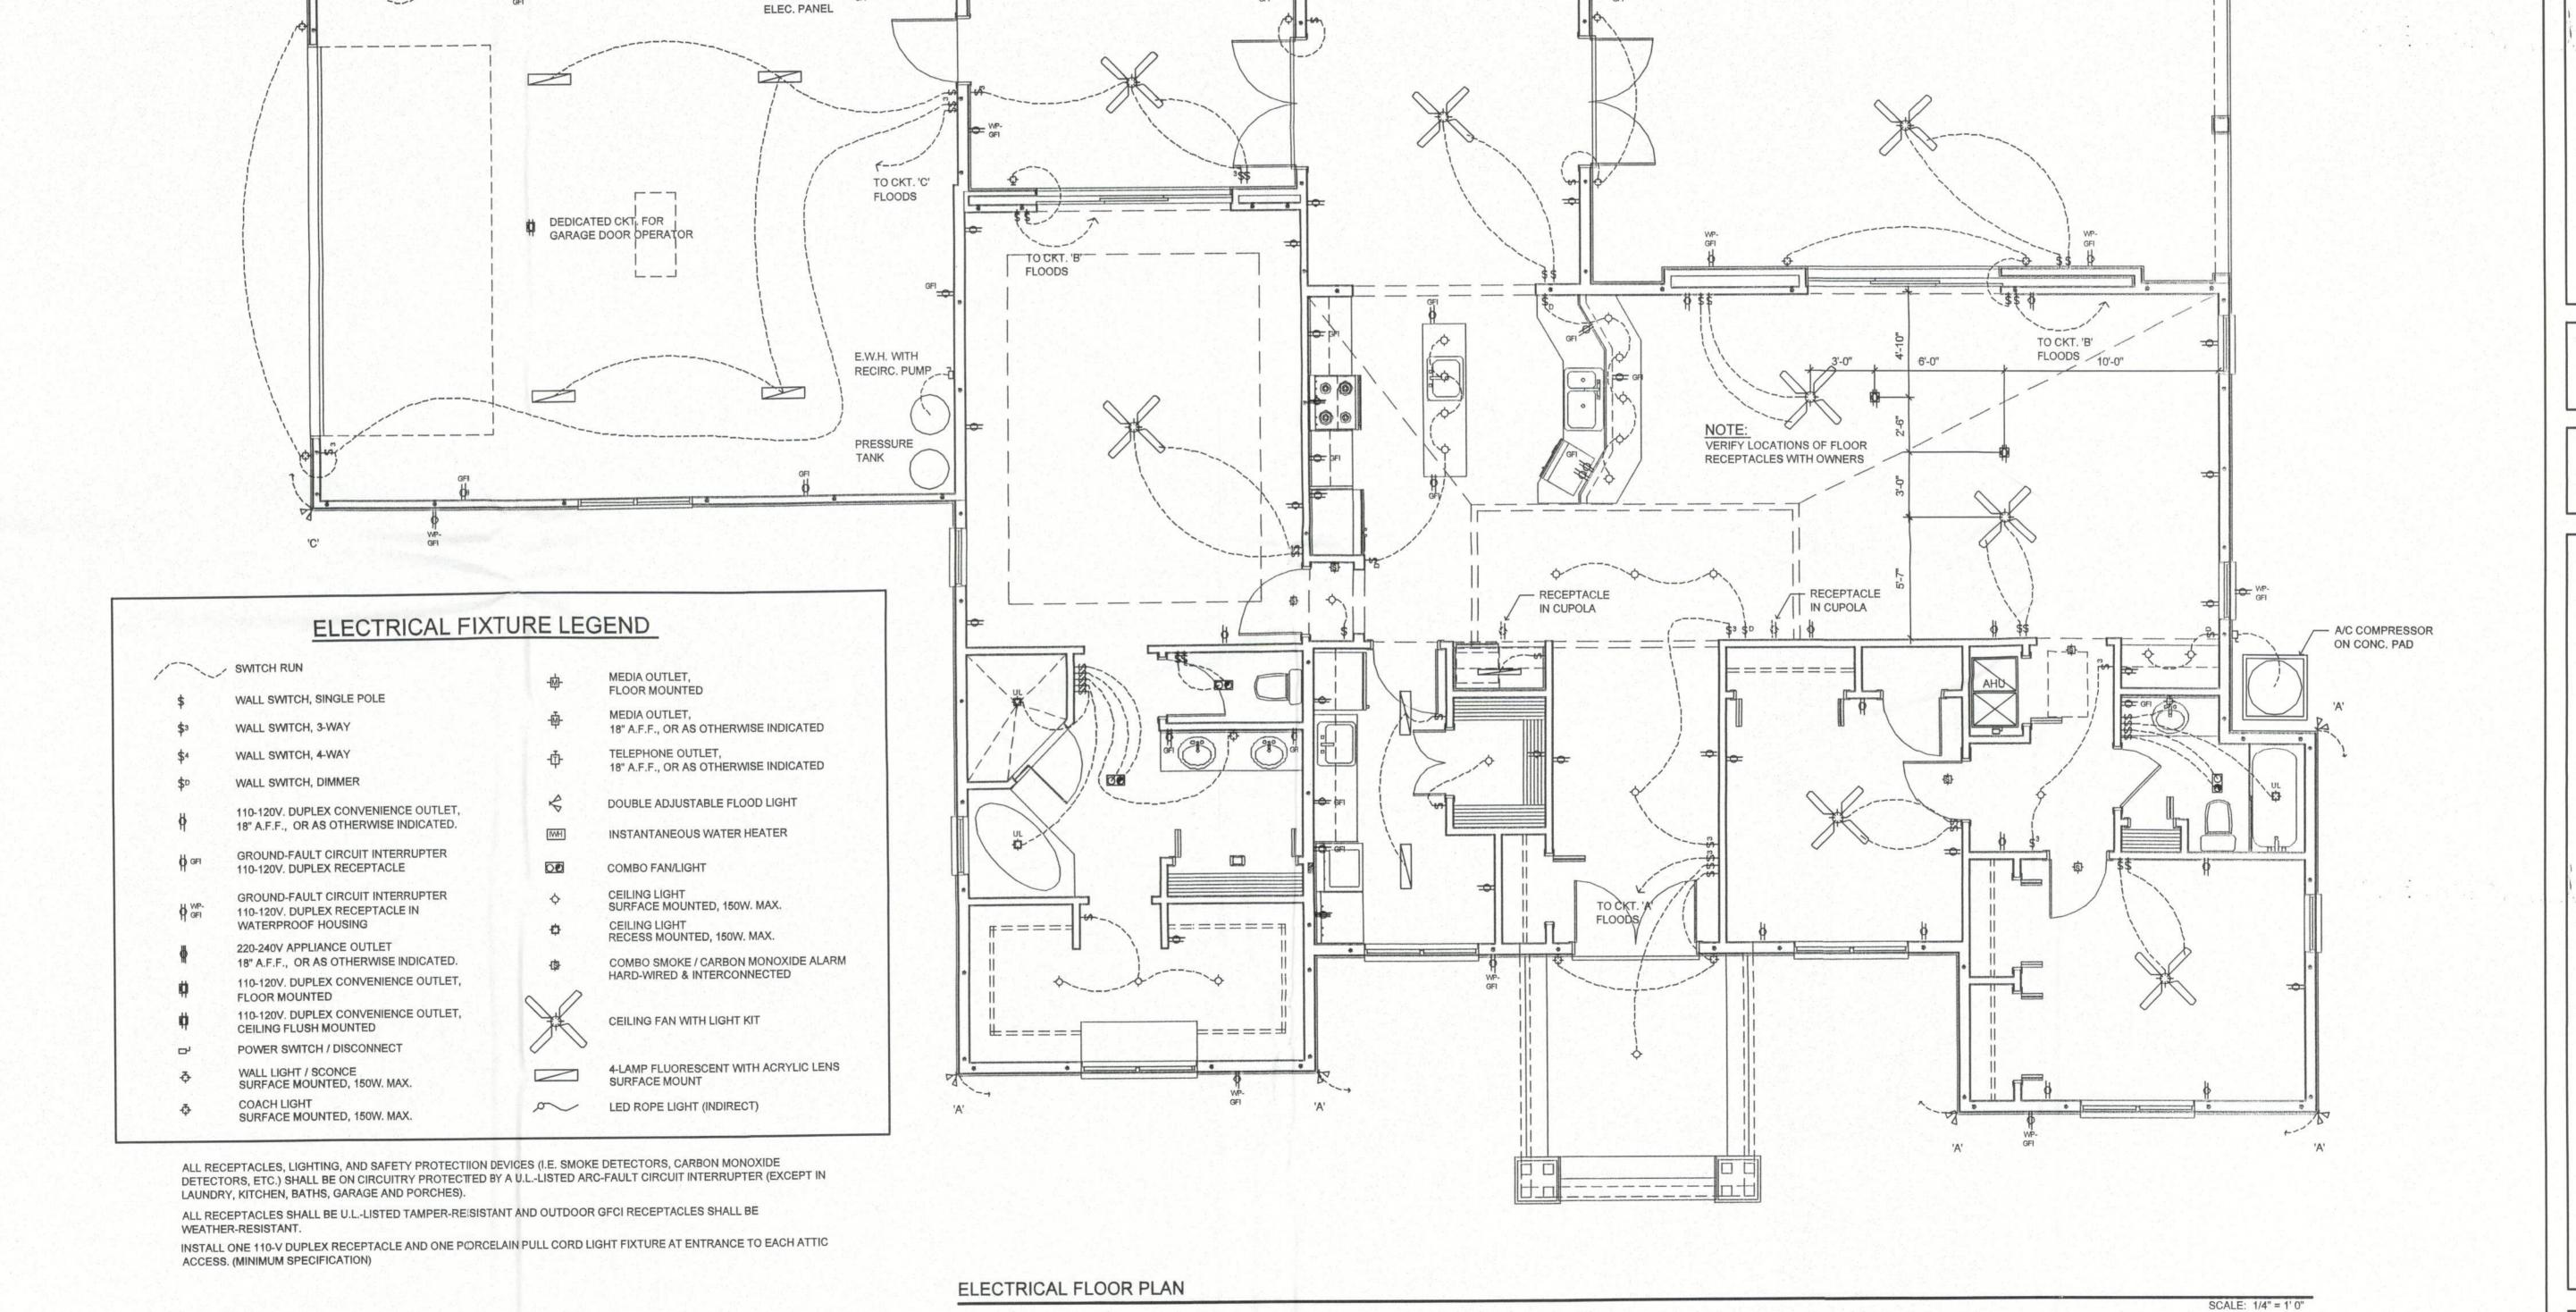
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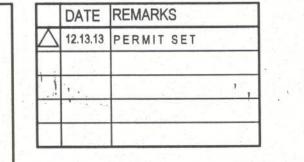
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PROJECT NO. 131006



MIN. 200-AMP

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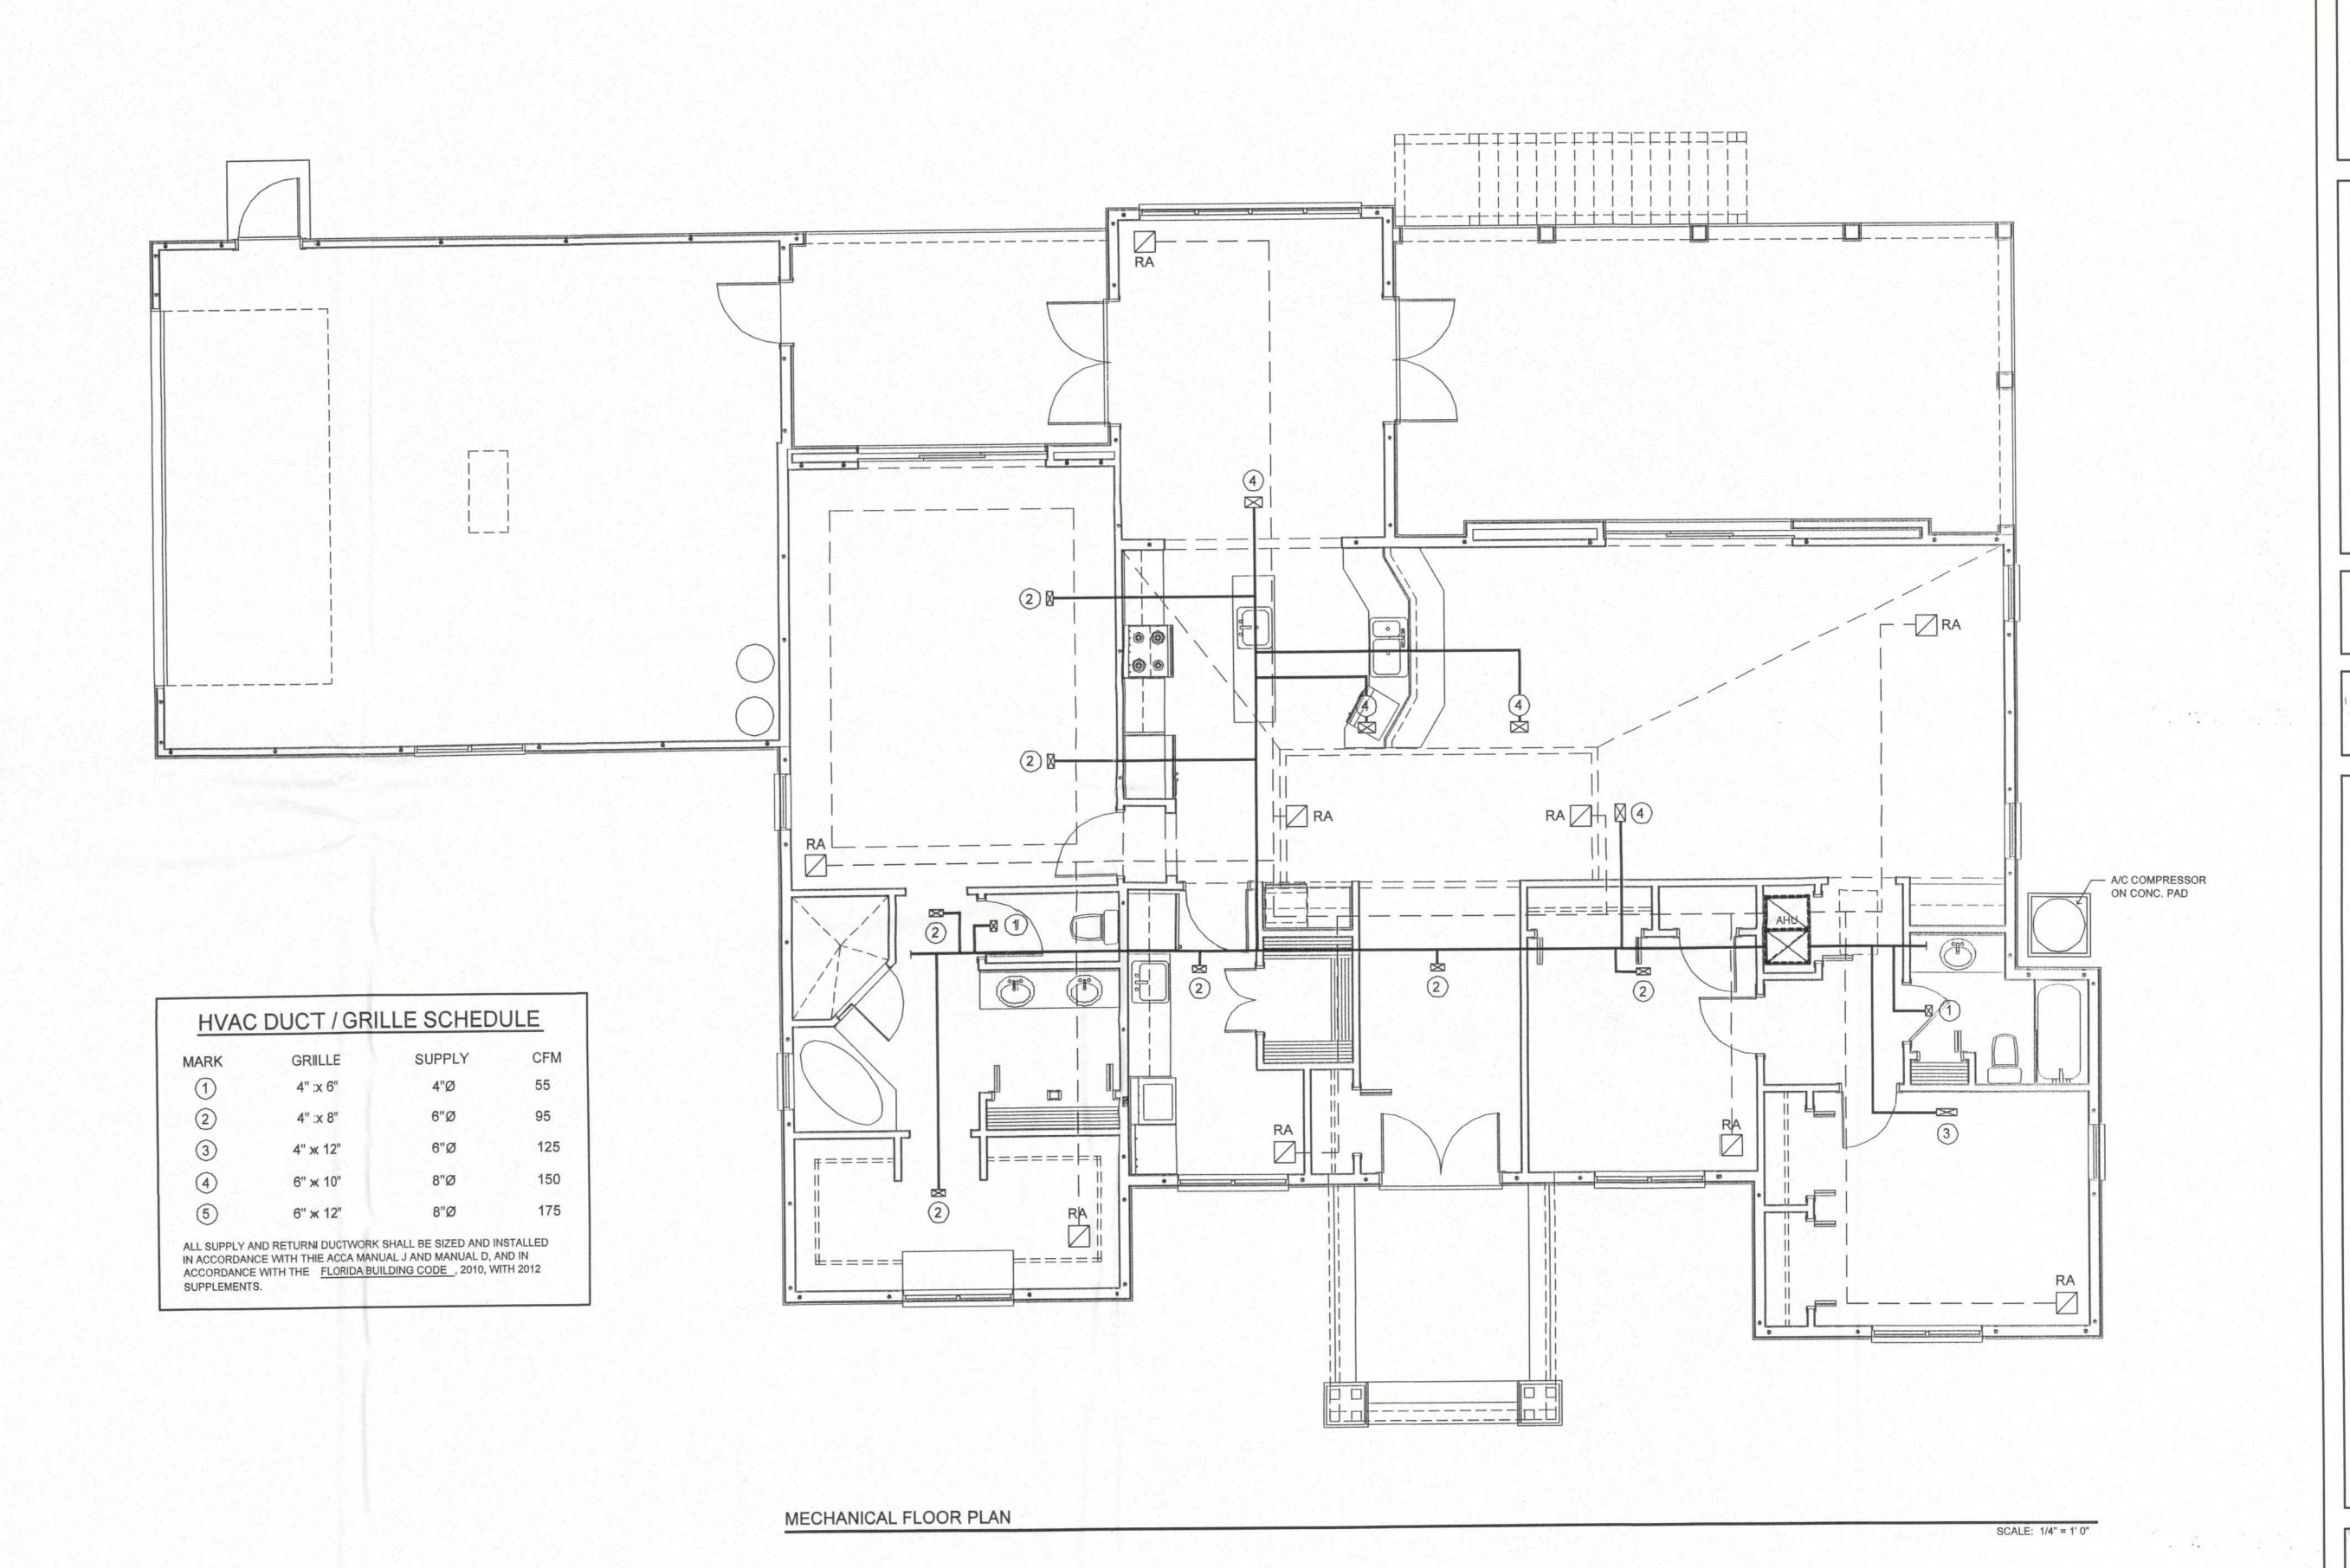
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- ALL WORK SHALL COMPLY WITH THE FLORIDA BUILDING CODE (LATEST EDITION) AND ALL OTHER LOCAL, COUNTY, STATE AND FEDERAL AGENCIES HAVING JURISDICTION OVER THE WORK. THE MORE STRINGENT CODE SHALL APPLY IF CONFLICT EXISTS IN OR BETWEEN CODES.
- IN GENERAL, THE CONTRACTOR(S) SHALL PROVIDE ALL LABOR, MATERIALS, EQUIPMENT AND INCIDENTALS NECESSARE AND/OR REQUIRED TO PERFORM AND COMPLETE THE ENTIRE
- ALL WORK SHALL BE TRUE, LEVEL, AND OF THE BEST WORKMANSHIP FOR EACH TRADE. ALL MECHANICS SHALL BE SKILLED AND/OR APPROPRIATELY LICENSED BY THE AUTHORITIES HAVING
- ALL EXTERIOR DIMENSIONS SHOWN ARE NOMINAL EXTERIOR FACE OF MASONRY TO EXTERIOR FACE OF MASONRY. ALL INTERIOR DIMENSIONS ARE NOMINAL FACE OF WOOD STUD TO FACE OF
- ANY VARIATIONS FROM CONDITIONS SHOWN ON THESE DRAWINGS SHALL BE BROUGHT TO THE ATTENTION OF THE DESIGNER. WORK SHALL NOT PROCEED UNTIL CLARIFICATION HAS BEEN
- SHOP DRAWINGS, WHERE APPLICABLE, MUST BE SUBMITTED TO THE OWNER FOR APPROVAL
- DISCREPANCIES AND OMISSIONS ON DRAWINGS AND SPECIFICATIONS SHALL BE REPORTED TO
- THE DESIGNER IN WRITING FOR CLARIFICATION.
- NO WORK SHALL COMMENCE UNTIL A BUILDING PERMIT HAS BEEN ISSUED. ALL SUBCONTRACTORS SHALL OBTAIN AND PAY FOR ALL NECESSARY PERMITS AND LICENSES AND BE RESPONSIBLE FOR HAVING THEIR WORK INSPECTED BY THE AUTHORITIES HAVING
- 10. EACH SUBCONTRACTOR SHALL COORDINATE HIS OWN WORK WITH OTHER TRADES. 1. ALL LUMBER IN CONTACT WITH CONCRETE OR MASONRY SHALL BE PRESSURE PRESERVATIVE
- 12. IF AMBIGUITIES EXIST IN THE DOCUMENTS, THE SUBCONTRACTOR SHALL INCLUDE IN HIS BID THE MORE EXPENSIVE METHOD OF WORK.
- 13. EACH SUBCONTRACTOR SHALL REMOVE AND DISPOSE OF HIS OWN DEBRIS PER CONTRACT SPECIFICATIONS, AND PREMISES SHALL BE LEFT BROOM-CLEANED ON A DAILY BASIS. ALL AREAS NOT INVOLVED IN THE WORK SHALL BE PROTECTED FROM DAMAGE, DUST, DEBRIS, AND ANY DAMAGE TO ADJACENT AREAS OCCASIONED BY THE SUBCONTRACTOR SHALL BE REPAIRED BY THE SUBCONTRACTOR.
- 14. LARGE SCALE DRAWINGS HAVE PRECEDENCE. HOWEVER, WORK INDICATED ON SMALL SCALE DRAWINGS SHALL NOT BE OMITTED. SIMILARLY, NOTES TAKE PRECEDENCE OVER SCHEDULES, PIPING AND WIRING DIAGRAMS, HOWEVER, WORK SHOWN OR DESCRIBED BY OTHER METHODS SHALL NOT BE OMITTED.
- 15. ALL WORK LET UNDER THIS CONTRACT SHALL BE GUARANTEED AND HONORED BY THE SUBCONTRACTOR FOR A PERIOD OF NOT LESS THAN ONE (1) YEAR FROM THE DATE OF FINAL PAYMENT, WHICH SHALL CONSTITUTE FINAL ACCEPTANCE. THE GRANTING OF A CERTIFICATE OF OCCUPANCY SHALL NOT CONSTITUTE FINAL ACCEPTANCE.
- 16. NEITHER THE DESIGNER NOR THE ENGINEER OF RECORD SHALL BE RESPONSIBLE FOR THE PERFORMANCE OF THE GENERAL CONTRACTOR NOR ANY ASSOCIATED SUBCONTRACTORS PERFORMING WORK UNDER THIS CONTRACT.
- 7. ALL SUBCONTRACTORS BIDDING ON THIS PROJECT SHALL VISIT THE SITE AND FAMILIARIZE THEMSELVES WITH EXISTING CONDITIONS PRIOR TO SUBMISSION OF A BID. FURTHERMORE, WHERE NO SPECIFIC BRAND OR MODEL IS SPECIFIED, THE SUBCONTRACTORS SHALL PROVIDE SUCH, INCLUDING MANUFACTURERS' CUT SHEETS AS A PART OF THEIR BID.

SITEWORK

1. SEE SITE PLAN NOTES, SHEET A1.1

1. SEE STRUCTURAL NOTES, THIS SHEET

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- GENERAL: CONTRACTOR SHALL PROVIDE NECESSARY LABOR, MATERIALS, AND EQUIPMENT TO LAY UP CONCRETE MASONRY UNITS AS SHOWN OR SPECIFIED IN THESE DOCUMENTS. WORKMANSHIP: ALL CONCRETE MASONRY WALLS SHALL BE TRUE AND PLUMB, AND BUILT TO DIMENSIONS AND PATTERNS AS INDICATED ON THE DRAWINGS.
- THE WORK OF THE MASONRY CONTRACTOR SHALL BE COORDINATED WITH THAT OF OTHER TRADES. ON CONCLUSION OF MASONRY WORK, CLEAN DOWN ALL CONCRETE MASONRY WALLS WITH A NON-ACID SOLUTION.
- MATERIALS: 8" AND 12" DECORATIVE CONCRETE BLOCK SHALL BE AS MANUFACTURED BY TITAN AMERICA (TARMAC), OLD CASTLE, OR CEMEX. PATTERNS, TEXTURES AND COLORS SHALL BE SELECTED BY OWNER.

GROUT COLORS SHALL BE SELECTED BY OWNER.

1. SEE STRUCTURAL NOTES, THIS SHEET

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THERMAL AND MOISTURE PROTECTION:

INSULATION:

INSULATION IN 4" OR 6" FRAME PARTITIONS SHALL BE UNFACED FIBER GLASS BATT INSULATION HAVING R-VALUES OF R-11 OR R-19, RESPECTIVELY. (ALTERNATE: SPRAY OPEN CELL POLYURETHANE FOAM WITH IGNITION BARRIER,)

ROOF INSULATION TO BE MINIMUM R-19 DIRECT APPLIED SPRAY OPEN CELL POLYURETHANE FOAM WITH APPLIED IGNITION BARRIER OVER FOAM.

INSULATION OF EXTERIOR CONCRETE WALLS SHALL BE 4 FOIL-FACED RIGID BOARD PLACED CONTINUOUSLY ON INNER FACE OF WALLS (P.T. FURRING MECHANICALLY ATTACHED ON INNER FACE OF RIGID INSULATION THROUGH TO MASONRY SUBSTRATE) PLUS ALL NON-GROUTED BLOCK CELLS/CAVITIES SHALL BE INSULATED WITH HIGH-PRESSURE INJECTED FOAM.

- A. UNFACED/KRAFT-FACED FIBER GLASS INSULATION: JOHNS MANVILLE FORMALDEHYDE FREE FIBER GLASS BATTS
- B. OPEN CELL POLYURETHANE FOAM INSULATION: JOHNS MANVILLE OPEN CELL POLYURETHANE FOAM, R-3.8 PER INCH
- RIGID POLYISOCYANURATE FOAM CORE INSULATION: DOW 'THERMAX' R-6.5 PER INCH. PRODUCT SHALL HAVE GLAS-FIBER-REINFORCED POLYISO CORE LAMINATED BETWEEN 1.0-MIL SMOOTH, REFLECTIVE ALUMINUM FOIL FACERS ON BOTH
- D. FOAM-IN-PLACE BLOCK INSULATION: TAILORED CHEMICAL PRODUCTS 'CORE-FILL 500'

COMPLY WITH INSULATION MANUFACTURER'S WRITTEN INSTRUCTIONS APPLICABLE TO PRODUCTS AND APPLICATION INDICATED.

INSTALL INSULATION THAT IS UNDAMAGED, DRY, AND UNSOILED AND THAT HAS NOT BEEN LEFT EXPOSED AT ANY TIME TO ICE, RAIN, OR SNOW. USE INSULATION WIDTHS AND LENGTHS THAT FILL THE CAVITIES FORMED BY FRAMING MEMBERS. IF MORE THAN ONE LENGTH IS REQUIRED TO FILL CAVITY, PROVIDE LENGTHS THAT WILL PRODUCE A SNUG FIT BETWEEN ENDS.

PLACE INSULATION IN CAVITIES FORMED BY FRAMING MEMBERS TO PRODUCE A FRICTION FIT BETWEEN EDGES OF INSULATION AND ADJOINING FRAMING MEMBERS.

INSTALLATION OF POLYURETHANE OPEN CELL FOAM INSULATION: SPRAY 5 1/2" OF FOAM TO SHEATHING IN ATTIC AND GABLE-END WALLS IN AREAS SHOWN IN DRAWINGS. INSTALL PER MANUFACTURER'S RECOMMENDATIONS. APPLY 2" OF JOHNS MANVILLE "SPYDER" FIBERGLASS IGNITION BARRIER OVER EXPOSED SURFACES OF FOAM.

GENERAL NOTES (CONTINUED):

THERMAL AND MOISTURE PROTECTION (CONTINUED):

2. ROOFING:

GENERAL: INSTALLED ROOFS SHALL BE GUARANTEED TWO (2) YEARS FROM DATE OF ACCEPTANCE OF THE BUILDING AND WARRANTED THIRTY (30) YEARS, CONTRACTOR SHALL PROVIDE ALL MATERIALS AND LABOR NECESSARY FOR A COMPLETE INSTALLATION.

TYPE: STANDING SEAM METAL ROOFING SYSTEM. GENERAL CONTRACTOR SHALL COORDINATE

UNDER: CONCRETE POURS: POLYETHYLENE VAPOR BARRIER: SIX (6) MIL CARBONATED POLYETHYLENE FILM, RATED 0.1 PERMS OR LESS.

INSTALLATION: LAPPED SEAMS: SEAL LAPPED SEAMS AND LAPS ONTO OTHER WORK WITH ADHESIVE OR SELF-ADHESIVE TAPE OF TYPE RECOMMENDED BY VAPOR BARRIER MANUFACTURER. BEFORE COVERING OVER VAPOR BARRIERS WITH OTHER CONCEALING WORK, PATCHI PUNCTURES AND TEARS WITH ADHESIVELY-APPLIED BARRIER MATERIAL OR TAPE WITH PERM RATING EQUAL TO THE BARRIER PERM RATING.

CAULKING AND SEALANTS:

GENERAL: THROUGHOUT THE WORK, CAULK AND SEAL ALL JOINTS INDICATED AND ELSEWHERE AS REQUIRED TO PROVIDE A POSITIVE BARRIER AGAINST PASSAGE OF AIR AND MOISTURE.

WRITT'EN GUARANTEE: CONTRACTOR SHALL FURNISH A WRITTEN GUARANTEE AGREEING TO MAKE ANY REPAIRS OR REPLACEMENTS REQUIRED BECAUSE OF FAULTY MATERIALS OR WORK:MANSHIP AT NO ADDITIONAL COST TO THE OWNER FOR A PERIOD OF ONE (1) YEAR FROM THE DIATE OF COMPLETION OF THE WORK.

PREPARATION: CLEAN AND PREPARE SURFACES TO WHICH SEALANT IS TO BE APPLIED PER MANUFACTURER'S RECOMMENDATIONS.

SEALANT INSTALLATION: APPLY SEALANT UNDER PRESSURE WITH HAND OR POWER-ACTUATED GUN O'R OTHER APPROPRIATE MEANS. GUNS SHALL HAVE NOZZLE OF PROPER SIZE AND PROVIDE SUFFICIENT PRESSURE TO COMPLETELY FILL JOINTS AS DESIGNED.

GENEIRAL: FLASHING SHALL BE 26-GA GALVANIZED STEEL.

WATERIPROOFING

- ALL WATERPROOFING FOR DECKS, SCUPPERS AND OTHER INSTALLATIONS SHALL UTILIZE "SEAL_OFLEX" WATERPROOFING SYSTEMS PRODUCTS (www.sealoflex.com).
- FOLLOW STEPS FOR ANY NECESSARY PRIMING AS OUTLINED IN "SEALOFLEX" SPECIIFICATIONS MANUAL.
- 3. FOLLOW STEPS FOR APPLICATION AS OUTLINED IN "SEALOFLEX" SPECIFICATIONS MANUAL.
- ALL "SEALOFLEX" FABRIC TO OVERLAP A MINIMUM OF 3" WHERE TWO PIECES COME TOGETHER.
- ALL "SEALOFLEX" FABRIC TO OVERLAP A MINIMUM OF 3" WHERE THERE IS A CHANGE IN PLANE.
- USE TWO SEPARATE PIECES OF "SEALOFLEX" FABRIC AT EDGES AND PENETRATIONS.
- "SEAL-O-FLEX" (DECKOFLEX) FLORIDA PRODUCT
- 6. APP'ROVAL No. 2920.3

DOORS AND WINDOWS:

- 1. DOOIRS AS SELECTED BY OWNER.
- WINDOWS SHALL BE 'INTEGRITY ULTEX' AS MANUFACTURED BY MARVIN. SEE WINDOW

WALILBOARD SYSTEM/MATERIALS:

SCHEDULE FOR MORE REQUIREMENTS

GYP(SUM BOARD: CONFORMING TO ASTM INTERNATIONAL STANDARD C 1396

| CEILLINGS: | 1/2" 'NON-SAG' GYPSUM WALLBOARD | |
|------------|--|--------|
| WALLS: | 1/2* GYPSUM WALLBOARD | |
| | 1/2" WATER-RESISTANT AND MILDEW-RETARDANT AT ALL | BATHRO |

1/2" DUROCK BEHIND ALL SHOWER AREAS

5/8" GEORGIA PACIFIC DENSGLASS FIREGUARD SHEATHING, TYPE DGG, WITH SYNTHETIC STUCCO AS MANUFACTURED BY 'DRY-VIT' OR EQUAL.

ASTM C 475, PERFORATED. COMPOUND:

ASTM C 475, OF THE TYPE INDICATED. PROVIDE READY-MIXED VINYL-TYPE FOR INTERIOR WORK. PROVIDE WATER RESISTANT TYPE MANUFACTURED BY UNITED STATES GYPSUM CO. FOR USE WITH WATER RESISTANT BACKING BOARD.

TWENTY-SIX (26) GAUGE, ELECTRO-GALVANIZED STEEL WITH KNURLED EDGING: SURFACES FOR EMBEDDING CEMENT, PROVIDE ANGLE CORNER PIECES WITH 1-1/4 INCH LEGS AT ALL EXTERNAL CORNERS AND CHANNEL-TYPE METAL TRIM PIECES AT ALL GYPSUM BOARD EDGES MEETING DISSIMILAR MATERIALS.

ANNULAR RING TYPE, LENGTHS AS REQUIRED BY GYPSUM BOARD NAILS 3/4" LONG.

GENERAL: FURNISH ALL PAINTING REQUIRED FOR A COMPLETE JOB. SURFACES SHALL RECEIVE COATINGS AS SHOWN ON THE DRAWINGS AND SCHEDULES AND AS SPECIFIED HEREIN.

PREPARATION OF SURFACES: NO PAINTING SHALL BE STARTED UNTIL SURFACES ARE IN PROPER CONDITION TO RECEIVE PAINT OR STAIN. SURFACES TO BE PAINTED OR STAINED SHALL BE CLEAN AND FREE FROM GREASE AND OIL BEFORE STAINING OR PAINTING. ALL KNOTS OR: SAPPY SPOTS SHALL BE CLEANED AND TOUCHED UP WITH KNOT SEALER OR SHELLAC BEFFORE PAINTING. ALL NECESSARY PUTTYING OF NAIL HOLES, CRACKS, AND BLEMISHES SHALL BE DONE ONLY AFTER PRIMING COAT HAS BECOME HARD AND DRY. ON STAIN WORK, NAIL HOLLES SHALL BE PUTTIED TO MATCH THE FINISH COLOR.

GENERAL NOTES (CONTINUED):

FINISHES (CONTINUED):

PAINTING (CONTINUED):

COLORS: ALL COLORS SHALL BE SELECTED BY THE OWNER. PAINTING CONTRACTOR SHALL FURNISH COLOR SAMPLES FOR THE SELECTION. NOTIFY THE OWNER TWO (2) WEEKS BEFORE STARTING WORK AND MAKE COLOR SAMPLES AS REQUESTED.

MANUFACTURERS: FIRST GRADE LINES OF PPG, SHERWIN-WILLIAMS, BENJAMIN MOORE, CABOT'S.

APPLICATION:

EXPOSED CONCRETE FLOOR SLAB: 'ARMORPOXY' 1-PART EPOXY COATING.

DRYWALL: 1 COAT LATEX PRIMER AND 2 COATS LATEX EGG-SHELL.

CEMENTITIOUS AND PVC TRIM: 1 COAT EXTERIOR ACRYLIC PRIMER AND 2 COATS EXTERIOR LATEX SATIN.

WOOD PAINTED: 1 COAT WOOD OIL PRIMER/UNDERCOAT AND 2 COATS LATEX EGG-SHELL.

WOOD STAINED: PRECONDITION WOOD BEFORE STAINING. 1 COAT WOOD CLASSICS' OIL STAIN AND 2 COATS 'WOOD CLASSICS' POLYURETHANE. GALVANIZED METAL AND ALUMINUM: 1 COAT 'GALVITE' HS SOLVENT-BASED ACRYLIC COATING

AND 2 COATS METAL LATEX SEMI-GLOSS. FERROUS METALS: 1 COAT 'KEM' KROMIK UNIVERSAL METAL PRIMER AND 2 COATS 'PROMAR 400'

ALKYD EGG-SHELL. 3. STUCCO:

> INSTALL 7/8" ROCK-SALT FINISH CEMENT STUCCO (3-COAT SYSTEM) ON PAPER-BACKED EXPANDED WIRE LATH OVER 'TYVEK HOUSE WRAP' ON PRESSURE-TREATED CDX PLYWOOD.

ON CONCRETE OR CONCRETE MASONRY:

ON WOOD FRAMING:

INSTALL 5/8" ROCK-SALT FINISH CEMENT STUCCO (2 COAT SYSTEM) DIRECTLY ON CLEAN CONCRETE OR CONCRETE MASONRY FACES.

- SHOP DRAWINGS FOR INTERIOR AND EXTERIOR RAILING FOR GUARD RAIL AND HAND RAIL SHALL BE SUBMITTED TO DESIGNER AND ENGINEER OF RECORD FOR REVIEW. RAILING SYSTEM (INCLUDING ANCHORAGE, BALUSTERS, AND TO)P RAIL) SHALL WITHSTAND A POINT FORCE OF 200 POUNDS APPLIED AT ANY LOCATION AND FROM ANY DIRECTION. FURTHER, OPENING IN RAILING SYSTEM SHALL NOT ALLOW TO PASS ANY OBJECT OF SIZE EQUAL TO A 4-INCH DIAMETER
- SPHERE OR LARGER. 2. CABINETS AND BUILT-IN SHELVING SHOWN ON THESE PLANS ARE SUGGESTED DESIGNS. GENERAL CONTRACTOR SHALL COORDINATE WITH THE OWNER AND A CERTIFIED KITCHEN AND BATH DESIGNER FOR ALL KITCHEN, BATH AND IBAR DESIGNS TO INCLUDE CABINET STORAGE ACCESSORIES. NATURAL AND CULTURED CABINET AND VANITY TOPS SHALL BE SELECTED BY OWNER. GENERAL CONTRACTOR SHALL COORDINATE WITH OWNER AND A QUALIFIED CUSTOM CLOSET DESIGNER FOR ALL CLOSET BUILT-INS INCLUDING SHELVING, CLOTHES RODS AND
- STORAGE UNITS. 3. CERAMIC TILE, PORCELAIN TILE AND BATH ACC; ESSORIES SHALL BE SELECTED BY OWNER.

APPLIANCES: GENERAL CONTRACTOR SHALL (COORDINATE WITH OWNER TO SELECT ALL KITCHEN AND LAUNDRY ROOM APPLIANCES.

TRANSFER SWITCH.

- HVAC: MECHANICAL CONTRACTOR SHALL DESSIGN AND SIZE ALL HEATING, COOLING AND VENTILATION SYSTEMS. HEATING AND COOLING SYSTEMS SHALL BEHIGH-EFFIECIENCY HEAT PUMP SYSTEMS. WATER HEATING SHALL BE BY ELECTRIC WATER HEATER WITH RECIRCULATING
- 2. PLUMBING: PLUMBING CONTRACTOR SHALL DIESIGN AND SIZE ALL POTABLE WATER PIPING, STORAGE AND PUMPING SYSTEMS. ACCEPTABLE SUPPLY PIPING SHALL BE COPPER OR CPVC SCHEDULE 40. ACCEPTABLE DRAIN, WASTE AIND VENT PIPING SHALLBE PVC OR CPVC
- 3. PLUMBING FIXTURES SHALL BE AS MANUFACTURED BY KOHLER, AMERICAN STANDARD OR

ELECTRICAL, HOME AUTOMATION, LIGHTNING PROTECTION, AND EMERGENCY STAND-BY POWER:

- 1. ELECTRICAL CONTRACTOR SHALL DESIGN ANID SIZE A WHOLE-PROPERTY ELECTRICAL SYSTEM FOR LIGHTING AND POWER. SERVICE SHALL BE UNDERGROUND. A MINIMUM 200-AMPERE
- SERVICE SHALL BE REQUIRED. 2. ALTERNATE No. 1: ELECTRICAL CONTRACTOR SHALL COORDINATE WITH THE OWNER AND WITH A QUALIFIED HOME AUTOMATION DESIGN AND INSTALLATION COMPANY FOR A WHOLE-PROPERTY AUTOMATION SYSTEM TO INCLUDE: LIGHTING CONTROLS, TIMERS, SECURITY, DATA AND ENTERTAINMENT.
- A QUALIFIED LIGHTNING PROTECTION DESIGN AND INSTALLATION COMPANY FOR A WHOLE-PROPERTY LIGHTNING PROTECTIONS SYSTEM. 4. ALTERNATE No. 3: ELECTRICAL CONTRACTOR SHALL COORDINATE WITH THE OWNER TO SELECT AND INSTALL A PERMANENT 25KW PRIOPANE-FIRED EMERGENCY STAND-BY ELECTRICAL

POWER GENERATOR. GENERATOR SHALL BE EQUIPPED WITH AND AUTOMATIC 100A/240V

ALTERNATE No. 2: ELECTRICAL CONTRACTOR SHALL COORDINATE WITH THE OWNER AND WITH

STRUCTURAL NOTES:

ALL DETAILS AND SECTIONS SHOWN ON THE DRAWINGS ARE INTENDED TO BE TYPICAL AND SHALL BE CONSTRUED TO APPLY TO ANY SIMILAR SITUATION ELSEWHERE ON THE PROJECT, EXCEPT WHERE A DIFFERENT DETAIL IS SHOWN.

MANUFACTURERS OF ANY PRE-ENGINEERED, PRE-FABRICATED SYSTEM OR COMPONENT SHALL SUBMIT SHOP DRAWINGS FOR THE OWNER'S APPROVAL PRIOR TO FABRICATION OR ERECTION OF SYSTEM/COMPONENT. THESE SHOP DRAWINGS SHALL BE SIGNED AND SEALED BY A

THE BUILDING IS DESIGNED IN ACCORDANCE WITH THE LATEST EDITION OF THE FLORIDA BUILDING CODE. FOLLOW ALL APPLICABLE PROVISIONS FOR ALL PHASES OF CONSTRUCTION.

THE STRUCTURAL INTEGRITY OF THE COMPLETED STRUCTURE DEPENDS UPON THE INTERACTION OF VARIOUS CONNECTED COMPONENTS. PROVIDE ADEQUATE BRACING, SHORING, AND OTHER TEMPORARY SUPPORTS AS REQUIRED TO SAFELY COMPLETE THE WORK.

EXCAVATON AND BACKFILL

FLORIDA REGISTERED ENGINEER.

- CLEAR, GRUB AND REMOVE ALL ORGANIC MATERIAL FROM AREAS OF CONSTRUCTION.
- ESTABLISH ACCURATE LAYOUT OF PROPOSED STRUCTURE AND EXCAVATE FOR FOOTINGS AND SLABS. EXCAVATE IN CRAWL SPACE AREAS TO PROVIDE MINIMUM 18" CLEAR SPACE BELOW BOTTOM OF WOOD FLOOR SYSTEM.
- VERIFY THAT SOILS CONDITIONS IN FOOTING AND SLAB SUBGRADES ARE SUITABLE FOR CONSTRUCTION. (SEE 'FOUNDATIONS' SECTION, BELOW)
- ALL BOTTOMS OF FOOTINGS SHALL BE IN VIRGIN SOIL. STEP FOOTINGS AS REQUIRED.
- ALL BACKFILL ADJACENT TO BASEMENT WALLS AND EXTERIOR RETAINING WALLS SHALL BE COMPACTED, WELL-DRAINED, GRANULAR MATERIALS.

SEE DETAILS FOR FOUNDATION DRAINAGE SYSTEM.

ALLOWABLE SOIL PRESSURE IS ASSUMED TO BE 2,000 P.S.F.

SPREAD FOOTINGS SHALL BEAR ON SOIL COMPACTED TO A DENSITY OF AT LEAST 95% OF MODIFIED PROCTOR MAXIMUM DENSITY (A.S.T.M. D1557). THE SOIL SHALL BE COMPACTED

TO THIS DENSITY TO A DEPTH OF AT LEAST TWO FEET BELOW THE BOTTOM OF THE FOOTINGS.

FILL UNDER FLOOR SLABS SHALL BE COMPACTED TO A DENSITY OF AT LEAST 95% OF MODIFIED PROCTOR MAXIMUM DENSITY (A.S.T.M. D1557), FOR ALL REQUIRED FILL AND FOR AT LEAST 2'-0" BELOW FINISHED FLOOR.

FOUNDATIONS:

DESIGN OF REINFORCED CONCRETE CONFORMS WITH BUILDING CODE REQUIREMENTS FOR REINFORCED CONCRETE - ACI 318, LATEST EDITION.

CONCRETE WORK SHALL BE PER ACI 301 (LATEST EDITION) SPECIFICATIONS FOR STRUCTURAL CONCRETE FOR BUILDINGS. ALL CONCRETE FOR FOUNDATIONS & SLAB ON GRADE SHALL HAVE AN UNCONFINED

COMPRESSIVE STRENGTH OF 2500 PSI AT 28 DAYS. ALL CONCRETE FOR CMU FILLED CELLS, COLUMNS, BEAMS, AND LINTELS SHALL HAVE AN UNCONFINED COMPRESSIVE STRENGTH OF 3000 PSI AT 28 DAYS.

FOR OPENINGS, SLEEVES, ANCHORS, HANGERS, SLAB DEPRESSIONS AND ANY OTHER ITEMS RELATED TO CONCRETE WORK, CONTRACTOR SHALL ASSUME FULL RESPONSIBILITY FOR THEIR

CONCRETE PROTECTION FOR REINFORCING BARS:

1-1/2" CLEAR TO TIES

PROPER LOCATION, BEFORE POURING CONCRETE.

3" CLEAR, BOTTOM AND SIDES, 2" CLEAR, TOP 2" CLEAR, OUTSIDE FACE, 1-1/2" CLEAR, INSIDE FACE 3/4" CLEAR, 1-1/2" CLEAR AT AREAS EXPOSED TO WEATHER. **BEAMS** 1-1/2" CLEAR TO STIRRUPS

COLUMNS

SUBMIT MIX DESIGN PREPARED BY A CERTIFIED LAB WHO IS DIFFERENT THAN THE ONE CONDUCTING SLUMP TESTS AND CYLINDER BREAKS. LABEL EACH MIX DESIGN TO INDICATE THE AREA IN WHICH THE CONCRETE IS TO BE PLACED. MIX DESIGN SHALL BE PER EITHER METHOD 1 OR METHOD 2 OF ACI 301. PROVIDE SUPPORTING DATA FOR EACH MIX DESIGN.

PROVIDE NORMAL WEIGHT CONCRETE WITH THE FOLLOWING PROPERTIES: 3000 PSI 28-DAY COMPRESSIVE STRENGTH, USE TYPE I PORTLAND CEMENT. NO FLY ASH OR OTHER POZZOLAN IS PERMITTED. SUMP LIMIT 3" TO 5". AIR CONTENT 2 TO 4% UNLESS SHOWN OTHERWISE IN DRAWINGS.

CONCRETE CURING AND TESTING:

CURING: PROTECT CONCRETE FOR 7 DAYS AGAINST MOISTURE LOSS, RAPID TEMPERATURE CHANGE, MECHANICAL INJURY AND INJURY FROM RAIN OR FLOWING WATER, MAINTAIN CONCRETE IN MOIST CONDITION AT TEMPERATURE ABOVE 50 DEGREES F. THROUGHOUT SPECIFIED CURING PERIOD. PROTECT FROM RAPID TEMPERATURE CHANGE AND RAPID DRYING FOR FIRST 24 HOURS FOLLOWING REMOVAL OF TEMPERATURE PROTECTION. START CURING ACTIVITIES AS SOON AS

TESTING: CONCRETE TESTING FOR THIS PROJECT SHALL CONSIST OF COMPRESSIVE TESTS MADE BY THE LABORATORY IN ACCORDANCE WITH ASTM C-31. FOLLOW ASTM C31 AND MAKE A SET OF FOUR (4) STANDARD CYLINDERS FOR EACH 50 CU. YDS. OR FOR EACH DAY'S POUR EXCEEDING 5 CU. YDS.

FREE WATER DISAPPEARS FROM SURFACE OF CONCRETE AFTER PLACING AND FINISHING.

TEST PER ASTM C39 AS FOLLOWS: ONE (1) SPECIMEN TESTED AT SEVEN (7) DAYS, ONE (1) AT 14 DAYS. ONE (1) TESTED AT 28 DAYS, AND ONE (1) HELD IN RESERVE. SLUMP TEST SHALL BE MADE IN ACCORDANCE WITH ASTM C-143 FOR EACH DAY'S POUR, FOR EACH LOAD, OR AS DIRECTEDBY THE ENGINEER OF RECORD.

CONCRETE ANCHORS AND FASTENERS:

MANUFACTURED BY HOMAN & BERNARD, OR APPROVED EQUAL.

EMBEDMENT ANCHORS SHALL BE NELSON HEADED ANCHORS WITH FLUSH ENDS (OR APPROWED EQUAL), SIZE AND SPACING AS INDICATED ON THE DRAWINGS. STUDS SHALL BE END WELDEID IN ACCORDANCE WITH RECOMMENDATIONS OF THE NELSON STUD WELDING COMPANY.

EXPANSION ANCHORS SHALL BE WS SERIES WEDGE ANCHORS AS MANUFACTURED BY PHILLIPS RED HEAD, OR HILTI KWIK BOLTS AS MANUFACTURED BY HILTI, INC. OR APPROVED EQUAL.

REINFORCING STEEL SHALL BE NEW BILLET STEEL CONFORMING TO A.S.T.M. A615-GRADE 40,

ALL DETAILING AND ACCESSORIES SHALL CONFORM TO TYPICAL DETAILS SHOWN IN THE "MANUAL OF STANDARD PRACTICE FOR DETAILING REINFORCED CONCRETE STRUCTURES ACI 315, LATEST EDITION".

IN LIEU OF EXPANSION ANCHORS CAST-IN-PLACE INSERTS WILL BE PERMITTED AS

ALL CONTINUOUS VERTICAL OR HORIZONTAL BARS IN FOOTINGS, FOUNDATIONS WALLS, SLABS AND OTHER CONCRETE SHALL BE LAP-SPLICED, WHERE NECESSARY OR DESIRABLE, BY WIRING TOGETHER IN CONTACT. LENGTH OF ALL LAPS SHALL BE 48-BAR DIAMETERS OR 2'-8" MINIMUM, WHICHEVER IS GREATER (EXCEPT AS NOTED BY DRAWINGS). ALL BARS AT END OF CONTINUOUS FOOTINGS OR BEAMS SHALL BE CONTINUOUS TO FAR SIDES OF INTERSECTING

ALL SLABS ON GRADE SHALL BE 4" THICK AND REINFORCED WITH 6x6-10/10 W.W.F. UNLESS OTHERWISE NOTED, LAP FABRIC 8" AT EDGES AND ENDS AND PROVIDE ADDITIONAL REINFORCING WHERE SHOWN ON DRAWINGS. PLACE MESH IN CENTER OF SLAB., USE SLAB BOLSTER AND WIRE TIES TO KEEP FABRIC IN PLACE DURING CONCRETE POUR LIFTING OF W.W.F. WHILE CONCRETE IS BEING POURED IS NOT ACCEPTABLE. MOISTURE BARRIER BENEATH FLOOR SLABS SHALL BE 6 MIL POLYETHYLENE. USE FLAT SHEETS OF WELDED WIRE FABRIC. ROLLS WILL NOT BE PERMITTED.

STRUCTURAL NOTES (CONTINUED):

CONCRETE MASONRY:

ALL CONCRETE MASONRY CONSTRUCTION SHALL CONFORM TO THE REQUIREMENTS OF "SPECIFICATIONS FOR THE DESIGN AND CONSTRUCTION OF LOAD BEARING CONCRETE MASONRY: OF THE NATIONAL CONCRETE MASONRY ASSOCIATION. CONCRETE MASONRY UNITS SHALL CONFORM TO ASTM C-90. ALL CONCRETE BLOCKS SHALL HAVE AN ULTIMATE NET COMPRESSIVE STRENGTH OF 2000 PSI MINIMUM TO GIVE A MINIMUM COMPRESSIVE STRENGTH OF MASONRY ASSEMBLAGE (fm) OF 1500 PSI, UNLESS NOTED

MORTAR SHALL BE ASTM C-270, TYPE "S" FRESHLY PREPARED AND UNIFORMLY MIXED WITH MINIMUM COMPRESSIVE STRENGTH OF 1800 PSI @ 28 DAYS. CONCRETE BLOCK WALLS SHALL BE REINFORCED WITH 8" OR 12" GALVANIZED, TRUSSED, HORIZONTAL MASONRY REINFORCING AT 16" O.C.

MAXIMUM HEIGHT OF GROUT POUR SHALL BE 4'-0" UNLESS CLEAN OUT OPENINGS ARE PROVIDED AT THE BOTTOM OF CELLS TO BE FILLED. ALL GROUT SHALL BE PUDDLED WITH GROUT STICK IMMEDIATELY AFTER POURING.

FILL ALL CELLS CONTAINING REINFORCING STEEL WITH PEA GRAVEL CONCRETE HAVING fc 3000 P.S.I. AT 28 DAYS

CONTINUOUS INSPECTION IS REQUIRED FOR ALL MASONRY WALL CONSTRUCTION.

STRUCTURAL WOOD FRAMING:

PER ROOF SHEATHING SCHEDULE, SHEET S2.5

ALL FRAMING SHALL BE DESIGNED, FABRICATED, AND INSTALLED AS PER AITC AND TPI

ALL WOOD STRUCTURAL MEMBERS SHALL BE SOUTHERN YELLOW PINE CONTROLLED STRESS GRADE LUMBER HAVING A MINIMUM FIBER STRESS OF 2050 P.S.I.

PLYWOOD ROOF SHEATHING SHALL BE FASTENED TO ROOF TRUSSES AND JOISTS

PROVIDE TEMPORARY TOP CHORD BRACING UNTIL ROOF DECK IS IN PLACE.

ALL WOOD MEMBERS EXPOSED TO WEATHER OR BEARING ON CONCRETE OR STEEL SHALL BE PRESSURE TREATED.

DATE REMARKS 12.13.13 PERMIT SET



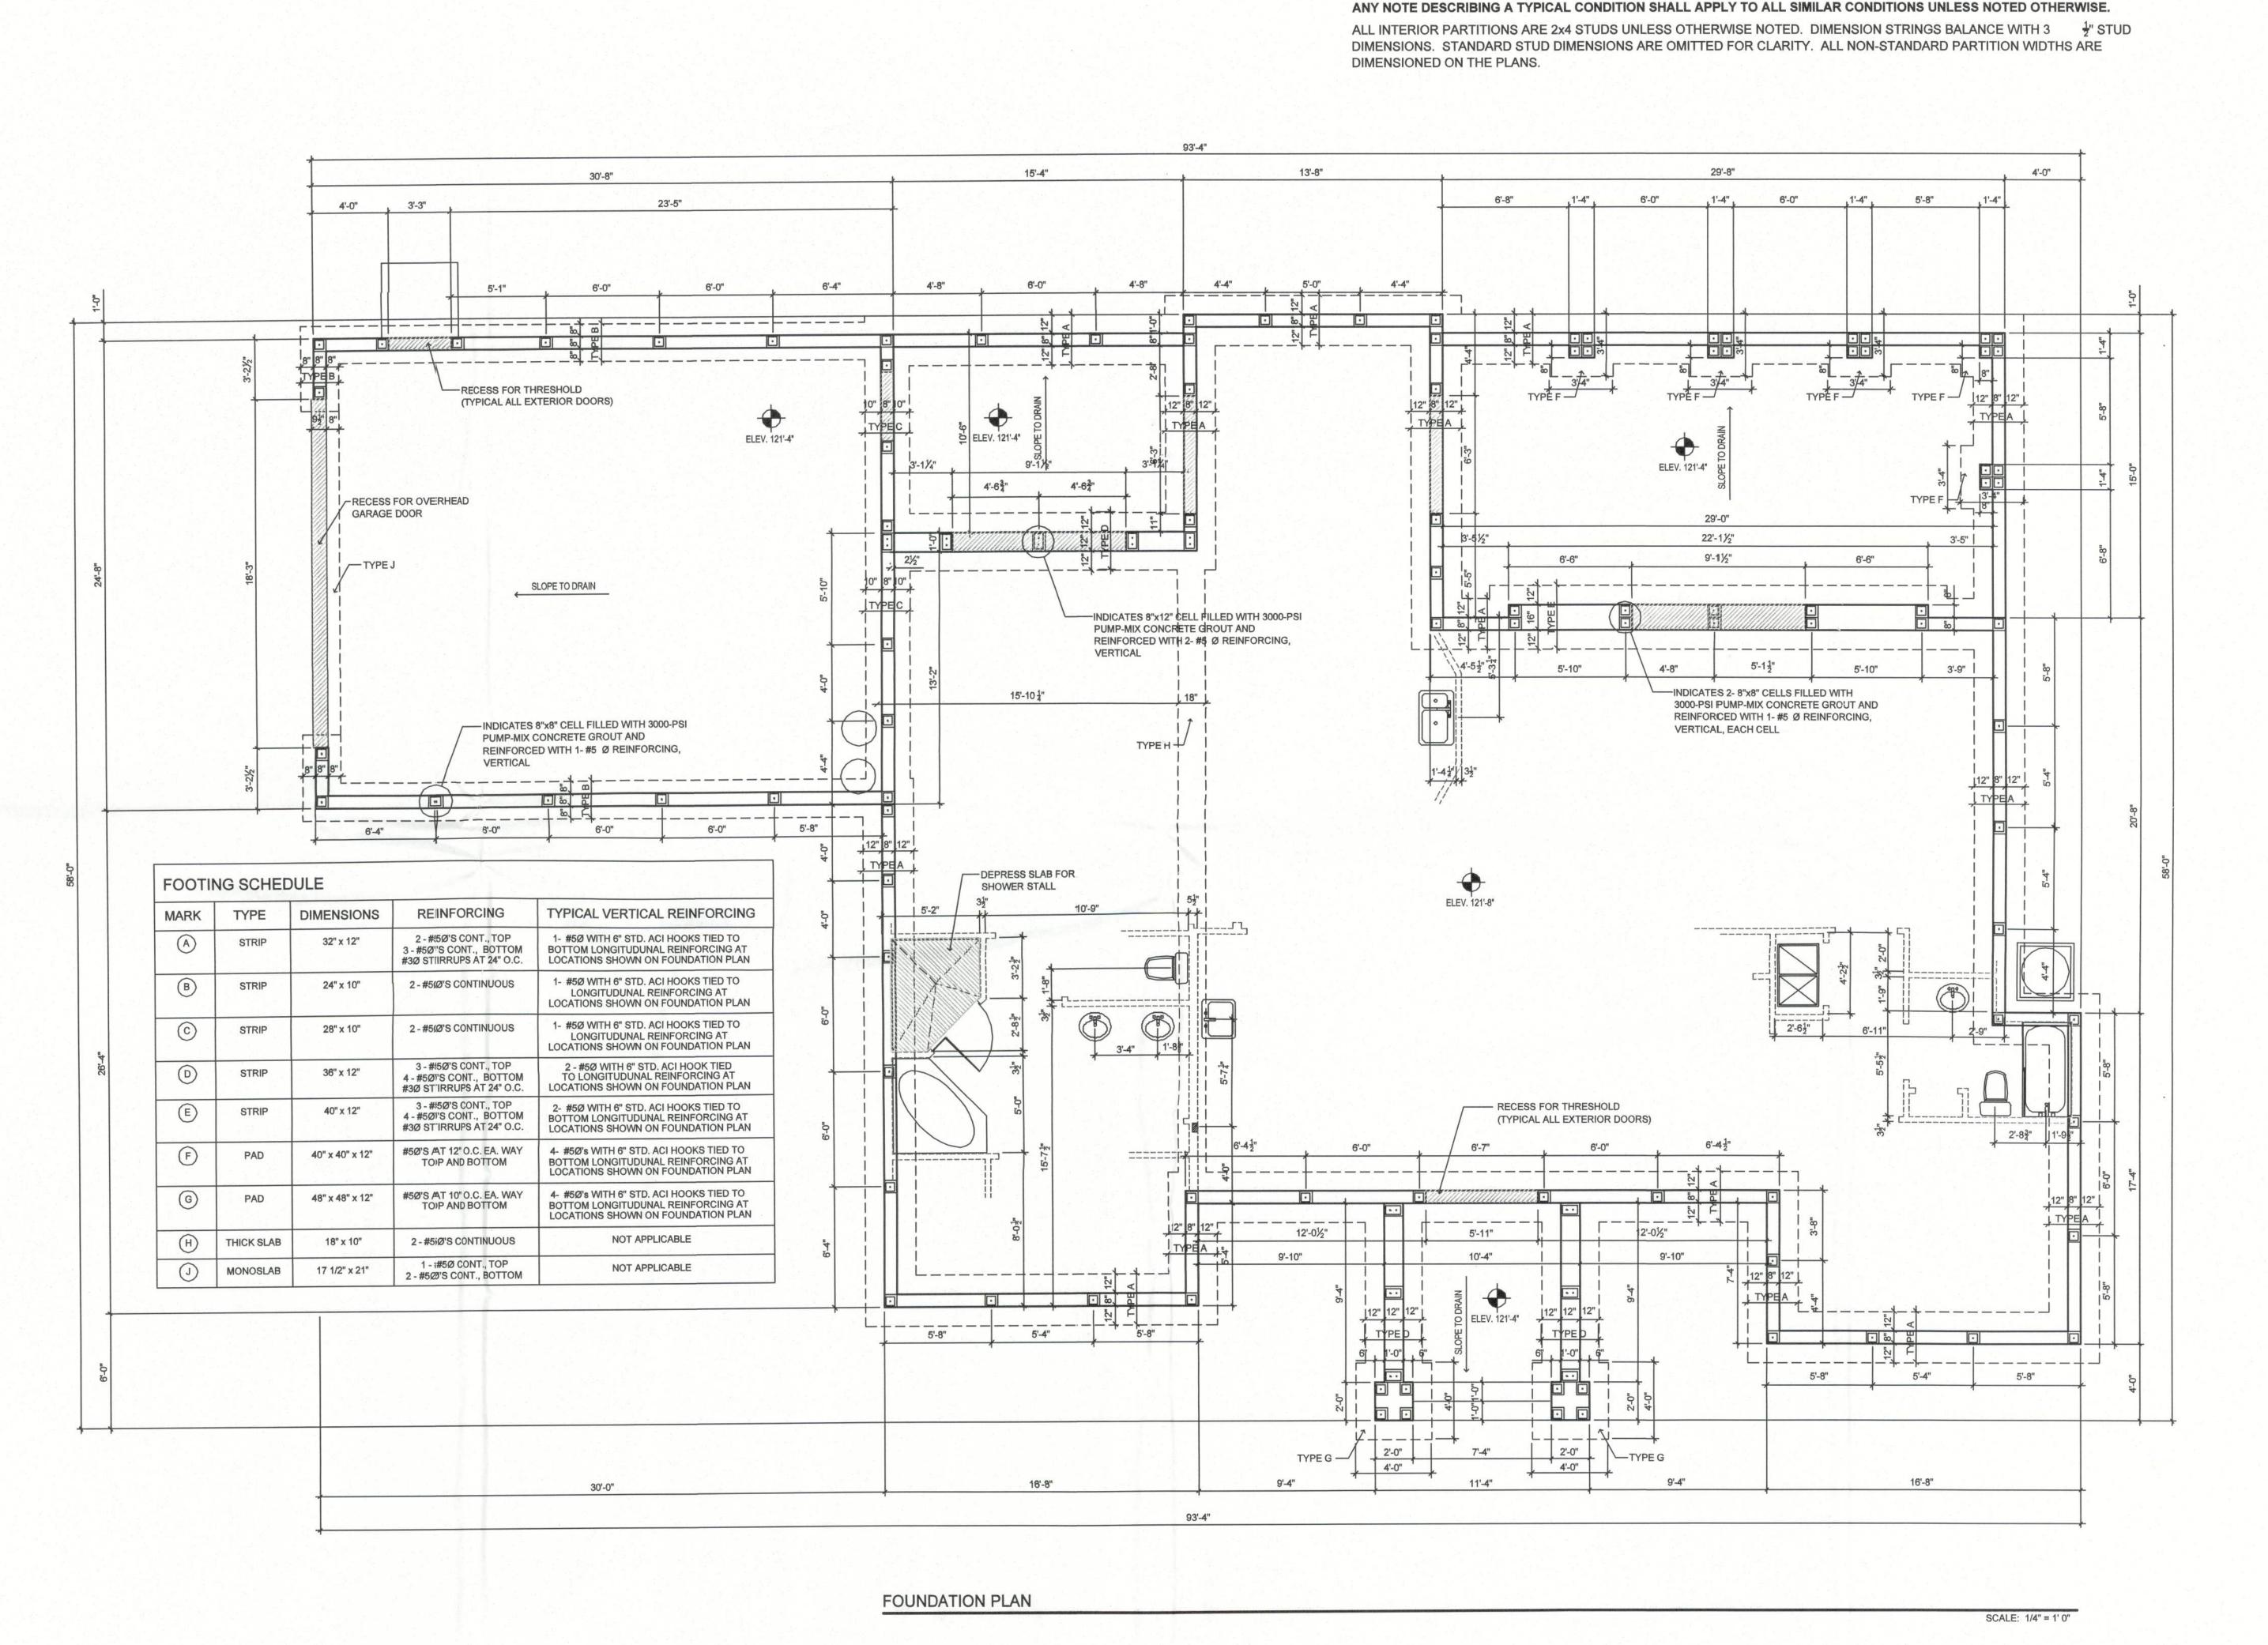


PLANS PREPARED BY AND UNDER THE DIRECT SUPERVISION OF RIDDLE CONSULTING ENGINEERS, INC. AND PAUL D. RIDDLE, P.E.

PETER WOODS, RESIDENTIAL DESIGNER 5524 PECAN RD., OCALA, FL 34472 peter.woods@redesignguru.com (352) 575-4984

PROJECT NO. 131006

THICKNESSES. FOR WOOD FRAMING, PROVIDE CEMENT COATED NAILS, OF LENGTHS REQUIRED. FOR CONCRETE, PROVIDE CASE HARDENED STEEL COUNTERSUNK PHILLIPS HEADS, LENGTHS AS REQUIRED WHEN FASTENING GYPSUM DRYWALL. DUROCK SCREWS WHEN FASTENING DUROCK.



TYPICAL NOTES:

DATE REMARKS

12.13.13 PERMIT SET



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Phone (352) 245-7041
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ROPOSED RESIDENCE

SHEET NUMBER

S2.1

2'-81/2" 4'-7" ELEV. 121'-4" ELEV. 121'-4" SLOPE TO DRAIN 1'-8" 8" 10'-81/2" B" 2'-01/2" ELEV. 121'-4" 2'-51/2" 10'-41/2" 9'-111/2" 2'-9" 6'-2" 3'-0" 4" 15'-73" — INDICATES 5/8" Ø GO-BOLT HURRICANE ANCHORAGE SYSTEM TIE ROD LOCATIONS 5'-01/2" 6'-8" ELEV. 121'-8" 6'-8" 7'-3" 4'-4" [8"] ELEV. 121'-4" 4'-4" 6'-8"

SLAB PLAN SHOWING GO-BOLT LOCATIONS

TYPICAL NOTES:

DIMENSIONED ON THE PLANS.

ANY NOTE DESCRIBING A TYPICAL CONDITION SHALL APPLY TO ALL SIMILAR CONDITIONS UNLESS NOTED OTHERWISE.

DIMENSIONS. STANDARD STUD DIMENSIONS ARE OMITTED FOR CLARITY. ALL NON-STANDARD PARTITION WIDTHS ARE

ALL INTERIOR PARTITIONS ARE 2x4 STUDS UNLESS OTHERWISE NOTED. DIMENSION STRINGS BALANCE WITH 3 2" STUD

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MECHANICAL

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PROPOSED RESIDENCE
ANITA AND JERRY WEST
463 LAKE HARRIS DRIVE, LAKE CITY, FL
PARCEL NUMBER 26-3S-16-02307-005

SHEET NUMBER

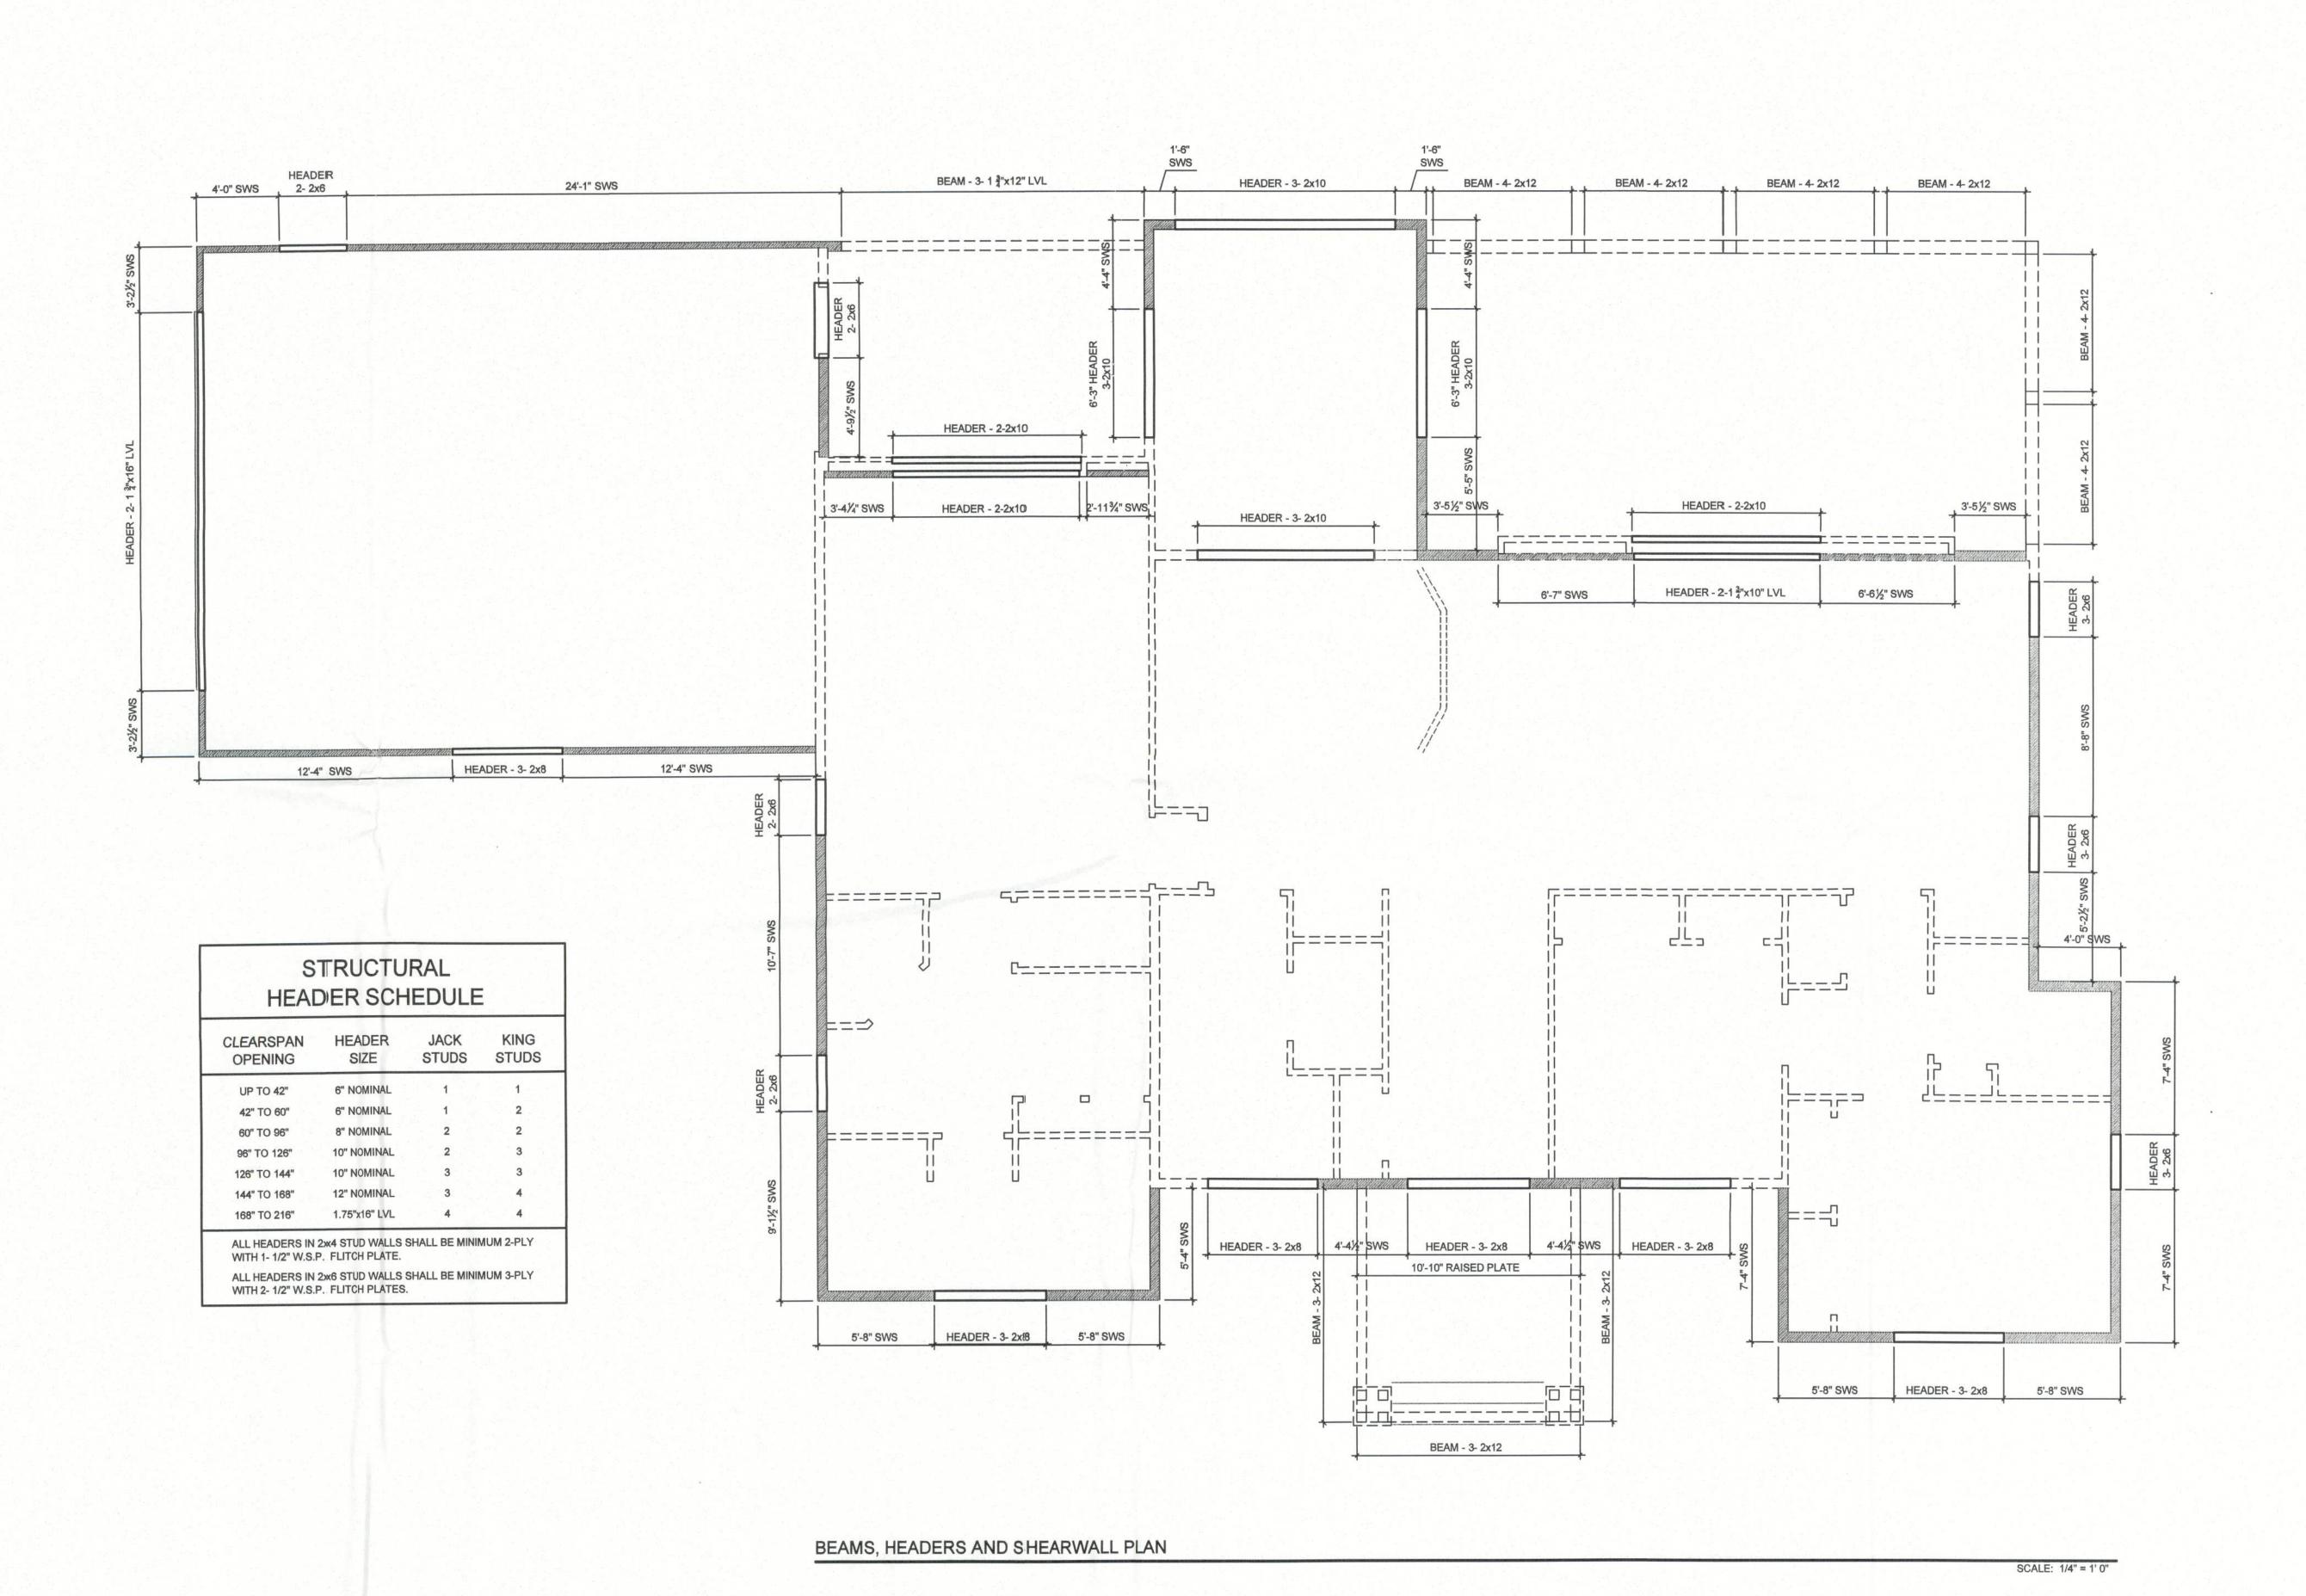
SCALE: 1/4" = 1' 0"

S2.2

TYPICAL NOTES:

ANY NOTE DESCRIBING A TYPICAL CONDITION SHALL APPLY TO ALL SIMILAR CONDITIONS UNLESS NOTED OTHERWISE.

ALL INTERIOR PARTITIONS ARE 2x4 STUDS UNLESS OTHERWISE NOTED. DIMENSION STRINGS BALANCE WITH 3 ½" STUD DIMENSIONS. STANDARD STUD DIMENSIONS ARE OMITTED FOR CLARITY. ALL NON-STANDARD PARTITION WIDTHS ARE DIMENSIONED ON THE PLANS.



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S2.3

-LU24-HG3A LU24 HG7A T-28 LU24 LU24 H13A LU24 LU24 LU24 LU24 LU24 T-12 LU24 T-9 LU24 T-5 T-11 T-8 Cupola T-7 EJ7 17-2 LU24 LU24 LU24 LU24 T-3 LU24 LU24 EJG7 口 IEJ9 EJ11 EJ12 HG11A H9A HG7B J5 T-26 H9B J3 J5 HG7C J5 J3

TYPICAL NOTES:

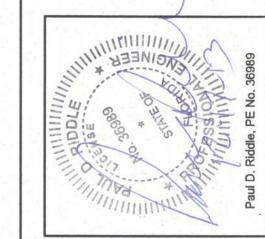
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DIMENSIONS. STANDARD STUD DIMENSIONS ARE OMITTED FOR CLARITY. ALL NON-STANDARD PARTITION WIDTHS ARE

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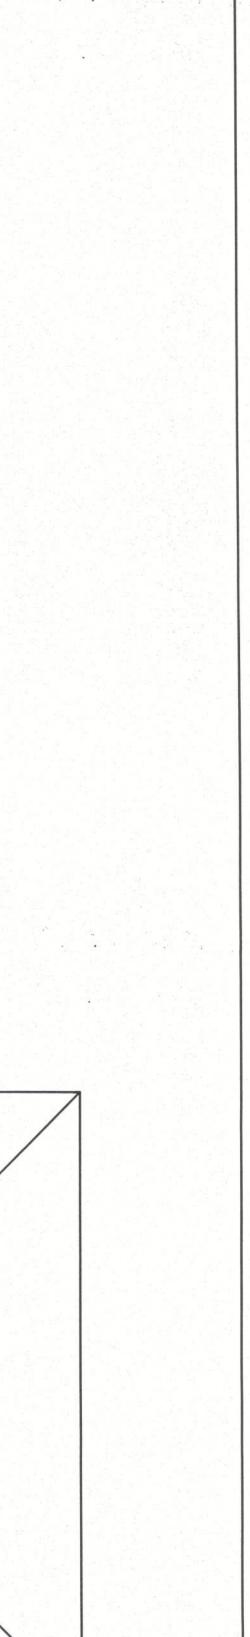
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PROJECT NO. 131006

CUPOLA ROOF FRAMING PLAN

MAIN ROOF FRAMING PLAN

SCALE: 1/4" = 1' 0"



SCALE: 1/4" = 1' 0"

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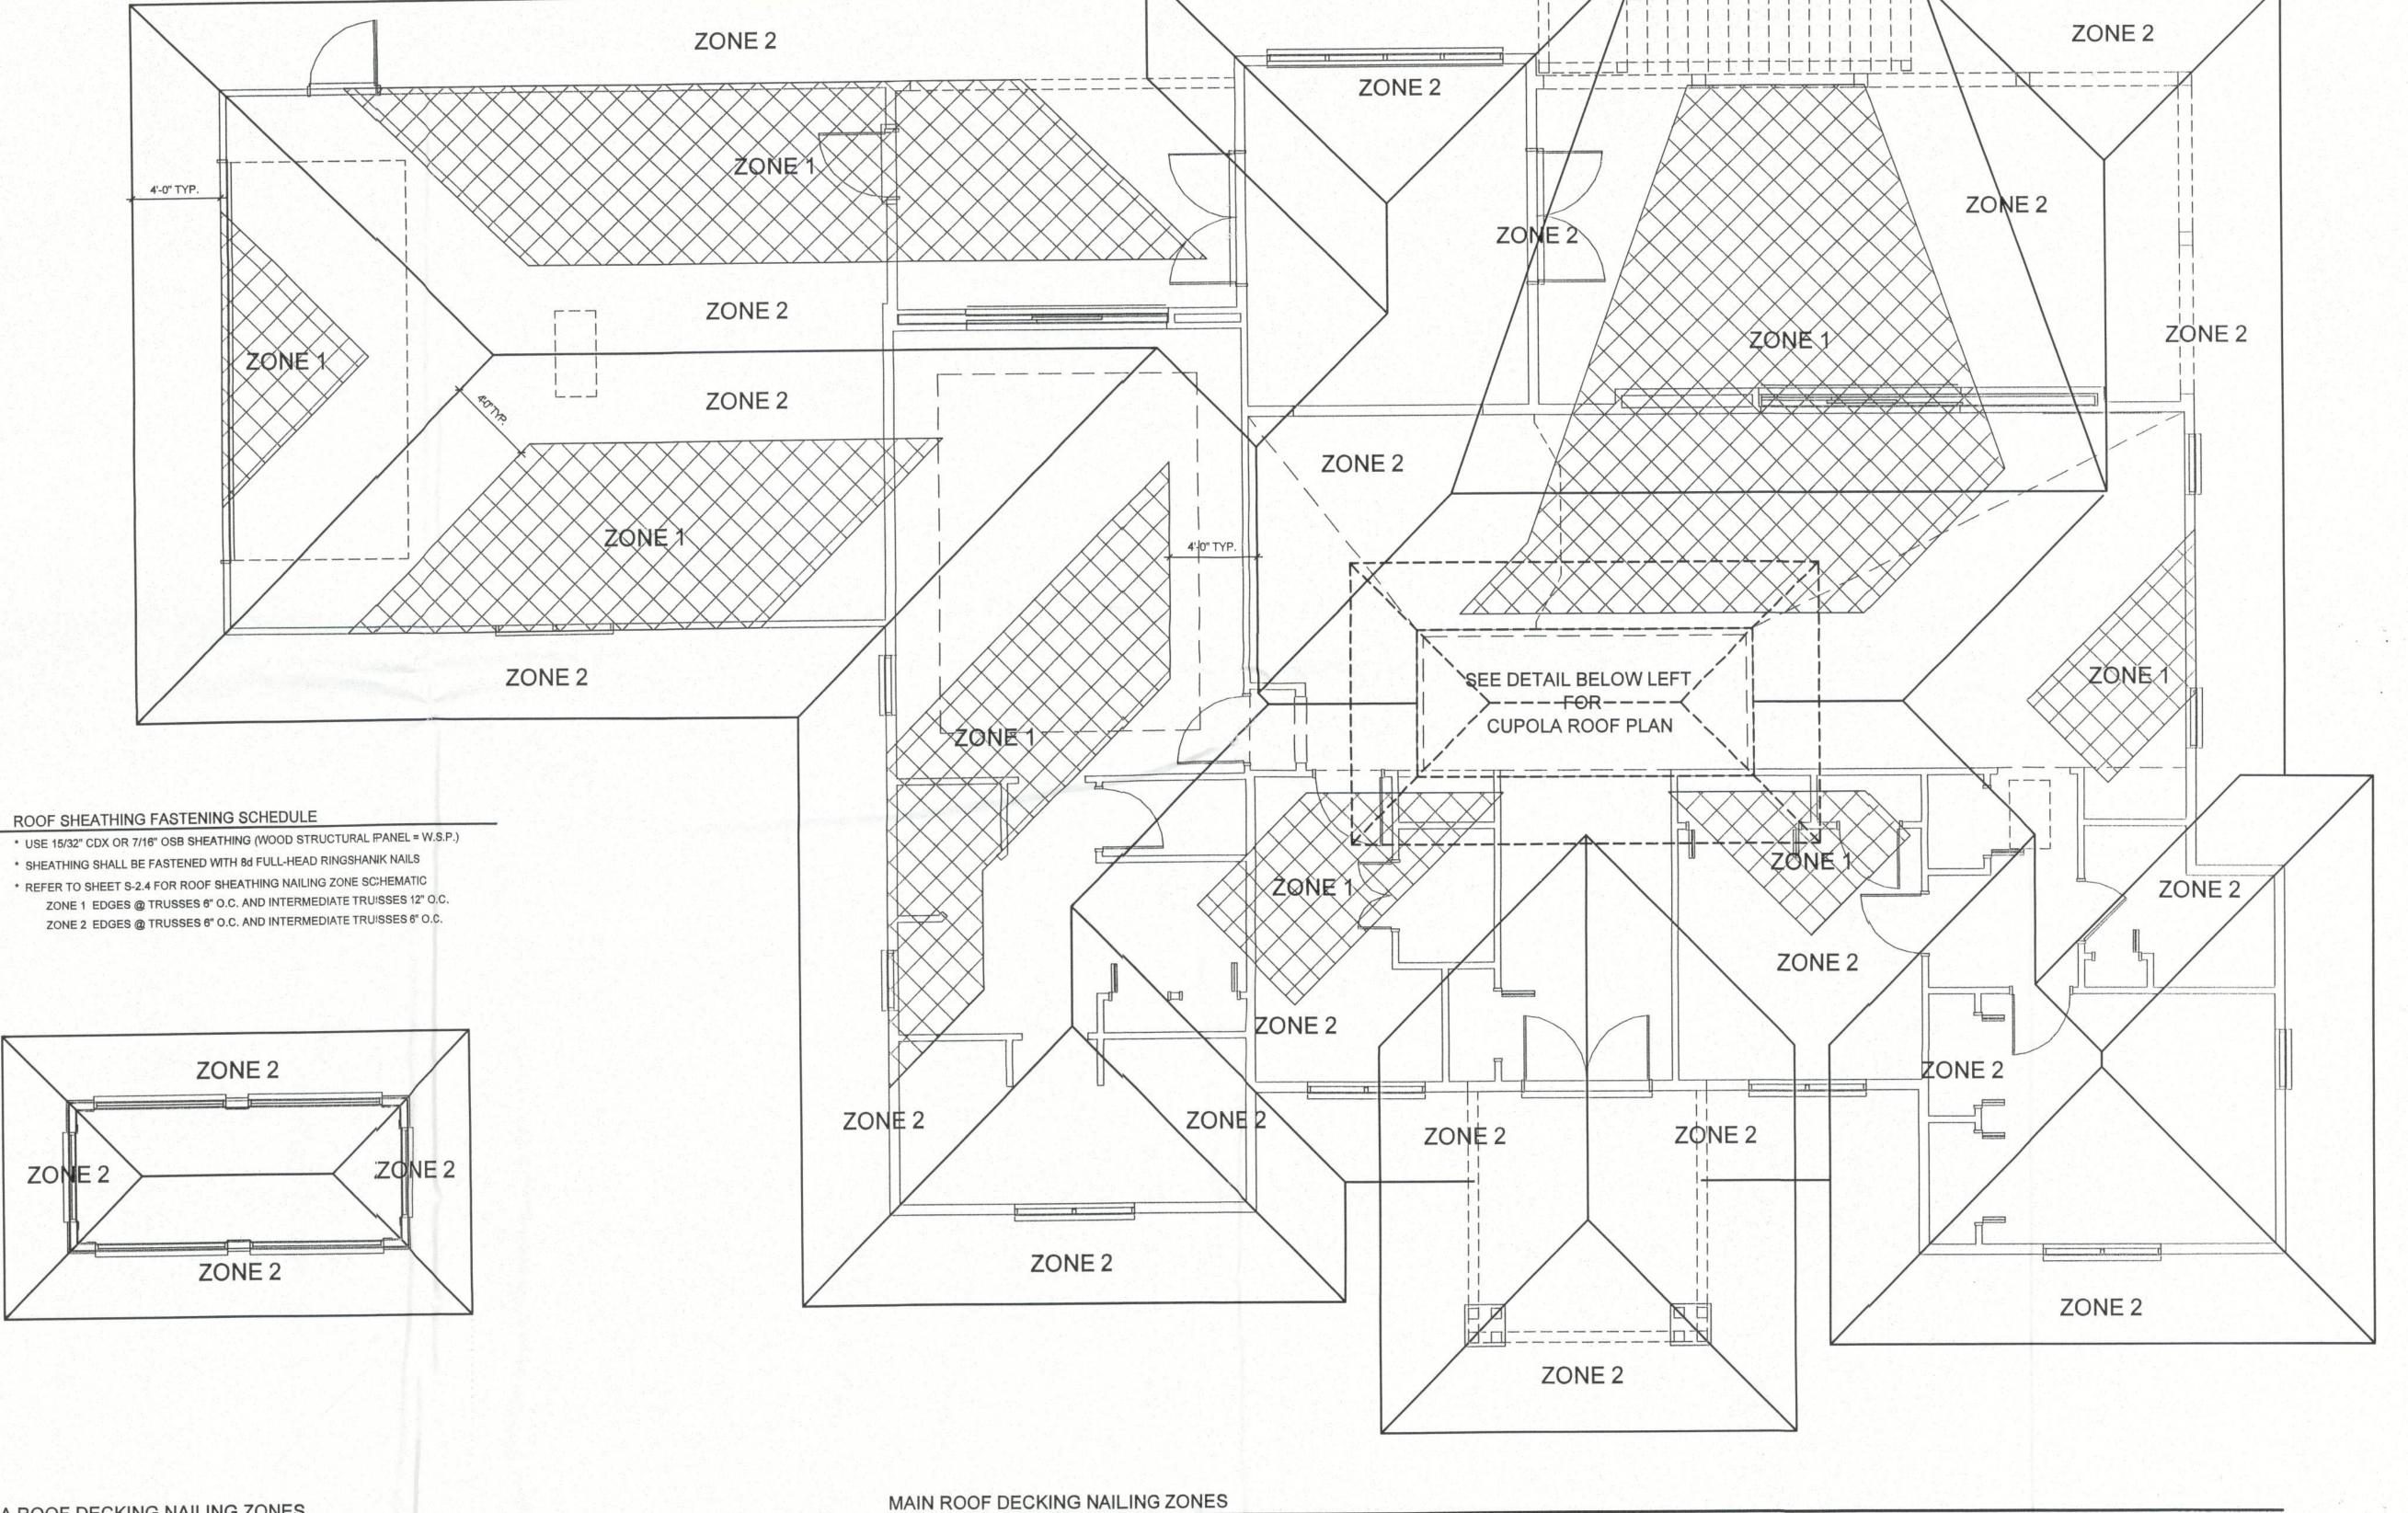
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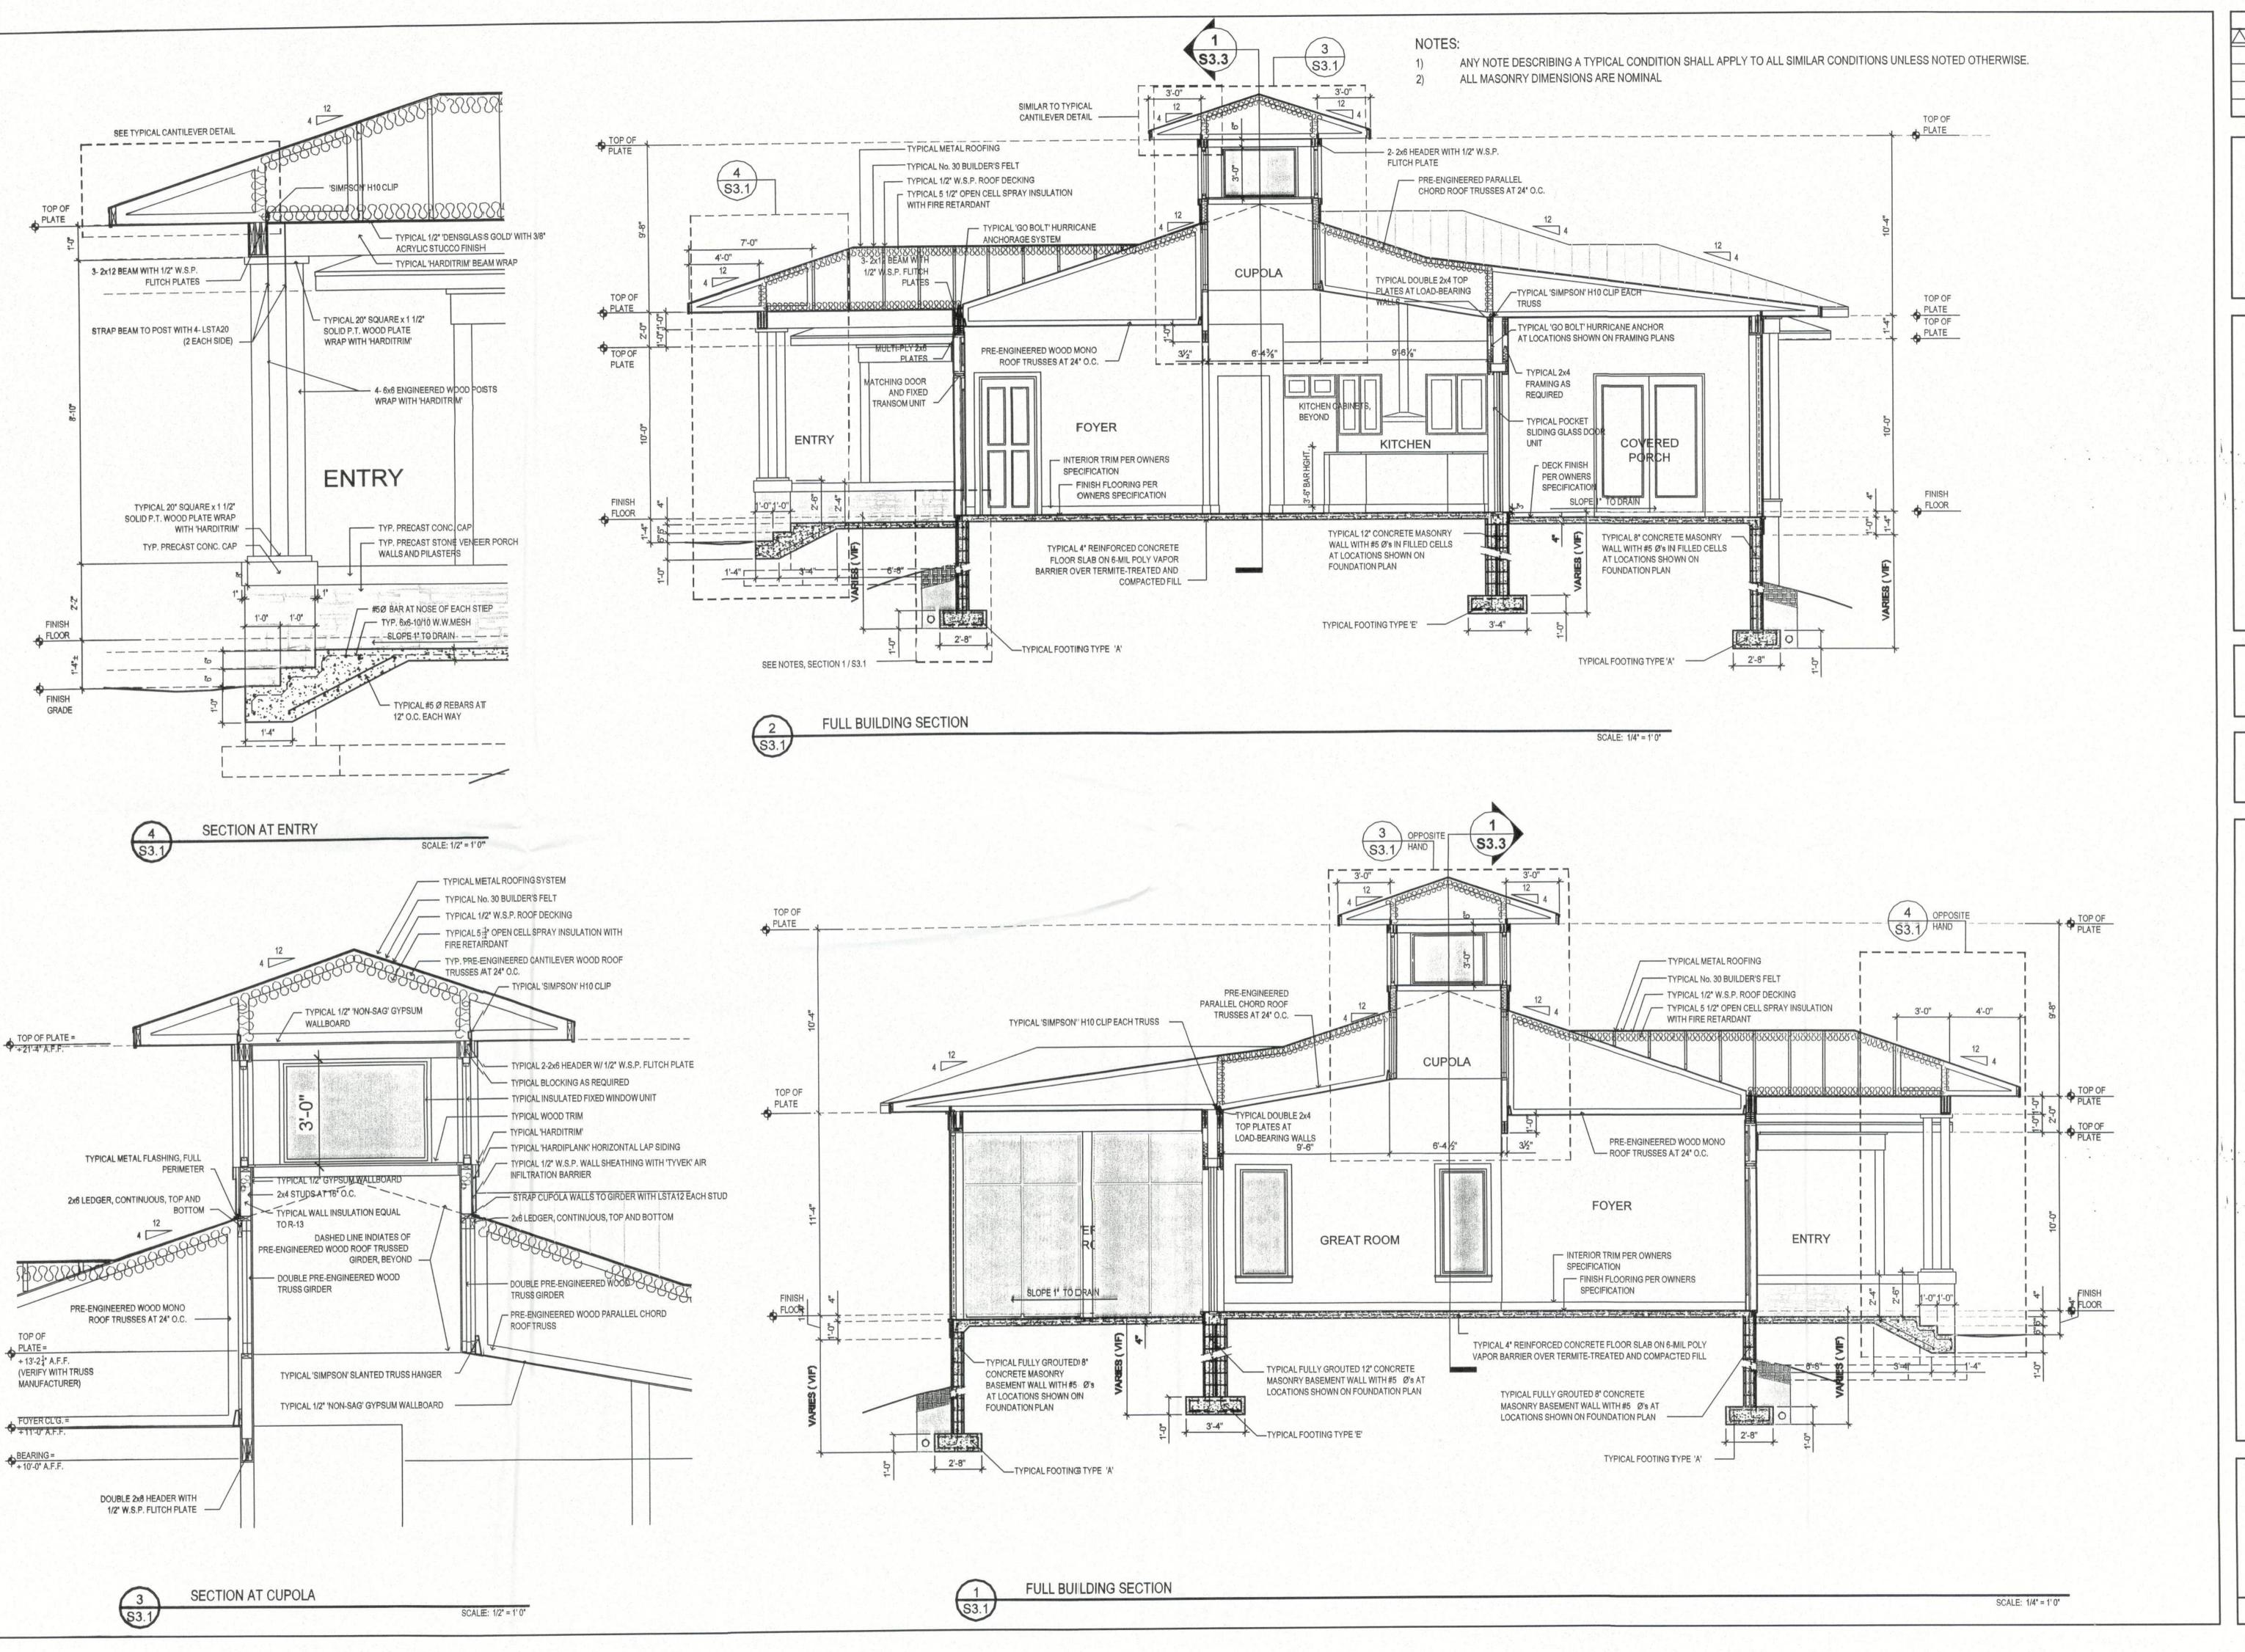
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PROJECT NO. 131006



CUPOLA ROOF DECKING NAILING ZONES

SCALE: 1/4" = 1' 0"



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MECHANICAL

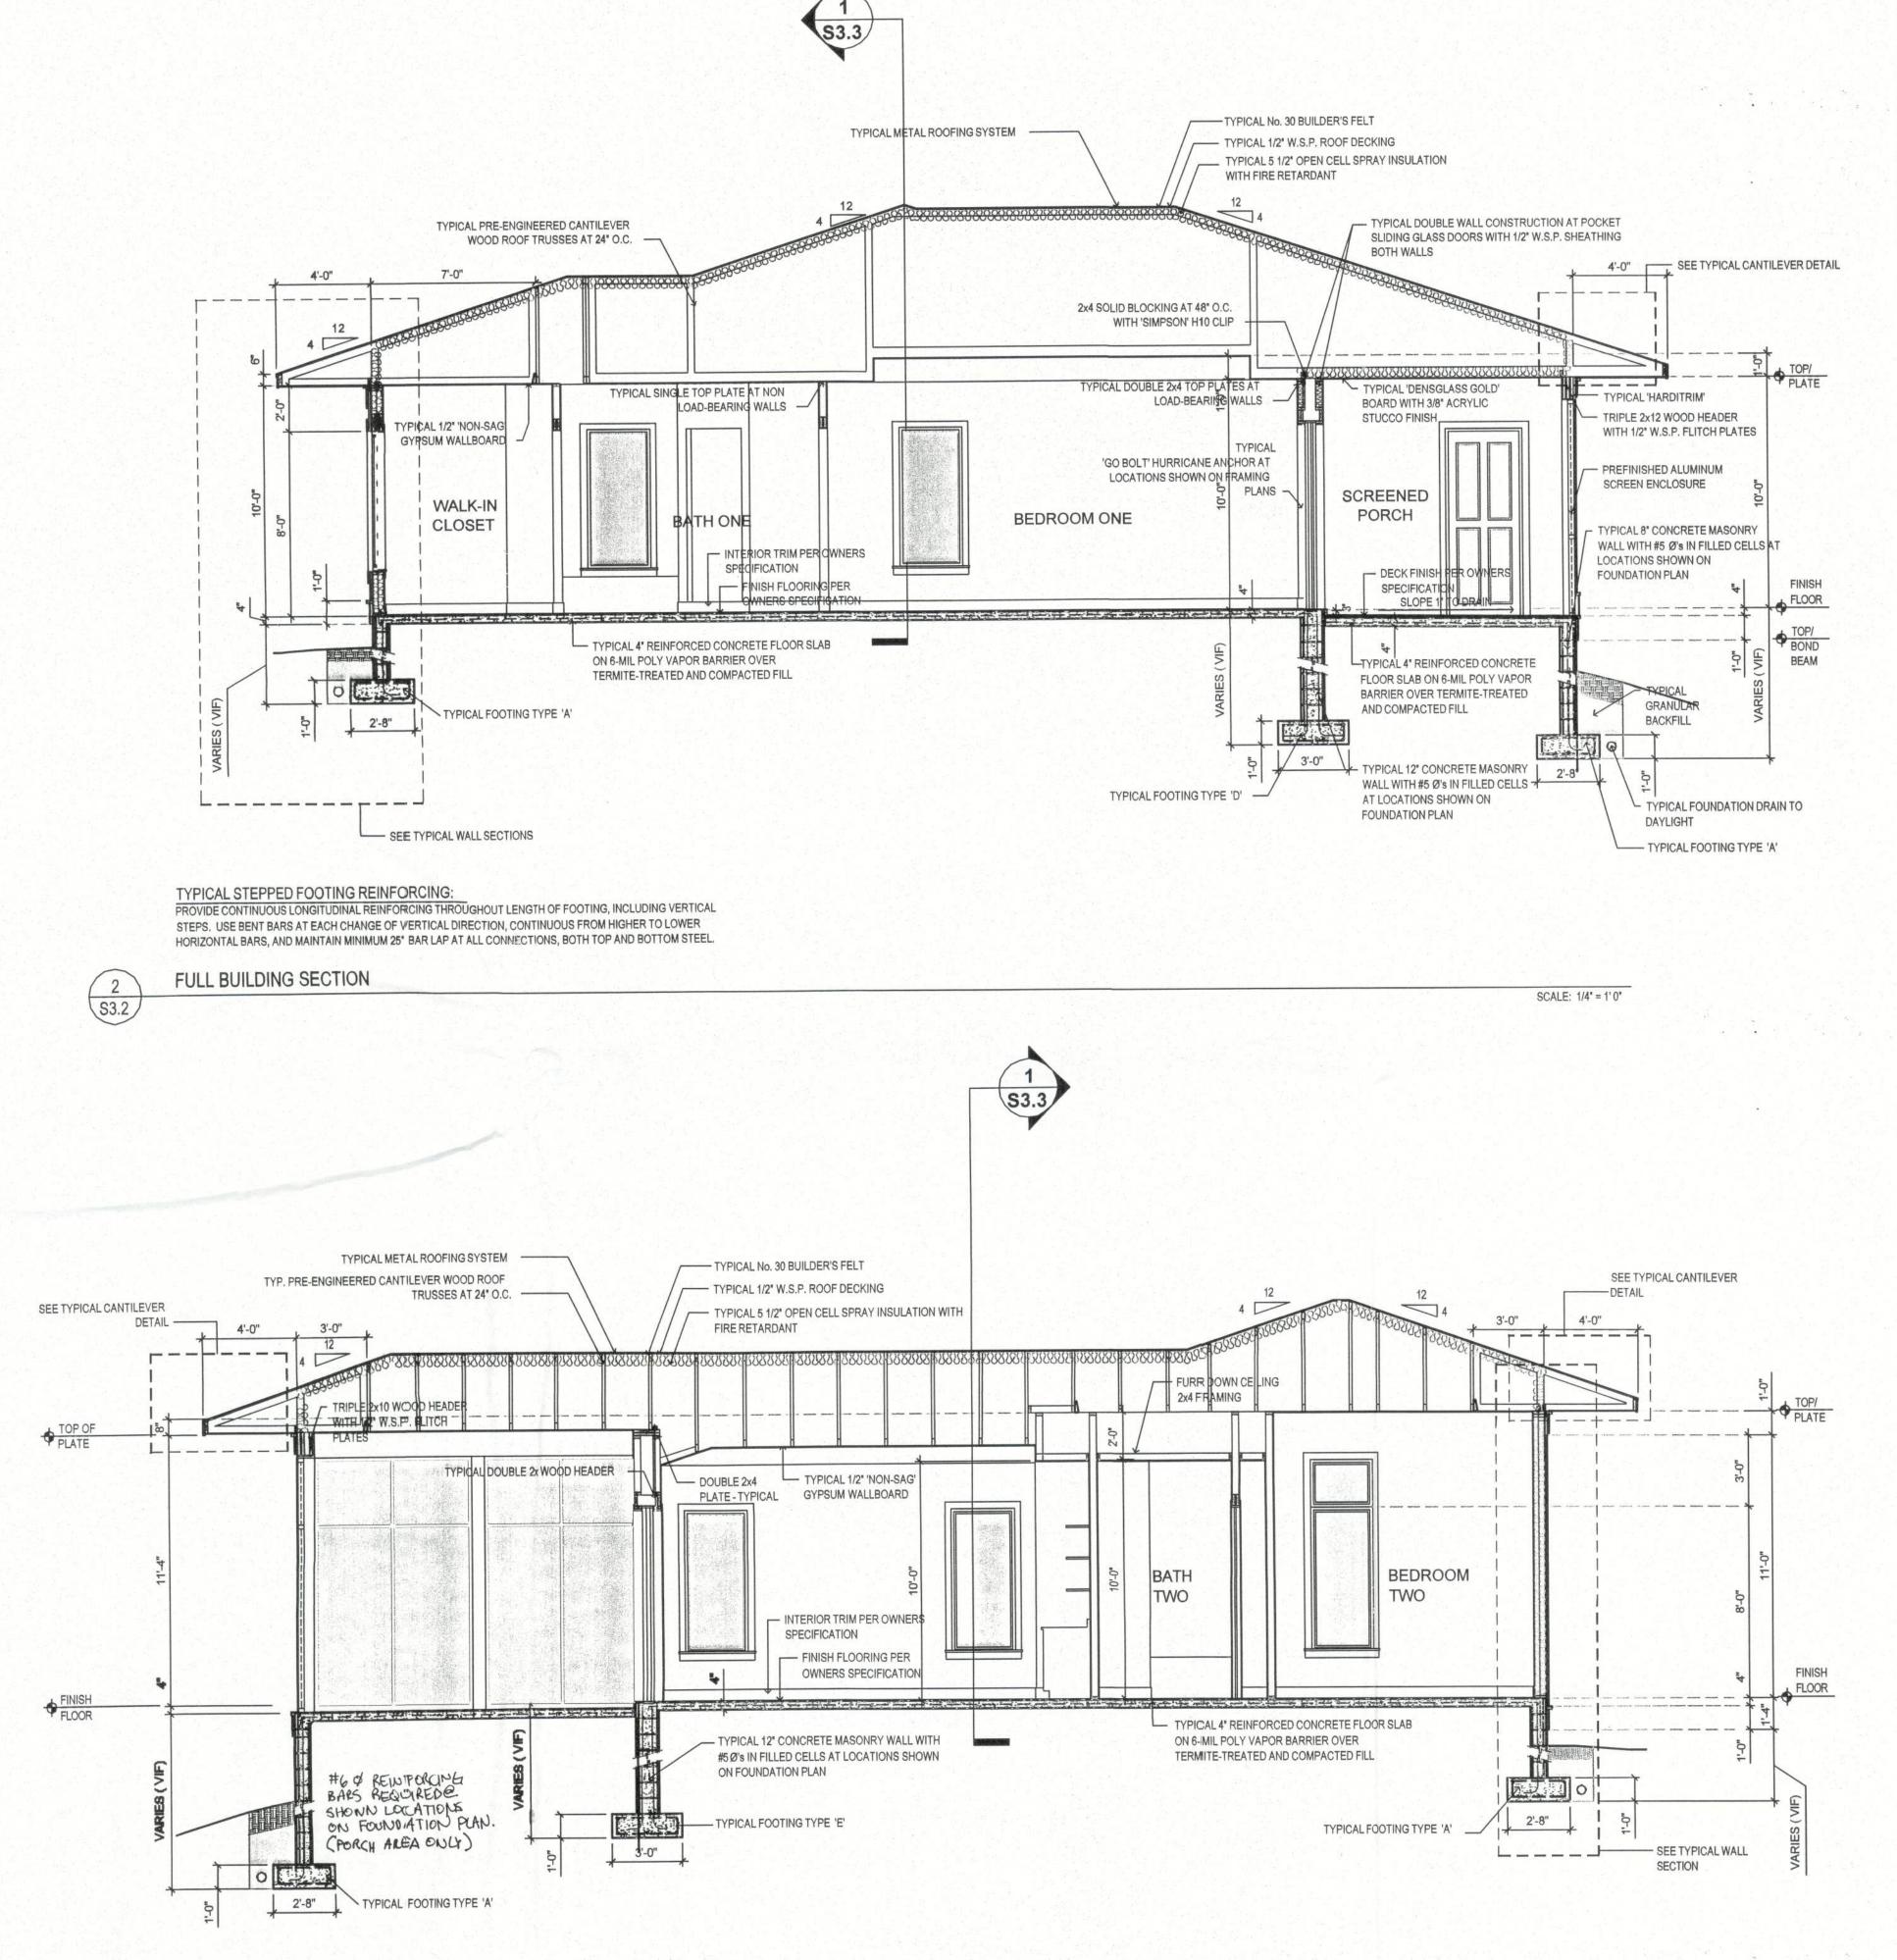
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S3.1



NOTES:

FULL BUILDING SECTION

\$3.2

) ANY NOTE DESCRIBING A TYPICAL CONDITION SHALL APPLY TO ALL SIMILAR CONDITIONS UNLESS NOTED OTHERWISE.

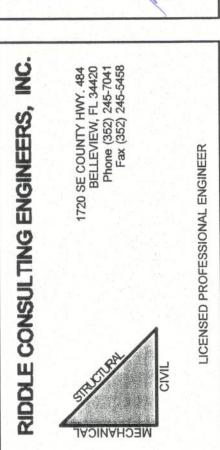
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ALL MASONRY DIMENSIONS ARE NOMINAL

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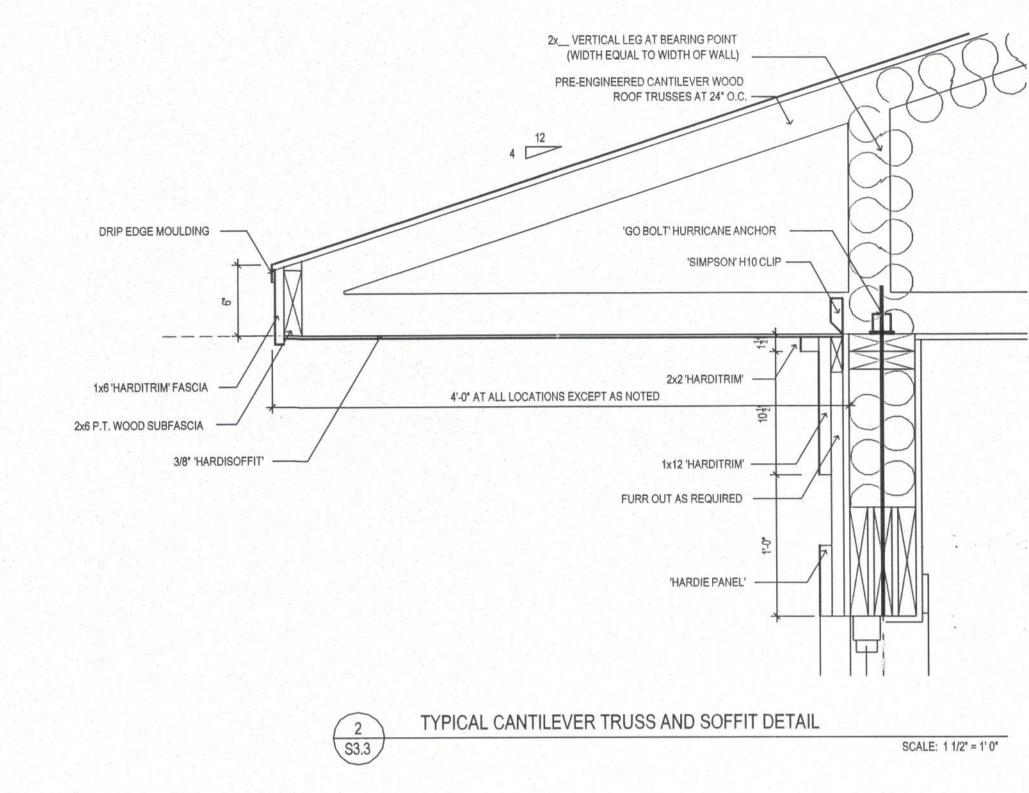
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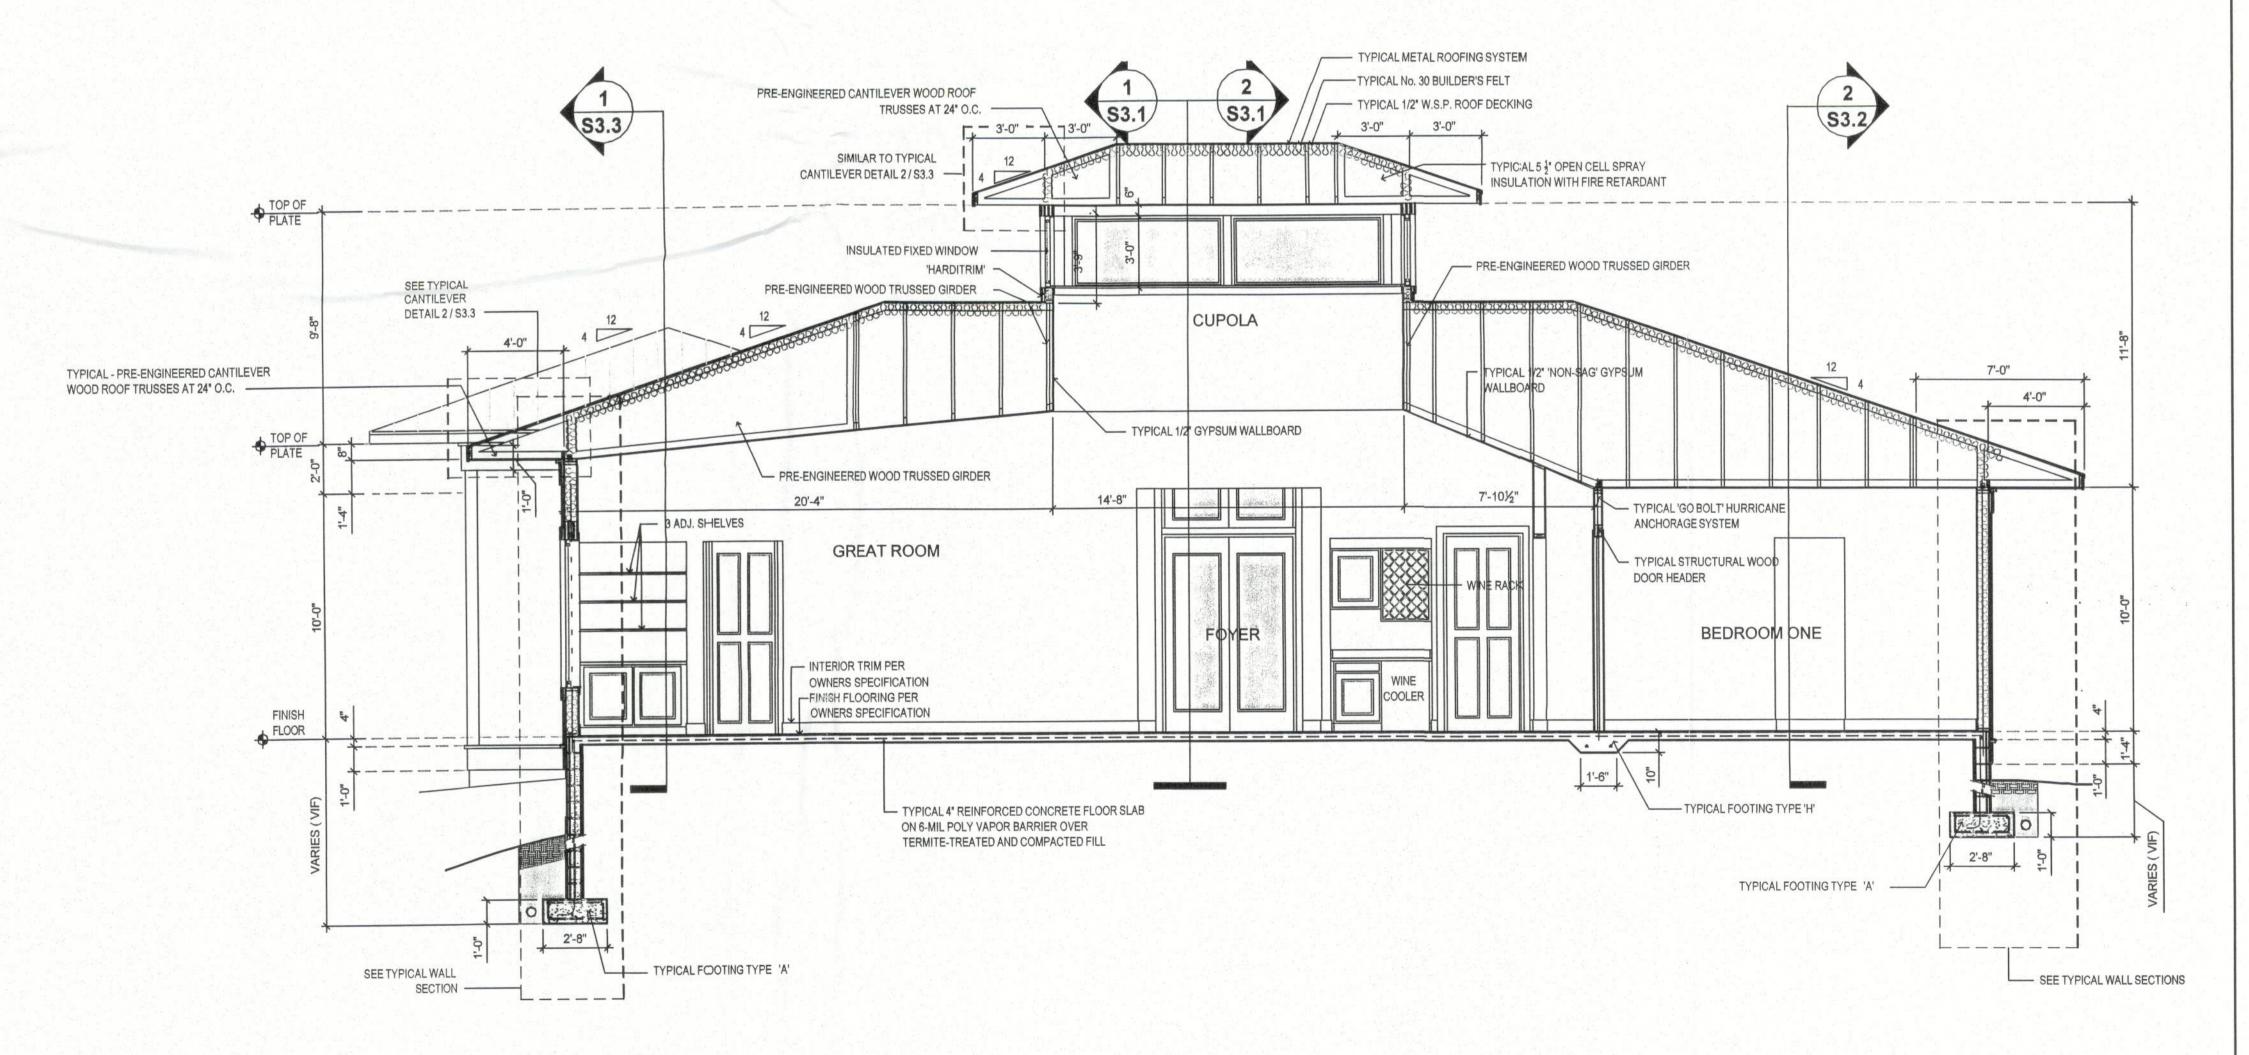
ANITA AND JERRY WEST

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FULL BUILDING SECTION

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