Columbia County New Building Permit Application (14 210) Date Received 7/15/19 By M6 Permit # 38399 Application # 1907-53 For Office Use Only Land Use 12 /4 Date 7-18-19 Flood Zone _ Zoning Official_ FEMA Map # N/A Elevation N/A MFE N/A River N/A Plans Examiner 7.C. NO electric Non Habitable Sturge Front 30' Sides 25 Comments Site Plan State Road Info Sell letter 911 Sheet Parent Parcel # _ □ In Floodway □ Letter of Auth. from Contractor □ Dev Permit # Owner Builder Disclosure Statement 🛮 Land Owner Affidavit 🔻 Ellisville Water ե App Fee Paid 19-0535 OR City Water Applicant (Who will sign/pickup the permit) Phone **Contractors Name Address** ***Include to get updates on this job. Contractor Email Fee Simple Owner Name & Address Bonding Co. Name & Address Architect/Engineer Name & Address Moure & Associates Eng. 1009 E Am. North Augusta SC 29841 Mortgage Lenders Name & Address Circle the correct power company | FL Power & Light | Clay Elec. | Suwannee Valley Elec. Stimated Construction Cost Property ID Number Subdivision Name Driving Directions from a Major Road 20 Past Old Bellainy Rd 441 South, 2nd drive Proposed Use/Occupancy 2 Car Meta Number of Existing Dwellings on Property_

Is the Building Fire Sprinkled? NO If Yes, blueprints included Or Explain

Circle Proposed Culvert Permit or Culvert Waiver or D.O.T. Permit or Have an Existing Drive

Actual Distance of Structure from Property Lines - Front Side 300 + Side 300 + Rear 300 + Community of Stories NA Heated Floor Area Name Total Floor Area 550 Acreage 14, 71

Zoning Applications applied for (Site & Development Plan, Special Exception, etc.)

carolyn1m913agmail.com

CODE: Florida Building Code 2017 and the 2014 National Electrical Code.

Application is hereby made to obtain a permit to do work and installations as indicated. I certify that no work or installation has commenced prior to the issuance of a permit and that all work be performed to meet the standards of all laws regulating construction in this jurisdiction.

TIME LIMITATIONS OF APPLICATION: An application for a permit for any proposed work shall be deemed to have been abandoned 180 days after the date of filing, unless pursued in good faith or a permit has been issued.

TIME LIMITATIONS OF PERMITS: Every permit issued shall become invalid unless the work authorized by such permit is commenced within 180 days after its issuance, or if the work authorized by such permit is suspended or abandoned for a period of 180 days after the time work is commenced. A valid permit receives an approved inspection every 180 days. Work shall be considered not suspended, abandoned or invalid when the permit has received an approved inspection within 180 days of the previous approved inspection.

FLORIDA'S CONSTRUCTION LIEN LAW: Protect Yourself and Your Investment: According to Florida Law, those who work on your property or provide materials, and are not paid-in-full, have a right to enforce their claim for payment against your property. This claim is known as a construction lien. If your contractor fails to pay subcontractors or material suppliers or neglects to make other legally required payments, the people who are owed money may look to your property for payment, even if you have paid your contractor in full. This means if a lien is filed against your property, it could be sold against your will to pay for labor, materials or other services which your contractor may have failed to pay.

NOTICE OF RESPONSIBILITY TO CONTRACTOR AND AGENT: YOU ARE HEREBY NOTIFIED as the recipient of a building permit from Columbia County, Florida, you will be held responsible to the County for any damage to sidewalks and/or road curbs and gutters, concrete features and structures, together with damage to drainage facilities, removal of sod, major changes to lot grades that result in ponding of water, or other damage to roadway and other public infrastructure facilities caused by you or your contractor, subcontractors, agents or representatives in the construction and/or improvement of the building and lot for which this permit is issued. No certificate of occupancy will be issued until all corrective work to these public infrastructures and facilities has been corrected.

WARNING TO OWNER: YOUR FAILURE TO RECORD A NOTICE OF COMMENCEMENT MAY RESULT IN YOU PAYING TWICE FOR IMPROVEMENTS TO YOUR PROPERTY. A NOTICE OF COMMENCEMENT MUST BE RECORDED AND POSTED ON THE JOB SITE BEFORE THE FIRST INSPECTION. IF YOU INTEND TO OBTAIN FINANCING, CONSULT WITH YOUR LENDER OR ATTORNEY BEFORE RECORDING YOUR NOTICE OF COMMENCEMENT.

OWNERS CERTIFICATION: I CERTIFY THAT ALL THE FOREGOING INFORMATION IS ACCURATE AND THAT ALL WORK WILL BE DONE IN COMPLIANCE WITH ALL APPLICABLE LAWS REGULATING CONSTRUCTION AND ZONING.

NOTICE TO OWNER: There are some properties that may have deed restrictions recorded upon them. These restrictions may limit or prohibit the work applied for in your building permit. You must verify if your property is encumbered by any restrictions or face possible litigation and or fines.

breph Medallion book &	**Property owners <u>must sign</u> here <u>before</u> any permit will be issued.
Print Owners Name Owners Signature	
**If this is an Owner Builder Permit Application then, ONL	$oldsymbol{arY}$ the owner can sign the building permit when it is issued.
CONTRACTORS AFFIDAVIT: By my signature I underst	tand and agree that I have informed and provided this
	en responsibilities in Columbia County for obtaining
this Building Permit including all application and per	•
/ Danumy i crime molading an application and por	The time in interestion.
K1/A	
11/77	Contractor's License Number
Contractor's Signature	Columbia County
1000	Competency Card Number
Affirmed under pen <u>alty</u> of perjury to by the <u>Contractor</u> and	d subscribed before me this day of 20
Personally known or Produced Identification	
or roduced recitations	
	SEAL:
State of Florida Notary Signature (For the Contractor)	

NOTICE OF COMMENCEMENT

Tax Parcel Identification Number:

04-75-17-09891-003

Clerk's Office Stamp

Notary Public - State of Florida Commission # FF 919374 My Comm. Expires Oct 17, 2019

Inst: 201912016189 Date: 07/15/2019 Time: 3:10PM

Page 1 of 1 B: 1388 P: 2356, P.DeWitt Cason, Clerk of Court

Columbia, County, By: BD

Deputy Clerk

THE UNDERSIGNED hereby gives notice that improvements will be made to certain real property, and in accordance with Section 713.13 of the Florida Statutes, the following information is provided in this NOTICE OF COMMENCEMENT.
1. Description of property (legal description): $\frac{5}{2}$ of NE /4 of $\frac{5}{2}$ /4 $\frac{5}{2}$ CF 4-7- 17 a) Street (job) Address: $\frac{20+2+5}{2}$ /5 441 High SpH nos FL 32643
2. General description of improvements: CONCIDE SOLD, MCTOL GOINGE, DIO
3. Owner Information or Lessee information if the Lessee contracted for the improvements: a) Name and address: DSP DN MCANION PO BX 2411 High DV NGS
b) Name and address of fee simple titleholder (if other than owner) c) Interest in property
4. Contractor Information at /A
a) Name and address:
b) Telephone No.:/
5. Surety Information (if applicable, a copy of the payment bond is attached):
a) Name and address:
b) Amount of Bond: // C) Telephone No.:
6. Lender
a) Name and address: 1 / A
b) Phone No.
7. Person within the State of Florida designated by Owner upon whom notices or other documents may be served as provided by Section
713.13(1)(a)7., Florida Statutes:
a) Name and address:
b) Telephone No.:
8. In addition to himself or herself, Owner designates the following person to receive a copy of the Lienor's Notice as provided in Section 713.13(I)(b), Florida Statutes:
a) Name: OF
b) Telephone No.:
9. Expiration date of Notice of Commencement (the expiration date will be 1 year from the date of recording unless a different date is specified):
WARNING TO OWNER: ANY PAYMENTS MADE BY THE OWNER AFTER THE EXPIRATION OF THE NOTICE OF COMMENCEMENT ARE CONSIDERED IMPROPER PAYMENTS UNDER CHAPTER 713, PART I, SECTION 713.13, FLORIDA STATUTES, AND CAN RESULT IN YOUR PAYING TWICE FOR IMPROVEMENTS TO YOUR PROPERTY; A NOTICE OF COMMENCEMENT MUST BE RECORDED AND POSTED ON THE JOB SITE BEFORE THE FIRST INSPECTION. IF YOU INTEND TO OBTAIN FINANCING, CONSULT YOUR LENDER OR AN ATTORNEY BEFORE COMMENCING WORK OR RECORDING YOUR NOTICE OF COMMENCEMENT.
STATE OF FLORIDA \ \ \ \ \ \ \ \ \ \ \ \ \ \ \ \ \ \ \
COUNTY OF COLUMBIA 10 DO MICHELLIAN
Signature of Owner or Lessee or Owner's or Lessee's Authorized Office/Director/Partner/Manager
Printed Name and Signatory's Title/Office
1 Annual Signatury 3 Haley Strike
The foregoing instrument was acknowledged before me, a Florida Notary, this 15th day of 20 19 by:
loseph Medallin - Kumar Ruider - Jacob Mondallin
(Name of Person) (Type of Authority) (name of party on behalf of whom instrument was executed)
(name of party on behalf of whom instrument was executed)
Personally Known OR Produced Identification Type + (
Notary Signature CX TAMMY J CREWS
Notary Signature Notary Stamp of Stamp



COLUMBIA COUNTY BUILDING DEPARTMENT

135 NE Hernando Ave., Suite B-21 Lake City, FL 32055

Office: 386-758-1008 Fax: 386-758-2160

OWNER BUILDER DISCLOSURE STATEMENT

I understand that state law requires construction to be done by a licensed contractor and have applied for an owner-builder permit under an exemption from the law. The exemption specifies that I, as the owner of the property listed, may act as my own contractor with certain restrictions even though I do not have a license.

I understand that building permits are not required to be signed by a property owner unless he or she is responsible for the construction and is not hiring a licensed contractor to assume responsibility.

I understand that, as an owner-builder, I am the responsible party of record on a permit. I understand that I may protect myself from potential financial risk by hiring a licensed contractor and having the permit filed in his or her name instead of my own name. I also understand that a contractor is required by law to be licensed and bonded in Florida and to list his or her license numbers on permits and contracts.

I understand that I may build or improve a one-family or two-family residence or farm outbuilding. I may also build or improve a commercial building if the costs do not exceed \$75,000. The building or residence must be for my own use or occupancy. It may not be built or substantially improved for sale or lease. If a building or residence that I have built or substantially improved myself is sold or leased with in 1 year after the construction is complete, the law will presume that I built or substantially improved it for sale or lease, which violates the exemption.

I understand that, as the owner-builder, I must provide direct, onsite supervision of the construction.

I understand that I may not hire an unlicensed person to act as my contractor or to supervise persons working on my building or residence. It is my responsibility to ensure that the persons whom I employ have the licenses required by law and by county or municipal ordinance.

I understand that it is frequent practice of unlicensed persons to have the property owner obtain an owner-builder permit that erroneously implies that the property owner is providing his or her own labor and materials. I, as an owner-builder, may be held liable and subjected to serious financial risk for any injuries sustained by an unlicensed person or his or her employees while working on my property. My homeowner's insurance may not provide coverage for those injuries. I am willfully acting as an owner-builder and am aware of the limits of my insurance coverage for injuries to workers on my property.

I understand that I may not delegate the responsibility for supervising work to a licensed contractor who is not licensed to perform the work being done. Any person working on my building who is not licensed must work under my direct supervision and must be employed by me, which means that I must comply with laws requiring the withholding of federal income tax and social security contributions under the Federal Insurance Contributions Act (FICA) and must provide workers' compensation for the employee. I understand that my failure to follow these laws may subject me to serious financial risk.

I agree that, as the party legally and financially responsible for this proposed construction activity, I will abide by all applicable laws and requirements that govern owner-builders as well as employers. I also understand that the construction must comply with all applicable laws, ordinances, building codes, and zoning regulations.

I understand that I may obtain more information regarding my obligations as an employer from the Internal Revenue Service, the United States Small Business Administration, the Florida Department of Financial Services, and the Florida Department of Revenue. I also understand that I may contact the Florida Construction Industry Licensing Board at 850-487-1395 or Internet website address http://www.myfloridalicense.com/dbpr/ for more information about licensed contractors.

I am aware of, and consent to, an owner-builder building permit applied for in my name and understand that I am the party legally and financially responsible for the proposed construction activity at the following address:

204248 US 441 High Spnngs FL 32643

I agree to notify Columbia County Building Department immediately of any additions, deletions, or changes to any of the information that I have provided on this disclosure. Licensed contractors are regulated by laws designed to protect the public. If you contract with a person who does not have a license, the Construction Industry Licensing Board and Department of Business and Professional Regulation may be unable to assist you with any financial loss that you sustain as a result of a complaint. Your only remedy against an unlicensed contractor may be in civil court. It is also important for you to understand that, if an unlicensed contractor or employee of an individual of firm is injured while working on your property, you may be held liable for damages. If you obtain an owner-builder permit and wish to hire a licensed contractor, you will be responsible for verifying whether the contractor is properly licensed and the status of the contractor's workers' compensation coverage.

I understand that if I hire subcontractors they must be licensed for that type of work in Columbia County, ex: framing, stucco, masonry, and state registered builders. Registered Contractors must have a minimum of \$300,000.00 in General Liability insurance coverage and the proper workers' compensation. Specialty Contractors must have a minimum of \$100,000.00 in General Liability insurance coverage and the proper workers' compensation coverage.

Before a building permit can be issued, this disclosure statement must be completed and signed by the property owner and returned to Columbia County Building Department.

TYPE OF CONSTRUCTION

() Single Family Dwelling () Two-Family Residence () Farm Outbuilding
() Addition, Alteration, Modification or other Improvement
() Commercial, Cost of Construction for construction of
() Other Metal 2 caraptage on concrete slab
statement for exemption from contractor licensing as an owner/builder. I agree to comply with
all requirements provided for in Florida Statutes allowing this exception for the construction
permitted by Columbia County Building Permit.
Notary Signature Date 7/15/19 Date 7/15/19 Date Notary Signature Date 7/15/19 Date 7/15/19
TAMMY J CREWS Notary Public - State of Florida Commission # FF 919374 My Comm. Expires Oct 17, 2019
I hereby certify that the above listed owner builder has been given notice of the restriction
stated above.
Building Official/Representative

Revised: 7-1-15 DISCLOSURE STATEMENT 15 Documents: B&Z Forms



@ CAM110M01	54,612 Land AG 36,323 Bldg	000 001 * 005 L B*
City, St HIGH SPRINGS FL Zip 32655 Y Y 2015 Country (PUD1) (PUD2) Splt/Co S 0618 JVChgCd pud4 pud5 Appr By SC Date 11/07/2017 AppCode UseCd 000200 MOBILI TxDist Nbhd MktA ExCode Exemption/% TxC 003 4717.00 02 HX 25000	(PUD3) M pud6 E HOME Code Units	KTA02
## DIST 3 House# 20424 Street US HIGHWAY 441 MD - City HIGH SPRINGS Zip Subd N/A Condo .00 N/A Sect 4 Twn 7S Rnge 17 Subd Blk Legals S1/2 OF NE1/4 OF SE1/4, EX RD R/W & EX 5 AC ON WI PROPERTY. 304-389, 398-438, 1 Map# Mnt 6/19/20 F1=Task F2=Extx F3=Exit F4=Prompt F11=Docs F10=GoTo	Lot EST END OF	



STATE OF FLORIDA DEPARTMENT OF HEALTH ONSITE SEWAGE TREATMENT AND DISPOSAL SYSTEM APPLICATION FOR CONSTRUCTION PERMIT

DATE PAID:	PERMIT NO.	19.	25	35
	DATE PAID:	77	12	179
	FEE PAID:	V	00	CAN
RECEIPT #: 2 40(0)	RECEIPT #:	14	241	YO

Page 1 of 4

APPLICATION FOR:
[] New System [] Existing System [] Holding Tank [] Innovative [] Repair [] Abandonment [] Temporary []
APPLICANT: Joseph Medallon
AGENT:TELEPHONE: 2454-510
MAILING ADDRESS: PO BOX 2411, High Springs, FL 32655
TO BE COMPLETED BY APPLICANT OR APPLICANT'S AUTHORIZED AGENT. SYSTEMS MUST BE CONSTRUCTE BY A PERSON LICENSED PURSUANT TO 489.105(3) (m) OR 489.552, FLORIDA STATUTES. IT IS THE APPLICANT'S RESPONSIBILITY TO PROVIDE DOCUMENTATION OF THE DATE THE LOT WAS CREATED OR PLATTED (MM/DD/YY) IF REQUESTING CONSIDERATION OF STATUTORY GRANDFATHER PROVISIONS.
PROPERTY INFORMATION
LOT: BLOCK: SUBDIVISION: PLATTED:
PROPERTY ID #: 34-75 -17-0989/2003 ZONING: I/M OR EQUIVALENT: [Y N
PROPERTY SIZE: ACRES WATER SUPPLY: [X] PRIVATE PUBLIC []<=2000GPD []>2000GPD
IS SEWER AVAILABLE AS PER 381.0065, FS? [Y/N] DISTANCE TO SEWER:
PROPERTY ADDRESS: 204245 U5 HWY 441 HIGHSDYINGS FL
DIRECTIONS TO PROPERTY:
15 How 441 between Dld Bellamy
- 4 Parcy Ra
BUILDING INFORMATION RESIDENTIAL [] COMMERCIAL
Unit Type of No. of Building Commercial/Institutional System Design No Establishment Bedrooms Area Sqft Table 1, Chapter 64E-6, FAC
1 Metal garage NA 550'
4
•
[] Floor/Equipment Drains [] Other (Specify)
SIGNATURE: DATE: 7/15/19
DH 4015, 08/09 (Obsoletes previous editions which may not be used) Incorporated 64E-6 001 FAC

STATE OF FLORIDA DEPARTMENT OF HEALTH APPLICATION FOR CONSTRUCTION PERMIT

Permit Application Number

er 9-0535

----- PART II - SITEPLAN -----MEDALLION/LICAUSID Existing CR 01-8760 Existing OSTDS well on front of property Non Occupied Unpaved drive Vacant 150' Waterline Vacant TBM in 20" oak ' 375' to ROAD 677 **'** Site 1 No slope Site 2 2001 >75' to well 9531 Site Plan submitted by: Plan Approved Not Approved Date County Health Department ALL CHANGES MUST BE APPROVED BY THE COUNTY HEALTH DEPARTMENT

DH 4015, 08/09 (Obsoletes previous editions which may not be used) Incorporated: 64E-6.001, FAC (Stock Number: 5744-002-4015-6)

Page 2 clf4



STRUCTURAL DESIGN ENCLOSED BUILDING

MAXIMUM 30'-0" WIDE X 20'-0" EAVE HEIGHT- BOX EAVE FRAME

14 December 2018 Revision 7 M&A Project No. 16062S/16155S/16207S/17155S/17200S/18068S/18156S/18290S

Prepared for:

Steel Buildings and Structures, Inc. P.O. Box 1287 Mt. Airy, NC 27030

Prepared by:

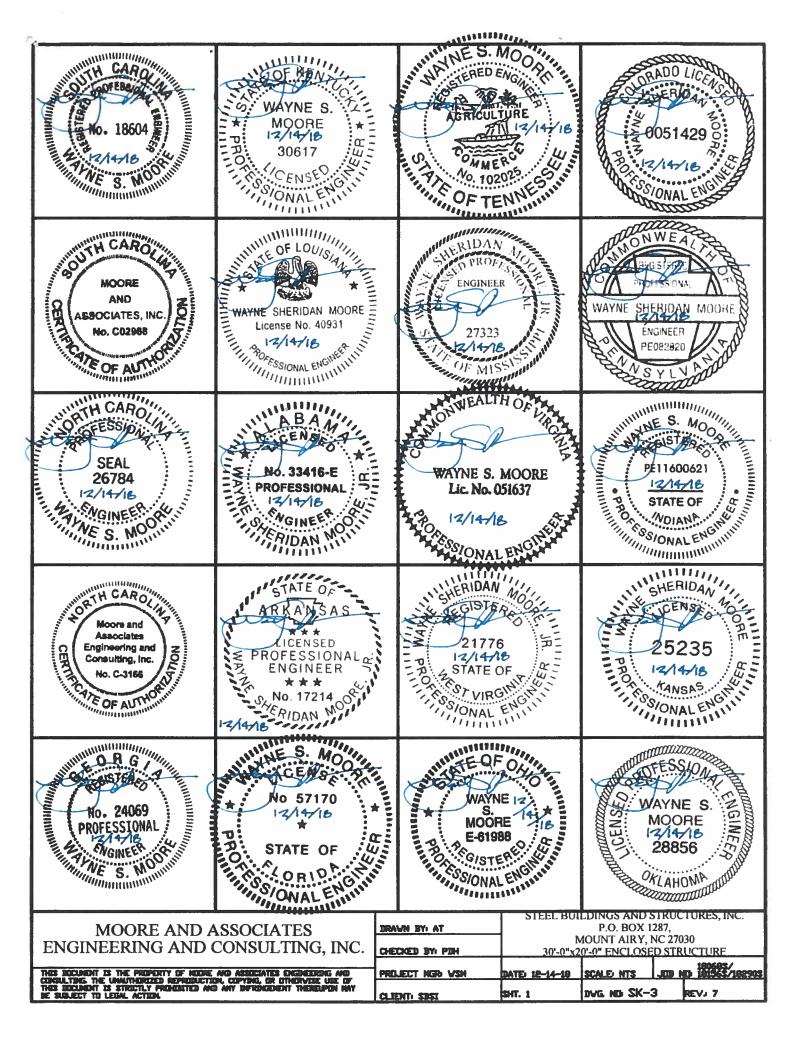
Moore and Associates Engineering and Consulting, Inc.

1009 East Avenue North Augusta, SC 29841

401 S. Main St., Suite 200 Mount Airy, NC 27030







OF MARY NO 4974A SONAL ENGINEERS 12/14/16	Professional Certification. I hereby certify that these documents were prepared approved by me, and that I a duly licensed professional engineer under the laws of the State of Maryland, License No. 49744, Expiration Date 6/6/20	or am			
WAYNE S. MOORE NUMBER PE-2016030730 12/14/18 13/ONAL ENGINEER					
SHERIDAN MO 23734 POLESSIONAL ENGINEER					
WAYNE S. MOORE 120644 CENSE OSIONAL ENGINEER					
MOORE AND A ENGINEERING AND	CONSULTING, INC.	DRAWN BY: AT CHECKED BY: PDH	30'-0"x2	P.O. BOX 128 MOUNT AIRY, NO 10'-0" ENCLOSED	27030
THIS ECCUMENT IS THE PROPERTY OF MOUSE CONSULTING THE UNIVERSITIED REPREDICTI THIS ECCUMENT IS STRUCTLY PREMIUMED AN HE SUBJECT TO LEGAL ACTION	MO ASSOCIATES ENGINEERING MO EN, CEPYING, OR UTHERVISE USE OF ED ANY ENTRIGEMENT THERELIPON MAY	PRILECT HGB VSH CLIENT: SBSI	DATE: 12-14-18 SHT. 1A	DWG ND SK-3	REV. 7

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            PE SEAL COVER SHEET (2 OF 2)
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            DRAWING INDEX
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SHEET 16
            OPTIONAL BASE RAIL ON TIMBER BEAM
SHEET 17
             WITH SOIL NAIL
SHEET 18
            OPTIONAL CONCRETE STRIP FOOTING
```

		CIEEL BILL	LIMAL-S AND	STRUCTURES, INC.
MOORE AND ASSOCIATES	DRAWN BY: AT	STEEL BOI	P.O. BOX I	,
ENGINEERING AND CONSULTING, INC.	CHÉCKED BY: PDH	-	MOUNT AIRY, I	NC 27030 ED STRUCTURE
			T	JUB ND 181565/1825

CLIENT: SBSI

DIVG. ND: SK-3

SHT. 2

180683/ 181565/18290S

REVJ 7

INSTALLATION NOTES AND SPECIFICATIONS

- 1. DESIGN IS FOR MAXIMUM 30'-0" WIDE x 20'-0" EAVE HEIGHT ENCLOSED STRUCTURES.
- 2. DESIGN WAS DONE IN ACCORDANCE WITH THE 2017 FLORIDA BUILDING CODE (FBC) 6TH EDITION, 2018 NORTH CAROLINA BUILDING CODE, 2006 INTERNATIONAL BUILDING CODE (IBC), 2009 IBC, 2012 IBC AND 2015 IBC.
- 3. DESIGN LOADS ARE AS FOLLOWS:

A) DEAD LOAD

= 1.5 PSF

B) LIVE LOAD

- = 12 PSF
- C) GROUND SNOW LOAD = 30 PSF (< 26'-0"), 35 PSF (26'-0" (W < 30'-0") (UNBALANCED SNOW LOADS DUE TO DRIFTING HAVE NOT BEEN EVALUATED.)
- 4. 3-SECOND GUST ULTIMATE WIND SPEED (V_{ULT}) 105 TO 145 MPH (NOMINAL WIND SPEED 82 TO 112 MPH): MAXIMUM RAFTER/COLUMN AND END COLUMN SPACING = 5.0 FEET (UNLESS NOTED OTHERWISE).
- 5. END WALL COLUMNS (POST) ARE EQUIVALENT TO SIDE WALL POSTS UNLESS NOTED OTHERWISE.
- 6. RISK CATEGORY I.
- 7. WIND EXPOSURE CATEGORY B
- 8. SPECIFICATIONS APPLICABLE TO 29 GAUGE METAL PANELS FASTENED DIRECTLY TO 2 1/2" x 2 1/2" 14 GAUGE TUBE STEEL (TS) FRAMING MEMBERS (UNLESS NOTED OTHERWISE).
- 9. AVERAGE FASTENER SPACING ON-CENTERS ALONG RAFTERS OR HAT CHANNELS, AND COLUMNS (INTERIOR OR END) = 8 INCHES.
- 10. FASTENERS CONSIST OF 1/4"x3/4" SELF-DRILLING FASTENER (SDF), USE CONTROL SEAL WASHER WITH EXTERIOR FASTENERS.

 SPECIFICATIONS APPLICABLE ONLY FOR MEAN ROOF HEIGHT OF 20 FEET OR LESS, AND ROOF SLOPES OF 14" (3:12 PITCH) OR LESS SPACING REQUIREMENTS FOR OTHER ROOF HEIGHTS AND/OR SLOPES MAY VARY.
- 11. GROUND ANCHORS SHALL BE INSTALLED THROUGH BASE RAIL WITHIN 6° DF EACH COLUMN.
- 12. GROUND ANCHORS CONSIST OF #4 REBAR W/ WELDED NUT x 36' LONG IN SUITABLE SOIL CONDITIONS. OPTIONAL ANCHORAGE MAY BE USED IN SUITABLE SOILS AND MUST BE USED IN UNSUITABLE SOILS AS NOTED.
- 13. WIND FORCES GOVERN OVER SEISMIC FORCES. SEISMIC PARAMETERS ANALYZED ARE:

SDIL SITE CLASS = D RISK CATEGORY I/II/III

R= 3.25

I_E= 1.0

Sps= 2.039

V= CsW

 $S_{B1} = 1.258$

14. WINDOW AND BOOK DESIGN PRESSURES ARE APPLICABLE TO THE STATE OF FLORIDA ONLY.

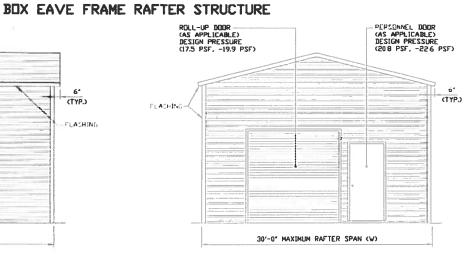
MOORE AND ASSOCIATES ENGINEERING AND CONSULTING, INC.

THIS EXCLUENT IS THE PROPERTY OF HIGHE AND ASSOCIATES ENGINEERING AND COMMULTING. THE UNMITTABLED REPRODUCTION, COPYDING, OR OTHERWISE USE OF THIS ENCLUENT IS STREETLY PROHIBITED AND ANY INTRINGEMENT THEREUPON MAY BE SUBJECT TO LEGAL ACTION.

STEEL BUILDINGS AND STRUCTURES, INC. P.O. BOX 1287. DRAWN BY: AT MOUNT AIRY, NC 27030 CHECKED BY: PDH 30'-0"x20'-0" ENCLOSED STRUCTURE JUB ND 18136\$/18290\$ PROJECT NGB VSH DATE: 12-14-19 SCALE NTS SHT. 3 DWG ND SK-3 CLIENT: SPSI

VINDUV (AS APPLICABLE) DESIGN PRESSURE (218 PSF, -236 PSF) LEVET - VARIES DEPENDING UN NUMBER AND GRACING OF RACTURE

TYPICAL SIDE ELEVATION
SCALE: NTS



TYPICAL END ELEVATION
SCALE: NTS

MOORE AND ASSOCIATES
ENGINEERING AND CONSULTING, INC.

THES EXCLUSION IS THE PROPERTY OF MODEL AND ASSOCIATES ENGINEERING AND COMMULTING, THE UNAUTHORIZED REPRODUCTION, COPYING, OR OTHERWISE USE OF THIS EXCLUSION IS STRUCTLY PRODUCTED AND ANY DEFENDEMENT THEREUPON MAY BE SUBJECT TO LEGAL ACTION.


	CLIENT: SBSI	SHT. 3A	ING. ND SK-3		REV. 7	
_	PROJECT NGB VSN	DATE: 12-14-18	SCALE NTS	Jun	ND 181565/182905	
•	CHECKED 311 PM1	30-0 X2	T			
	CHECKED BY: PDH		P.O. BOX 1287, MOUNT AIRY, NC 27030 30'-0"x20'-0" ENCLOSED STRUCTURE			
	BRAVN BY: AT	_				
		STEEL BU	LDINGS AND	STRU	CTURES, INC.	

WINDOV (AS APPLICABLE) DESIGN PRESSURE GEIGN PRESSU

TYPICAL SIDE ELEVATION


TYPICAL END ELEVATION
SCALE: NTS

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THES ECCURENT IS THE PROPERTY OF ROOME AND ASSOCIATES ENGINEERING AND	PREJECT NEW VSH	DATE: 12-14-19	SCALE NTS	JUB ND 18156\$/18290\$
MOORE AND ASSOCIATES ENGINEERING AND CONSULTING, INC.	CHECKED BY: PDH		MOUNT AIRY, I	•
MOODE AND ACCOCIATED	DRAWN BY: AT	STEEL BUI	LDINGS AND S P.O. BOX 1:	STRUCTURES, INC.

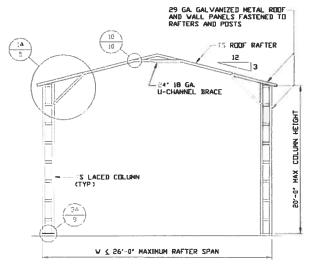


TYPICAL RAFTER/COLUMN FRAME SECTION

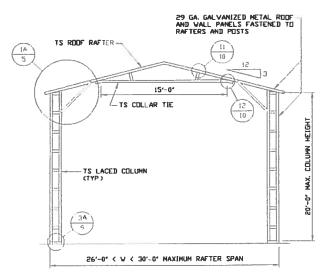SCALE: NTS



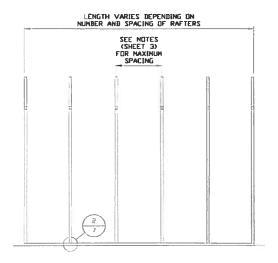
TYPICAL RAFTER/COLUMN FRAME SECTION
SCALE: NTS



TYPICAL RAFTER/COLUMN SIDE FRAMING SECTION


SCALE: NTS

i	1 STEEL BUI	TOIMOS WIND S	STRUCTURES, INC.
DRAWN BY: AT		P.O. BOX 12	287,
] N	OUNT AIRY, N	NC 27030
CHECKED BY: PDH	30'-0"x2	0'-0" ENCLOSE	D STRUCTURE
			JEB ND 180685/ 182905 DI BIJS
PROJECT NGO VSN	DATE: 12-14-18	SCALE NTS	
CLIENT: SBSI	SHT. 4	DVG ND SK-3	3 REV. 7
	CHECKED BY: POH PROJECT MGR VSN	CHECKED BY: PDH 30'-0"x2 PROJECT MGR VSN DATE: 12-14-18	MOUNT AIRY, I CHECKED BY POH 30'-0"x20'-0" ENCLOSE PROJECT NGB VSN DATE 12-14-19 SCALE NTS

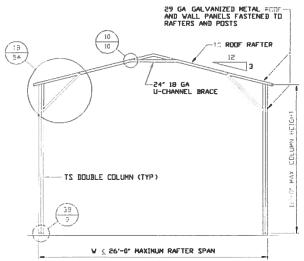


TYPICAL RAFTER/COLUMN FRAME SECTION

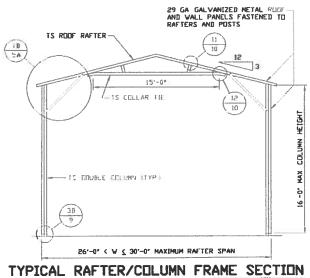SCALE: NTS



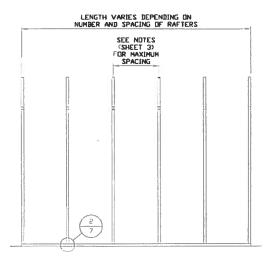
TYPICAL RAFTER/COLUMN FRAME SECTION SCALE: NTS



TYPICAL RAFTER/COLUMN SIDE FRAMING SECTION


SCALE NTS

THES EXCURENT IS THE PROPERTY OF NODE: AND ASSOCIATES ENGINEERING AND COMMUNITIES. THE IDAMINISEZED REPRESECTION, COPYING, OR OTHERWISE USE OF THESE STRUCKLY PROMINETED AND ANY DEPENDENT THEREUPON MAY BE SUBJECT TO LEGAL ACTION.	CLIENT: SISI	SHT. 4A	DWG. ND SK-3	3	EV. 7
THES EXCLUSIVE IS THE PROPERTY OF HOUSE AND ASSOCIATES ENGINEERING AND	PROJECT NGD VSN	DATE: 12-14-18	SCALE NTS	JOB NO	100605/
MOORE AND ASSOCIATES ENGINEERING AND CONSULTING, INC.	CHECKED BY: PDH		P.O. BOX 12 MOUNT AIRY, N O'-0" ENCLOSE	NC 270 3	
		STEEL BUI	LDINGS AND S	TRUCT	URES, INC.

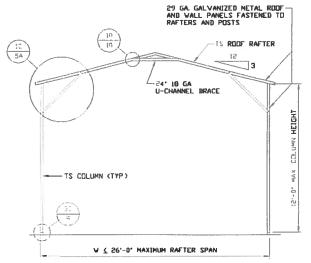

TYPICAL RAFTER/COLUMN FRAME SECTION

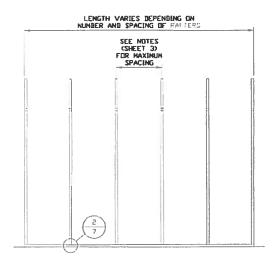SCALE: NTS



TYPICAL RAFTER/COLUMN SIDE FRAMING SECTION

SCALE: NTS


		29 GA GALVANIZED METAL ROOF— AND WALL PANELS FASTENED TO RAFTERS AND POSTS	
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TYPICAL RAFTER/COLUMN FRAME SECTION SCALE: NTS


MOORE AND ASSOCIATES	
ENGINEERING AND CONSULTING, INC.	•
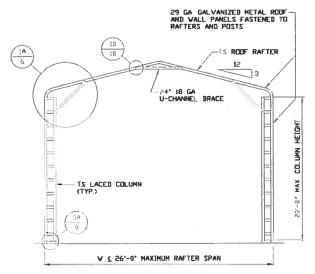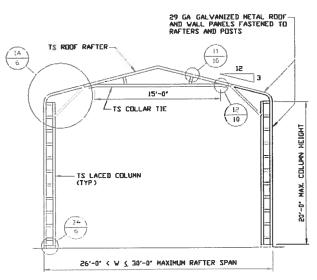
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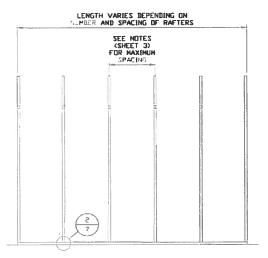
	1	DVG. ND SK-		REV. 7
 PROJECT NEW VSM	DATE: 12-14-19	SCALE NTS	,m)	D 101965/192905
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TYPICAL RAFTER/CULUMN FRAME SECTION SCALE: NTS




TYPICAL RAFTER/COLUMN FRAME SECTION SCALE: NTS



TYPICAL RAFTER/COLUMN SIDE FRAMING SECTION

SCALE: NTS

MOORE AND ASSOCIATES ENGINEERING AND CONSULTING, INC.	DRAVN BY: AT		P.O. BOX 13 MOUNT AIRY, N	
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TYPICAL RAFTER/COLUMN FRAME SECTION

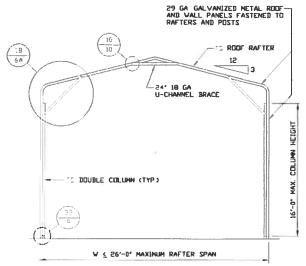
SCALE: NTS

LENGTH VARIES DEPENDING ON NUMBER AND SPACING OF PAPIEPS

SEE NOTES
(SHEET 3)
FOR MAXINUM
SPACING


TYPICAL RAFTER/COLUMN SIDE FRAMING SECTION

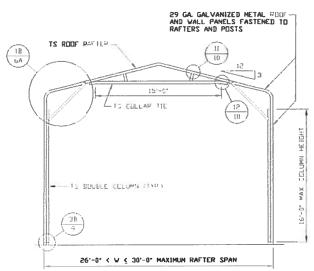SCALE: NTS



TYPICAL RAFTER/COLUMN FRAME SECTION
SCALE: NTS

MOORE AND ASSOCIATES	DRAVN BY: AT	"""	P.O. BOX 1	287,
		ו 1	MOUNT AIRY, I	NC 27030
ENGINEERING AND CONSULTING, INC.	CHECKED BY: PBH	30'-0"x2	0'-0" ENCLOSE	D STRUCTURE
THIS DOCUMENT IS THE PROPERTY OF NEEDE AND ASSOCIATES ENGINEERING AND	PRELIECT NGB VSN	DATE: 12-14-19	SCALE: NTS	.IIB ND 18056\$/18290\$
CONGULTING. THE UNAUTHORIZED REPRODUCTION, COPYING, OR OTHERVISE USE OF THIS BOCUMENT IS STREETLY PROMUNTED AND ANY DIFFERENCENT THEMELIFON MAY BE SUBJECT TO LEGAL ACTION.	CLIENT: SBSI		DVG. ND. SK-	

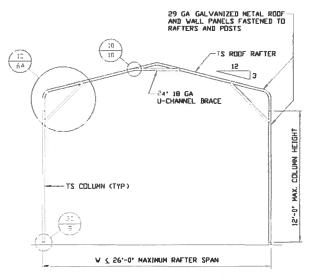

TYPICAL RAFTER/COLUMN FRAME SECTION SCALE NTS

29 GA. GALVANIZED METAL PROF AND VALL PANELS FASTENED TO RAFTERS AND POSTS

15'-0'

12 CUILLAD HE

12 3

15'-0'

12 CUILLAD HE

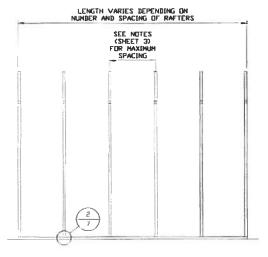
12 3

15'-0'

12 CUILLAD HE

12 3


TYPICAL RAFTER/COLUMN FRAME SECTION
SCALE: NTS



TYPICAL RAFTER/COLUMN SIDE FRAMING SECTION


SCALE: NTS

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		STEEL BUI		TRUCTURES, INC.

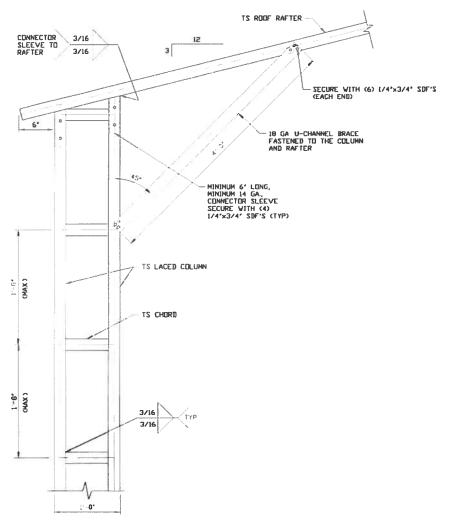


BOX EAVE RAFTER/CORNER POST CONNECTION DETAIL

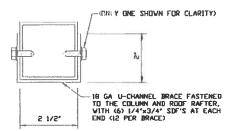FOR HEIGHTS 16'-0" < TO \(\) 20'-0"



BRACE SECTION
SCALE NTS


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THIS DECIMENT IS THE PROPERTY OF MODILE AND ASSOCIATES ENGINEERING AND	PROJECT NGO VSM	DATE: 12-14-18	SCALE NTS	JOB NO	180685/ 181565/188905
ENGINEERING AND CONSULTING, INC.	CHECKED BY: PDH		10UNT AIRY, 1 0'-0" ENCLOSE		1
MOORE AND ASSOCIATES	DRAVN BY AT		LDINGS AND S P.O. BOX 1	287,	

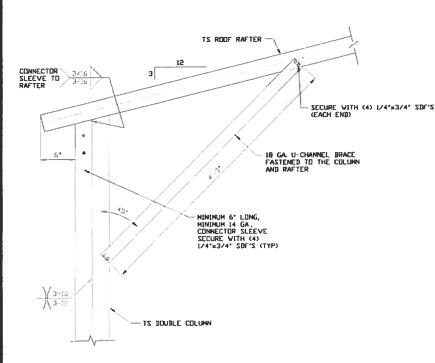

CYTISHE SHOWN FOR CLARITY -18 GA U-CHANNEL BRACE FASTENED TO THE COLUMN AND ROOF RAFTER, VITH (4) 1/4"x3/4" SDF'S AT EACH END (8 PER BRACE) 2 1/2"

BRACE SECTION

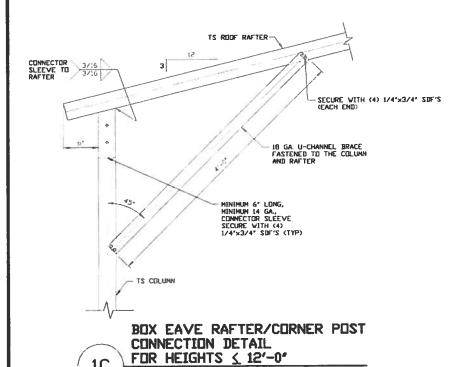
BOX EAVE RAFTER/CORNER POST CONNECTION DETAIL FOR HEIGHTS 12'-0' < TO ≤ 16'-0' 1B SCALE: NTS




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SCALE: NTS

		STEEL BUI		TRUCTURES, INC.
MOORE AND ASSOCIATES	DRAWN BY: AT		P.O. BOX 1:	287,
		1 N	MOUNT AIRY, I	NC 27030
ENGINEERING AND CONSULTING, INC.	CHECKED BY: PDH	30'-0"x2	0'-0" ENCLOSE	D STRUCTURE
				190693/
THIS DOCUMENT IS THE PROPERTY OF NODE AND ASSOCIATES ENGINEERING AND	PROJECT NGR VSN	DATE: 12-14-18	SCALE: NTS	JOB NO 181565/182905
THIS DOCUMENT IS THE PROPERTY OF NOTIFE AND ASSOCIATES ENGINEERING AND CONSULTING, THE UNAUTHORIZED REPRODUCTION, COPYENG, OR OTHERWISE USE OF THIS BOCUMENT IS STRUCTLY PRODUCTED AND ANY DEPRINGEMENT THERELPON MAY BE SUBJECT TO LEGAL ACTION.	CLIENT: SRSI	SHT. 5A	DVG. ND SK-	3 REV. 7

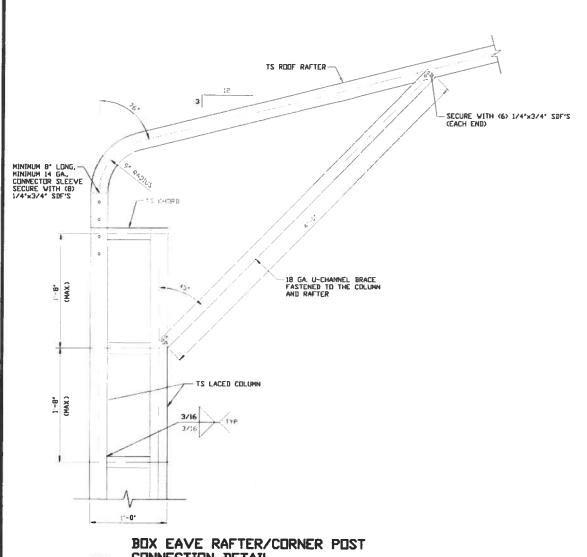


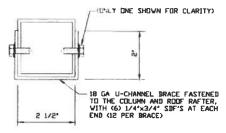BOX EAVE RAFTER/CORNER POST CONNECTION DETAIL FUR HEIGHTS 16'-0' < TO \(\) 20'-0'




BRACE SECTION
SCALE: NTS

	·	STEEL BUI		TRUCTURES, INC.
MOORE AND ASSOCIATES	DRAWN BY: AT		P.O. BOX 1	
ENCINEEDING AND CONCULTING INC.			MOUNT AIRY, 1	
ENGINEERING AND CONSULTING, INC.	CHECKED BY: PDH	30'-0"x2	0'-0" ENCLOSE	D STRUCTURE
THE PERSON IN THE REPORTED OF MOTHER AND ASSESSMENT COMPANIES AND				JUB ND 18156\$/10290\$
CONSULTING THE UNMITHERED REPRODUCTION COPYING OR OTHERWISE USE OF	PROJECT MGR VSM	DATE 12-14-18	SCALE: NTS	7011 AP 191202/165302
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BOX EAVE RAFTER/CORNER POST CONNECTION DETAIL

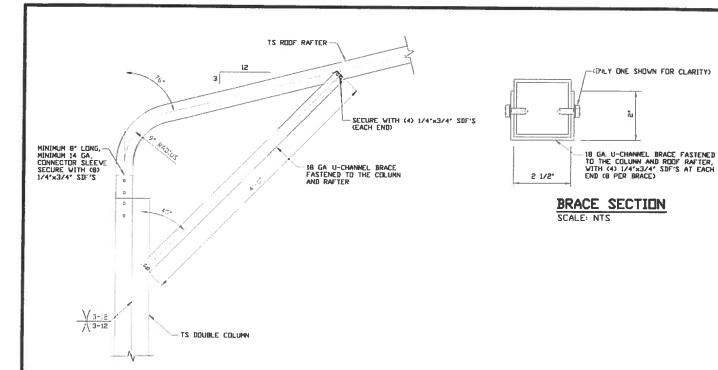1B | FOR HEIGHTS 12'-0" < TO \(\) 16'-0"



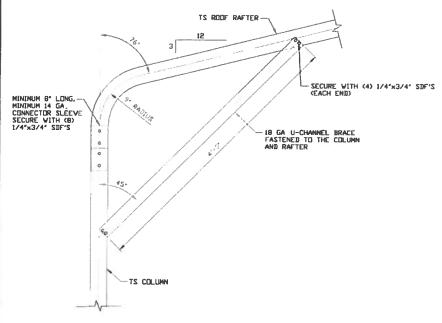
BUX EAVE RAFTER/CURNER POST CONNECTION DETAIL FUR HEIGHTS & 12'-0'

MOORE AND ASSOCIATES ENGINEERING AND CONSULTING, INC.

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1C

	CLIENT: SBSI	SHT. 6A	ING ND SK-3	3	REV. 7		
-	PROJECT NEW VSH	DATE: 12-14-18	SCALE NTS	J. (CO)	180685/ CD 181565/182905		
	CHECKED BY: PBH	MOUNT AIRY, NC 27030 30'-0"x20'-0" ENCLOSED STRUCTURE					
	DRAWN BY AT	P.O. BOX 1287,					

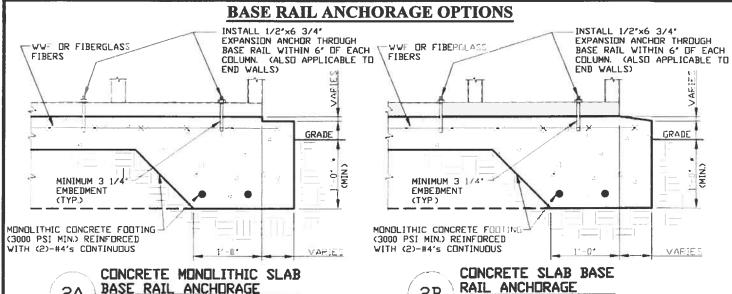

BASE RAIL ANCHORAGE

SCALE: NTS MINIMUM ANCHOR EDGE DISTANCE IS 4°. * COORDINATE WITH LOCAL CODES/ORD.

GENERAL NOTES

NOTE: CONCRETE MONOLITHIC SLAB DESIGN BASED ON MINIMUM SDIL BEARING CAPACITY OF 1,500 PSF

CONCRETE SHALL HAVE A MINIMUM SPECIFIED COMPRESSIVE STRENGTH OF 3,000 PSI AT 28 DAYS.

COVER OVER REINFORCING STEEL!

FOR FOUNDATIONS, MINIMUM CONCRETE COVER OVER REINFORCING BARS SHALL BE PER ACI-318:

3' IN FOUNDATIONS WHERE THE CONCRETE IS CAST AGAINST AND PERMANENTLY IN CONTACT WITH THE EARTH OR EXPOSED TO THE EARTH OR WEATHER, AND 1 1/2' ELSEWHERE.

REINFORCING STEEL

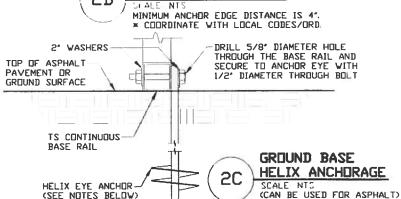
THE TURNDOWN REINFORCING STEEL SHALL BE ASTM A615 GRADE 60. THE SLAB REINFORCEMENT SHALL BE WELDED WIRE FABRIC MEETING ASTM A185 OR FIBERGLASS FIBER REINFORCEMENT.

REINFORCEMENT MAY BE BENT IN THE SHOP OR THE FIELD PROVIDED:

- REINFORCEMENT IS BENT COLD.
- THE DIAMETER OF THE BEND, MEASURED ON THE INSIDE OF THE BAR, IS NOT LESS THAN SIX-BAR DIAMETERS.
 REINFORCEMENT PARTIALLY EMBEDDED IN CONCRETE SHALL NOT
- BE FIELD BENT.

HELIX ANCHOR NOTES:

- FOR VERY DENSE AND/OR CEMENTED SANDS, COARSE GRAVEL AND COBBLES, CALICHE, PRELOADED SILTS AND CLAYS, USE MINIMUM (2) 4" HELICES WITH MINIMUM 30" EMBEDMENT OR SINGLE 6" HELIX WITH MINIMUM 50" EMBEDMENT
- 2. FOR CORAL USE MINIMUM (2) 4" HELICES WITH MINIMUM 30" EMBEDMENT OR SINGLE 6" HELIX WITH MINIMUM 50" EMBEDMENT.
- FOR MEDIUM DENSE COARSE SANDS, SANDY GRAVELS, VERY FOR MEDION DENSE COMMSE SANDS, SANDT GRAVELS, VERT STIFF SILTS, AND CLAYS USE MINIMUM (2) 4° HELICES WITH MINIMUM 30 INCH EMBEDMENT OR SINGLE 6° HELIX WITH MINIMUM 50" EMBERMENT.
- 4. FOR LOOSE TO MEDIUM DENSE SANDS, FIRM TO STIFF CLAYS AND SILTS ALLUVIAL FILL, USE MINIMUM (2) 6" HELICES WITH MINIMUM 50' EMBEDMENT.
- 5. FOR VERY LOSE TO MEDIUM DENSE SANDS, FIRM TO STIFFER CLAYS AND SILTS, ALLUVIAL FILL, USE MINIMUM (2) 8" HELICES WITH MINIMUM 60" EMBEDMENT.

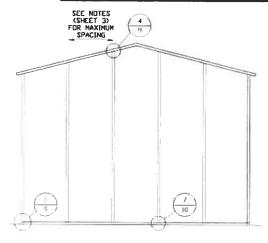


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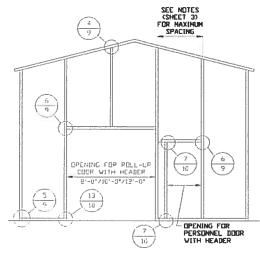
STEEL BUILDINGS AND STRUCTURES, INC. P.O. BOX 1287. DRAWN BY: AT MOUNT AIRY, NC 27030 CHECKED BY: PBH 30'-0"x20'-0" ENCLOSED STRUCTURE JO NO 181565/182905 PROJECT NGR VSN SCALE NTS DATE 12-14-18 DVG. ND SK-3 SHT. 7 REV. 7 CLIENT: SIST

BOX EAVE RAFTER END WALL AND SIDE WALL OPENINGS



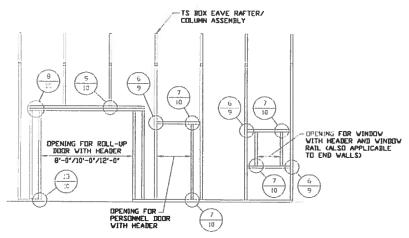
TYPICAL BOX EAVE RAFTER END WALL FRAMING SECTION

SCALE: NTS



TYPICAL BOX EAVE RAFTER END WALL OPENINGS FRAMING SECTION

SCALE: NTS



TYPICAL BOX EAVE RAFTER SIDE WALL OPENINGS FRAMING SECTION


SCALE: NTS

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ENGINEERING AND CONSULTING, INC.
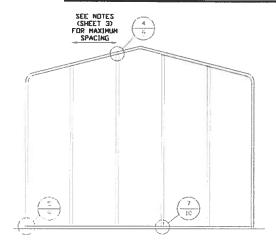
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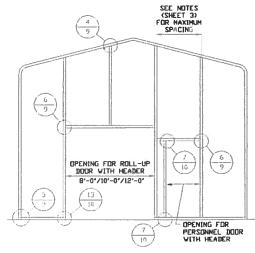
CL TEXT. COST	SHT. B	IMG. ND: SK-	REV. 7			
PROJECT MGB VSM	DATE: 12-14-18	SCALE NTS	JOB	19068\$/ ND 19156\$/18290\$		
CHECKED BY: PDH		MOUNT AIRY, NC 27030 30'-0"x20'-0" ENCLOSED STRUCTURE				
BRAVN BY: AT	STEEL BUI	STEEL BUILDINGS AND STRUCTURES, INC. P.O. BOX 1287,				

BOX EAVE RAFTER END WALL AND SIDE WALL OPENINGS



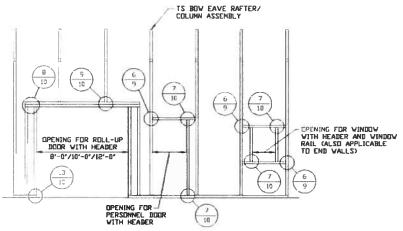
TYPICAL BOX EAVE RAFTER END WALL FRAMING SECTION

SCALE: NTS



TYPICAL BOX EAVE RAFTER END WALL OPENINGS FRAMING SECTION


SCALE: NTS




TYPICAL BUX EAVE RAFTER SIDE WALL OPENINGS FRAMING SECTION

SCALE: NTS

MOORE AND ASSOCIATES	BRAVN BY: AT	STEEL BUI	LDINGS AND S P.O. BOX 1	287.
ENCINEEDING AND CONGULTING INC.	CHECKED BY: PDH	1	MOUNT AIRY, 1	•
THUS EXCLUMENT IS THE PROPERTY OF MODILE AND ASSOCIATES ENGINEERING AND	PROJECT NGO VSN	DATE: 12-14-18	SCALE) NTS	JUB ND 180563/182905
THIS EXCLUDINT IS THE PROPERTY OF NOTICE AND ASSOCIATES ENGINEERING AND CONSULTING THE UNAUTHORIZED REPROJUCTION, COPYING, OR OTHERWISE USE OF THIS SOCIALIST IS STRUCTLY PROBLEMED AND ANY INFRINGEMENT THEREUPON MAY BE SUBJECT TO LEGAL ACTION.	CLIENT: SIBSI		DVG. ND SK-	

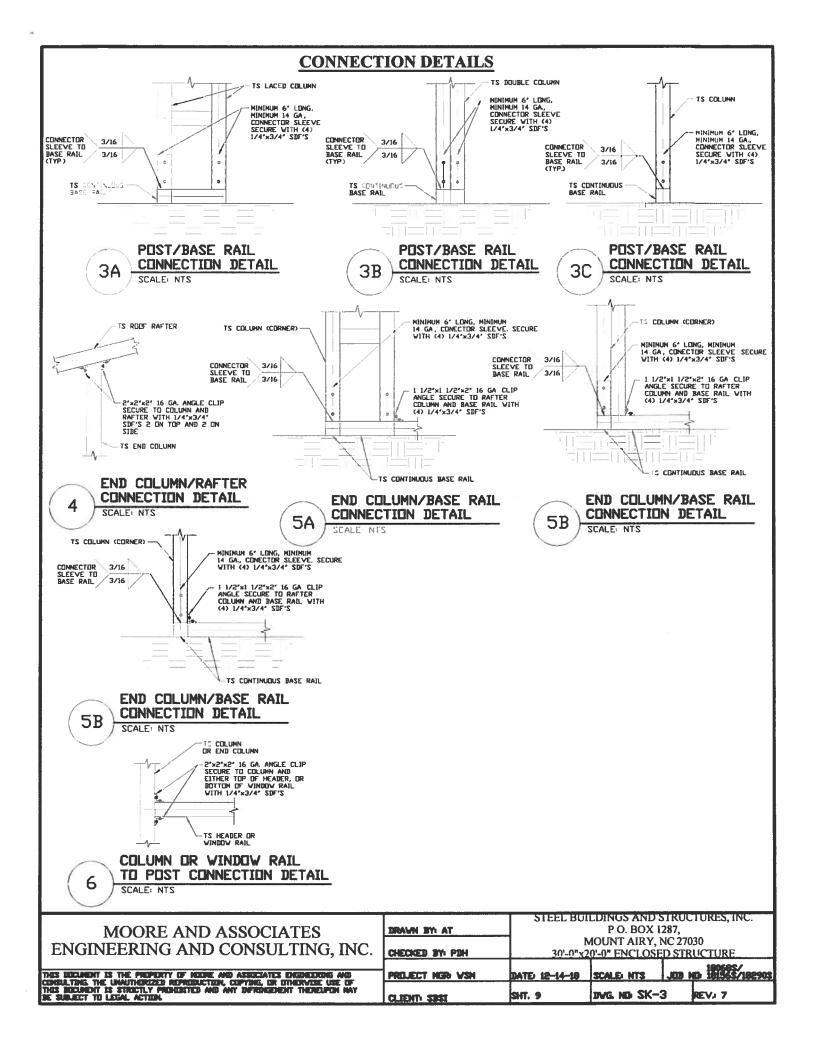

CONNECTION DETAILS

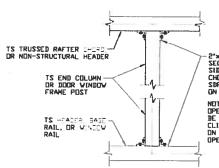

2'x2'x2' 16 GA. ANGLE CLIP SECURE TO COLUMN CEACH SIBE) AND RAFTER CHORD/RAIL VITH 1/4'x3/4' SBF'S 2 ON BOTTOM AND 2 ON SIDE

NOTE: AT ROLL-UP DOOR OPENINGS, COLUMN SHOULD BE FLUSH WITH RAIL END CLIP COLUMN TO RAIL ONLY ON SIDE OPPOSITE THE OPENING.

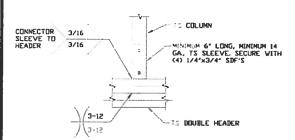
COLUMN TO HEADER, BASE RAIL, OR WINDOW RAIL CONNECTION DETAIL

CONNECTOR 3/16
SLEEVE TO HEADER

TS DOUBLE HEADER

NININUM 6' LONG, MININUM 14 GA, TS SLEEVE SECURE EACH VITH (4) 1/4'x3/4' SDF'S

8 DOUBLE HEADER/COLUMN CONNECTION DETAIL



ATTACH COLLAR TIE
TU ROOF RAFTER VITH
(4) 1/4*32/4*
SDF'S (EACH END)

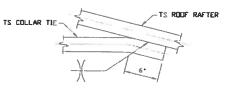
3/16 TS CHORD

9 COLUMN/DOUBLE HEADER
CONNECTION DETAIL
SCALE NTS


10 COLLAR TIE CONNECTION DETAIL
SCALE: NTS

RAFTER TO CHORD CONNECTION DETAIL

SCALE NTS



12 COLLAR TIE CONNECTION DETAIL

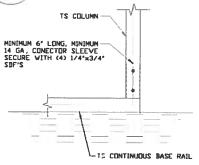

COLUMN/BASE RAIL
CONNECTION DETAIL
SCALE NTS

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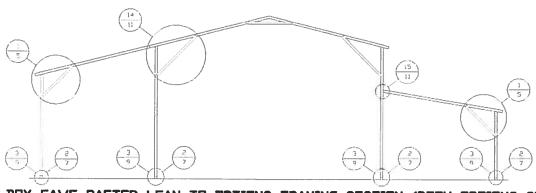
STEEL BUILDINGS AND STRUCTURES, INC.
P.O BOX 1287.
MOUNT AIRY, NC 27030

CHECKED BY PDH 30'-0"x20'-0" ENCLOSED STRUCTURE

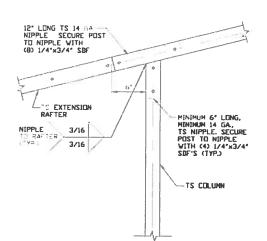
PROLECT MGB VSM DATE 12-14-18 SCALE MTS JOB ND 181565/18290S

CLIENT: SEST SHT. 10 DVG. ND SK-3 REV. 7


BOX EAVE RAFTER LEAN-TO OPTIONS



TYPICAL BOX EAVE RAFTER LEAN-TO OPTIONS FRAMING SECTION (BOTH OPTIONS SHOWN)



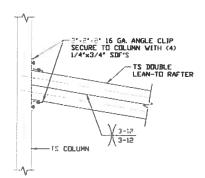SIDE EXTENSION RAFTER/CORNER POST DETAIL



15A

LEAN-TO RAFTER TO RAFTER POST CONNECTION DETAIL FOR WIDTHS 12'-0' < TO \(\leftarrow \) 16'-0'

2'-2',2' 16 GA. ANGLE CLIP
SECURE TO COLUMN WITH (4)
1/4'x3/4' SDE'S

TS LEAN-TD
RAFTER

TS COLUMN

LEAN-TO RAFTER
TO RAFTER POST
CONNECTION DETAIL
FOR WIDTHS

SCALE NTS


15B

MOORE AND ASSOCIATES ENGINEERING AND CONSULTING, INC.


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	DRAWN BY AT	STEEL BOIL	LDINGS AND S		TURES, INC.	
		P.O. BOX 1287, MOUNT AIRY, NC 27030				
	CHECKED BY PBH	30'-0"x20'-0" ENCLOSED STRUCTURE				
+	PROJECT MGB VSM	DATE: 12-14-18	SCALD NTS	J00 N	19068\$/ D 19156\$/19290\$	
			DWG. ND SK-3		REV. 7	

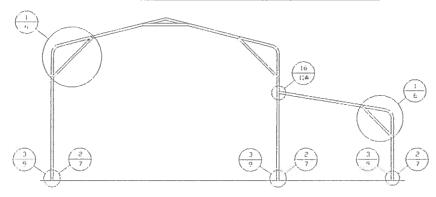BOW EAVE RAFTER LEAN-TO OPTIONS




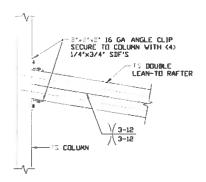TYPICAL BOW EAVE RAFTER LEAN-TO OPTIONS FRAMING SECTION



LEAN-TO RAFTER TO RAFTER POST CONNECTION DETAIL FOR WIDTHS

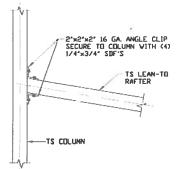16A SCALE NESS



LEAN-TO RAFTER
TO RAFTER POST
CONNECTION DETAIL
FOR WIDTHS

SCALE: NTS

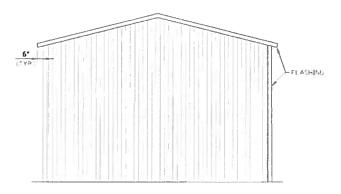
16B

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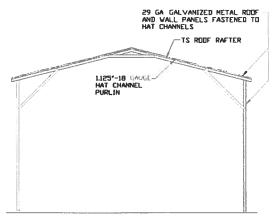
			DWG. ND SK-3		REV. 7
-	PROJECT NGS VSN	DATE: 12-14-18	SCALE) NTS	JEBN	D 191563/18290S
·.	CHECKED BY: PDH	P.O. BOX 1287, MOUNT AIRY, NC 27030 30'-0"x20'-0" ENCLOSED STRUCTURE			
	BRAWN BY: AT				

BOX EAVE RAFTER VERTICAL ROOF/SIDING OPTION



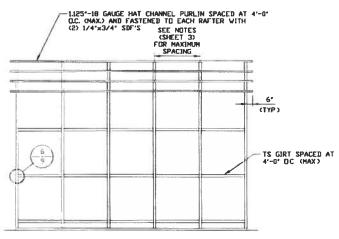
TYPICAL END ELEVATION VERTICAL ROOF/SIDING

SCALE: NTS



TYPICAL SECTION VERTICAL ROOF/SIDING OPTION


SCALE: NTS



6'
(TYP)
FLASHNG

TYPICAL SIDE ELEVATION VERTICAL ROOF/SIDING

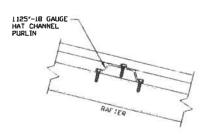SCALE: NTS



PANEL ATTACHMENT (ALTERNATE FOR VERTICAL ROOF PANELS)


TYPICAL FRAMING SECTION
VERTICAL ROOF/SIDING OPTION
SCALE: NTS

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	CL STOUT. COMES	SMT. 12	BOAG NEW SIK-	3	REVI 6A
	PROJECT NEW VSH	DATE 12-14-18	SCALE NTS	JOB 1	180685/ 181365/182905
<u>.</u>	CHECKED BY: PDH		NOUNT AIRY, 10'-0" ENCLOSE		
	DRAWN BY AT		P.O. BOX I	287,	ŕ
		I STEEL BUI	LUINGS AND I	SIKUL	JUKES, INC.

OPTIONAL HEADER



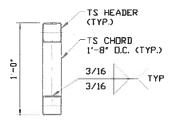HEADER DETAIL FOR DOOR

OPENINGS 12'-0' < LENGTH < 20'-0"


SCALE: NTS

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ENGINEERING AND CONSULTING, INC.


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	CLIENT) \$9\$1	SHT. 13	DVG. ND: SK-	3	REV. 7	
_	PREJECT NGN VSN	DATE: 12-14-18	SCALE NTS	JOB	18068\$/ D 18156\$/18290\$	
	CHECKED IN PIH	MOUNT AIRY, NC 27030 30'-0"x20'-0" ENCLOSED STRUCTURE				
	DRAVN BY: AT	P.O. BOX 1287,				

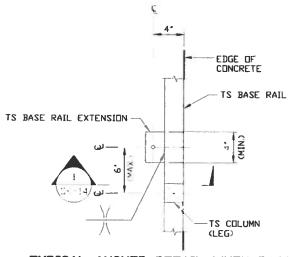
ADDITIONAL BASE RAIL ANCHORAGE OPTION



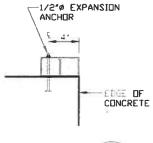TYPICAL ANCHUR DETAIL WHEN BASE RAIL IS NEAR EDGE OF CONCRETE




SECTION SCALE: NTS SK-14

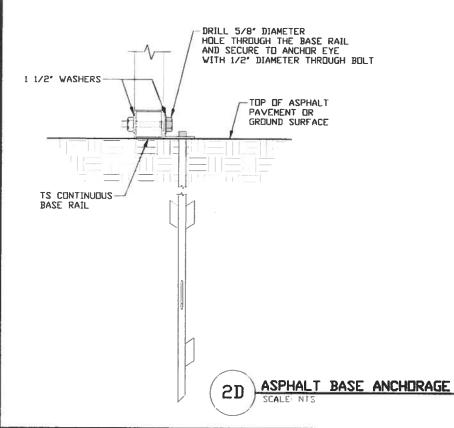



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		STEEL BUILDINGS AND STRUCTURES, INC.				
	DRAVN BY AT		P.O. BOX 1287,			
			OUNT AIRY, I			
	CHECKED BY PIN	30'-0"x2	0'-0" ENCLOSE	D.STRI	ICTURE	
-	PROJECT MGR VSM	DATE: 12-14-19	SCALE: NTS	J03 N	180603/ D 181563/182903	
			DWG. ND SK-3		REV. 7	





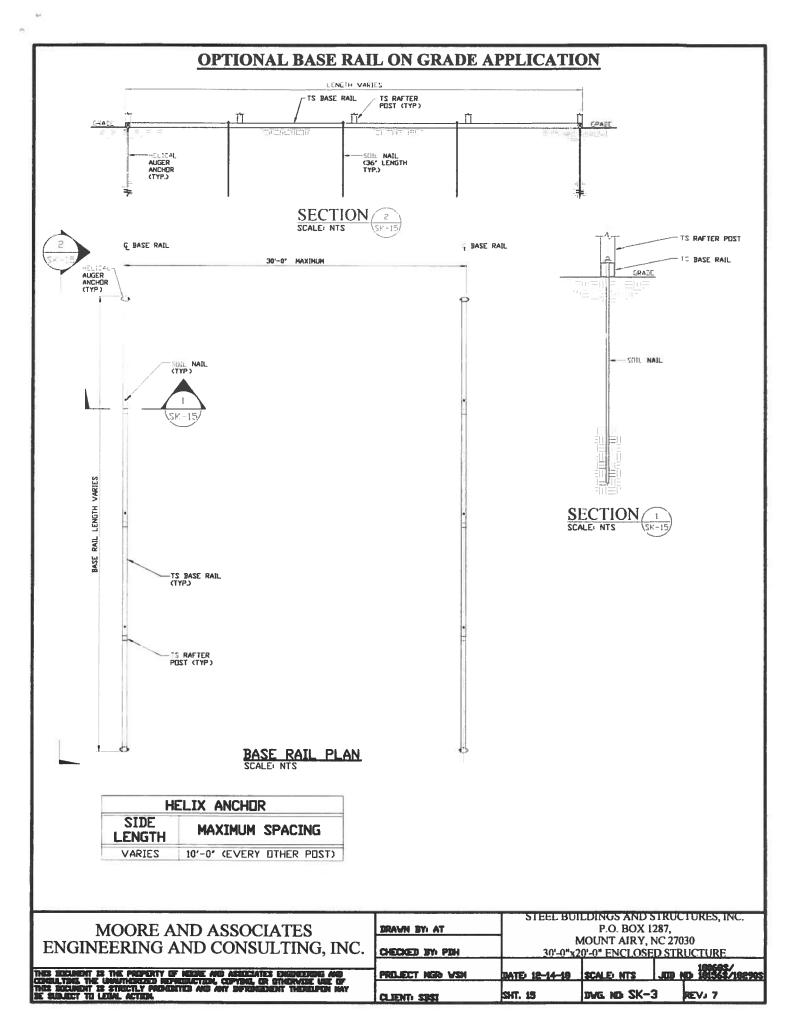

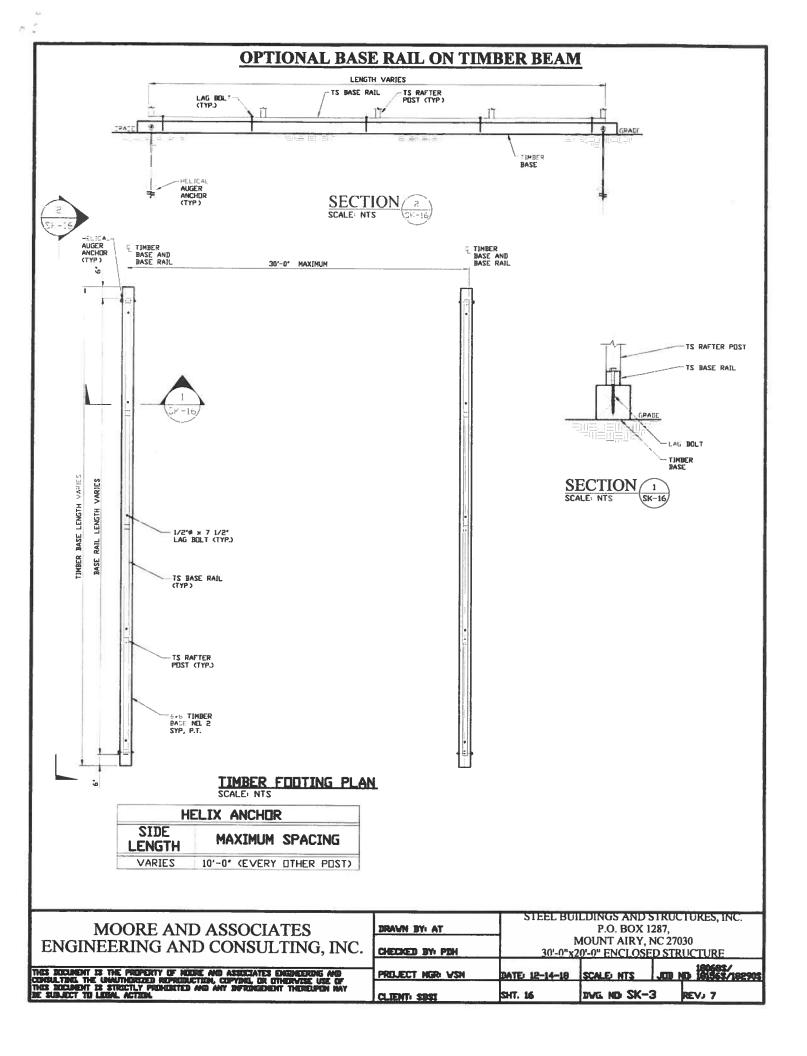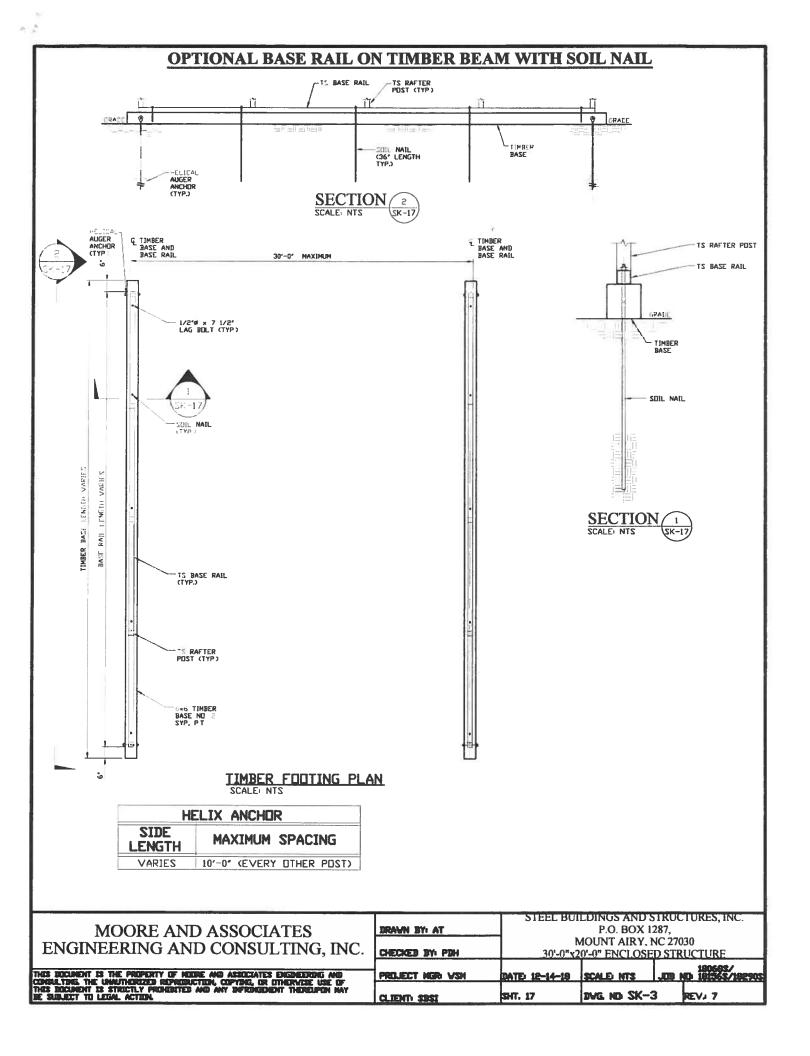OPTIONAL CONCRETE STRIP FOOTING G FOOTING AND BASE RAIL E FOOTING AND BASE RAIL MUNIXAM "0-"0E FOOTING LENGTH VARIES LENGTH 1/2'Ø EXPANSION ANCHOR (TYP.) RAIL BASE TS BASE RAIL CONCRETE STRIP FOOTING (3000 PSI MIN) CONCRETE STRIP FOOTING PLAN SCALE: NTS 1'-6" TS RAFTER POST - 15 BASE RAIL GRADE -2 84 T&B INSTALL 1/2'x6 3/4' EXPANSION ANCHOR THROUGH BASE RAIL WITHIN 6' OF EACH COLUMN. MINIMUM 3 1/4' EMBEDMENT (TYP) 2" CLR 김 SECTION (1 SK-18/ SCALE: NTS * COORDINATE WITH LOCAL CODES/ORD. STEEL BUILDINGS AND STRUCTURES, INC. P.O. BOX 1287, MOORE AND ASSOCIATES DRAWN BY AT MOUNT AIRY, NC 27030 ENGINEERING AND CONSULTING, INC. 30'-0"x20'-0" ENCLOSED STRUCTURE CHECKED BY: PBH 18068\$/ JDB ND 18136\$/18290\$ THES RECEMENT IS THE PROPERTY OF NEIDE AND ASSOCIATES ENGINEERING AND CONSULTING. THE UNMERHORIZED REPRODUCTION, COPYING, OR OTHERWISE USE OF THES RECURENT IS STRUCTLY PROHESTED AND ANY DEFRINGEMENT THERELIPON MAY BE SUBJECT TO LEGAL ACTION. SCALE: NTS PROJECT NGR WSM DATE: 12-14-18 DAC NO 2K-3 REV. 7 SHT. 18 CLIENT: SISI