
Kib Kibler & Janie Graziani

A New Residence For

208 Southwest Skinner Glen - Lake City, Florida

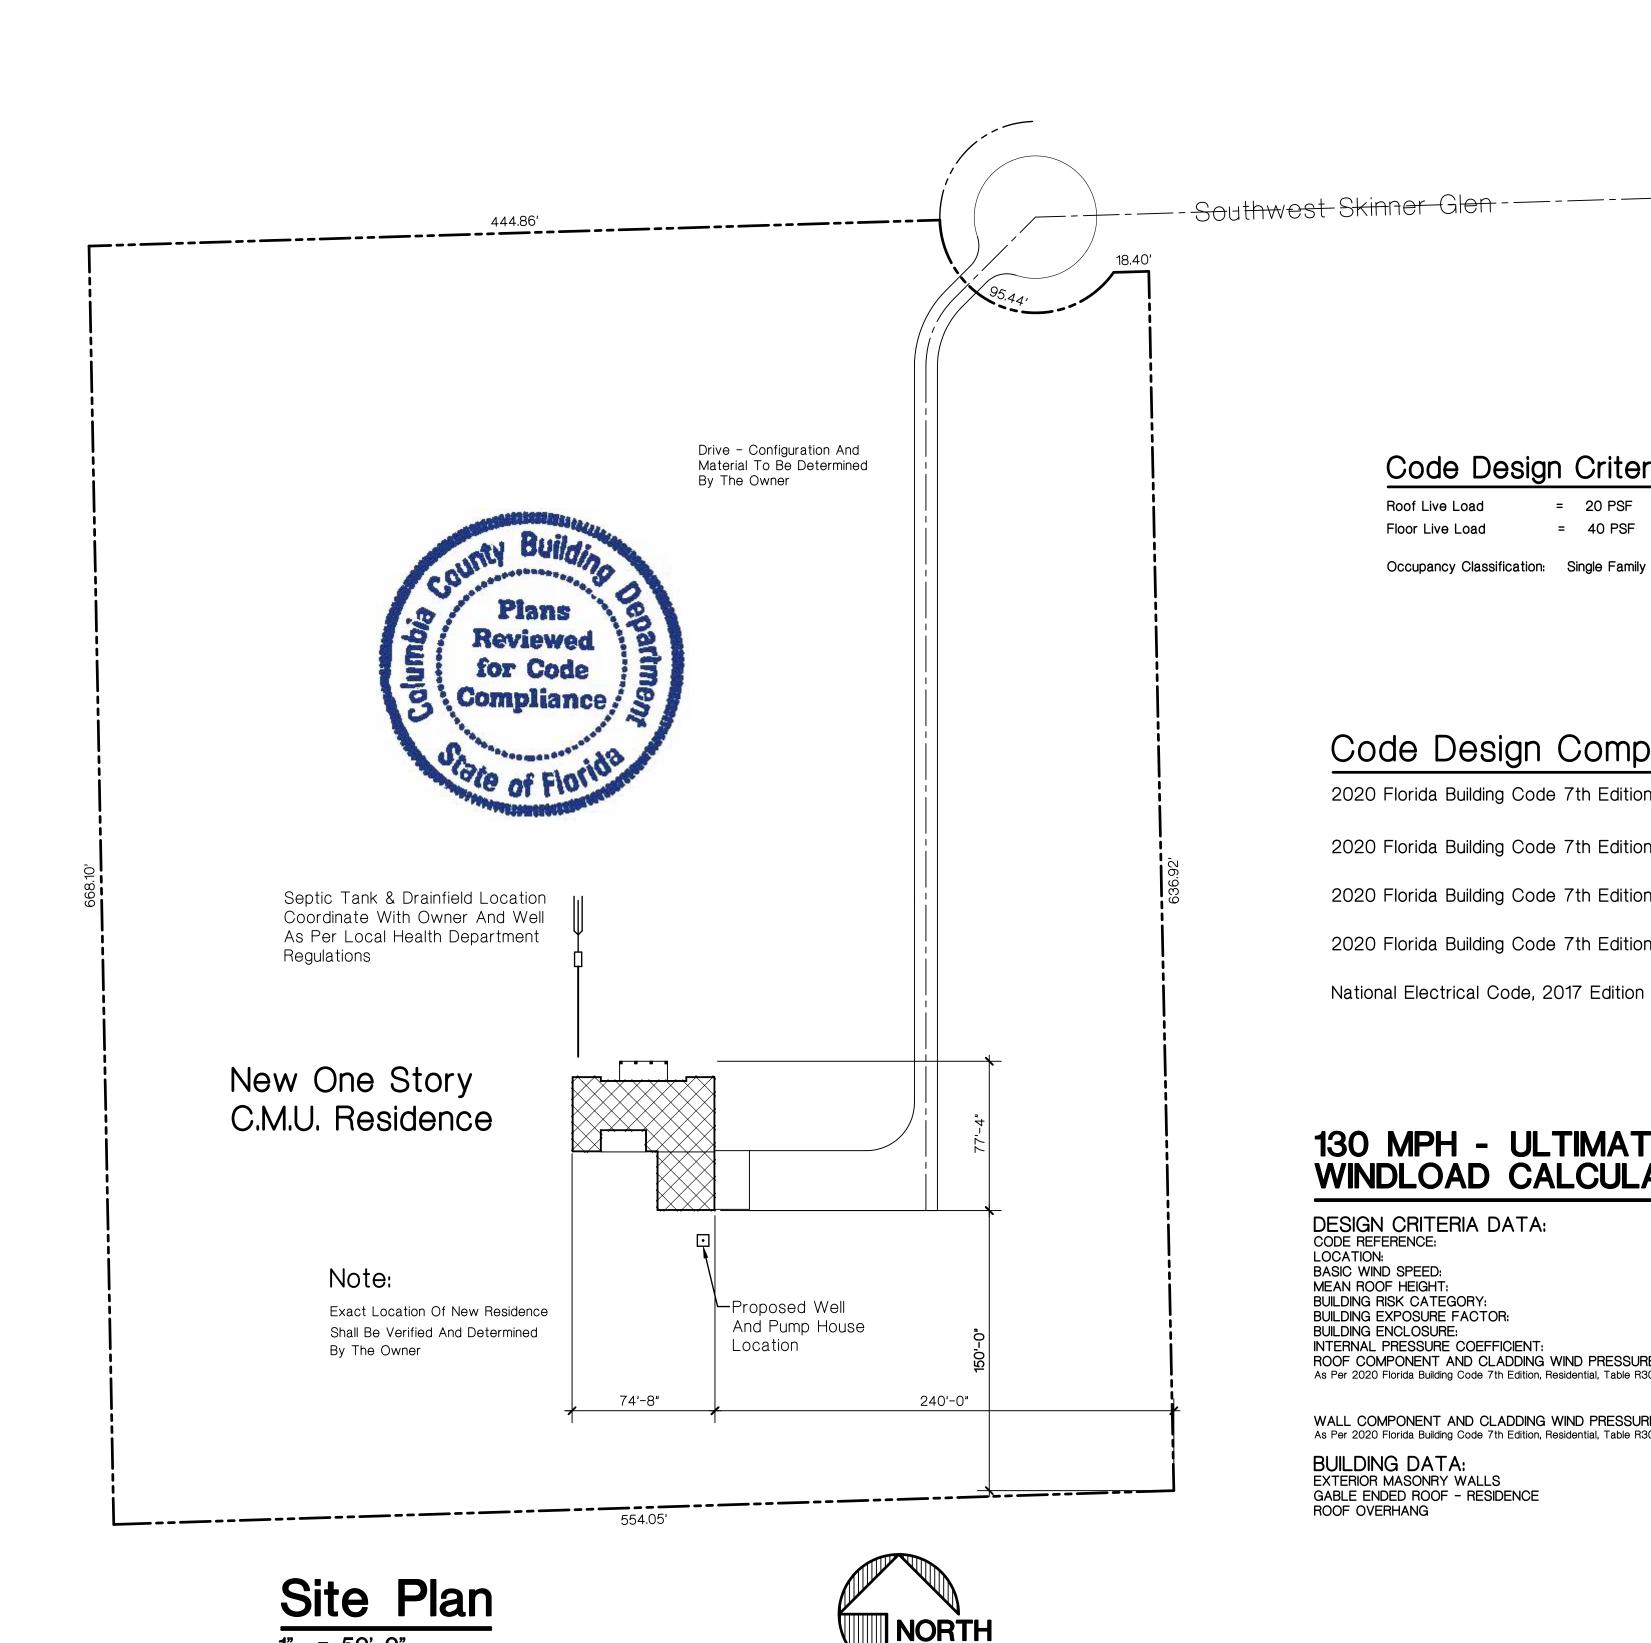

Code Design Criteria

= 20 PSF

Occupancy Classification: Single Family Residential

Code Design Compliance, Residential

2020 Florida Building Code 7th Edition, Residential

2020 Florida Building Code 7th Edition, Plumbing

2020 Florida Building Code 7th Edition, Mechanical

2020 Florida Building Code 7th Edition, Energy Conservation

National Electrical Code, 2017 Edition

130 MPH - ULTIMATE - RISK CAT. II WINDLOAD CALCULATION SUMMARY

DESIGN CRITERIA DATA: LOCATION: **BASIC WIND SPEED:** MEAN ROOF HEIGHT BUILDING RISK CATEGORY: BUILDING EXPOSURE FACTOR: BUILDING ENCLOSURE: INTERNAL PRESSURE COEFFICIENT: ROOF COMPONENT AND CLADDING WIND PRESSURE: As Per 2020 Florida Building Code 7th Edition, Residential, Table R301.2 (2) WALL COMPONENT AND CLADDING WIND PRESSURE:

As Per 2020 Florida Building Code 7th Edition, Residential, Table R301.2 (2) **BUILDING DATA:**

EXTERIOR MASONRY WALLS GABLE ENDED ROOF - RESIDENCE ROOF OVERHANG

2020 FLORIDA BUILDING CODE 7th Edition, RES. ALACHUA, FLORIDA 130 MPH - ULTIMATE DESIGN WIND SPEED LESS THAN 30'-0"

BUILDING IS ENCLOSED (1) +10.0 PSF, -15.0 PSF (2) +10.0 PSF, -21.0 PSF (3) +10.0 PSF, -33.0 PSF

EXPOSURE B

(4) +15.5 PSF, -17.0 PSF (5) +15.5 PSF, -19.0 PSF

RECTANGULAR SHAPED 2'-0"

Protection Against Termites

Termite Protection Shall Be Provided By Registered Termiticides, Including Soil Applied Pesticides, Baiting Systems, And Pesticides Applied To Wood, Or Other Approved Methods Of Termite Protection Labeled For Use As A Preventative Treatment For New Construction. A "Certificate Of Compliance" Shall Be Issued To The Building Department Upon Completion Of The Application(s), By The Licensed Pest Control Company That Contains The Following Statement: "The Building Has Received A Complete Treatment For The Prevention Of Subterranean Termites, Treatment Is In Accordance With Rules And Laws Established By The Florida Department Of Agriculture And Consumer Services."

If Soil Treatment Is Used For Subterranean Termites Prevention:

- 1. The Initial Chemical Soil Treatment Inside The Foundation Perimeter Shall Be Done After All Excavation, Backfilling And Compaction Is Complete. 2. Any Soil Area Disturbed After Initial Chemical Soil Treatment Shall Be Retreated With A Chemical Soil Treatment, Including Spaces Boxed Or Formed. 3. The Space In Concrete Floors Boxed Out Or Formed For Subesquent Installation Of Plumbing Traps, Drains Or Any Other Purpose Shall Be Created By Using Plastic Or Metal Permanently Placed Forms Of Sufficient Depth To Eliminate Any Planned Soil Disturbance After Initial Chemical Soil Treatment. 4. Chemically Treated Soil Shall Be Protected With A Minimum 6 Mil Vapor Retarder To Protect Against Rainfall Dilution. If Rainfall Occurs Before Vapor Retarder Placement, Retreatment Is Required. Any Work, Including Placement Of Reinforcing Steel, Done After Chemical Treatment Until The Concrete Floor Is Poured, Shall Be Done In Such A Manner As To Avoid Penetrating Or Disturbing Treated Soil.
- 5. Any Concrete Overpour Or Mortar Accumulated Along The Exterior Foundation Perimeter Shall Be Removed Prior To Exterior Chemical Soil Treatment To Enhance Vertical Penetration Of The Chemicals.
- 6. Chemical Soil Treatments Shall Also Be Applied Under All Exterior Concrete Or Grade Within 12" (Inches) Of The Primary Structure Sidewalls. Also, A Vertical Chemical Barrier Shall Be Applied Promptly After Construction Is Completed, Including Initial Landscaping And Irrigation / Sprinkler System Installation. Any Soil Disturbed After The Chemical Vertical Barrier Is Applied Shall Be Retreated.
- 7. If A Registered Termiticide Is Formulated And Registered As A Bait System Is Used For Subterranean Termite Prevention, Items 1 Thru 6 Do Not Apply; However, A Signed Contract Assuring The Installation, Maintenance And Monitoring Of The Baiting System That Is In Compliance With The Requirements Of Chapter 482, Florida Statutes, Shall Be Provided To The Building Official Prior To The Pouring Of The Concrete Slab, And The System Must Be Installed Prior
- 8. If A Registered Termiticide Formulated And Registered As A Wood Treatment Is Used For Subterranean Termite Prevention, Items 1 Thru 6 Do Not Apply Application Of The Wood Treatment Termiticide Shall Be As Required By Label Directions For Use, And Must Be Completed Prior To Final Building Approval.


Refer To The 2020 Florida Building Code, 7th Edition, Residential, Chapter 3, Building Planning, Section R318, Protection Against Termites For

General Notes

- 1. All Work Shall Be In Strict Accordance With The Latest Revisions To The 2020 Florida Building Code 7th Edition, Residential And All Applicable Codes, Ordinances And Regulations Of Local Governing Authorities.
- 2. Any Discrepancies Between Referenced Standards And The Drawings Shall Be Brought To The Attention Of The Architect In Writing Prior To Commencing The Work. Commencement Of The Work Without Notifying The Architect In Writing Implies The Contractor Takes The Responsibility With All Applicable Codes, Ordinances And Standards.
- 3. All Sub-Grade Under Buildings Shall Be Well Compacted To Achieve A Minimum Bearing Capacity Of 2500 PSF.
- 4. All Concrete Work For Use In Footings Shall Be A Minimum Of 3000 PSI. All Other Locations Shall Have Concrete With A Minimum Strength Of 3000 PSI. All Reinforcing Steel Shall Be Grade 60. All Concrete And Steel Reinforcing Work Shall Be Done In Strict Accordance With A.C.I. - 318 And Its Latest Revisions.
- 5. All Anchor Bolts Shall Conform To ASTM A-307. All Framing Anchors Shall Be Galvanized, Type And Size As Required For Each Specific Load And Installation Application. Provide A 2" Round Or Square Plate Washer At Anchor Bolts For Use To Anchor Wall Bottom Plates To The Concrete Slab.
- 6. Structural Framing Lumber Shall Be Number 2 Southern Yellow Pine, F = 1500 PSI Bending, Or Equal. Wall Framing Lumber Shall Be Number 2 Spruce-Pine-Fir Or Cedar. All Wood Sheathing For Roof & Walls Shall Be As Indicated On Sections And Details And Other Locations On The Drawings. At Roof, Provide "H" Clips Between Trusses. All Finish Wood And Trim Shall Be Selected By The Owner.
- Actual Computed Dead Loads, And Shall Be So Certified By An Engineer Registered In The State Of Florida. 8. Roofing Shall Be As Noted On The Drawings And Selected By The Owner And Installed Over Synthetic Underlayment System. Flashing


7. Pre-Fabricated Trusses Shall Be Engineered For Live Loads As Required By The 2020 Florida Building Code 7th Edition, Residential And


- Shall Be Minimum 26 Gauge Galvanized Metal Or Aluminum. 9. All Doors And Windows And Their Finishes And Hardware Shall Be Selected By The Owner And Shall Comply With The 2020 Florida
- Building Code 7th Edition, Residential. All Windows At Sleeping Rooms Shall Comply With The Emergency Egress Code. All Windows Shall Have Insulated Glazings.
- 10. All Finish Materials, Color Schemes And Textures Shall Be Selected By The Owner.
- 11. All Electrical Work Shall Conform To The National Electrical Code, 2017. All Electrical Outlets Shall Be Installed With Tamper Proof Receptacles. Provide For Arc Fault Circuit Interrupter Protection.
- 12. All Telephone Outlet Locations Shall Be Determined By The Owner.
- 13. The Contractor Shall Verify All Dimensions Indicated Herein And Shall Notify The Architect Of Any And All Discrepancies Promptly. Any Discrepancies Not Brought To The Attention Of The Architect, Shall Be The Responsibility Of The Contractor.

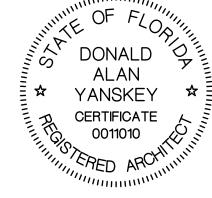

DONALD ALAN YANSKEY, ARCHITECT FLORIDA REGISRTRATION NO. AR0011010 DATE: SEPTEMBER 15, 2021



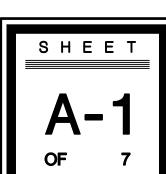

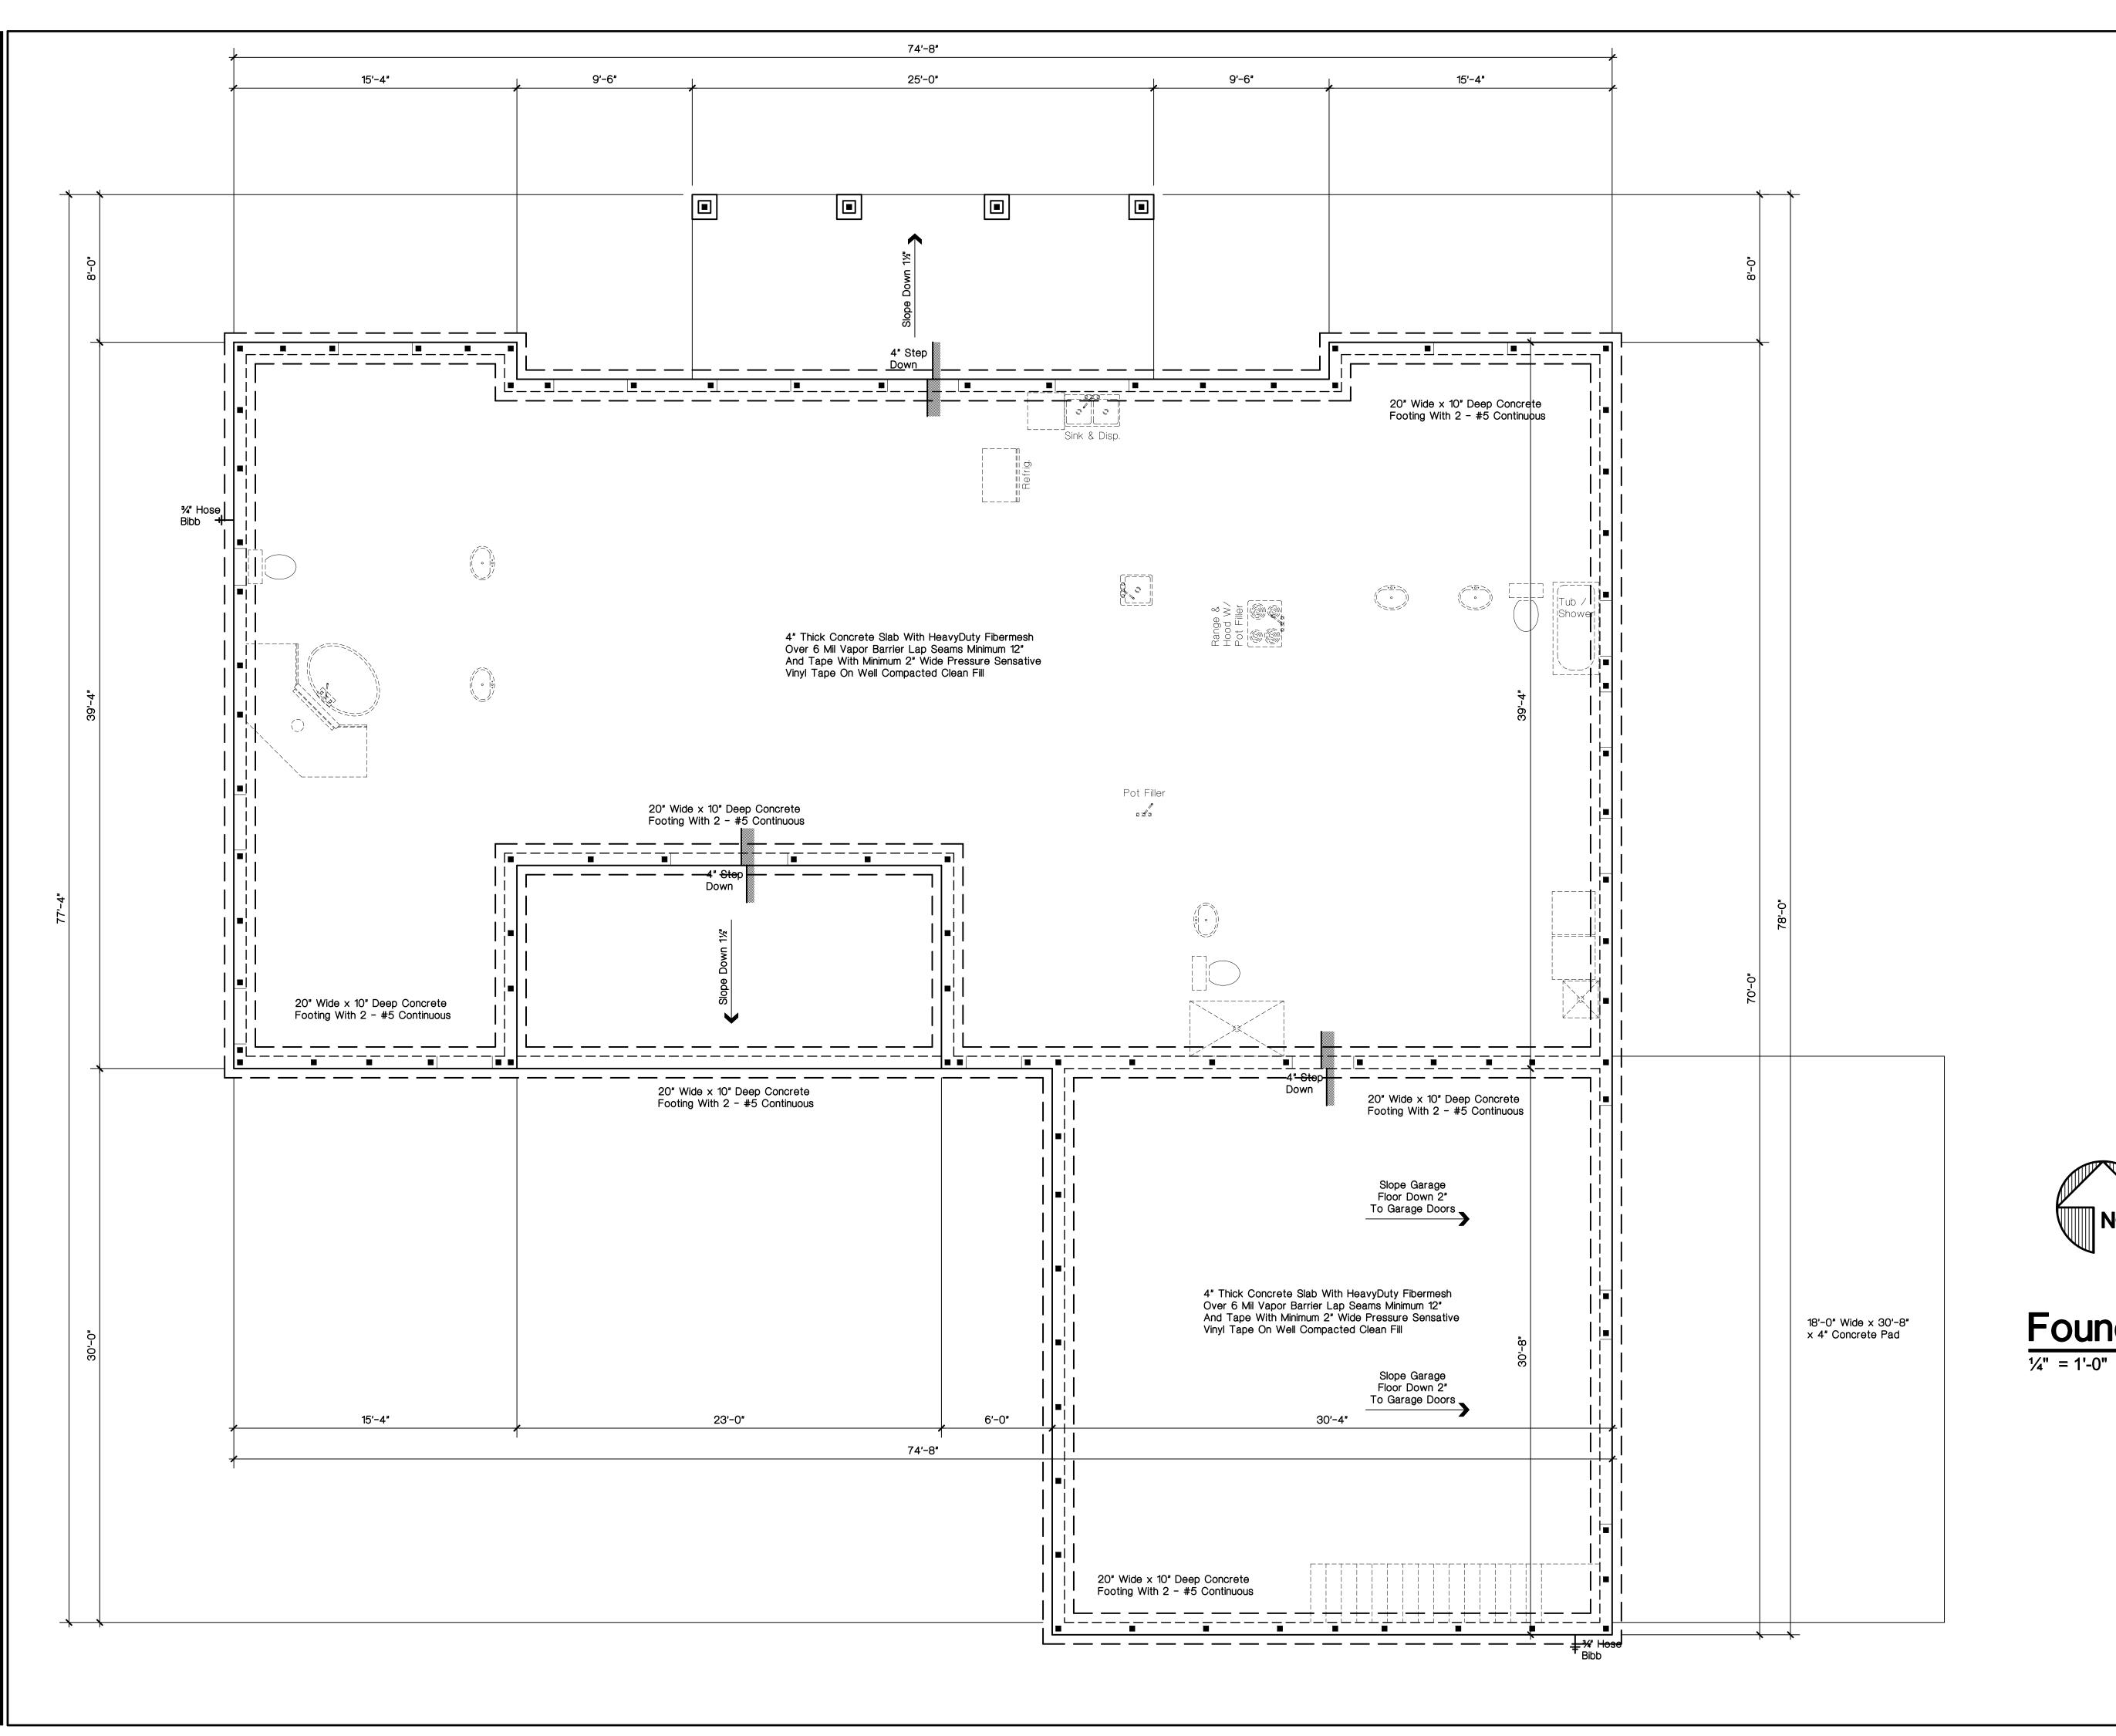

Harvey Building & Construction Newberry, Florida 352-258-9051

Donald Man Yanskey

ADCHINE Gainesville, Florida 32605

DATE DRAWN BY REVISED
Sept. 15, 2021
D. A. Y.


OB NUMBER CHECKED
Kibler
D. A. Y.

& Janie Graziani nner Glen - Lake City, Florida

Foundation Plan


1/4" = 1'-0"

NORTH

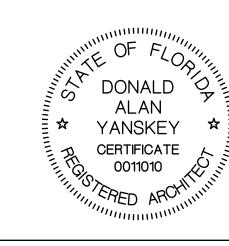

DONALD ALAN YANSKEY, ARCHITECT
FLORIDA REGISRTRATION NO. AR0011010
DATE: SEPTEMBER 15, 2021

A-2
OF 7

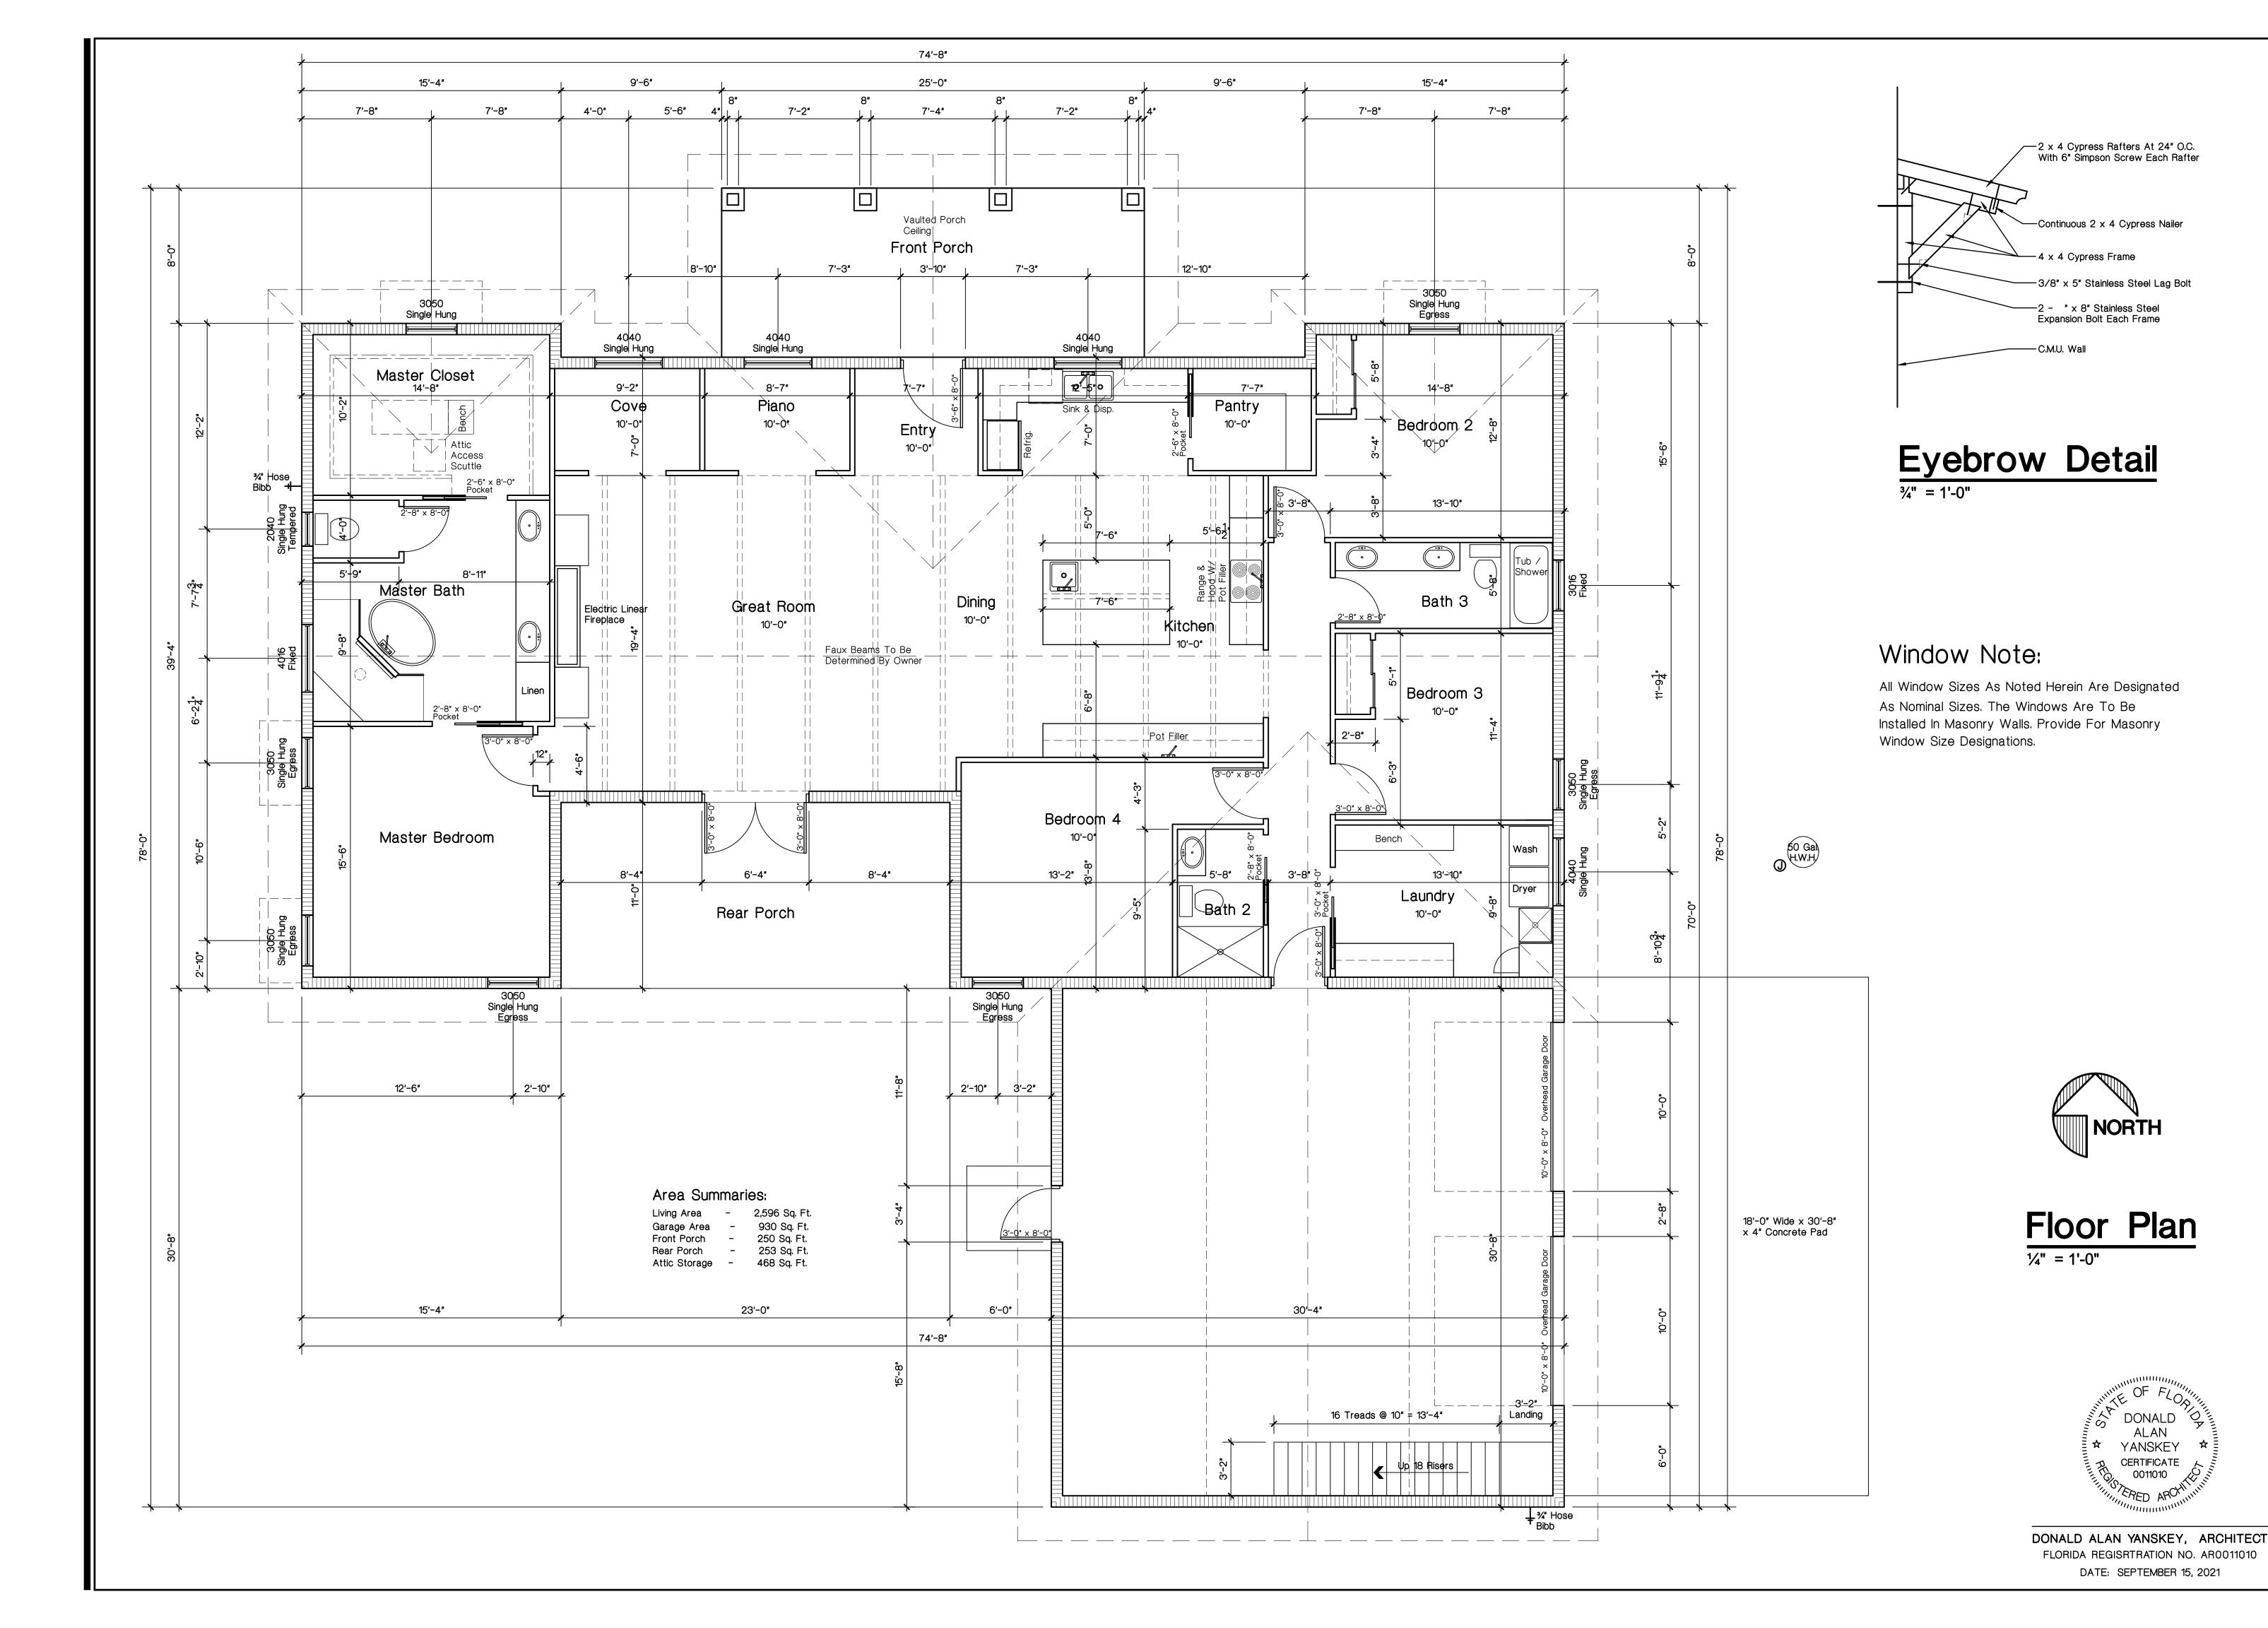

arvey Building & Construction Newberry, Florida 352-258-9051

Donald Man Yanskey

ADCHITECT

IS, 2021 D. A. Y.

UMBER CHECKED

D. A. Y.

D. A. Y.

Sept. 15, 2021

Sept. 15, 2021

D. A. Y.

Light

Florida

Date

D. A. Y.

Kibler

D. A. Y.


Skinner Glen - Lake City, Florid


ib Kibler & Janie Glen -

S H E E T

A-3

OF 7

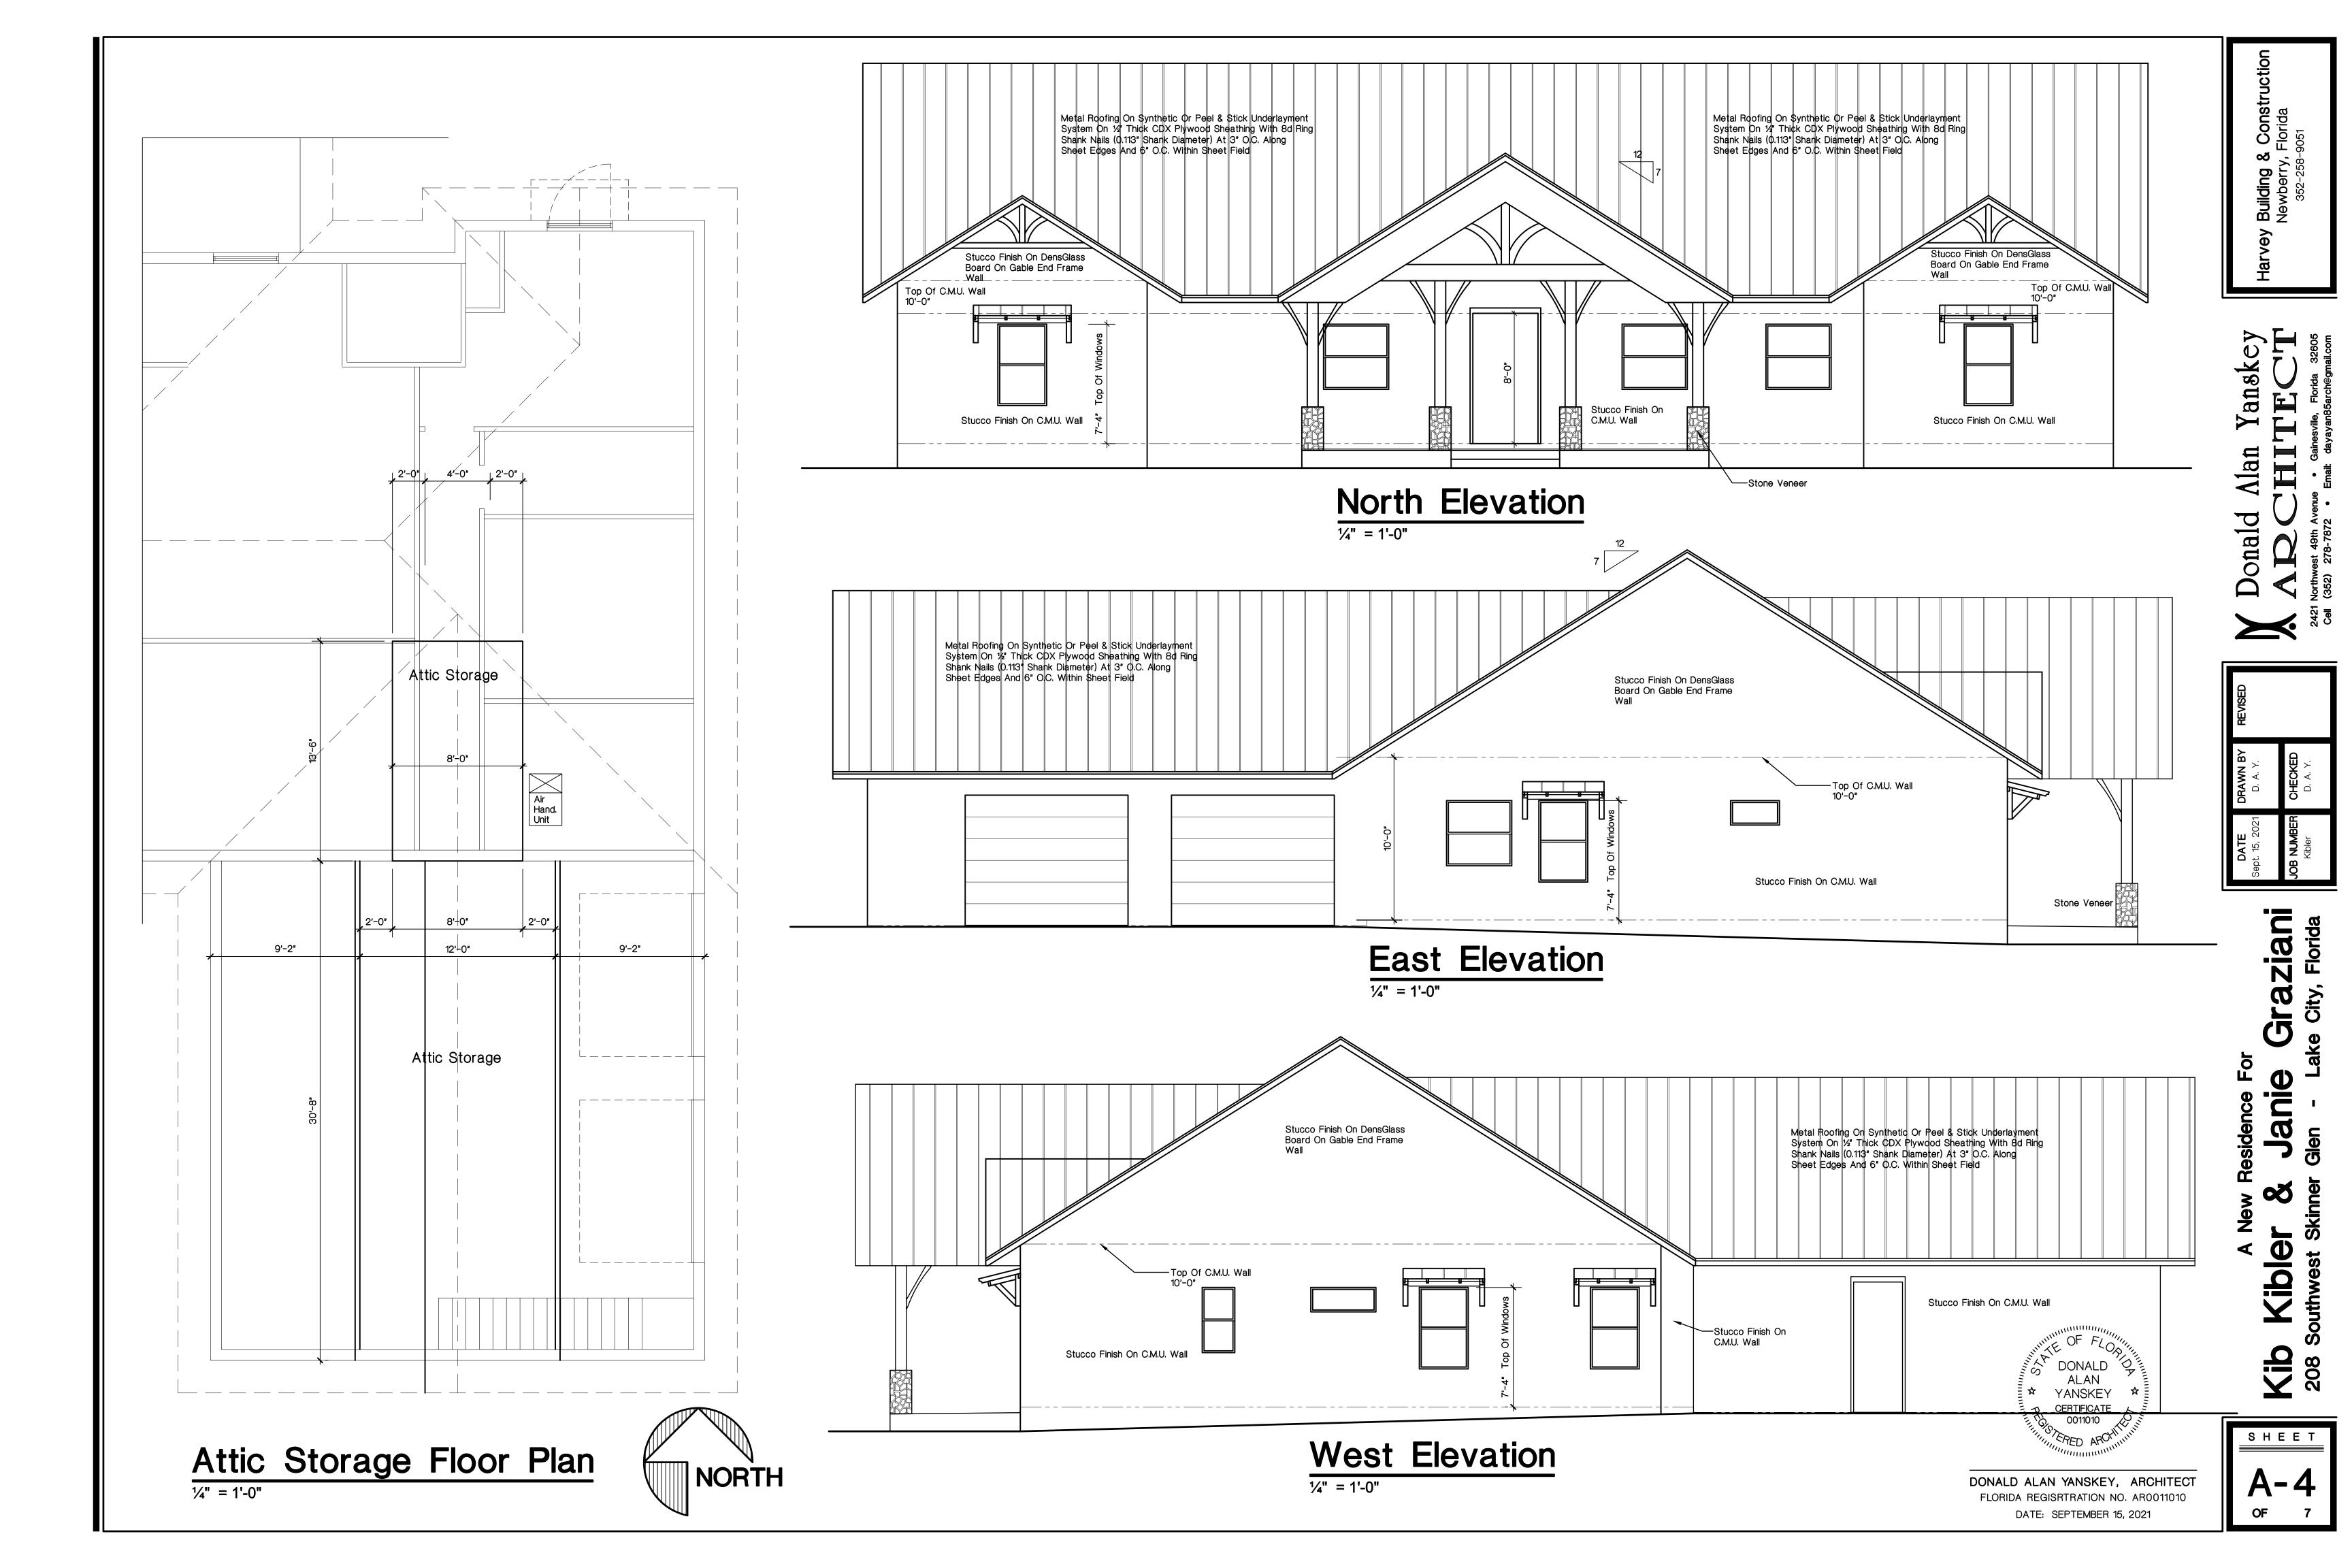

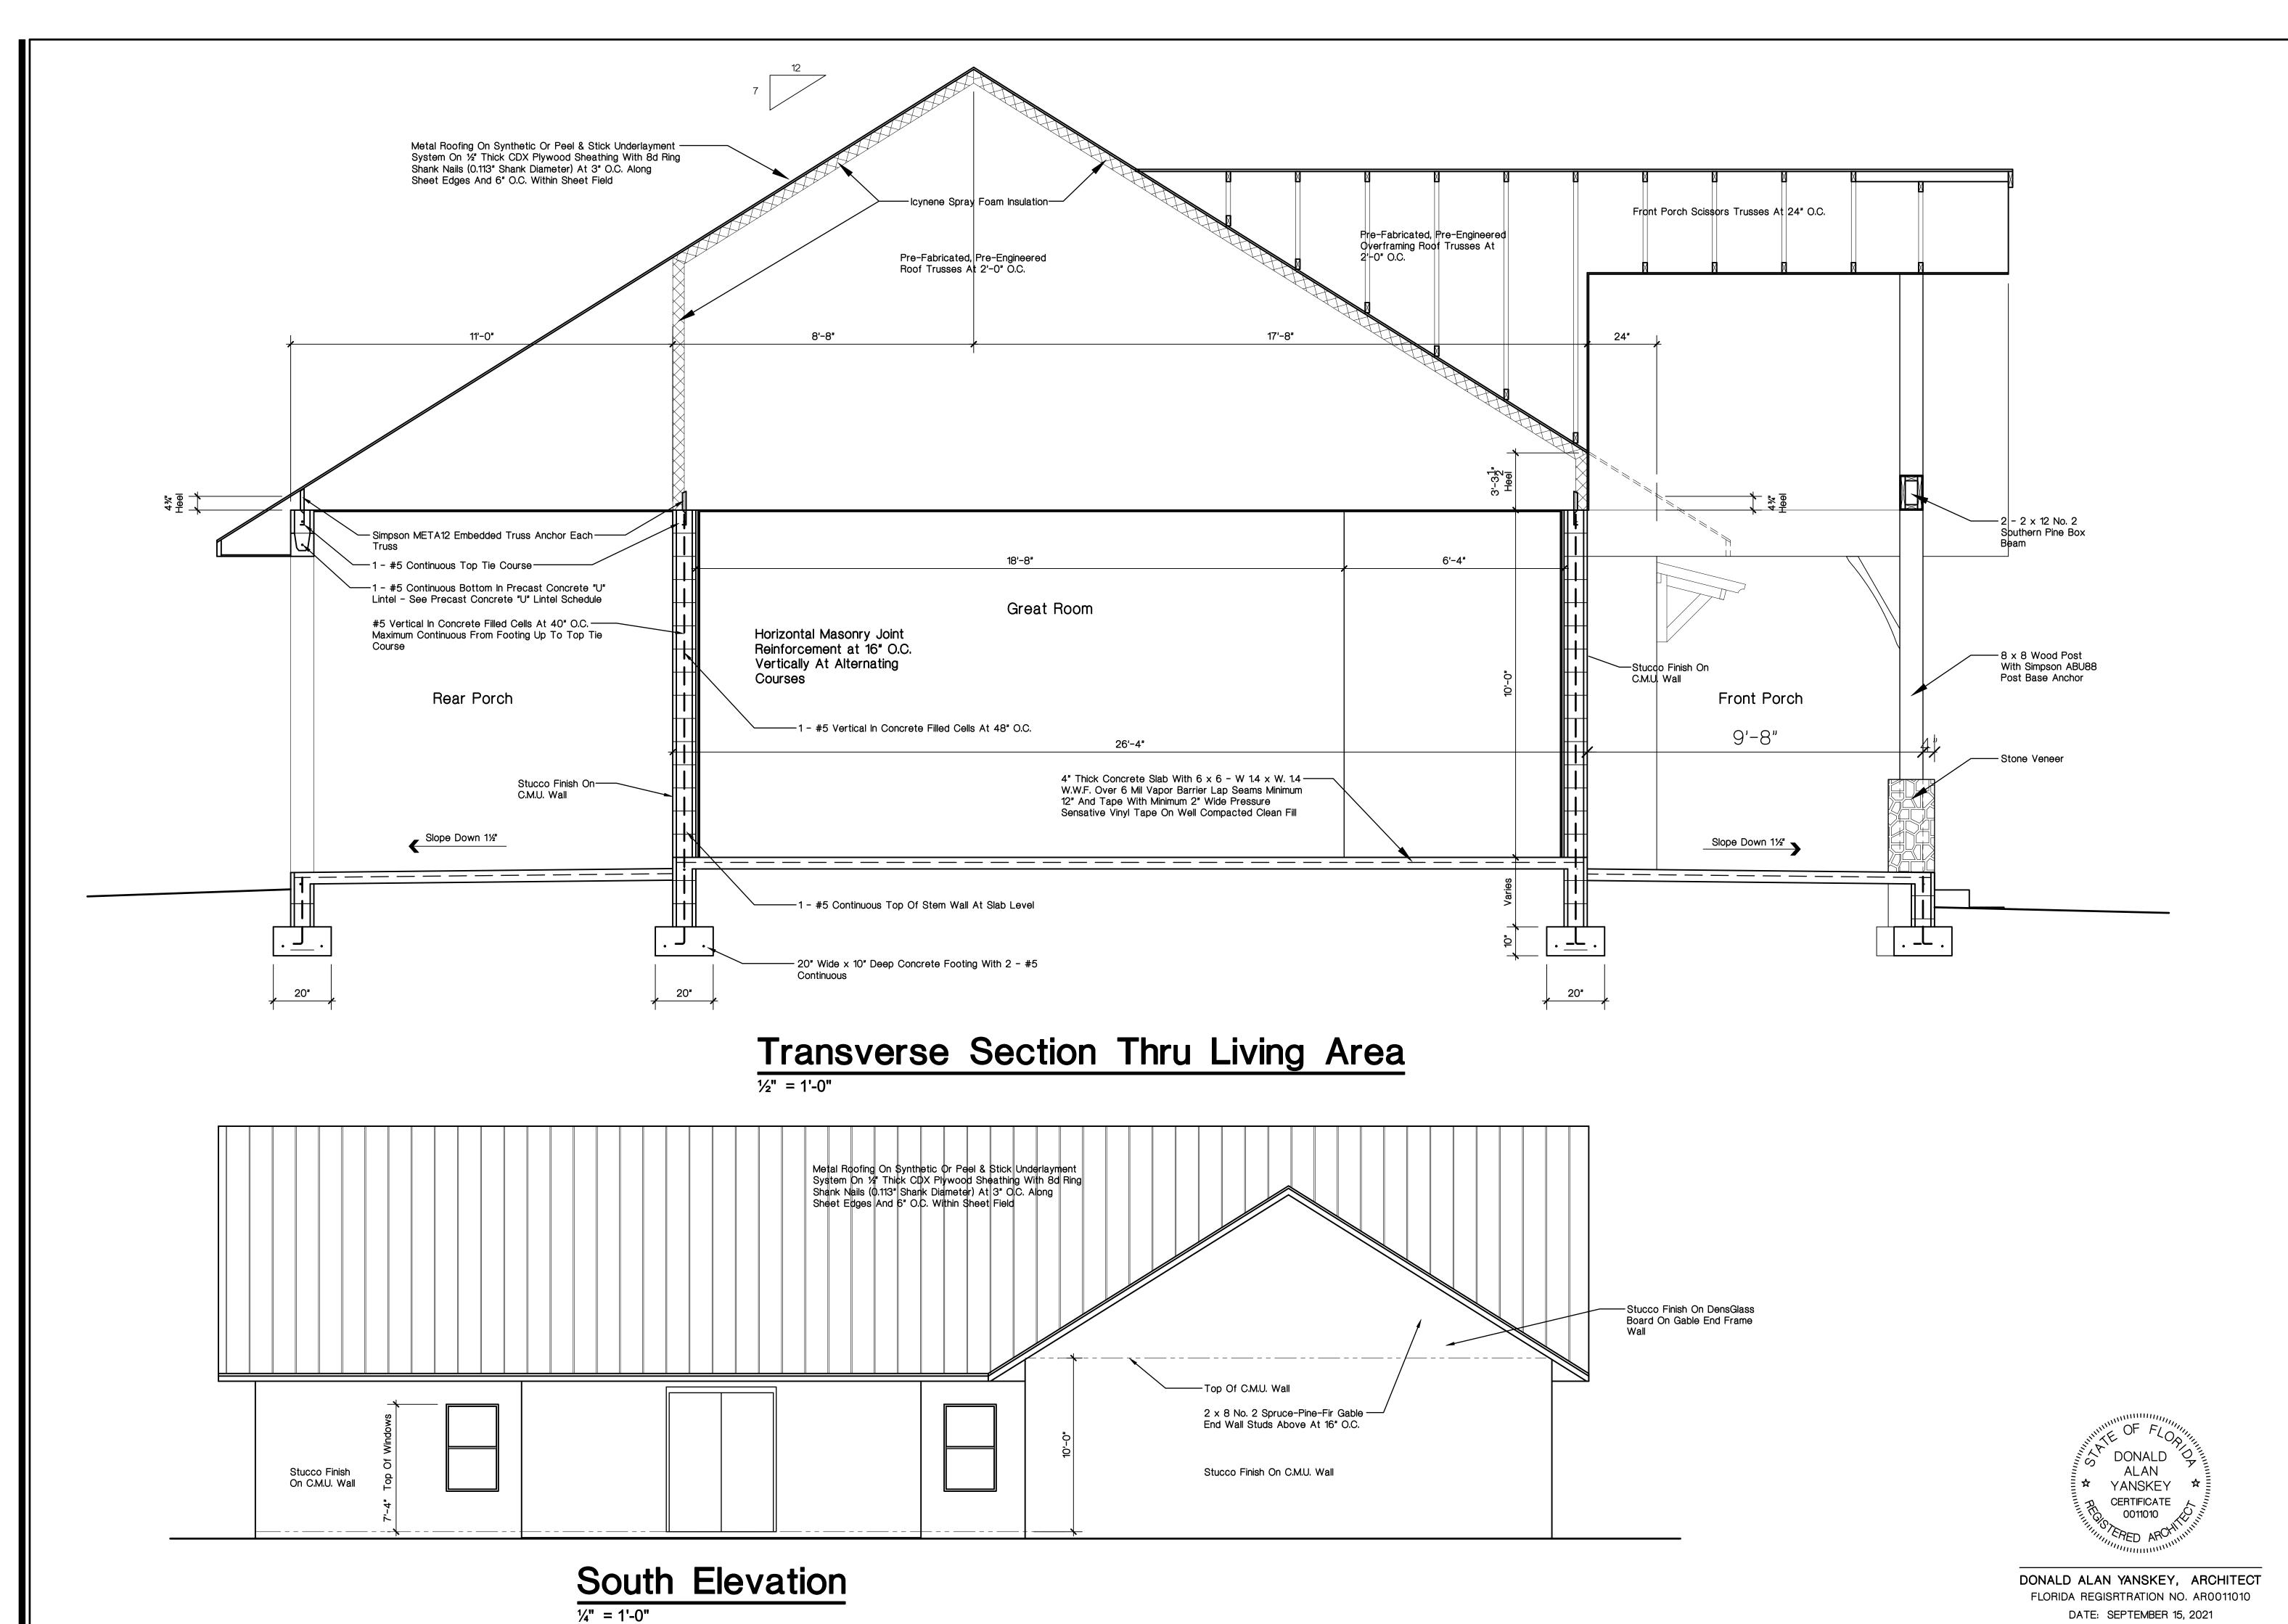

larvey Building & Constructio Newberry, Florida 352-258-9051

Donald Alan Yanskey

ADCHITTECT

Northwest 49th Avenue Gainesville, Florida 32605


DATE DRAWN BY REVISED
Sept. 15, 2021
D. A. Y.

JOB NUMBER CHECKED
Kibler
D. A. Y.

Zibler & Janie Graziani

S H E E T

A-5

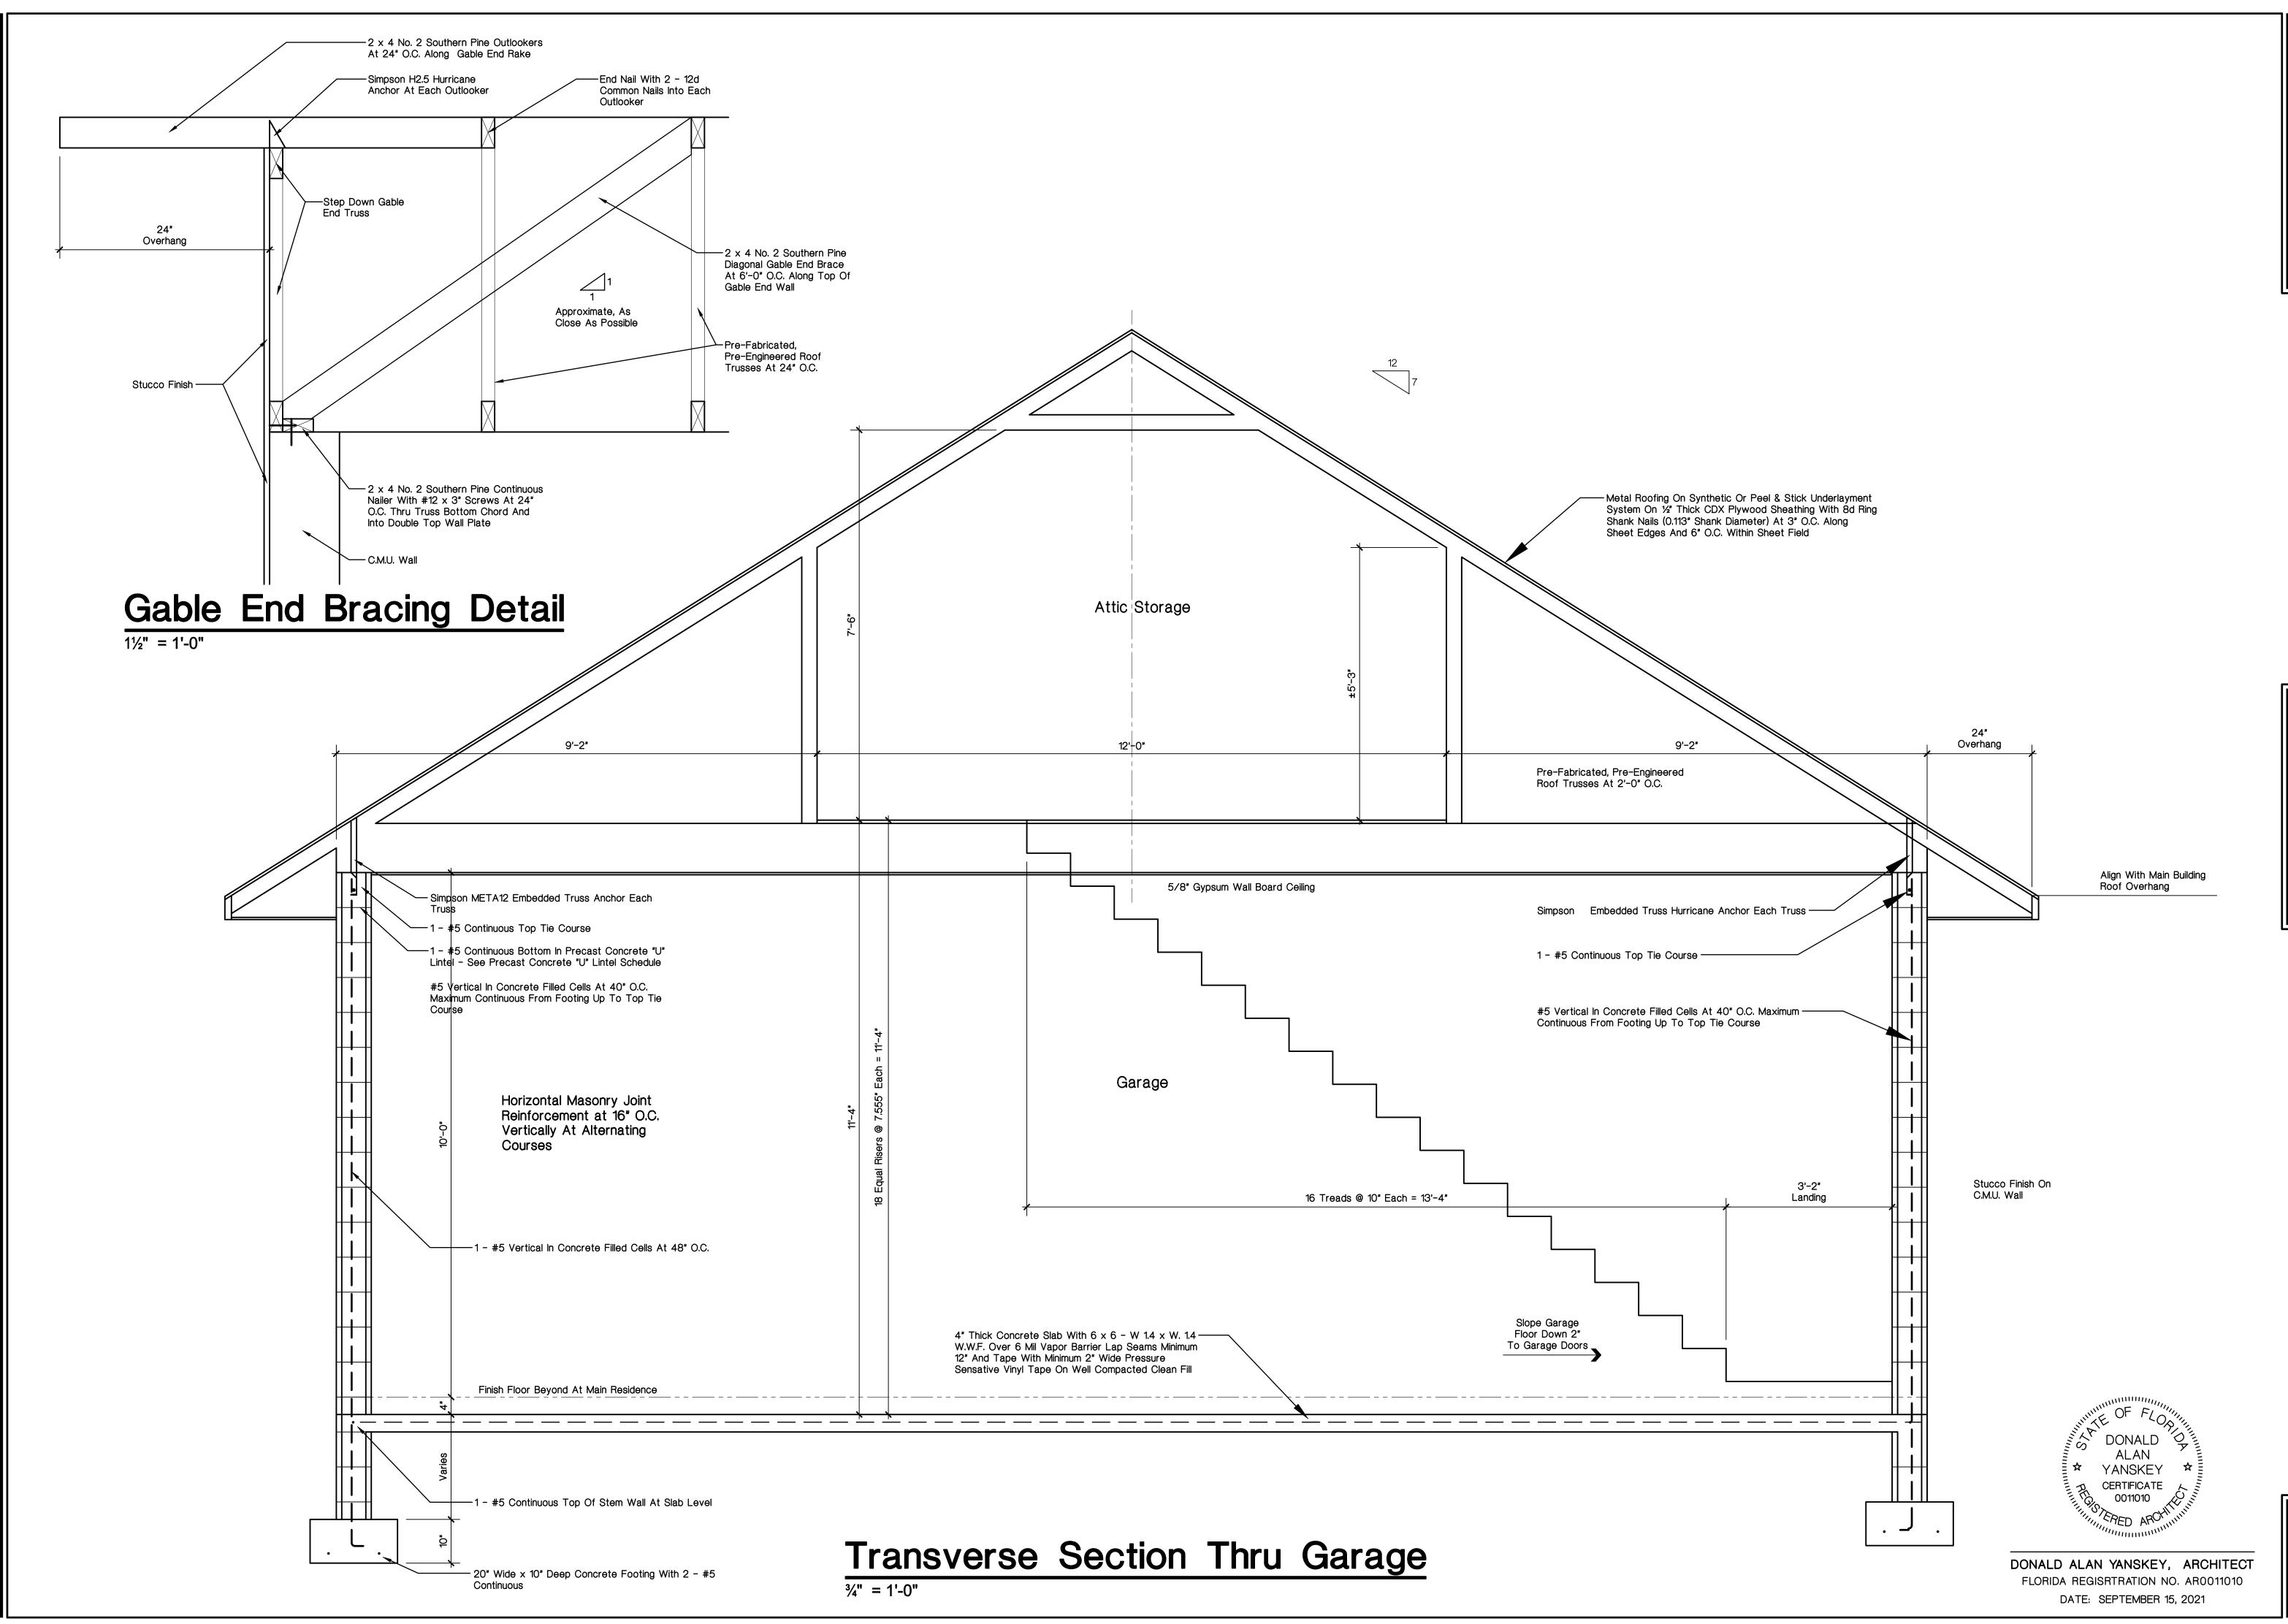

Harvey Building & Constructior
Newberry, Florida
352-258-9051

Donald Man Yanskey

ADCHITECT

AI Northwest 49th Avenue Gainesville, Florida 32605

DATE DRAWN BY REVISED
Sept. 15, 2021
D. A. Y.

JOB NUMBER CHECKED
Kibler
D. A. Y.

A New Residence For

Kibler & Janie Grazial
Southwest Skinner Glen - Lake City, Florid

S H E E T

A-6

¹/₄" = 1'-0"

No Scale

ansk Alan onald

Graziani

FLORIDA REGISRTRATION NO. AR0011010

DATE: SEPTEMBER 15, 2021