


PROPOSED EAST ELEVATION

SCALE: 1/4" = 1'-0"

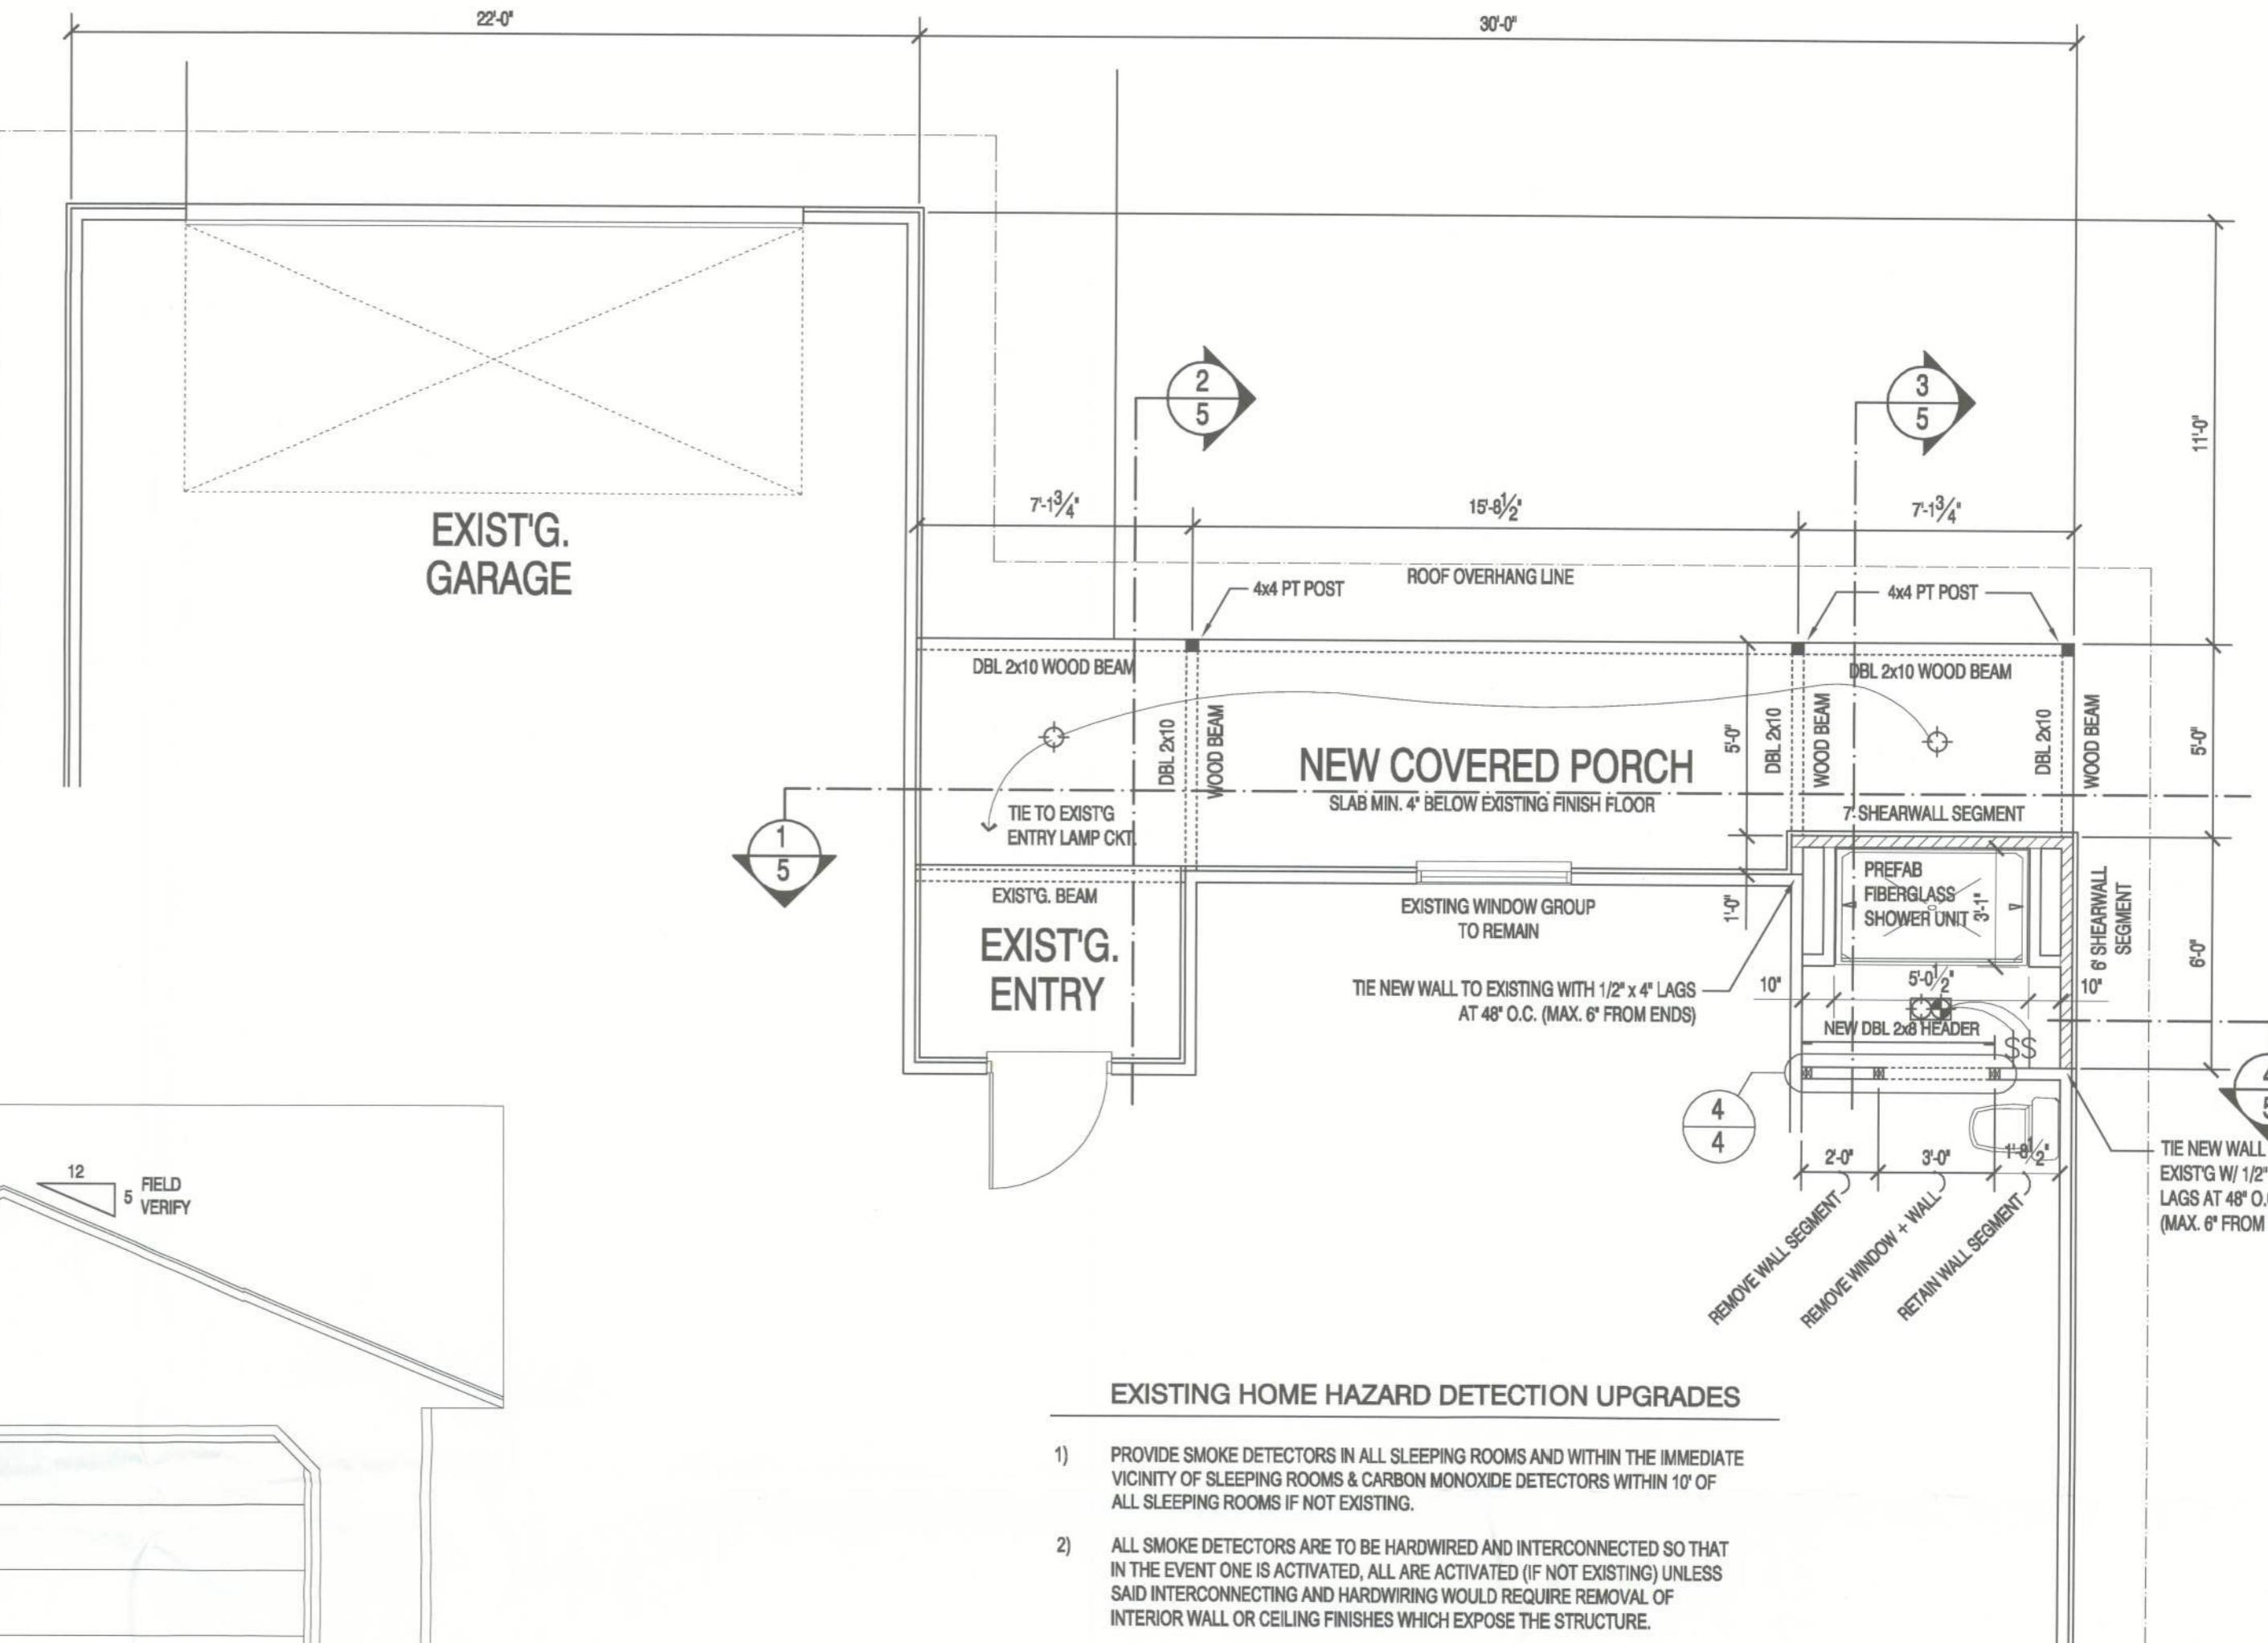

PROPOSED PARTIAL FIRST FLOOR PLAN

SHOWING PROPOSED ELECTRICAL WORK

SCALE: 1/4" = 1' 0"

ELECTRICAL FIXTURE LEGEND

- 1) PROVIDE SMOKE DETECTORS IN ALL SLEEPING ROOMS AND WITHIN THE IMMEDIATE VICINITY OF SLEEPING ROOMS & CARBON MONOXIDE DETECTORS WITHIN 10' OF ALL SLEEPING ROOMS IF NOT EXISTING.
 - 2) ALL SMOKE DETECTORS ARE TO BE HARDWIRED AND INTERCONNECTED SO THAT IN THE EVENT ONE IS ACTIVATED, ALL ARE ACTIVATED (IF NOT EXISTING) UNLESS SAID INTERCONNECTING AND HARDWIRING WOULD REQUIRE REMOVAL OF INTERIOR WALL OR CEILING FINISHES WHICH EXPOSE THE STRUCTURE.

SCISSOR TRUSS PROFILE

SCALE: 3/4" = 1'-0"

IT IS ESSENTIAL THAT THE GENERAL CONTRACTOR VERIFY ALL
MEASUREMENTS AND PROPOSED TRUSS DESIGN DIMENSIONS PRIOR TO
ORDERING MANUFACTURE OF PRE-ENGINEERED WOOD ROOF TRUSSES

Architectural drawing showing the transition from an existing roof to a new gable roof. The drawing includes labels for existing and new materials, dimensions (12/5 pitch, 2 inches), and specific construction details like scissor trusses and flashings at intersections and valleys. A central window group and an entrance door are also indicated.

EXISTING HOME HAZARD DETECTION UPGRADES

ELECTRICAL FIXTURE LEGEND

- SWITCH RUN

\$ WALL SWITCH

 110-120V. DUPLEX CONVENIENCE OUTLET,
18" A.F.F., OR AS OTHERWISE INDICATED.

 GFCI GROUND-FAULT CIRCUIT INTERRUPTER 110-120V. DUPLEX RECEPTACLE

 WP - GFCI GROUND-FAULT CIRCUIT INTERRUPTER 110-120V. DUPLEX RECEPTACLE IN WATERPROOF HOUSING

 EXTERIOR CEILING LIGHT - UL LISTED SURFACE MOUNTED, 150W. MAX.

 BATH FAN/LIGHT COMBO - UL LISTED

NOTES

HEATING AND AIR CONDITIONING DESIGN BY OTHERS

ELECTRICAL CONTRACTOR SHALL EXAMINE EXISTING LOAD CENTER AND
SHALL FEED ALL NEW CIRCUITRY FROM OPEN SLOTS

PLUMBING CONTRACTOR SHALL TIE INTO EXISTING WATER SUPPLY AND

DISCLAIMER

THE EXISTING CONDITIONS AS SHOWN ON THIS SITE PLAN AND OTHER DRAWINGS AND DETAILS IN THIS PLAN SET ARE FROM SURVEY PLATS AND VERIFIED BY FIELD MEASUREMENTS. STRUCTURAL PLAN SERVICES, INC. TAKES NO RESPONSIBILITY AS TO THE ACCURACY OR COMPLETENESS OF THE REPRESENTATIONS.

SHEET NUMBER

OF 5 SHEETS

PROJECT NO. 100701

ANSWER

✓ See 8/20/10

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(386) 365-6812

**PROPOSED ADDITION
BRADFORD RESIDENCE
30 SE CAROB GLEN, LAKE CITY, FL 32025
PARCEL NO. 03-4S-17-07570-023**