



| AREA SUMMARY | |
|--------------|-----------|
| MAIN FLOOR - | 1486.7 SF |
| GARAGE - | 484.0 SF |
| PORCHES - | 236.2 SF |
| TOTAL AREA - | 2206.9 SF |

NEW SINGLE FAMILY DWELLING FOR:
NATHAN BORER


BRIAN S. CRAWFORD
ARCHITECTURAL DESIGN
2108 W. U.S. HWY 90 SUITE 170-44
LAKE CITY, FL 33505
(286) 785-9987

ELEVATION PLAN
SCALE: 1/4"=1'-0"



SHEET NUMBER

A-1

OF 4 SHEETS

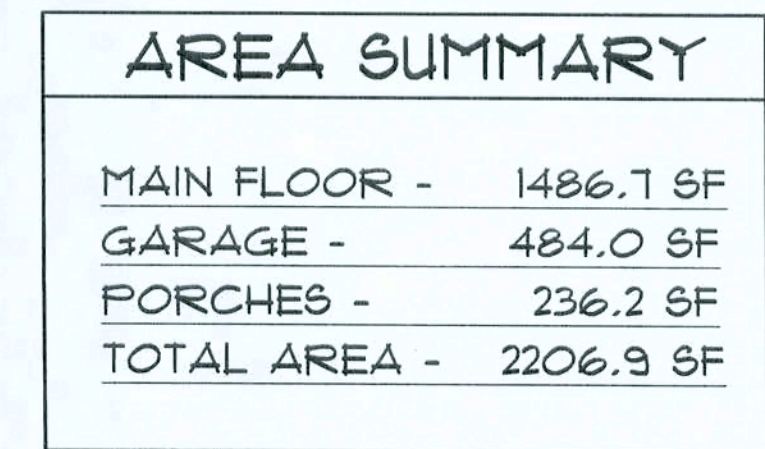

OF 4 SHEETS

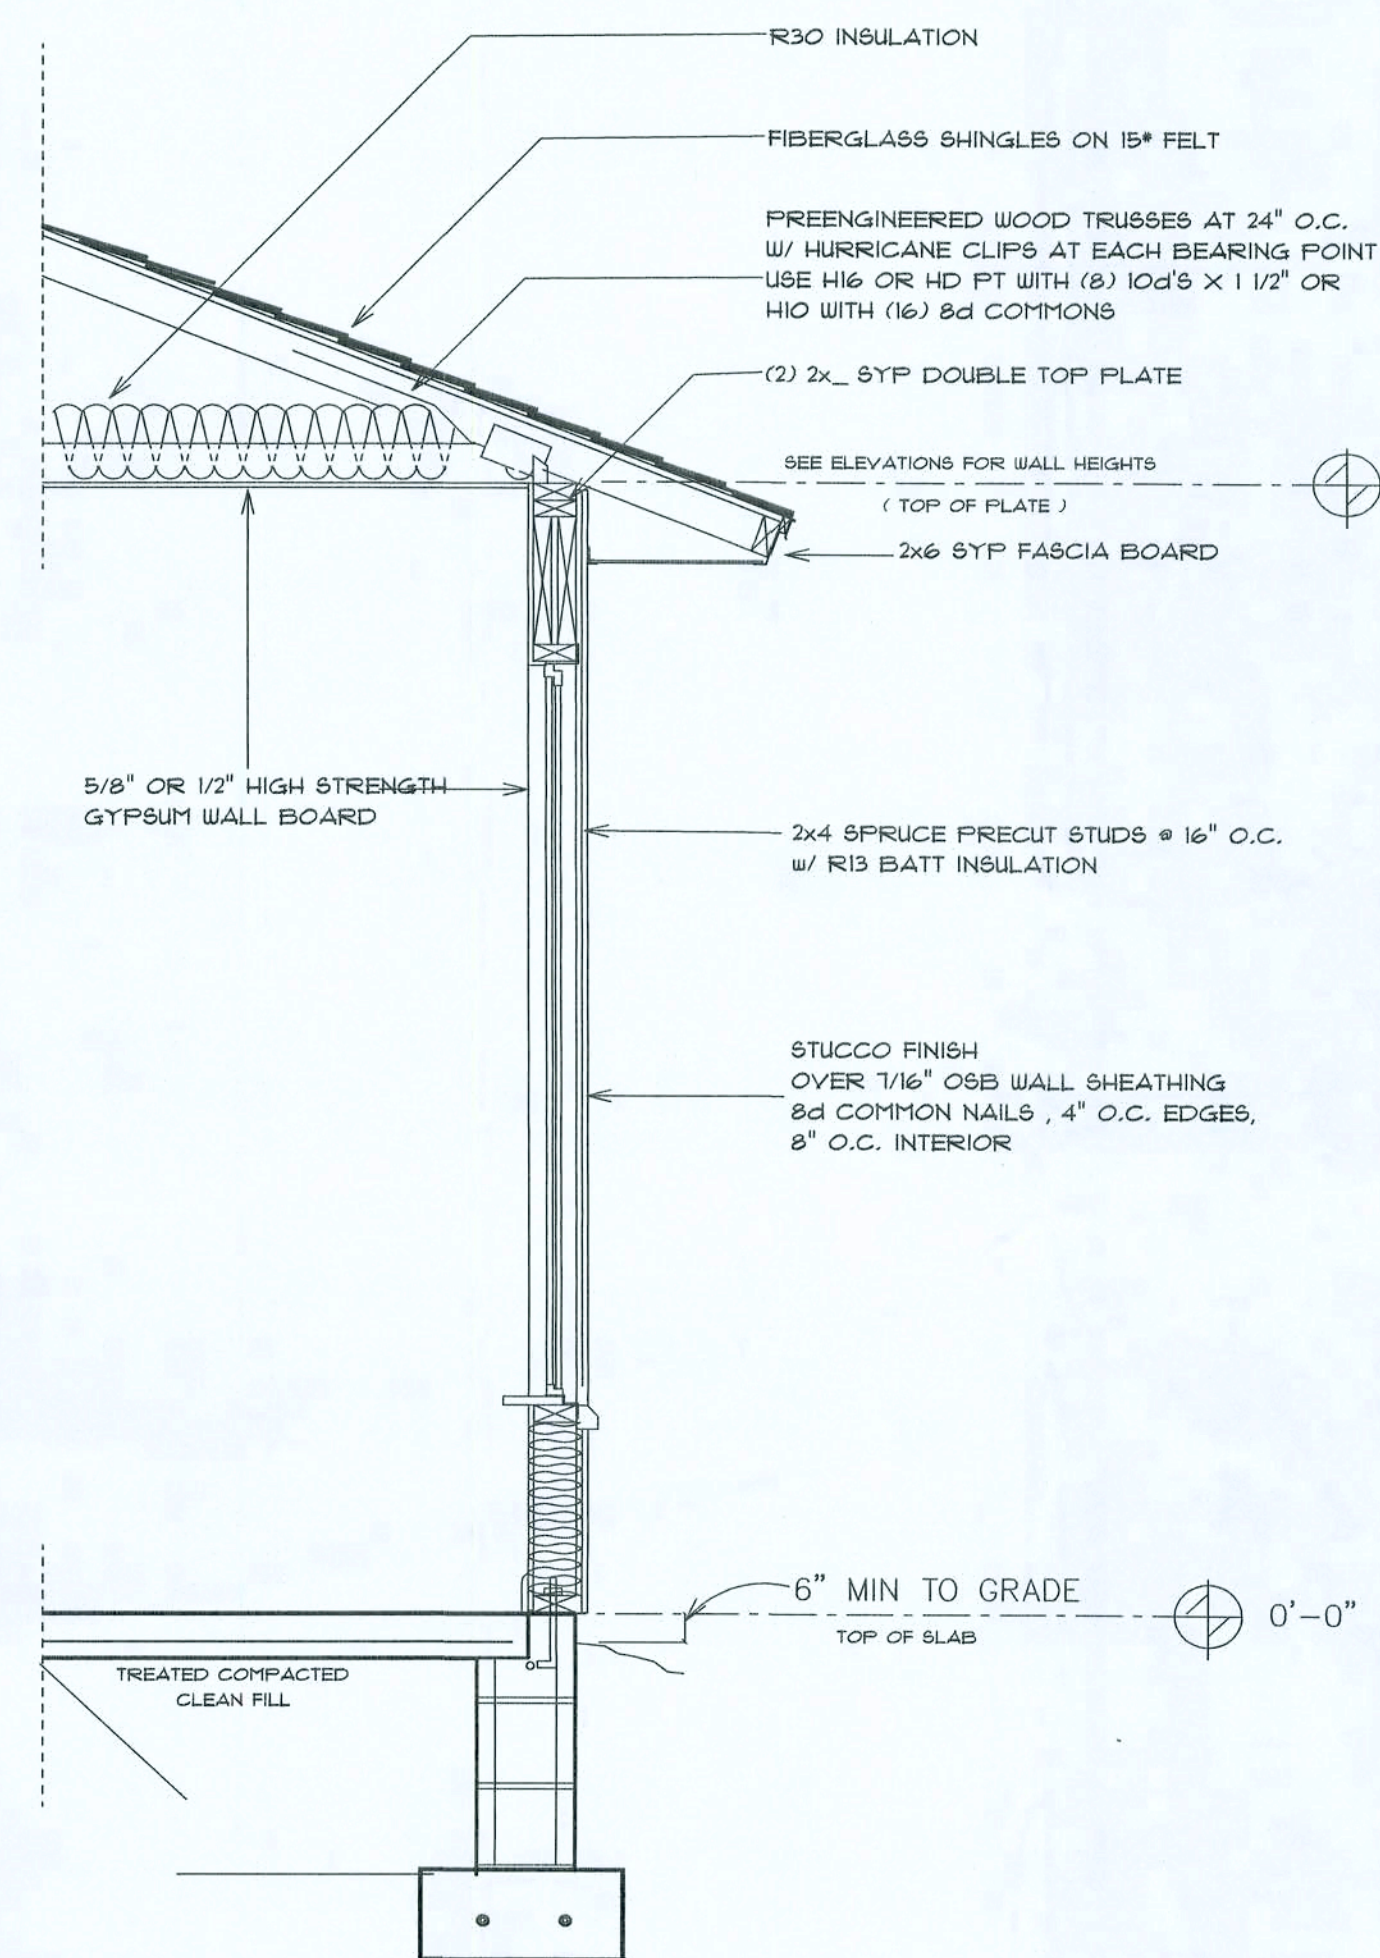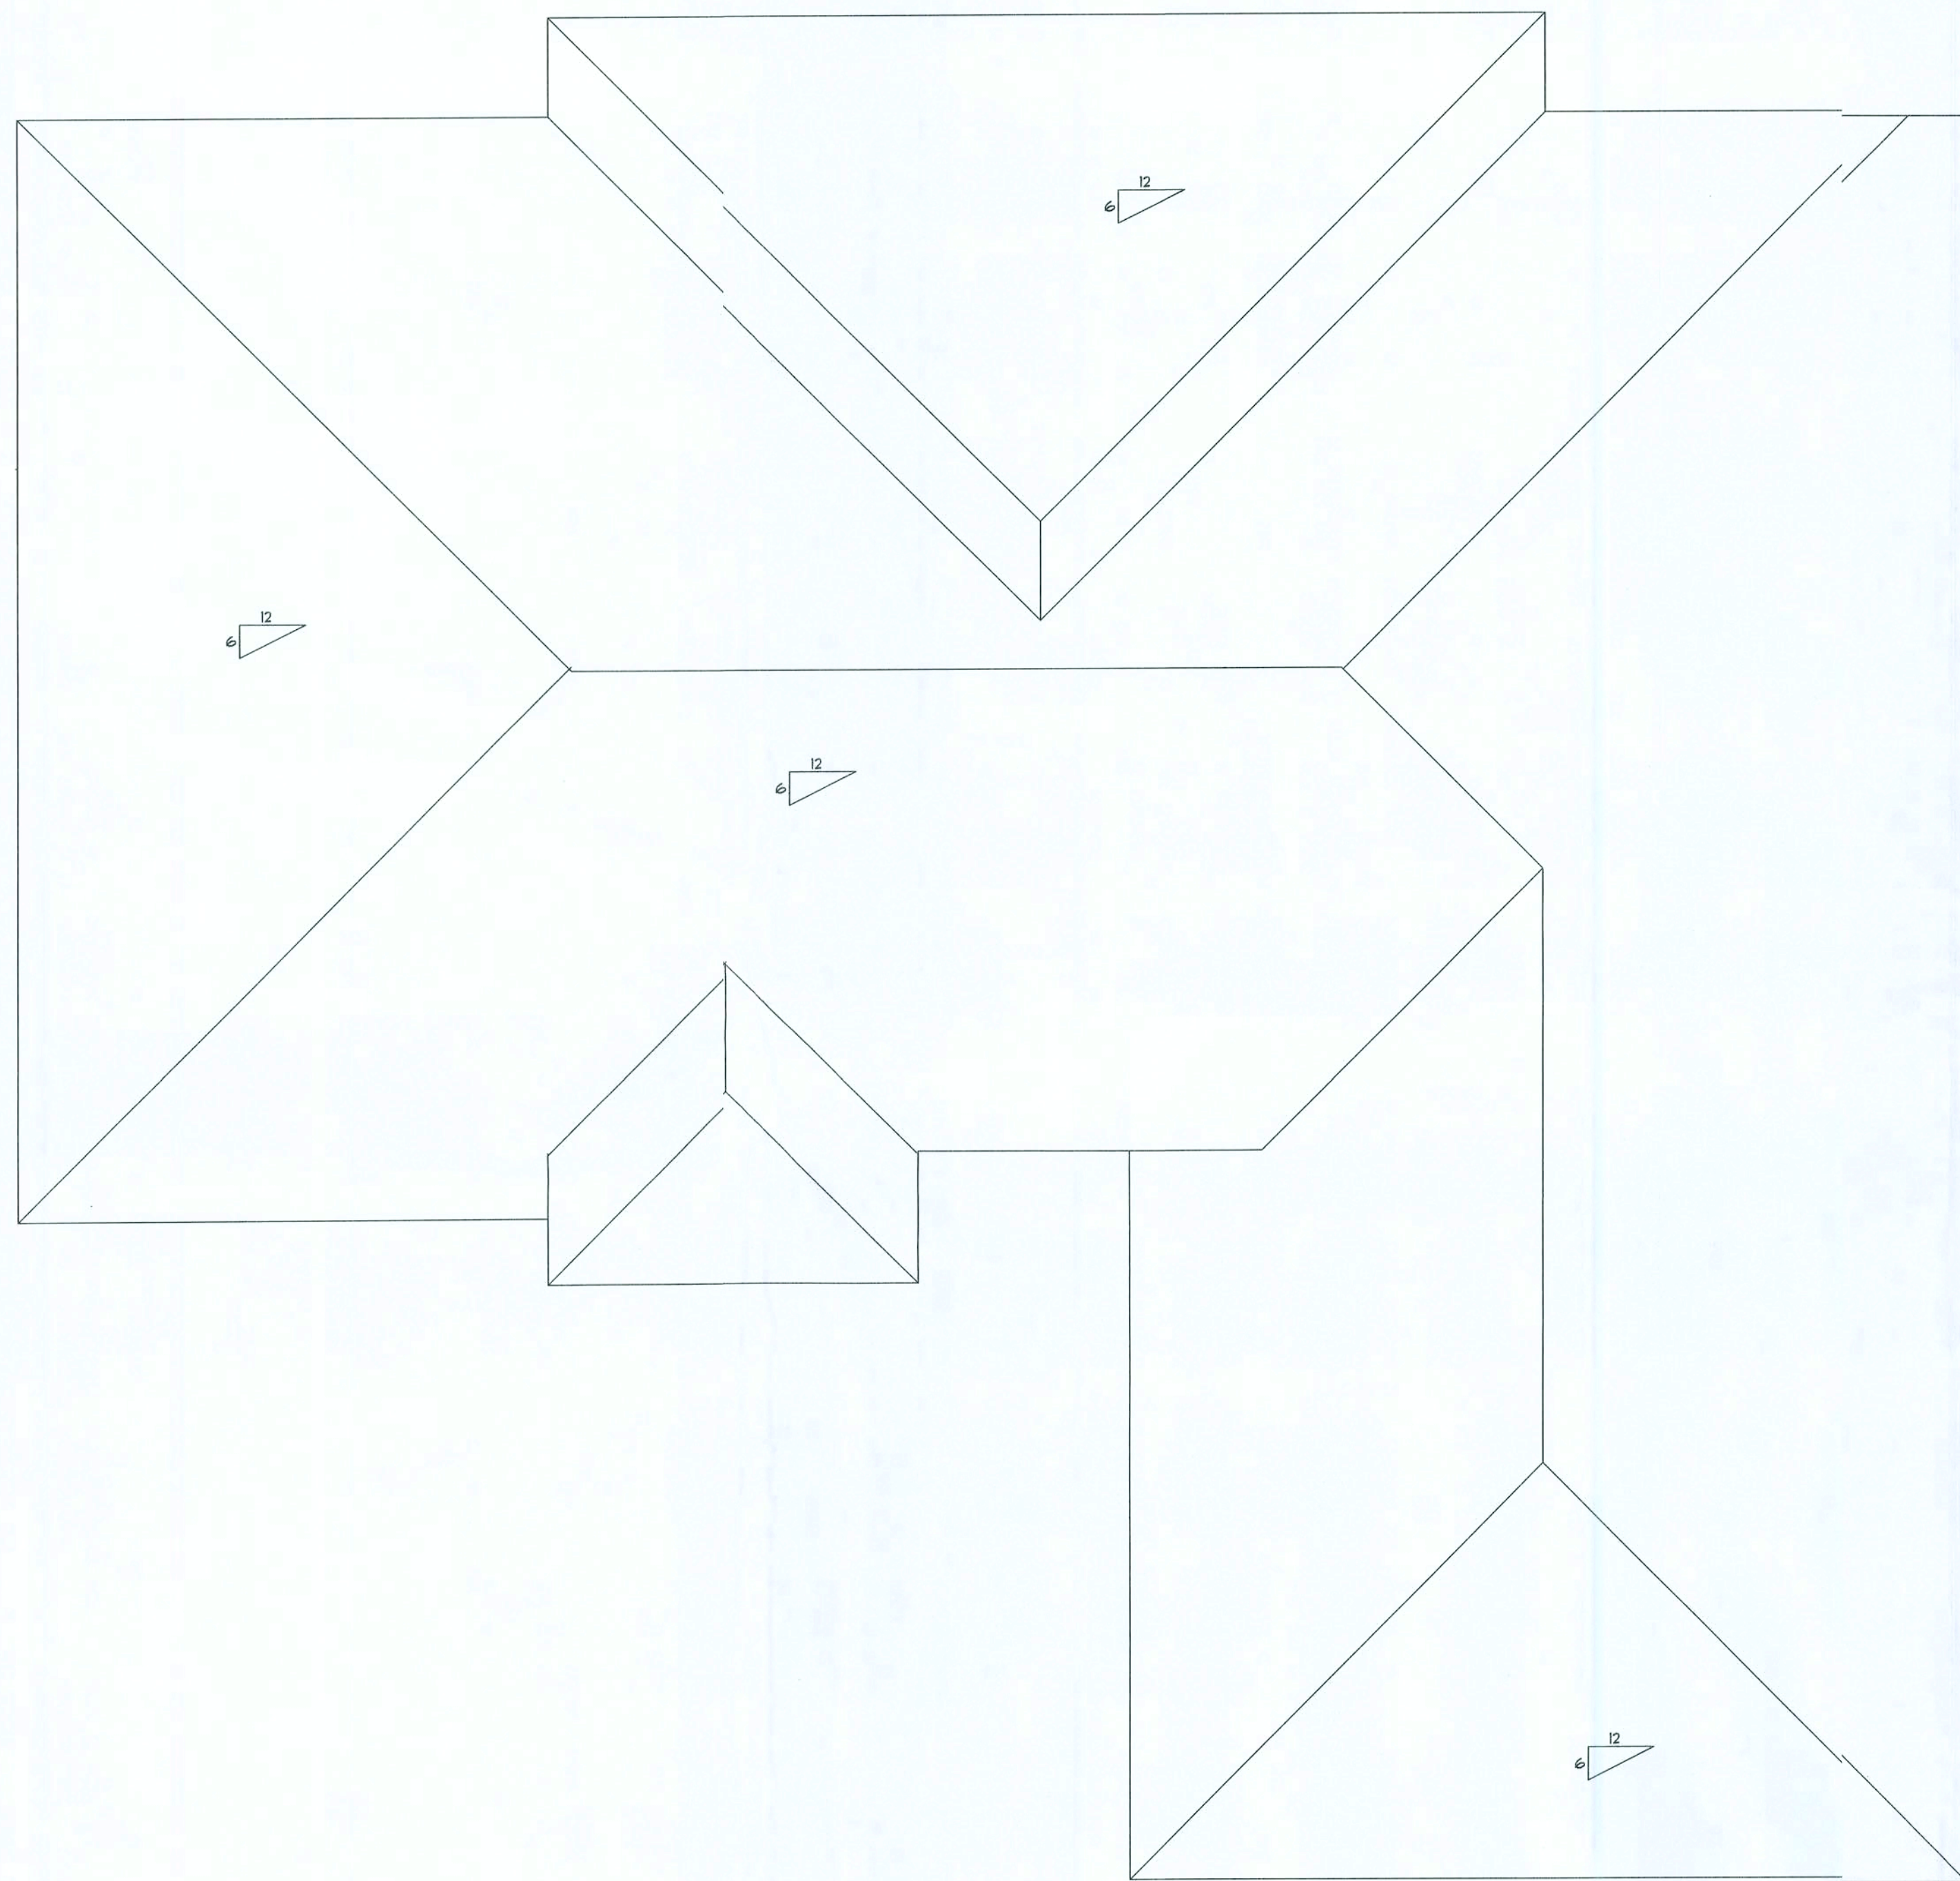

TYPICAL WALL SECTION
2 X 4 STUD WALL

AREA SUMMARY

| | |
|--------------|-----------|
| MAIN FLOOR - | 1486.1 SF |
| GARAGE - | 484.0 SF |
| PORCHES - | 236.2 SF |
| TOTAL AREA - | 2206.3 SF |

NEW SINGLE FAMILY DWELLING FOR
NATHAN BORER


BRIAN S. CRAWFORD
ARCHITECTURAL DESIGN
2103 W. U.S. HWY 90 SUITE 170-144
LAKE CITY, FL 32055
(386) 755-8861

ROOF PLAN
SCALE: 1/4"=1'-0"

SHEET NUMBER

A-3

OF 4 SHEETS

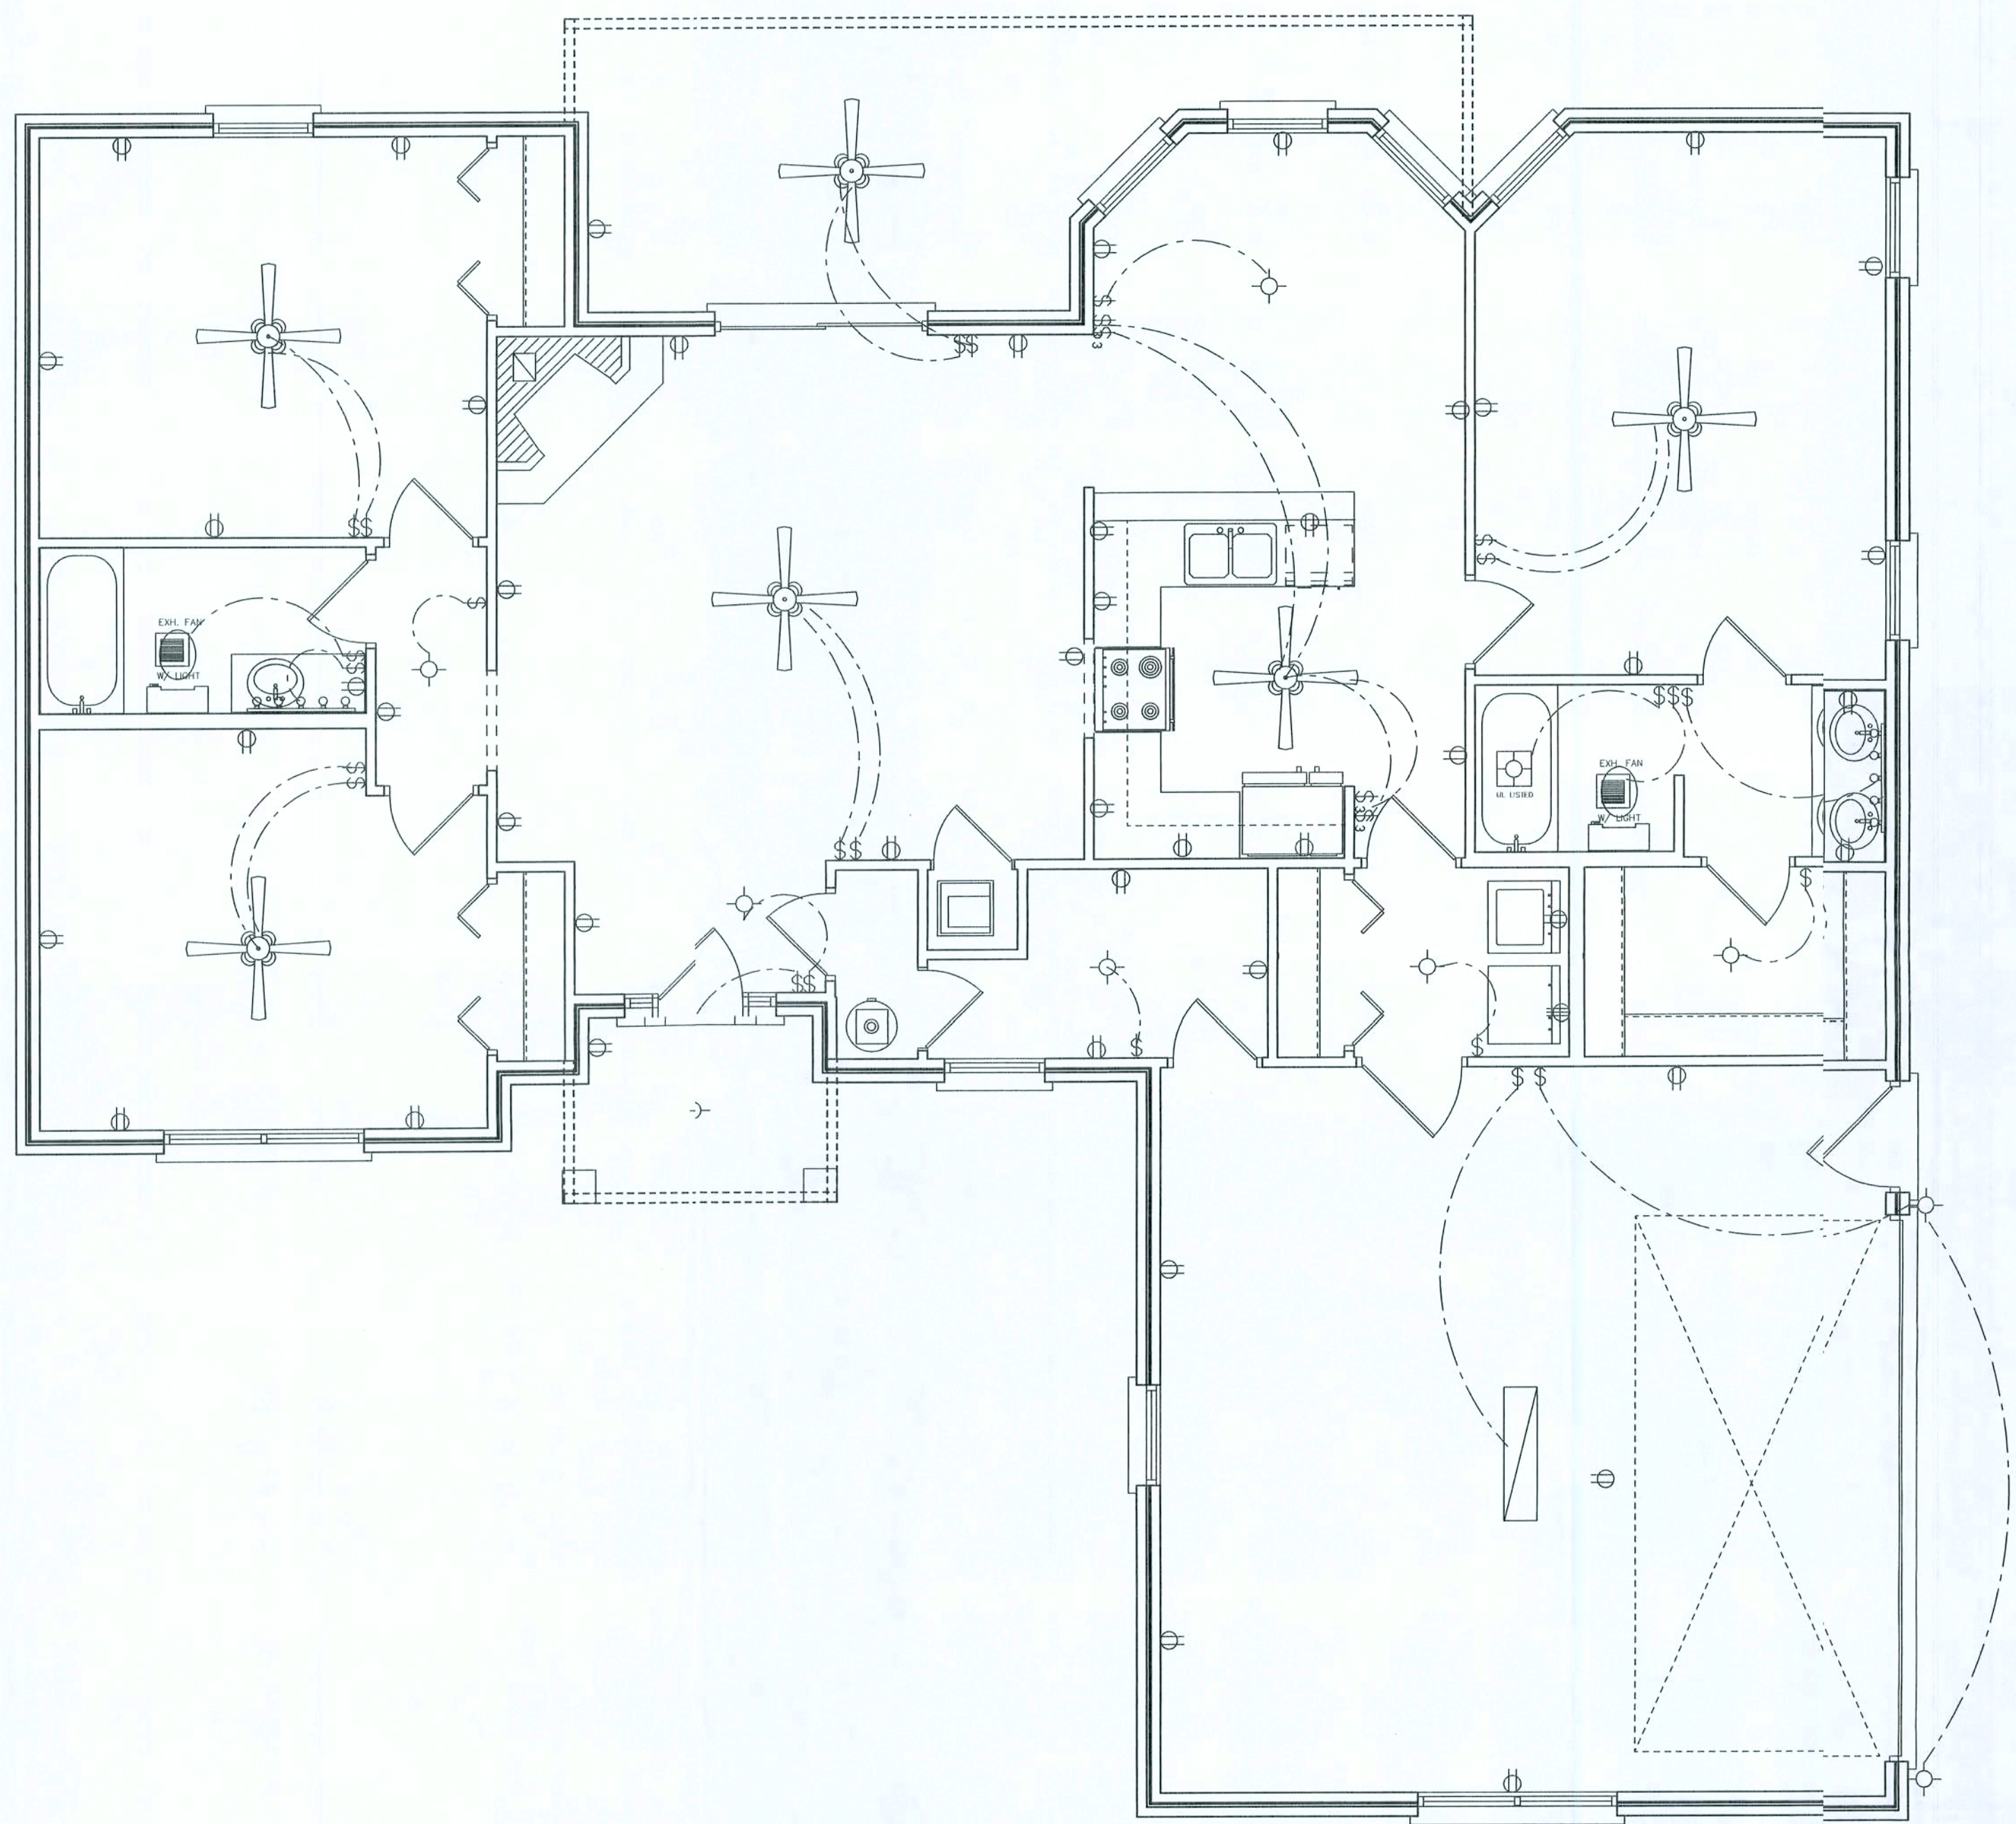

| ELECTRICAL | COUNT | SYMBOL |
|--------------------------|-------|--------|
| ceiling fan spotlights 1 | 6 | |
| 220 Volt Outlet | 1 | |
| 3 Way Switch | 4 | |
| EXT. FAN W LITE | 2 | |
| Light | 9 | |
| Outlet | 46 | |
| Switch | 24 | |
| UL LISTED | 1 | |
| fluor fixture | 1 | |
| vanity bar lt | 2 | |

ELECTRICAL PLAN NOTES

ALL RECEPTALS IN ALL BEDROOMS SHALL BE AFCI CIRCUITS

WIRE ALL APPLIANCES, HVAC UNITS AND OTHER EQUIPMENT PER MANUF. SPECIFICATIONS.

CONSULT THE OWNER FOR THE NUMBER OF SEPERATE TELEPHONE LINES TO BE INSTALLED.

INSTALLATION SHALL BE PER NAT'L. ELECTRIC CODE.

ALL SMOKE DETECTORS SHALL BE 120V W/ BATTERY BACKUP OF THE PHOTOELECTRIC TYPE, AND SHALL BE INTERLOCKED TOGETHER. INSTALL INSIDE AND NEAR ALL BEDROOMS.

TELEPHONE, TELEVISION AND OTHER LOW VOLTAGE DEVICES OR OUTLETS SHALL BE AS PER THE OWNER'S DIRECTIONS, & IN ACCORDANCE W/ APPLICABLE SECTIONS OF NEC-LATEST EDITION.

ELECTRICAL CONTR SHALL PREPARE "AS-BUILT" SHOP DWGS INDICATING ALL ELECTRICAL WORK, INCLUDING ANY CHANGES TO THE ELEC. PLAN, ADD'NS TO THE ELEC. PLAN, RISER DIAGRAM, AS-BUILT PANEL SCHEDULE W/ ALL CKTS IDENTIFIED W/ CKT Nr., DESCRIPTION & BRKR, SERVICE ENT. & ALL UNDERGROUND WIRE LOCATIONS/ROUTING/DEPTH. RISER DIA. SHALL INCLUDE WIRE SIZES/TYPE & EQUIPMENT TYPE W/ RATINGS & LOADS. CONTRACTOR SHALL PROVIDE 1 COPY OF AS-BUILT DWGS TO OWNER & 1 COPY TO THE PERMIT ISSUING AUTHORITY.

| AREA SUMMARY | |
|--------------|-----------|
| MAIN FLOOR - | 1486.7 SF |
| GARAGE - | 484.0 SF |
| PORCHES - | 236.2 SF |
| TOTAL AREA - | 2206.9 SF |

NEW SINGLE FAMILY DWELLING FOR:
NATHAN BORER

BRIAN S. CRAWFORD
ARCHITECTURAL DESIGN
2105 W. U.S. HWY. 100 SUITE 110-144
LAKESIDE, CO. 80123
(303) 715-5881


ELECTRICAL
SCALE: 1/4"=1'-0"

SHEET NUMBER

A-4
OF 4 SHEETS


REVISIONS

SOFTPLAN
ARCHITECTURAL DESIGN SOFTWARE

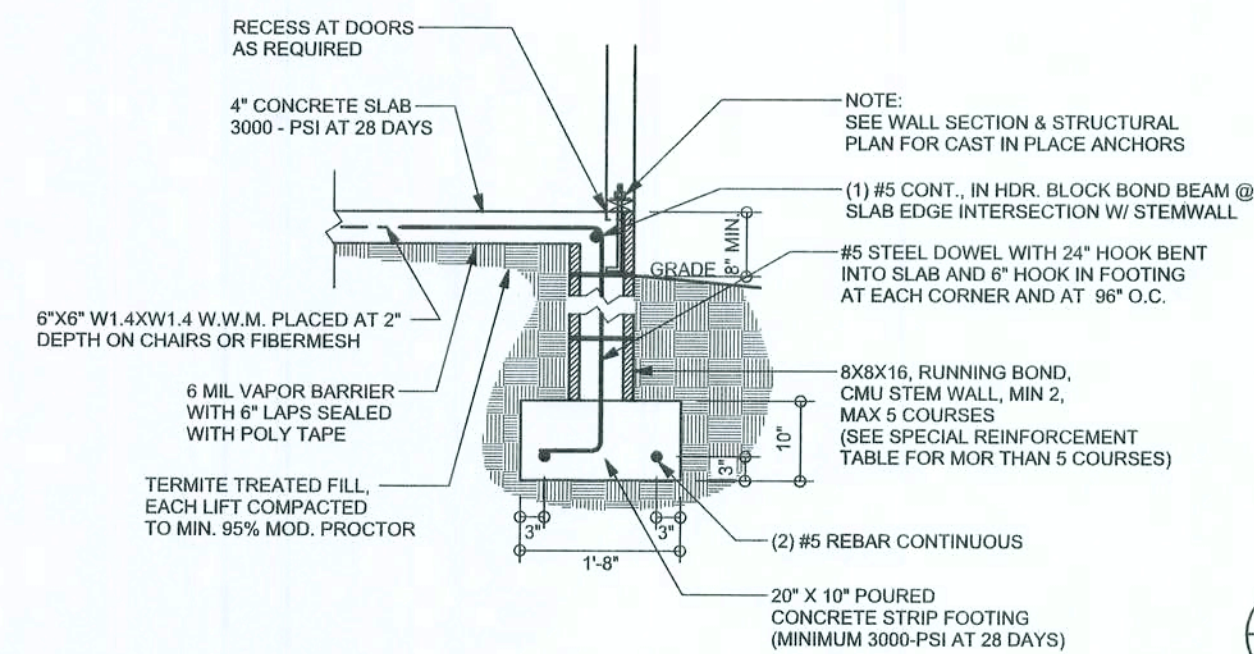


F6 S-2 TYPICAL NON-BEARING STEP FOOTING
SCALE: 1/2" = 1'-0"


F9 S-2 STEM WALL FOOTING
SCALE: 1/2" = 1'-0"

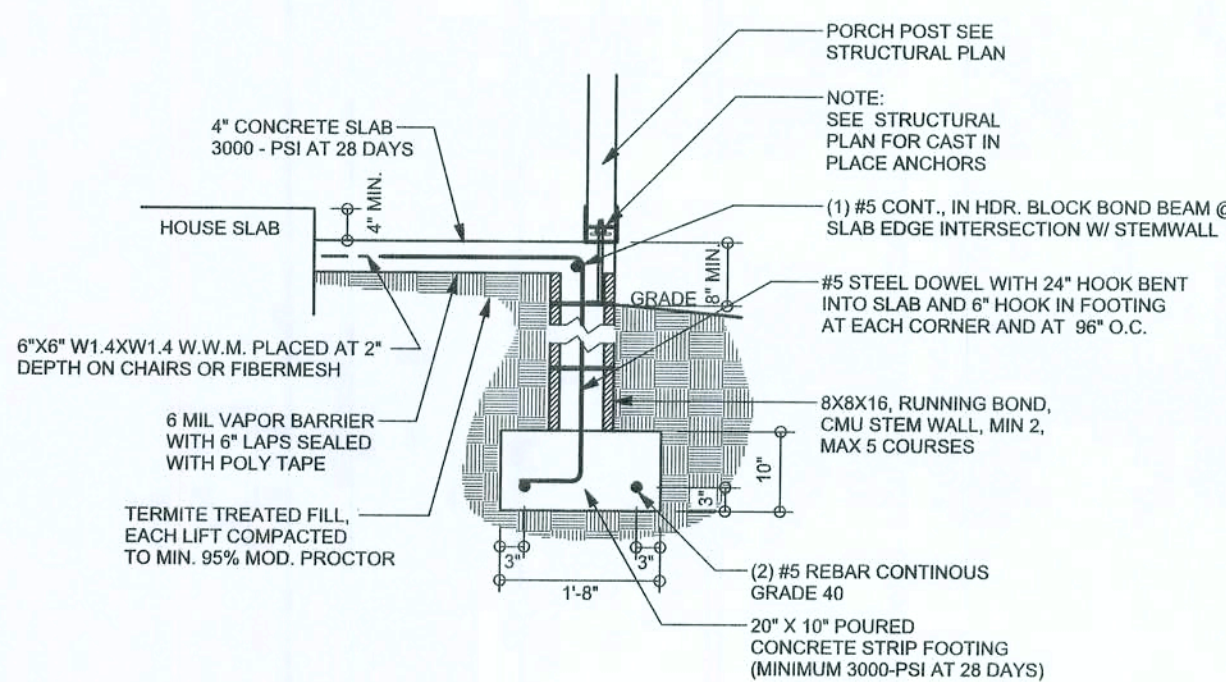


F12 S-2 ALT. STEM WALL PORCH FOOTING
SCALE: 1/2" = 1'-0"

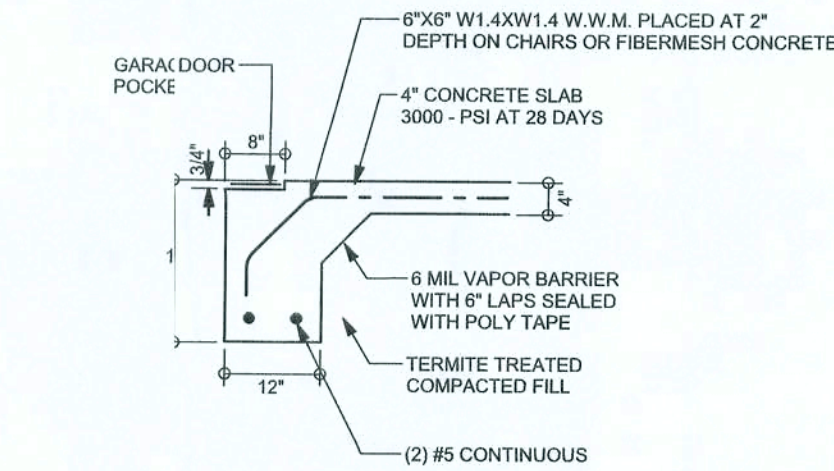


F4 S-2 GARAGE DOOR FOOTING
SCALE: 1/2" = 1'-0"

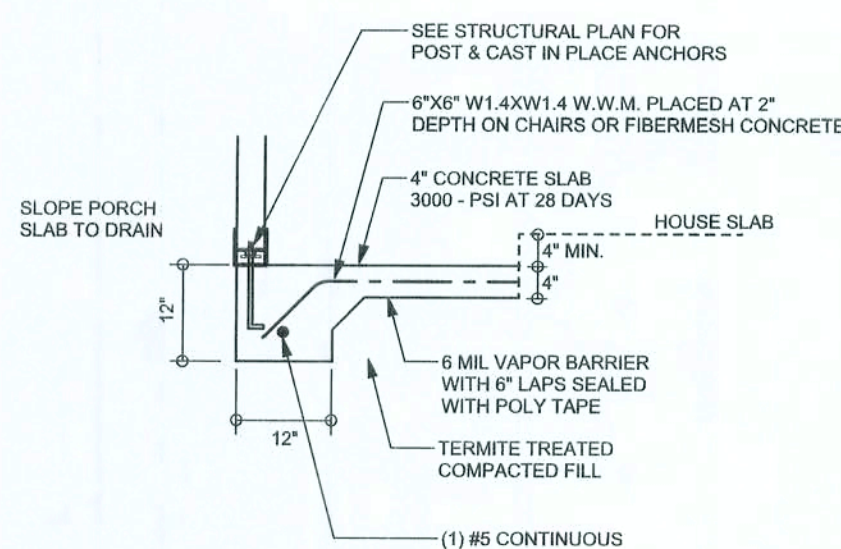

F5 S-2 PORCH FOOTING
SCALE: 1/2" = 1'-0"

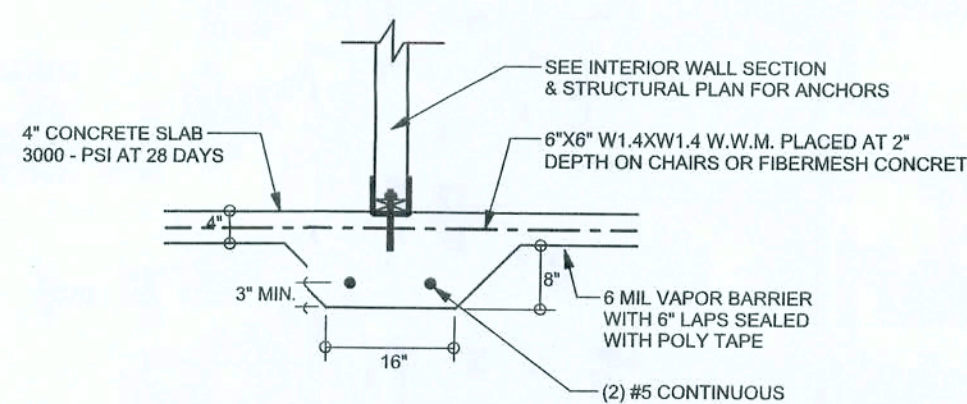

F2 S-2 INTERIOR BEARING FOOTING
SCALE: 1/2" = 1'-0"

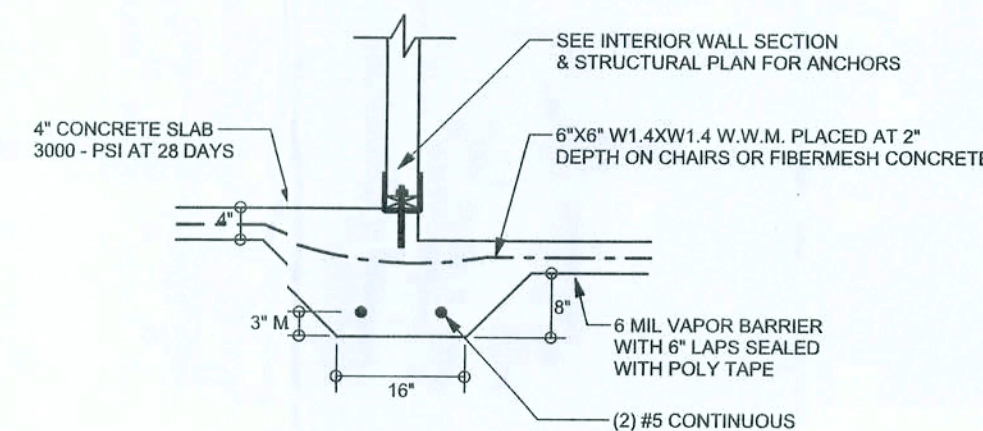


F3 S-2 INTERIOR BEARING STEP FOOTING
SCALE: 1/2" = 1'-0"

TALL STEM WALL TABLE

The table assumes 60 ksi reinforcing bars with 6" hook in the footing and bent 24" into the reinforced slab at the top. The vertical steel is to be placed toward the tension side of the CMU wall (away from the soil pressure, within 2" of the exterior side of the wall). If the wall is over 8' high, add Diagonal ladder reinforcement at 16" O.C. vertically or a horizontal bond beam with 16S continuous at mid height. For higher parts of the wall 12" CMU may be used with reinforcement as shown in the table below.

| STEM WALL HEIGHT (FEET) | UNBALANCED BACKFILL HEIGHT | VERTICAL REINFORCEMENT FOR 8" CMU STEM WALL (INCHES O.C.) | | | VERTICAL REINFORCEMENT FOR 12" CMU STEM WALL (INCHES O.C.) | | |
|-------------------------|----------------------------|---|----|----|--|----|----|
| | | #5 | #7 | #8 | #5 | #7 | #8 |
| 3.3 | 3.0 | 96 | 96 | 96 | 96 | 96 | 96 |
| 4.0 | 3.7 | 96 | 96 | 96 | 96 | 96 | 96 |
| 4.7 | 4.3 | 88 | 96 | 96 | 96 | 96 | 96 |
| 5.3 | 5.0 | 56 | 96 | 96 | 96 | 96 | 96 |
| 6.0 | 5.7 | 40 | 80 | 96 | 80 | 96 | 96 |
| 6.7 | 6.3 | 32 | 56 | 80 | 56 | 96 | 96 |
| 7.3 | 7.0 | 24 | 40 | 56 | 40 | 80 | 96 |
| 8.0 | 7.7 | 16 | 32 | 48 | 32 | 64 | 80 |
| 8.7 | 8.3 | 8 | 24 | 32 | 24 | 48 | 64 |
| 9.3 | 9.0 | 8 | 16 | 24 | 16 | 40 | 48 |

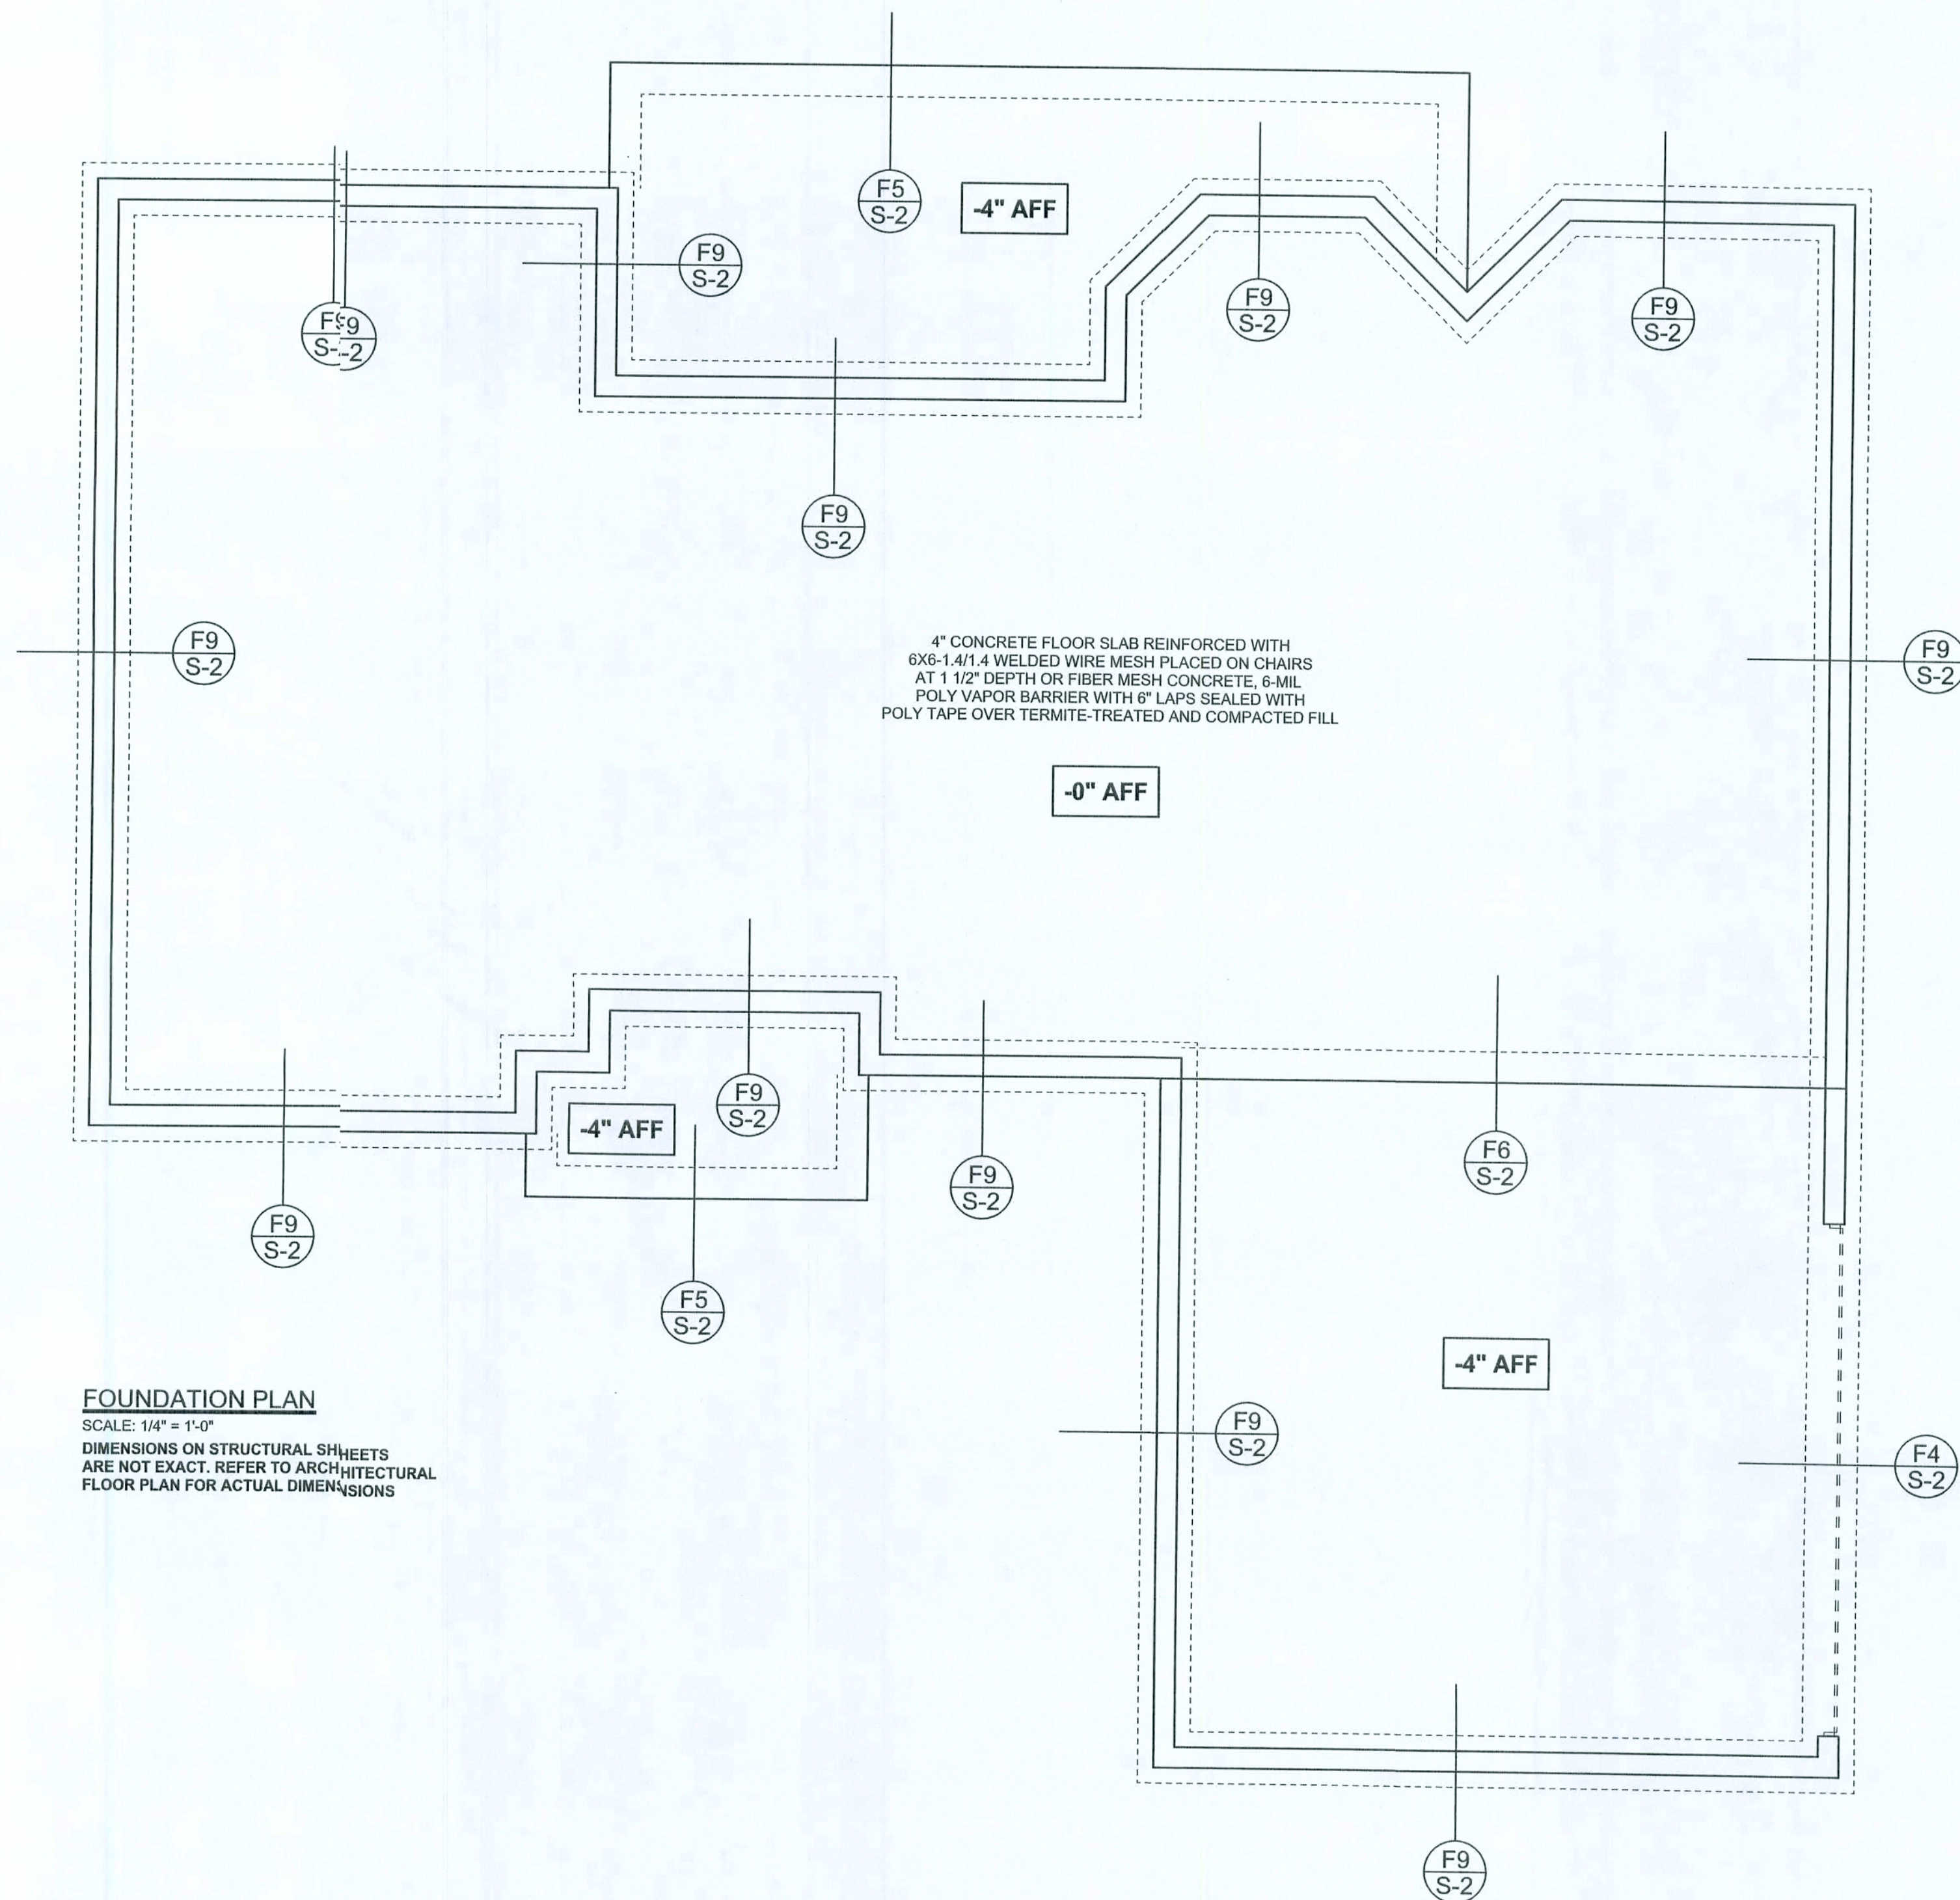

FOUNDATION PLAN
SCALE: 1/4" = 1'-0"
DIMENSIONS ON STRUCTURAL SHEETS ARE NOT EXACT. REFER TO ARCHITECTURAL FLOOR PLAN FOR ACTUAL DIMENSIONS

WINDLOAD ENGINEER: Mark Disoway, P.E. No. 33915, P.O. Box 868, Lake City, FL 32056, 386-754-5419

DIMENSIONS:
Stated dimensions supersedes scaled dimensions. Refer all questions to Mark Disoway, P.E. for resolution. Do not proceed without clarification.

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CERTIFICATION: I hereby certify that I have examined this plan, and that the applicable portions of the plan, relating to wind engineering comply with section FC1-2.1, Florida building code residential 2004, to the best of my knowledge.

LIMITATION: This design is valid for one building, at specified location.

MARK DISOWAY
P.E. 3915

Stanley Crawford Construction

Nathar Borer Residence

ADDRESS:
281 SW Calaway DR.
Columbia Co. Lake City, FL 32024

Mark Disoway P.E.
P.O. Box 868
Lake City, Florida 32056
Phone: (386) 754 - 5419
Fax: (386) 769 - 4871

PRINTED DATE:
April 12, 2007

DRAWN BY: David Disoway
CHECKED BY:

FINALS DATE:
12 / Apr / 07

JOB NUMBER:
70413


DRAWING NUMBER

S-2

OF 3 SHEETS

| REVISIONS | |
|-----------|--|
| | |
| | |
| | |

SOFTPLAN
ARCHITECTURAL DESIGN SOFTWARE

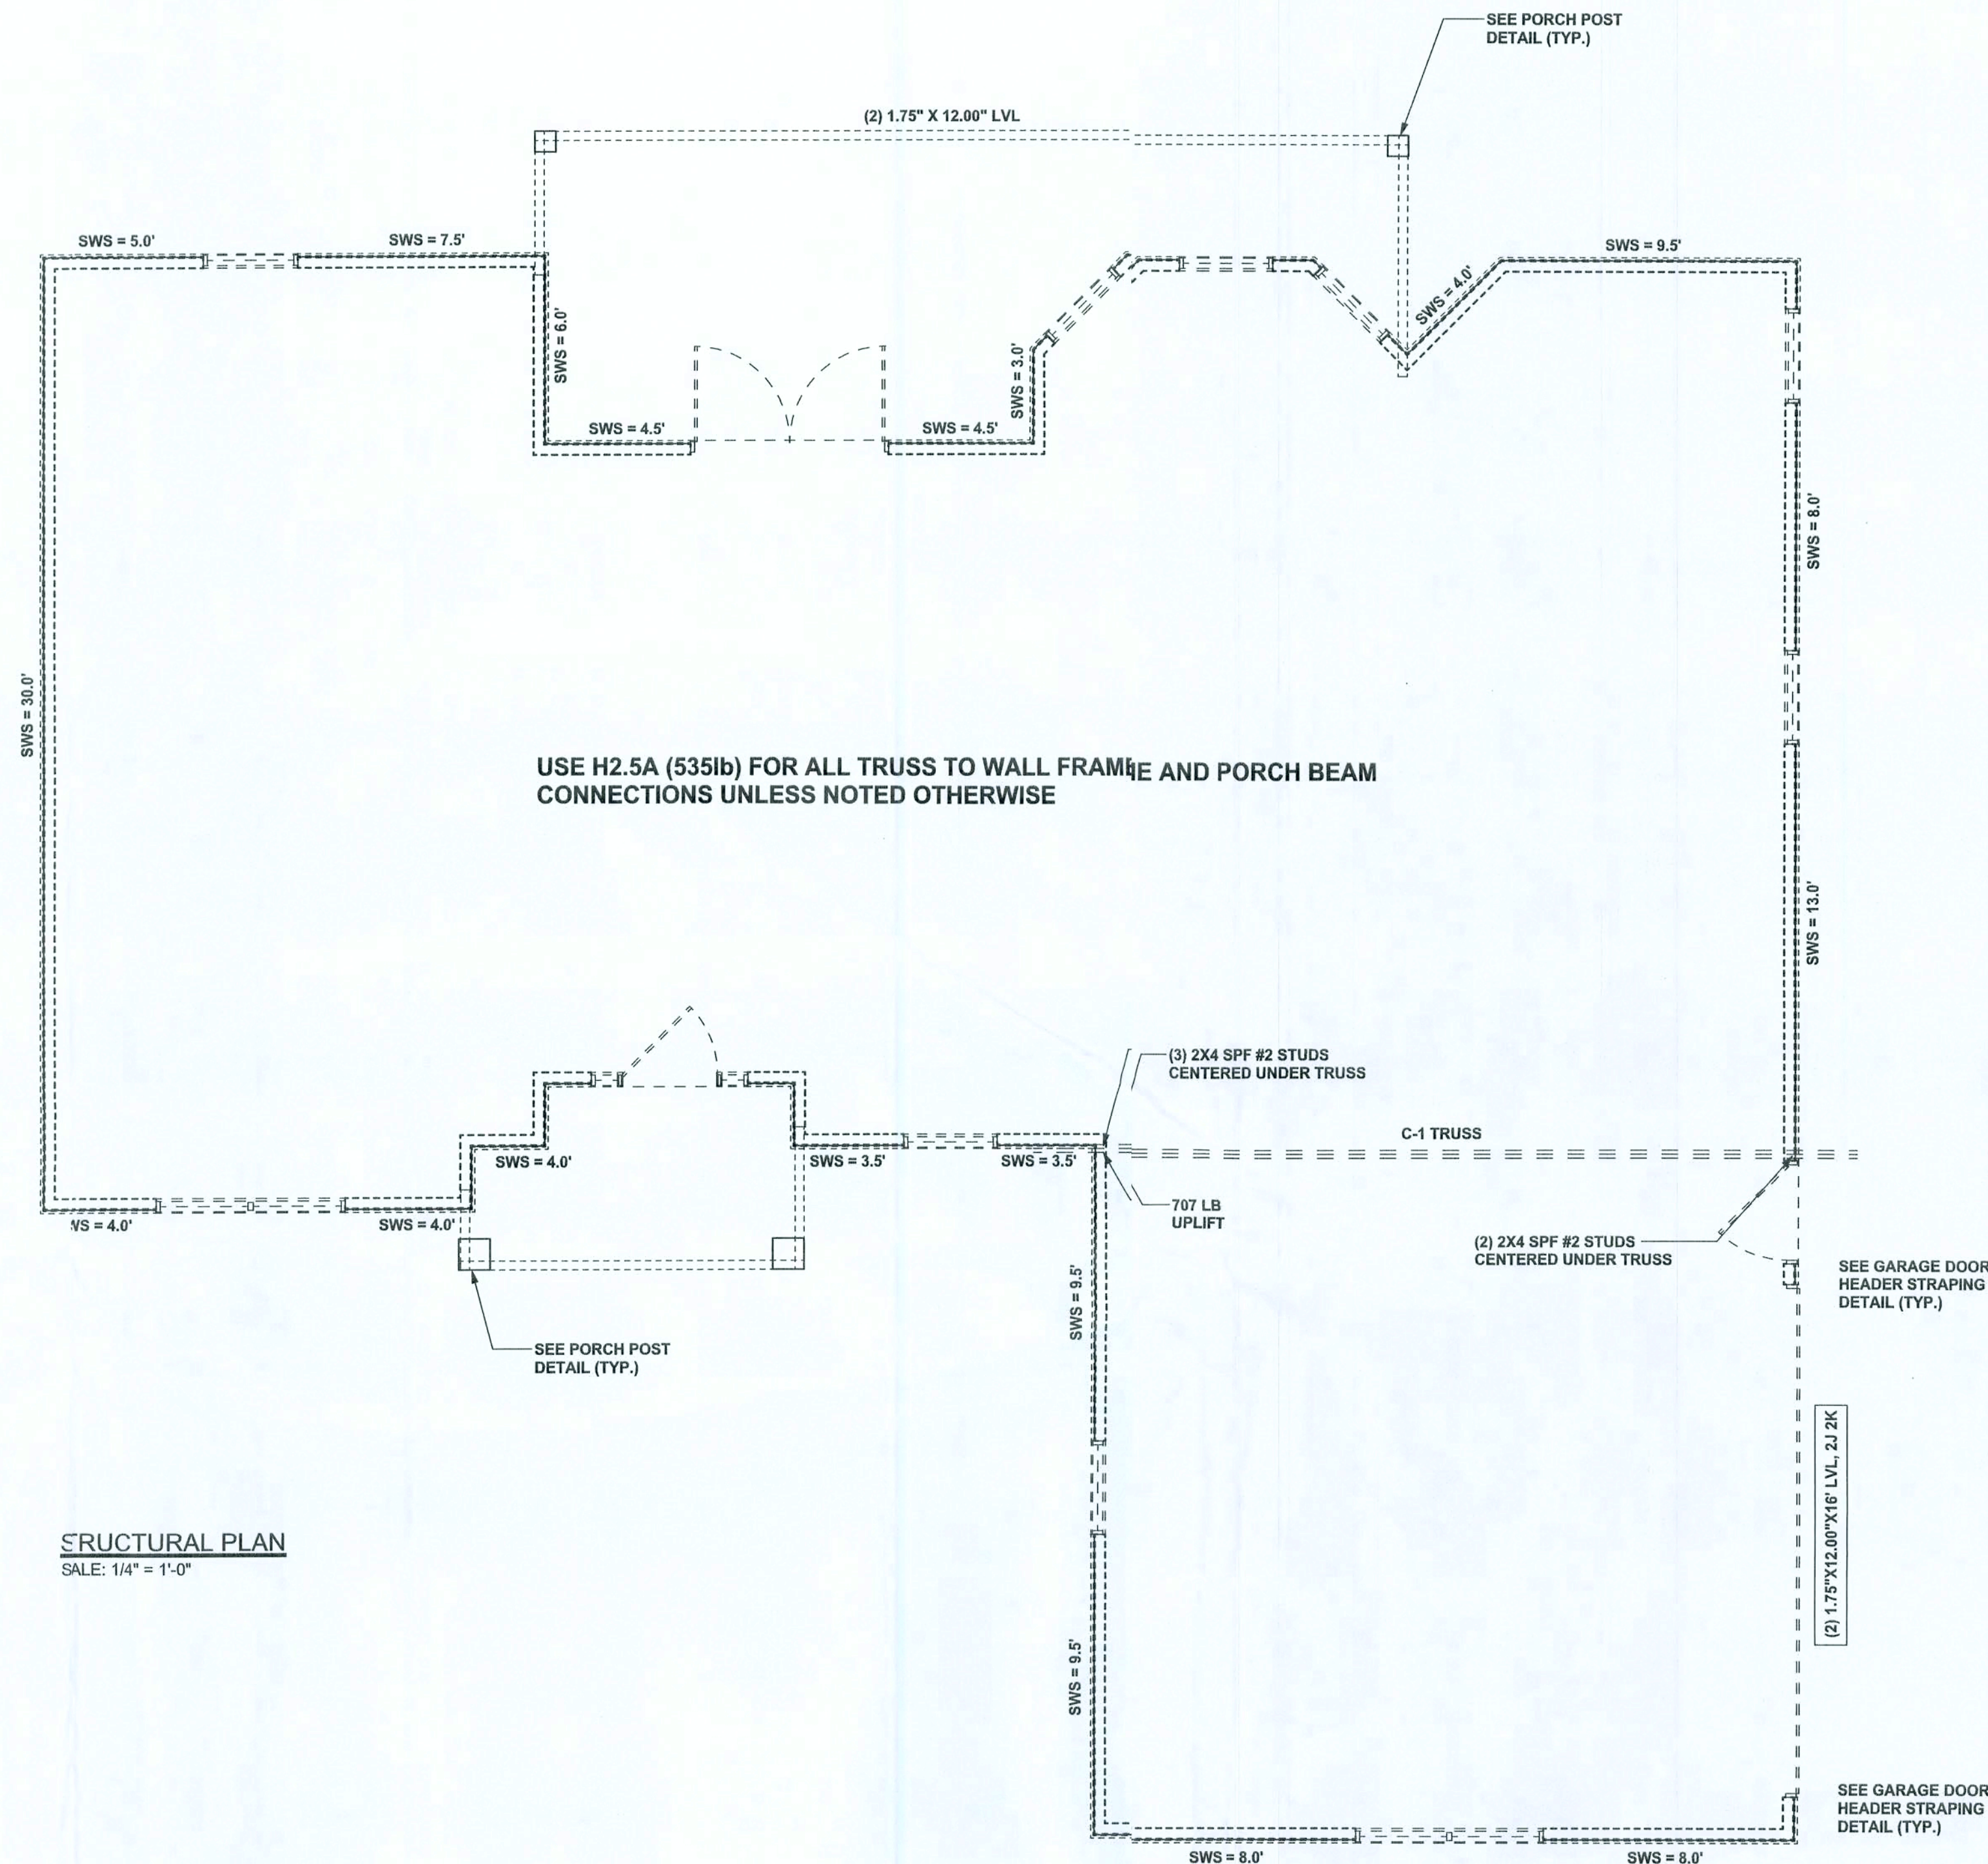

STRUCTURAL PLAN
SCALE: 1/4" = 1'-0"


STRUCTURAL PLAN NOTES

- SN1** ALL LOAD BEARING FRAME WALL & PORCH HEADERS SHALL BE A MINIMUM OF (2) 2X12 SYP #2 (U.N.O.)
- SN2** ALL LOAD BEARING FRAME WALL HEADERS SHALL HAVE (1) JACK STUD & (1) KING STUD EACH SIDE (U.N.O.)
- SN3** DIMENSIONS ON STRUCTURAL SHEETS ARE NOT EXACT. REFER TO ARCHITECTURAL FLOOR PLAN FOR ACTUAL DIMENSIONS
- SN4** PERMANENT TRUSS BRACING IS TO BE INSTALLED AT LOCATIONS AS SHOWN ON THE SEALED TRUSS DRAWINGS. LATERAL BRACING IS TO BE RESTRAINED PER BCS1-03, BCS1-B1, BCS1-B2, & BCS1-B3. BCS1-B1, BCS1-B2, & BCS1-B3 ARE FURNISHED BY THE TRUSS SUPPLIER, WITH THE SEALED TRUSS PACKAGE

WALL LEGEND

| | |
|--|---------------------------------|
| SWS = 0.0' [Symbol: Dashed line with vertical ticks] | 1ST FLOOR EXTERIOR WALL |
| SWS = 0.0' [Symbol: Solid line with vertical ticks] | 2ND FLOOR EXTERIOR WALL |
| IBW [Symbol: Dashed line with vertical ticks] | 1ST FLOOR INTERIOR BEARING WALL |
| IBW [Symbol: Solid line with vertical ticks] | 2ND FLOOR INTERIOR BEARING WALL |

HEADER LEGEND

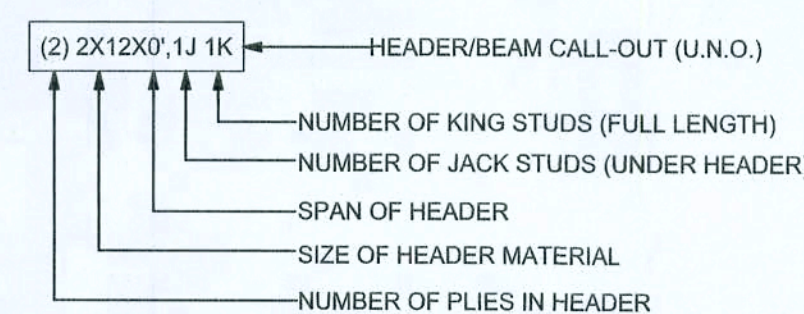

TOTAL SHEAR WALL SEGMENTS

SWS = 0.0' INDICATES SHEAR WALL SEGMENTS

| | REQUIRED | ACTUAL |
|--------------|----------|--------|
| TRANSVERSE | 32.5' | 78.0' |
| LONGITUDINAL | 28.7' | 64.0' |

CONNECTIONS, WALL, & HEADER DESIGN IS BASED ON REACTIONS & UPLIFTS FROM TRUSS ENGINEERING FURNISHED BY BUILDER, ANDERSON TRUSS
JOB #7-103

WINDLOAD ENGINEER Mark Disoway,
P.E. No. 53815, PCB 888 Lake City, FL
32056, 386-754-5419

DIMENSIONS:
Stated dimensions supercede scaled dimensions. Refer all questions to Mark Disoway, P.E. for resolution. Do not proceed without clarification.

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CERTIFICATION: I hereby certify that I have examined this plan, and that the applicable portions of the plan, relating to wind engineering comply with section F502.2.1, Florida building code residential 2004, to the best of my knowledge.

LIMITATION: This design is valid for one building, at specified location.

MARK DISOWAY
P.E. 53815

[Signature]
SEAL

Stanley Crawford
Construction

Nathan Borer
Residence

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PRINTED DATE:
April 12, 2007

DRAWN BY: David Disoway
CHECKED BY:

FINALS DATE:
12 / Apr / 07

JOB NUMBER:
704113

DRAWING NUMBER

S3

OF 3 SHEETS