CONSTRUCTION DOCUMENTS

THE CUSTOMER IS RESPONSIBLE FOR DELIVERING THE REQ'D SETS OF CONSTRUCTION DOCUMENTS TO THE PERMIT ISSUING AUTHORITIES, FOR THE ISSUANCE OF CONSTRUCTION PERMITS. THE CONTRACTOR SHALL REVIEW THE CONSTRUCTION DOCUMENTS AND VERIFY ALL DIMENSIONS, ANY DISCREPANCIES SHALL BE REPORTED TO THE ENGINEER PRIOR TO THE COMMENCEMENT OF ANY WORK OR FABRICATION OF ANY MATERIALS.

DO NOT SCALE OFF THESE PLANS

AMPLE DIMENSIONS ARE SHOWN ON THE PLANS TO LOCATE ALL ITEMS. SIMPLE ARITHMETIC MAY BE USED TO DETERMINE THE LOCATIONS OF THOSE ITEMS NOT DIMENSIONED.

CHANGES TO FINAL PLAN SETS

PLEASE DO NOT MAKE ANY STRUCTURAL CHANGES TO THESE
PLANS WITHOUT CONSULTING THE ENGINEER. THE OWNER
SHALL ASSUME ANY AND ALL LIABILITY FOR STRUCTURAL DAMAGE
RESULTING FROM CHANGES MADE TO THE PLANS OR BY SUBSTITUTION
OF MATERIALS DIFFERENT FROM SPECIFICATIONS ON THE PLANS.

MISC. NOTES

THE CONTRACTOR SHALL INDEMNIFY THE OWNER AGAINST ALL CLAIMS, WHETHER FROM PERSONAL INJURY OR PROPERTY DAMAGE, ARISING FROM EVENTS ASSOCIATED WITH THE WORK PERFORMED UNDER THE CONTRACT FOR THIS PROJECT.

THE CONTRACTOR AND/OR SUB-CONTRACTORS SHALL WAR-RANTY ALL WORK FOR A PERIOD OF ONE YEAR FOLLOWING THE DATE OF FINAL COMPLETION AND ACCEPTANCE BY THE OWNER. DEFECTS IN MATERIALS, EQUIPMENT, COMPONENTS AND WORK-MANSHIP SHALL BE CORRECTED AT NO FURTHER COST TO THE OWNER DURING THE ONE YEAR WARRANTY PERIOD.

NOT

ALL RECEPTACLES SHALL BE 60" A.F.F. EXCEPT IN KITCHEN AND OFFICE

SMOKE DETECTORS SHALL BE LOCATED EVERY 30' IN HALL WAYS AND IN KITCHEN.

HEAT SENSORS SHALL BE LOCATED IN KITCHEN AND IN A/C CLOSETS.

A TYPE 20ABC FIRE EXTINGUISHER SHALL BE LOCATED WITHIN

15 FEET OF RANGE IN KITCHEN.

Stroke - 81

FIRE BELLS SHALL BE LOCATED ON OPPOSITE ENDS OF ALL ROOMS AND SHALL BE ACCESSIBLE.

DETECTION:

A SMOKE DETECTION SYSTEM SHALL BE INSTALLED IN ACCORDANCE WITH NFPA 72, WITH

PLACEMENT OF DETECTORS IN EACH STORY IN FRONT OF DOORS TO THE STAIRWAYS AND IN FRONT

OCCUPANCY. DETECTORS SHALL ALSO
BE INSTALLED IN LOUNGES, RECREATION AREAS AND SLEEPING
ROOMS IN THE DAY-CARE
OCCUPANCY.

OF CORRIDORS OF ALL FLOORS OCCUPIED BY THE DAY-CARE

NOTE:

ROOMS OCCUPIED BY CHILDREN MUST HAVE AND MAINTAIN LIGHTING THE EQUIVALENT OF 20 FOOT CANDLES AT THREE FEET FROM THE FLOOR TO ALLOW FOR SUPERVISION, AND FOR SAFE METHODS OF ENTERING AND EXITING EACH ROOM.

IN READING, PAINTING, AND OTHER CLOSE WORK AREAS, LIGHTING MUST BE EQUIVALENT TO 50 FOOT CANDLES ON THE WORK SURFACE.

OCCUPANT NOTIFICATION:

AUDIBLE AND VISIBLE ALARMS SHALL BE PROVIDED TO ALERT OCCUPANTS OF A FIRE OR OTHER EMERGENCY.

INITIATION:

INITIATION OF THE REQUIRED FIRE ALARM SYSTEM SHALL BE BY MANUAL MEANS AND BY OPERATION OF ANY REQUIRED SMOKE DETECTORS.

FIRE DEPARTMENT NOTIFICATION:

THE FIRE ALARM SYSTEM SHALL BE ARRANGED TO TRANSMIT THE ALARM AUTOMATICALLY TO THE FIRE DEPARTMENT IN ACCORDANCE WITH NFPA 72 BY MEANS OF ONE OF THE FOLLOWING METHODS AS APPROVED BY THE BUILDING OFFICIAL:

- an auxiliary alarm system, or
 a central station connection of
- a central station connection, or
 a proprietary system, or
- a proprietary system, or
 a remote station connection.

Exception:

DATE BY

WHERE NONE OF THE ABOVE MEANS OF NOTIFICATION IS AVAILABLE, A PLAN FOR NOTIFICATION OF THE FIRE DEPARTMENT, ACCEPTABLE TO THE BUILDING OFFICIAL, SHALL BE PROVIDED.

MEANS OF EGRESS FBC CHAPTER 10		
OCCUPANCY CLASSIFICATION	UNSPRINKLERED &	UNPROTECTED
GROUP E	REQUIRED	PROVIDED
MAX. TRAVEL DIST. (FBC 1016)	200 FT	MAX. 88'-8"
MAX. DEAD-END CORRIDOR (FBC 1018.4)	N/A	N/A
TOTAL # OF EXITS (TABLE 1021.1)	2	5
ÈGRESS WIDTH PER PERSON (FBC 1005)	0.2 326 x 0.2 = 65.2"	206"
MIN. CLEAR OPENING OF EXIT DOORS (FBC 1008.1.1)	32"	34"

AT THE OWNER'S OPTION, A WAFANTY INSPECTION SHALL BE PERFORMED DURING THE ELEVITH MONTH FOLLOWING THE COMMENCEMENT OF THE WARRITY PERIOD, FOR THE PUREPOSE OF DETERMINING ANY WARANTY WORK THAT MAY BE REQUIRED. THE CONTRACTOR SALL BE PRESENT DURING THIS INSPECTION IF REQUESTED BY TO WORK.

THE OWNER SHALL PAY FOR ALLERMITS, LICENSES,
TESTS AND THE LIKE THAT MAY I REQUIRED BY THE VARIOUS AUTHORITIES HAVING JURDICTION OVER THIS PROJECT
BE THEY CITY, COUNTY, STATE OFEDERAL.

THE OWNER SHALL FILE A "NOTIC OF COMMENCEMENT" PRIOR TO THE BEGINNING THE THE PRICECT AND THE CONTRACTOR(S) SHALL FILE "NOTICE TO OWNER ND PROVIDE "RELEASE OF LIEN" FOR ALL PAYMENT REQUES PRIOR TO DISBURSEMENT OF ANY FUNDS.

ANY AND ALL DISPUTES ARISING ROM EVENTS ASSOCIATED WITH THE CONSTRUCTION OF THE PROJECT BETWEEN THE OWNER, CONTRACTOR(S) AND S'PLIERS SHALL BE RESOLVED THROUGH ARBITRATION.

ALL WORK SHALL BE IN ACCORDICE W/ APPLICABLE CODES AND LOCAL REGULATIONS, INCLUING APPLICABLE ENERGY CODES. ALL COMPONENTS OF THE BUILDING SHALL MEET WITH THE MINIMUM ENERGY REQUIREENTS OF THE BUILDING CODE. ANY DISCREPANCIES SHALL BE FORTED TO THE ENGINEER IN WRITING PRIOR TO THE COMMICEMENT OF THE WORK.

ALL INSULATION SHALL BE LEFT IPOSED AND ALL LABLES LEFT INTACT ON THE WINDOWS /D DOORS UNTIL INSPECTED BY THE BUILDING OFFICIAL.

NOTE:

THE HVAC CONTRACTOR SHALPROVIDE RELAY SWITCHES FROM EACH SMOKE DAMPER TO CONECT TO THE ALARM SYSTEM.

MOUNTING HEIGHT:

key pad - 48" smoke detector - ceiling horn strobe - 81" pull station - 48" strobe - 81"

LIFE SAFETY NOTES

ALL EXIT AND EMERGENCY BHTING SHALL BE INSTALLED PER NEC 700-12,014 EDITION.


ACCESS TO EXITS SHALL BEIARKED BY APPROVED READILY VISIBLE SIGNS IN A CASES WHERE THE EXIT OR WAY TO REACH THE EXIT IS NOT REALLY APPARENT TO THE OCCUPANTS. SIGN PLACEMENT SHALL BEUCH THAT NO POINT IN THE EXIT ACCESS CORRIDOR IS MORTHAN 100 FT FROM THE NEAREST EXTERNALLY ILLUMINATED SIN AND IS NOT IN EXCESS OF THE MARKED RATING FOR INTERALLY ILLUMINATED SIGNS.

ALL FIRE EXTINGUISHERS SALL BE TYPE 2A-20BC AND SHALL BE LOCATED SO THAT NO PAT IN THE DIRECTION OF TRAVEL FROM ANY POINT IS MORE TAN 75 FT TO THE FIRE EXTINGUISHER.



PROJECT LOCATION

SOUTHRIDGE DAY SCHOOL

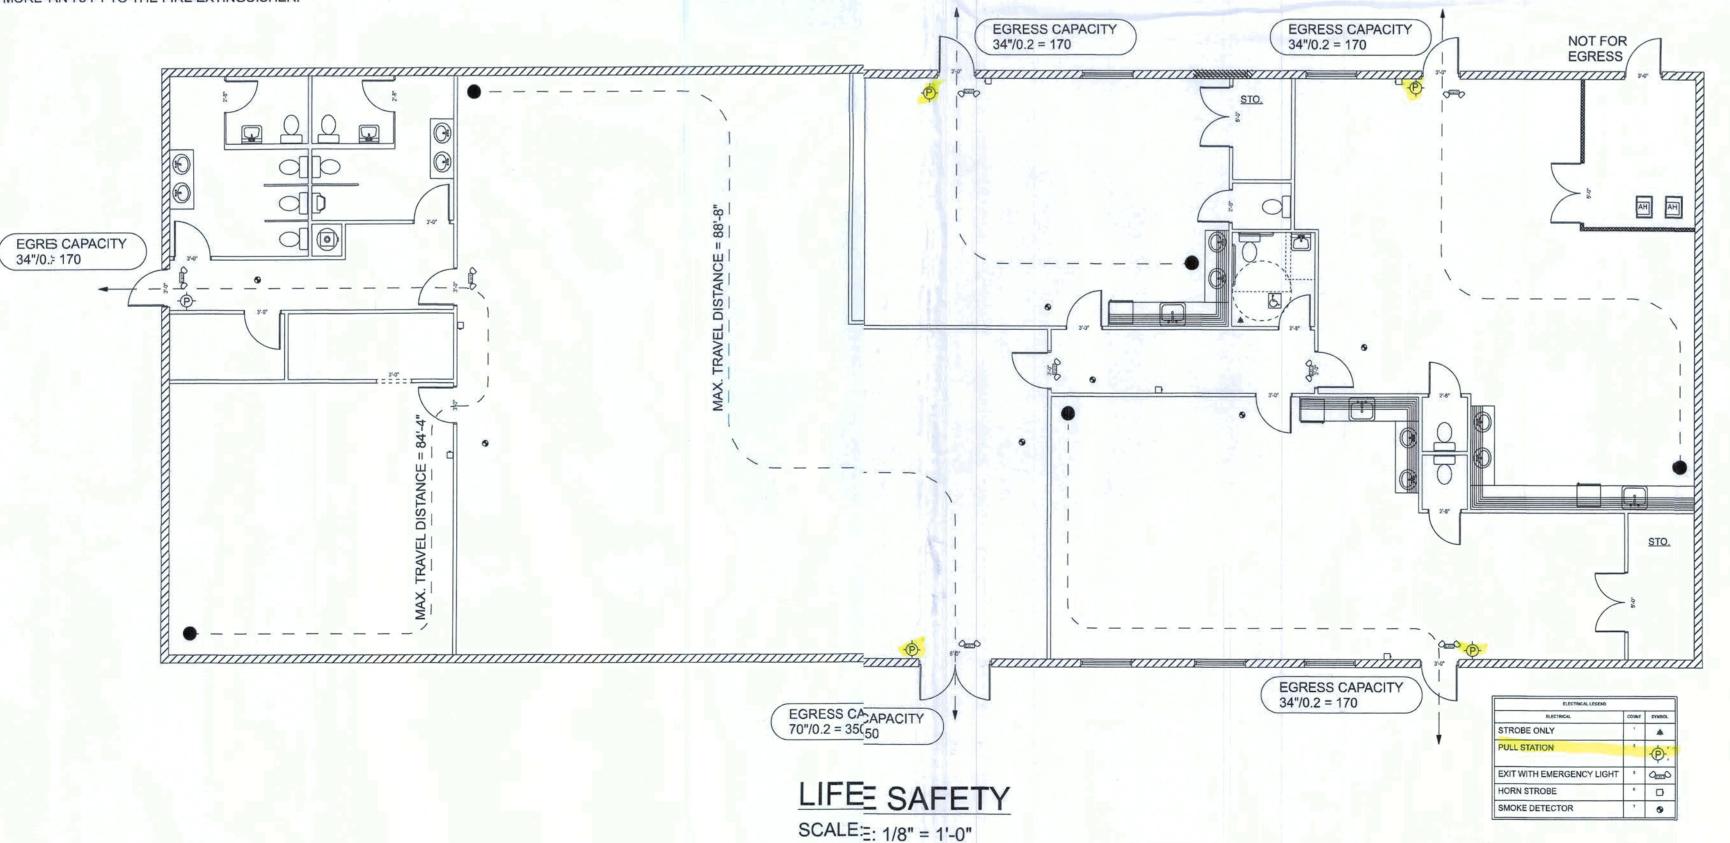

ABBREVIATIONS

.B.	Anchor Bolt	Flr.	Floor	Plt. Ht.	Plate Height
bv.	Above	Fdn.	Foundation	Plt Sh.	Plant Shelf
/C	Air-Conditioner	Flr. Sys.	Floor System	PSF	Pounds per square foot
dj.	Adjustable	F.Pl.	Fireplace	P.T.	Pressure Treated
.F.F.	Above Finished Floor	Ft.	Foot / Feet	Pwd.	Powder Room
	Air Handler Unit	Ftg.	Footing	Rad.	Radius
LT.	Alternate	FX	Fixed	Ref.	Refrigerator
.C.	Base Cabinet	Galv.	Galvanized	Reg'd.	Required
.F.	Bifold Door	G.C.	General Contractor	Rm.	Room
	Book Shelf	G.F.I.	Ground Fault Interrupter	Rnd.	Round
m.	Beam	G.T.	Girder Truss	R/SH	Rod and Shelf
OT.	Bottom	Hdr.	Header	SD.	Smoke Detector
P.	Bypass door	Hgt.	Height	S.F.	Square Ft.
rg.	Bearing	HB	Hose Bibb	Sh.	Shelves
ir.	Circle	Int.	Interior	SHT	Sheet
lg.	Ceiling	K/Wall	Kneewall	S.L.	Side Lights
ol.	Column	K.S.	Knee Space	S.P.F.	Spruce Pine Fir
	A/C Compressor	Laun.	Laundry	Sq.	Square
Т.	Ceramic Tile	Lav.	Lavatory	S.Y.P.	Southern Yellow Pine
2 (2.5)	Dryer	L.F.	Linear Ft.	Temp.	Tempered
ec.	Decorative	L.T.	Laundry Tub	Thik'n.	Thicken
ed.	Dedicated Outlet	Mas.	Masonry	T.O.B.	Top of Block
bl.	Double	Max	Maximum	T.O.M.	Top of Masonry
ia.	Diameter	M.C.	Medicine Cabinet	T.O.P.	Top of Plate
isp.	Disposal	MDP	Master Distribution Panel	Trans.	Transom Window
ist.	Distance	Mfgr.	Manufacturer	Тур.	Typical
.S.	Drawer Stack	Micro.	Microwave	UCL.	Under Cabinet Lighting
.V.	Dryer Vent	Min	Minimum	U.N.O.	Unless Noted Otherwise
.W.	Dishwasher	M.L.	Microlam	VB	Vanity Base
a.	Each	Mir.	Mirror	Vert.	Vertical
.W.	Each Way	Mono	Monolithic	V.L.	Versalam
lec.	Electrical	N.T.S.	Not to Scale	VTR	Vent through Roof
lev.	Elevation	Opn'g.	Opening	W	Washer
xt.	Exterior	Opt.	Optional	W/	With
xp.	Expansion	Pc.	Piece	W/C	Water Closet
B.C.	Florida Bldg. Code	Ped.	Pedestal	W.A.	Wedge Anchor
in. Flr.		P.L.	Parallam	Wd	Wood
G.	Fixed Glass	PLF	Pounds per linear foot	WP	Water Proof

BUILDING GROUP OCCUPANCY	GROUP E	
TABLE 503 TYPE OF CONSTRUCTION	TYPE V	
TABLE 503 AREA/HEIGHT LIMITATIONS	9,500 SF/1 STORY	
OCCUPANT LOAD:		
KITCHEN STAFF OCCUPANCY	4	
DAYCARE OCCUPANCY 35 SF/CHILD PLUS STAFF	69	
ASSEMBLY OCCUPANCY CAFETERIA 15 SF/CHILD	143	

* PER CODE TRAVEL PATHS, BATHROOMS, AND STORAGE AREAS HAVE BEEN EXCLUDED FROM OCCUPANT LOAD AREA CALCULATIONS



INDEX OF SHEETS

SHEET DESCRIPTION

LS-1 COVER SHEET AND LIFE SAFETY
A-1 EXISTING PLAN
A-2 PROPOSED FLOOR PLAN
FRAMING DETAILS

*ELECTRICAL, PLUMBING, AND MECHANICAL CONTRACTORS SHALL PROVIDE APPLICABLE PROJECT SPECIFICATIONS FOR RENOVATIONS TO EXISTING SYSTEMS AS REQUIRED BY THE BUILDING OFFICIAL

REVISIONS

DESCRIPTION

DEIGN BY:

CERTIFIED GENERAL CONTRACTOR
CGC1514780

STE. 101

163 SW MIDTOWN PL.


LAKE CITY, FL. 32025

TRADEMARK Construction Group, Inc.



CERTIFICATE OF AUTHORIZATION NO. 28022

> P.O. BOX 970 LAKE CITY, FL 32056 PHONE: 386.754.4085

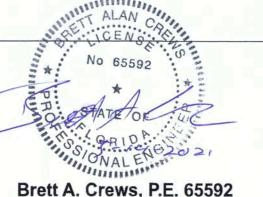

DRAWN BY:

TM

APPROVED BY:

BC


SOUTHRIDGE DAY SCHOOL REMODEL

COVER SHEET AND LIFE SAFETY PLAN

LS-1

C21.001

PROJECT NO .:

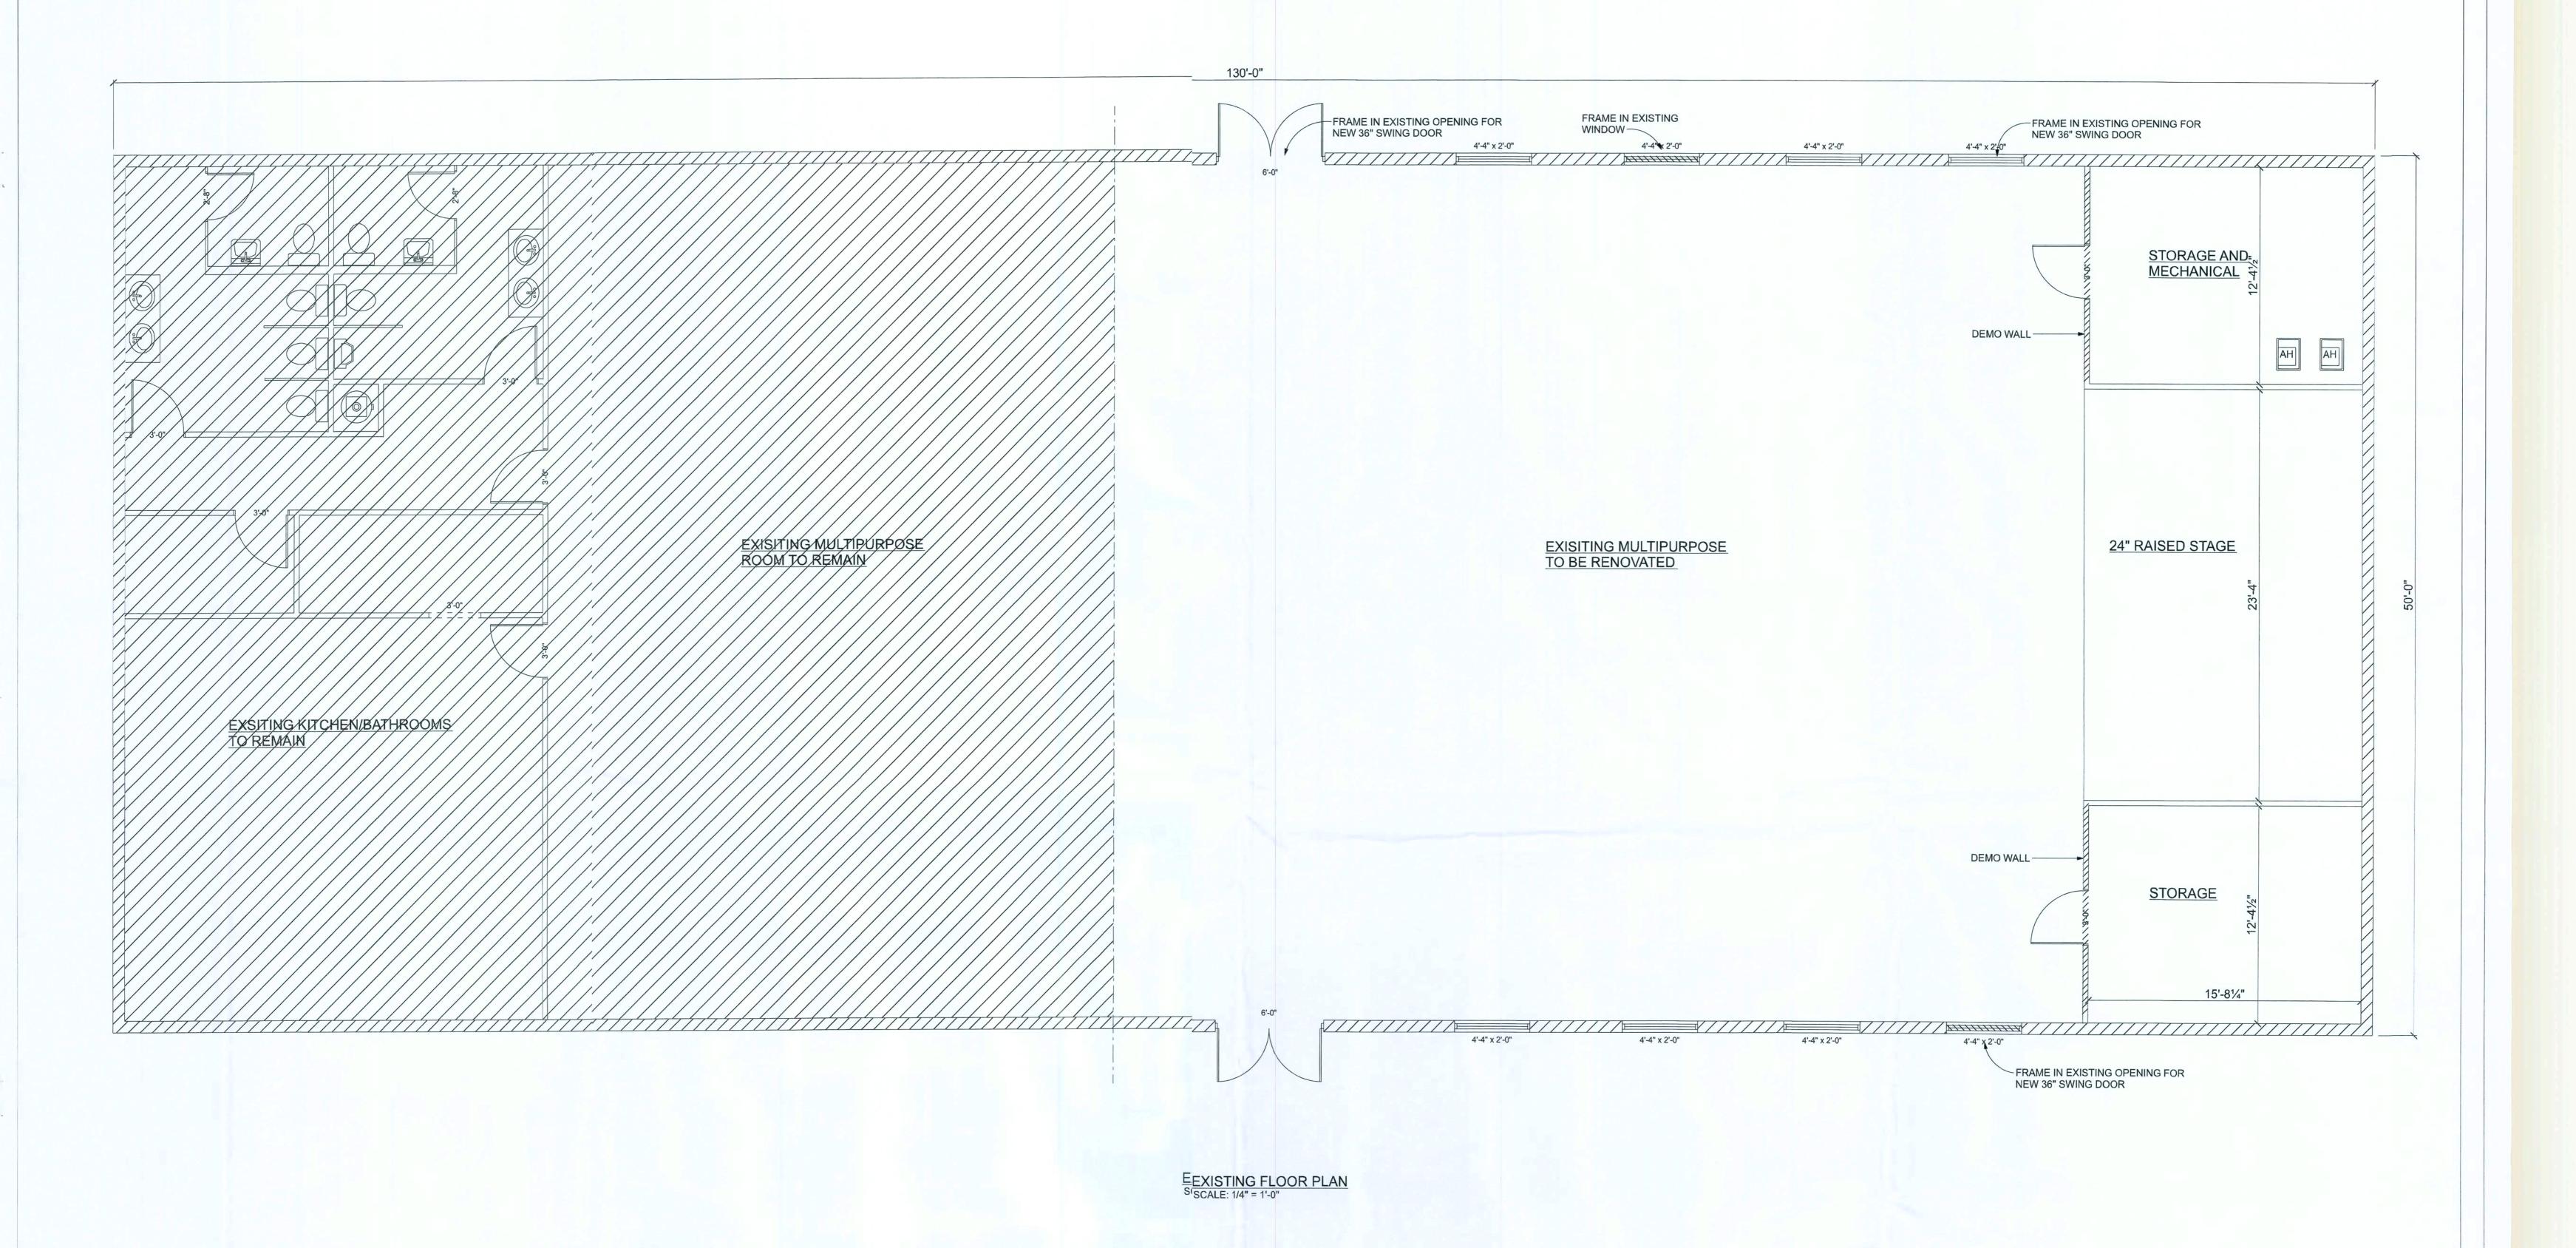

DATE BY REVISIONS
DESCRIPTION

DE:GN BY:

CERTIFIED GENERAL CONTRACTOR CGC1514780

TRADEMARK

163 SW MIDTOWN PL.
STE. 101

LAKE CITY, FL. 32025
(386)755-5254



CERTIFICATE OF AUTHORIZATION NO. 28022

P.O. BOX 970 LAKE CITY, FL 32056 PHONE: 386.754.4085

ALAN CALL
No 65592
STATE OF
ORIDICAL CONTROLL
Brett A. Crews, P.E. 65592


DRAWN BY:	
TM	
APPROVED BY:	

BC

SOUTHRIDGE DAY SCHOOL REMODEL PROJEC*NO.:
C21.001

EXISTING FLOOR PLAN

SHEET:
A-1

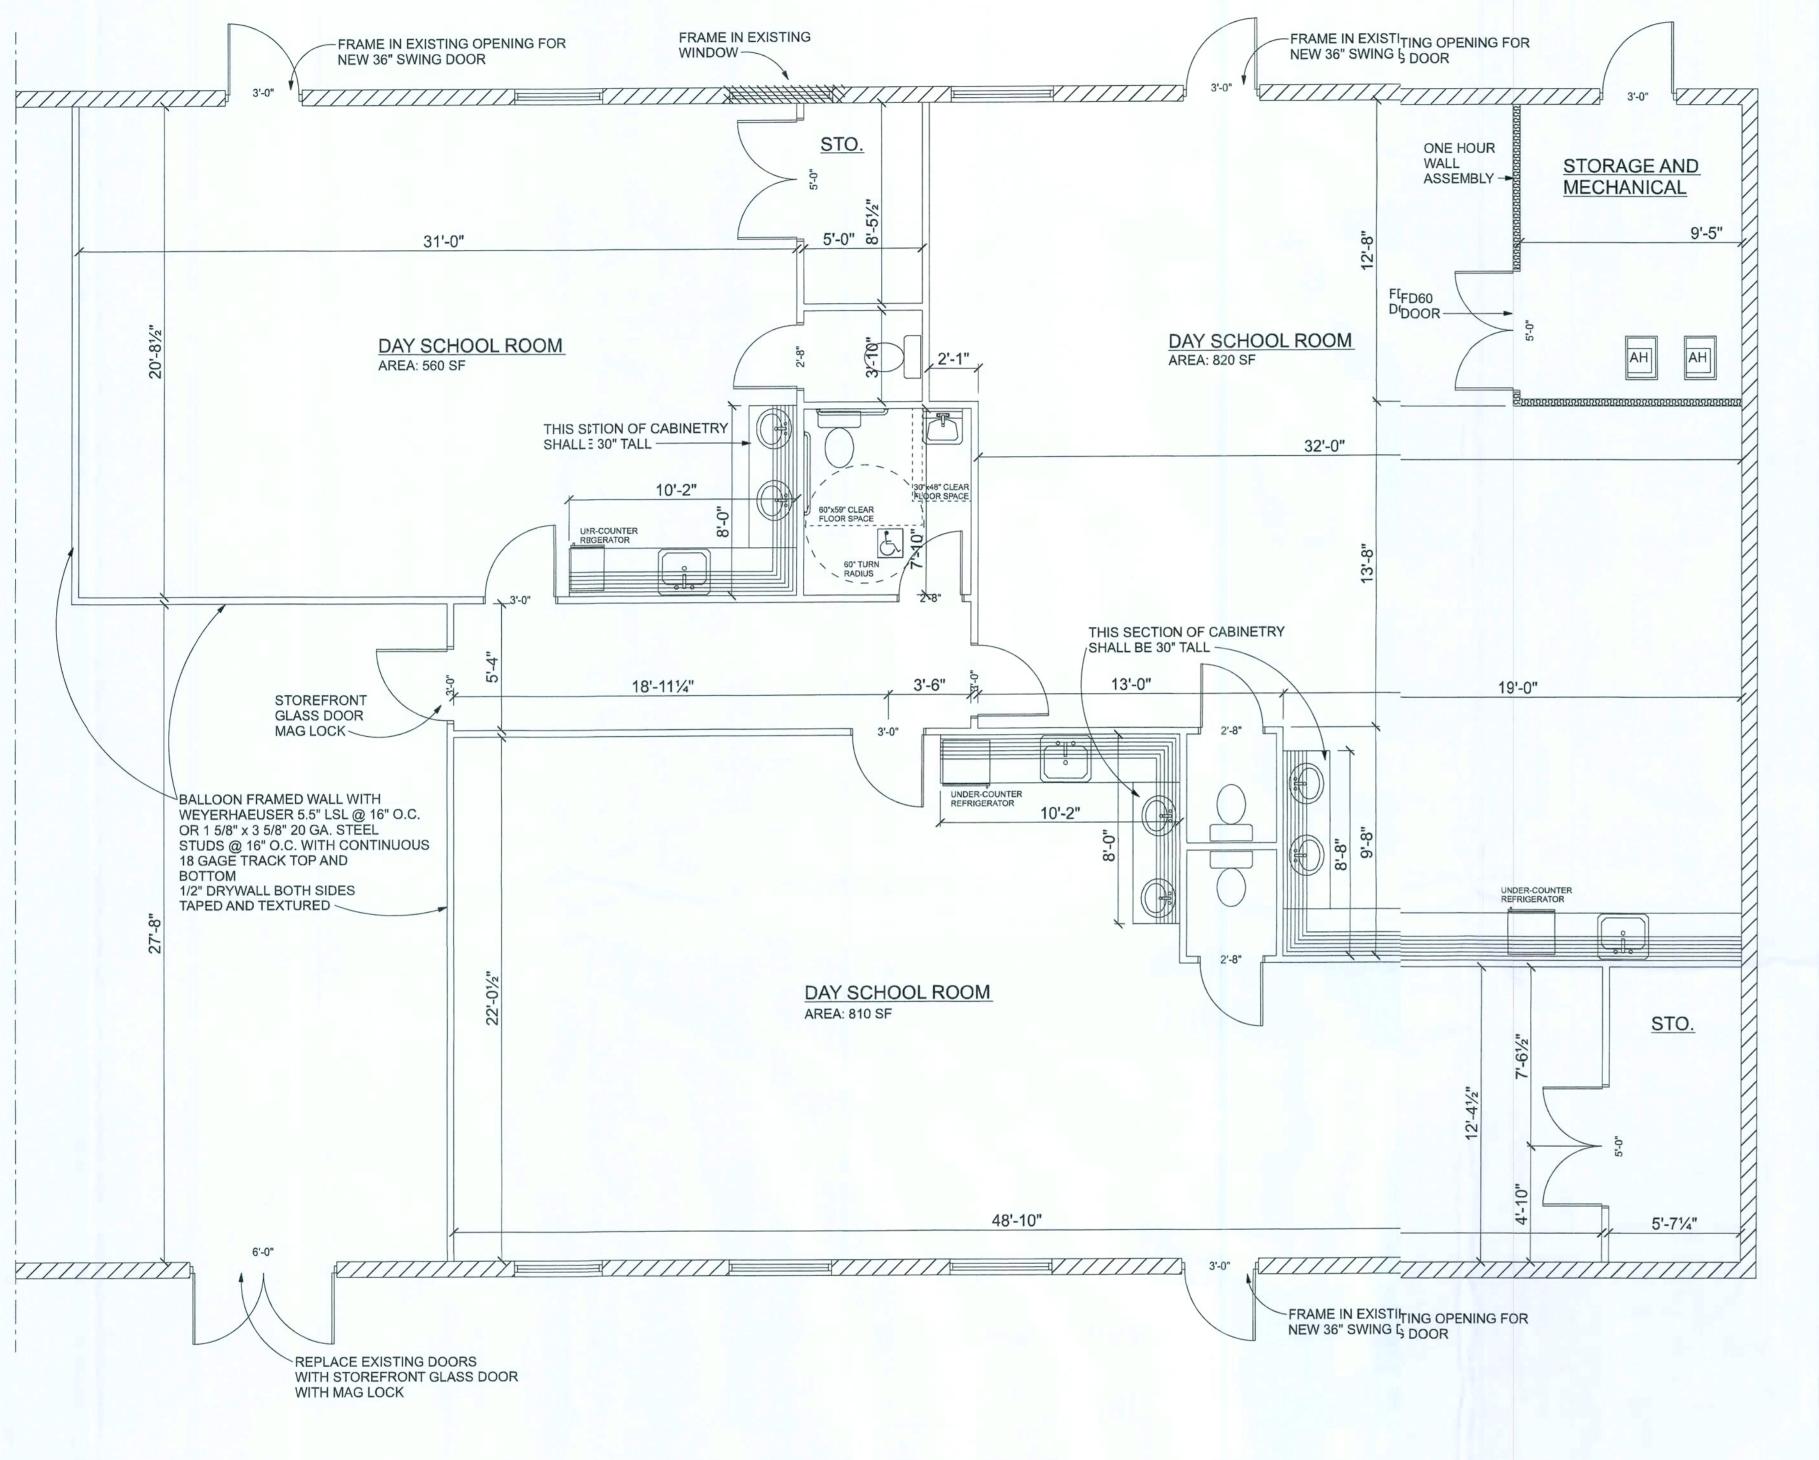

PROPOSED FLOOR PLAN

CERTIFIED GENERAL CONTRACTOR

CGC1514780

STE. 101

163 SW MIDTOWN PL.


LAKE CITY, FL. 32025 (386)755-5254

SCALE: 1/4" = 1'-0"


FIREBLOCKING NOTES:

FIREBLOCKING SHALL BE INSTALLED IN WOOD FRAME CONSTRUCTION IN THE FOLLOWING LOCATIONS:

- 1. IN CONCEALED SPACES OF STUD WALLS AND PARTITIONS INCLUDING FURRED SPACES AT CEILING AND FLOOR LEVELS.
- 2. AT ALL INTERCONNECTIONS BETWEEN CONCEALED VERTICAL AND HORIZONTAL SPACES SUCH AS OCCUR AT SOFFITS, DROP CEILINGS, COVE CEILINGS, ETC.
- 3. IN CONCEALED SPACES BETWEEN STAIR STRINGERS AT THE TOP AND BOTTOM OF
- 4. AT OPENINGS AROUND VENTS, PIPES, DUCTS, CHIMNEYS AND FIREPLACES AT CEILING AND FLOOR LEVELS WITH PYROPANEL MULTIFLEX SEALANT
- 5. AT ALL INTERCONNECTIONS BETWEEN CONCEALED VERTICAL STUD WALL OR PARTITION SPACES AND CONCEALED SPACES CREATED BY AN ASSEMBLY OF FLOOR JOISTS, FIREBLOCKING SHALL BE PROVIDED FOR THE FULL DEPTH OF THE JOISTS AT THE ENDS AND OVER THE SUPPORTS.

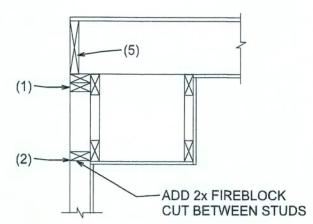

SOFFIT/DROPPED CLG.

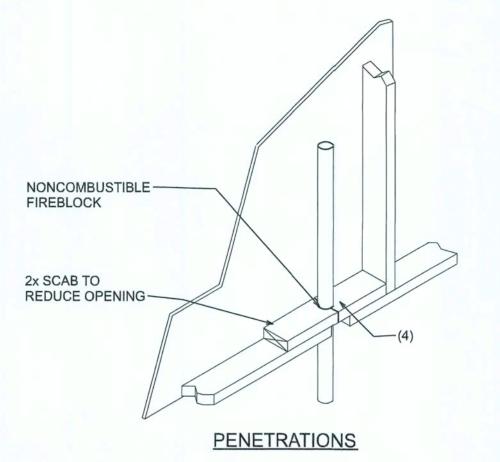


CONTRACTOR SHALL BRACE TOP PLATES OF PARTITION WALLS -R-30 BATTS — SUSPENDED ACOUSTICAL — DOUBLE TOP PLATE CEILING TILE (OWNER TO SPECIFY) 2x4 STUDS 16" O.C. 1/2" DRYWALL TAPED AND SANDED-4" CONC. SLAB ---FINISHED FLOOR

INTERIOR PARTITION WALL

DESIGN NO. U305 ANSI/UL 263

BEARING WALL RATING - 1 HOUR (SEE ITEM 2) NONBEARING WALL RATING - 1 HOUR (SEE ITEM 2)

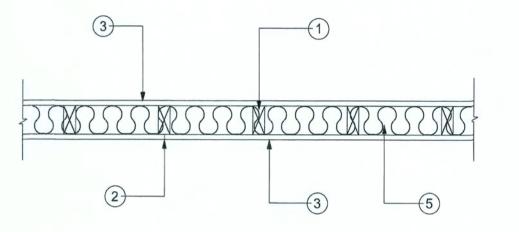

CORRIDOR NOTE: FOR CEILING PROTECTION CONTRACTOR CAN PROVIDE USG SHAFT AND STAIR WALL SYSTEM OF AER-09038 OR EQUIVALENT.

- 1. Wood Studs Nom 2 by 4 in. spaced 16 in. OC max, effectively firestopped.
- 2. Joints and Nail-Heads Joints covered with joint compound and paper tape. Joint compound and paper tape may be omitted when square edge boards are used. As an alternate, nom 3/32 in. thick gypsum veneer plaster may be applied to the entire surface of Classified veneer baseboard with the joints reinforced with paper tape. Nailheads exposed or covered with joint
- 3. Gypsum Board* 5/8 in. thick paper or vinyl surfaced, with beveled, square, or tapered edges, applied either horizontally or vertically. Gypsum panels naed 7 in. OC with 6d cement coated nails 1-7/8 in. long, 0.0915 in. shank diam aid 15/64 in. diam heads. When used in widths other than 48 in., gypsum panels are to be installed horizontally. For an alternate method of attachment of gypsum panels, refer to Items 6, 6A or 6B, Steel Framing Members*.
- 4. Steel Corner Fasteners (Optional) For use at wall corners. Channel shaped, 2 in. long by 1 in. high on the back side with two 1/8 in. wide cleats protruding into the 5/8 in. wide channel, fabricated from 24 gauge galv steel. Fasteners applied only to the end or cut edge (not along tapered edges) of the gypsum board, no greater than 2 in. from corner of gypsum board, max spacing 16 in. OC. Nailed to adjacent stud through tab using one No. 6d cement coated nail per fastener. Corners of wall board shall be nailed to top and bottom plate using No. 6d cement coated nails.
- 5. Batts and Blankets* (Optional Required when Item 6A is used (RC-1) — Glass fiber or mineral wool insulation. Placed to completely or partially fill the stud cavities. When Item 6A is used, glass fiber or mineral wool insulation shall be friction-fitted to completely fill the stud cavities.
- 6. Steel Framing Members* (Optional, Not Shown) Furring channels and Steel Framing Members as described below: a. Furring Channels — Formed of No. 25 MSG galv steel. 2-9/16 in. or 2-23/2 in. wide by 7/8 in. deep, spaced 24 in. OC perpendicular to studs. Channels secured to stude as described in Item b. Ends of adjoining channels are overlapped 6 in. and tied together with double strand of No. 18 SWG galv steel wire near each end of overlap. As an alternate, ends of adjoining channels may be overlapped 6 in. and secured together with two self-tapping #6 framing screws, min. 7/16 in. long at the midpoint of the overlap, with one screw on each flange of the channel. Gypsum board attached to furring channels as described in Item 3.
- b. Steel Framing Members* Used to attach furring channels (Item 6a) to studs. Clips spaced 48 in. OC. RSIC-1 and RSIC-1 (2.75) clips secured to studs with No. 8 x 2-1/2 in. coarse drywall screw through the center gromme. RSIC-V and RSIC-V (2.75) clips secured to studs with No. 8 x 1-1/2 in. coarse drywall screw through the center hole. Furring channels are friction fitted into clips. RSIC-1 and RSIC-V clips for use with 2-9/16 in. wide furring channels. RSIC-1 (2.75) and RSIC-V (2.75) clips for use with 2-23/32 in. wide furring

PAC INTERNATIONAL L L C — Types RSIC-1, RSIC-V, RSIC-1 (2.75), RSIC-V (2.75)

REVISIONS DESCRIPTION DATE BY

TR ADEMARK **Construction Group, Inc.**

DE:GN BY:



AREA SUMMARY

TOTAL 3,130 SF

INTERIOR BUILD-OUT 3,130 SF

CERTIFICATE OF AUTHORIZATION NO. 28022

> P.O. BOX 970 LAKE CITY, FL 32056 PHONE: 386.754.4085



DRAWN BY:

SCALE: NTS

APPROVED BY:


SOUTHRIDGE DAY SCHOOL REMODEL

PROJEC' NO .: C21.001

SHEET:

PROPOSED FLOOR PLAN

A-2

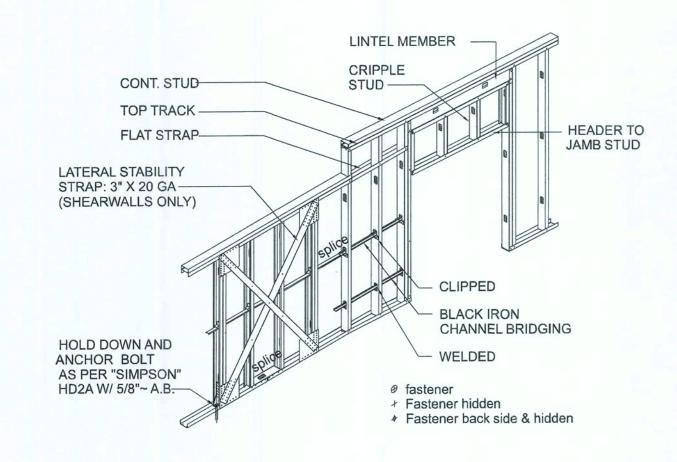

STRUCTURAL WALL ASSEMBLY


LIGHT GAGE STEEL CONNECTION NOTES:


type	location
#8 self drilling x 1/2"	stud to track with gypsum
low profile	board and sheathing
#10, 3/4" hex-washer head	all other areas up to three
self drilling screws	layers of 33-mil material
#8 self piercing screws	sheathing to steel
	20 gage or less
#8 self drilling screws	sheathing to steel
	18 gage or more
#6 self piercing screws	gypsum board to steel
	20 gage or less
	gypsum board to steel
#6 self drilling screws	18 gage or more


STEEL STUD BRACING NOTES:

walls installed in accordance with table above.


- The flanges of load bearing steel studs shall be laterally braced in accordance with
- on of the following methods. 1. Gypsum wall board or structural sheathing on both sides of load bearing
- 2. Horizontal steel strapping installed on both sides at mid-height for 8 foot walls, and third lenghts for 9 foot and 10 foot walls. Horizontal steel straps shall be at least 1 1/2" wide and 33 mills in thickness. Straps shall be attached to the flanges of studs with at least one No. 8 screw. In-line blocking shall be installed between studs at the termination of staps and at 12-foot intervals along the strap: straps shall be fastened to the blocking with at least two No.8 screws.
- 3. Gypsum wall board or structural sheathing on one side and horizontal stee strapping on the other side of load bearing walls.

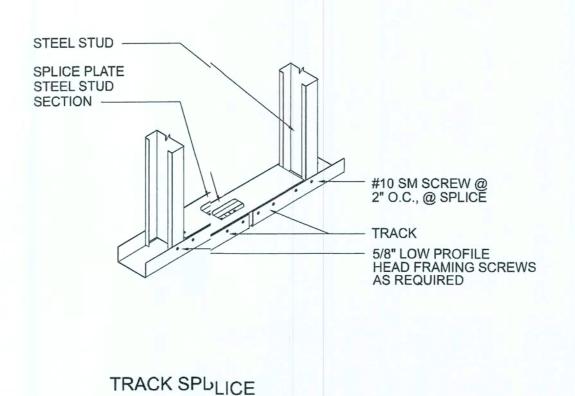


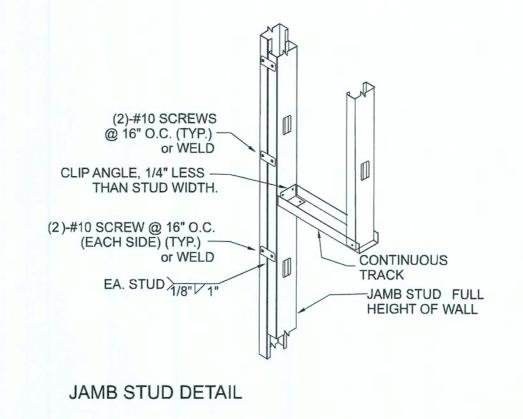


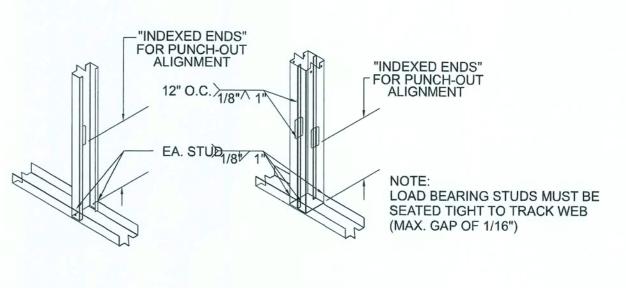


TYPICAL STUD TO TRACK CONNECTIONS

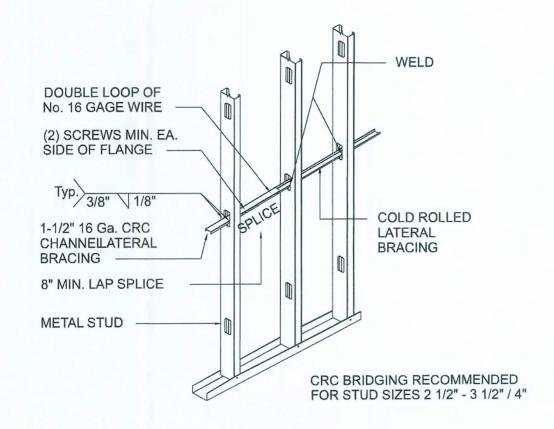


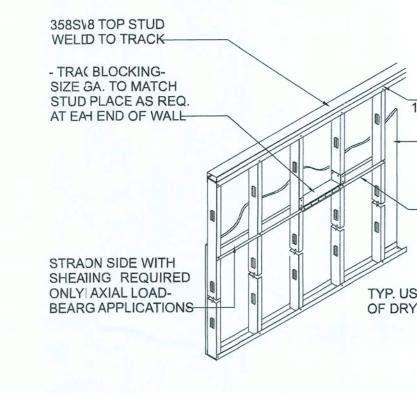

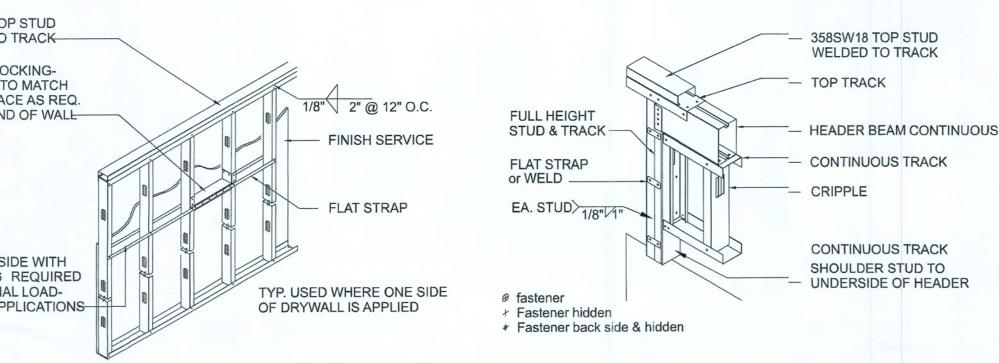

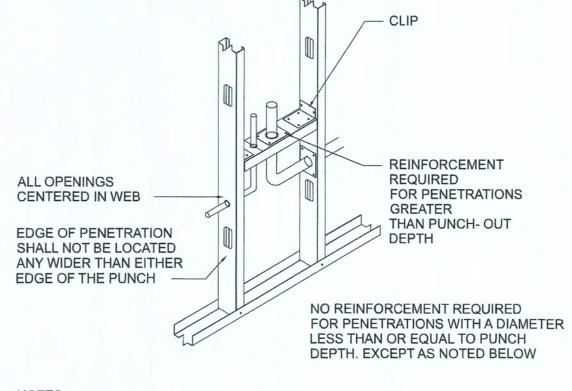

1. FLANGES SHALL NOT BE NOTCHED OR CUT. 2. CAPACITY VERIFICATION BY DESIGN IS REQR ANY OPENINGS LOCATED AT CONCENTRATEDDADS AND BEARING ENDS. 3. APPLICABLE TO TRACK, STUDS, JOISTS & RAFTERS

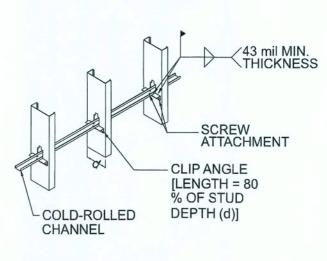


COLD-ROLLED CHANNEL W/CLIP ANGLE

WELDED CRC BRIDGING


FLASTRAP LATERIAL BRACING

HEADER TO JAMB STUD DETAAIL

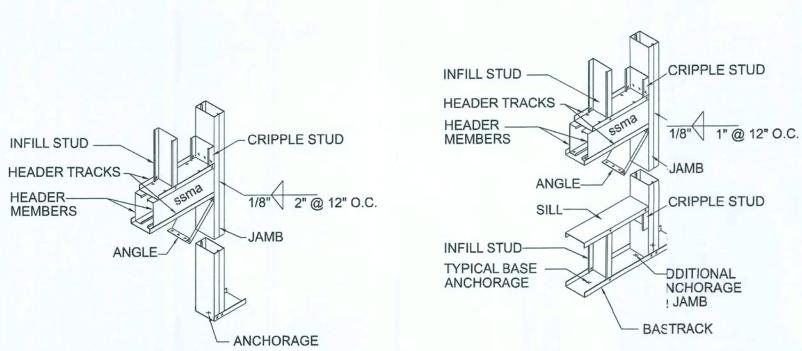


WINDOW - LOAD BEARING **BOXED HEADER - BOXED JAME** TRACK BLOCK PIECE — TO MATCH WALL STUD CLIP FLANGE AND BEND O.C. FRAMED WALL - SCREW ATTACHMENT -TAUT FLAT STRAPS

BRIDGING DOUBLE FLAT STRAP W/BLOCKING

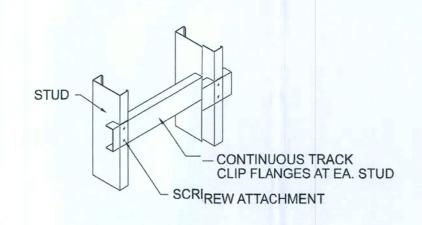


BACKING - CLIPPED TRACK: HVY. LOADED (GRAB BARS, HANDRAILS, \, WALL HUNG CABINETS)

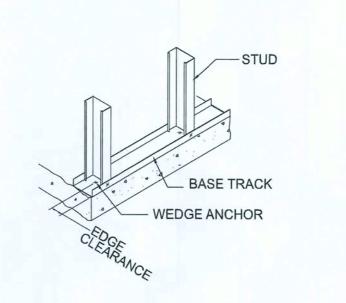


STUD WEB PENETRATIONS

BOTTOM TRACK WEDGE ANCHOR

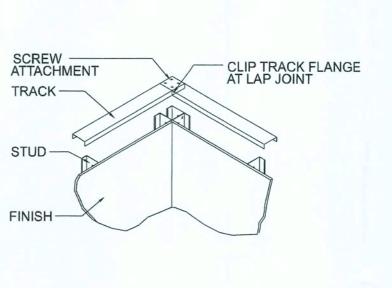

CORNER TRACK LAP CONNECTION

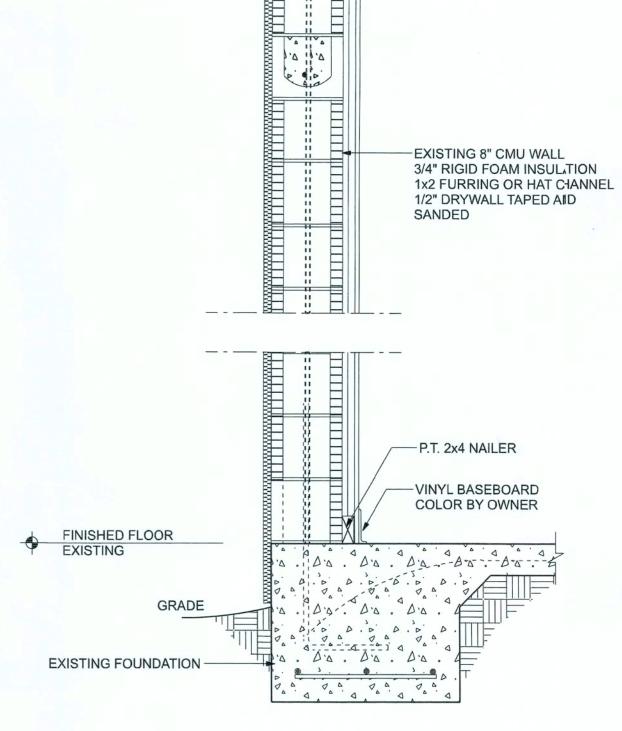

WALL SECTION SCALE: NTS

Metal Stud DETAILS

Door - Load Bearing **Boxed Header**

Boxed Jamb

SCALE: NONE

DOOR - LOAD BEARING

BOXED HEADER - BOXED JAMB

NOTE! ALL METAL STUDS IN AXIAL LOAD APPLICATIONS SHALL BE 358SW18 MINIMUM, W/ MATCHING TRACK, ALL WELDED JOINTS

		REVISIONS	
DATE	BY	DESCRIPTION	

DBIGN BY:

CERTIFIED GENERAL CONTRACTOR CGC1514780

163 SW MIDTOWN PL. STE. 101 LAKE CITY, FL. 32025 (386)755-5254 **Onstruction Group, Inc.**



CERTIFICATE OF AUTHORIZATION NO. 28022

> P.O. BOX 970 LAKE CITY, FL 32056 PHONE: 386.754.4085



DRAWN BY:	
TM	
APPROVED BY:	
BC.	

VN BY:	
TM	
OVED BY:	
BC.	

SOUTHRIDGE DAY SCHOOL REMODEL

PROJECT NO .: c21.001

FRAMING DETAILS

SHEET: A-3