


+engineering

2809 jax Avenue Suite 100 Rogers Arkansas 72758 Phone: 479.636.3545 fax: 479.636.1209 Achitect of Record

HIS CONTROLL OF THE STATE OF TH

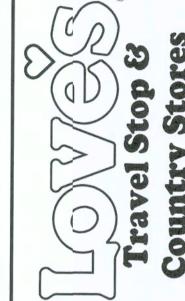


SSUE BIOCK

DRAWN BY DOCUMENT DATE: 01/29/2020




DEMOLITION PLAN

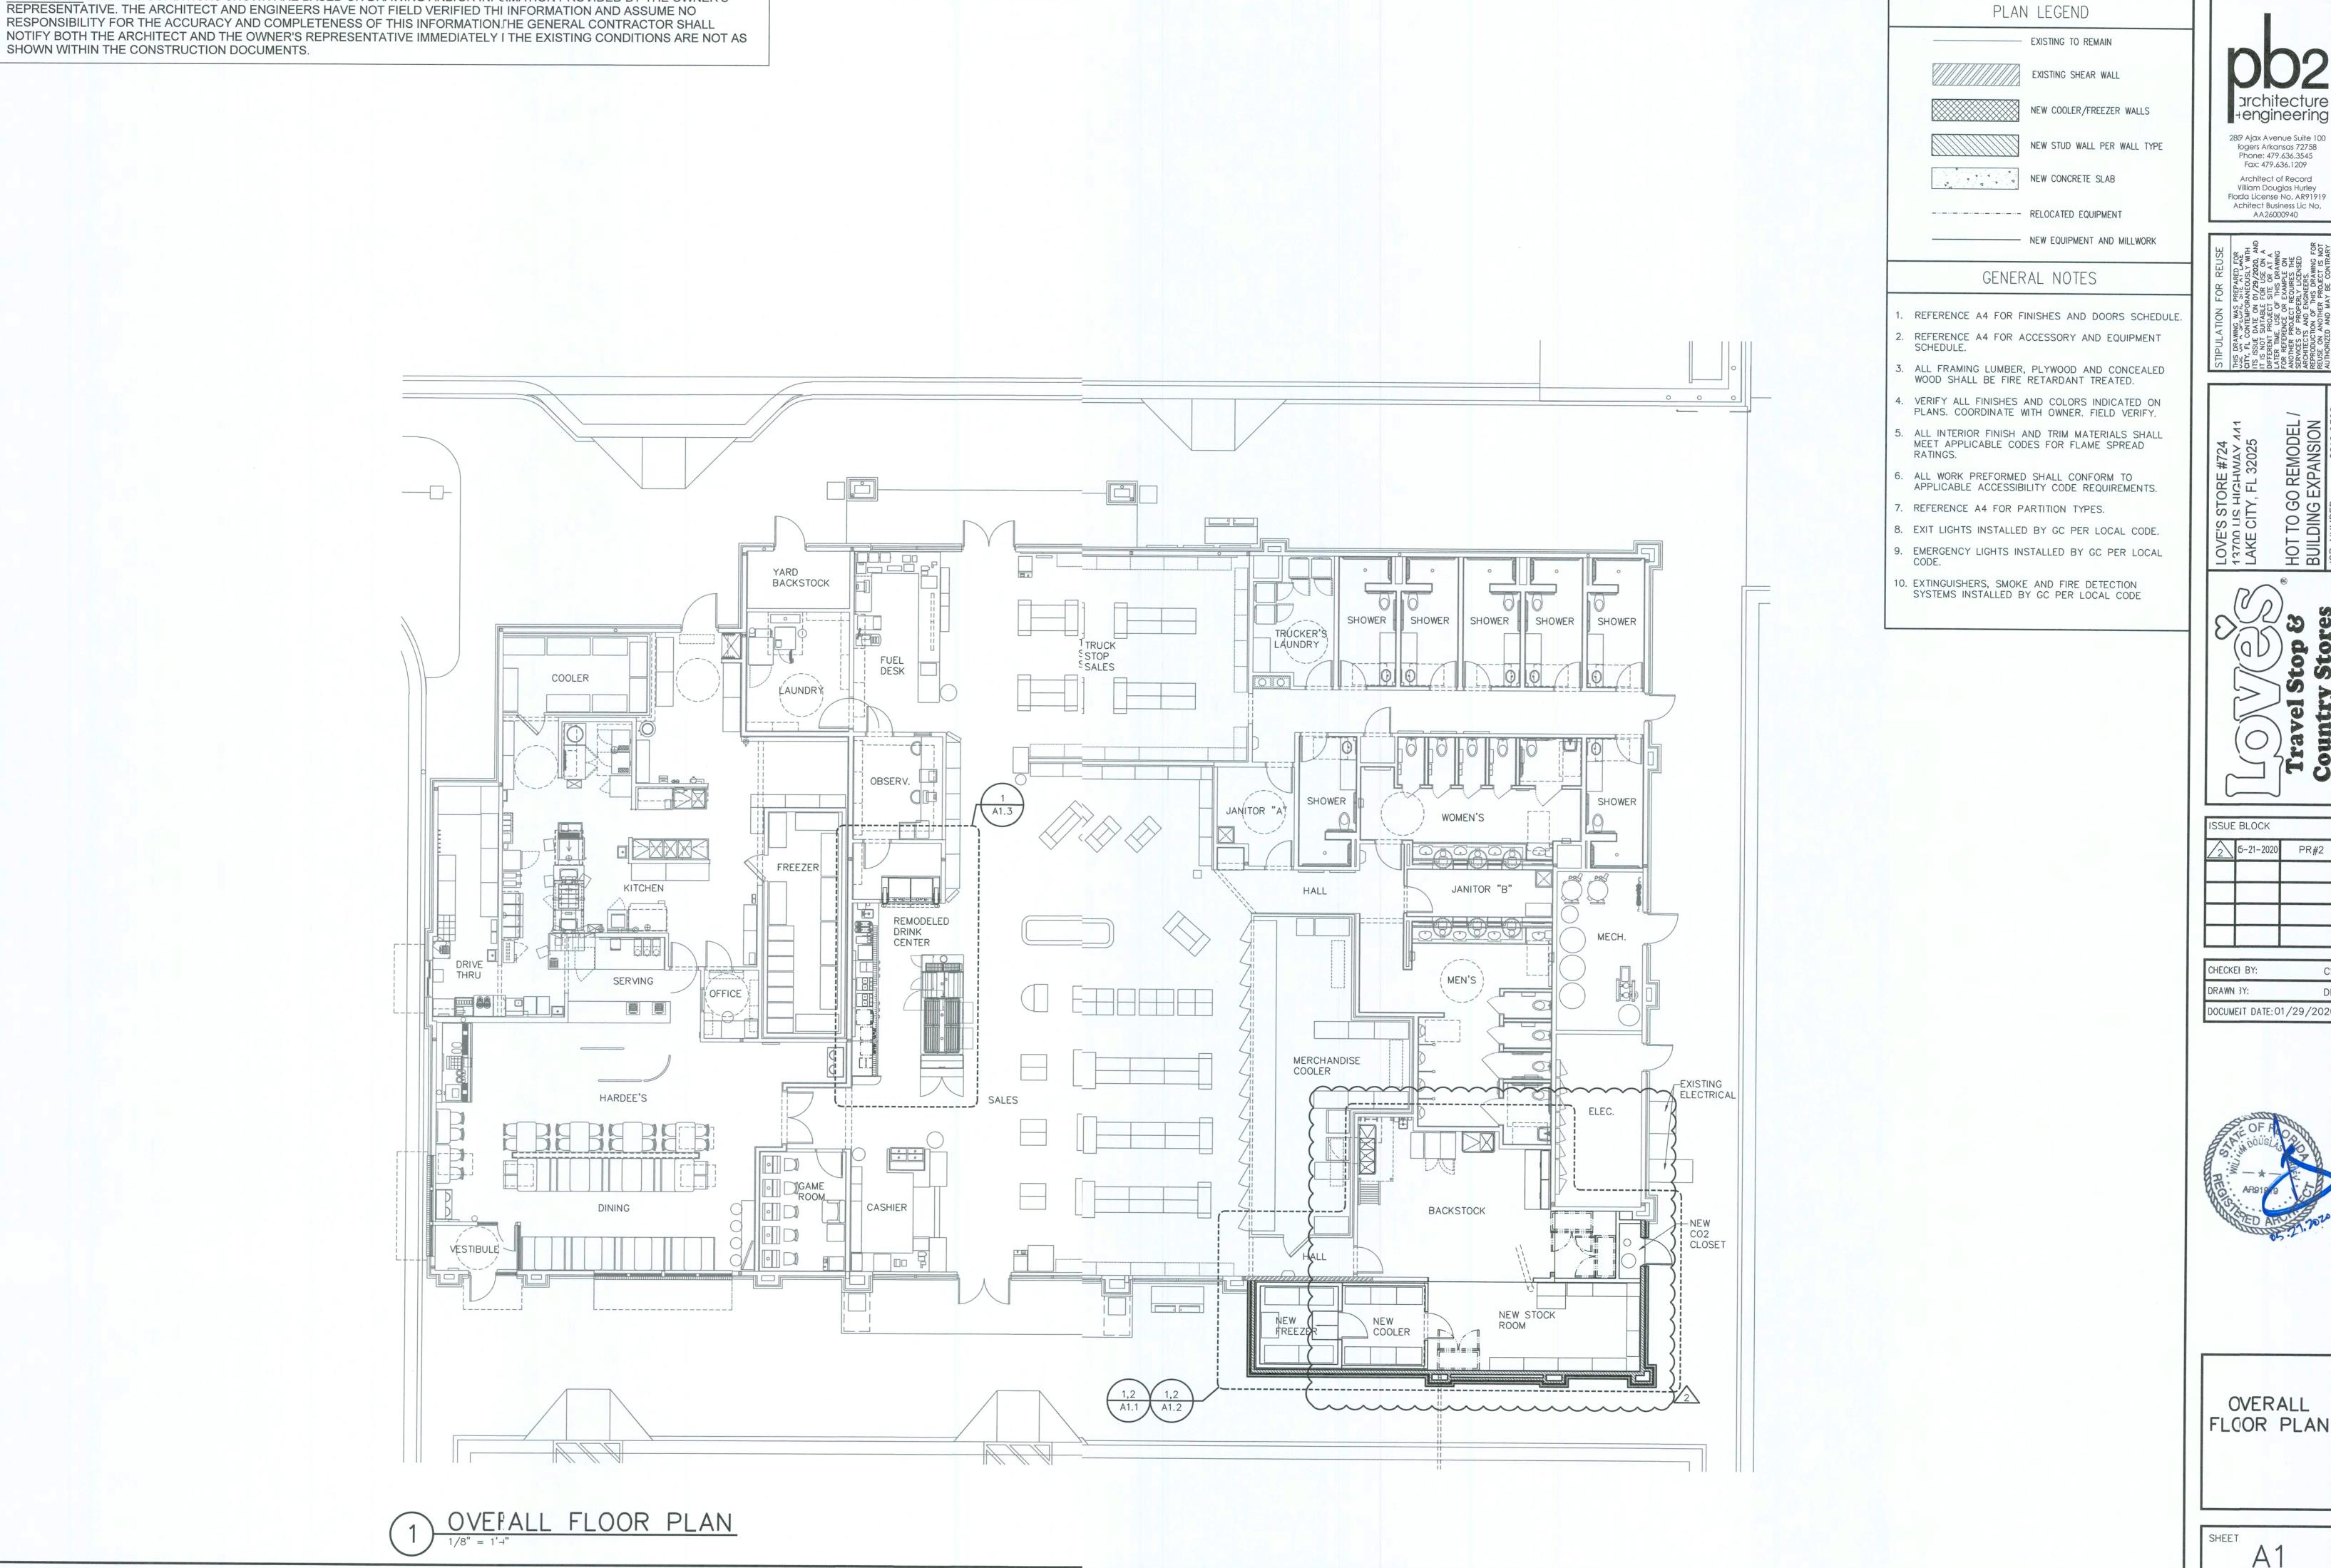

DISCLAIMER: EXISTING CONDITIONS SHOWN ARE BASED ON DRAWING AND/OR INFRMATION PROVIDED BY THE OWNER'S

+engineering 289 Ajax Avenue Suite 100 logers Arkansas 72758 Phone: 479.636.3545 Fax: 479.636.1209 Architect of Record Villiam Douglas Hurley

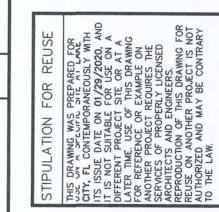

ISSUE	BLOCK	
$\sqrt{2}$	G-21-2020	PR#2


CHECKEI BY:	(
DRAWN 3Y:	
DOCUMEIT DATE: 01/	/29/202



OVERALL FLOOR PLAN


A1

DISCLAIMER: EXISTING CONDITIONS SHOWN ARE BASED ON DRAWING AND/OR INFORMATION PROVIDED BY THE OWNER'S REPRESENTATIVE. THE ARCHITECT AND ENGINEERS HAVE NOT FIELD VERIFIED THIS IFORMATION AND ASSUME NO RESPONSIBILITY FOR THE ACCURACY AND COMPLETENESS OF THIS INFORMATION. THE GENERAL CONTRACTOR SHALL NOTIFY BOTH THE ARCHITECT AND THE OWNER'S REPRESENTATIVE IMMEDIATELY IF THE EXISTING CONDITIONS ARE NOT AS SHOWN WITHIN THE CONSTRUCTION DOCUMENTS.

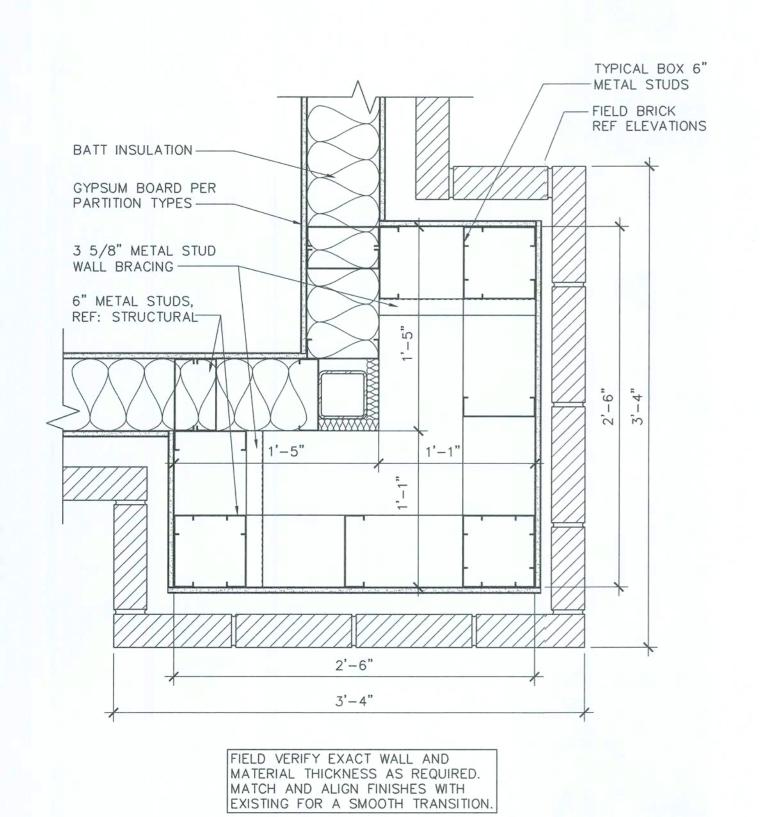


CORNER PILASTER DETAIL

1 1/2" = 1'-0"

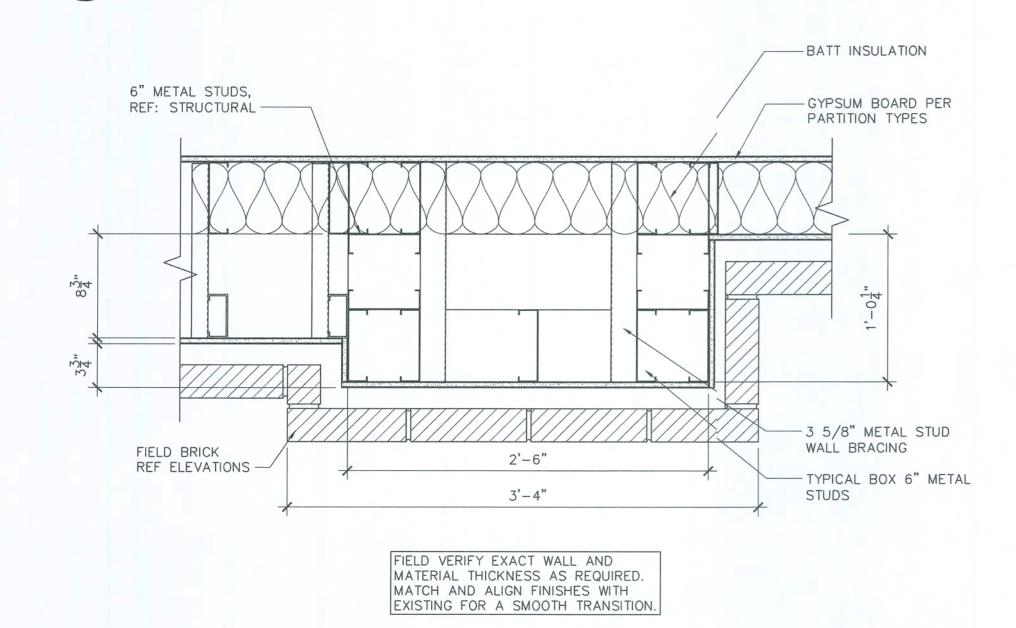


VED: add

5/21/2020 4:04 PM BY: Lesya Morri jects\projects\loves\2019.0328 0724

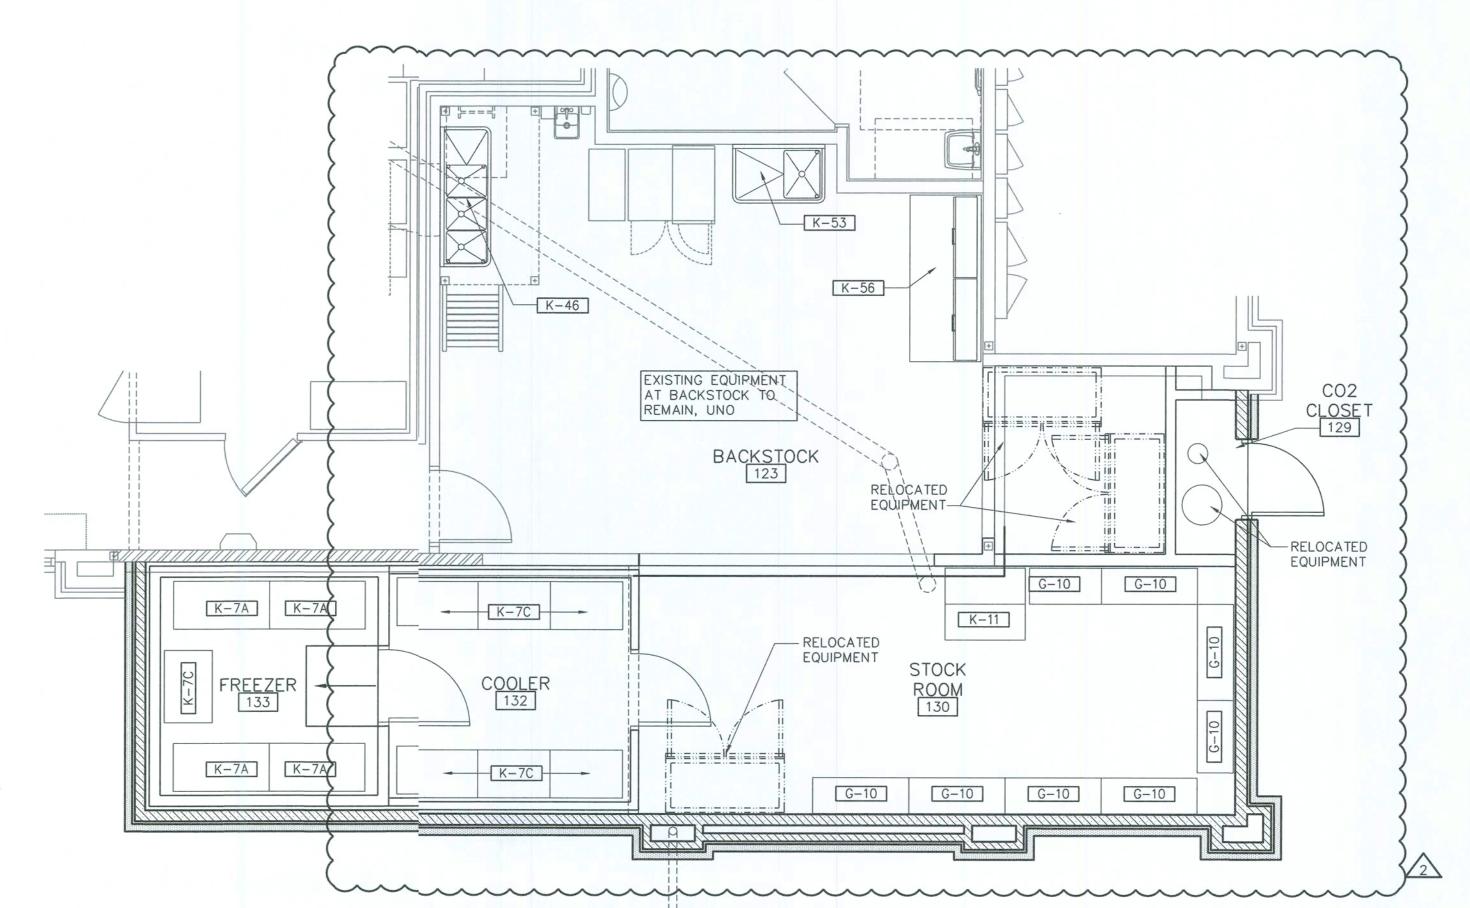

) ENLARGED FLOOR PLAN

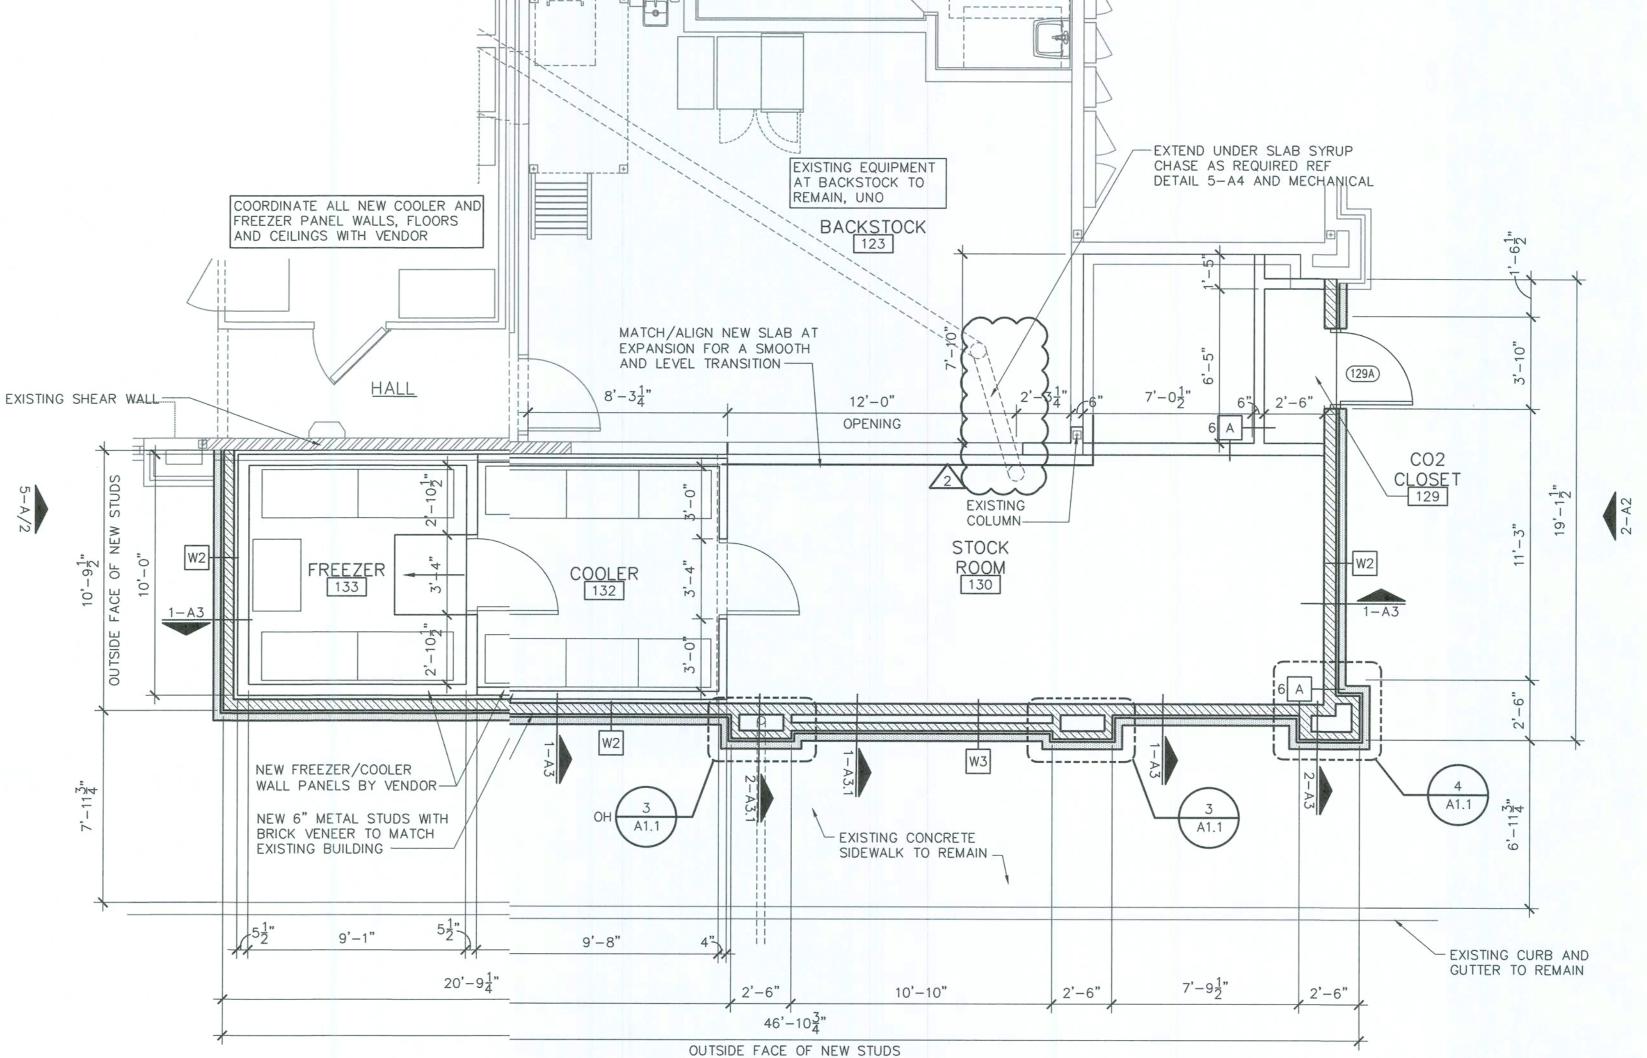

1-A2

PLAN LEGEND

EXISTING TO REMAIN EXISTING SHEAR WALL NEW COOLER/FREEZER WALLS

NEW STUD WALL PER WALL

NEW BRICK PER WALL TYPES AND ELEVATIONS

#### GENERAL NOTES

- ALL METAL STUDS ARE TO BE 20 GA. TYPICAL NON-LOAD BEARING PARTITIONS. SEE USG STEEL-FRAMED DRYWALL SYSTEMS "LIMIT HEIGHT -STEEL STUD ASSEMBLIES" CHART. USE THE L/240 ALLOWABLE DEFLECTION FIGURES ONLY.
- 2. REFERENCE A4 FOR FINISHES AND DOORS SCHEDULE
- REFERENCE A4 FOR ACCESSORY AND EQUIPMENT SCHEDULE.
- 4. ALL WALL TILE VERTICAL JOINTS LOCATED AT INSIDE CORNERS SHALL BE CAULKED. MATCH TILE COLOR.
- 5. ALL FRAMING LUMBER, PLYWOOD AND CONCEALED WOOD SHALL BE FIRE RETARDANT TREATED.
- MILLWORK, ACCESSORIES, FIXTURES, AND SHELVING ARE PROVIDED BY OWNER AND INSTALLED BY GC
- VERIFY ALL FINISHES AND COLORS INDICATED ON
- PLANS, COORDINATE WITH OWNER, FIELD VERIFY. B. ALL INTERIOR FINISH AND TRIM MATERIALS SHALL

MEET APPLICABLE CODES FOR FLAME SPREAD

- RATINGS. 9. ALL WORK PREFORMED SHALL CONFORM TO APPLICABLE ACCESSIBILITY CODE REQUIREMENTS.
- 10. REFERENCE A4 FOR PARTITION TYPES.
- 11. EXIT LIGHTS INSTALLED BY GC PER LOCAL CODE.
- 12. EMERGENCY LIGHTS INSTALLED BY GC PER LOCAL
- 13. EXTINGUISHERS, SMOKE AND FIRE DETECTION SYSTEMS INSTALLED BY GC PER LOCAL CODE



Willian Douglas Hurley Florida Icense No. AR91919 Architect Business Lic No.

1A26000940




'S STORE US HIGHV CITV, FL 3

ISSUE	BLJCK	
$\sqrt{1}$	03-5-2020	PR#1
2	05-11-2020	PR#2
-		


CHECKED BY: DRAWN BY: DOCUMENT DATE: 01/29/202





**ENLARGED** F\_OOR PLANS AND DETAILS

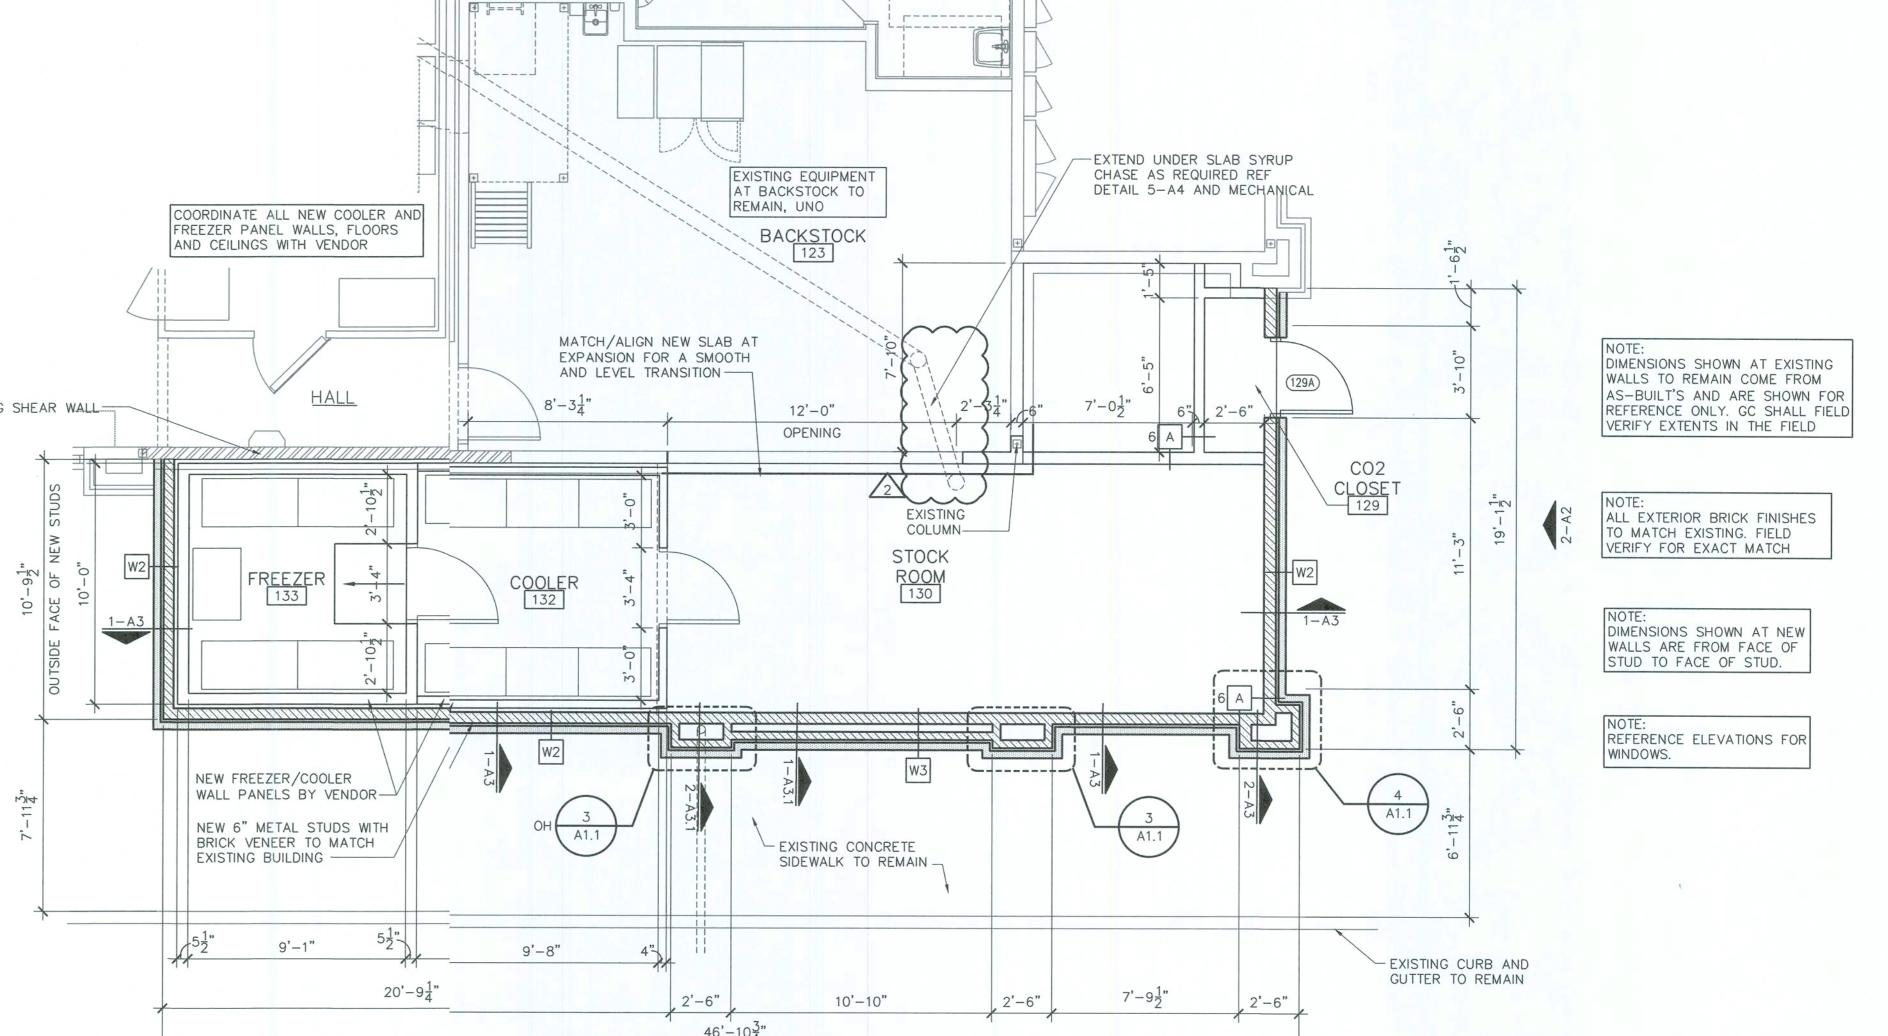

	MATERIAL IEGEND - INTERIOR DO								
MARK	DESCRIPTION	MODEL	COMMENTS	MK					
EP-1	EPOXY	SIKADUR 55 SLV REF SPECS		- IVIN					
-T-3	SURFACE-TREAD	DALTILE 6"X6" SURETREAD, OQ76 GRAY - WITH MAPEI BLACK GROUT	AT WALK-IN COOLER	129A					
3S-1	RUBBER BASE	"ROPPE" BLACK - 4"							
PT-7	PAINT	SHERWIN WILLIAMS 7567 "NATURAL TAN" - LATEX OR PPG 1075-3 "CASIL ELEGANCE"							
AND 096	53. TILE FINISH NUMBERS 1, 8, AM	ND 12 ARE FURNISHED THROUGH DALTILE. CONTACT: BRANDT ELDRIDG 405-606-9415, IED THROUGH METRO SURFACES. CONTACT: RYAN DODE, 405-657-0833, DVES@METROS	AIN, AND RESILIENT TILE AND WALL BASE. REFER TO SPECIFICATION SECTIONS 09310, 09651, BRANDT.ELDRIDGE@DALTILE.COM SURFACES.COM	ROOM					
				123					
				129					
				130					
				132					
		STUD WALL REF PARTITION TYPE (B) UP TO DECK		133					
				EQI					
		CONTINUOUS TRACK ATTACH		ITEM					
		TO COOLER/FREEZER PER MANUFACTURER INSTRUCTION		K-7A 2					
				K-7C 2					
	COOLER/FREEZER WALL-	COOLED /EDEEZED CEILING		K-13A F					
		COOLER/FREEZER CEILING		K-22A					

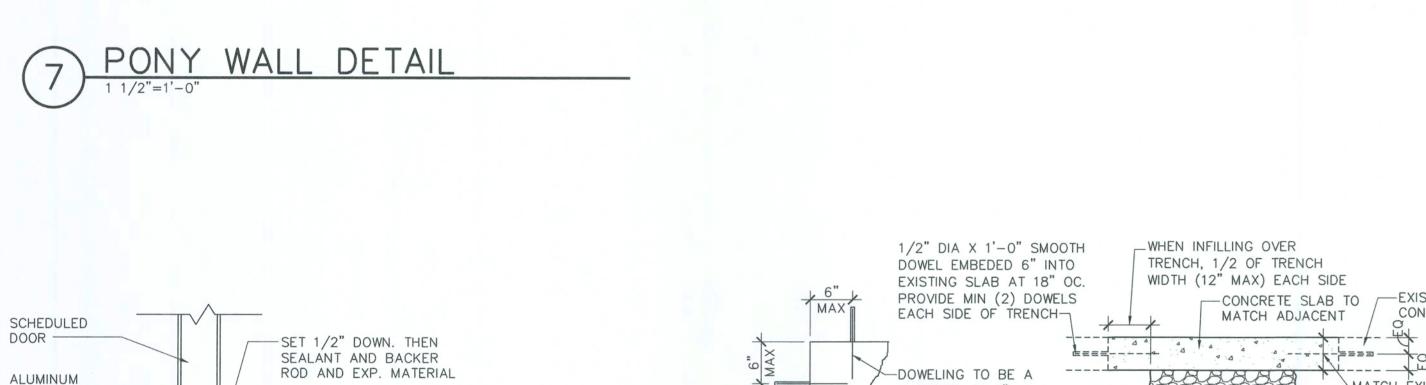

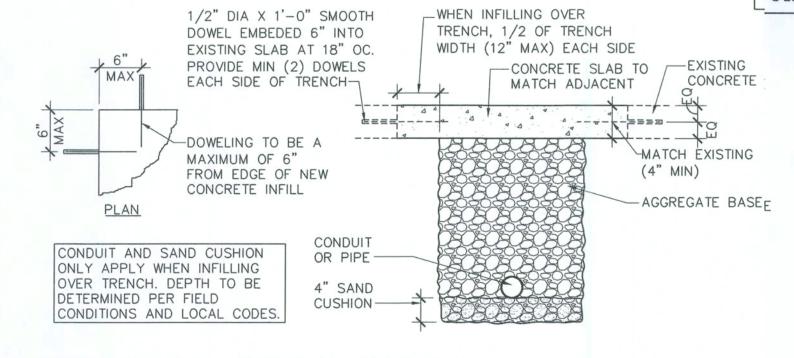

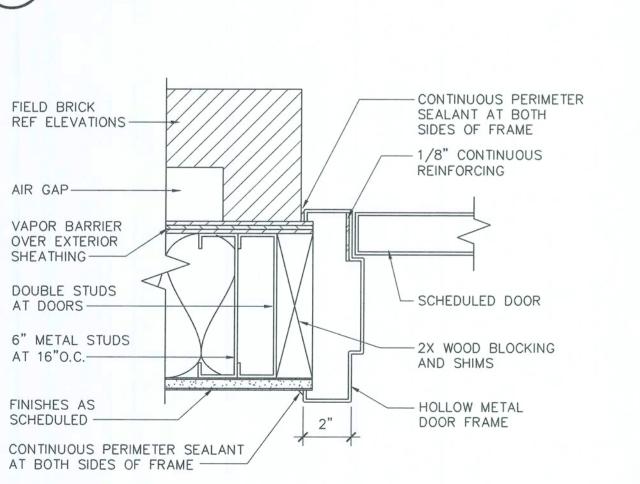

SLOPE AWAY FROM

-SEALANT, MATCH ADJACENT


BUILDING, MAX 2%

SURFACE COLOR


THRESHOLD

THRESHOLD SET

IN CONT. MASTIC -

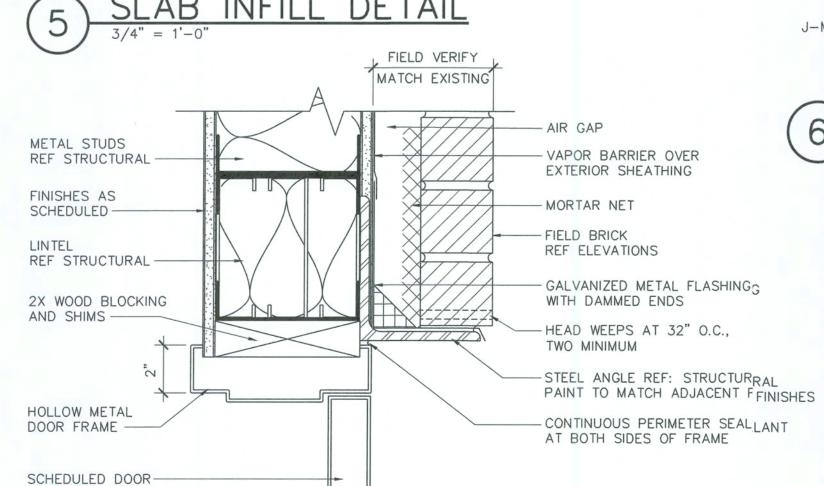

-SEAL AIR SPACE WITH EXPANDING FOAM SEALANT METAL ROOF DECK -ATTACH 6"x6"x16 GAUGE WITH #10x1" SCREWS FOR (2) ATTACH GYPSUM BOARD ROWS AT 24" OC TO AT TOP ONLY METAL ROOF DECK 2" x 20 GAUGE CONTINUOUS METAL STRAP J-MOLD EDGE -

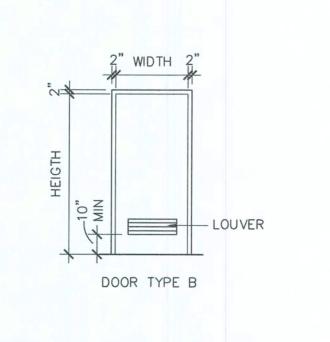

OOR FINISH SCHEDULE TYP. SIZE FRAME GLAZING HEAD JAMB THRESHOLD REMARKS 2-A4 INSULATED 3'-6" X 7'-0" X 1-3/4" HOLLOW METAL MATCH EXISTING METAL. MATCH EXISTING

	ROOM FINISH SCHEDULE 4 2												
ROOM		FLOOR	BASE		TYPICAL S	UBSTRATE	S		FIN	IISHES		CEILING	
NUMBER	ROOM NAME	FINISH	FINISH	1	2	3	4	1	2	3	4	FINISH	COMMENTS
123	BACKSTOCK	EP-1	BS-1	ETR	1/2" GYP BD OVER 1/2" PLYWOOD OVER 5/8" GYP BD	1/2" GYP BD OVER 1/2" PLYWOOD OVER 5/8" GYP BD	ETR	ETR	PT-7	PT-7	ETR	NONE	PLYWOOD TO RUN FROM FLOOR TO 12'-0"
129	CO2 CLOSET	SC-1	NONE	1/2" GYP BD	1/2" GYP BD	1/2" GYP BD	1/2" GYP BD	PT-7	PT-7	PT-7	PT-7	NONE	
130	STOCKROOM	EP-1	BS-1	1/2" GYP BD OVER 1/2" PLYWOOD OVER 5/8" GYP BD	PT-7	PT-7	PT-7	PT-7	NONE	PLYWOOD TO RUN FROM FLOOR TO 12'-0"			
132	COOLER	FT-3	NONE	NONE	NONE	NONE	NONE	FACTORY	FACTORY	FACTORY	FACTORY	FACTORY	COOLER PANELS PROVIDED/INSTALLED BY BOX MANUFACTURER
133	FREEZER	FACTORY	FACTORY	NONE	NONE	NONE	NONE	FACTORY	FACTORY	FACTORY	FACTORY	1	FREEZER PANELS PROVIDED/INSTALLED BY BOX MANUFACTURER

PARTITION TYPES


ITEM DESCRIPTION		MODEL	SUPPLIER/ REMARKS	
			INSTALLER	
K-7A	24"x48" COATED WIRE SHELVING	PER OWNER	OWNER / GC	
K-7C	24"x36" COATED WIRE SHELVING	PER OWNER	OWNER / GC	
K-11	SYRUP BOX RACK	CORNELIUS 161111000Q3082	OWNER/ OWNER	
K-13A	POP - ICE DISPENSER	CORNELIUS IDC PRO	OWNER / GC	
K-22A	BEAN 2 CUP COFFE BREWER	SCHAERER - COFFE ART C TOUCH	OWNER / GC	_
K-46	3 COMP SINK	ADVANCE TABCO FE-3-1620-18R-X	OWNER / GC	
K-53	PREP SINK	TO BE SOURCED	OWNER / GC	
K-56	PREP TABLE	RANDELL 8383N-290	OWNER / GC	
K-60	POP - CUP DISPENSER	TO FIT "SOLO" BRAND CUPS	MILLWORK CONTRACTOR	^
K-75	LID DISPENSER		MILLWORK CONTRACTOR	
K-93A	POST ICE MAKER	HOSHIZAKI F-2001MRJ-C	OWNER / GC	
G-10	18"x48" STORAGE SHELVING	LOZIER MFG. SHELVING	OWNER/ GC	
S-28	CUSTOM MILLWORK		MILLWORK CONTRACTOR	

-METAL STUDS

# PARTITION NOTES

- 1. WALL INSULATION WHERE INDICATED ON PLANS
- 2. WALL FINISHES AS INDICATED ON ROOM FINISH AND INTERIOR ELEVATIONS SCHEDULE
- 3. USE DEFLECTION CHANNEL AT DECKING CONNECTION ALL PARTITIONS THAT GO TO DECK FOR
- 4. ALL PARTITIONS THAT DO NOT GO TO DECK SHALL HAVE DIAGONAL BRACING BEGINNING 2" ABOVE THE CEILING FINISH. BRACING: 3 5/8" 20 GAUGE METAL STUD BRACING @ 48" OC SECURE END TO BAR JOIST ABOVE
- 5. USE FIRE RATED 5/8" TYPE "X" GYP BD SUBSTRATE ON FIRE RATED PARTITIONS.
- 6. ON FIRE RATED PARTITIONS WHERE DENS SHIELD SUBSTRATE IS INDICATED. USE DENS SHIELD THAT IS EQUAL TO FIRE RATED "X" GYP BD SUBSTRATE.
- 7. SUBSTRATE TO STOP AT CEILING AT GYP BD CEILING CONDITIONS, TYP
- AT 6" ABOVE LAY—IN CEILINGS, TYP UNO AT TOP OF STUD FOR ROOMS WITHOUT CEILINGS (EXPOSED TO STRUCTURE), TYP UNO
- 8. ALL WOOD AND PLYWOOD USED IN THE BUILDING SHALL BE FIRE RETARDANT TREATED
- 9. REFERENCE CAPTURE TRACK DETAIL 6/A4 FOR WALLS THAT CONNECT TO DECK.
- 10. G.C. TO FIELD VERIFY AND MATCH EXISTING EXTERIOR WALL FINISHES AND THICKNESS AS REQUIRED TO MATCH/ALIGN FINISHES FOR A SMOOTH TRANSITION.

EXTERIOR WALL TYPES

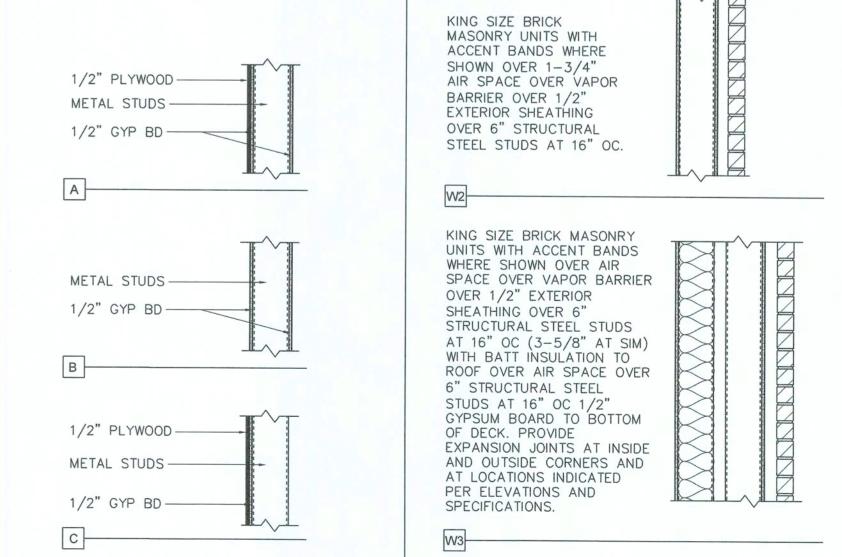

architecture +engineering

2809 Aja Avenue Suite 100 Roger Arkansas 72758 Phore: 479.636.3545 Fax 479.636.1209 Archtect of Record Willian Douglas Hurley Florida License No. AR91919 Architect Business Lic No.

A 26000940


ISSUE BL(CK 2 05-2-2020 PR#2

CHECKED BY DRAWN BY: DOCUMENT [ATE: 01/29/2020



SCHEDULES **DETAILS** 

SHEET:

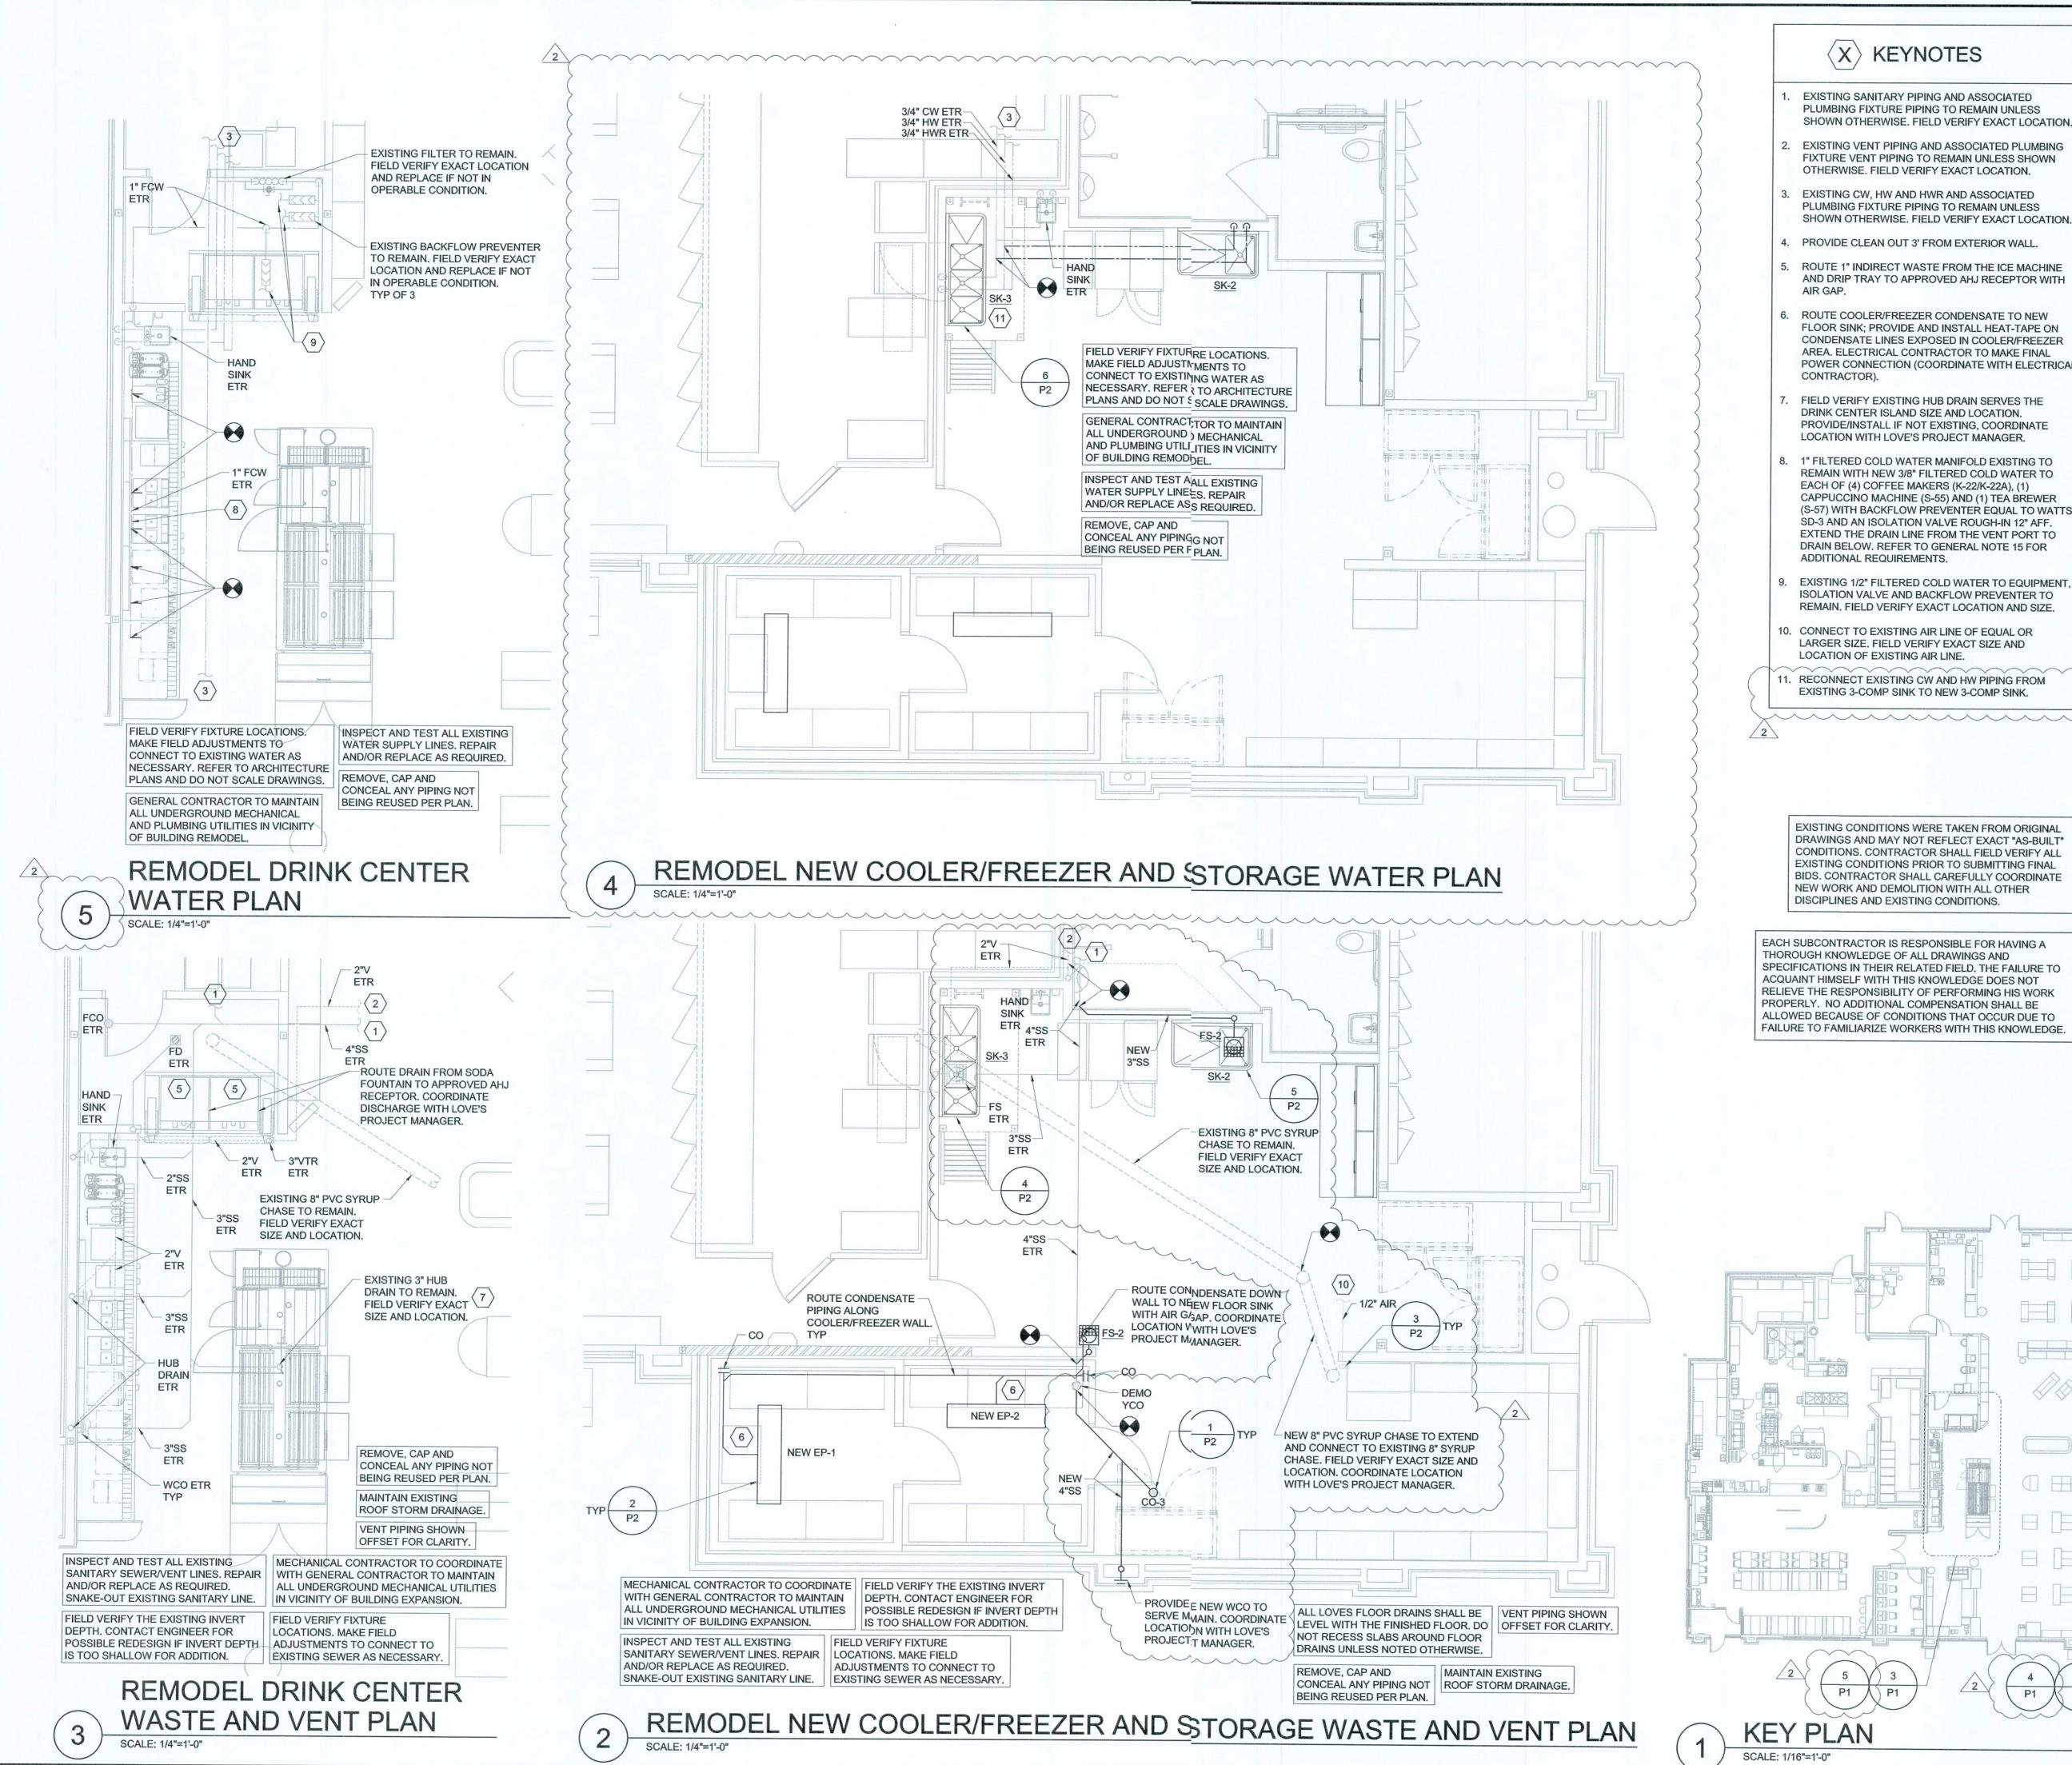

EXISTING SANITARY PIPING AND ASSOCIATED PLUMBING FIXTURE PIPING TO REMAIN UNLESS SHOWN OTHERWISE. FIELD VERIFY EXACT LOCATION.

EXISTING VENT PIPING AND ASSOCIATED PLUMBING FIXTURE VENT PIPING TO REMAIN UNLESS SHOWN

EXISTING CW, HW AND HWR AND ASSOCIATED

ROUTE 1" INDIRECT WASTE FROM THE ICE MACHINE AND DRIP TRAY TO APPROVED AHJ RECEPTOR WITH

ROUTE COOLER/FREEZER CONDENSATE TO NEW FLOOR SINK; PROVIDE AND INSTALL HEAT-TAPE ON CONDENSATE LINES EXPOSED IN COOLER/FREEZER AREA. ELECTRICAL CONTRACTOR TO MAKE FINAL POWER CONNECTION (COORDINATE WITH ELECTRICAL)

FIELD VERIFY EXISTING HUB DRAIN SERVES THE DRINK CENTER ISLAND SIZE AND LOCATION. PROVIDE/INSTALL IF NOT EXISTING, COORDINATE

1" FILTERED COLD WATER MANIFOLD EXISTING TO REMAIN WITH NEW 3/8" FILTERED COLD WATER TO EACH OF (4) COFFEE MAKERS (K-22/K-22A), (1) CAPPUCCINO MACHINE (S-55) AND (1) TEA BREWER (S-57) WITH BACKFLOW PREVENTER EQUAL TO WATTS SD-3 AND AN ISOLATION VALVE ROUGH-IN 12" AFF. EXTEND THE DRAIN LINE FROM THE VENT PORT TO DRAIN BELOW. REFER TO GENERAL NOTE 15 FOR

EXISTING 1/2" FILTERED COLD WATER TO EQUIPMENT, ISOLATION VALVE AND BACKFLOW PREVENTER TO REMAIN. FIELD VERIFY EXACT LOCATION AND SIZE.

LARGER SIZE. FIELD VERIFY EXACT SIZE AND

RECONNECT EXISTING CW AND HW PIPING FROM EXISTING 3-COMP SINK TO NEW 3-COMP SINK.

> EXISTING CONDITIONS WERE TAKEN FROM ORIGINAL DRAWINGS AND MAY NOT REFLECT EXACT "AS-BUILT' CONDITIONS. CONTRACTOR SHALL FIELD VERIFY ALL EXISTING CONDITIONS PRIOR TO SUBMITTING FINAL BIDS. CONTRACTOR SHALL CAREFULLY COORDINATE NEW WORK AND DEMOLITION WITH ALL OTHER

EACH SUBCONTRACTOR IS RESPONSIBLE FOR HAVING A SPECIFICATIONS IN THEIR RELATED FIELD. THE FAILURE TO ACQUAINT HIMSELF WITH THIS KNOWLEDGE DOES NOT RELIEVE THE RESPONSIBILITY OF PERFORMING HIS WORK PROPERLY. NO ADDITIONAL COMPENSATION SHALL BE ALLOWED BECAUSE OF CONDITIONS THAT OCCUR DUE TO

#### **GENERAL NOTES**

ALL PLUMBING WORK SHALL BE PERFORMED IN STRICT ACCORDANCE WITH THE BASE BUILDING SPECIFICATION AND WITH THE LATEST EDITION OF THE PREVAILING STATE MECHANICAL/PLUMBING AND BUILDING CODES AS WELL AS ALL REGULATIONS THAT MAY APPLY. IN CASE OF CONFLICT BETWEEN THE CONTRACT DOCUMENTS AND A GOVERNING CODE OR ORDINANCE THE MORE STRINGENT STANDARD SHALL APPLY.

INSTALL ALL REQUIRED CLEANOUTS TO CLEAR EQUIPMENT AND FIXTURES.

SANITARY AND VENT PIPING SHALL BE SCHEDULE 40 PVC WITH INSTALLATION IN ACCORDANCE WITH ASTM D-232.1; ALL FITTINGS SHALL BE APPROVED SANITARY TYPE.

ALL FIXTURES ARE PROVIDED WITH STANDARD TRAP AND CLEANOUT (NOT SHOWN).

ALL WORK SHALL BE PROPERLY TESTED, BALANCED, CLEANED AND DISINFECTED. PROVIDE A ONE YEAR WARRANTY FROM DATE OF FINAL INSPECTION ON ALL PARTS AND LABOR.

ALL WASTE PIPING 3"Ø AND SMALLER SHALL BE SLOPED AT 1/4" PER FT. PIPING LARGER THAN 3"Ø SHALL BE SLOPED AT 1/8" PER FT.

REFER TO PLUMBING FIXTURE SCHEDULE FOR FIXTURE SPECIFICATIONS.

UNDERFLOOR PLUMBING IS SHOWN SCHEMATICALLY FOR VIEWING PURPOSES ONLY; DURING INSTALLATION FIELD MODIFICATIONS TO ROUTING MAY BE REQUIRED.

TERMINATE PLUMBING VENTS AT A MINIMUM OF 10 FEET FROM ALL AIR HANDLING EQUIPMENT INTAKE

10. CONTRACTOR SHALL VERIFY LOCAL CODE REQUIREMENTS FOR INDIRECT CONNECTIONS FOR FOOD PREP AREAS. CONNECTIONS SHALL BE PROVIDED WITH A MINIMUM 1" AIR GAP. UNLESS REQUIRED OTHERWISE BY LOCAL HEALTH DEPARTMENT.

. ALL FLOOR DRAINS SHALL HAVE DEEP SEAL P-TRAPS.

12. CONTRACTOR SHALL PROVIDE AND INSTALL APPROPRIATE SLEEVES AND/OR CAULKING AT ALL PENETRATIONS TO ENSURE FIRE RATING IS MAINTAINED.

13. NO PIPING SHOULD RUN EXPOSED IN FINISHED

14. DOMESTIC WATER SERVICE PIPE 4" AND SMALLER ABOVE SLAB SHALL BE TYPE "L" HARD DRAWN ASTM B88 COPPER TUBE.

15. INSULATE ALL WATER PIPING EXCEPT EXPOSED TO FIXTURES WITH 1" FIBERGLASS INSULATION WITH NON-COMBUSTIBLE UL RATED VAPOR BARRIER OR CLOSED CELL FLEXIBLE INSULATION EQUAL TO

RUN-OUT SIZES TO INDIVIDUAL PLUMBING FIXTURES TO BE EQUAL TO ROUGH-IN SIZE NOTED IN THE PLUMBING FIXTURE ROUGH-IN SCHEDULE. SHEET P2

PLUMBING/PIPING IS SHOWN SCHEMATICALLY FOR VIEWING PURPOSES ONLY. DURING INSTALLATION FIELD MODIFICATIONS TO ROUTING MAY BE REQUIRED.

+engineering 2809 Ajax Avenue Suite 100

Rogers Arkansas 72758 Phone: 479.636.3545 fax: 479.636.1209 Eigineer of Record Matlew Bryan Lewis, P.E. Florica License No. 83179


CO. License No. 26880

SSU

SUE BIOCK 05/:1/2020



**PLUMBING PLANS** 

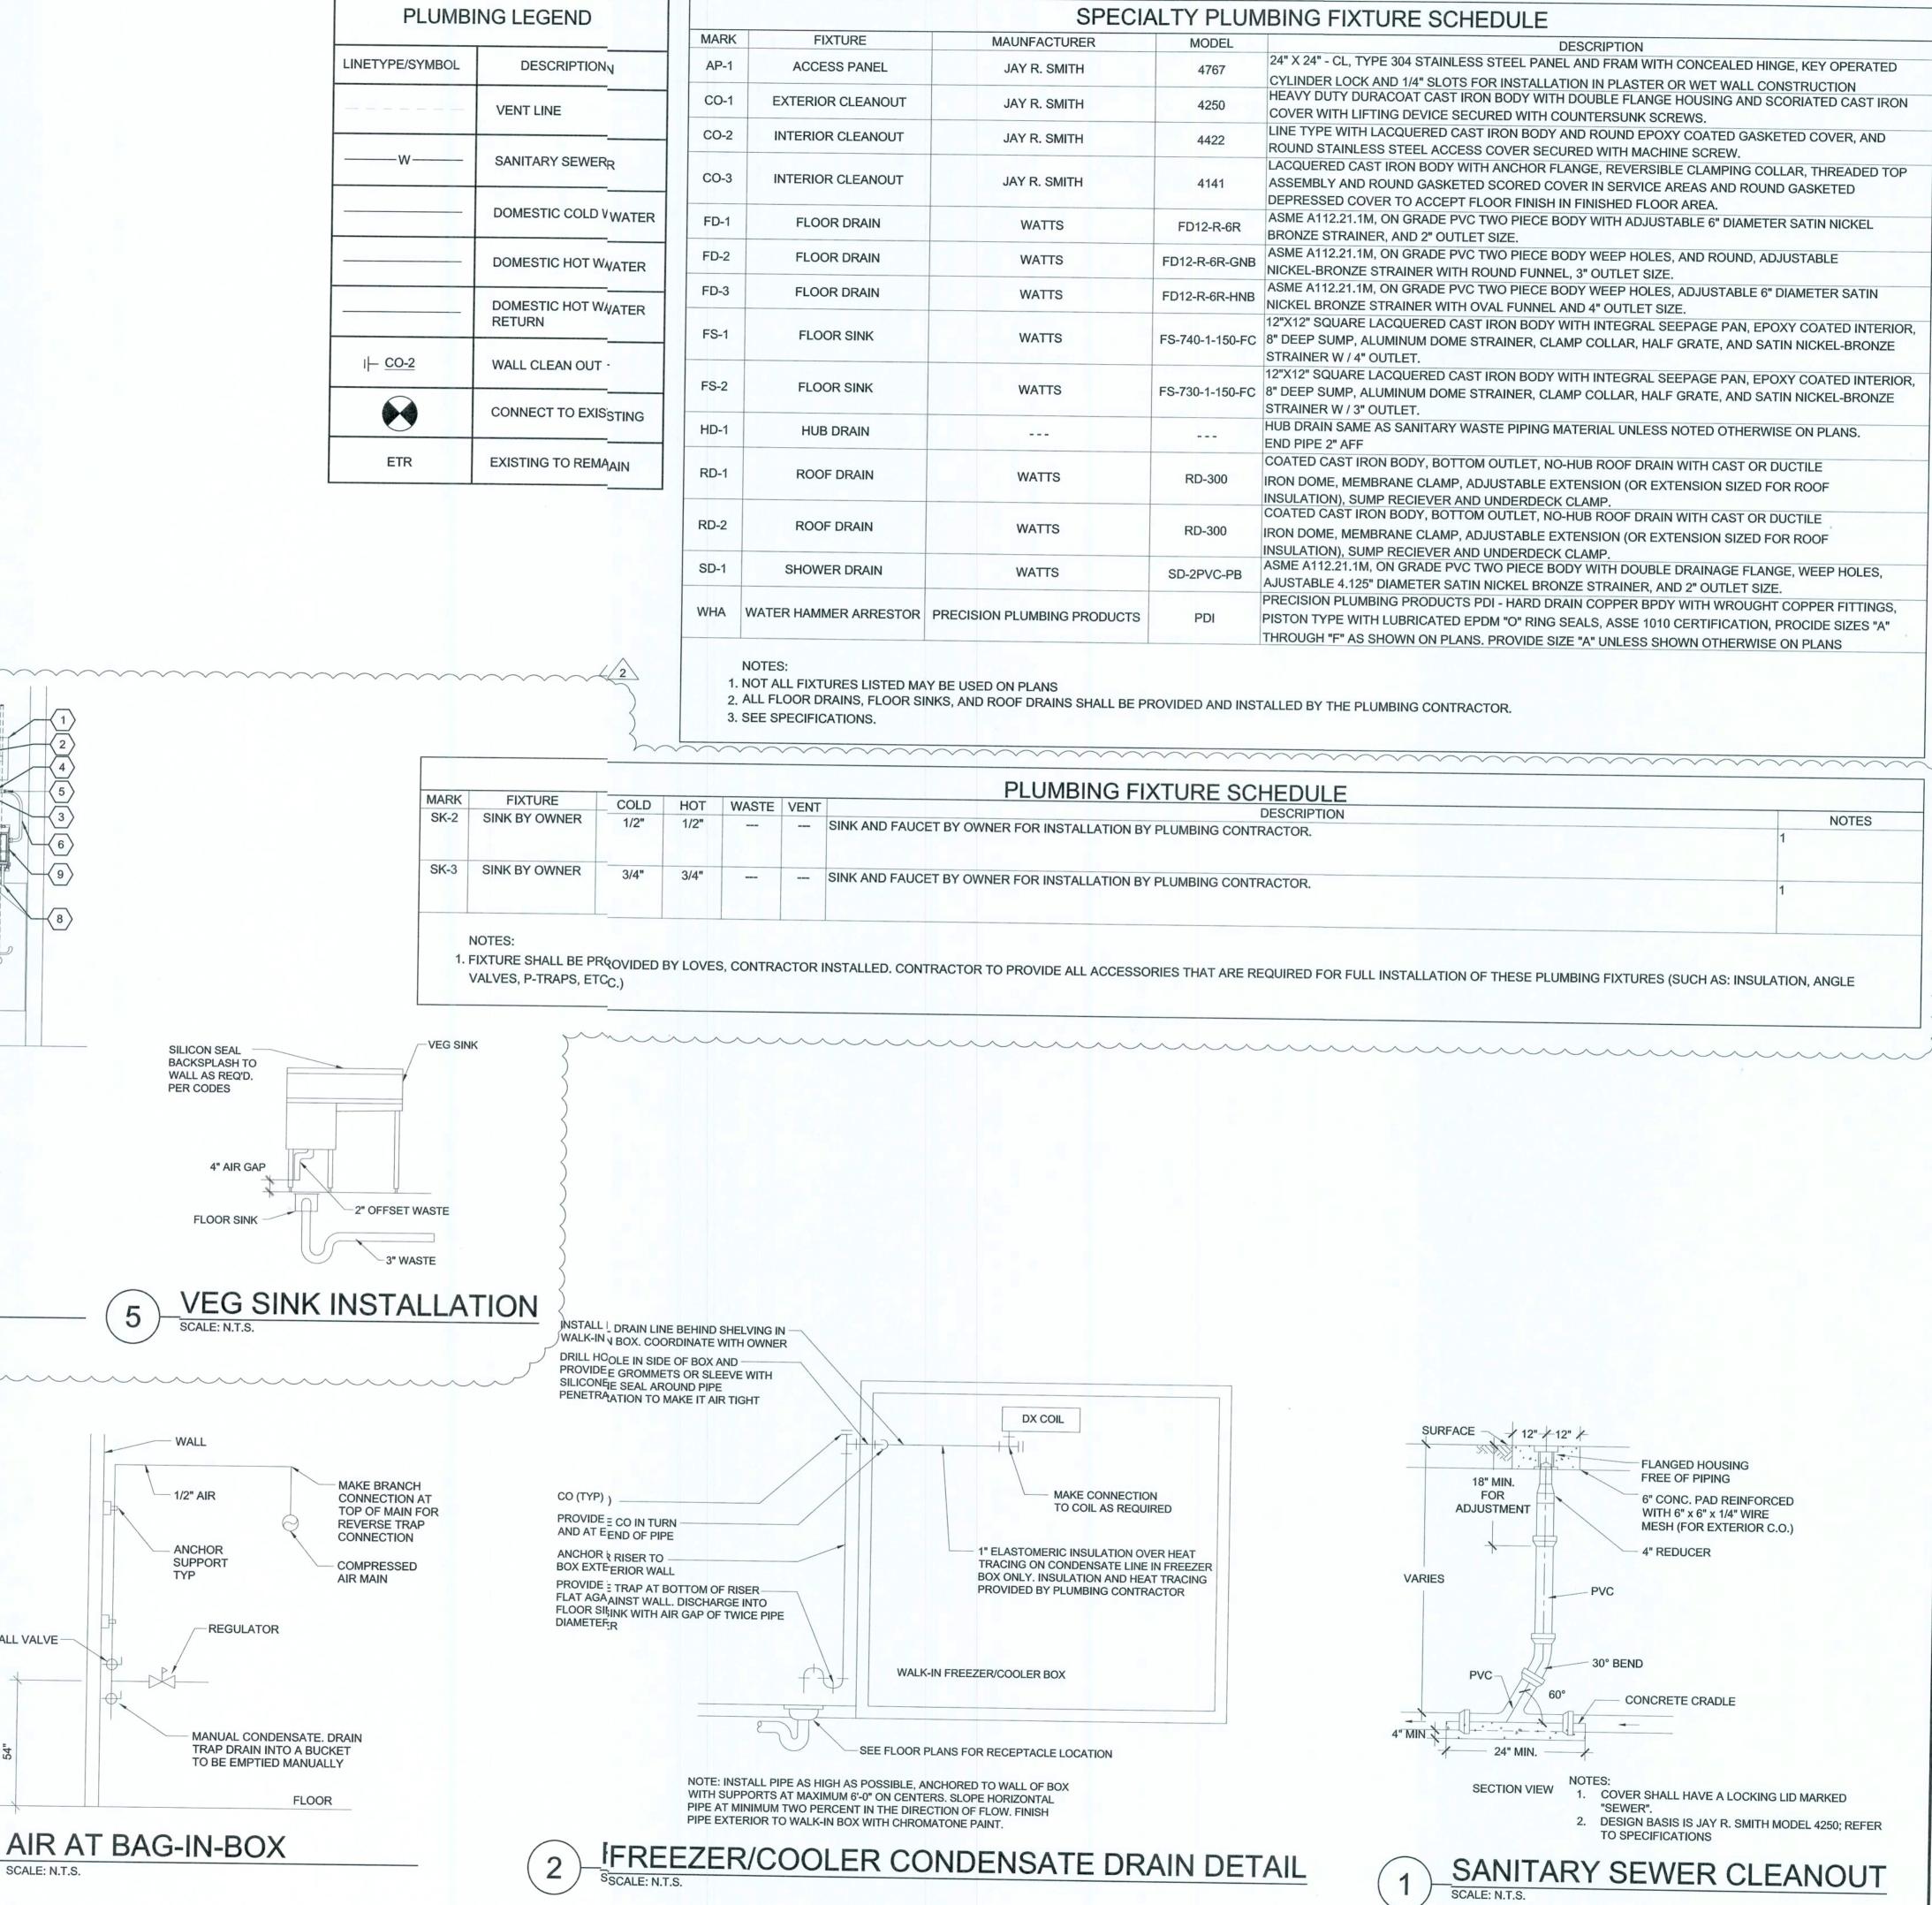

3-COMP. SINK

SILICONE SEAL BACKSPLASH TO

WALL AS REQ'D PER CODES

4" AIR GAP

FLOOR SINK-

SHUT-OFF VALVE 3/4" MHT CONNECTION

12"X12" ACCESS PANEL (COORDINATE INSTALLATION WITH G.C.)

PIPE THROUGH WALL WITH ESCUTCHEON PLATE

\*\*\*PLUMBER'S WORK ENDS AT MHT CONNECTION\*\*\*

ECOLAB SOLIDSENSE CHEMICAL DISPENSER

ECOLAB SMARTSHAPE CHEMICAL DISPENSER CHEMICAL SYSTEM INSTALLATION

HOSE TO CHEMICAL SYSTEM

CHEMICAL DISPENSING HOSE

0 0 0 0

THERMOSTATIC MIXING VALVE SET TO 110°F (WATTS SERIES MMV-UTASSE 1070)

3-COMP. SINK

MIN. HEIGHT OF

SINK DRAINBOARD

- ADJUSTABLE EQUIPENT LEGS ON 3-COMPARTMENT SINK

STRAP DRAIN LINE AGAINST WALL

MOP SINK

BALL VALVE

SCALE: N.T.S.

architecture +engineering 2809 AjaxAvenue Suite 100 Rogers Arkansas 72758

Phone 479.636.3545 Fax: 179.636.1209 Engineer of Record

MathewBryan Lewis, P.E.

Florida License No. 83179

COA License No. 26880

O III

ST S H  $o \ge$ 

SUE BLOCK 05/21/2020


OCUMENT DATI: 01/29/202



PLUMBING **DETAILS AND** SCHEDULES

SHEET: P2

FREEZER / COOLER AREA POWER PLAN

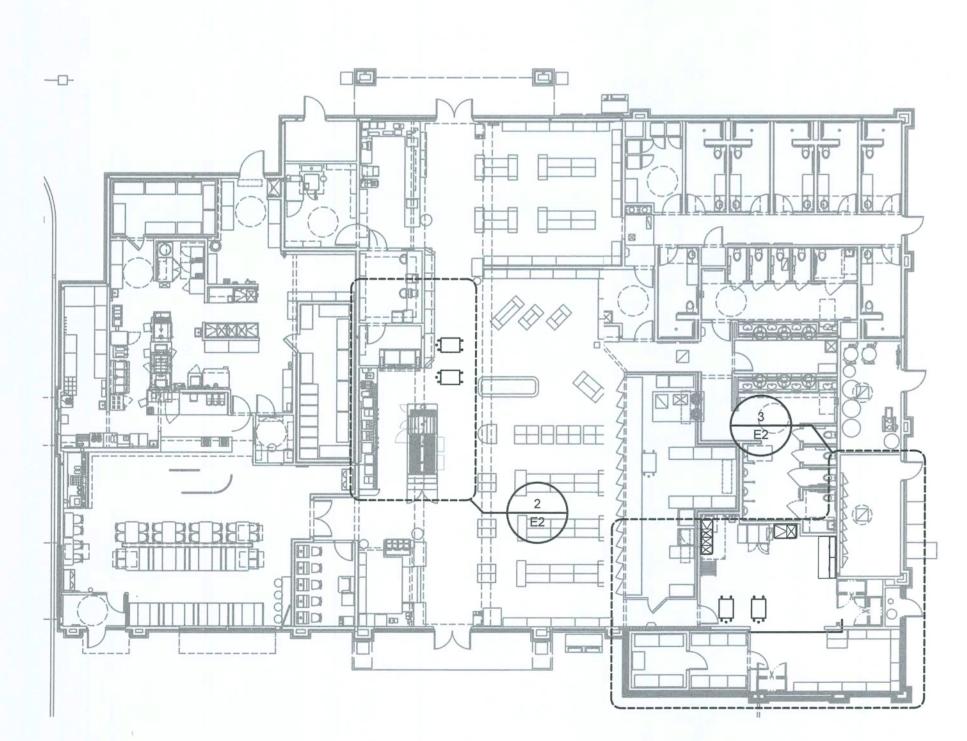

Cor

Brady LAST SAVED: 5/22/2020 12:28 hot to go\drawings\mep\elec\sheets\

Corey - add

PM BY: lisville fl

5/22/2020 12:29 2019.0328 0724 ell

OVERALL POWER ?LAN

#### **GENERAL NOTES**

- FURNISH AND INSTALL ALL MATERIALS, EQUIPMENT, AND LABOR, FOR A COMPLETE INSTALLATION IN ALL RESPECTS, READY FOR INTENDED USE AND IN STRICT ACCORDANCE WITH NEC, NESC, STATE, AND LOCAL CODES, AND MANUFACTURER'S RECOMMENDATIONS.
- A. NO CIRCUITRY SHALL BE ALLOWED TO BE ROUTED ACROSS THE

C. CONTRACTOR SHALL VERIFY THAT ALL AFFECTED PANELBOARDS

HAVE CIRCUIT BREAKER KNOCKOUTS PROPERLY COVERED AND

B. ALL EQUIPMENT SHALL BE UL LISTED WHERE APPLICABLE.

ROOF OR THE EXTERIOR SIDE OF THE EXTERIOR WALLS.

- THAT ALL TRIM IS IN GOOD CONDITION, ALLOWING NO ACCESS TO ALL PENETRATIONS IN THE RATED WALLS SHALL BE SEALED
- WITH A MATERIAL CAPABLE OF PREVENTING THE PASSAGE OF FLAMES AND HOT GASSES. THE SEALANT SHALL HAVE A T-RATING OF ONE HOUR.
- . PROVIDE A SEPARATE EQUIPMENT GROUNDING CONDUCTOR (SIZE PER NEC) IN PVC TYPE CONDUIT, POWER CIRCUITS, ISOLATED GROUND CIRCUITS, OR AS SHOWN ON PLANS. CONDUIT SHALL BE SIZED PER NEC BASED ON THWN 600 VOLT COPPER SINGLE CONDUCTORS, PLUS THE EQUIPMENT GROUNDING CONDUCTOR.
- WIRING DEVICES: DEVICE MOUNTING HEIGHTS ARE FROM FINISHED FLOOR TO CENTER OF OUTLET BOX UNLESS NOTED OTHERWISE ON PLANS. COORDINATE THE STANDARD MOUNTING HEIGHTS WITH MASONRY:
- A. SWITCHES +44" B. RECEPTACLES +20"
- C. VOICE/DATA +20"
- . WIRING SHALL INCLUDE FINAL CONNECTION TO ALL EQUIPMENT IN CONFORMANCE WITH EQUIPMENT SUPPLIER WIRING DIAGRAMS.
- 5. CONTRACTOR IS RESPONSIBLE FOR PROVIDING COMPLETE PANELBOARD IDENTIFICATION SCHEDULES FOR PANELBOARDS AFFECTED BY REMODEL.
- NEW OVERCURRENT PROTECTIVE DEVICES INSTALLED IN EXISTING PANELBOARDS OR DISTRIBUTION BOARDS SHALL MATCH THE TYPE AND AIC RATING OF EXISTING OVERCURRENT PROTECTIVE DEVICES.
- B. BRANCH CIRCUIT CONDUCTORS SHALL BE MINIMUM #12 AWG UNLESS NOTED OTHERWISE IN SCHEDULES. WHERE 20A BRANCH CIRCUITS HAVE #8 AND LARGER WIRE SPECIFIED, #10 AWG WIRE SHALL BE USED FOR THE FINAL CONNECTION (15-FT MAXIMUM).
- . WHERE BRANCH CIRCUITS ARE GROUPED, SIZE CONDUIT AND DERATE CURRENT CARRYING CONDUCTORS PER NEC.
- EXISTING ELECTRICAL DEMOLITION:

CONDENSER

NEMA 3R,

26.440

NEMA 3R, 26.440

TO ICE MAKER BELOW, TYP.

ICE MAKER CONDENSER

ICE MAKER o CONDENSER (ROOF)

K-93A

(ROOF)

REMOVE OR RELOCATE EXISTING ELECTRICAL EQUIPMENT CONDUIT, AND CONDUCTORS AS INDICATED ON THE DRAWINGS, OR ONLY AS REQUIRED BY DEMOLITION. REMOVE ALL PANELBOARDS, DISCONNECT SWITCHES, BOXES, RELAYS, TIME SWITCHES, LIGHTS, DEVICES, ETC., WHICH WILL NOT BE REUSED.

## **KEYNOTES**

- 26.131 CONNECT TO EXISTING CIRCUIT. E.C SHALL VERIFY PRIOR TO ROUGH-IN THAT EXISTING CIRCUIT HAS SPARE CAPACITY TO ACCOMMODATE ADDITIONAL LOAD.
- 26.145 CONNECT TO EXISTING BRANCH CIRCUIT. VERIFY PRIOR TO ROUGH-IN THAT EXISTING CIRCUIT HAS CAPACITY TO ACCOMMODATE NEW LOAD. VERIFY CONDITION OF BRANCH CIRCUIT, CONDUIT, AND WIRE PRIOR TO USE TO INSURE THAT THEY MEET ALL U.L. RATINGS AND REPLACE AS REQUIRED.
- 26.400 PROVIDE ALL INTERLOCK BETWEEN EVAPORATOR AND CONDENSER FOR A COMPLETE AND OPERATIONAL SYSTEM AS REQUIRED.
- 26.407 EQUIPMENT DISCONNECT SWITCHES SHALL BE SUPPLIED AND PREWIRED FOR CONNECTION TO COOLER/FREEZER/STORAGE PACKAGE. ELECTRICAL CONTRACTOR SHALL MAKE ALL FINAL CONNECTIONS.
- 26.430 WRAP CONDENSATE LINES WITH HEAT TAPE AND PROVIDE 120V CONNECTION. REFER TO HEAT TAPE MANUFACTURER.
- 26.431 J-BOX FOR CONNECTION TO DOOR HEAT TRACE. BOX LOCATION SHALL NOT INTERFERE WITH DOOR OPERATION. FINAL CONNECTION TO HEAT TRACE SHALL BE BY OTHERS.
- 26.432 PROVIDE CONTROL CIRCUIT AND 3/4"" CONDUIT TO CONDENSING UNIT ON ROOF.
- 26.433 ALL CONDUIT AND WIRE FOR WALK-INS SHALL BE DONE OUTSIDE OF WALK-INS AND ALL PENETRATIONS SHALL BE SEALED PER THE
- 26.434 E.C. SHALL PROVIDE (2)#12 AND (1)#12 GROUND IN 1/2" CONDUIT FOR 208V/1P ELECTRIC

DEFROST CIRCUIT FROM CONDENSING UNIT.

- 26.436 PROVIDE CIRCUITRY FOR ELECTRIC DEFROST FROM CONDENSING UNIT TO FREEZER EVAPORATORS. REF ENLARGED POWER PLAN FOR CIRCUIT REQUIREMENTS.
- 26.440 REFER TO MANUFACTURERS REQUIREMENTS FOR ICE MACHINE WIRING. CONNECT TO INTERIOR EQUIPMENT.
- 26.470 FURNISH AND INSTALL NEW 20 AMP, 120 VOLT CIRCUIT(S). FEED FROM PANELBOARD AS INDICATED. PROVIDE 20A-1P CIRCUIT BREAKER, IF NEEDED. E.C. SHALL MATCH TYPE AND AIC RATINGS OF EXISTING CIRCUIT BREAKERS. E.C. SHALL VERIFY PRIOR TO ROUGH-IN THAT EXISTING PANELBOARD HAS SPARE CAPACITY TO ACCOMMODATE ADDITIONAL LOAD.
- 26.472 FURNISH AND INSTALL NEW CIRCUIT BREAKER (##A-#P) IN EXISTING PANEL INDICATED. E.C. SHALL MATCH TYPE AND AIC RATINGS OF EXISTING CIRCUIT BREAKERS. E.C. SHALL VERIFY PRIOR TO ROUGH-IN THAT EXISTING PANELBOARD HAS SPARE CAPACITY TO ACCOMMODATE ADDITIONAL LOAD.
- 26.489 RELOCATE, EXTEND, AND RECONNECT CIRCUITRY AND ELECTRICAL DEVICES FOR RELOCATED AND/OR NEW EQUIPMENT. VERIFY CONDITION OF BRANCH CIRCUITRY, CONDUIT AND WIRE TO ENSURE THEY MEET ALL U.L. RATINGS AND REPLACE AS REQUIRED. VERIFY FINAL LOCATION OF RELOCATED/NEW **EQUIPMENT WITH CONSTRUCTION MANAGER** PRIOR TO ROUGH-IN.
- 26.492 E.C. SHALL COORDINATE WITH GENERAL CONTRACTOR AND ARCHITECTURAL DEMOLITION PLANS THE EXTENT OF ELECTRICAL DEMOLITION. REMOVE CONDUITS AND WIRES ALL THE WAY BACK TO ORIGINATING JUNCTION BOXES OR PANELBOARDS. DEMOLITION SHALL NOT AFFECT ACTIVE CIRCUITS. LABEL DEMOLISHED CIRCUIT(S) IN PANELBOARDS AS "SPARE". COORDINATE EXACT REQUIREMENTS WITH EXISTING CONDITIONS PRIOR TO BID.



2809 Aax Avenue Suite 100 Rogers Arkansas 72758 Phone: 479.636.3545


Fix: 479.636.1209 Engineer of Record Keith Allen Williams, P.E. Florida License No. 64983 CO/License No. 26880

THIS USE CITY ITS ITS ITS IT IS ANO SERV SERV SERV AUTH

SSF 0 4 H B



ICCLIE	DIOOK							
ISSUE	BLOCK							
$\sqrt{1}$	05&1/2020	PR 2						

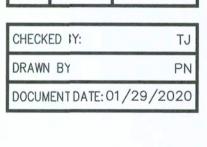



**POWER** PLAN

EXISTING CONDITIONS WERE TAKEN FROM ORIGINAL DRAWINGS AND MAY NOT REFLECT EXACT "AS-BUILT" CONDITIONS. CONTRACTOR SHALL FIELD VERIFY ALL EXISTING CONDITIONS PRIOR TO SUBMITTING FINAL BIDS. CONTRACTOR SHALL CAREFULLY COORDINATE NEW WORK AND DEMOLITION WITH ALL OTHER DISCIPLINES AND EXISTING CONDITIONS. TYPICAL OF ALL ELECTRICAL

EACH SUBCONTRACTOR IS RESPONSIBLE FOR HAVING A THOROUGH KNOWLEDGE OF ALL DRAWINGS AND


SPECIFICATIONS IN THEIR RELATED FIELD. THE FAILURE TO ACQUAINT THEMSELVES WITH THIS KNOWLEDGE DOES

NOT RELIEVE THE RESPONSIBILITY OF PERFORMING THE

OCCUR DUE TO FAILURE TO FAMILIARIZE WORKERS WITH THIS KNOWLEDGE. TYPICAL OF ALL ELECTRICAL SHEETS.

WORK PROPERLY. NO ADDITIONAL COMPENSATION SHALL BE ALLOWED BECAUSE OF CONDITIONS THAT

SHEET:

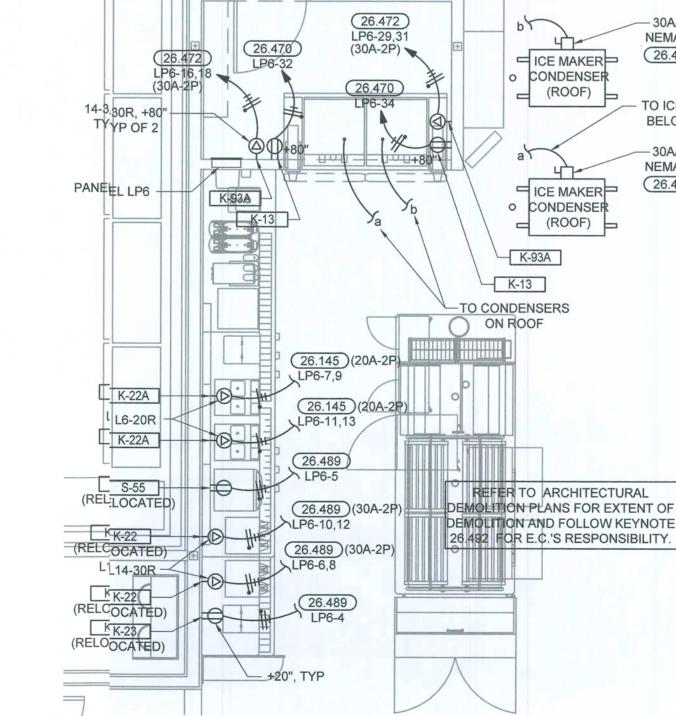

DRINK CENTER POWER PLAN

1/4" = 1'-0"

(SYMBOLS AF	PPLY ONLY WHEN USED ON DRAWINGS)  DESCRIPTION
H⊗ / ⊗	EXIT FIXTURE
	(WALL MOUNTED/CEILING MOUNTED) EMERGENCY FIXTURE
₩	
\$	SWITCH, SINGLE POLE
\$3	SWITCH, 3-WAY
\$4	SWITCH, 4-WAY
\$K	SWITCH, KEYED
\$D	SWITCH, DIMMER
\$vs	
	SWITCH, VARIABLE SPEED
\$М	SWITCH, MANUAL MOTOR
OS 1	ULTRASONIC WALL SWITCH OCC. SENSOR, MANUAL ON, AUTO OFF
OS 2	PIR DIMMER WALL SWITCH OCC. SENSOR, MANUAL ON, AUTO OFF
(OS)3	ULTRASONIC CEILING OCC. SENSOR
OS 4	DUAL-TECH WALL SWITCH OCC.
	SENSOR, MANUAL ON, AUTO OFF ULTRASONIC, LOW TEMPERATURE
<u>(S)</u> 7	CEILING OCC. SENSOR
P	POWER PACK
Ψ	RECEPTACLE, DUPLEX
0=	RECEPTACLE, DUPLEX, MOUNTED HORIZONTALLY
	RECEPTACLE, DUPLEX FLUSH FLOOR
	RECEPTACLE, DUPLEX ISOLATED
#	GROUND FLUSH FLOOR
	RECEPTACLE, DOUBLE DUPLEX RECEPTACLE, DUPLEX
Ψ	ISOLATED GROUND
**	RECEPTACLE, DOUBLE DUPLEX, ISOLATED GROUND
Φ	RECEPTACLE, SIMPLEX TWIST LOCK, L5-15R, UNO
•	RECEPTACLE, SIMPLEX TWIST LOCK, ISOLATED GROUND, L5-15R, UNO
<b>@</b>	RECEPTACLE, DUPLEX TWIST LOCK,
(P)	L5-15R, UNO RECEPTACLE, DUPLEX TWIST LOCK,
	ISOLATED GROUND, L5-15R, UNO
-🗆	RECEPTACLE, SPECIAL
Φ	RECEPTACLE, SIMPLEX
STATE WAS	RECEPTACLE, PLUG-MOLD
<b>(J)</b>	JUNCTION BOX (WALL MOUNTED/CEILING MOUNTED)
A	ALARM JUNCTION BOX,
	(WALL MOUNTED/CEILING MOUNTED) ALARM JUNCTION BOX,
®	FOR REMOTE TEST/RESET (WALL MOUNTED/CEILING MOUNTED)
	EQUIPMENT CONNECTION POINT
마	(PROVIDED WITH EQUIPMENT)  NON-FUSED DISCONNECT
Øı	FUSED DISCONNECT
	UNDERGROUND CONDUIT RUN
	LOW VOLTAGE CIRCUITRY
	CIRCUIT, CONCEALED
-	CIRCUIT, EXPOSED
Н	CONDUIT SLEEVE
	FLUSH MOUNTED PANELBOARD
	SURFACE MOUNTED PANELBOARD
•	VOICE / DATA BOX
$\nabla$	LOW VOLTAGE CABLE BOX FOR OTHER
	VOICE / DATA, FLUSH FLOOR
<i>N</i>	MOTOR
O	TELEPOWER POLE
•	PUSH BUTTON
	BUZZER
<b>(a)</b>	SMOKE DETECTOR
	HORN / STROBE
*******	
DH	DOOR HOLD OPEN
\$Т	HBA DIGITAL TIMER SWITCH - TD200
CF	CONDENSER FANS

5/22/2020 12:29 (2019.0328 0724 ell

**PANELBOARD** 208/120V, 3PH, 4V **EXISTING** 225A, M.L.O SERVES: GENERAL POWER OCATION: FOUNTAIN ROOM DESCRIPTION WIRE BRKR PL L BRKR WIRE DESCRIPTION slushi machine (11) creamer dispenser (11) ice tea machine (11) CREAMER DISPENSER (4,11) S-55 CAPPUCHINO MACHINE (4,11) 0 K-22 COFFEE BREWER (11) 1.60 2.55 K-22A BEAN TO CUP MACHINE (11) 30 | 10 | K-22 COFFEE BREWER (11) 1 K-22A BEAN TO CUP MACHINE (11) 15 hot dog grill (11) 10 K-93A POST ICE MAKER 7 hot dog grill (11) 9 microwave (11) microwave (11) food prep table (11) 23 hot dog grill (11) warming drawer (11) hot dog grill (11) warming drawer (11) 27 food warmer (11) chili cheese dispenser (11) 29 K-93A POST ICE MAKER 2.07 0.48 hot dog bar (11) K-13 POP ICE DISPENSER (4) 31 33 PREP TABLE 0.72 0.62 K-13 POP ICE DISPENSER (4) 7 space 39 space 0.00 16.30 - EXISTING KVA LOAD INFORMATION BASED 135.83 125.57 OFF OF ASBUILT DRAWINGS. AMPS TOTAL LOAD 45.24 81.62 PER NEC ARTICLE 220: FEEDER LOAD 29.40

PANELBOARD EXISTING

	DES/accommon						K\	VA			-	DELCE			
	DES(SCRIPTION	WIRE	BRKR	PL		A		В			PL	BRKR	WIRE	DESCRIPTION	
	ghting - cashier office (; (11)		20	1	0.98	0.84					1	20		rec sales shelving (11)	
1	ghting - vaulted ceiling g (11)		20	1			1.23	1.08			1	20		rec back stock (11)	
	ghting - main retail (11) <sub>1)</sub>		20	1					1.14	0.35	1	20		rec mech, showers (11)	
	ghting - truck retail (11) <sub>1)</sub>		20	1	1.11	1.08					1	20		rec showers, fans (11)	Ī
	ghting - electrical room <sub>m (11)</sub>		20	1			0.74	0.18	1		1	20		paper towel dispenser (11)	
į	f - 4/spare room (11)		20	1					0.60	1.08	1	20		rec showers (11)	
١	IEN'S RR/ STORAGE/E/COOLER/FRZER LTS (11)		20	1	1.44	1.00					1	20		cooler (11)	_
1	ec shower fans (11)		20	1			1.26	0.18			1	20		rec. (11)	
	ec generator (11)		20	1					0.18	0.18	1	20		printer (11)	
!	enerator block heater ( <sub>r (11)</sub>		40	2	0.75	0.72					1	20		rec. (11)	Ī
							0.75	0.36			1	20		floor boxes - truck retail (11)	
-	pare		20	1					0.00	1.08	1	20		rec sales shelving (11)	
	pare		20	1	0.00	0.72					1	20		rec auto side soffit (11)	
	ec diesel farm tanker er htr. (11)		20	1			1.20	0.98			1	20		ice merch. (11)	
_	pare		20	1					0.00	0.00	1	20		floor boxes - auto retail (11)	
	ec outside elec. room <sub>m (11)</sub>		20	1	0.36	0.72					1	20		rec truck side soffit (11)	
I	u - spare circuit (11)		20	1			0.18	0.12			1	20		ef - 2 (11)	
_	u - rec. (11)		20	1					0.72	0.12	1	20		ef - 1 (11)	
	pare		20	1	0.00	1.44					1	20		rec. (11)	_
	pare		40	2			0.00	1.08			1	20		rec. (11)	
_									0.00	0.60	1	20		water softner (11)	
	pare		20	1	0.00	0.32					1	20		EP-2 - COOLER EVAPORATOR (15)	-
I	ropane pumps (11)		20	2			1.37	0.96			1	20		FREEZER/COOLER DOOR HTR/HEAT TAPE (5)	
									1.37	0.62	1	20		yard building (11)	
*	pare		20	1	0.00	1.08					1	20		rec sales shelving (11)	-
*	pare		20	1			0.00	0.72			1	20		rec sales shelving (11)	
1	pare		20	1					0.00	0.90	1	20		rec car canopy (11)	
1	pare		20	1	0.00	0.72					1	20		rec. truck canopy (11)	
1	pare		20	1			0.00	0.12			1	20		rec. truck sales shelving (11)	
1	pare		20	1					0.00	1.50	1	20		spare circuit w/tanker htr. (11)	
	ec. (11)		20	1	0.18	0.90					1	20		rec. laundry/fuel desk (11)	-
,	erchandiser freezer (1:44)		20	1			0.00	0.60			1	20		lighting - cooler (11)	
0	poler door heaters (11)		20	1					1.50	0.18	1	20		rec front shelving (11)	
1	erchandiser refrigerato <sub>tor (11)</sub>		20	1	0.97	0.54					1	20		rec front shelving (11)	-
E	P-1 - FREEZER EVAP PORATOR (15)		20	2			0.20	0.06			1	20		ef - 3 (11)	
L									0.20	0.00	1	20		spare	
ł	and dryer women's rr (1(11)		20	1	1.50	0.00	T				1	20		spare	-
ŀ	and dryer women's rr (1 <sub>(11)</sub>		20	1			1.50	0.70			1	20		cash / coin recycler (11)	
	and dryer men's rr (11) <sub>1</sub> )		20	1				3.1.0	1.50	0.38	1	20		ice merchandiser rear (11)	
	and dryer men's rr (11) <sub>1)</sub>		20	1	1.50	1.20				3.00	1	20		air compressor - self-service (11)	-
	ico equipment (11)		20	1			1.20	1.20			1	20		price sign - front spare (11)	
	co equipment (11)		20	1			1.20	1.20	1.20	1.20	1	20			
	co equipment (11)		20	1	1.20	0.72				7.20	1	20		price sign - front (11)	-
	c. (11)		20	1		0.12	0.54	0.72			1	20		rec game rm. (11)	
	e merchandiser front (1 <sub>(11)</sub>		20	1			0.04	5.12	0.96	0.00		20		rec game rm. (11) spare	
	re pass equipment (11) <sub>1)</sub>		20	1	0.54	3.12			0.00	0.00	3	50			-
	re pass equipment (11) <sub>1)</sub>		20	1	0.07	0.12	0.54	3.12			"	50		oven (11)	
	ash bill recycler (11)		20	1			0.04	0.12	0.00	3.12					
$\overline{}$	xisting load (11)		20	2	1.20	2.38	1		5.00	0.12	2	30		existing lead (11)	-
			20	-	1.20	2.00	1.20	2.38			2	30		existing load (11)	
(	U-1 - FREEZER CONCIDENSER	10	30	3			1.2.0	2.00	3.48	1.80	3	20		CU-2 - COOLER CONDENSER	
	- IDENOLIN	10	50	-	3.48	1.80			5.40	1.00	3	20		00-2 - GOOLER CONDENSER	-
				-	0.40	1.00	3.48	1.80							
S	pace						0.40	1.00	0.00	0.00	1			space	
-	'a			-	0.00	14.55			0.00	0.00	3	150			-
	a			-	0.00	14.00	0.00	14.39			3	150		panel lp6 (11)	
	a						0.00	14.38	0.00	16.30	1				
-			TO	TAI	49.	06	46.	14	42.		KVA		_		-
			10	IAL	49.				42.	20	TVA				
					400	70	004	47	0.50	17	ABAR	20		EMOTING IA	
		,	TOTAL LO	)AD	408 137		KVA 384	.47	352 381		AMF			- EXISTING KVA LOAD INFORMATION BASED OFF OF ASBUILT DRAWINGS.	

PANELBOARD NOTES ()

(1) TERMINATE GROUND ON ISOLATED GROUND BUS.

(2) INSTALL LOCKING DEVICE (LOCK-OFF FOR MAINTENANCE).

LOCKING DEVICE SHALL BE UL LISTED. MANUFACTURER

SHALL MATCH EXISTING PANELBOARD MANUFACTURER

INSTALL LOCKING DEVICE (LOCK-ON FOR CRITICAL LOAD).

GFI BREAKER FOR PERSONNEL PROTECTION (5mA).

) GFI BREAKER FOR EQUIPMENT PROTECTION (30mA)
) CONDUCTOR SIZE HAS BEEN INCREASED FOR VOLTAGE DROP. SIZE EQUIPMENT GROUNDING CONDUCTOR

PROPORTIONATELY PER NEC.
REFER TO ONE-LINE DIAGRAM FOR AVAILABLE FAULT
CURRENT FOR INTERRUPT RATINGS.

REFER TO ONE-LINE DIAGRAM FOR WIRE SIZES.

(9) FACTORY WIRED TO LOAD.

208/120V, 3PH, 4V

400A, M.L.O

BREAKER SHALL BE HIGH MAGNETIC TYPE.

(11) EXISTING CIRCUIT TO REMAIN.(12) ROUTE CIRCUIT THROUGH CONTACTOR

 PROVIDE INTERLOCK WIRING WITH EXHAUST HOOD ANSUL SYSTEM.

HACR CIRCUIT BREAKER.

EXISTING CIRCUIT BREAKER TO REMAIN. VERIFY CONDITION OF CIRCUIT BREAKER TO ENSURE THAT IT IS OPERATIONAL AND MEETS ALL U.L. RATINGS.

TRACE EXISITING CIRCUIT, IDENTIFY LOAD AND PROVIDE COMPLETE TYPEWRITTEN PANELBOARD IDENTIFICATION SCHEDULE AND PLACE ON INTERIOR OF PANELBOARD DOOR. IF CIRCUIT IS A "SPARE" THEN REFER TO PANELBOARD NOTE (21).

(17) PROVIDE BLANK CIRCUIT BREAKER FILLER PLATE FOR EXPOSED SPACE IN PANELBOARD.

GENERAL NOTES:

ENERAL NOTES:

E.C. SHALL ADD OR REARRANGE CIRCUIT BREAKERS WITHIN PANELBOARDS AS REQUIRED TO MATCH NEW CIRCUIT DESIGNATIONS SHOWN ON DRAWINGS.

 NEW OVERCURRENT PROTECTIVE DEVICES PLACED IN EXISTING PANELBOARDS OR DISTRIBUTION BOARDS SHALL MATCH THE TYPE AND AIC RATING OF EXISTING OVERCURRENT PROTECTION DEVICES IN SAID BOARD.
 E.C. SHALL TRACE ALL ELECTRICAL CIRCUITS FOR ALL EXISTING ELECTRICAL PANELBOARDS AFFECTED BY THE REMODEL AND

IDENTIFY LOADS ON EACH CIRCUIT. PROVIDE A COMPLETE

TYPEWRITTEN PANELBOARD IDENTIFICATION SCHEDULE FOR ALL AFFECTED PANELBOARDS.

4. ALL OVERCURRENT DEVICES ARE NEW UNLESS NOTED OTHERWISE.

#### 20A WIRE SIZING SCHEDULE

ALL WIRE SIZES SHOWN ON PANEL SCHEDULES ARE INTENDED TO BE MINIMUM ACCEPTABLE WIRE SIZE.

THE FOLLOWING SCHEDULE IS TO BE USED TO SIZE WIRE FOR 20 AMP CIRCUITS (120 AND 277 VOLT).

LENGTHS (IN FEET) ARE INTENDED TO BE MAXIMUM.

120 VOLT	#12	#10	#8	#6
1-5 AMPS	200 FT.	325 FT.	490 FT.	770 FT.
6-10 AMPS	100 FT.	160 FT.	245 FT.	385 FT.
11-15 AMPS	70 FT.	110 FT.	165 FT.	255 FT.
277 VOLT	#12	#10	#8	#6
1-5 AMPS	480 FT.	760 FT.	1170 FT.	1865 FT.
6-10 AMPS	240 FT.	380 FT.	585 FT.	930 FT.
11-15 AMPS	160 FT.	250 FT.	390 FT.	620 FT.

20A WIRE SIZING SCHEDULE APPLIES TO EVERY SHEET WITH PANELBOARD SCHEDULES

### GROUND WIRE SIZING CHART

BREAKER AMPACITY	WIRE		V	VIRE SIZ	ZE	
15-20	PHASE	#12	#10	#8	#6	#4
15-20	GROUND	#12	#10	#8	#6	#4
25-30	PHASE	#10	#8	#6	#4	#3
25-30	GROUND	#10	#8	#6	#4	#3
35-50	PHASE	#8	#6	#4	#3	#2
33-30	GROUND	#10	#8	#4	#4	#4
60	PHASE	#6	#4	#3	#2	#
00	GROUND	#10	#6	#6	#4	#4
70	PHASE	#6	#4	#3	#2	#
70	GROUND	#8	#4	#4	#3	#2
80-90	PHASE	#4	#3	#2	#1	#'1
00-90	GROUND	#8	#6	#4	#4	#3
100	PHASE	#3	#2	#1	#'1/0	#2
100	GROUND	#8	#6	#4	#4	#3

WIRE SIZES PER NEC 250.122 (B)

EACH SUBCONTRACTOR IS RESPONSIBLE FOR HAVING A THOROUGH KNOWLEDGE OF ALL DRAWINGS AND SPECIFICATIONS IN THEIR RELATED FIELD. THE FAILURE TO ACQUAINT THEMSELVES WITH THIS KNOWLEDGE DOES NOT RELIEVE THE RESPONSIBILITY OF PERFORMING THE WORK PROPERLY. NO ADDITIONAL COMPENSATION SHALL BE ALLOWED BECAUSE OF CONDITIONS THAT OCCUR DUE TO FAILURE TO FAMILIARIZE WORKERS WITH THIS KNOWLEDGE.

EXISTING CONDITIONS WERE TAKEN FROM ORIGINAL DRAWINGS AND MAY NOT REFLECT EXACT "AS-BUILT" CONDITIONS. CONTRACTOR SHALL FIELD VERIFY ALL EXISTING CONDITIONS PRIOR TO SUBMITTING FINAL BIDS. CONTRACTOR SHALL CAREFULLY COORDINATE NEW WORK AND DEMOLITION WITH ALL OTHER DISCIPLINES AND EXISTING CONDITIONS.



+engineering
2809 Ajax Avenue Suite 100
Roges Arkansas 72758
Phae: 479.636.3545
Fα: 479.636.1209

Engineer of Record

KeithAllen Williams, P.E.

Florida License No. 64983

COA\_icense No. 26880

STIPULATION FOR REUSE
THIS DRAWING WAS PREPARED FOR USE ON A SPECIFIC SITE AT LAKE CITY, FL CONTEMPORANEOUSLY WITH ITS ISSUE UNTERPORTED FOR USE ON A DIFFERENT PROJECT SITE OR AT A LATER TIME. USE OF THIS DRAWING FOR REFERENCE OR EXAMPLE ON ANOTHER PROJECT REQUIRES THE SERVICES OF PROPERLY LICENSED ARCHITECTS AND ENGINEERS.

REPRODUCTION OF THIS DRAWING FOR REUSE ON ANOTHER PROJECT IS NOT REUSE ON ANOTHER PROJECT IS NOT AUTHORIZED AND MAY BE CONTRARY

HOT TO GO REMODEL /
BUILDING EXPANSION
JOB NUMBER: 2019.0328

LOVE'S STORE # 13700 US HIGHW LAKE CITY, FL 3



SUE	BLOCK	
	05/21/2020	PR 2

CHECKED BY: TJ

DRAWN BY: PN

DOCUMENT DATE: 01/29/2020



ELECTRICAL DETAILS AND SCHEDULES

SHEET:

E3