- 1.1. THESE STRUCTURAL DRAWINGS HAVE BEEN PREPARED IN ACCORDANCE WITH THE FLORIDA BUILDING CODE. ALL CONSTRUCTION SHALL CONFORM TO THE EDITION OF THE BUILDING CODE REFERENCED. REFERENCE TO OTHER SPECIFICATIONS OR CODES SHALL MEAN THE VERSION INDICATED IN THE BUILDING CODE.
- 1.2. THE STRUCTURAL DRAWINGS AND SPECIFICATIONS ARE A PORTION OF THE CONSTRUCTION DOCUMENTS. THE CONTRACTOR AND SUBCONTRACTORS SHALL REFERENCE AND COORDINATE WITH ALL OTHER DISCIPLINES DRAWINGS. ANY DISCREPANCIES OR OMISSIONS SHALL BE REPORTED TO THE ARCHITECT/ENGINEER.
- THE CONTRACTOR SHALL VERIFY SITE CONDITIONS AND COORDINATE STRUCTURAL DIMENSIONS, ELEVATIONS AND SECTIONS WITH ARCHITECTURAL DIMENSIONS ELEVATIONS, AND SECTIONS AND REPORT ANY DISCREPANCY TO THE ARCHITECT/ENGINEER PRIOR TO THE FABRICATION OR INSTALLATION OF STRUCTURAL MEMBERS.
- 1.4. STRUCTURAL DRAWINGS SHOW TYPICAL AND CERTAIN SPECIFIC CONDITIONS ONLY AND SHALL APPLY FOR LIKE OR SIMILAR CONDITIONS UNLESS NOTED OTHERWISE. FOR CONDITIONS NOT SPECIFICALLY SHOWN, PROVIDE DETAILS SIMILAR TO THOSE SHOWN. IF THERE IS A QUESTION REGARDING THE APPLICABILITY OF A DETAIL, CONTACT THE ARCHITECT/ENGINEER IN WRITING REQUESTING CLARIFICATION.
- COORDINATE AND VERIFY ALL OPENING SIZES AND LOCATIONS WITH ARCHITECTURAL, MECHANICAL, PLUMBING, AND/OR ELECTRICAL DRAWINGS BEFORE PROCEEDING WITH CONSTRUCTION. STRUCTURAL DRAWINGS ONLY SHOW OPENINGS RELATIVE TO THE STRUCTURE
- 1.6. COORDINATE ALL LIMITS AND DEPTHS OF DEPRESSIONS FOR FLOOR FINISHES WITH ARCHITECTURAL DRAWINGS AND SCHEDULES. LIMITS SHOWN ON STRUCTURAL DRAWINGS ARE SCHEMATIC. COORDINATE FLOOR JOINTS WITH ARCHITECTURAL FLOOR FINISHES.
- STRUCTURAL MEMBERS SHALL NOT BE CUT, NOTCHED, CHANGED, OR MODIFIED WITHOUT THE WRITTEN APPROVAL OF THE STRUCTURAL ENGINEER OF RECORD. DO NOT SCALE FOR DIMENSIONS NOT SHOWN ON THE DRAWINGS. SEND A WRITTEN
- REQUEST FOR INFORMATION TO THE ARCHITECT/ENGINEER FOR DIMENSIONS NOT PROVIDED
- THE STRUCTURAL DRAWINGS AND SPECIFICATIONS REPRESENT THE FINISHED STRUCTURE. UNLESS OTHERWISE INDICATED, THEY DO NOT INDICATE THE METHOD OF CONSTRUCTION. CONTRACTOR IS RESPONSIBLE FOR THE MEANS, METHODS, TECHNIQUES, SEQUENCES, AND PROCEDURES OF CONSTRUCTION.
- 1.10. THE STRUCTURE SHOWN ON THESE DRAWINGS IS STRUCTURALLY SOUND ONLY IN ITS COMPLETED FORM. THE CONTRACTOR IS SOLELY RESPONSIBLE FOR THE DESIGN, ADEQUACY, AND SAFETY OF ERECTION BRACING, SHORING, TEMPORARY SUPPORTS, ETC. THE ENGINEER WILL NOT ADVISE ON OR ISSUE DIRECTION RELATED TO SAFETY REQUIREMENTS. IT IS THE CONTRACTOR'S RESPONSIBILITY TO FOLLOW ALL APPLICABLE OSHA REGULATIONS
- 1.11. CONSTRUCTION MATERIALS SHALL BE SPREAD OUT IF PLACED ON FRAMED FLOORS/ROOFS. IT IS THE CONTRACTOR'S RESPONSIBILITY TO ENSURE THAT CONSTRUCTION LOADS DO NOT EXCEED THE DESIGN LIVE LOAD.
- 1.12. WHERE SPECIFIED, POST INSTALLED ANCHORING SYSTEMS SUCH AS MANUFACTURED BY SIMPSON OR HILTI, SHALL BE INSTALLED IN STRICT ACCORDANCE WITH MANUFACTURER'S WRITTEN INSTRUCTIONS. SPECIAL ATTENTION SHALL BE GIVEN TO THE DRILLING, CLEANING, AND PREPARATION OF HOLES. WHERE ADHESIVE ANCHORS ARE SHOWN, SPECIAL ATTENTION SHALL BE GIVEN TO THE REQUIRED MIXING, APPLICATION, AND CURING TIME OF THE ADHESIVE SPECIFIED.
- 1.13. THE CONTRACTOR IS RESPONSIBLE FOR LOCATING ALL UNDERGROUND UTILITIES IN THE AREA OF CONSTRUCTION THAT MIGHT BE AFFECTED BY, OR OTHERWISE INTERFERE WITH, INSTALLATION OF NEW WORK. THIS INCLUDES THOSE THAT MIGHT BE DAMAGED BY NEW FOUNDATIONS OR OTHER WORK, AND THOSE WHOSE PRESENCE MIGHT LEAD DAMAGE TO THE NEW WORK (e.g. DIFFERENTIAL SETTLEMENT).

DESIGN CRITERIA:

2.1. GENERAL BUILDING CODE:

FLORIDA BUILDING CODE, FBC 2020, 7TH EDITION. ALL CODES BELOW ARE THE EDITION REFERENCED IN THE CODE.

2.2. DESIGN LOAD CRITERIA

MINIMUM DESIGN LOADS FOR BUILDINGS AND OTHER STRUCTURES, AMERICAN SOCIETY OF CIVIL ENGINEERS, ASCE 7.

2.3. CONCRETE

BUILDING CODE REQUIREMENTS FOR STRUCTURAL CONCRETE, AMERICAN CONCRETE INSTITUTE, ACI 318.

SPECIFICATION FOR STRUCTURAL STEEL BUILDINGS, AMERICAN INSTITUTE OF STEEL CONSTRUCTION, AISC 360.

2.5. STEEL DECK:

STEEL DECK INSTITUTE, DESIGN MANUAL FOR COMPOSITE DECKS, FORM DECKS, ROOF DECKS AND CELLULAR METAL FLOOR DECK WITH ELECTRICAL DISTRIBUTION,

2.6. COLD-FORMED METAL FRAMING:

NORTH AMERICAN SPECIFICATION FOR DESIGN OF COLD-FORMED STEEL STRUCTURAL MEMBERS, AMERICAN IRON AND STEEL INSTITUTE, AISI 100. MASONRY

BUILDING CODE REQUIREMENTS AND SPECIFICATION FOR MASONRY STRUCTURES, AMERICAN CONCRETE INSTITUTE, ACI 530/530.1.

DESIGN LOADS

DESIGN DEAD LOAD IS ACTUAL WEIGHT OF THE STRUCTURE. ANY CHANGES IN CONSTRUCTION MATERIALS FROM THOSE SHOWN ON THE ARCHITECTURAL OR STRUCTURAL DRAWINGS SHALL BE REPORTED BY THE CONTRACTOR TO THE STRUCTURAL ENGINEER FOR VERIFICATION OF LOAD-CARRYING CAPACITY OF THE STRUCTURE.

3.2. LIVE LOADS (PSF):

CONCRETE SLABS LIVE LOAD REDUCTIONS HAVE BEEN APPLIED IN ACCORDANCE WITH THE BUILDING CODE

WHEN PERMITTED. 3.4. SNOW LOADS (PSF):

GROUND SNOW LOAD (Pg)

3.5. WIND LOADS: DESIGN WIND SPEED (V) ALLOWABLE WIND SPEED (Vasd) 123 MPH RISK CATEGORY EXPOSURE CATEGORY PRESSURE COEFFICIENT (WASH BLDG)

PRESSURE COEFFICIENT (VAC CANOPY) SEE DRAWINGS FOR EXTERIOR COMPONENT AND CLADDING WIND PRESSURES.

3.7. SEISMIC LOADS:

RISK CATEGORY IMPORTANCE FACTOR (Ie)

MAPPED SPECTRAL RESPONSE ACCELERATIONS:

 $S_S = 0.298$ S1 = 0.099

DESIGN SPECTRAL RESPONSE ACCELERATIONS:

Sds = 0.310Sd1 = 0.158

SEISMIC DESIGN CATEGORY SEISMIC RESPONSE COEFFICIENT (Cs) RESPONSE MODIFICATION FACTOR (R)

DESIGN BASE SHEAR

3.8. ANALYSIS PROCEDURE: EQUIVALENT LATERAL FORCE METHOD

3.9. BASIC SEISMIC-FORCE-RESISTING SYSTEM: STRUCTURAL STEEL SYSTEMS NOT

SPECIFICALLY DETAILED FOR SEISMIC RESISTANCE

SHOP DRAWINGS AND SUBMITTALS:

- 4.1. THE USE OR REPRODUCTION OF THE CONTRACT DRAWINGS BY ANY CONTRACTOR, SUBCONTRACTOR, OR MATERIAL SUPPLIER IN LIEU OF PREPARATION OF SHOP DRAWINGS IS
- 4.2. SHOP DRAWINGS SHALL DETAIL ALL CONDITIONS IN ACCORDANCE WITH SPECIFIED STANDARDS AND THE SPECIFIC REQUIREMENTS OF THIS PROJECT AS INDICATED ON THE
- THE CONTRACTOR REMAINS SOLELY RESPONSIBLE FOR ERRORS AND OMISSIONS ASSOCIATED WITH THE PREPARATION OF SHOP DRAWINGS AS SPECIFIED IN THE CONTRACT DOCUMENTS. ALL SHOP DRAWINGS MUST BE REVIEWED AND "APPROVED" BY THE CONTRACTOR PRIOR TO SUBMITTAL TO THE STRUCTURAL ENGINEER. REVIEW OF SHOP DRAWINGS AND OTHER SUBMITTALS BY THE STRUCTURAL ENGINEER DOES NOT RELIEVE THE CONTRACTOR OF THEIR RESPONSIBILITIES.
- SHOP DRAWINGS AND CALCULATIONS SUBMITTED AS PART OF A DELEGATED DESIGN SHALL BE SIGNED AND SEALED BY A LICENSED ENGINEER IN THE STATE OF THE PROJECT.
- HARDCOPY SHOP DRAWING SUBMITTALS: SUBMIT ALL SHOP DRAWINGS ON THREE PRINTS ONLY. ONE PRINT WILL BE RETURNED TO THE CONTRACTOR. ALL PRINTS REOUIRED BY THE CONTRACTOR ARE THE RESPONSIBILITY OF THE CONTRACTOR AND SHALL BE MADE AFTER APPROVED SHOP DRAWINGS ARE RETURNED. IF ADDITIONAL PRINTS ARE SUBMITTED, THEY WILL BE RETURNED UNMARKED.
- ELECTRONIC SHOP DRAWING SUBMITTALS: SUBMIT ALL ELECTRONIC SHOP DRAWINGS IN PDF FORMAT. REVIEWED SHOP DRAWINGS WILL BE RETURNED IN PDF FORMAT. ALL PRINTS REQUIRED BY THE CONTRACTOR ARE THE RESPONSIBILITY OF THE CONTRACTOR AND SHALL BE MADE AFTER APPROVED SHOP DRAWINGS ARE RETURNED.
- RESUBMITTED SHOP DRAWINGS: RESUBMITTED SHOP DRAWINGS SHALL HAVE ALL CHANGES SINCE THE PREVIOUS SUBMISSION IDENTIFIED BY CLOUDING OR OTHER CLEAR COMMUNICATION. RE-REVIEWED SHOP DRAWINGS WILL ONLY BE REVIEWED FOR IDENTIFIED CHANGES.
- SHOP DRAWINGS: SEE THE RELATED MATERIAL SECTION FOR THE REQUIRED SUBMITTALS AND SHOP DRAWINGS.

5. SOILS, SLABS, WALLS, AND SHALLOW FOUNDATIONS:

UNLESS NOTED OTHERWISE

- 5.1. THE FOUNDATION AND SLAB ON GRADE DESIGN IS BASED ON CRITERIA ESTABLISHED IN THE GEOTECHNICAL REPORT BY ECS FLORIDA, LLC TITLED "GEOTECHNICAL ENGINEERING REPORT, TIDAL WAVE, LAKE CITY, FL, PROJECT NO. 35:32386, DATED JANUARY 7, 2022". THE CONTRACTOR SHALL OBTAIN A COPY OF THE GEOTECHNICAL REPORT FROM THE OWNER AND FOLLOW ALL REQUIREMENTS AND RECOMMENDATIONS.
- MAX ALLOWABLE BEARING PER GEOTECHNICAL REPORT (PSF):
- 5.3. ALL FOUNDATION BEARING SURFACES SHALL BE REVIEWED BY THE GEOTECHNICAL ENGINEER PRIOR TO PLACING CONCRETE TO ENSURE THEIR COMPLIANCE WITH THE PRESSURES NOTED, THE REQUIREMENTS OF THE PROJECT SPECIFICATIONS, AND THE GEOTECHNICAL REPORT. SOILS DEEMED UNSUITABLE SHALL BE UNDERCUT TO COMPETENT MATERIAL, BACKFILLED WITH AN APPROVED AND PROPERLY COMPACTED MATERIAL, AND
- ALL FOOTING ELEVATIONS ARE ESTIMATED AND MAY BE ADJUSTED IN THE FIELD BY THE GEOTECHNICAL ENGINEER.
- COMPACTED FILL SHALL MEET THE REQUIREMENTS NOTED IN THE GEOTECHNICAL REPORT. WHEN EXCAVATIONS APPROACH THE GROUND WATER TABLE, THE WATER LEVEL SHALL BE
- LOWERED BY AN ACCEPTABLE DEWATERING SYSTEM SO THAT THE WATER LEVEL IS MAINTAINED CONTINUOUSLY A MINIMUM OF 2' BELOW THE EXCAVATION DURING CONSTRUCTION
- CONTRACTOR SHALL FOLLOW THE SITE WORK AND SUBGRADE RECOMMENDATIONS PROVIDED IN THE GEOTECHNICAL REPORT.
- 5.8. EARTH SUPPORTED SLAB:

SUBGRADE MODULUS

- 5.9. PROVIDE 4" COMPACTED GRANULAR FILL BENEATH ALL EARTH SUPPORTED SLABS. PROVIDE A MINIMUM 10 MIL VAPOR BARRIER BETWEEN BOTTOM OF SLAB AND TOP OF GRANULAR FILL, SEE ARCHITECTURAL DRAWINGS FOR ACTUAL THICKNESS.
- 5.10. PROVIDE ½" P.E.J FILLER AROUND PERIMETER OF SLABS WHERE THEY ABUT VERTICAL SURFACES AND AT COLUMN ISOLATION JOINTS AS DETAILED.
- SIDES OF FOUNDATIONS SHALL BE FORMED UNLESS CONDITIONS PERMIT EARTH FORMING.
- 5.12. HORIZONTAL BARS IN FOOTINGS AND STEM WALLS SHALL BE CONTINUOUS. PROVIDE
- CORNER BARS AT ALL INTERSECTIONS UNLESS NOTED OTHERWISE. SUPPORT BOTTOM REINFORCING IN FOOTINGS WITH CONCRETE BRICKS OR PLASTIC CHAIRS SPACED A MAXIMUM OF 3'-0" EACH WAY. SUPPORTS SHALL BE POSITIONED TO PROVIDE A MINIMUM OF 3" CLEAR TO BOTTOM OF LOWEST REINFORCING BAR.
- CONSTRUCTION JOINTS IN CONTINUOUS FOOTINGS SHALL BE FORMED VERTICALLY WITH A
- CLASS B LAP IN HORIZONTAL REINFORCING.

5.15. POUR A 2" MUD MAT OF LEAN CONCRETE IN THE BOTTOM OF A FOOTING EXCAVATION THAT

- WILL BE EXPOSED TO RAIN OR REMAIN OPEN OVERNIGHT. 5.16. ALL REINFORCING SHALL BE TIED IN PLACE PRIOR TO PLACING CONCRETE.
- 5.17. FOUNDATION PENETRATIONS SHALL BE SUBJECT TO APPROVAL BY THE STRUCTURAL
- 5.18. WHERE FOOTING STEPS ARE REQUIRED, THEY SHALL BE NO STEEPER THAN ONE VERTICAL TO TWO HORIZONTAL.
- 5.19. WHERE GRAVITY PLUMBING LINES OCCUR BELOW TOP OF WALL FOOTING, STEP FOOTING DOWN TO PROVIDE CLEARANCE. COORDINATE WITH PLUMBING DRAWINGS FOR LOCATIONS,
- 5.20. PROTECT STRUCTURES, UTILITIES, SIDEWALKS, PAVEMENTS, AND OTHER FACILITIES FROM DAMAGE CAUSED BY SETTLEMENT, LATERAL MOVEMENT, UNDERMINING, WASHOUT, AND OTHER HAZARDS CREATED BY EARTHWORK OPERATIONS.
- PREVENT SURFACE WATER AND GROUND WATER FROM ENTERING EXCAVATIONS AND FROM PONDING ON PREPARED SUBGRADES AND SLABS. DO NOT USE EXCAVATED TRENCHES AS TEMPORARY DRAINAGE DITCHES.

DEWATER EXCAVATIONS AND REMOVE ANY WET MATERIAL PRIOR TO THE PLACING OF

- IMMEDIATELY NOTIFY THE OWNERS REPRESENTATIVE AND ENGINEER IF UNUSUAL SOIL CONDITIONS ARE FOUND.

6. **CONCRETE**

ENGINEER.

- 6.1. ALL CONCRETING OPERATIONS SHALL COMPLY WITH ACI 301, "SPECIFICATIONS FOR STRUCTURAL CONCRETE FOR BUILDINGS".
- DETAIL CONCRETE REINFORCEMENT AND ACCESSORIES IN ACCORDANCE WITH ACI 315 "DETAILING MANUAL".
- THE CONTRACTOR SHALL SUBMIT FOR THE STRUCTURAL ENGINEER'S REVIEW SHOP DRAWINGS FOR THE FOLLOWING ITEMS.
- 6.3.1. CONCRETE MIX DESIGNS
- CONCRETE REINFORCING
- CONTRACTOR SHALL NOT FABRICATE OR PLACE REINFORCEMENT UNTIL REINFORCEMENT SHOP DRAWINGS, REVIEWED AND STAMPED BY THE STRUCTURAL ENGINEER, ARE RECEIVED ON THE JOB SITE. SHOP DRAWINGS SHALL CONSIST OF BOTH "CUT" AND PLACEMENT SHEETS. PLACEMENT SHEETS SHALL CONTAIN ALL INFORMATION NECESSARY TO POSITION ALL REINFORCING STEEL IN THE FIELD WITHOUT HAVING TO REFER TO THE STRUCTURAL DRAWINGS. ARCHITECTURAL AND STRUCTURAL DRAWINGS SHALL NOT BE COPIED OR REPRODUCED FOR USE AS SHOP DRAWINGS.
- A QUALITY ASSURANCE PROGRAM CONSISTING OF SUBMITTALS, TESTING, AND INSPECTIONS SHALL BE USED TO VERIFY THAT CONSTRUCTION IS IN CONFORMANCE WITH THE CONTRACT DOCUMENTS. MATERIAL QUALITY, HANDLING, STORAGE, PREPARATION, PLACEMENT, AND CONSTRUCTION SHALL CONFORM TO THE REQUIREMENTS OF THE CODE.
- THE PROPOSED MATERIALS AND MIX DESIGN SHALL BE FULLY DOCUMENTED. RESPONSIBILITY FOR OBTAINING THE REQUIRED CONCRETE DESIGN STRENGTH IS THE CONTRACTOR'S.
 - REINFORCING BARS SHALL CONFORM TO ASTM A615, GRADE 60.
- WELDED WIRE REINFORCEMENT (WWR) SHALL CONFORM TO ASTM A1064. MINIMUM LAP AND EMBEDMENT TO BE THE GREATER OF ONE CROSS WIRE SPACING PLUS 2" OR 8". WWR SHALL BE SUPPLIED IN FLAT SHEETS (NOT ROLLS).
- SEE CONCRETE MIX DESIGN SCHEDULE FOR REQUIRED CONCRETE STRENGTH AND

- 6.10. USE OF CALCIUM CHLORIDE, CHLORIDE IONS, OR OTHER SALTS IN CONCRETE IS NOT
- 6.11. ALL EXPOSED CONCRETE EDGES SHALL HAVE A 3/4 INCH CHAMFER.

6.12. CONSTRUCTION JOINTS IN A HORIZONTAL PLANE ARE NOT PERMITTED

- 6.13. ANY STOP IN CONCRETE WORK MUST BE MADE WITH VERTICAL BULKHEADS AND HORIZONTAL KEYS. MAKE ALL REINFORCING CONTINUOUS THROUGH CONSTRUCTION JOINTS. CONTROL JOINTS FOR CONCRETE SLABS ON GRADE SHALL BE AS DETAILED AND LOCATED AS SHOWN IN THE CONSTRUCTION DOCUMENTS.
- 6.14. CONCRETE CONTAINING FIBER: REINFORCE WITH 50% SYNTHETIC MACROFIBERS AT A DOSAGE RATE OF 3.5 POUNDS PER CUBIC YARD, AND 50% SYNTHETIC MICROFIBER AT A DOSAGE RATE OF 1.0 POUND PER CUBIC YARD. FIBER SHALL MEET ASTM C1116, TYPE III STANDARD AND BE EQUIVALENT TO EUCLID CHEMICAL TUF-STRAND SF AND PSI FIBERSTRAND 100, RESPECTIVELY. SEE CONCRETE MIX DESIGN SCHEDULE FOR REQUIRED LOCATIONS OF FIBER REINFORCEMENT.
- COAT ALL SLABS WITH CURING COMPOUND WITHIN 24 HOURS OF PLACING. PRODUCT USED SHALL CONFORM WITH ASTM C309, AND SHALL BE COMPATIBLE WITH ADHERED FINISHES. A DISSIPATING FORMULATION SHALL BE USED AT CEMENTITIOUS FINISHES.
- 6.16. SLAB JOINTS SHALL BE FILLED WITH AN APPROVED MATERIAL. THIS SHOULD TAKE PLACE AS LATE AS POSSIBLE, PREFERABLY 4 TO 6 WEEKS AFTER THE SLAB HAS BEEN CAST. PRIOR TO FILLING, REMOVE ALL DEBRIS FROM THE SLAB JOINTS, THEN FILL IN ACCORDANCE WITH THE MANUFACTURERS RECOMMENDATIONS AS FOLLOWS: 6" SLABS FILL WITH EPOXY RESIN, OTHER SLABS FILL WITH FIELD MOLDED OR ELECTROMETRIC SEALANT.
- 6.17. SEE ARCHITECTURAL DRAWINGS FOR LOCATION OF DEPRESSED SLABS AND DRAINS. SLOPE SLAB TO DRAINS WHERE SHOWN.
- 6.18. REFER TO ARCHITECTURAL, MECHANICAL, ELECTRICAL, AND VENDOR DRAWINGS FOR SLEEVES, EMBEDDED ITEMS, ACCESSORIES, ETC. THE CONTRACTOR SHALL BE RESPONSIBLE FOR COORDINATING AND PLACING ALL SLEEVES, EMBEDDED ITEMS, ACCESSORIES, ETC.
- 6.19. SEE CONCRETE DETAILS, SECTIONS, AND COVER SCHEDULE FOR REQUIRED STEEL
- 6.20. REINFORCING STEEL SHOWN IN SECTIONS AND DETAILS ARE A SCHEMATIC INDICATION THAT REINFORCING EXISTS. SEE SCHEDULES, SECTION NOTES, AND GENERAL NOTES FOR ACTUAL REINFORCING REQUIRED.
- 6.21. ALL SPLICES SHALL BE CLASS "B" TENSION LAP SPLICE, UNLESS NOTED OTHERWISE.
- 6.22. TIE ALL REINFORCING STEEL AND EMBEDMENT'S SECURELY IN PLACE PRIOR TO PLACING CONCRETE. PROVIDE SUFFICIENT SUPPORTS TO MAINTAIN POSITION OF REINFORCEMENT WITHIN SPECIFIED TOLERANCES DURING ALL CONSTRUCTION ACTIVITIES. "STICKING" DOWELS INTO WET CONCRETE IS NOT PERMITTED.
- ADDITIONAL REINFORCING AND THE QUANTITY OF REINFORCING OCCURRING AT OPENINGS
- SHALL BE PLACED EQUALLY EACH SIDE OF OPENINGS AS DETAILED. 6.24. HOOKS IN REINFORCING ARE IN ADDITION TO LENGTH SHOWN.
- 6.25. FIELD BENDING OF BARS LARGER THAN #4 IS NOT PERMITTED. ALL BENDS FOR BARS LARGER THAN #4 SHALL BE SHOP MADE COLD BENDS.
- 6.26. FOR PEDESTAL, COLUMN, AND WALL VERTICAL REINFORCING, DOWEL TO FOUNDATION WITH HOOKED BARS OF SAME SIZE AND SPACING AS VERTICAL REINFORCING.
- 7.1. FABRICATE AND ERECT ALL STRUCTURAL STEEL IN ACCORDANCE WITH AISC "CODE OF STANDARD PRACTICE FOR STEEL BUILDINGS AND BRIDGES".
- 7.2. THE CONTRACTOR SHALL SUBMIT FOR THE STRUCTURAL ENGINEER'S REVIEW SHOP DRAWINGS WHICH INCLUDE ERECTION DRAWINGS, MATERIALS, CONNECTIONS, FABRICATION, AND ALL DETAILS FOR THE FOLLOWING ITEMS.
- 7.2.1. STRUCTURAL STEEL 7.3. THE STEEL FRAME IS "NON-SELF-SUPPORTING". ADEQUATE TEMPORARY SUPPORT MUST BE PROVIDED BY THE CONTRACTOR UNTIL THE LATERAL LOAD RESISTANCE SYSTEM IS INSTALLED AND STABILITY OF THE COMPLETED STRUCTURE IS ACHIEVED. THE LATERAL LOAD RESISTANCE SYSTEM AND STABILITY OF THE STRUCTURE IS PROVIDED BELOW:
- ROOF DIAPHRAGM: STEEL ROOF DECKING
- COLLECTOR ELEMENTS/DRAG STRUTS: WIDE FLANGE BEAMS
- LATERAL LOAD RESISTING SYSTEM: STEEL ORDINARY MOMENT FRAMES AND STEEL CANTILEVERED COLUMNS.
- 7.4. STRUCTURAL STEEL:
- 7.4.1. ASTM A992 FOR WIDE FLANGE BEAMS
- ASTM A36 FOR STEEL ANGLES AND CHANNELS
- ASTM A36 FOR STIFFENER PLATES, BASE PLATES, COLUMN CAP PLATES, BEAM CONNECTION PLATES
- 7.5. HOLLOW STRUCTURAL SECTIONS: ASTM A500, GRADE B/C.
- 7.6. WELDED CONNECTIONS: E70XX ELECTRODES, MINIMUM SIZE FILLET WELD 3/16". ALL SHOP AND FIELD WELDING SHALL BE BY A CERTIFIED WELDER AND IN ACCORDANCE WITH AMERICAN WELDING SOCIETY D1.1 SPECIFICATION.
- HEADED ANCHOR RODS: ASTM F1554, GRADE 55 HEADED, WELDABLE ANCHOR WITH HEAVY
- 7.8. ENGINEER SHALL BE CONTACTED FOR APPROVAL OF ANY FIELD MODIFICATIONS OR
- REPAIRS OF ANCHOR BOLTS OR RODS, AND COLUMN BASE PLATES. BOLTED CONNECTIONS: BEARING TYPE A325-N OR F1852 IN ACCORDANCE WITH AISC "SPECIFICATION FOR STRUCTURAL JOINTS USING ASTM A325 OR A490 BOLTS". BOLTS THROUGH 4" WIDE BEAM FLANGES SHALL BE 5/8" DIAMETER. OTHER BOLTS SHALL BE 3/4"
- DIAMETER. 7.10. WHERE STEEL BEAMS ARE CONTINUOUS OVER COLUMNS, PROVIDE WEB STIFFENER PLATES EACH SIDE OF BEAM WEB, OF THICKNESS EQUAL TO BEAM FLANGE THICKNESS, LOCATED IN
- ALIGNMENT WITH COLUMN WEB, FLANGES OR CENTER LINE OF TUBES AND PIPE COLUMNS. 7.11. PACK UNDER BASE PLATES WITH NON-SHRINK, NON-METALLIC, HI-STRENGTH (6,000 PSI MIN) GROUT MEETING THE REQUIREMENTS OF ASTM 1107 AFTER SETTING AND LEVELING.
- 7.12. ALL BRICK SHELF ANGLES SHALL BE HOT DIPPED GALVANIZED. 7.13. STEEL COLUMNS, BASE PLATES AND ALL STEEL BELOW GRADE SHALL HAVE A MINIMUM 3"
- CONCRETE COVER.
- 8.1. ROOF PANELS AND INSTALLATION SHALL COMPLY WITH MIAMI DATE COUNTY NOTICE OF
- ACCEPTANCE NO. 17-0920.04. THE ROOF PANEL SYSTEM, INCLUDING FASTENERS, FLASHING, AND ALL OTHER ROOFING ACCESSORIES SHALL BE SELECTED AND INSTALLED TO SATISFY THE ROOF LOAD REQUIREMENTS FOR DEAD LOAD, LIVE LOAD, CONSTRUCTION LOADS, AND COMPONENTS
- AND CLADDING WIND PRESSURES IN BOTH THE POSITIVE AND NEGATIVE DIRECTIONS. THE MINIMUM ALLOWABLE ROOF PANEL SPANS OF THE SELECTED SYSTEM SHALL BE ADEQUATE TO SPAN BETWEEN THE DESIGNED PURLIN SPACING UNDER ALL LOADS
- REQUIRED IN THE BUILDING CODE. PRIOR TO FABRICATION, CONTRACTOR SHALL SUBMIT SHOP DRAWINGS INCLUDING A PANEL LAYOUT PLAN AND SHOWING ALL COMPONENTS AND DETAILS OF THE ROOF PANEL SYSTEM. CONTRACTOR SHALL INCLUDE THE MANUFACTURER'S LOAD SPAN TABLES FOR THE

SELECTED ROOF PANEL WITH THE SHOP DRAWING SUBMITTAL. **COLD-FORMED METAL FRAMING:**

- 9.1. FABRICATE AND ERECT COLD-FORMED METAL FRAMING IN ACCORDANCE WITH THE AMERICAN IRON AND STEEL INSTITUTE.
- 9.2. THE CONTRACTOR SHALL SUBMIT FOR THE STRUCTURAL ENGINEER'S REVIEW PRODUCT DATA AND SHOP DRAWINGS WHICH SHALL INCLUDE THE FOLLOWING INFORMATION: PRODUCT DATA: FOR EACH TYPE OF COLD-FORMED METAL FRAMING PRODUCT AND
- ACCESSORY UTILIZED. SHOP DRAWINGS: SHOW LAYOUT, SPACING'S, SIZES, THICKNESS, AND TYPES OF COLD-FORMED METAL FRAMING, FABRICATIONS, AND FASTENING AND ANCHORAGE DETAILS, INCLUDING MECHANICAL FASTENERS. SHOW REINFORCING CHANNELS, OPENING FRAMING, SUPPLEMENTAL FRAMING, STRAPPING, BRACING, BRIDGING, SPLICES, ACCESSORIES, CONNECTION DETAILS, AND ATTACHMENT TO ADJOINING
- 9.3. FRAMING MEMBERS SHALL BE ONE CONTINUOUS PIECE. SPLICING FRAMING COMPONENTS, OTHER THAN THE CONTINUOUS TRACK AT THE TOP AND BOTTOM OF WALLS, IS NOT PERMITTED.

9.4. CUTTING, NOTCHING, OR OTHERWISE MODIFYING COLD-FORMED FRAMING IS NOT ALLOWED WITHOUT WRITTEN PERMISSION FROM THE ENGINEER OF RECORD.

- 10.1. MASONRY CONSTRUCTION SHALL COMPLY WITH THE REQUIREMENTS OF THE MASONRY SOCIETY AND THE AMERICAN CONCRETE INSTITUTE.
- 10.2. ALL MASONRY SHALL BE RUNNING BOND, UNLESS NOTED OTHERWISE.
- 10.3. THE CONTRACTOR SHALL SUBMIT FOR THE STRUCTURAL ENGINEER'S REVIEW THE BELOW
- LISTED ITEMS (IF USED).
- CONCRETE MASONRY UNIT CERTIFICATES
- MORTAR MATERIALS CERTIFICATES AND MIX DESIGN
- GROUT MATERIALS CERTIFICATES AND MIX DESIGN 10.3.4.
- SELF-CONSOLIDATING GROUT MATERIALS CERTIFICATES SELF-CONSOLIDATING GROUT MIX DESIGN
- 10.3.6. SELF-CONSOLIDATING GROUT TESTS
- JOINT REINFORCEMENT MATERIALS CERTIFICATES
- METAL ANCHORS AND ANCHOR BOLTS PRODUCT DATA
- MASONRY TIE PRODUCT DATA
- METAL ACCESSORIES MATERIAL CERTIFICATES
- 10.3.11. COLD WEATHER CONSTRUCTION PROCEDURES
- 10.3.12. HOT WEATHER CONSTRUCTION PROCEDURES 10.3.13. HIGH WIND CONSTRUCTION PROCEDURES
- 10.4. THE CONTRACTOR SHALL SUBMIT FOR THE STRUCTURAL ENGINEER'S REVIEW SHOP DRAWINGS SHOWING ALL FABRICATION DIMENSIONS AND LOCATIONS FOR PLACING REINFORCING STEEL AND ACCESSORIES. WALL STEEL SHALL BE SHOWN IN ELEVATION. NO FABRICATION SHALL BEGIN UNTIL SHOP DRAWINGS ARE APPROVED BY THE STRUCTURAL
- 10.5. A QUALITY ASSURANCE PROGRAM CONSISTING OF SUBMITTALS, TESTING, AND INSPECTIONS SHALL BE USED TO VERIFY THAT THE CONSTRUCTED MASONRY IS IN CONFORMANCE WITH THE CONTRACT DOCUMENTS. MATERIAL QUALITY, HANDLING, STORAGE, PREPARATION, PLACEMENT, AND CONSTRUCTION SHALL CONFORM TO THE REQUIREMENTS OF THE CODE
- PROVIDE CONCRETE MASONRY UNITS WITH A MINIMUM COMPRESSIVE STRENGTH OF fm = 2000 PSI, AS DETERMINED IN ACCORDANCE WITH ASTM C140.
- 10.7. PROVIDE HOLLOW, LOAD BEARING CONCRETE MASONRY UNITS CONFORMING TO ASTM C90.
- 10.8. PROVIDE TYPE "S" MORTAR IN ACCORDANCE WITH ASTM C270, UNLESS NOTED OTHERWISE. 10.9. COURSE MASONRY GROUT SHALL CONFORM TO ASTM C476 WITH A MAXIMUM AGGREGATE SIZE OF 3/8". MINIMUM COMPRESSIVE STRENGTH SHALL BE 2000 PSI AT 28 DAYS. STOP
- GROUT 2" SHORT OF TOP BED JOINT TO CREATE A SHEAR KEY WITH THE NEXT LIFT. 10.10. MASONRY GROUT SHALL BE MECHANICALLY CONSOLIDATED AT THE TIME OF PLACEMENT
- AND THEN RECONSOLIDATED WITHIN 45 MINUTES. 10.11. DEFORMED REINFORCING BARS SHALL CONFORM TO ASTM A615, GRADE 60.
- 10.12. MINIMUM REINFORCING TENSION LAP SPLICE LENGTHS SHALL BE PER THE MASONRY TENSION SPLICE LAP TABLE OR 52 BAR DIAMETERS, WHICHEVER IS GREATER.

10.13. ALL BLOCK CELLS AND CAVITIES BELOW GRADE SHALL BE FILLED WITH PROPERLY

- CONSOLIDATED CONCRETE OR GROUT. 10.14. ALL REINFORCING IN MASONRY WALLS SHALL BE FULLY ENCLOSED WITH PROPERLY CONSOLIDATED GROUT.
- 10.15. VERTICAL REINFORCEMENT FOR MASONRY WALLS SHALL BE PLACED IN THE CENTER OF THE WALL UNLESS INDICATED OTHERWISE ON THE DRAWINGS. PROVIDE ALL ACCESSORIES AS REQUIRED TO SUPPORT BARS AT LOCATIONS INDICATED. 10.16. WHEN LAYING BLOCK MORE THAN FIVE FEET FOUR INCHES VERTICAL PRIOR TO GROUTING (HIGH LIFT), PROVIDE A 4"X4" CLEAN OUT OPENING AT THE BOTTOM COURSE OF EACH LIFT

AT EACH REINFORCED CELL. CELLS SHALL BE THOROUGHLY CLEANED PRIOR TO GROUTING.

- SEAL OPENING DURING GROUTING 10.17. BLOCK BOND BEAMS AND LINTELS SHALL BE SPECIALLY FORMED U-BLOCK OR LOW WEB
- UNITS WITH REINFORCEMENT AS SHOWN. 10.18. PROVIDE AN 8" DEEP CMU BOND BEAM WITH (1) #5 CONTINUOUS BAR GROUTED SOLID AT ROOF BEARING LEVEL AND TOP OF ALL CMU WALLS. PROVIDE (1) #5 CORNER BAR AND LAP WITH CONTINUOUS REINFORCEMENT AT CORNERS AND TEES PER MASONRY TENSION SPLICE LAP TABLE. BOND BEAM REINFORCEMENT SHALL BE CONTINUOUS ACROSS CONTROL JOINTS. PROVIDE RAKED JOINTS IN THESE ELEMENTS TO MATCH THE CONTROL JOINT. SEE
- TYPICAL DETAILS, PLANS, AND SECTIONS FOR ADDITIONAL REQUIREMENTS. 10.19. PROVIDE 9 GA. GALVANIZED LADDER TYPE HORIZONTAL JOINT REINFORCEMENT COMPLYING WITH ASTM A82 OR ASTM A951 AT 16" OC VERTICALLY FOR FULL WALL HEIGHT. LAP 6" MINIMUM AND PROVIDE PREFAB CORNERS AND TEES. SEE ARCHITECTURAL FOR
- BRICK TIES FABRICATED INTEGRAL WITH JOINT REINFORCING, IF REQUIRED. 10.20. HORIZONTAL JOINT REINFORCEMENT SHALL TERMINATE 2" FROM EACH SIDE OF A VERTICAL
- 10.21. UNLESS NOTED OTHERWISE, PROVIDE VERTICAL CONTROL JOINTS AS DESCRIBED BELOW:
- 10.21.1. AT 30' OC, MAXIMUM. 10.21.2. AT 15' FROM BUILDING CORNERS, MAXIMUM.

LATERAL STABILITY TO THE WALL.

10.21.3. ON ONE OR BOTH SIDES OF OPENINGS. 10.21.4. NO CLOSER THAN 1'-4" TO OPENING EDGES.

10.21.5. NO CLOSER THAN 1'-4" TO MAJOR BEAM OR JOIST BEARING.

10.22. SEE ARCHITECTURAL DRAWINGS FOR LOCATIONS AND DETAILS OF MASONRY VENEER 10.23. ADEQUATE TEMPORARY BRACING OF CMU WALLS MUST BE PROVIDED BY THE CONTRACTOR

UNTIL REQUIRED CONNECTIONS OR ELEMENTS ARE IN PLACE TO PROVIDE ADEQUATE

4300 Legendary Drive, Suite 234 Destin, Florida 32541

PROJECT:

T: 850.650.4353 F: 850.650.3881

Lake City, FL 32055 Columbia County

Tidal Wave Auto Spa

PROTOTYPE PROTOTYPE DATE:

SETUP DATE: SET NAME:

PROFESSIONAL OF RECORD: STATE OF

DESIGNER'S INFORMATION:

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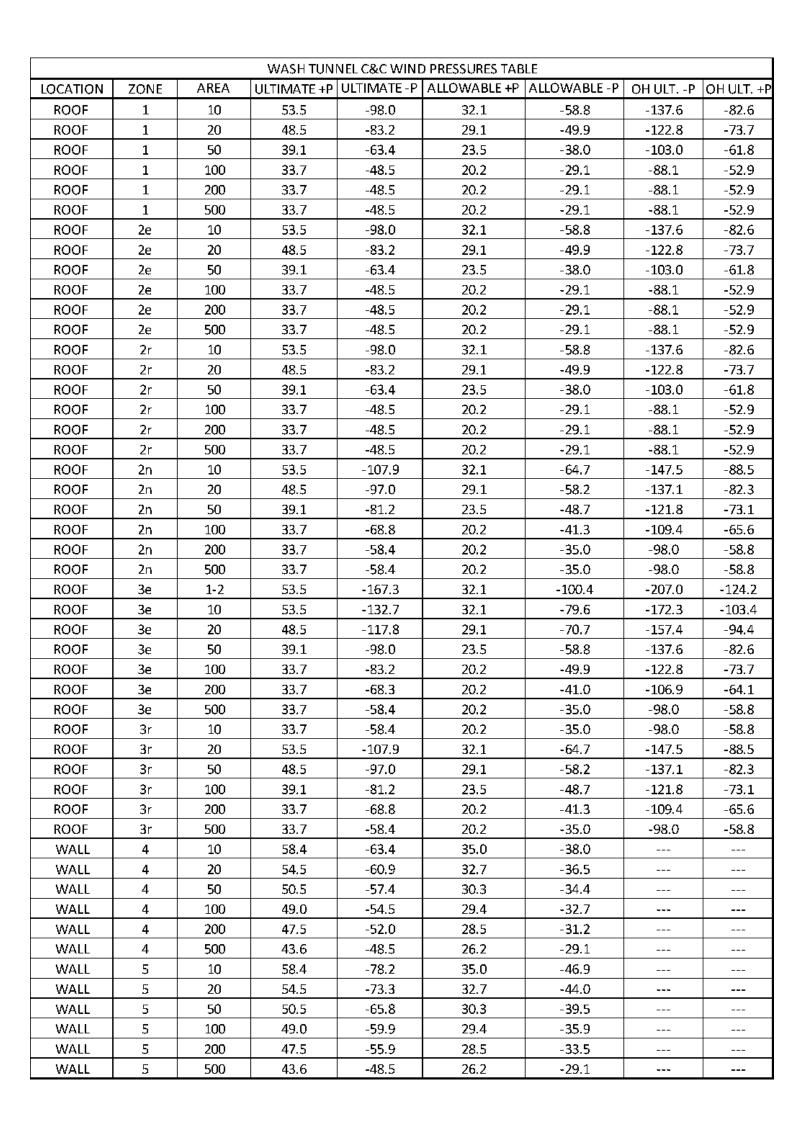
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GENERAL NOTES

SHEET SCALE:


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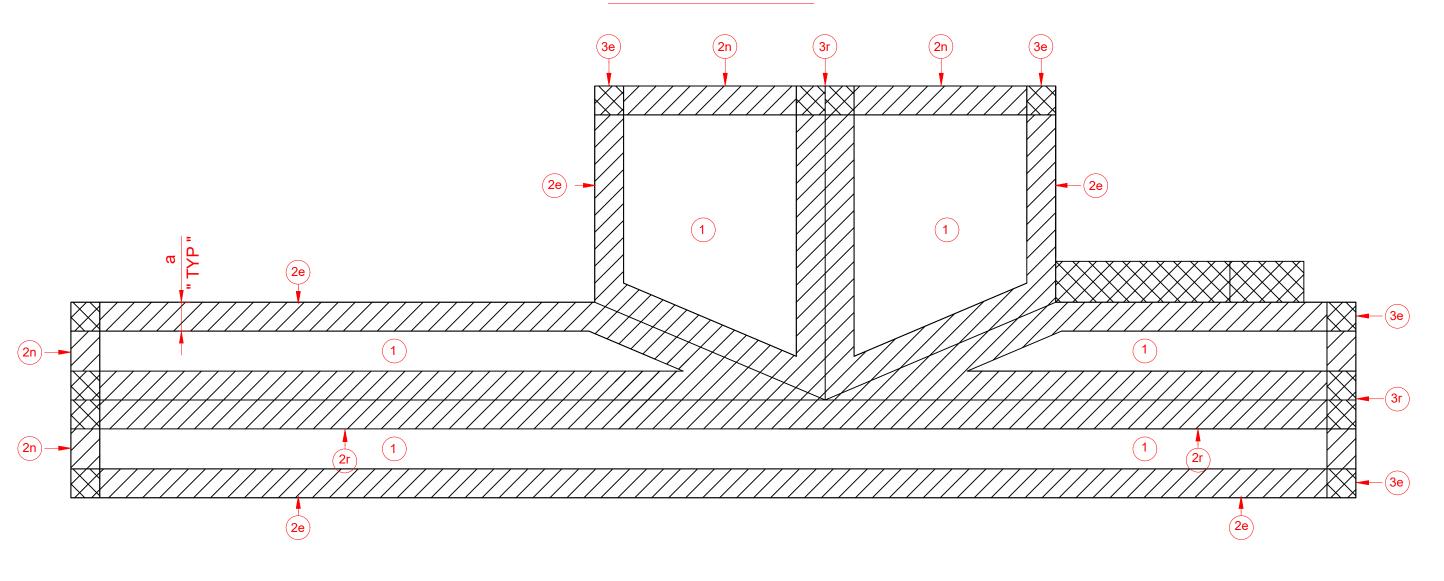


VAC CANOPY C&C WIND PRESSURES TABLE						
LOCATION	ZONE	AREA	ULTIMATE +P	ULTIMATE -P	ALLOWABLE +P	ALLOWABLE -P
ROOF	1	≤ a2	50.1	-34.7	30.0	-20.8
ROOF	1	> a2,≤ 4.0a2	50.1	-34.7	30.0	-20.8
ROOF	1	>4.0 a 2	50.1	-34.7	30.0	-20.8
ROOF	2	≤ a2	77.0	-53.9	46.2	-32.3
ROOF	2	> a2,≤ 4.0a2	77.0	-53.9	46.2	-32.3
ROOF	2	>4.0 a 2	50.1	-34.7	30.0	-20.8
ROOF	3	≤ a2	100.1	-69.3	60.1	-41.6
ROOF	3	> a2,≤ 4.0a2	77.0	-53.9	46.2	-32.3
ROOF	3	>4.0 a 2	50.1	-34.7	30.0	-20.8


- 1. DESIGN BASED ON ASCE 7-16, SECTION 30. SEE GENERAL NOTES FOR ADDITIONAL INFORMATION.
- 2. ALLOWABLE WIND LOADS ARE 60% OF ULTIMATE WIND LOADS.
- 3. WASH TUNNEL PRESSURE CATEGORY, ENCLOSED. 4. VACUUM CANOPY PRESSURE CATEGORY, OPEN.
- 5. WIDTH OF EDGE STRIP, "a" = 4'-0".



VAC CANOPY ROOF

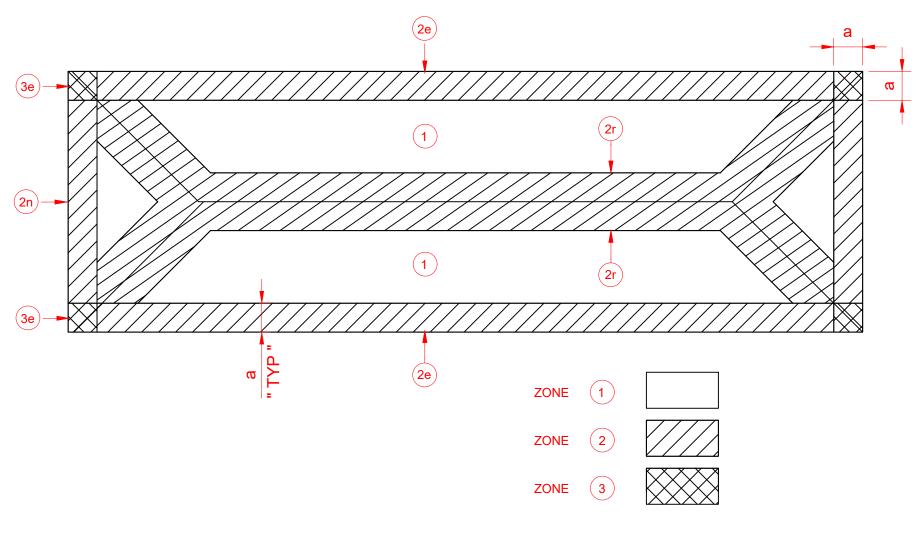

WASH TUNNEL ROOF

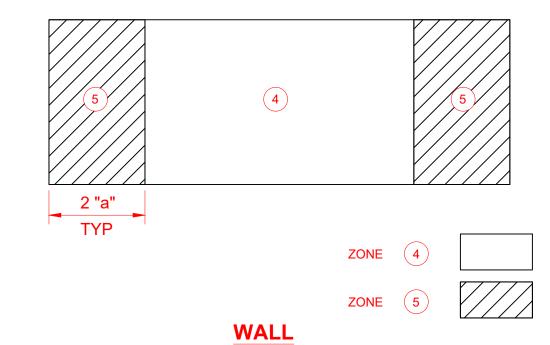




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Tidal Wave Auto Spa 3039 W US-90 Lake City, FL 32055 Columbia County

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COMPONENTS & CLADDING WIND DIAGRAMS & TABLES

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CAST-IN-PLACE CONCRETE MIX SCHEDULE									
APPLICATION	EXPOSURE CLASS	STRENGTH (PSI)	TYPE	W/C RATIO	SLUMP	AIR CONTENT	MAX AGGREGATE	MAX CONCRETE WEIGHT (PCF)	FIBER
FOUNDATIONS	F0, S0, P0, C0	3,000	NORMAL WT.	0.50	4" TO 6"		3/4"		NO
WASH TUNNEL SLAB	F0, S0, P0, C0	5,000	NORMAL WT.	0.42	3" TO 5"		3/4"		YES
VAC HOUSE & DUMPSTER SLAB	F0, S0, P0, C0	4,000	NORMAL WT.	0.45	3" TO 5"		3/4"		NO
PAY ISLAND MAT FOUNDATION	F0, S0, P0, C0	4,000	NORMAL WT.	0.45	3" TO 5"		3/4"		NO

I. EXPOSURE CLASS FOR FREEZE/THAW, SULFATES, PERMEABILITY, AND CORROSION ARE PER ACI 318, SECTION 4.2.

WHERE NO W/C RATIO, SLUMP, OR AIR CONTENT IS NOTED, VALUES SHALL BE AS RECOMMENDED BY THE READY MIX SUPPLIERS ENGINEER.

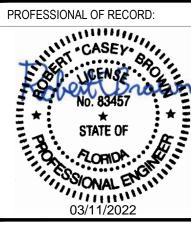WHERE AIR ENTRAINMENT IS NOT REQUIRED PER THE ABOVE TABLE, THE CONTRACTOR, INSTALLER, OR SUPPLIER MAY CHOOSE TO INCLUDE AIR ENTRAINMENT TO IMPROVE PLACEMENT AND FINISHING CHARACTERISTICS. AIR ENTRAINMENT IS NOT PERMITTED IN NORMAL WEIGHT CONCRETE TO RECEIVE A HARD TROWEL FINISH, AND ENTRAPPED AIR SHALL NOT EXCEED 3%. AIR ENTRIANMENT IN LIGHT WEIGHT CONCRETE SLABS IS REQUIRED TO MEET FIRE RATING REQUIREMENTS. SLABS SHALL BE PROPERLY FINISHED TO AVOID SURFACE IMPERFECTIONS SUCH AS BLISTERING OR DELAMINATION.

CEMENT AND AGGREGATES SHALL BE FROM A SINGLE SOURCE.

CIP CONCRETE CLEAR COVER	SCHEDULE
LOCATION	COVER mm (IN)
CONCRETE CAST AGAINST & EXPOSED TO EARTH	3"
CONCRETE EXPOSED TO EARTH OR WEATHER:	
#6 TO #18 BARS	2"
#5, W31, AND SMALLER BARS	1 1/2"
CONCRETE NOT EXPOSED TO EARTH OR WEATHER:	
SLABS, WALLS, AND JOISTS	
#14 AND #18 BARS	1 1/2"
#11 AND SMALLER BARS	3/4"
BEAMS AND COLUMNS	1 1/2"
FOOTINGS, GRADE BEAMS, AND PILE CAPS	2" TOP 3" BOTT. & SIDES
DRILLED PIERS AND BELLED PIERS	3" CLEAR OF TIES
PEDESTALS AND COLUMNS	1 1/2" CLEAR OF TIES
BASEMENT WALLS	2" EXT. & 3/4" INT.
RETAINING WALLS	2" BOTH FACES
SUMP AND PIT WALLS	2" BOTH FACES
ELEVATED SLABS NOT EXPOSED TO WEATHER	3/4" TOP & BOTT.
POST TENSIONED SLABS EXPOSED TO WEATHER	1" TOP & BOTT.
ELEVATED SLABS EXPOSED TO WEATHER:	
#5 AND SMALLER BARS	1 1/2" TOP & 3/4" BOTT.
#6 AND GREATER BARS	2" TOP & 3/4" BOTT.
WELDED WIRE REINFORCEMENT:	
5" OR LESS SLAB THICKNESS	CENTER
6" OR GREATER SLAB THICKNESS	2" FROM TOP
SLAB ON WELL GRADED SUBGRADE OR VAPOR BARRIERS	3/4" TOP 1 1/2" BOTT.
BEAMS	1 1/2" CLEAR OF STIRRUPS
JOISTS	1 1/2" ALL SIDES
WIDE MODULE JOISTS	3/4"

	CONCRETE TENSION SPLICE LAP LENGTHS											
		f'c = 30	000 PSI			f'c = 40	000 PSI		f'c = 5000 PSI			
BAR SIZE	TOP	BARS	OTHER	BARS	TOP	BARS	OTHER	BARS	TOP	BARS	OTHER	BARS
	Α	В	Α	В	Α	В	Α	В	Α	В	Α	В
#3	22	28	17	22	19	25	15	19	17	22	13	17
#4	29	38	22	29	25	33	19	25	23	29	17	23
#5	36	47	28	36	31	41	24	31	28	36	22	28
#6	54	56	33	43	37	49	29	37	34	44	26	34
#7	63	81	48	63	54	71	42	54	49	63	38	49
#8	72	93	55	72	62	81	48	62	56	72	43	56
#9	81	105	62	81	70	91	54	70	63	81	48	63
#10	91	118	70	91	79	102	61	79	71	92	54	71
#11	101	131	78	101	87	114	67	87	78	102	60	78

ALL LENGTHS ARE IN INCHES.

BAR COVER AND TRANSVERSE REINFORCEMENT SHALL MEET CODE MINUMUM.

LAP SPLICING OF #14 & #18 BARS IS NOT ALLOWED.

LAP LENGTHS ARE FOR NORMAL WEIGHT CONCRETE WITH UNCOATED, 60 KSI BARS. WHEN LAPPING BARS OF DIFFERENT SIZES USE THE SPLICE LAP LENGTH OF THE SMALLER BAR, OR THE DEVELOPMENT LENGTH OF THE LARGER BAR, WHICHEVER IS GREATER. THE "A" VALUE FROM THE TABLE IS EQUAL TO THE BAR DEVELOPMENT LENGTH.

TOP BARS ARE HORIZONTAL REINFORCEMENT WITH MORE THAN 12" OF CONCRETE CAST BELOW THE REINFORCEMENT.

MASONRY TENSION SPLICE LAP LENGTHS						
BAR SIZE	f'm = 1500	f'm = 2000	f'm = 2500	f'm = 3000		
#3	20	20	20	20		
#4	26	26	26	26		
#5	32	32	32	32		
#6	40	39	39	39		
#7	46	45	45	45		
#8	61	53	52	52		
#9	69	60	58	58		



PROJECT:

TIDAL

AUTORIAN

SEPA

Destin, Florida 32541

T: 850.650.4353 F: 850.650.3881

Tidal Wave Auto Spa 3039 W US-90 Lake City, FL 32055 Columbia County


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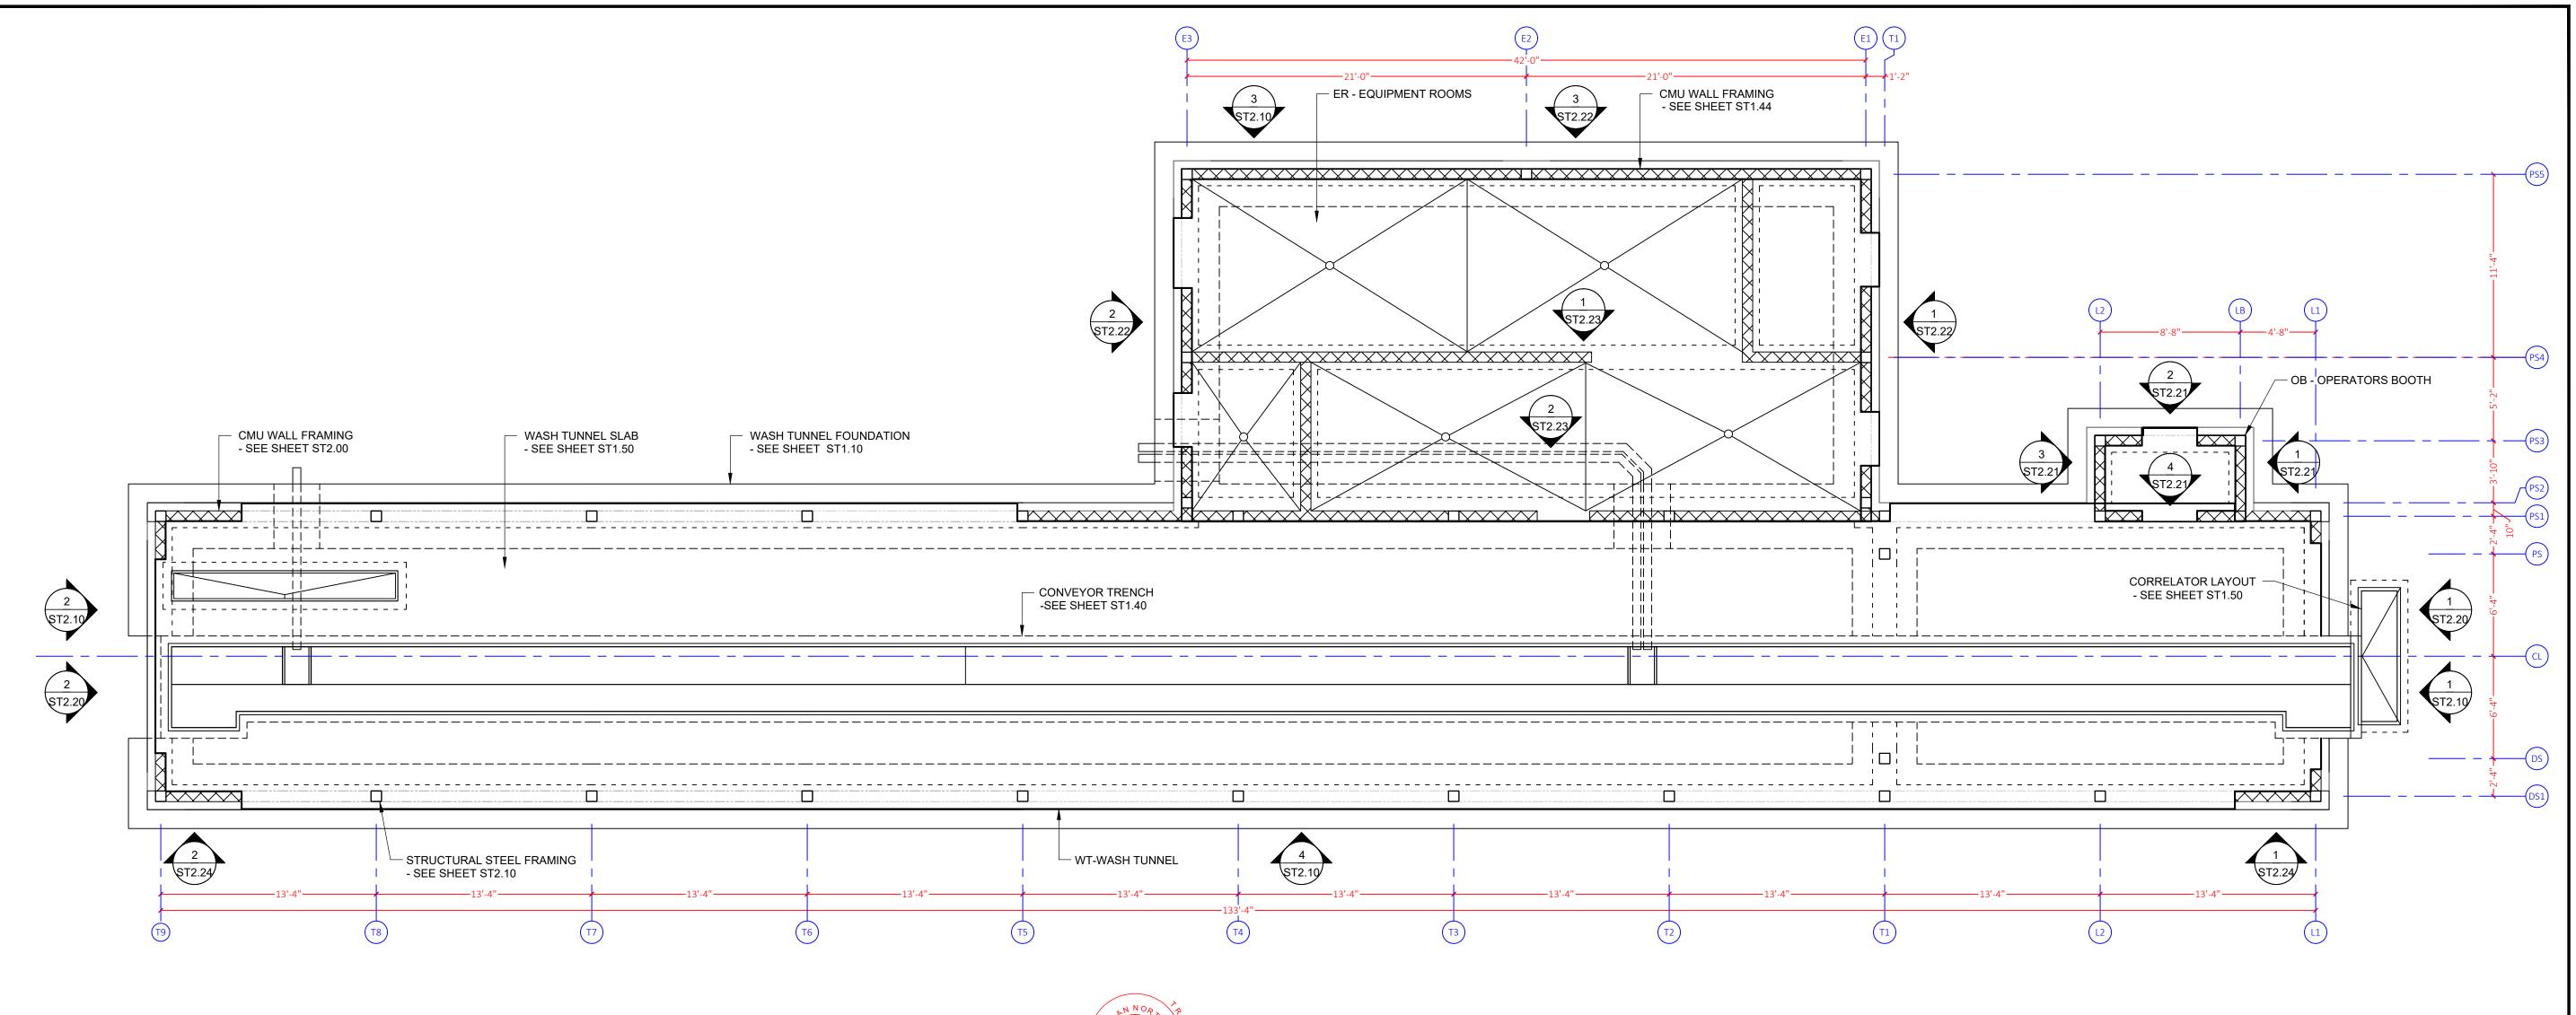
ABBREVIATIONS & SCHEDULES

SHEET SCAL

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1 SLAB LEVEL KEYNOTE PLAN 3/16" = 1'-0"

1. TOP OF SLAB ELEVATIONS ARE SET WITH AN EQUIPMENT ROOM REFERENCE ELEVATION OF 0'-0". SEE CIVIL PLANS FOR ACTUAL TOP OF

- 2. COORDINATE TOP OF SLAB WITH ACTUAL SLAB ELEVATION, SLAB
- RECESSES, AND FLOOR SLOPES. 3. COORDINATE DRAIN LOCATIONS AND SLAB SLOPES WITH
- ARCHITECTURAL AND PLUMBING DRAWINGS.
- 4. WASH TUNNEL FOUNDATION CONCRETE, INCLUDING ASSOCIATED TRENCHES AND PITS TO BE 5,000 PSI CONCRETE.
- 5. ALL EXPOSED CONCRETE (SLAB, TRENCH, PITS) SHALL BE REINFORCED USING A COMBINATION OF MACRO AND MICRO FILAMENT FIBER MESH.
- SEE CONCRETE GENERAL NOTES.
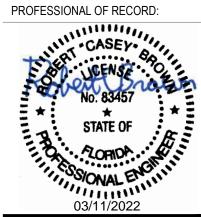
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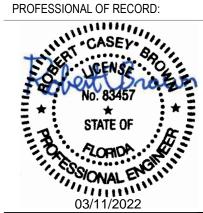
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Lake City, FL 32055 Columbia County

Destin, Florida 32541 T: 850.650.4353 F: 850.650.3881

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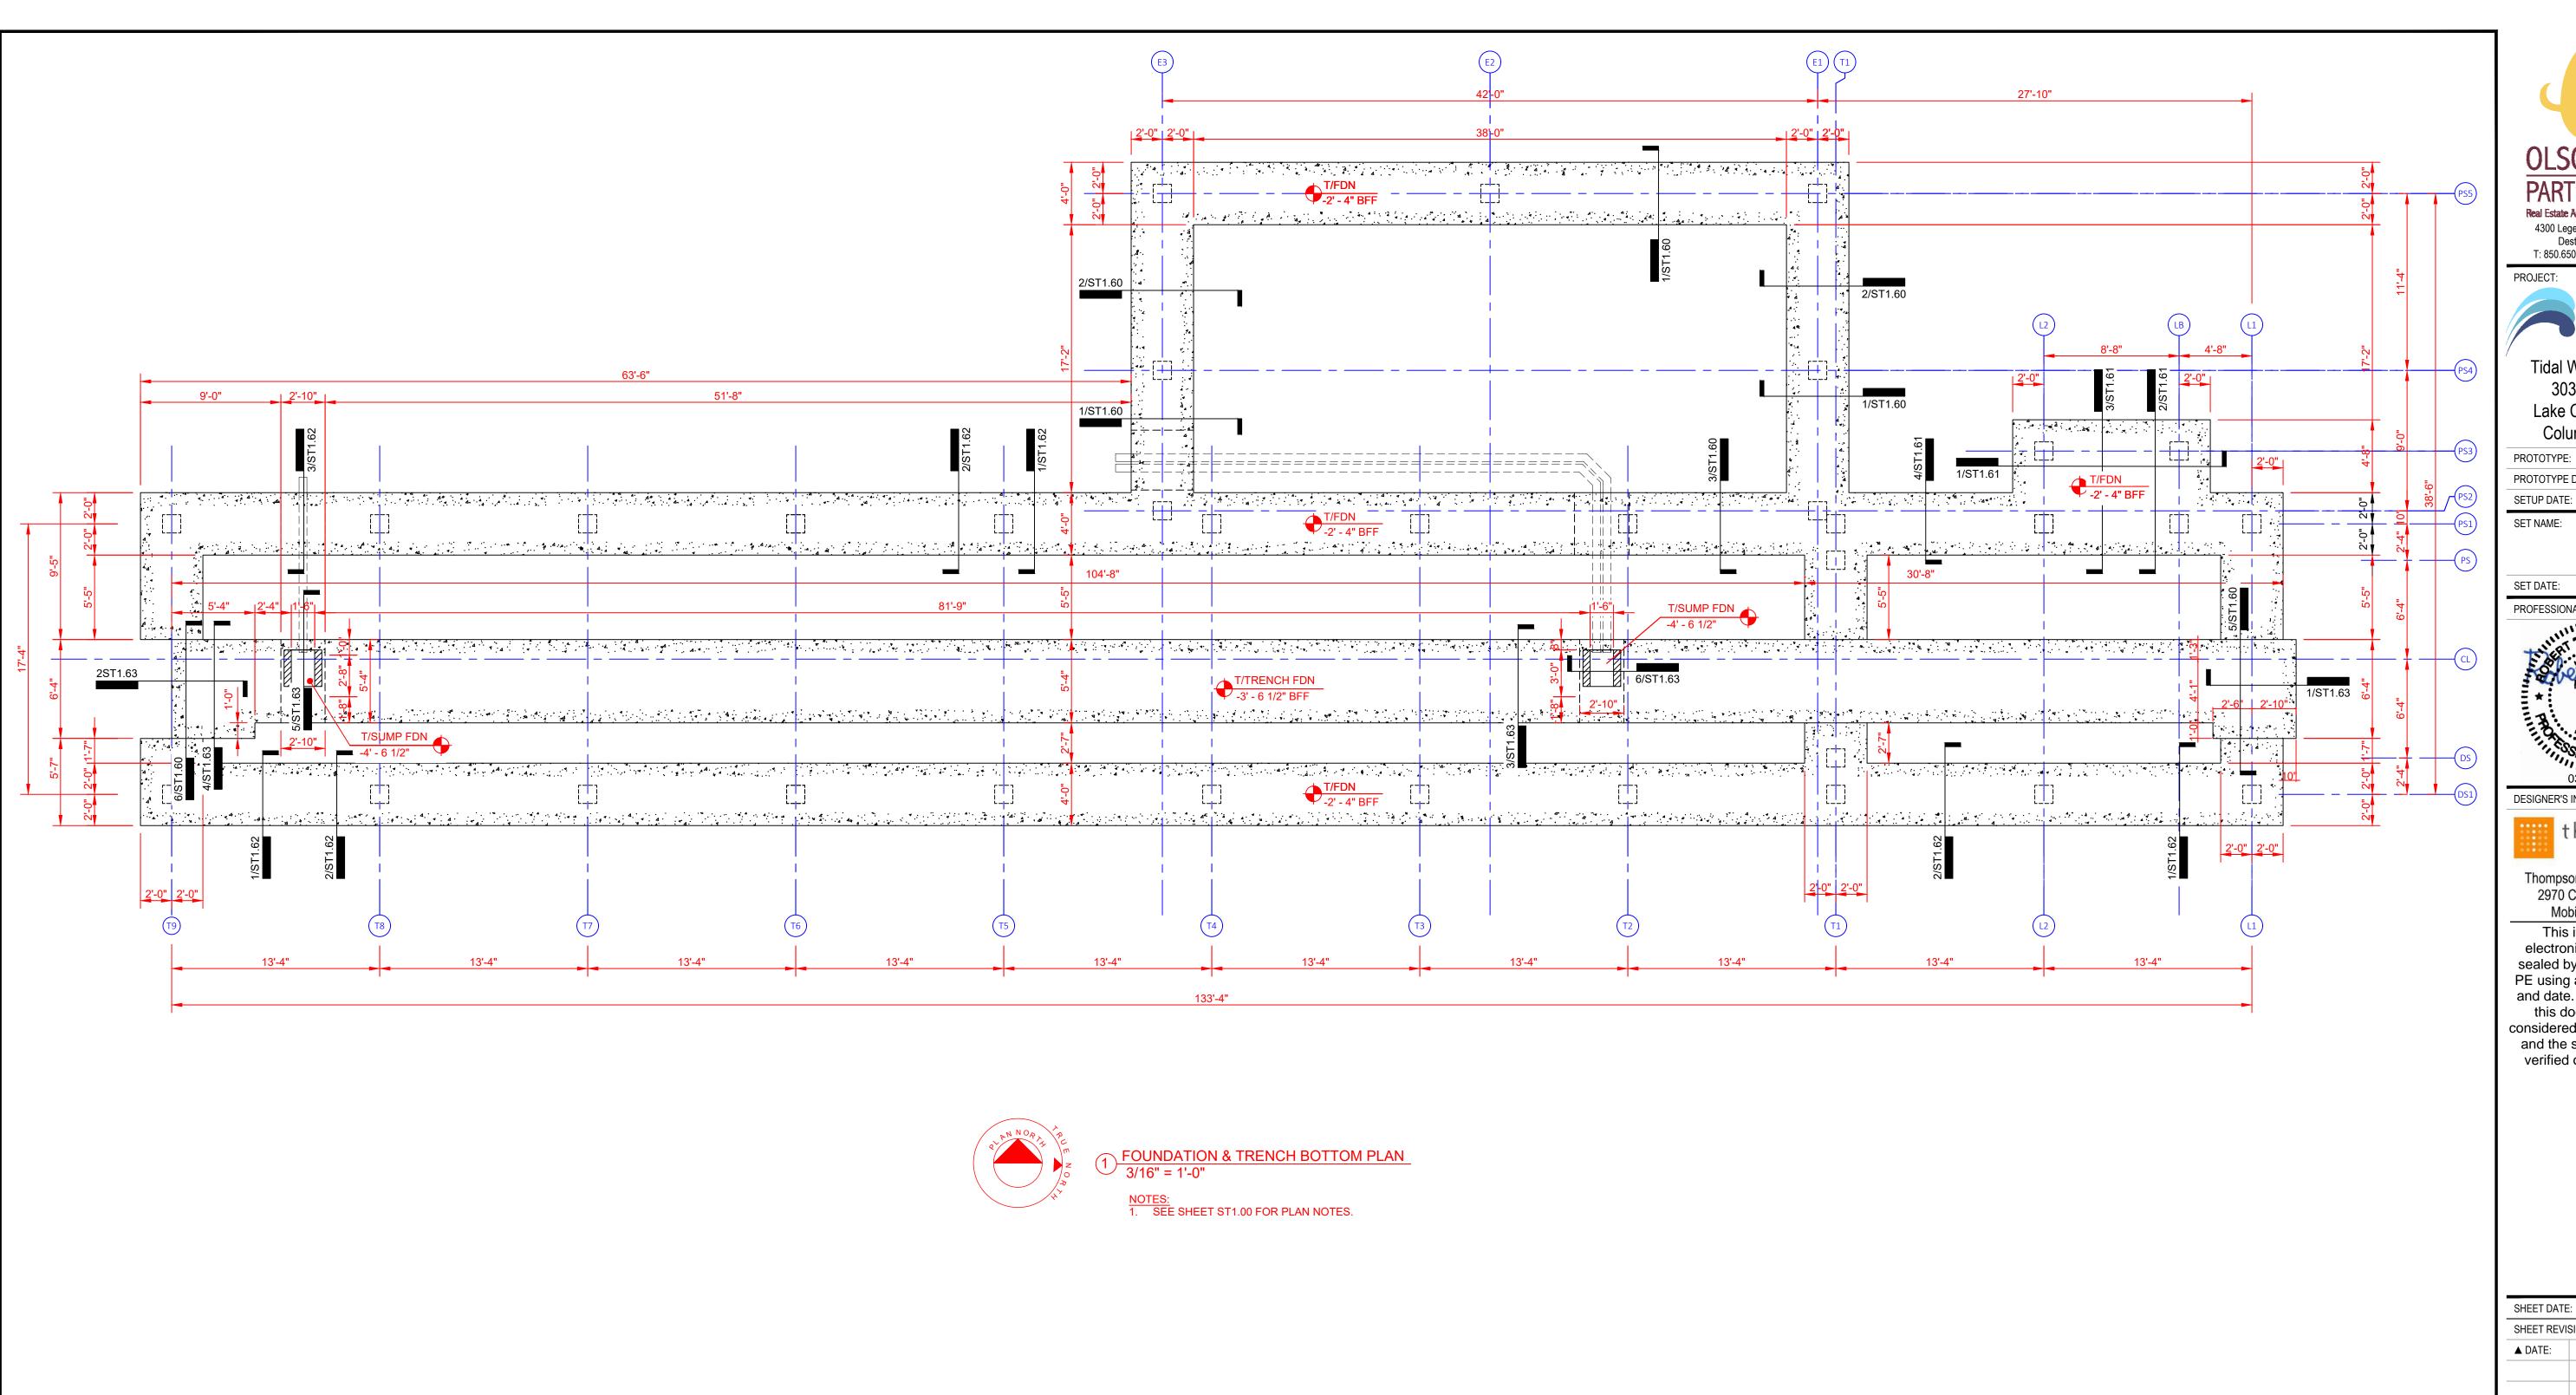
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> **SLAB LEVEL KEYNOTE PLAN**

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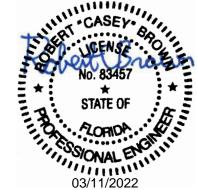


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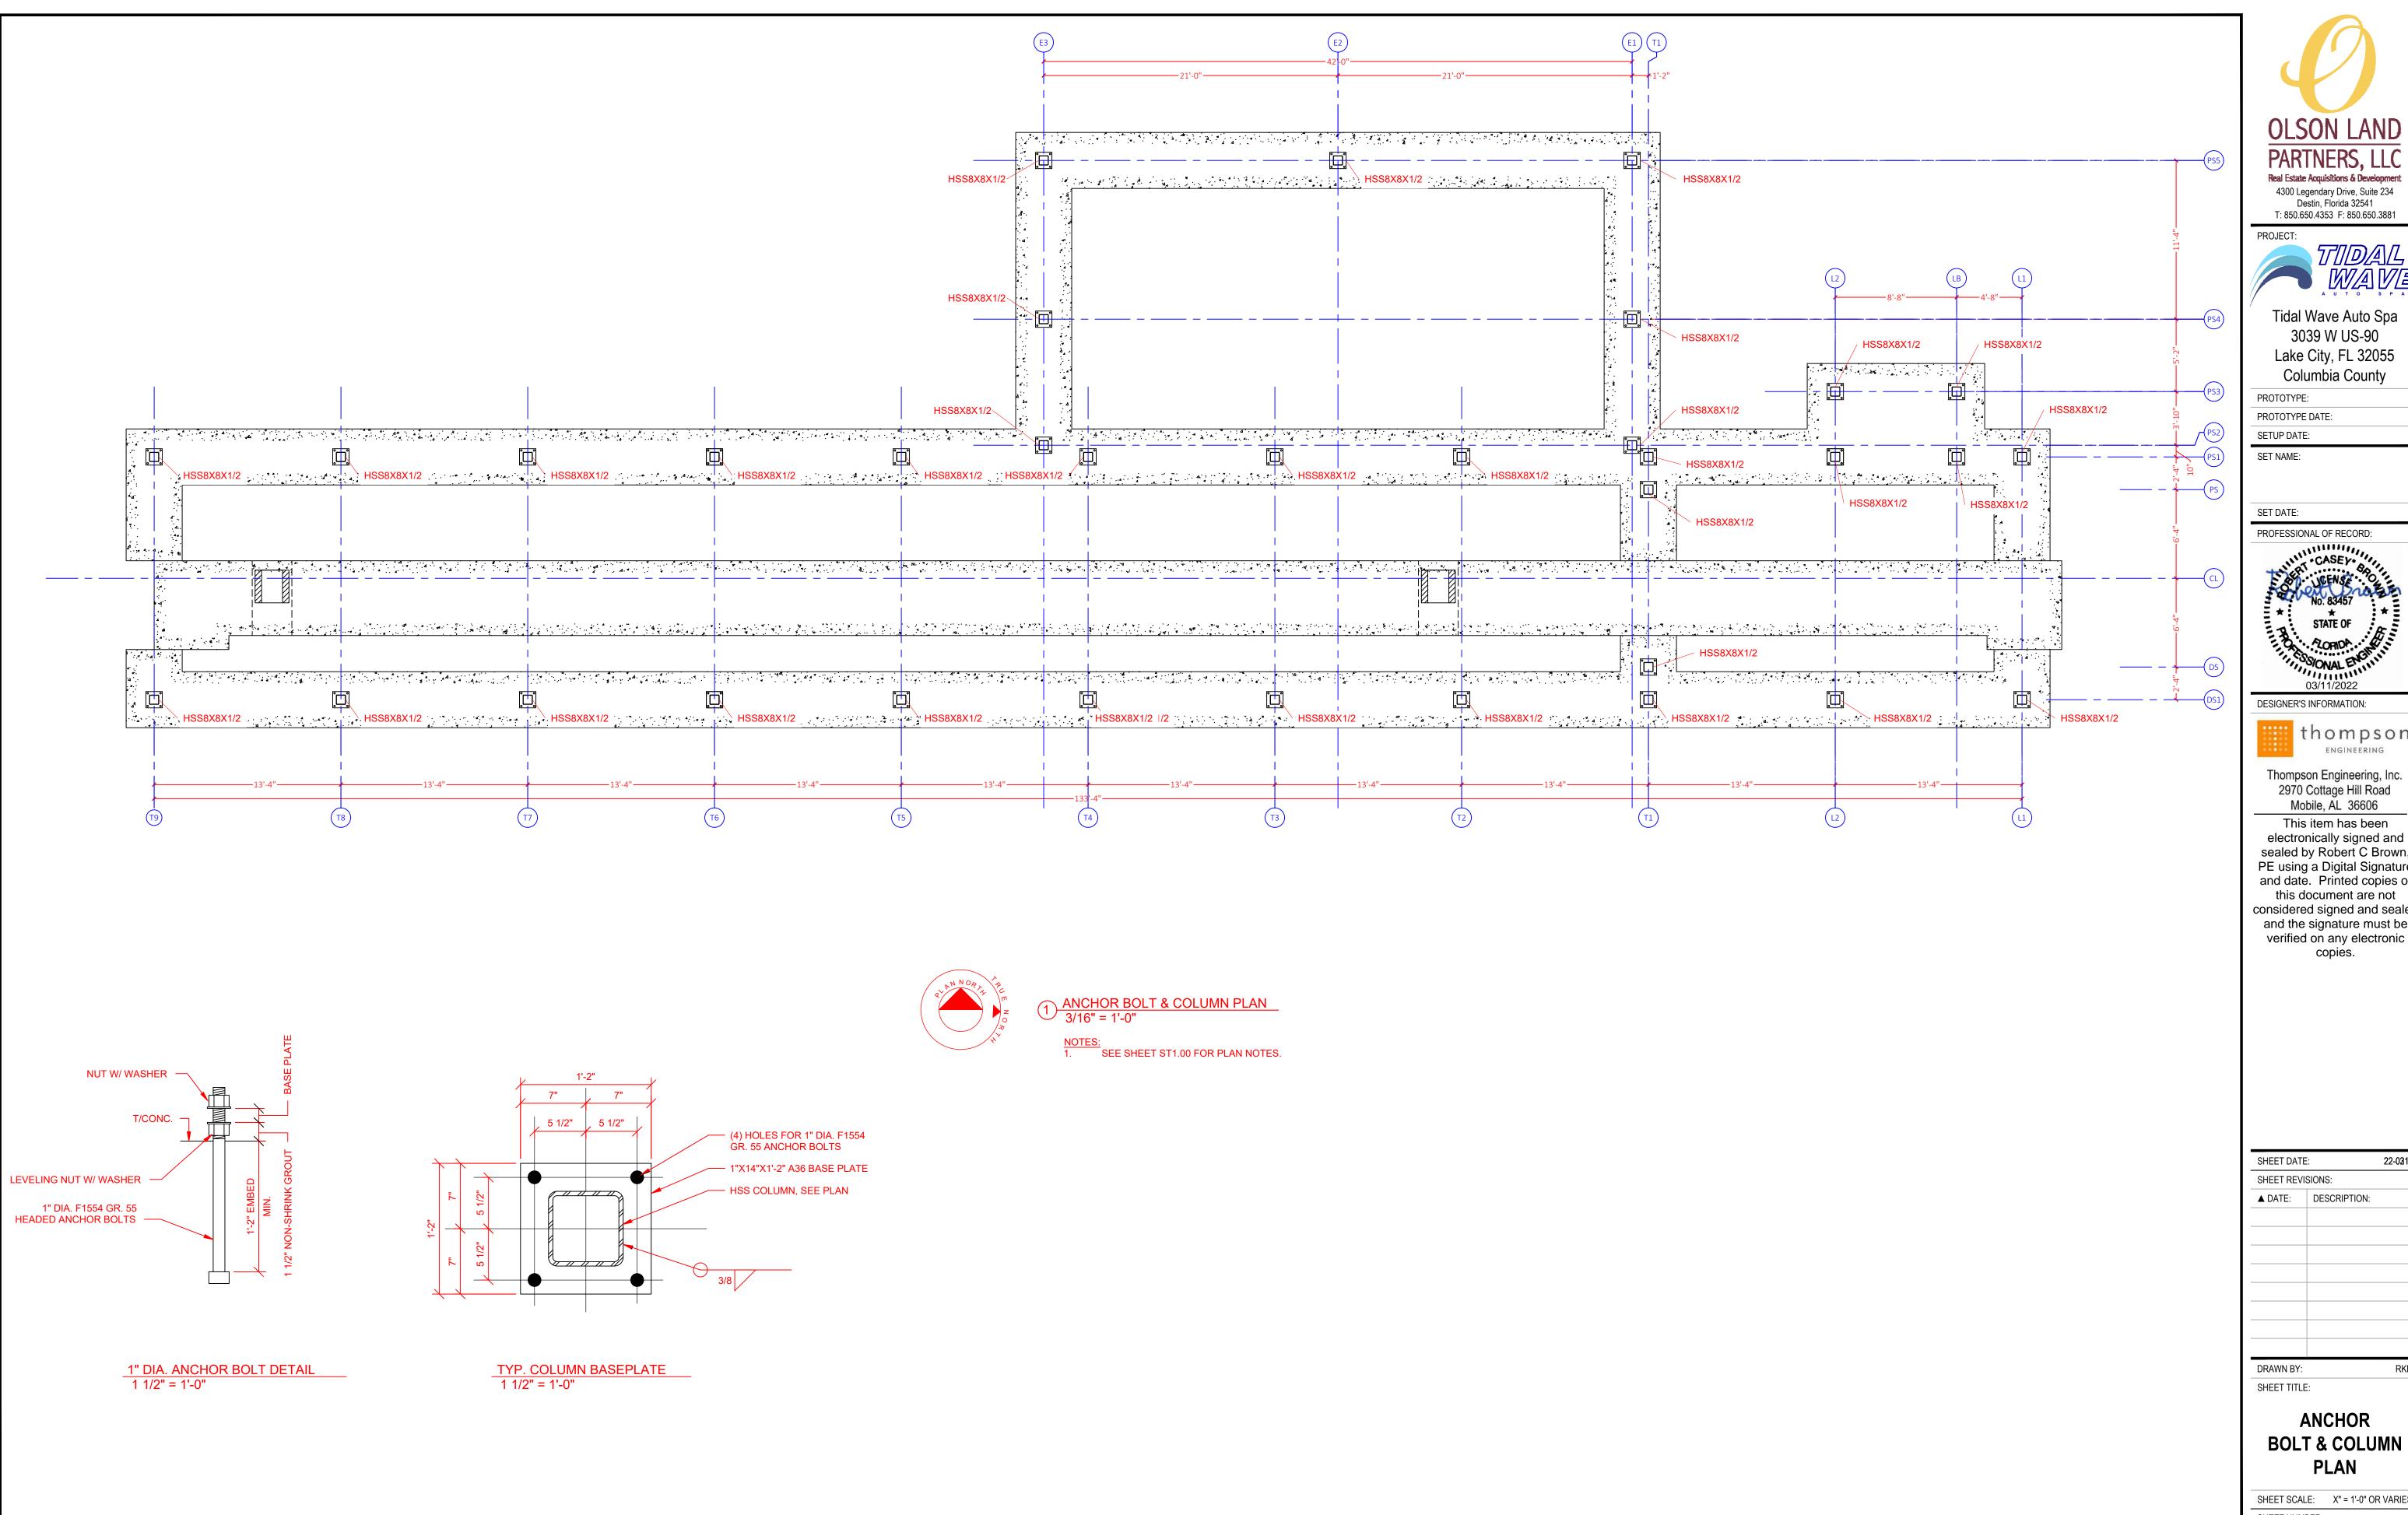
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FOUNDATION & TRENCH BOTTOM **PLAN**

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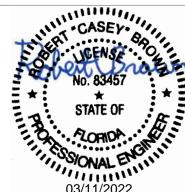




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Tidal Wave Auto Spa 3039 W US-90 Lake City, FL 32055 Columbia County

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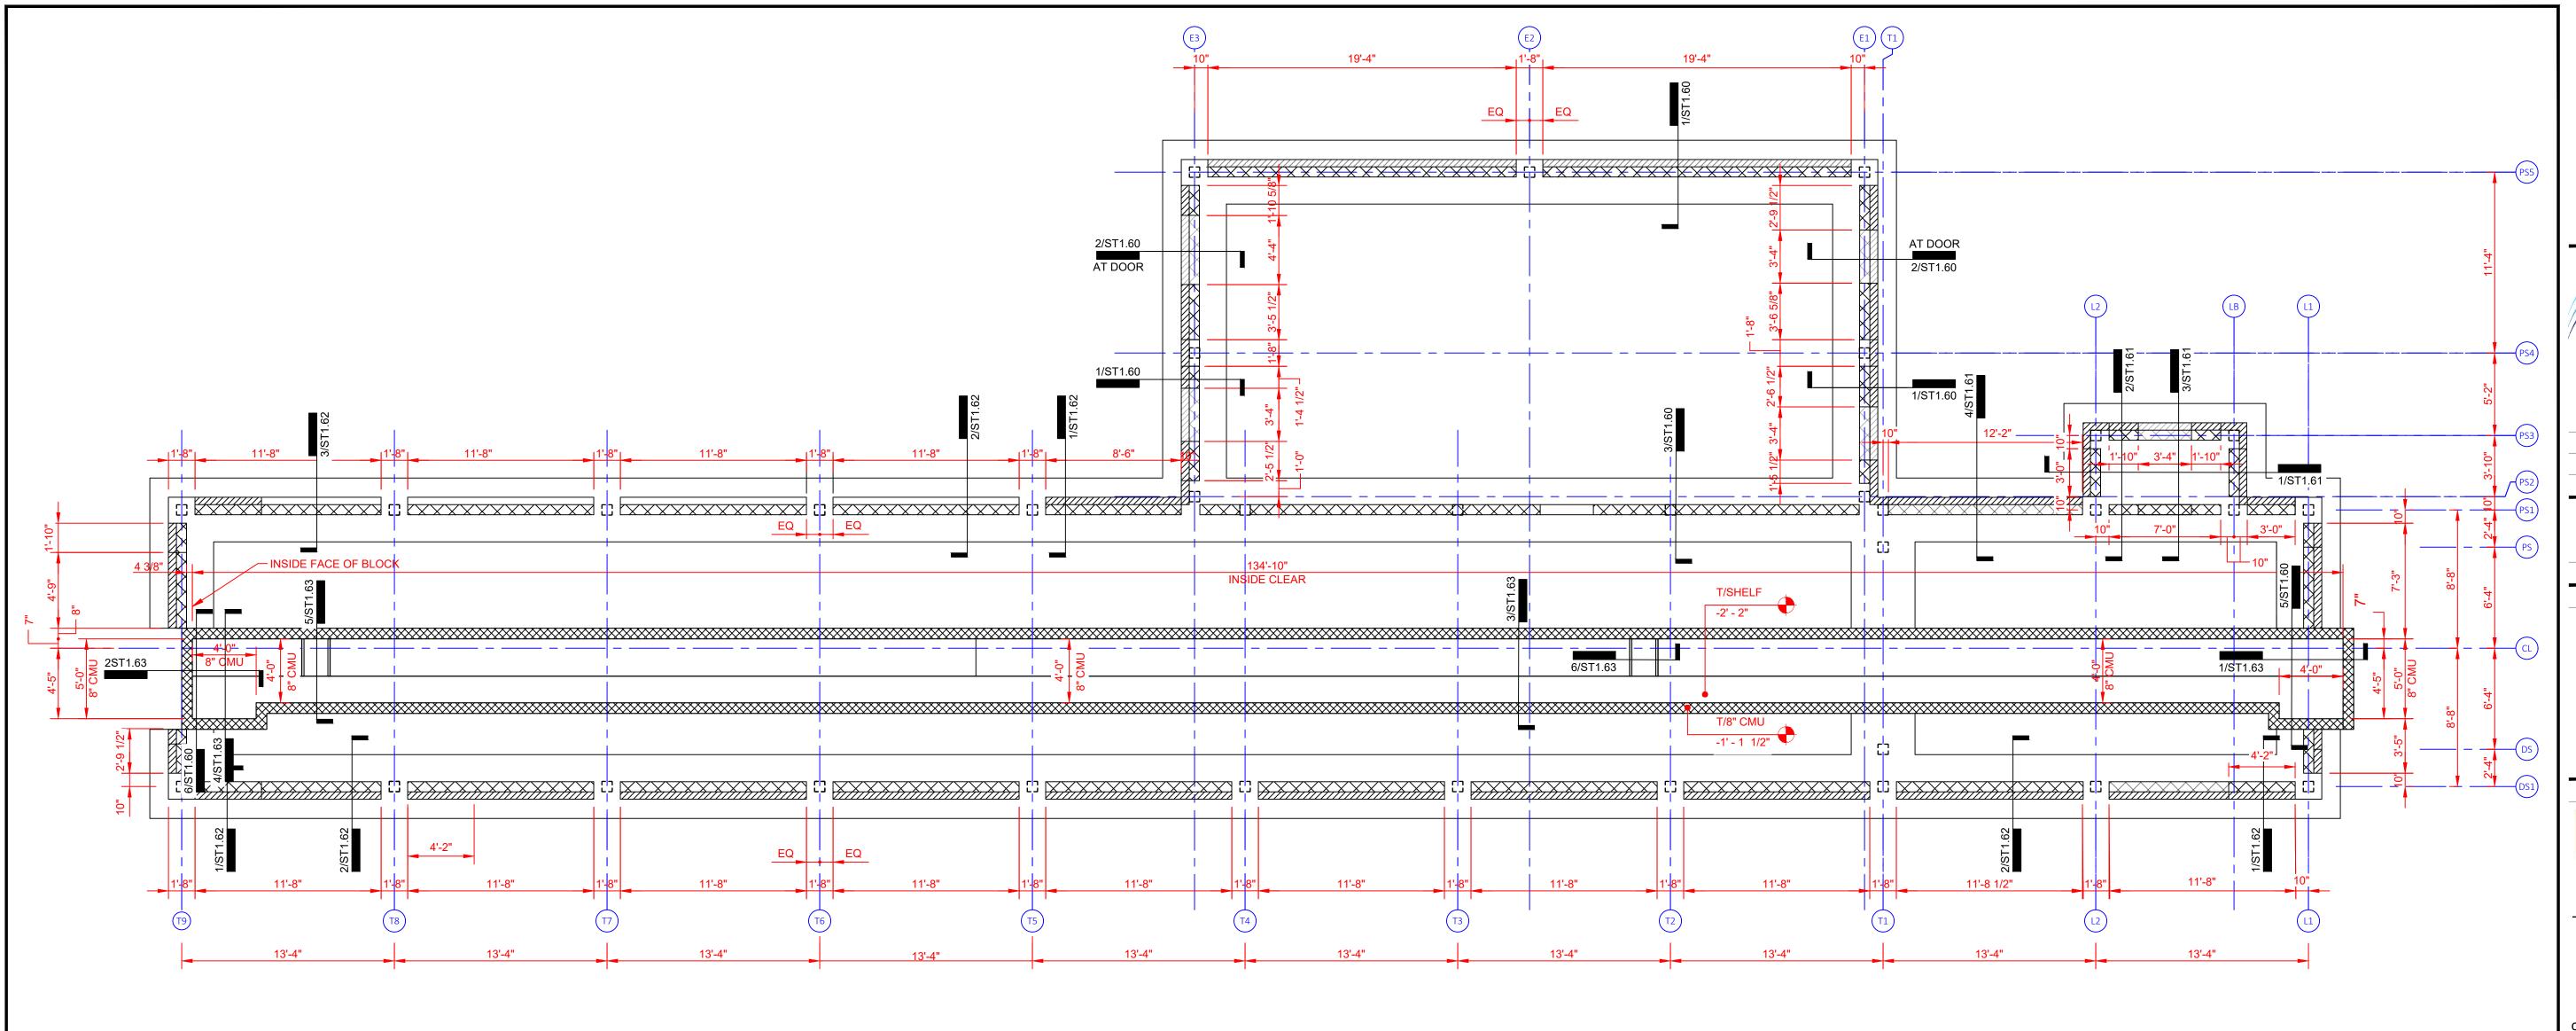
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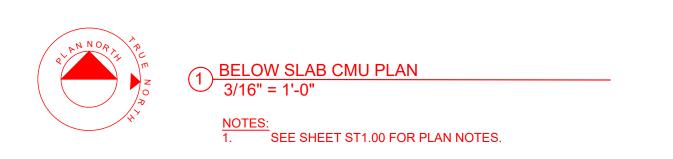
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ANCHOR BOLT & COLUMN PLAN

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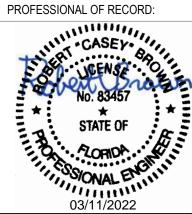


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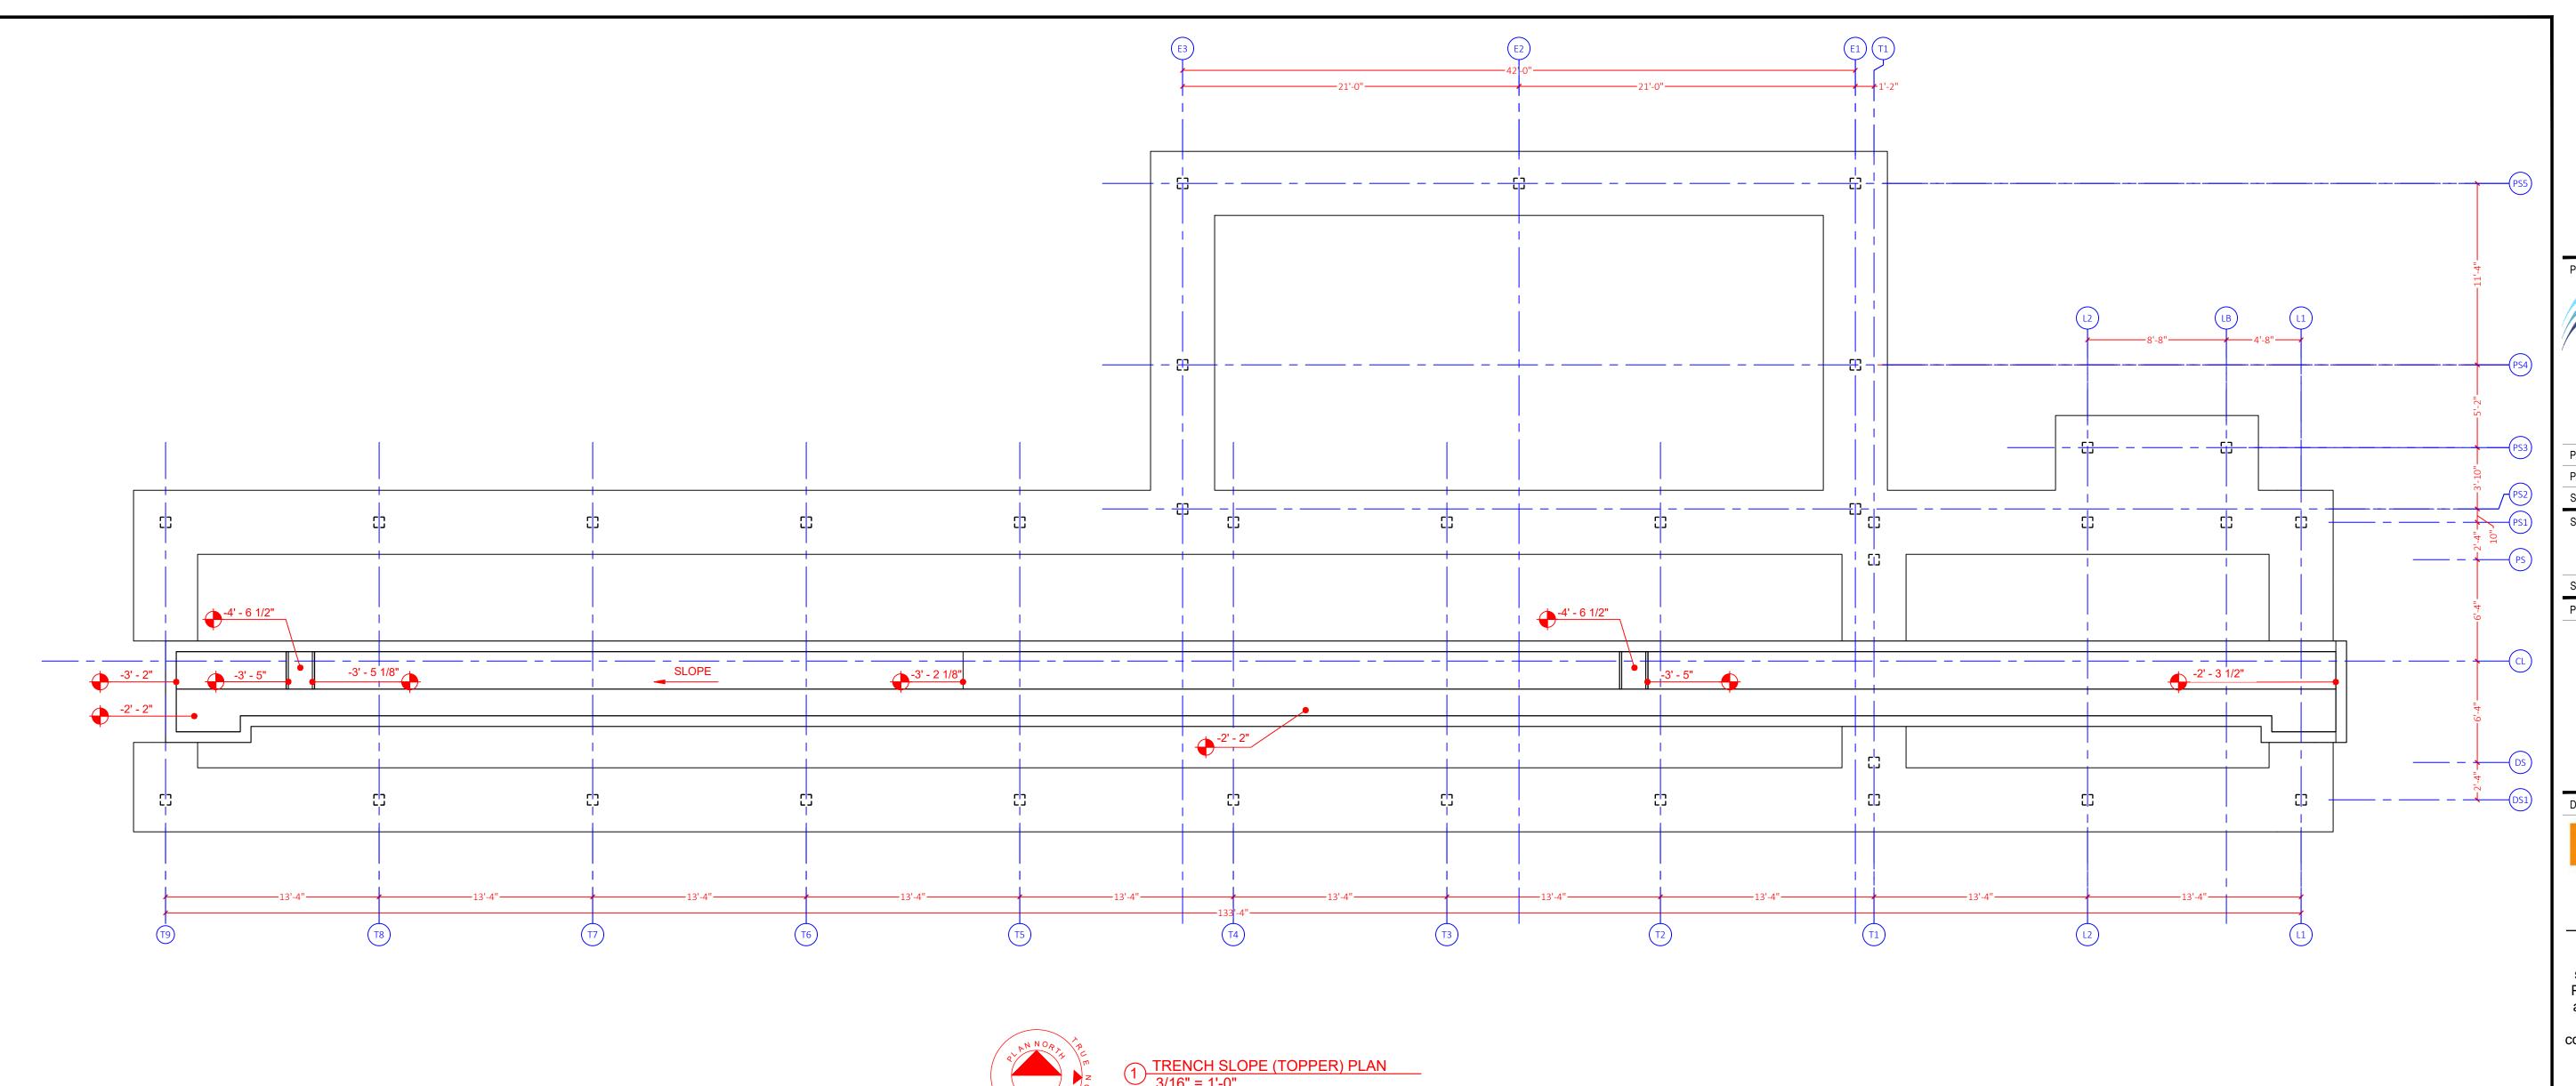
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> **BELOW SLAB CMU PLAN**

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TRENCH SLOPE (TOPPER)


PLAN

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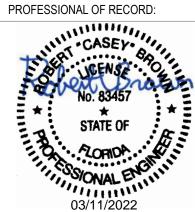
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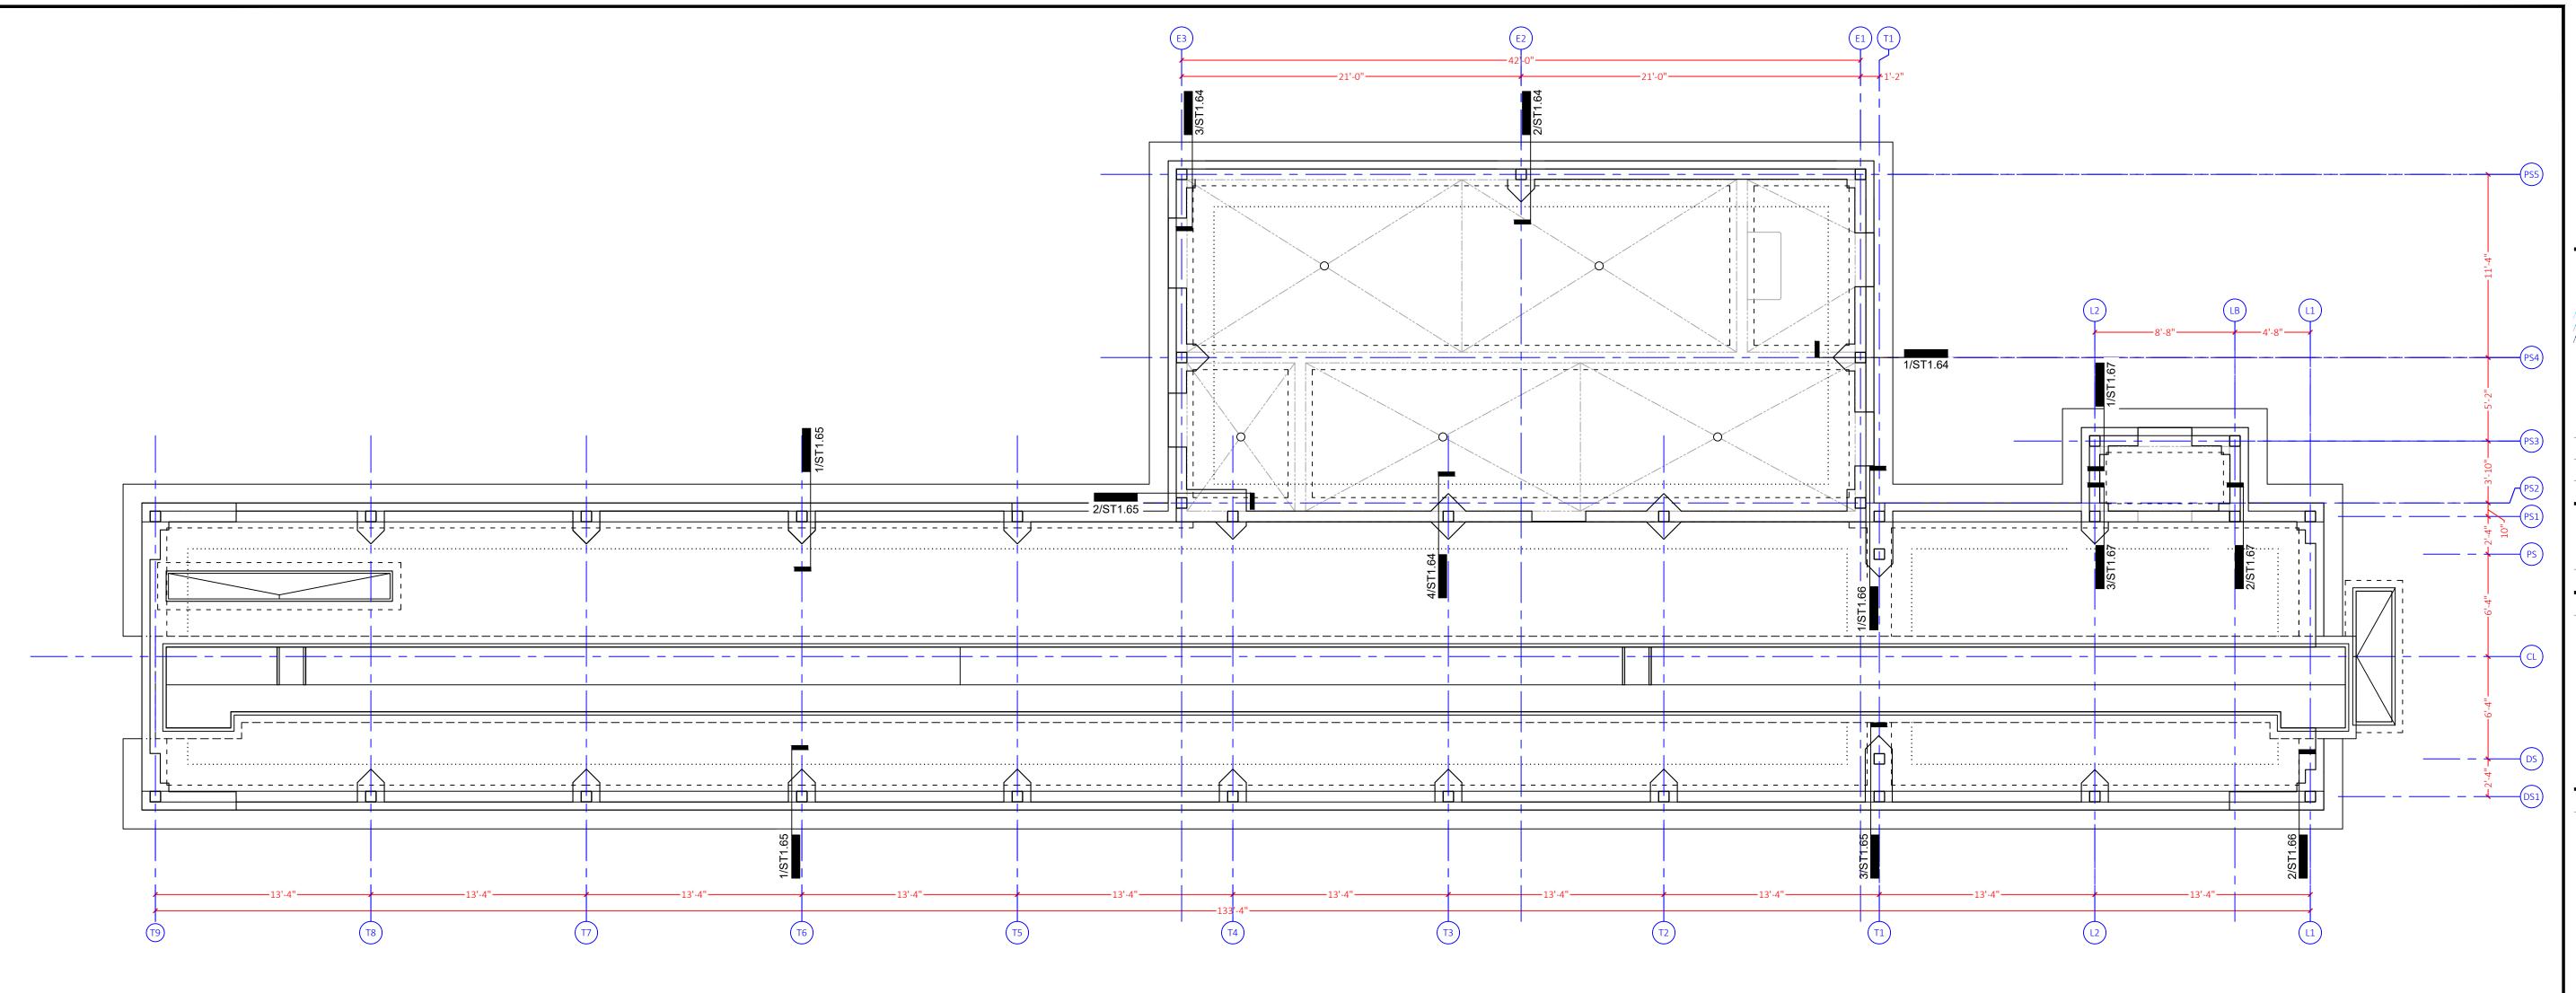
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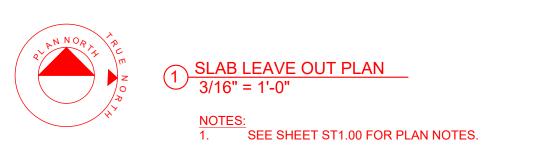
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SLAB PLAN

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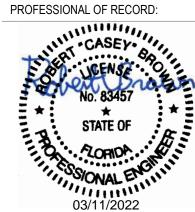
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SLAB LEAVE OUT PLAN


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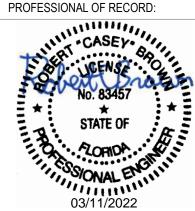
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OLSON LAND

TIDAL WAYE

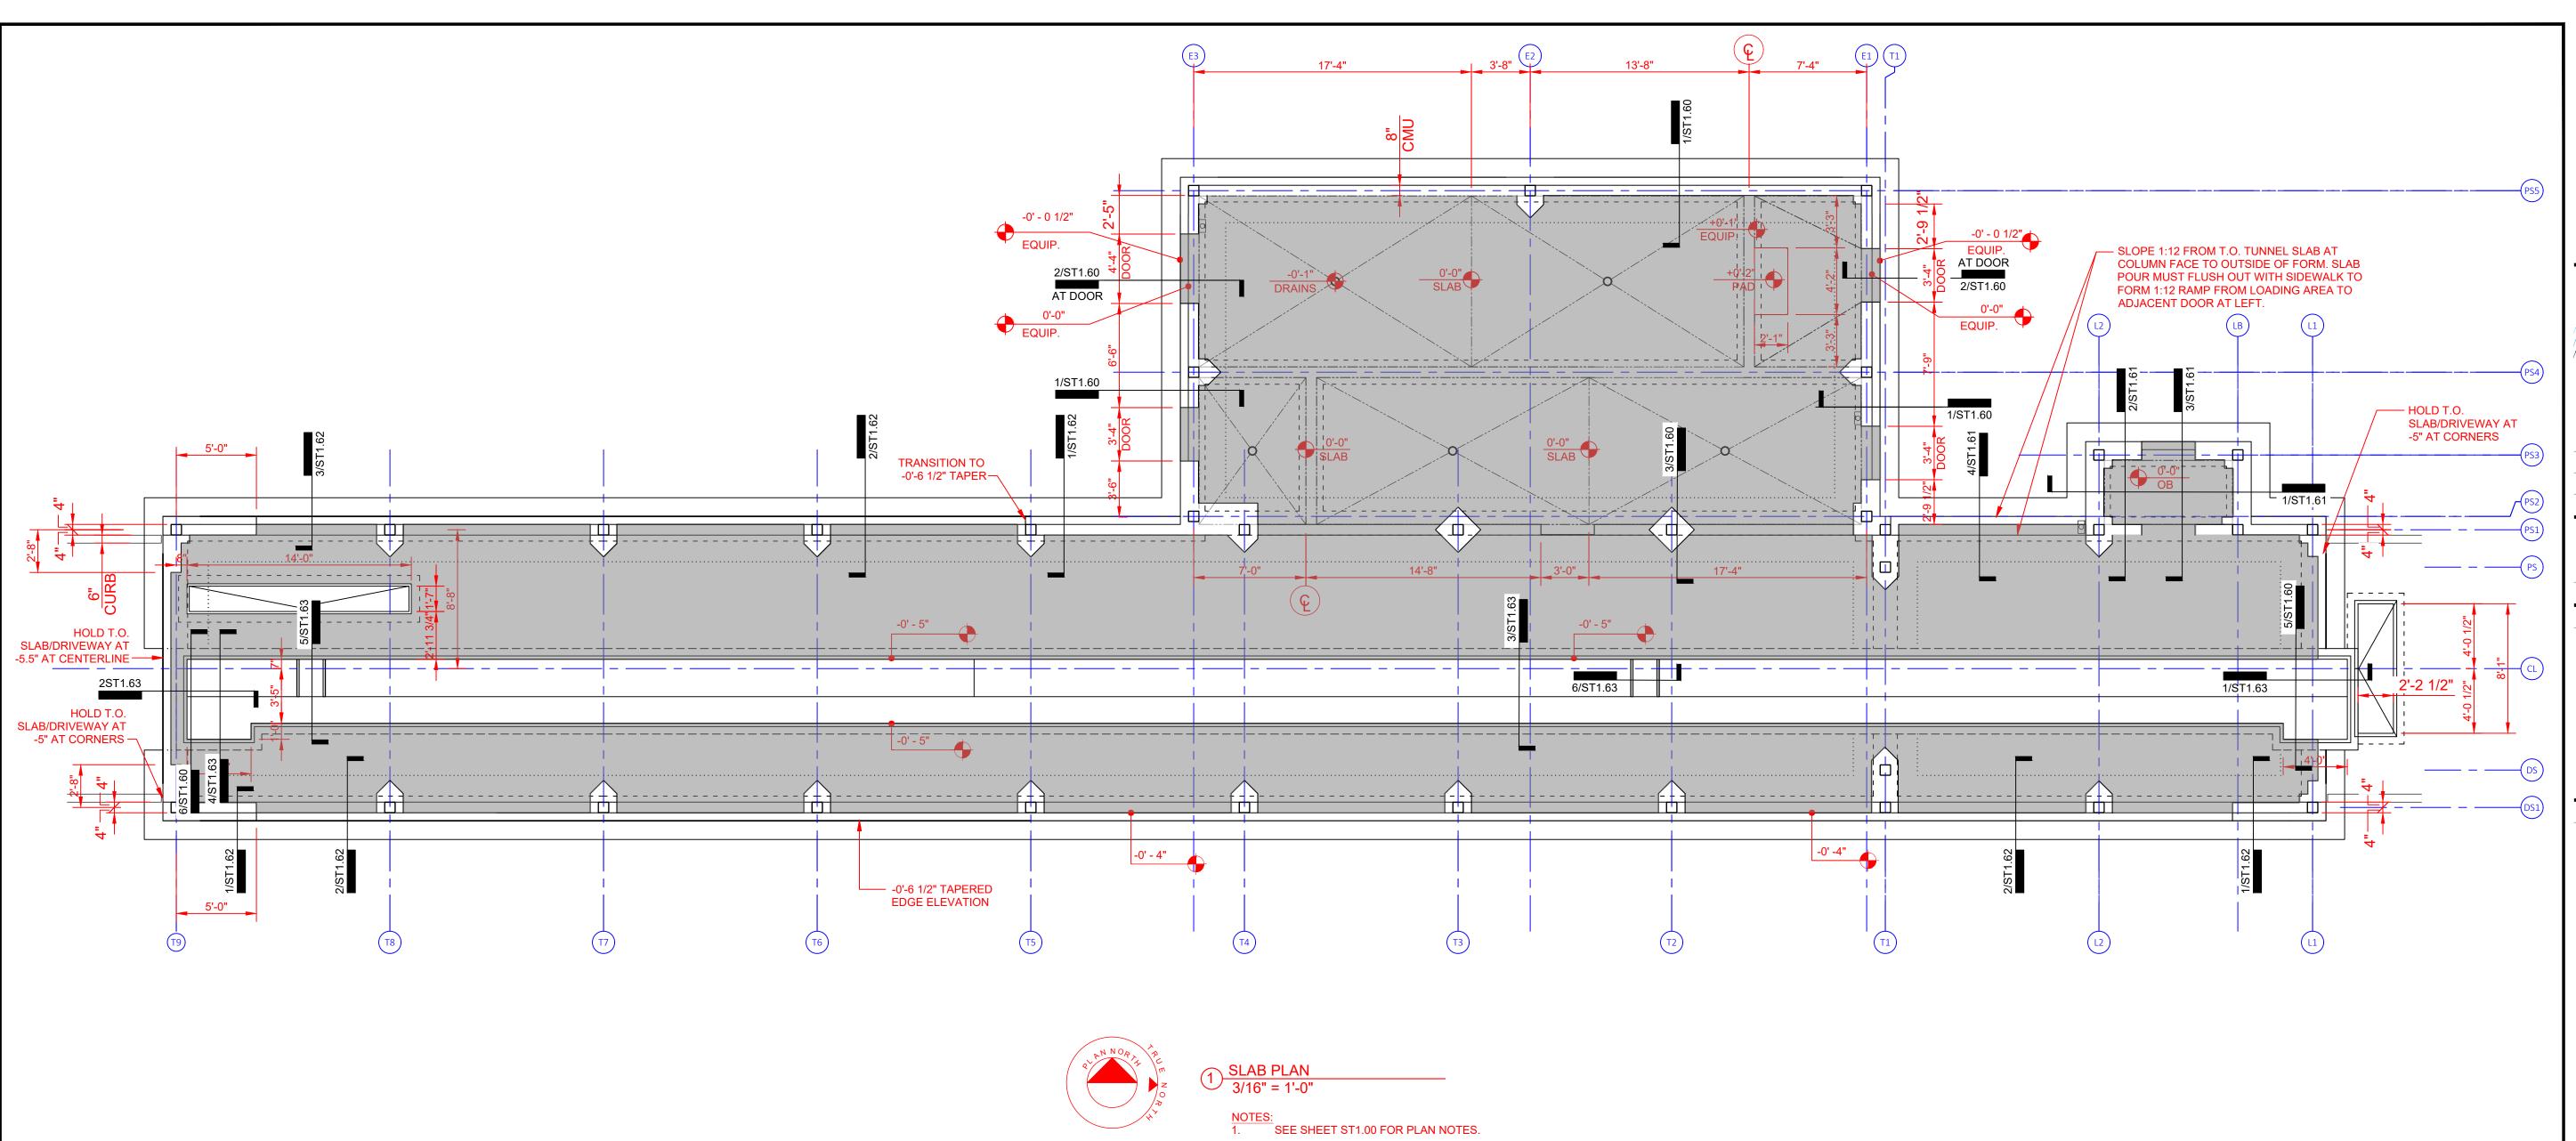Tidal Wave Auto Spa 3039 W US-90 Lake City, FL 32055 Columbia County




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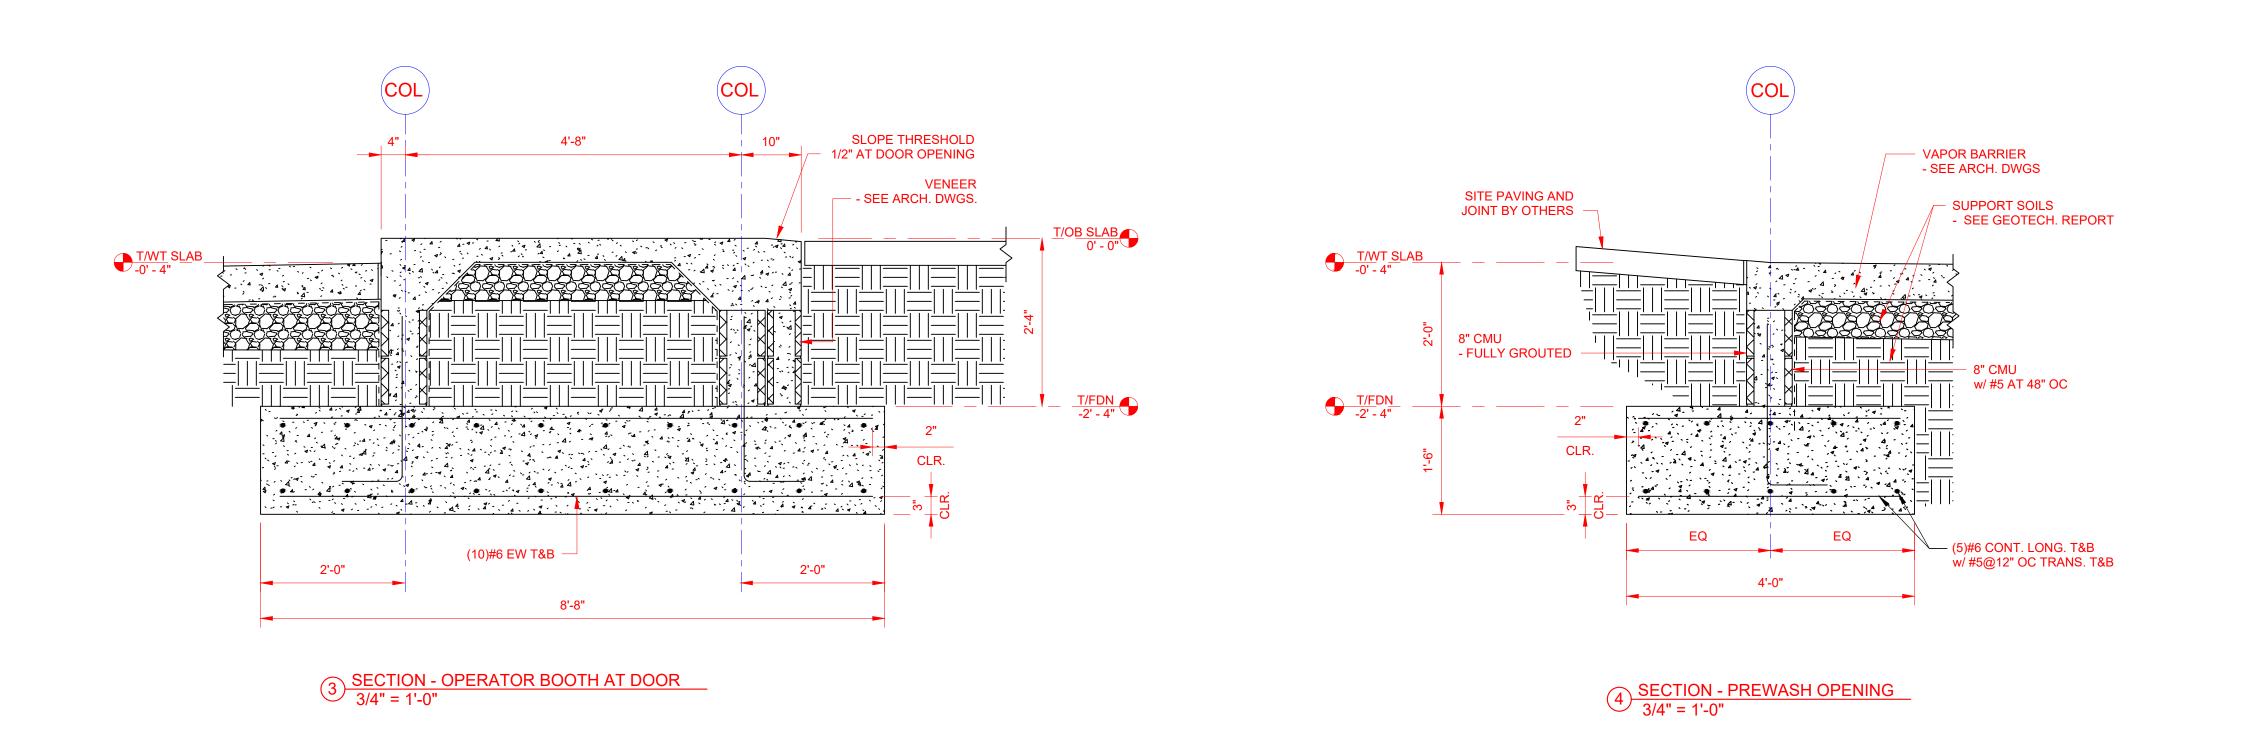
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WASH TUNNEL FOUNDATION & SLAB SECTIONS & DETAILS

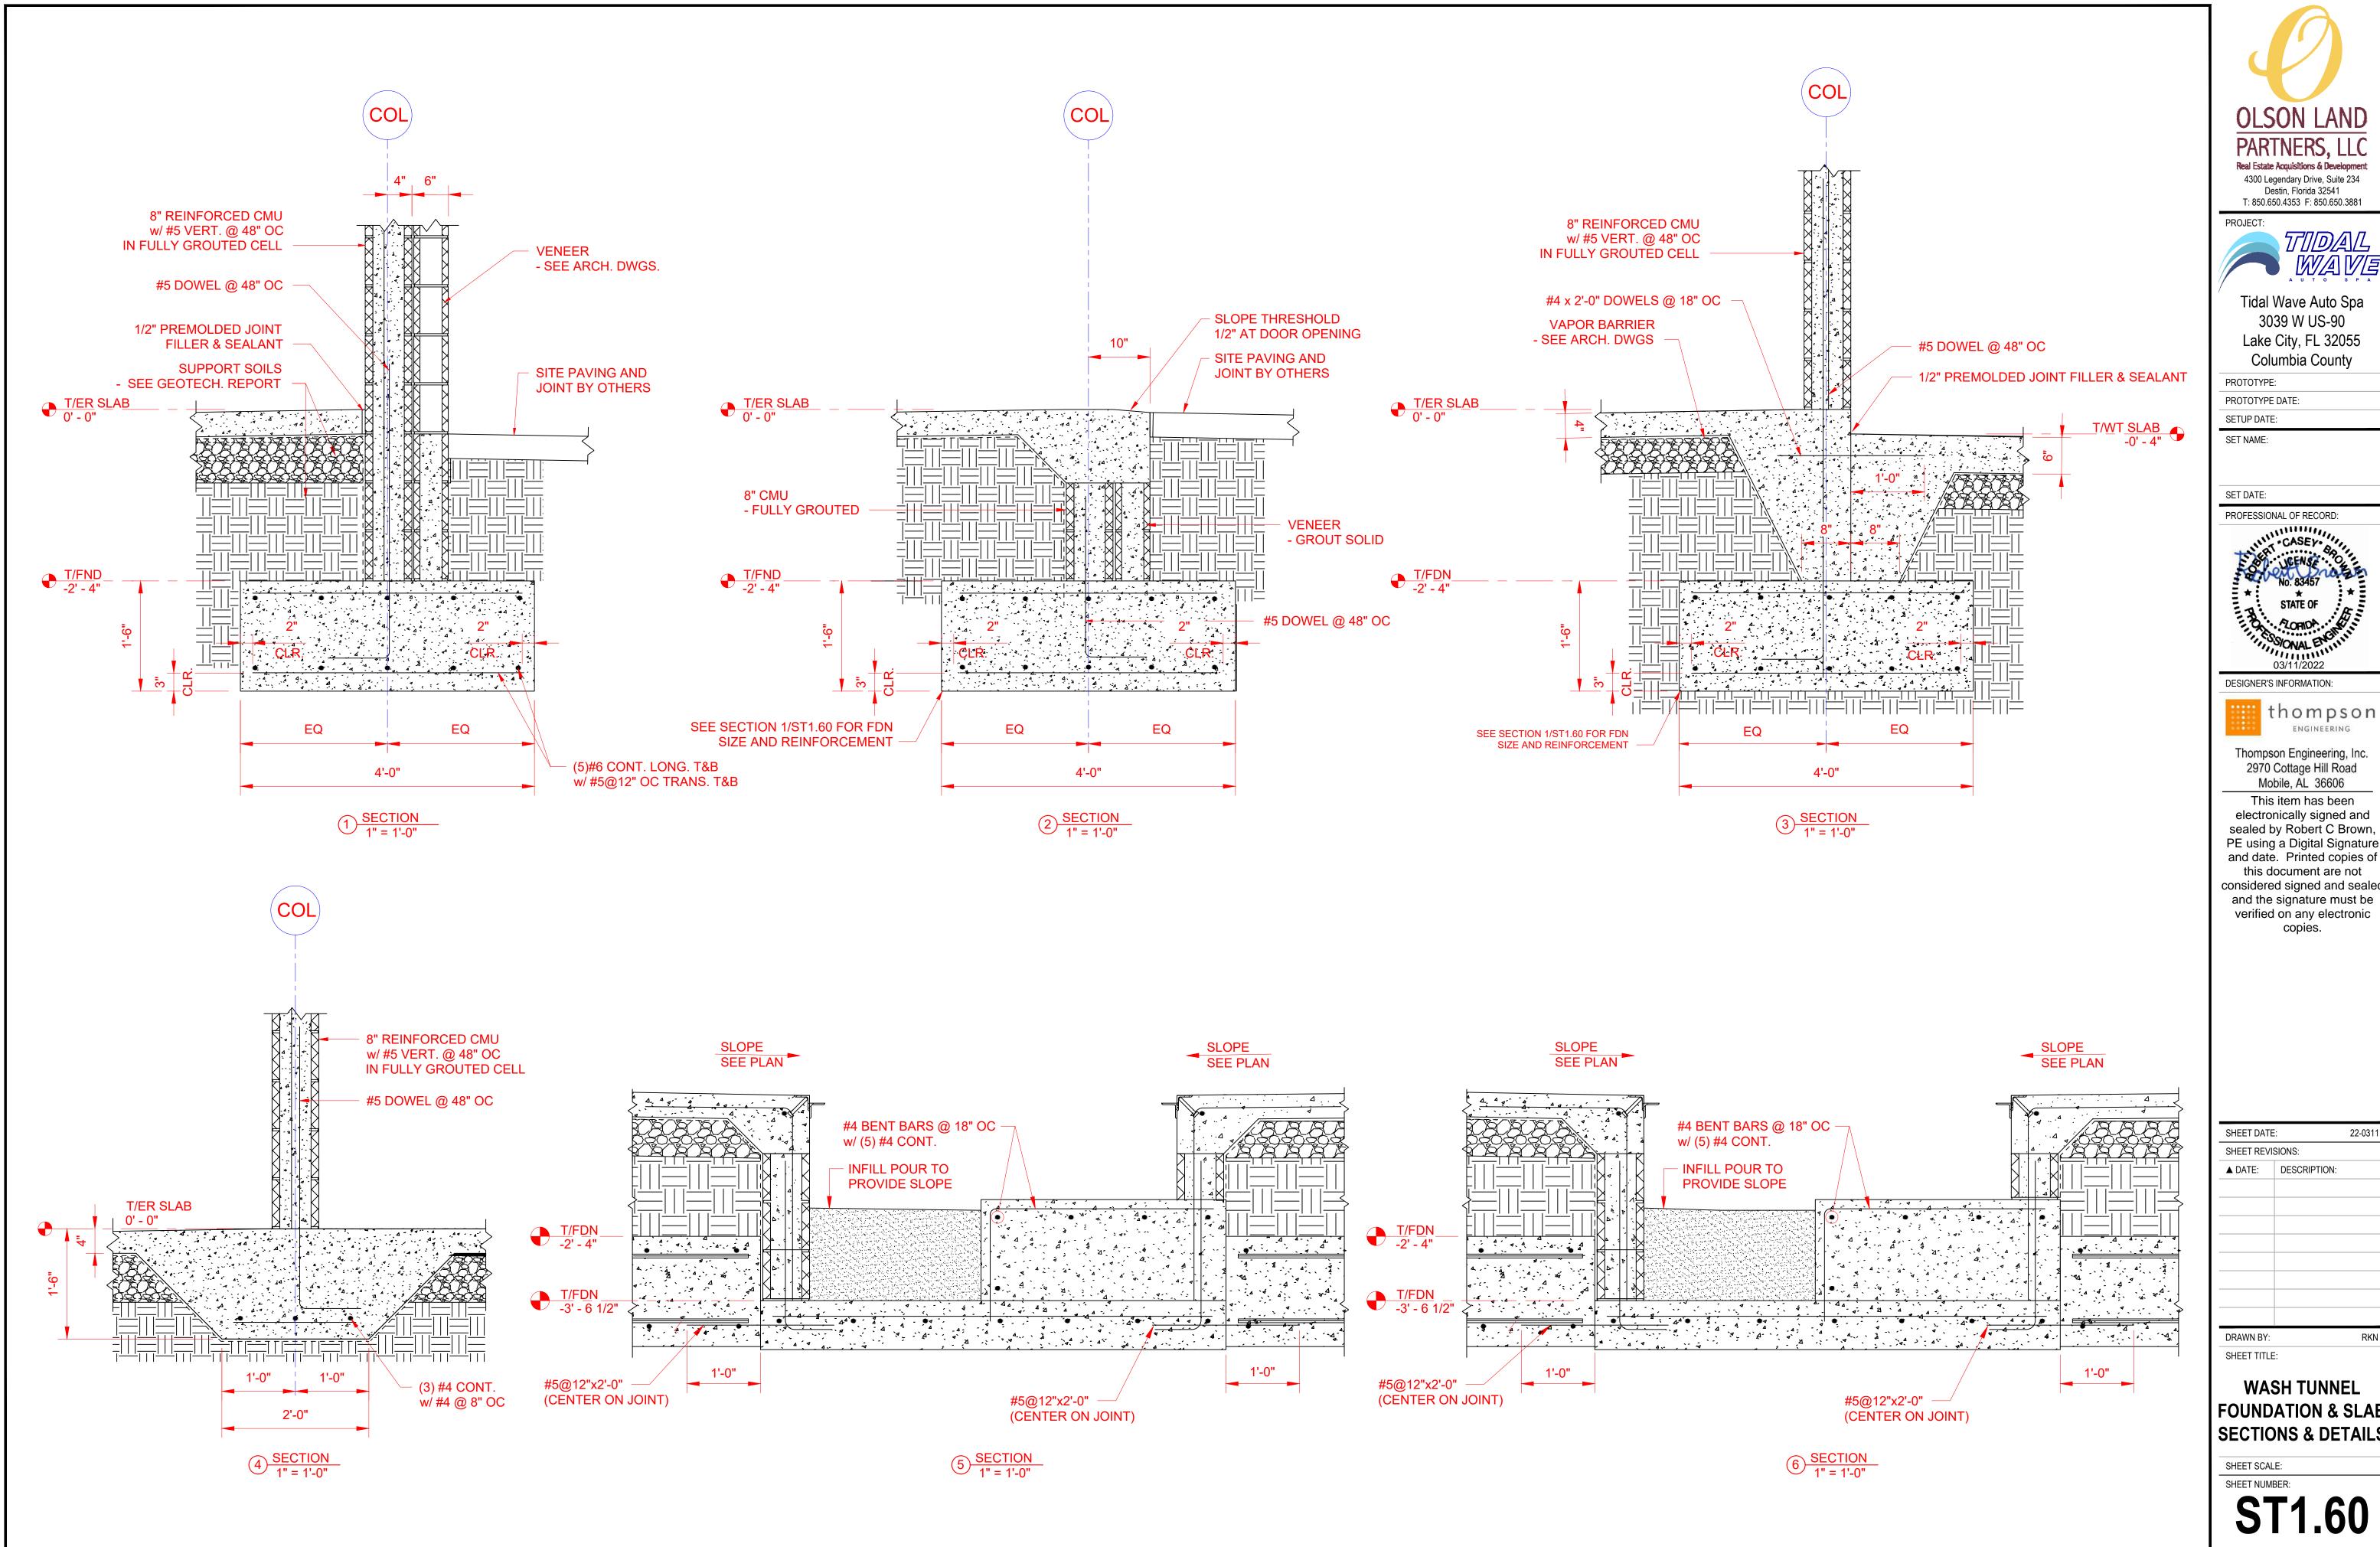



OLSON LAND
PARTNERS, LLC
Real Estate Acquisitions & Development
4300 Legendary Drive, Suite 234
Destin, Florida 32541
T: 850.650.4353 F: 850.650.3881

PROJECT:

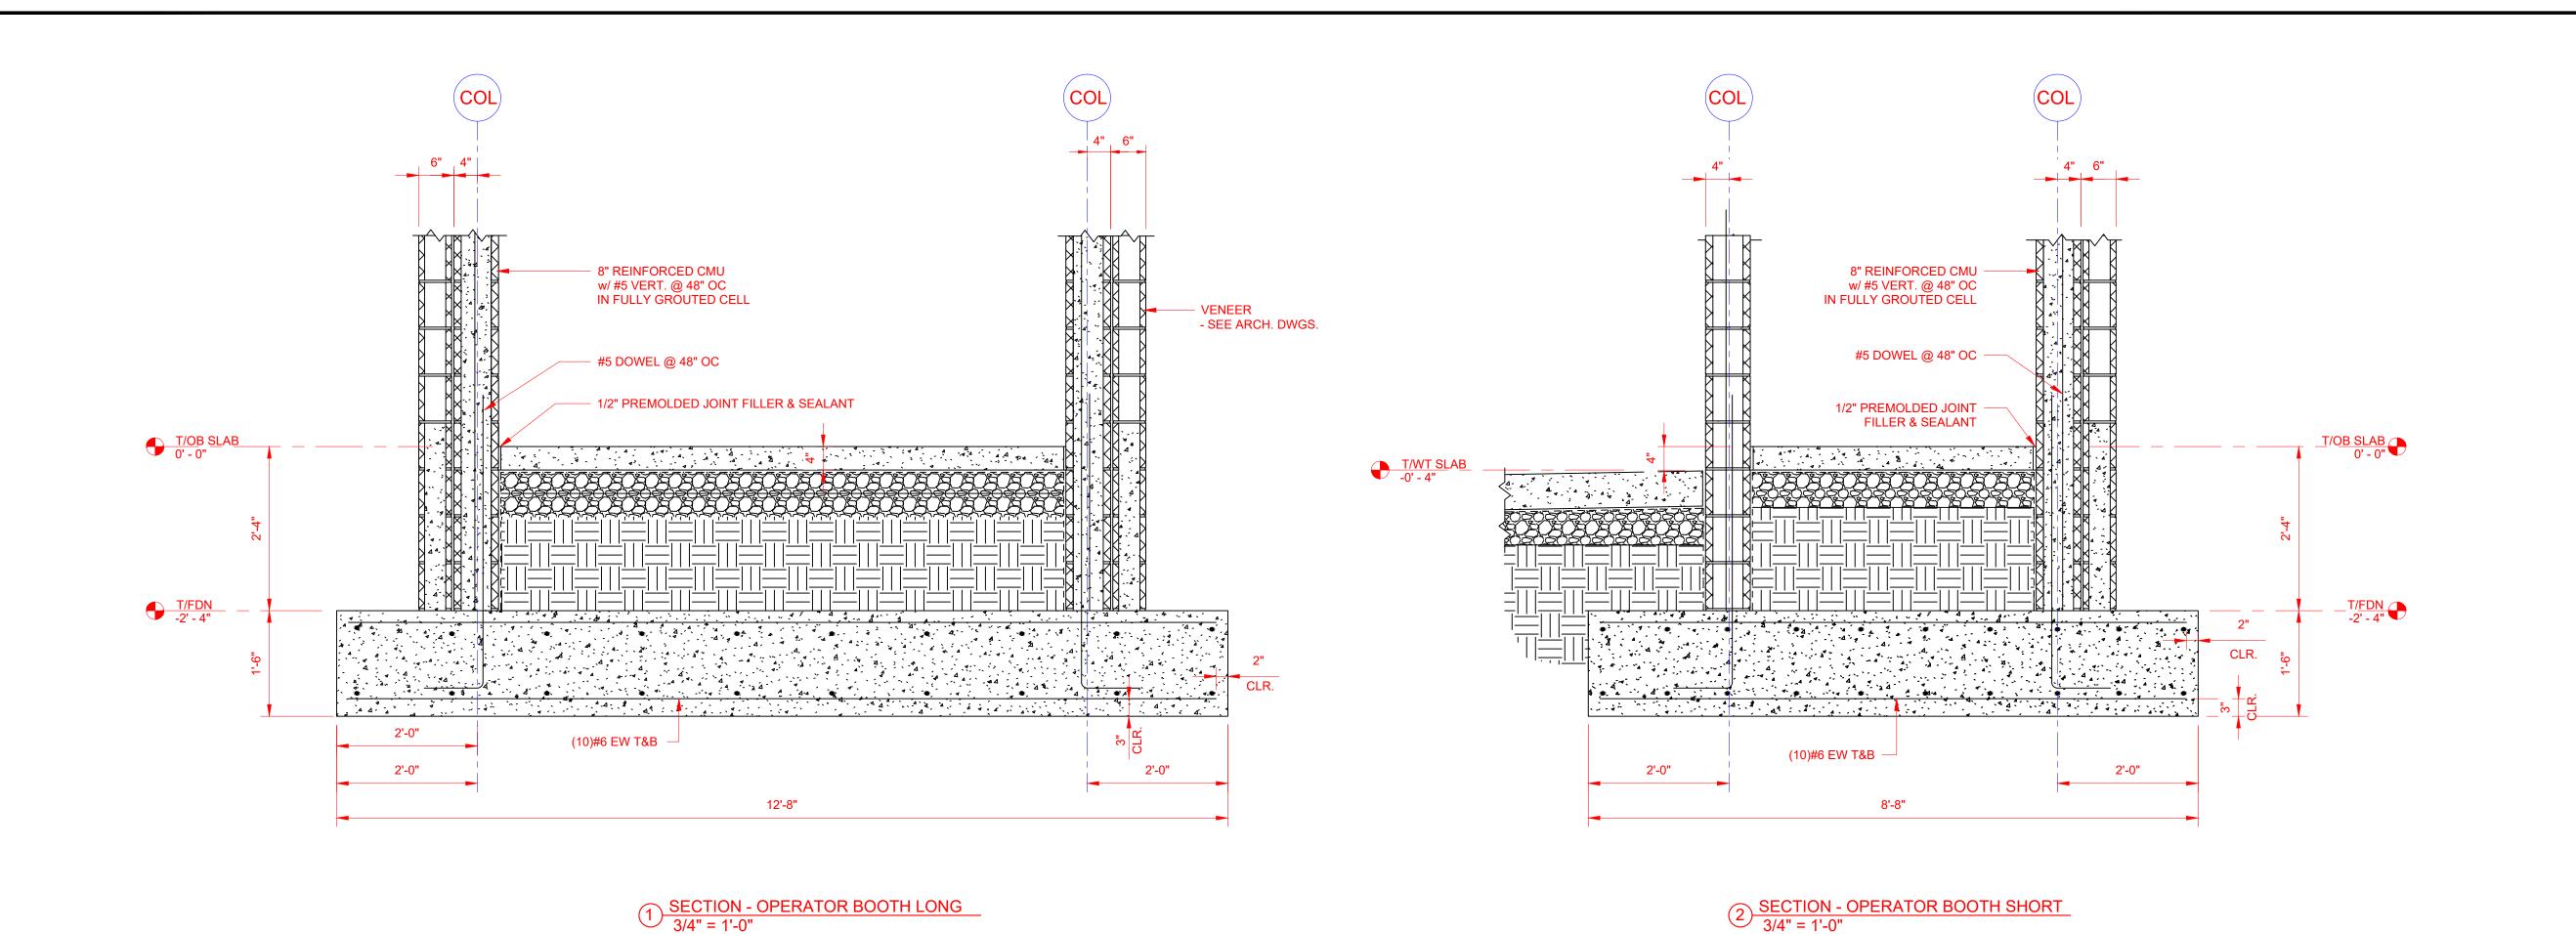TODAL

AUTORIAN SERVICE

AUTORIAN SERV

Tidal Wave Auto Spa 3039 W US-90 Lake City, FL 32055 Columbia County


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WASH TUNNEL FOUNDATION & SLAB


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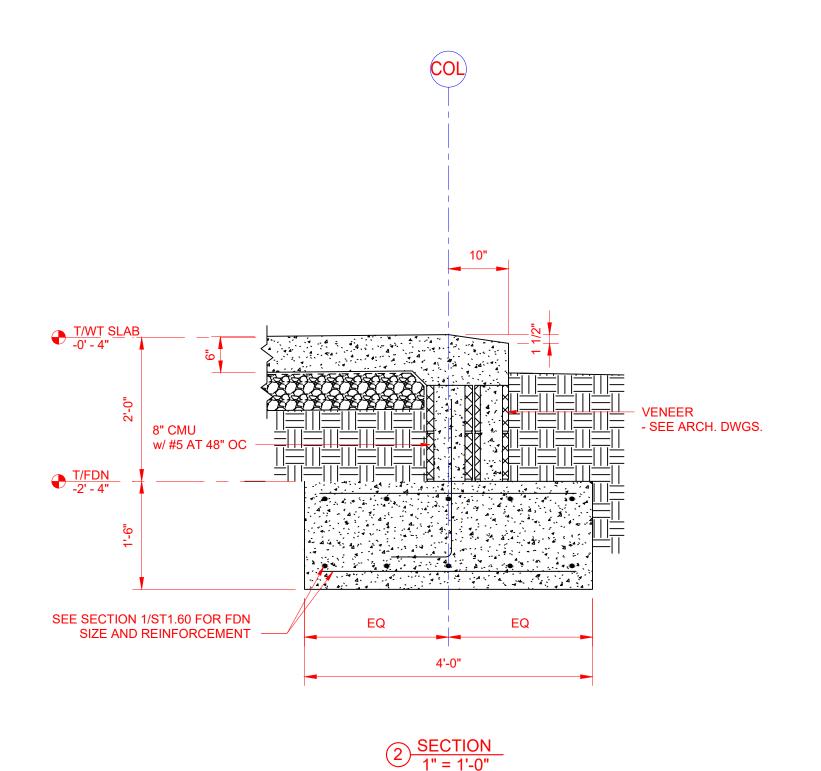
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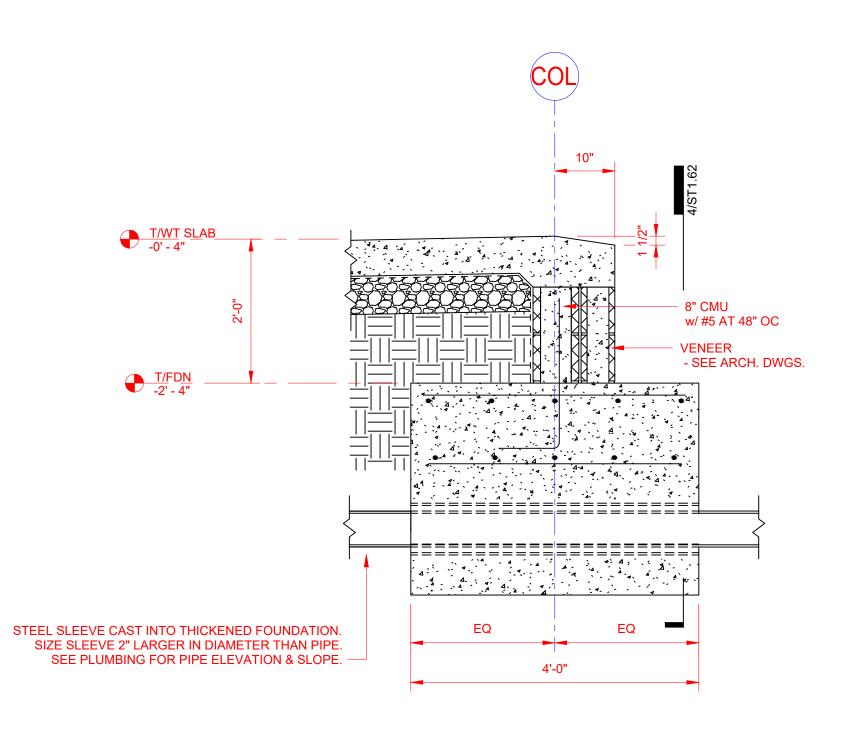
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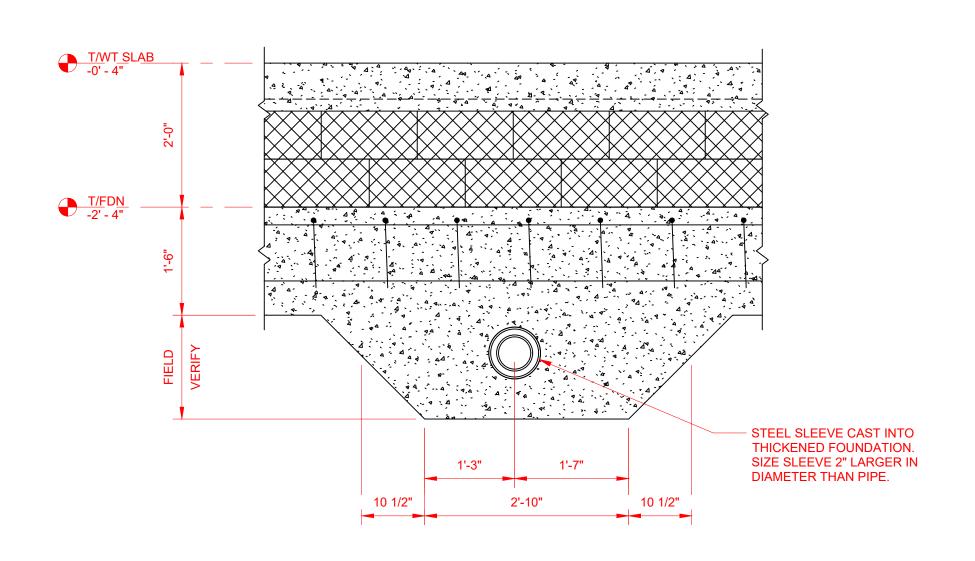
SHEET NUMBER:

ST1.6





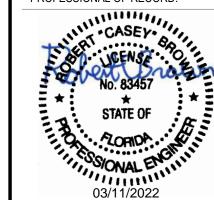

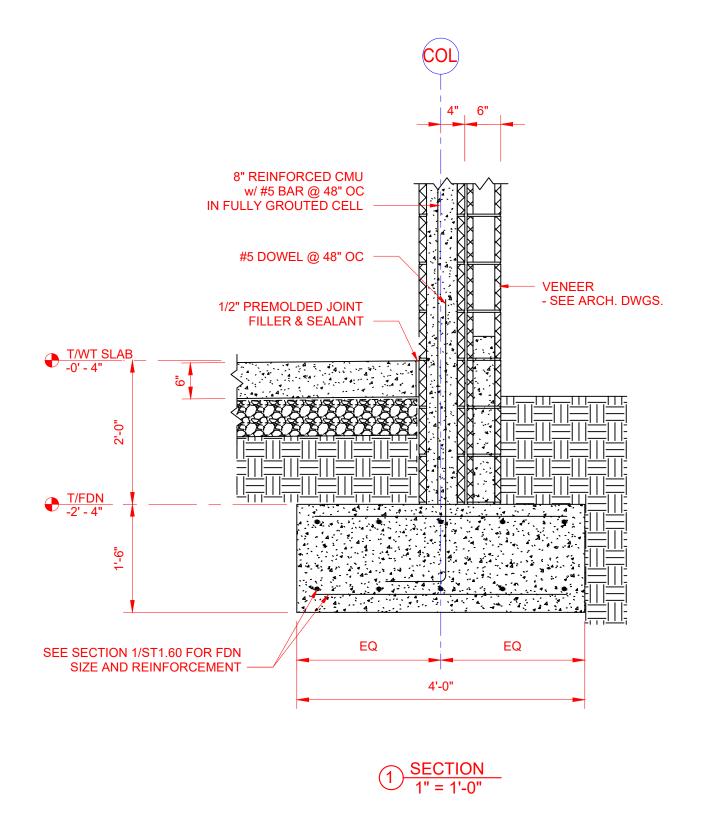

3 SECTION - PIPE PENETRATION
3/4" = 1'-0"

4 SECTION - PIPE PENETRATION FACE
3/4" = 1'-0"

OLSON LAND
PARTNERS, LLC
Real Estate Acquisitions & Development
4300 Legendary Drive, Suite 234
Destin, Florida 32541
T: 850.650.4353 F: 850.650.3881

PROJECT:

TIDAL

WALL

S P

Tidal Wave Auto Spa 3039 W US-90 Lake City, FL 32055 Columbia County

PROTOTYPE:

PROTOTYPE DATE:

SETUP DATE:
SET NAME:

SET DATE:
PROFESSIONAL OF RECORD:



DESIGNER'S INFORMATION:



2970 Cottage Hill Road
Mobile, AL 36606

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▲ DATE:	DESCRIPTION:	
		DIAN


DRAWN BY:
SHEET TITLE:

WASH TUNNEL FOUNDATION & SLAB SECTIONS & DETAILS

SHEET SCALE:

SHEET NUMBER:


ST1.62

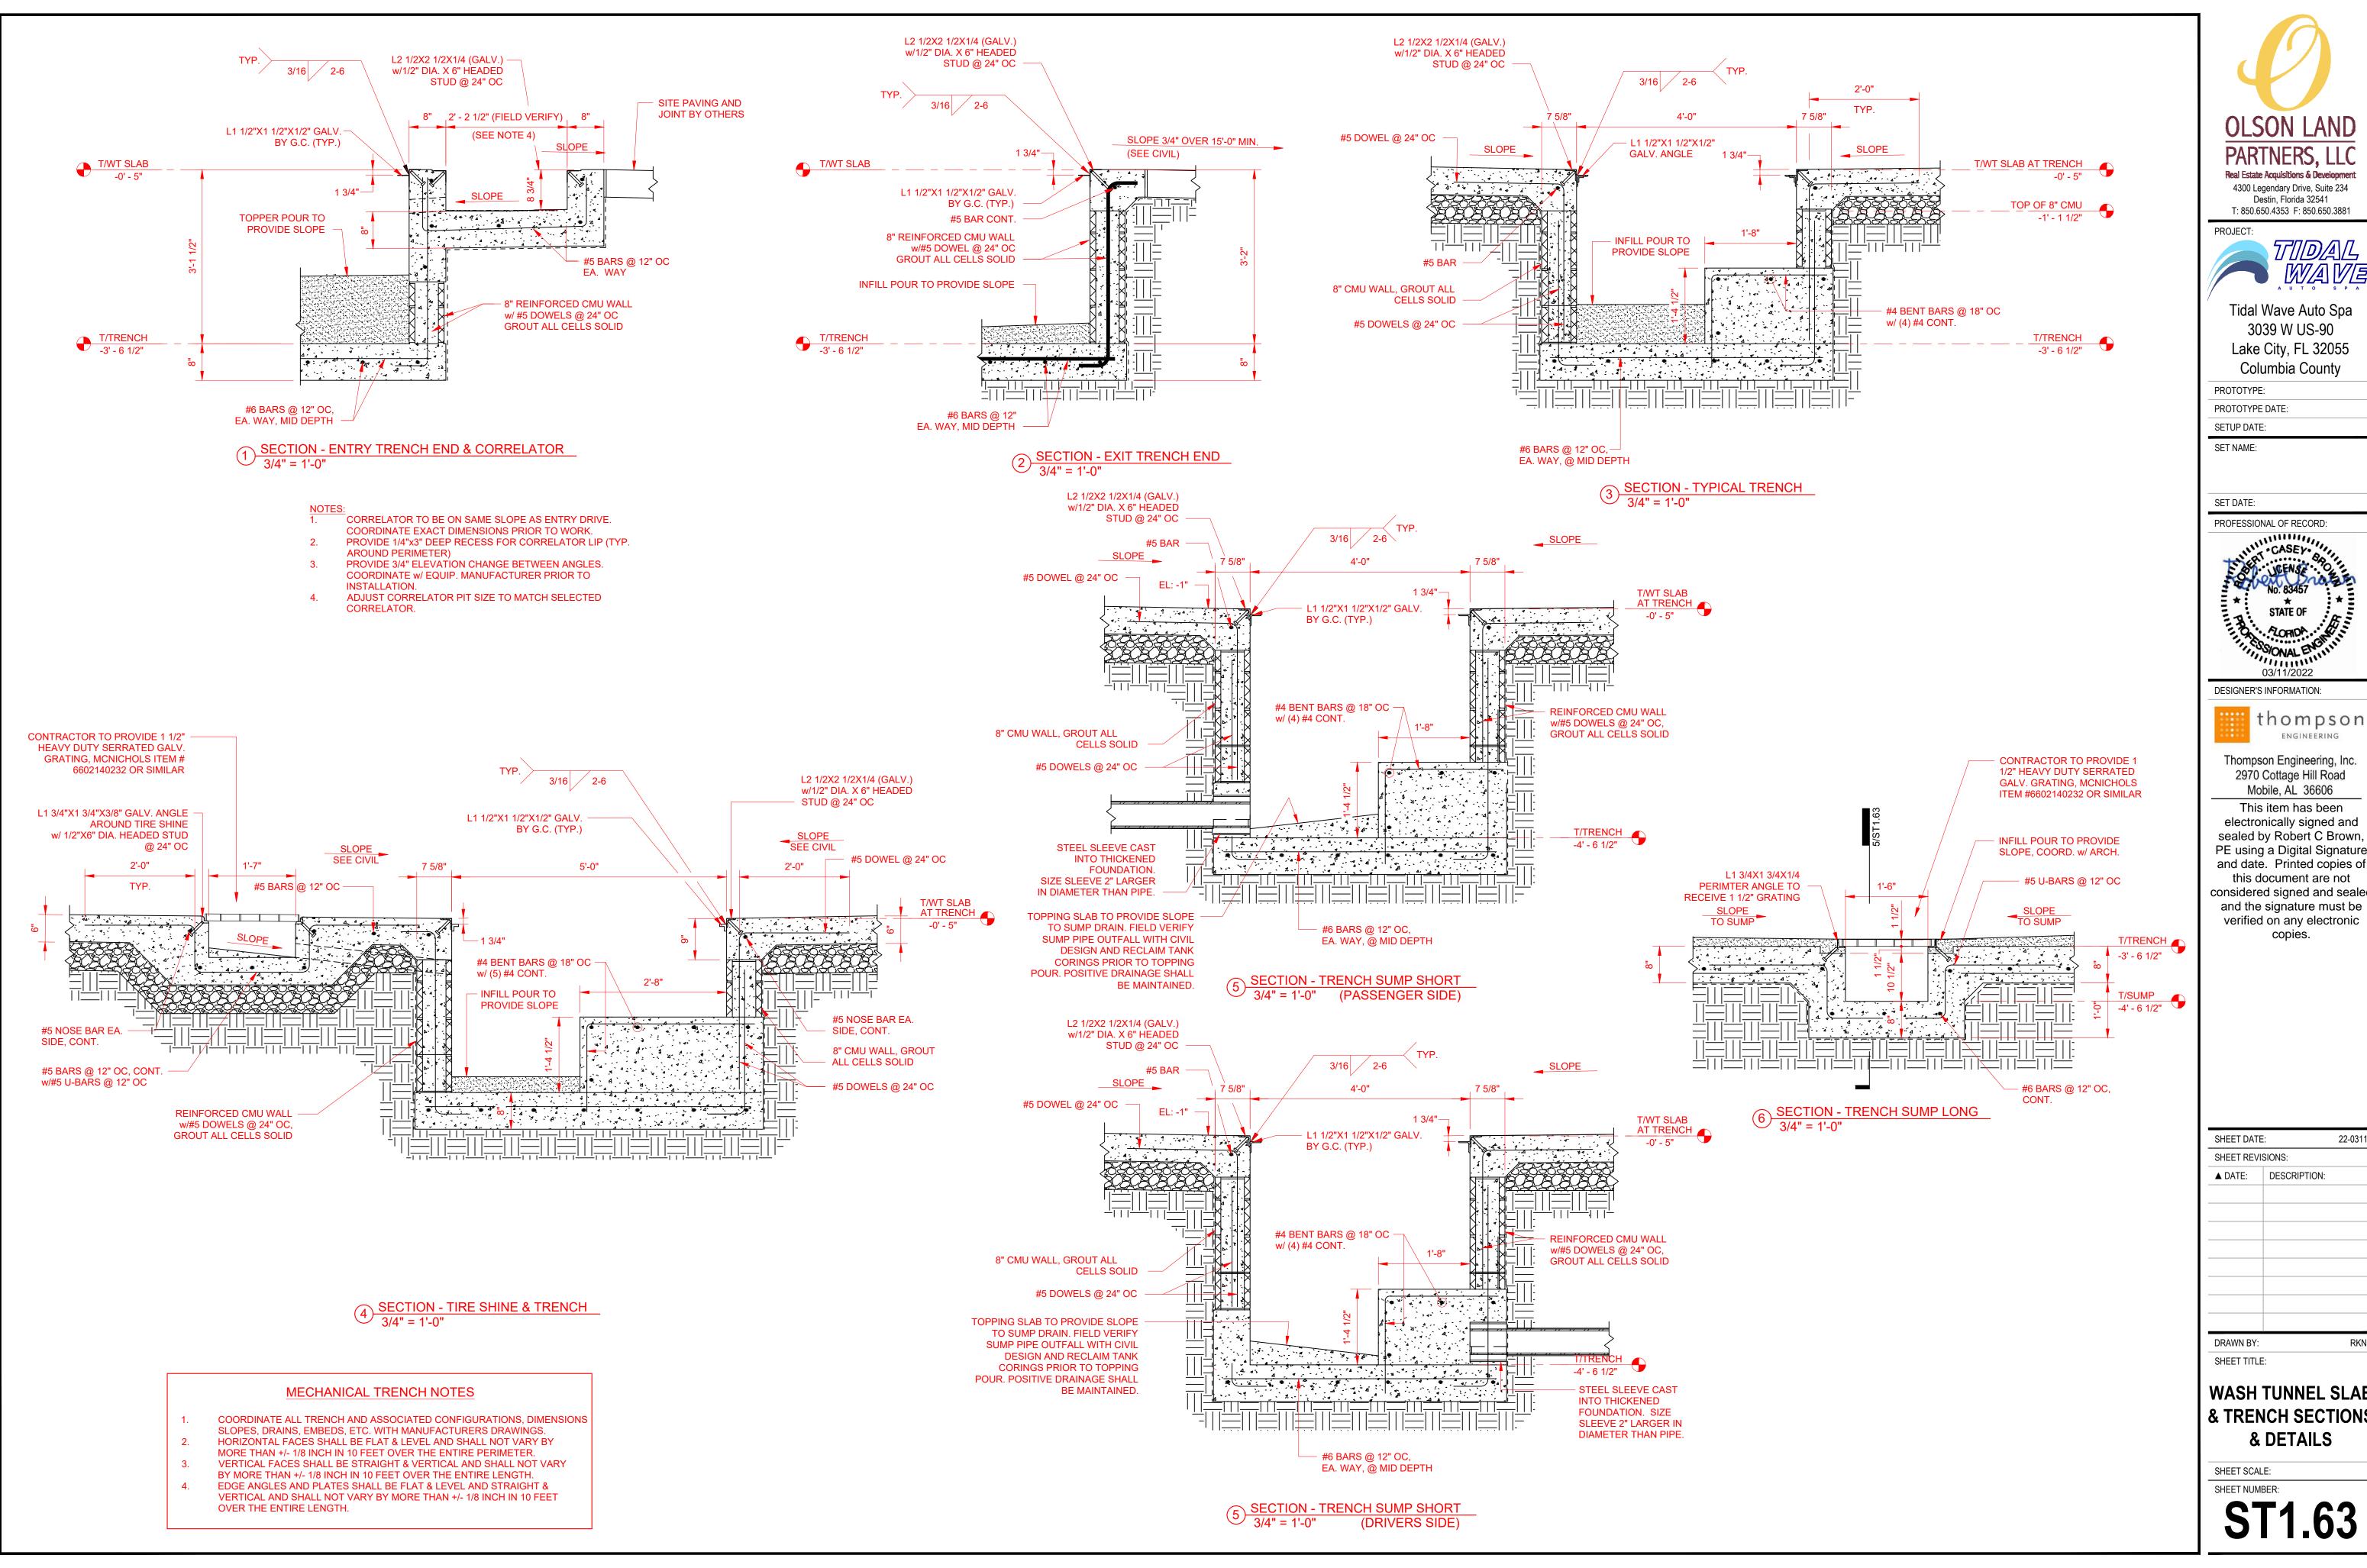

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TIDAL

Tidal Wave Auto Spa 3039 W US-90 Lake City, FL 32055



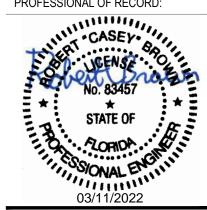


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WASH TUNNEL SLAB & TRENCH SECTIONS



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Tidal Wave Auto Spa 3039 W US-90 Lake City, FL 32055 Columbia County

PROTOTYPE: PROTOTYPE DATE:

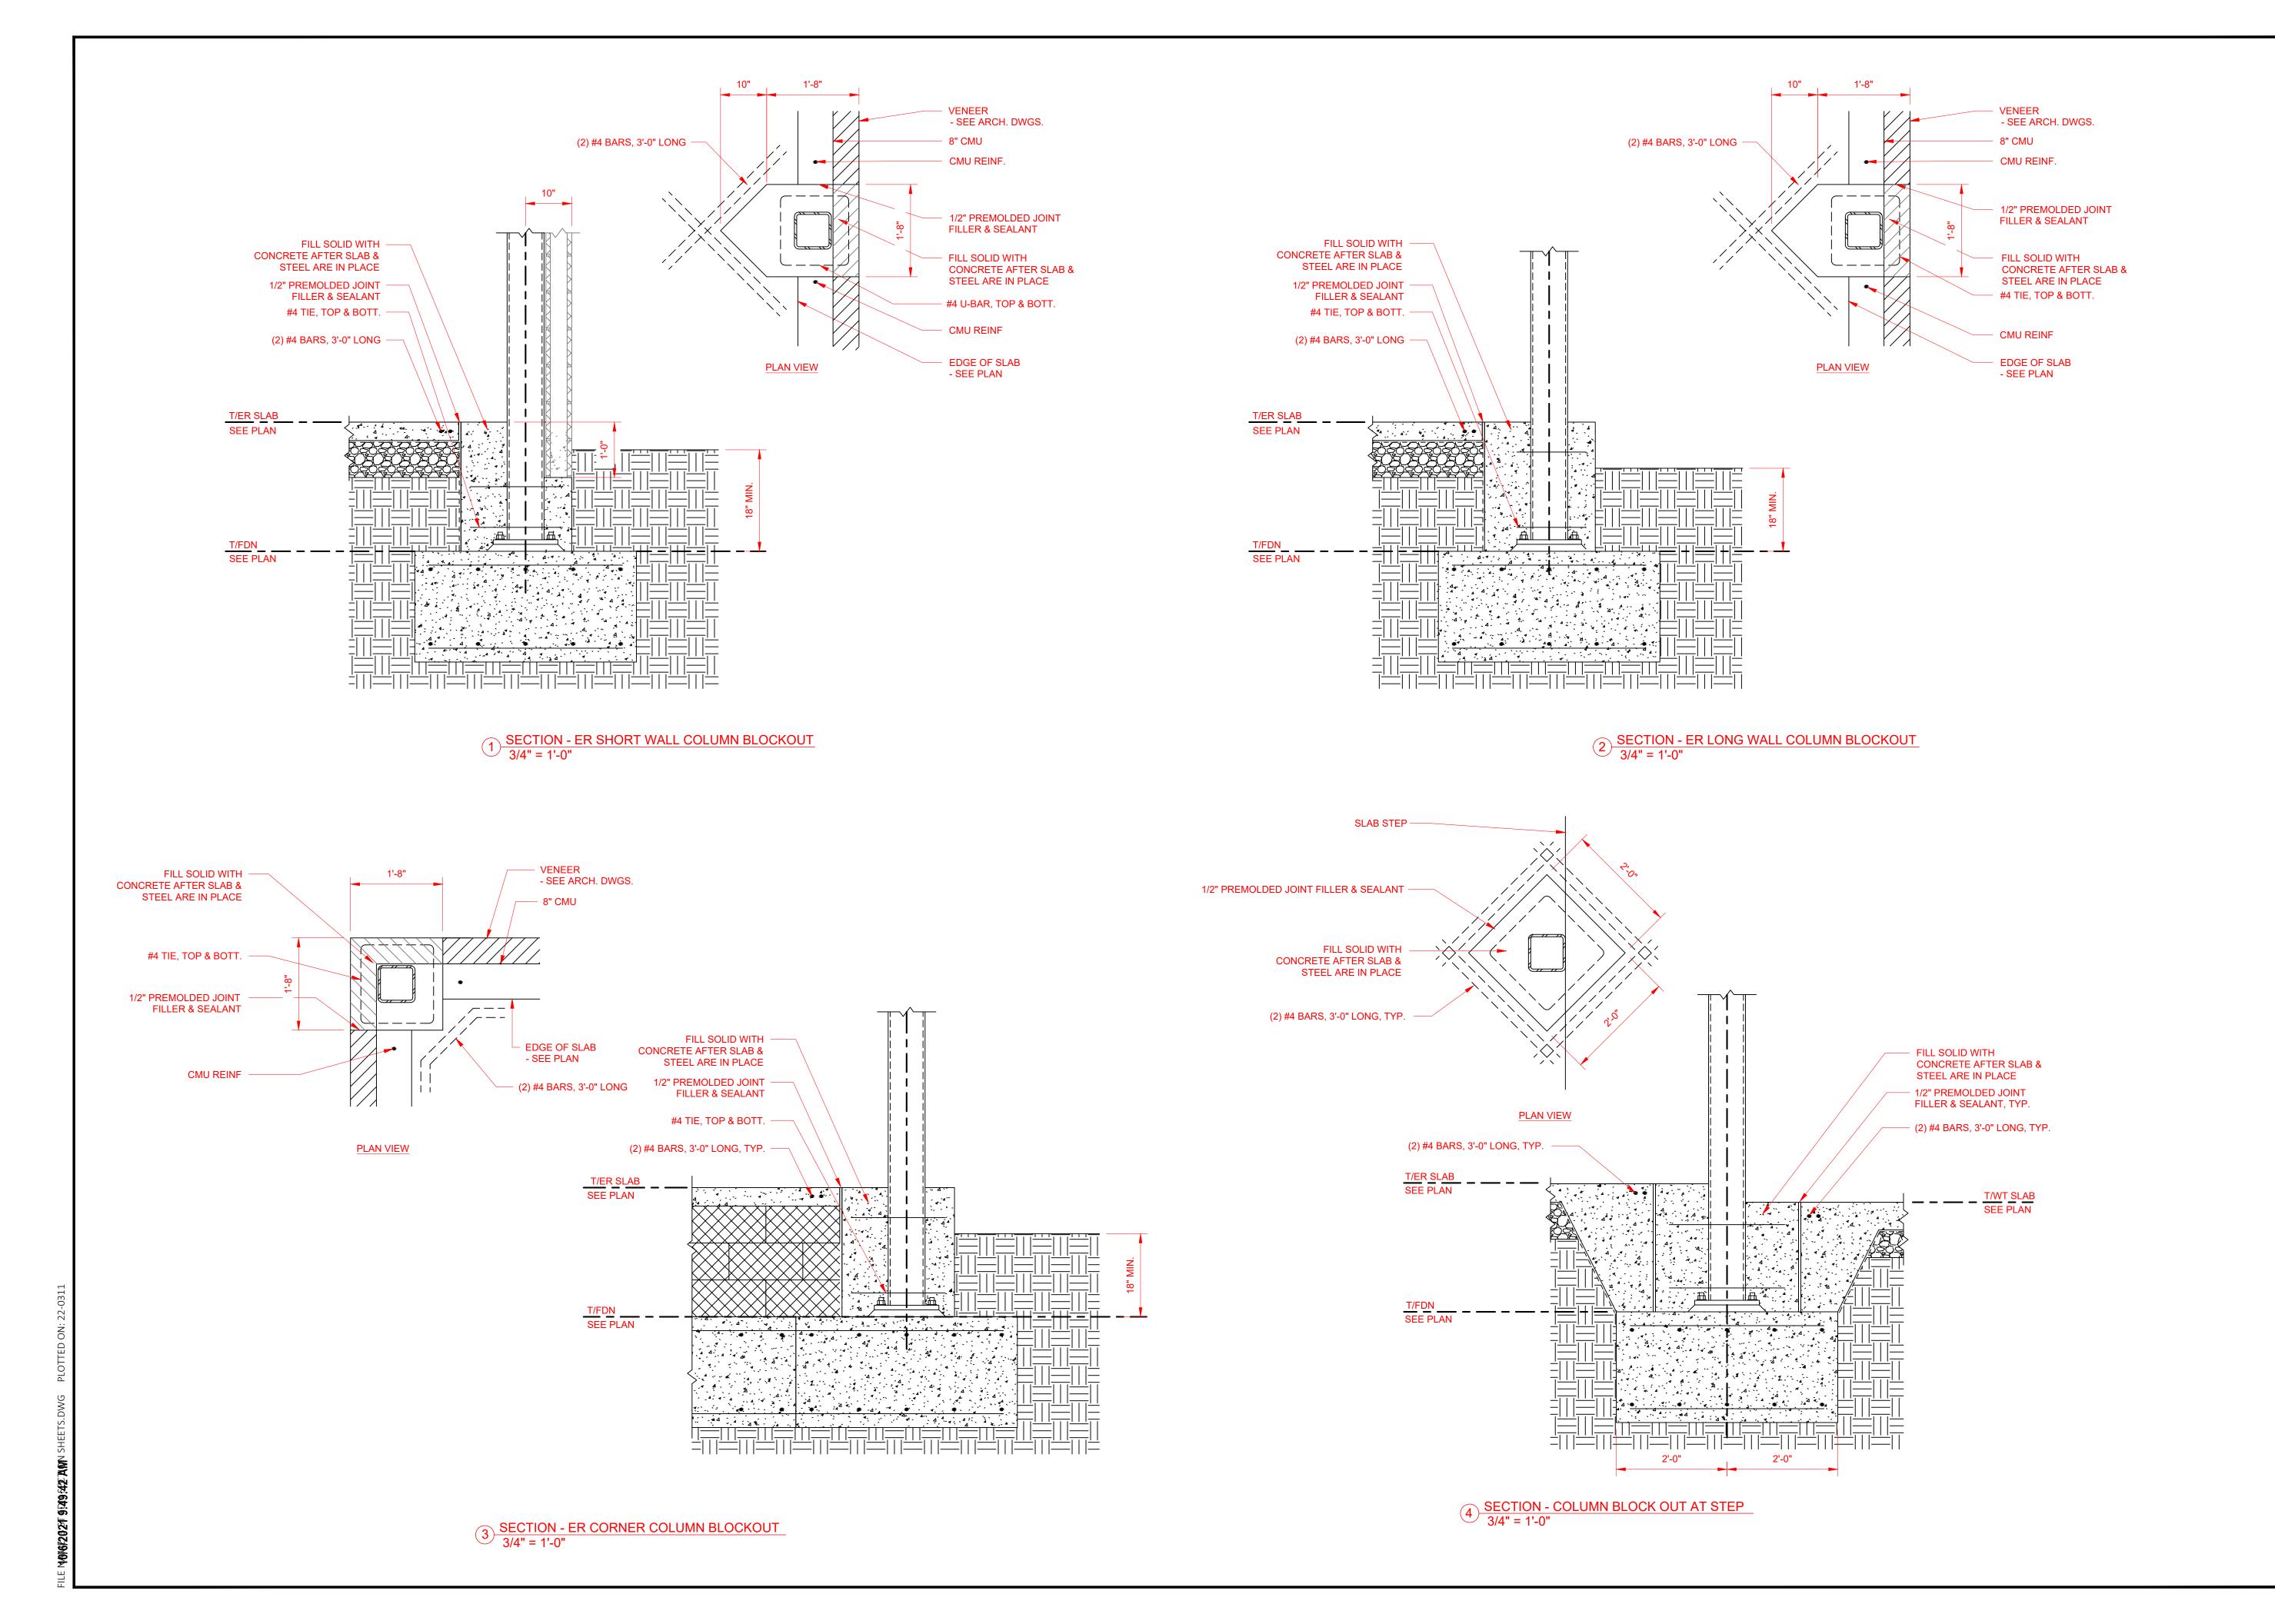SETUP DATE:

SET NAME:

SET DATE:

PROFESSIONAL OF RECORD:



DESIGNER'S INFORMATION:

thompson ENGINEERING

> Thompson Engineering, Inc. 2970 Cottage Hill Road


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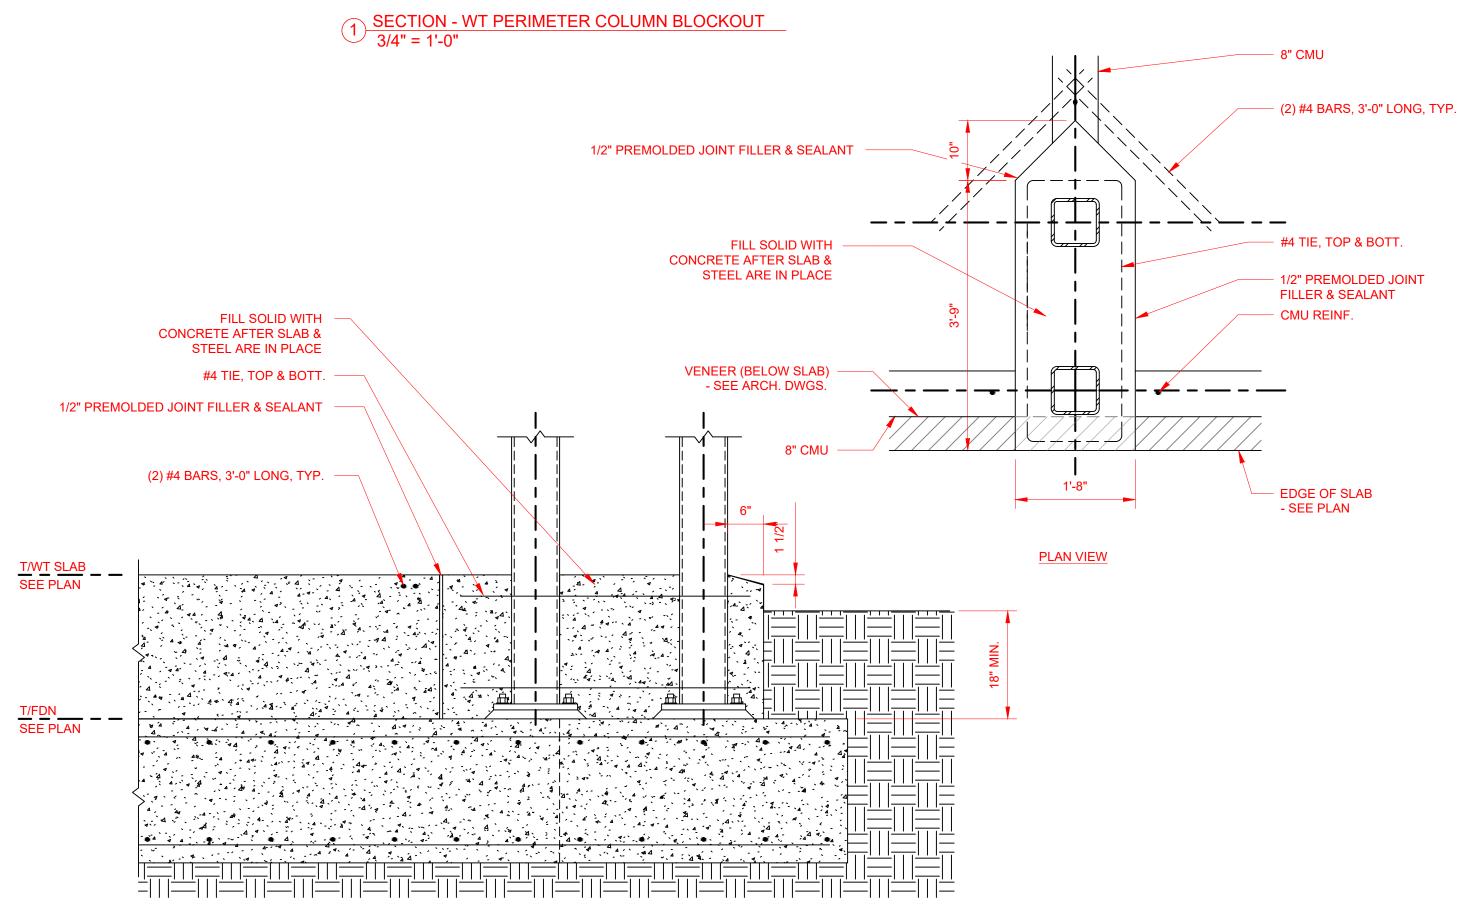
SHEET DATE: 22-0311 SHEET REVISIONS: ▲ DATE: DESCRIPTION: DRAWN BY:

WASH TUNNEL FOUNDATION & SLAB LEAVE OUT SECTIONS & DETAILS


SHEET SCALE:

SHEET TITLE:



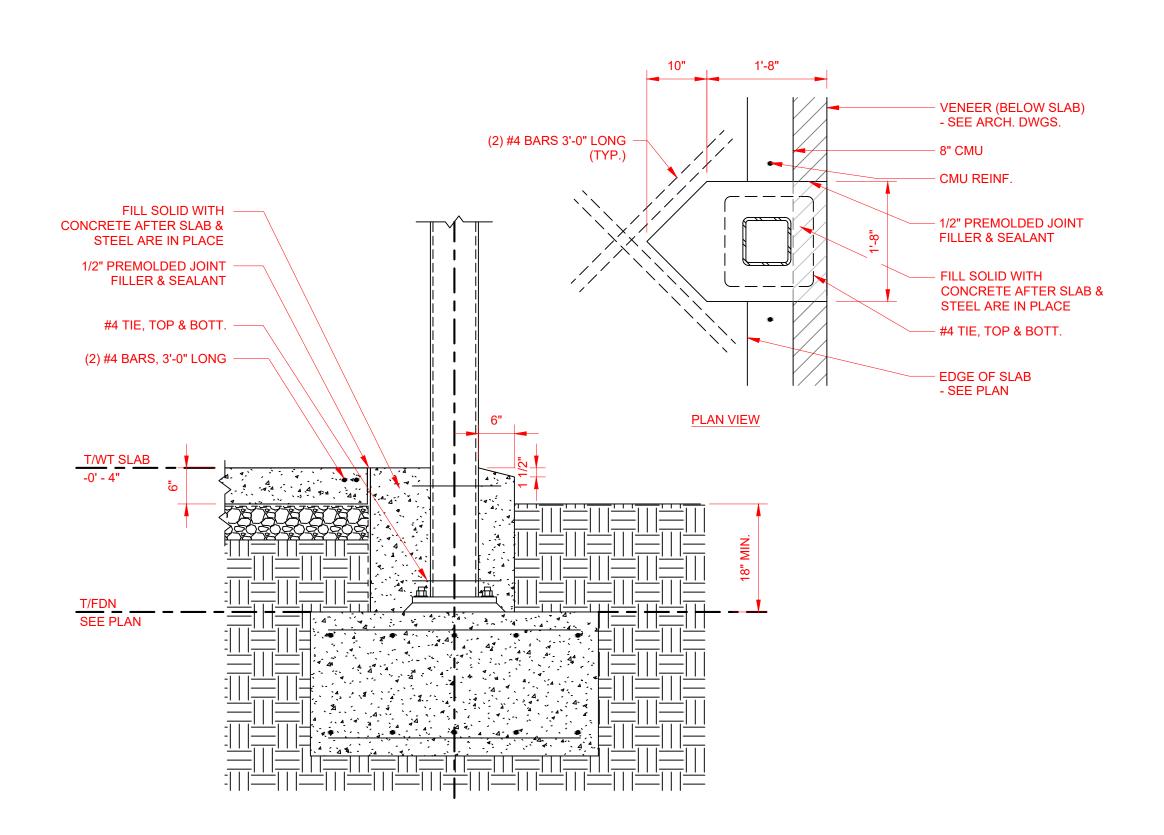

VENEER -(2) #4 BARS, 3'-0" LONG, TYP. - SEE ARCH. DWGS. 8" CMU-- #4 TIE, TOP & BOTT. EDGE OF SLAB-- SEE PLAN VENEER -- SEE ARCH. DWGS. 8" CMU -SLAB STEP - SEE PLAN CMU REINF. —— FILL SOLID WITH -CONCRETE AFTER SLAB & - 1/2" PREMOLDED JOINT FILLER & SEALANT STEEL ARE IN PLACE 1'-1" 10" 1/2" PREMOLDED JOINT FILLER & SEALANT -

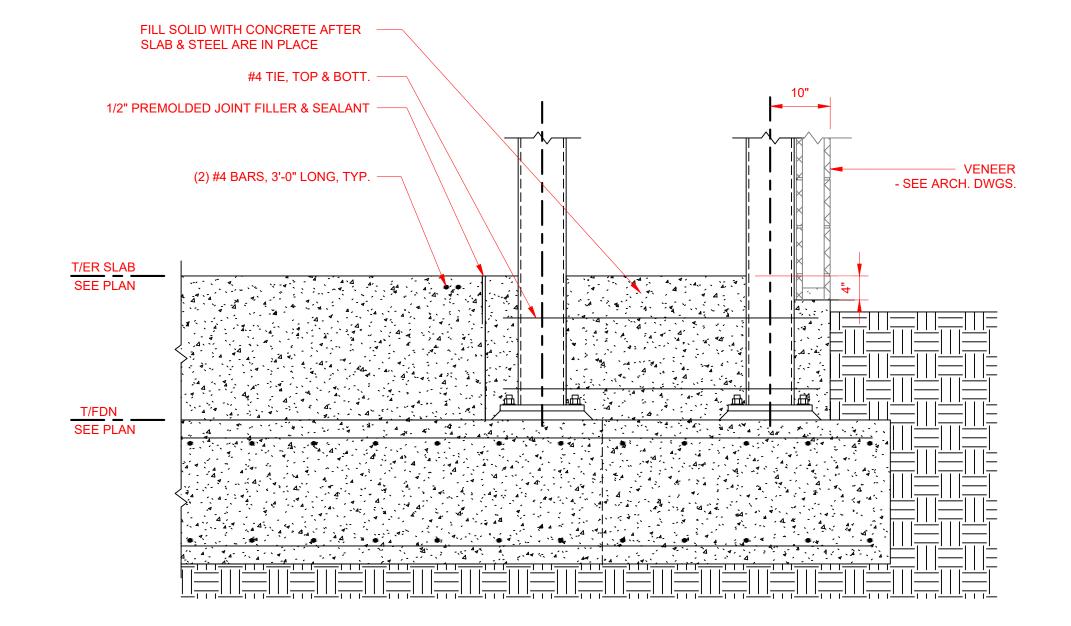

PLAN VIEW

2 SECTION - WT DOUBLE COLUMN BLOCK OUT A 3/4" = 1'-0"



PROJECT:


Tidal Wave Auto Spa 3039 W US-90 Lake City, FL 32055 Columbia County

PROTOTYPE:

PROTOTYPE DATE: SETUP DATE:

SET NAME:

SET DATE:

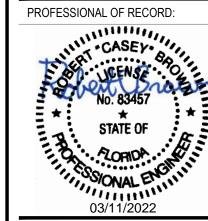

DESIGNER'S INFORMATION:

thompson ENGINEERING Thompson Engineering, Inc.

2970 Cottage Hill Road

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▲ DATE:	DESCRIPTION:	

SHEET TITLE: **WASH TUNNEL** FOUNDATION & SLAB LEAVE OUT SECTIONS


RKN

& DETAILS

SHEET SCALE:

DRAWN BY:

3 SECTION - WT DOUBLE COLUMN BLOCK OUT B
3/4" = 1'-0"

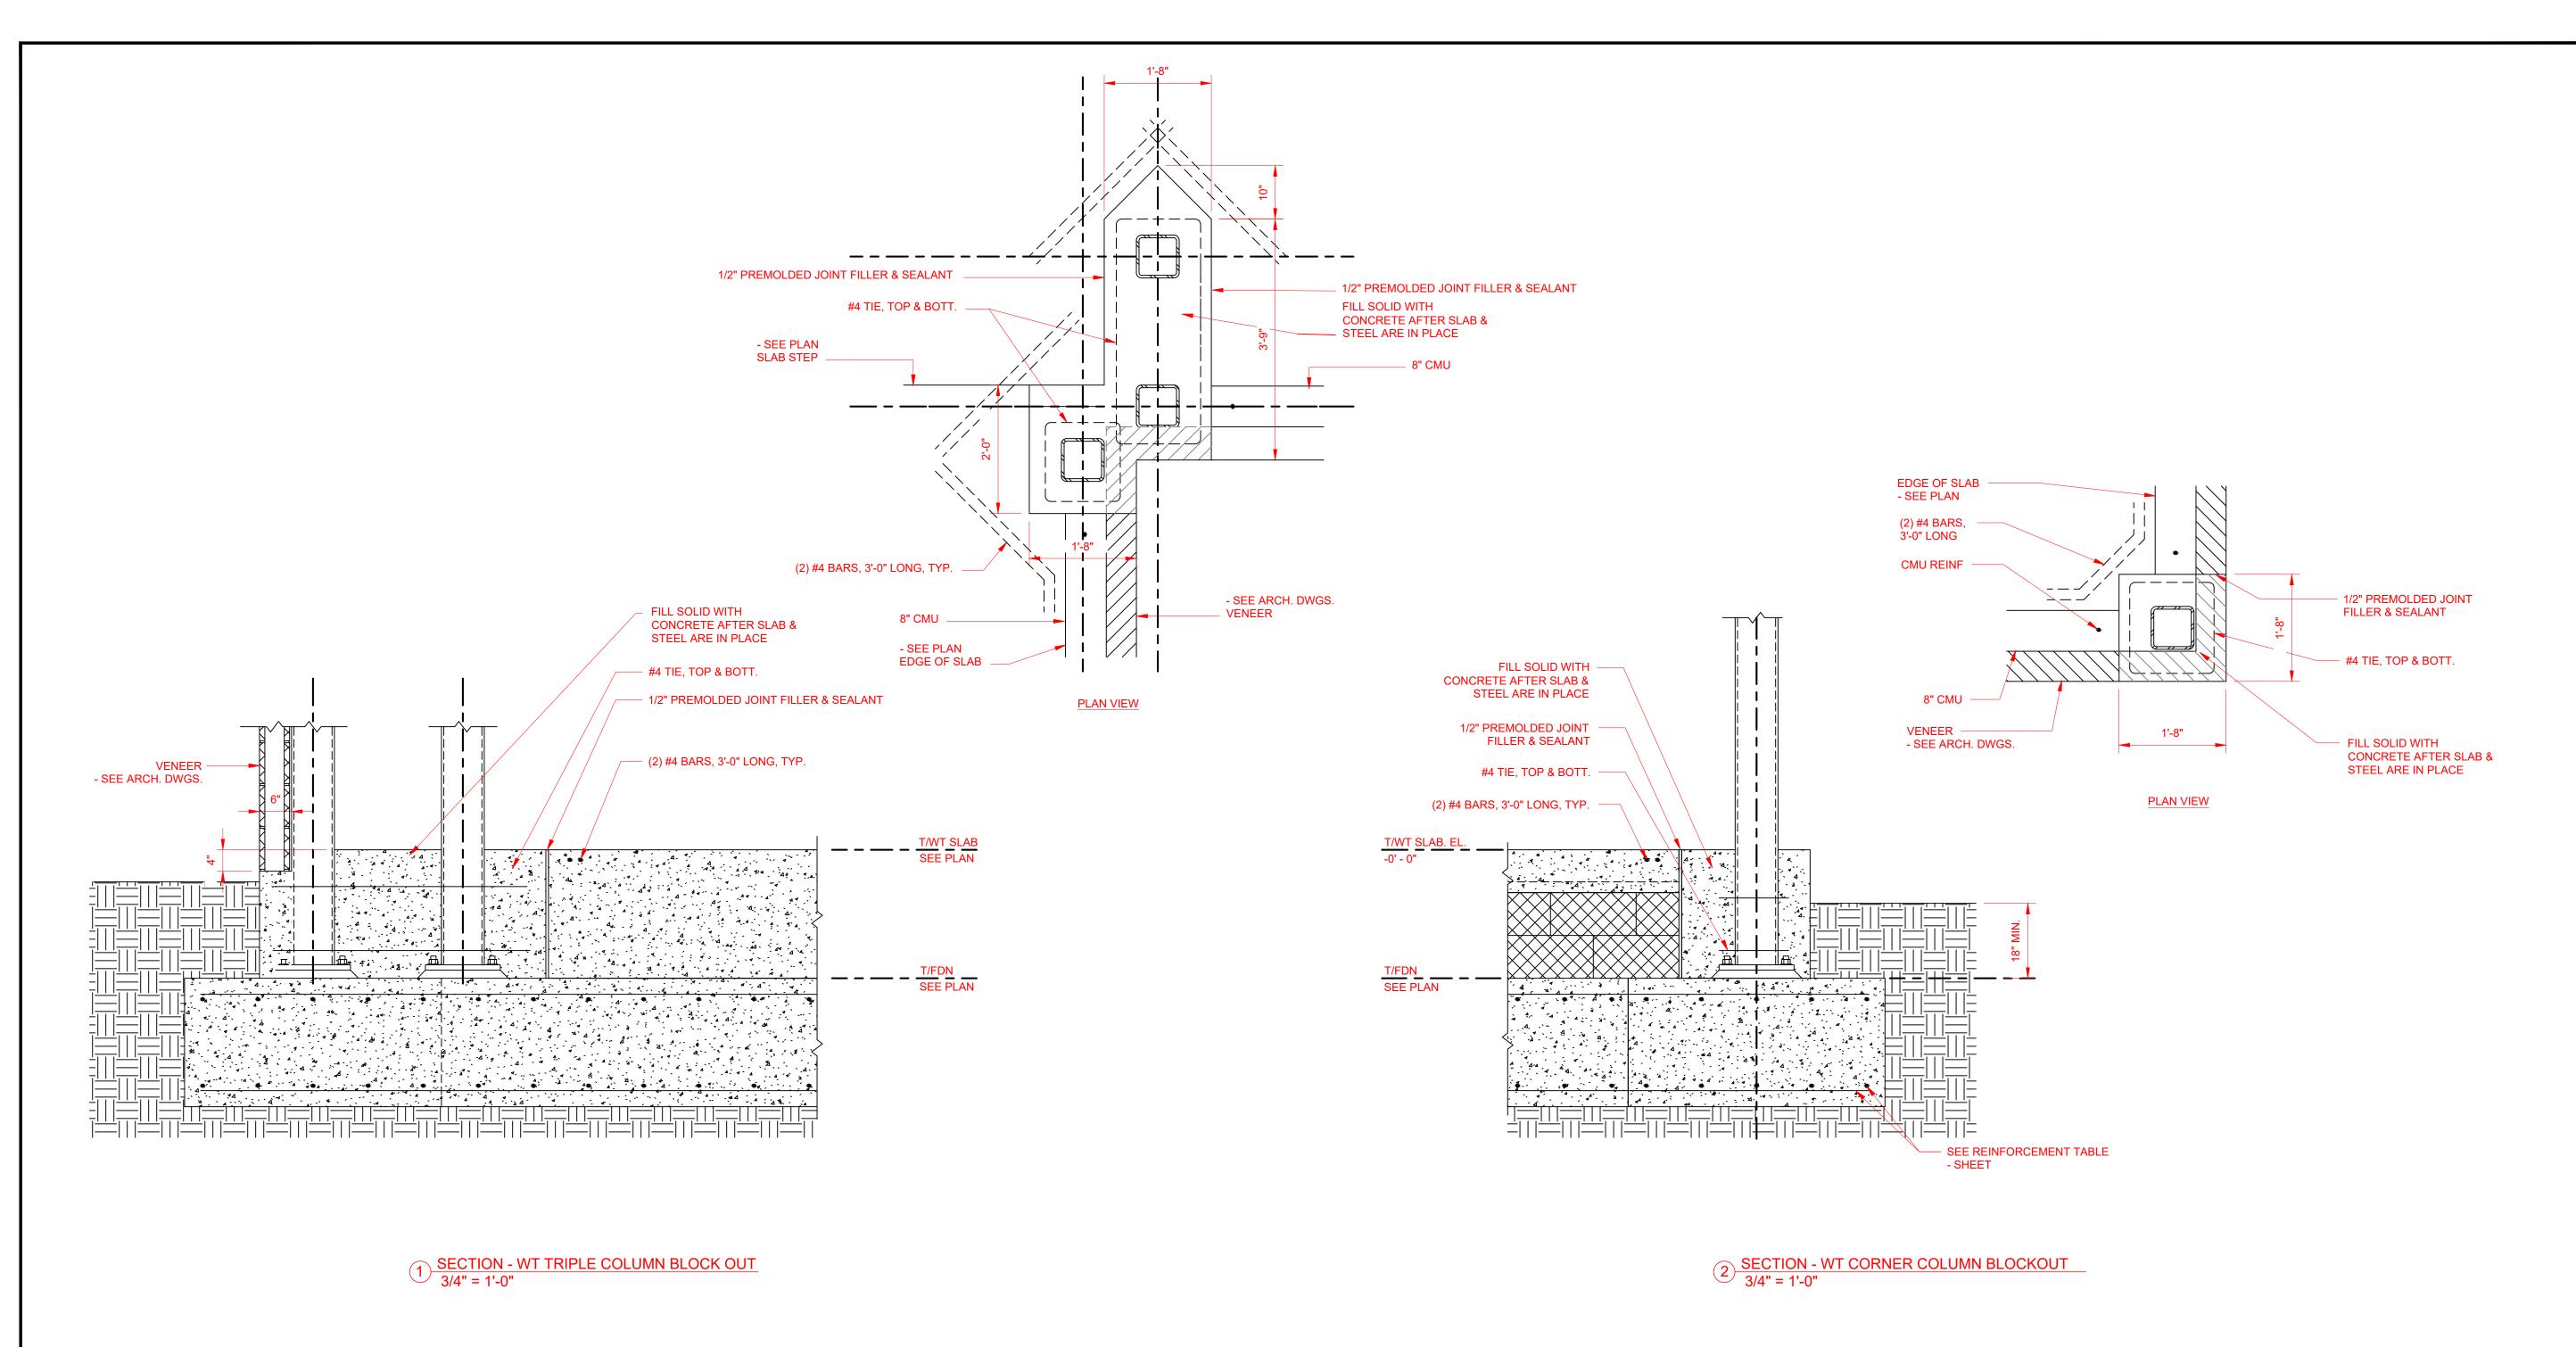

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PROJECT:

Tidal Wave Auto Spa 3039 W US-90 Lake City, FL 32055 Columbia County

PROTOTYPE: PROTOTYPE DATE: SETUP DATE:

SET NAME:

SET DATE: PROFESSIONAL OF RECORD:

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03/11/2022

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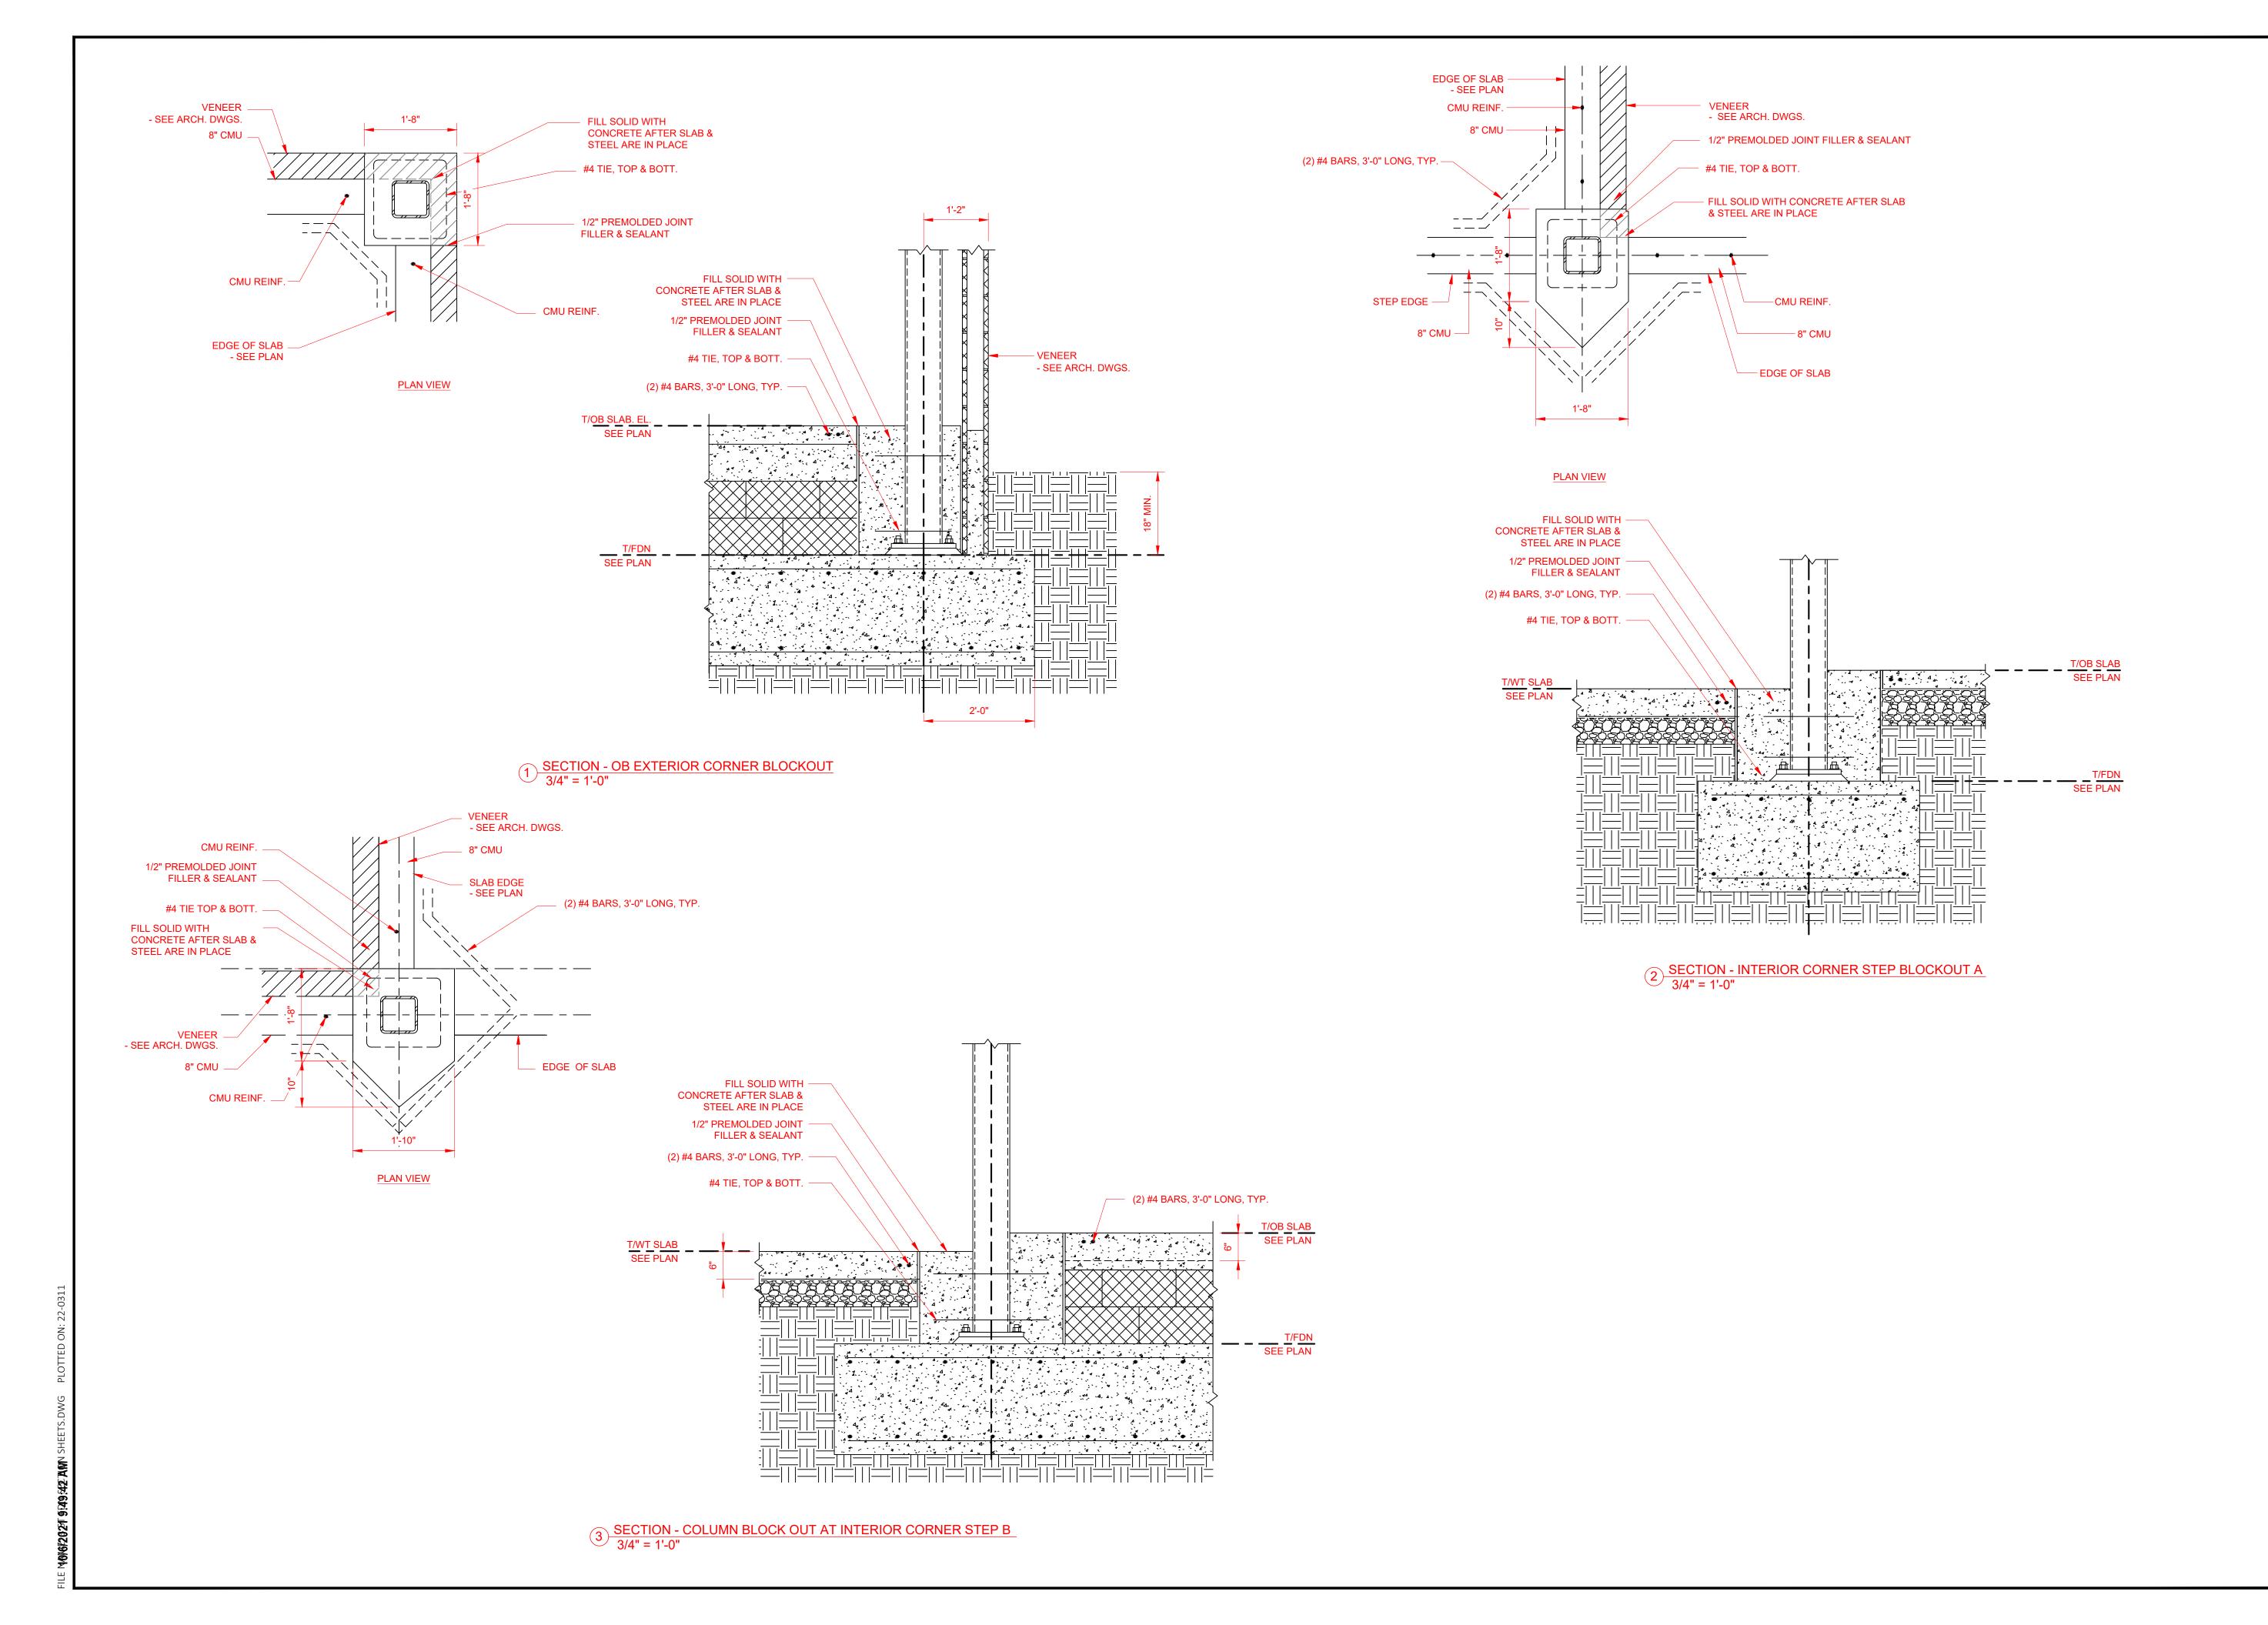
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SHEET DATE: 22-0311 SHEET REVISIONS: ▲ DATE: DESCRIPTION:

DRAWN BY: SHEET TITLE:

WASH TUNNEL FOUNDATION & SLAB LEAVE OUT SECTIONS & DETAILS

SHEET SCALE:





PROJECT:

TIDAL

NOTE OF THE PROJECT:

Tidal Wave Auto Spa 3039 W US-90 Lake City, FL 32055 Columbia County


PROTOTYPE:

PROTOTYPE DATE:

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SET NAME:

SET DATE:

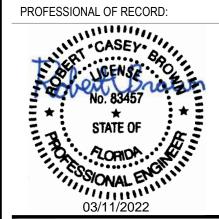

DESIGNER'S INFORMATION:

thompson ENGINEERING

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▲ DATE:	DESCRIPTION:	


DRAWN BY:
SHEET TITLE:

WASH TUNNEL
FOUNDATION & SLAB
LEAVE OUT SECTIONS
& DETAILS

SHEET SCALE:

SHEET SCALE:

ST1.67

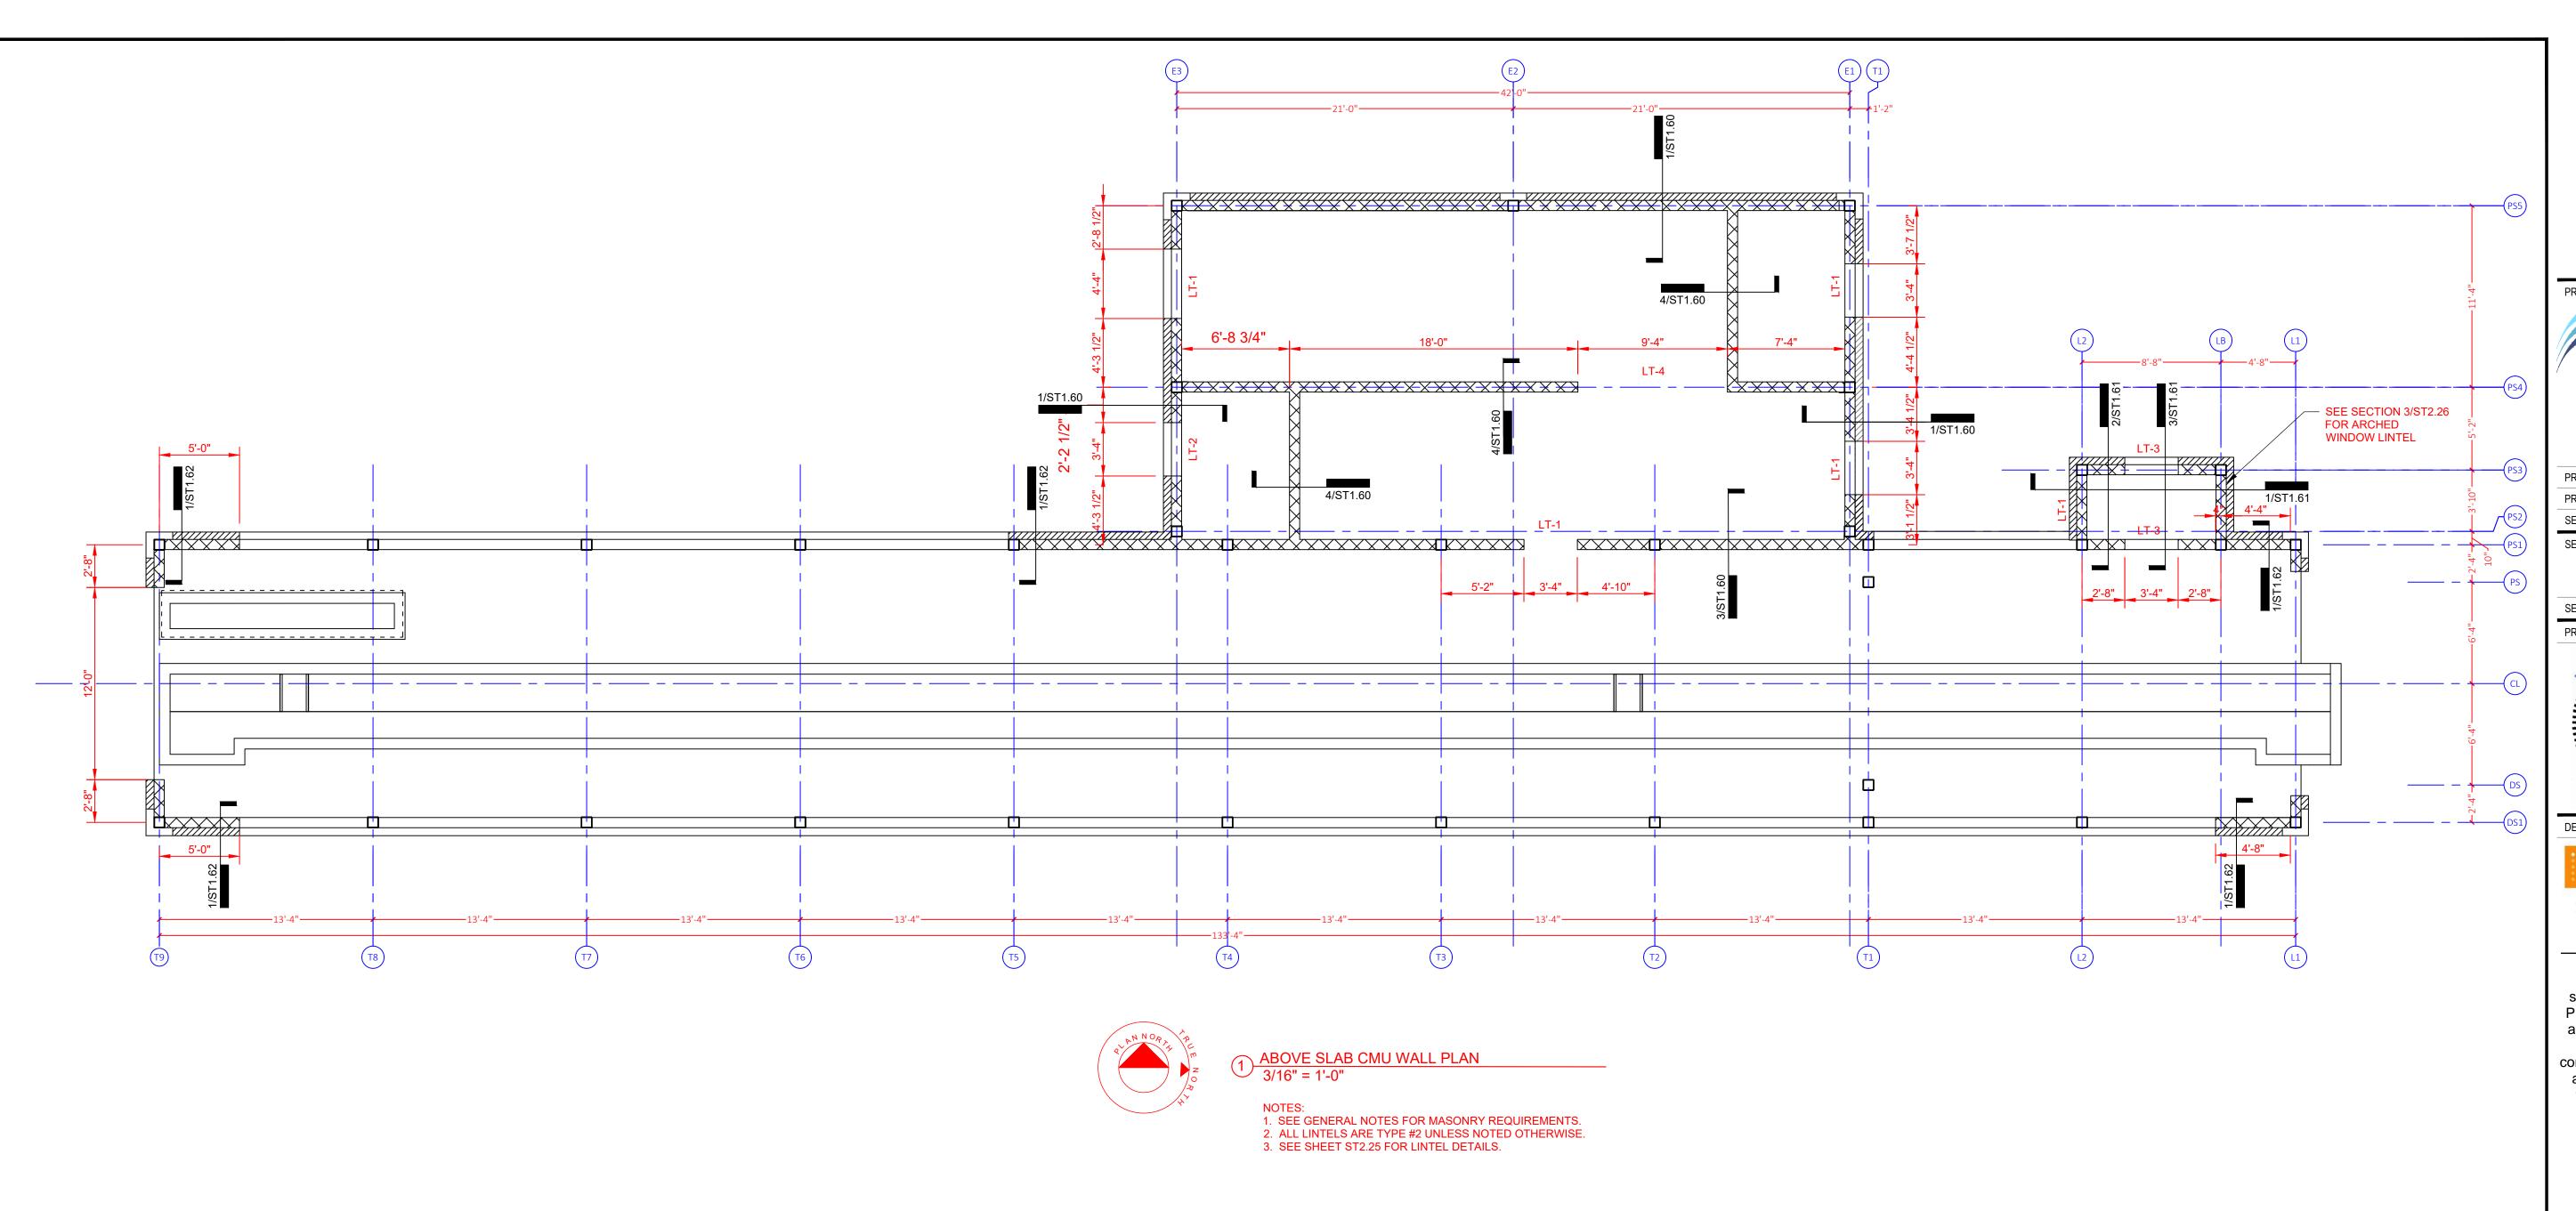




Tidal Wave Auto Spa 3039 W US-90 Lake City, FL 32055 Columbia County

PROTOTYPE:
PROTOTYPE DATE:

PROTOTYPE DATE:
SETUP DATE:

SET NAME:

SET DATE:

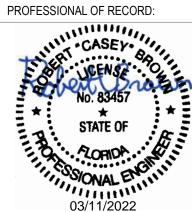

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DRAWN BY:		RKN


ABOVE SLAB CMU WALL PLAN

SHEET SCALE: X" = 1'-0" OR VARIES

SHEET SCALE: SHEET NUMBER:

SHEET TITLE:

ST2.00

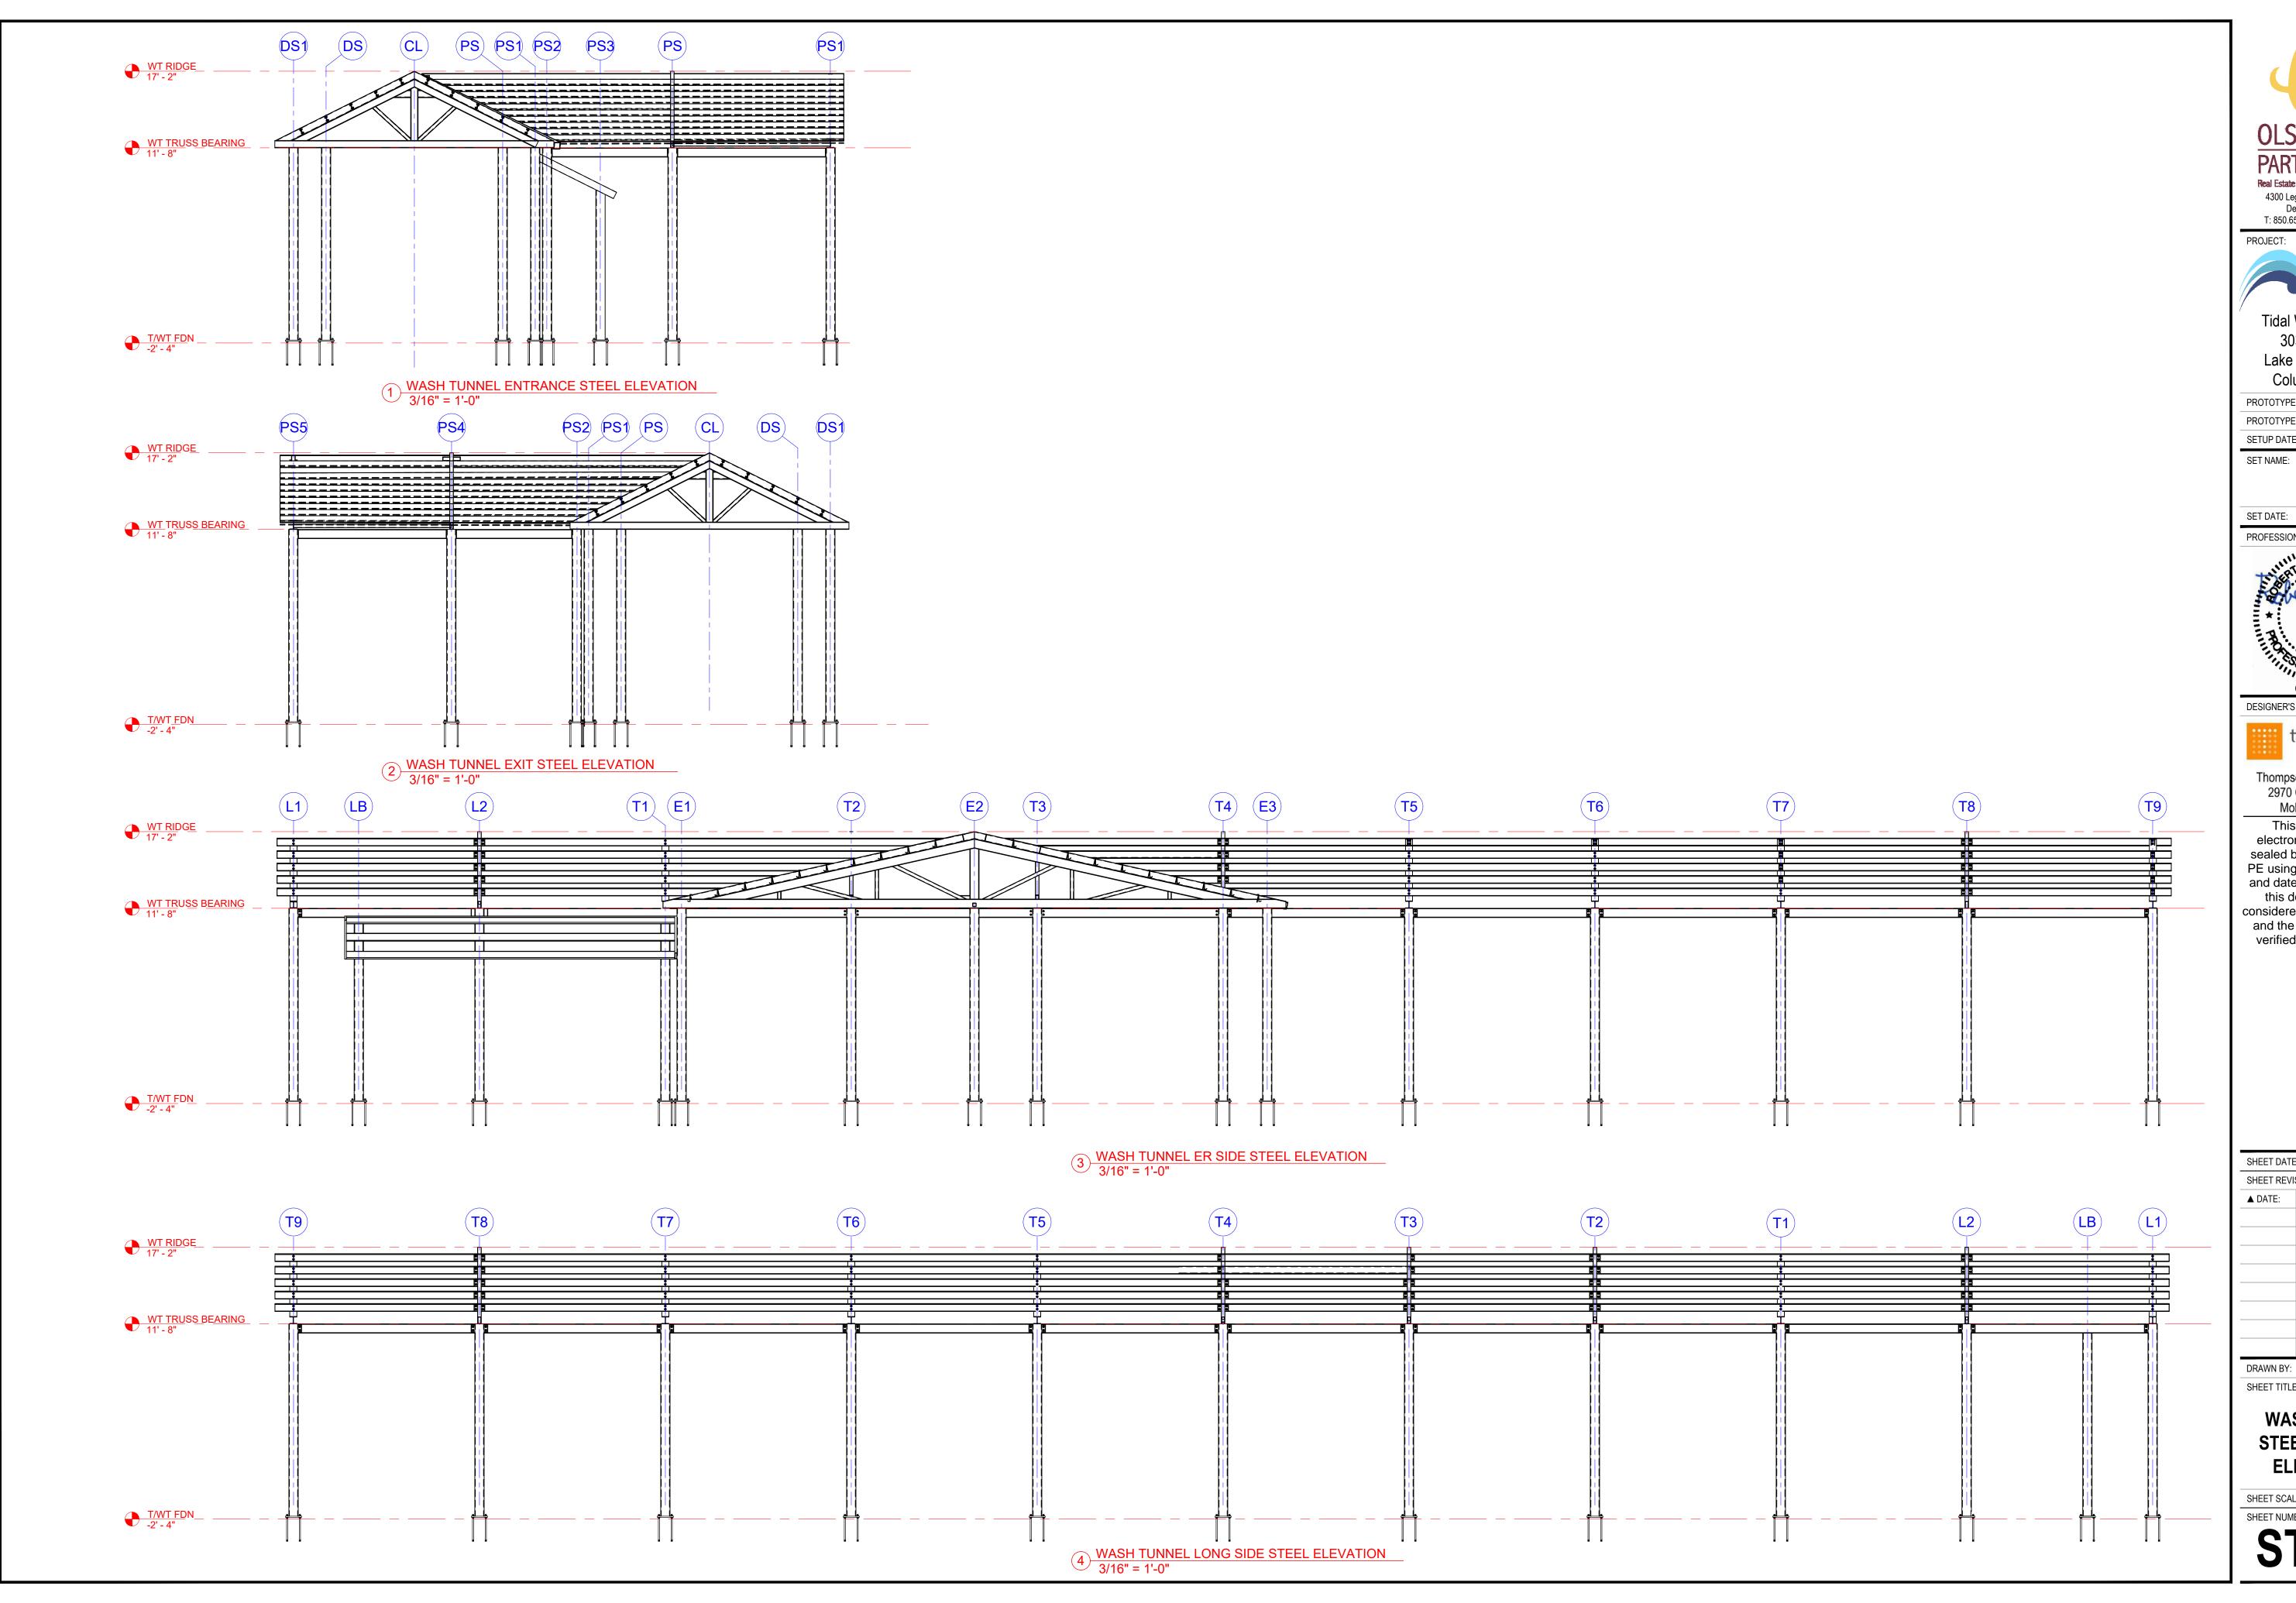



PROJECT: TIDAL WAYE

Tidal Wave Auto Spa 3039 W US-90

Lake City, FL 32055

Columbia County PROTOTYPE:

PROTOTYPE DATE:

SETUP DATE:

SET DATE:

PROFESSIONAL OF RECORD: 03/11/2022

DESIGNER'S INFORMATION:




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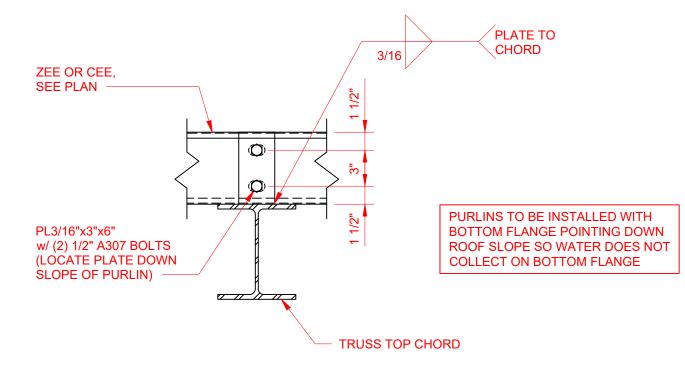
DRAWN BY: SHEET TITLE:

WASH TUNNEL STEEL FRAMING **ELEVATIONS**


SHEET SCALE: SHEET NUMBER:




1 TYPICAL - HSS BEAM TO BEAM 1 1/2" = 1'-0"

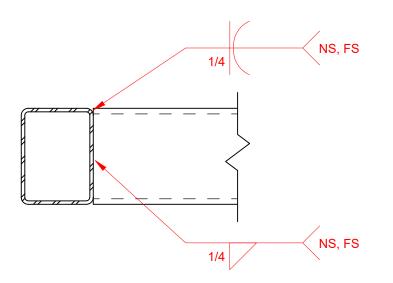


2 TYPICAL - PURLIN BYPASS ATTACHMENT 1 1/2" = 1'-0"

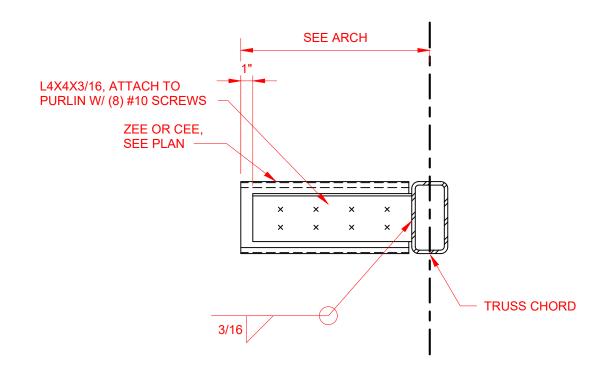


3 TYPICAL - PURLIN ATTACHMENT AT LOOKOUT

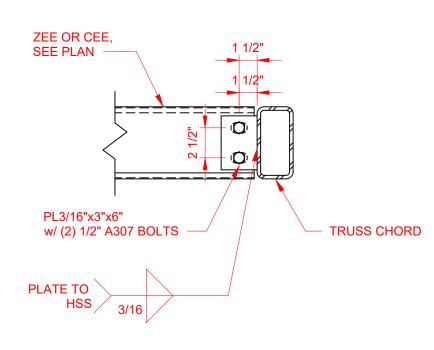

TYPICAL - PURLIN FACE ATTACHMENT

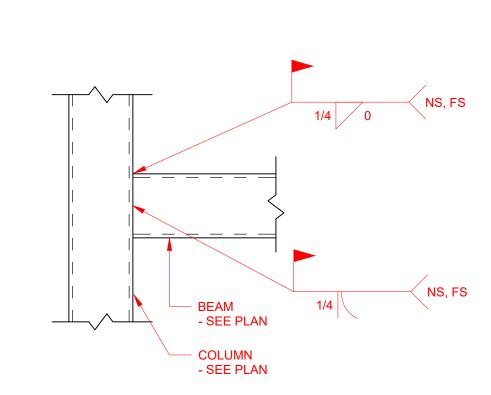

5 TYPICAL - HSS BEAM TO COLUMN
1" = 1'-0"

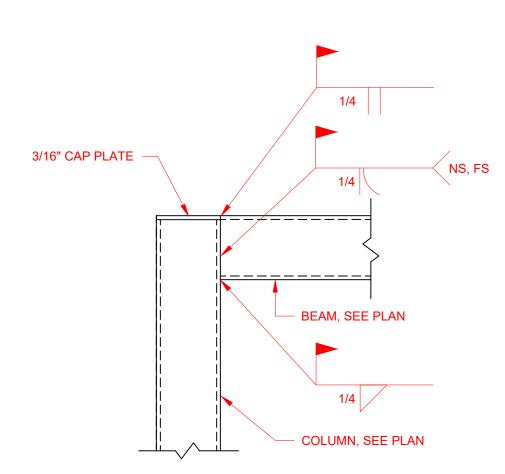

6 TYPICAL - HSS BEAM TO TOP OF COLUMN
1" = 1'-0"



PROJECT:

Tidal Wave Auto Spa 3039 W US-90 Lake City, FL 32055

Columbia County


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PROTOTYPE DATE:

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SET DATE:



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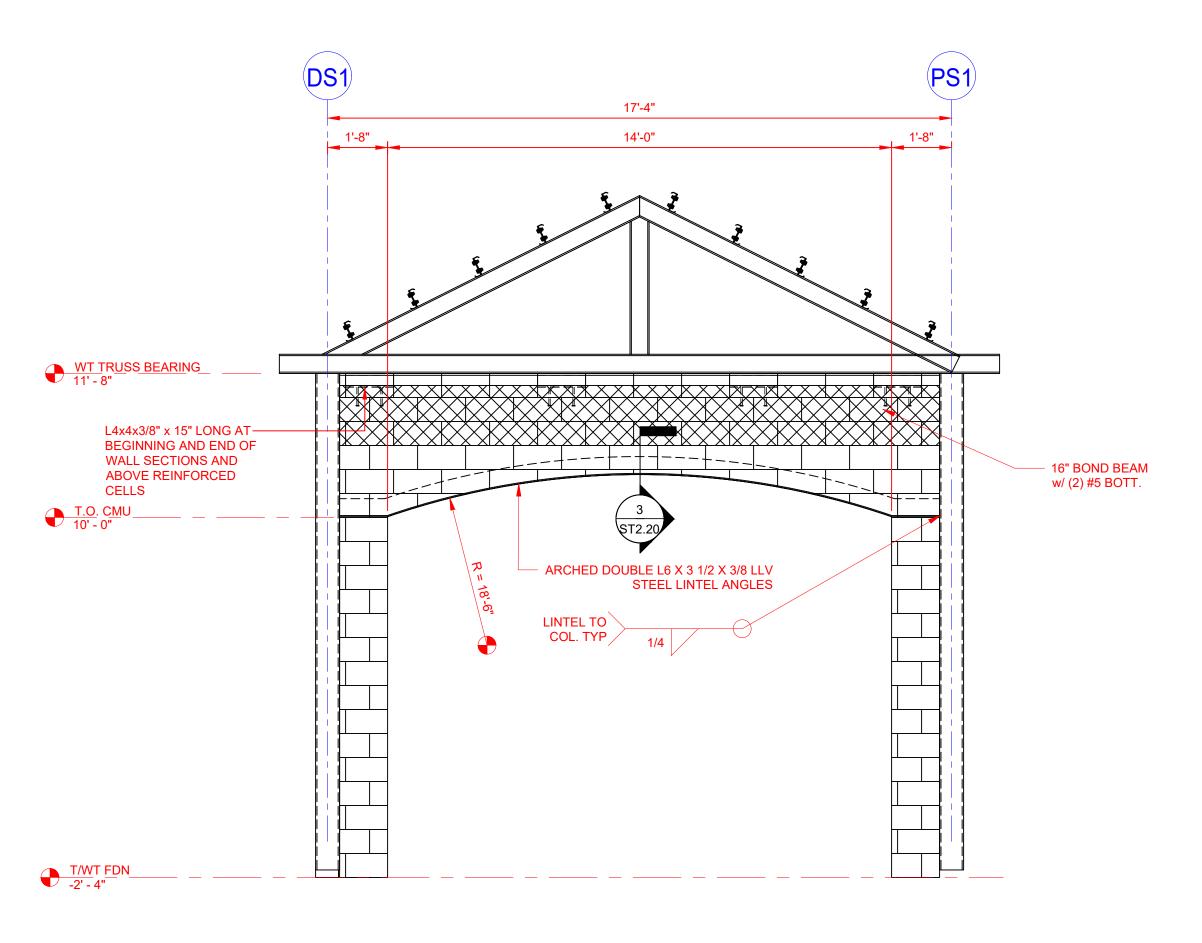
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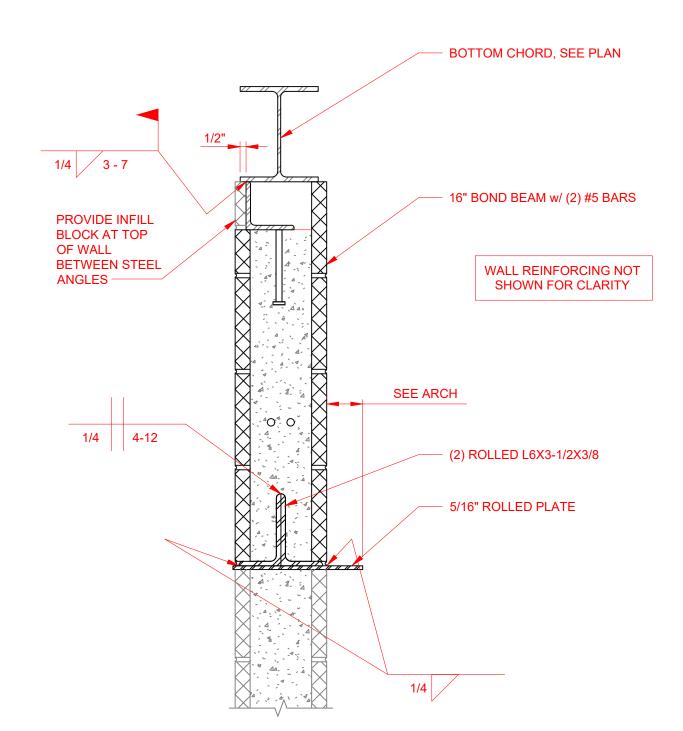
DRAWN BY: SHEET TITLE:

> **WASH TUNNEL** STEEL FRAMING **DETAILS**

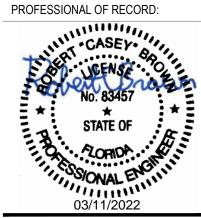SHEET SCALE:



1 ELEVATION - WASH TUNNEL ENTRANCE WALL 3/8" = 1'-0"



3 SECTION - WASH TUNNEL ENTRACE/EXIT LINTEL 1 1/2" = 1'-0"

WITTRUSS BEARING

11-6

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12-0

13-43-38° x 15* LONG AT

BEGINNING AND END OF
WALL SECTIONS AND
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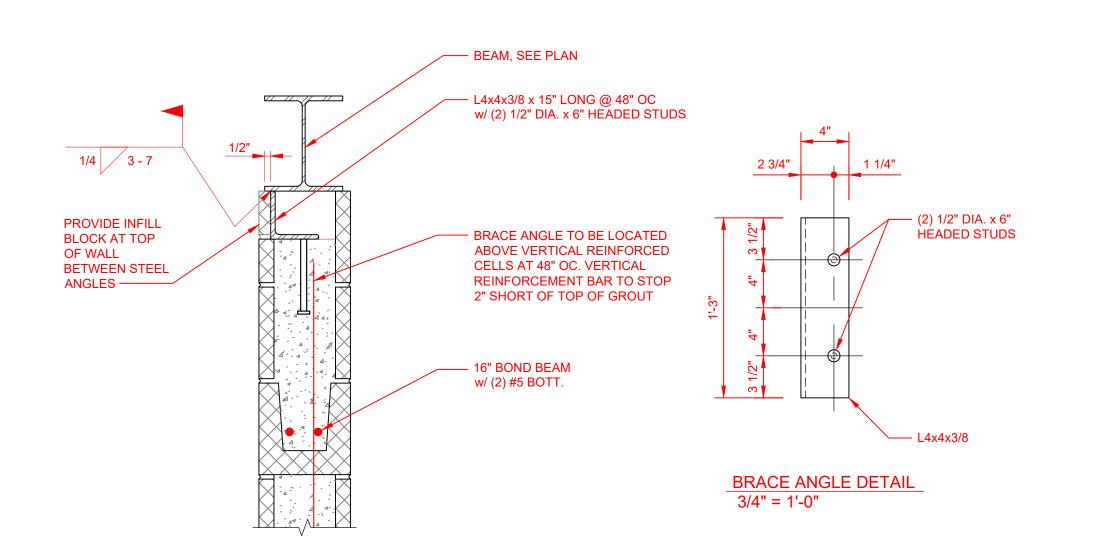
10-0

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10-0

2 ELEVATION - WASH TUNNEL EXIT WALL
3/8" = 1'-0"



4 TYPICAL - CMU TO BEAM ATTACHMENT
3/4" = 1'-0"



PROJECT:


Tidal Wave Auto Spa 3039 W US-90 Lake City, FL 32055 Columbia County

PROTOTYPE:

PROTOTYPE DATE:
SETUP DATE:

SET NAME:

SET DATE:

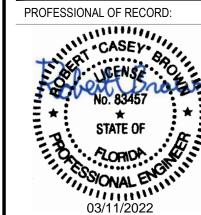

DESIGNER'S INFORMATION:



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WASH TUNNEL CMU

WALL ELEVATIONS


RKN

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SHEET TITLE:

SHEET SCALE:
SHEET NUMBER:

ST2.20

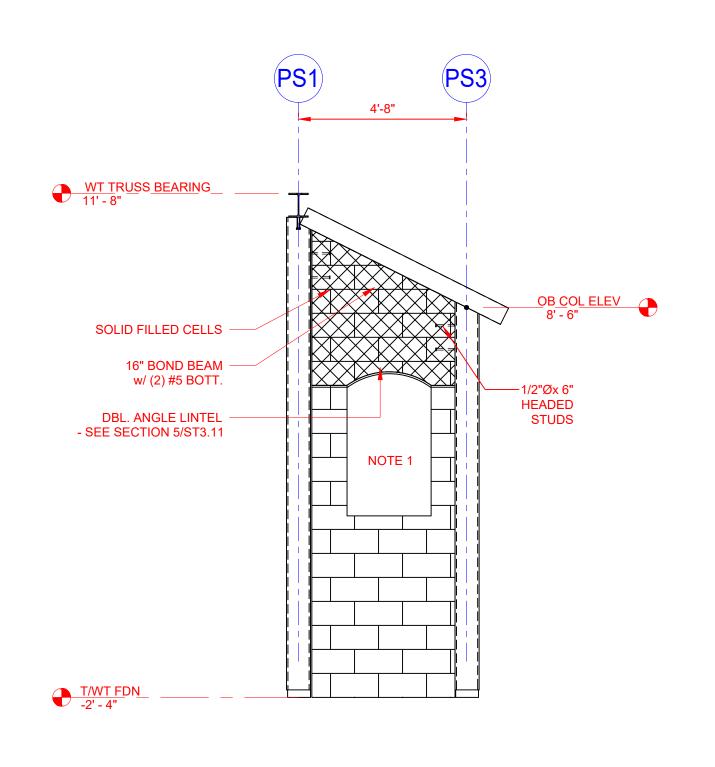


16" BOND BEAM
W (2) #5 BOTT.

LT-2
- SEE SHEET
ST2.25

L4x4x3/8" x 15" LONG AT
BEGINNING AND DEN DO F
WALL SECTIONS AND
ABOVE REINFORCED
CELLS

TAWT FDN
2"-4"

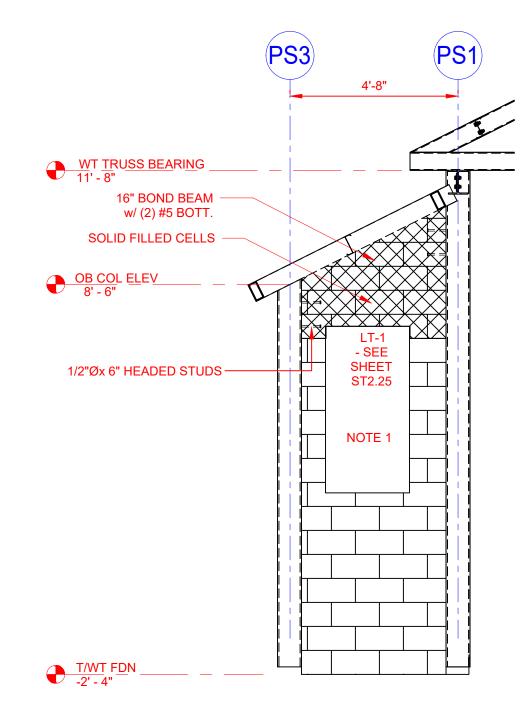


1 CMU OB EXTERIOR ELEVATION 1 3/8" = 1'-0"

SEE ARCH. DRAWINGS FOR OPENING SIZE.

2 CMU OB EXTERIOR ELEVATION 2
3/8" = 1'-0"

 SEE ARCH. DRAWINGS FOR OPENING SIZE. 3 CMU OB EXTERIOR ELEVATION 3
3/8" = 1'-0"

 SEE ARCH. DRAWINGS FOR OPENING SIZE.

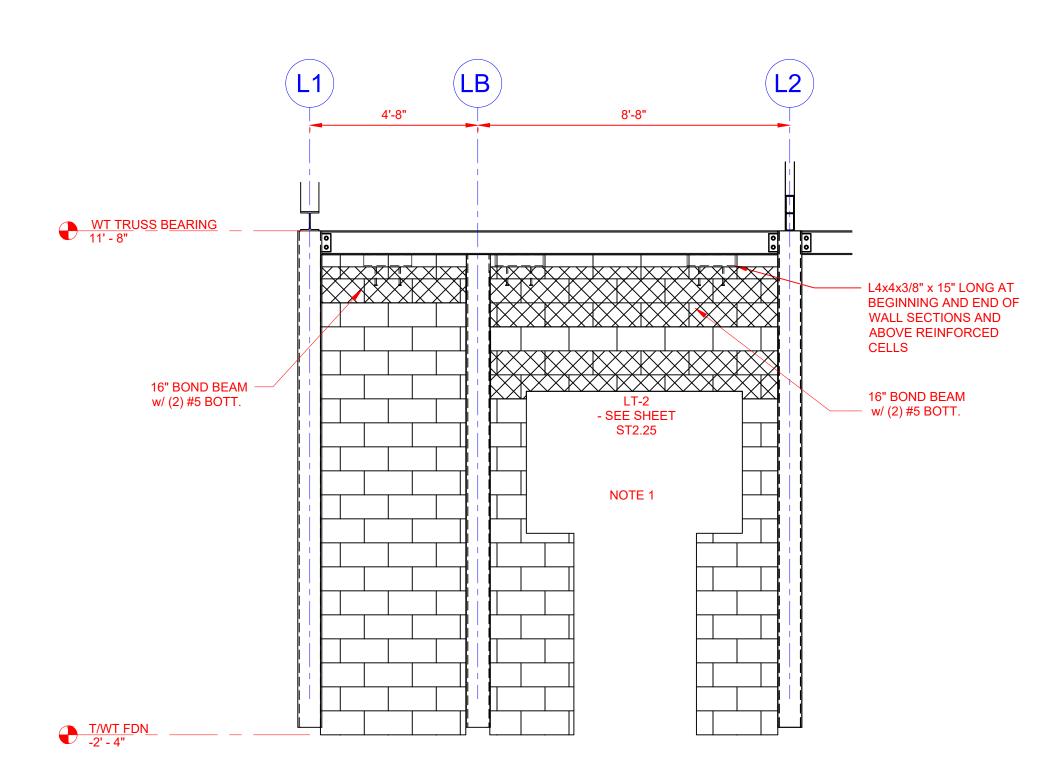

4 CMU OB EXTERIOR ELEVATION 4
3/8" = 1'-0"

 SEE ARCH. DRAWINGS FOR OPENING SIZE.



PROJECT:

TIDA

W/A

Tidal Wave Auto Spa 3039 W US-90 Lake City, FL 32055 Columbia County


PROTOTYPE:

PROTOTYPE DATE:

SETUP DATE:
SET NAME:

SET DATE:

PROFESSIONAL OF RECORD:

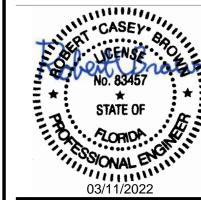

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WASH TUNNEL CMU WALL ELEVATIONS

RKN


SHEET SCALE:

DRAWN BY:

SHEET TITLE:

SHEET NUMB

ST2.21

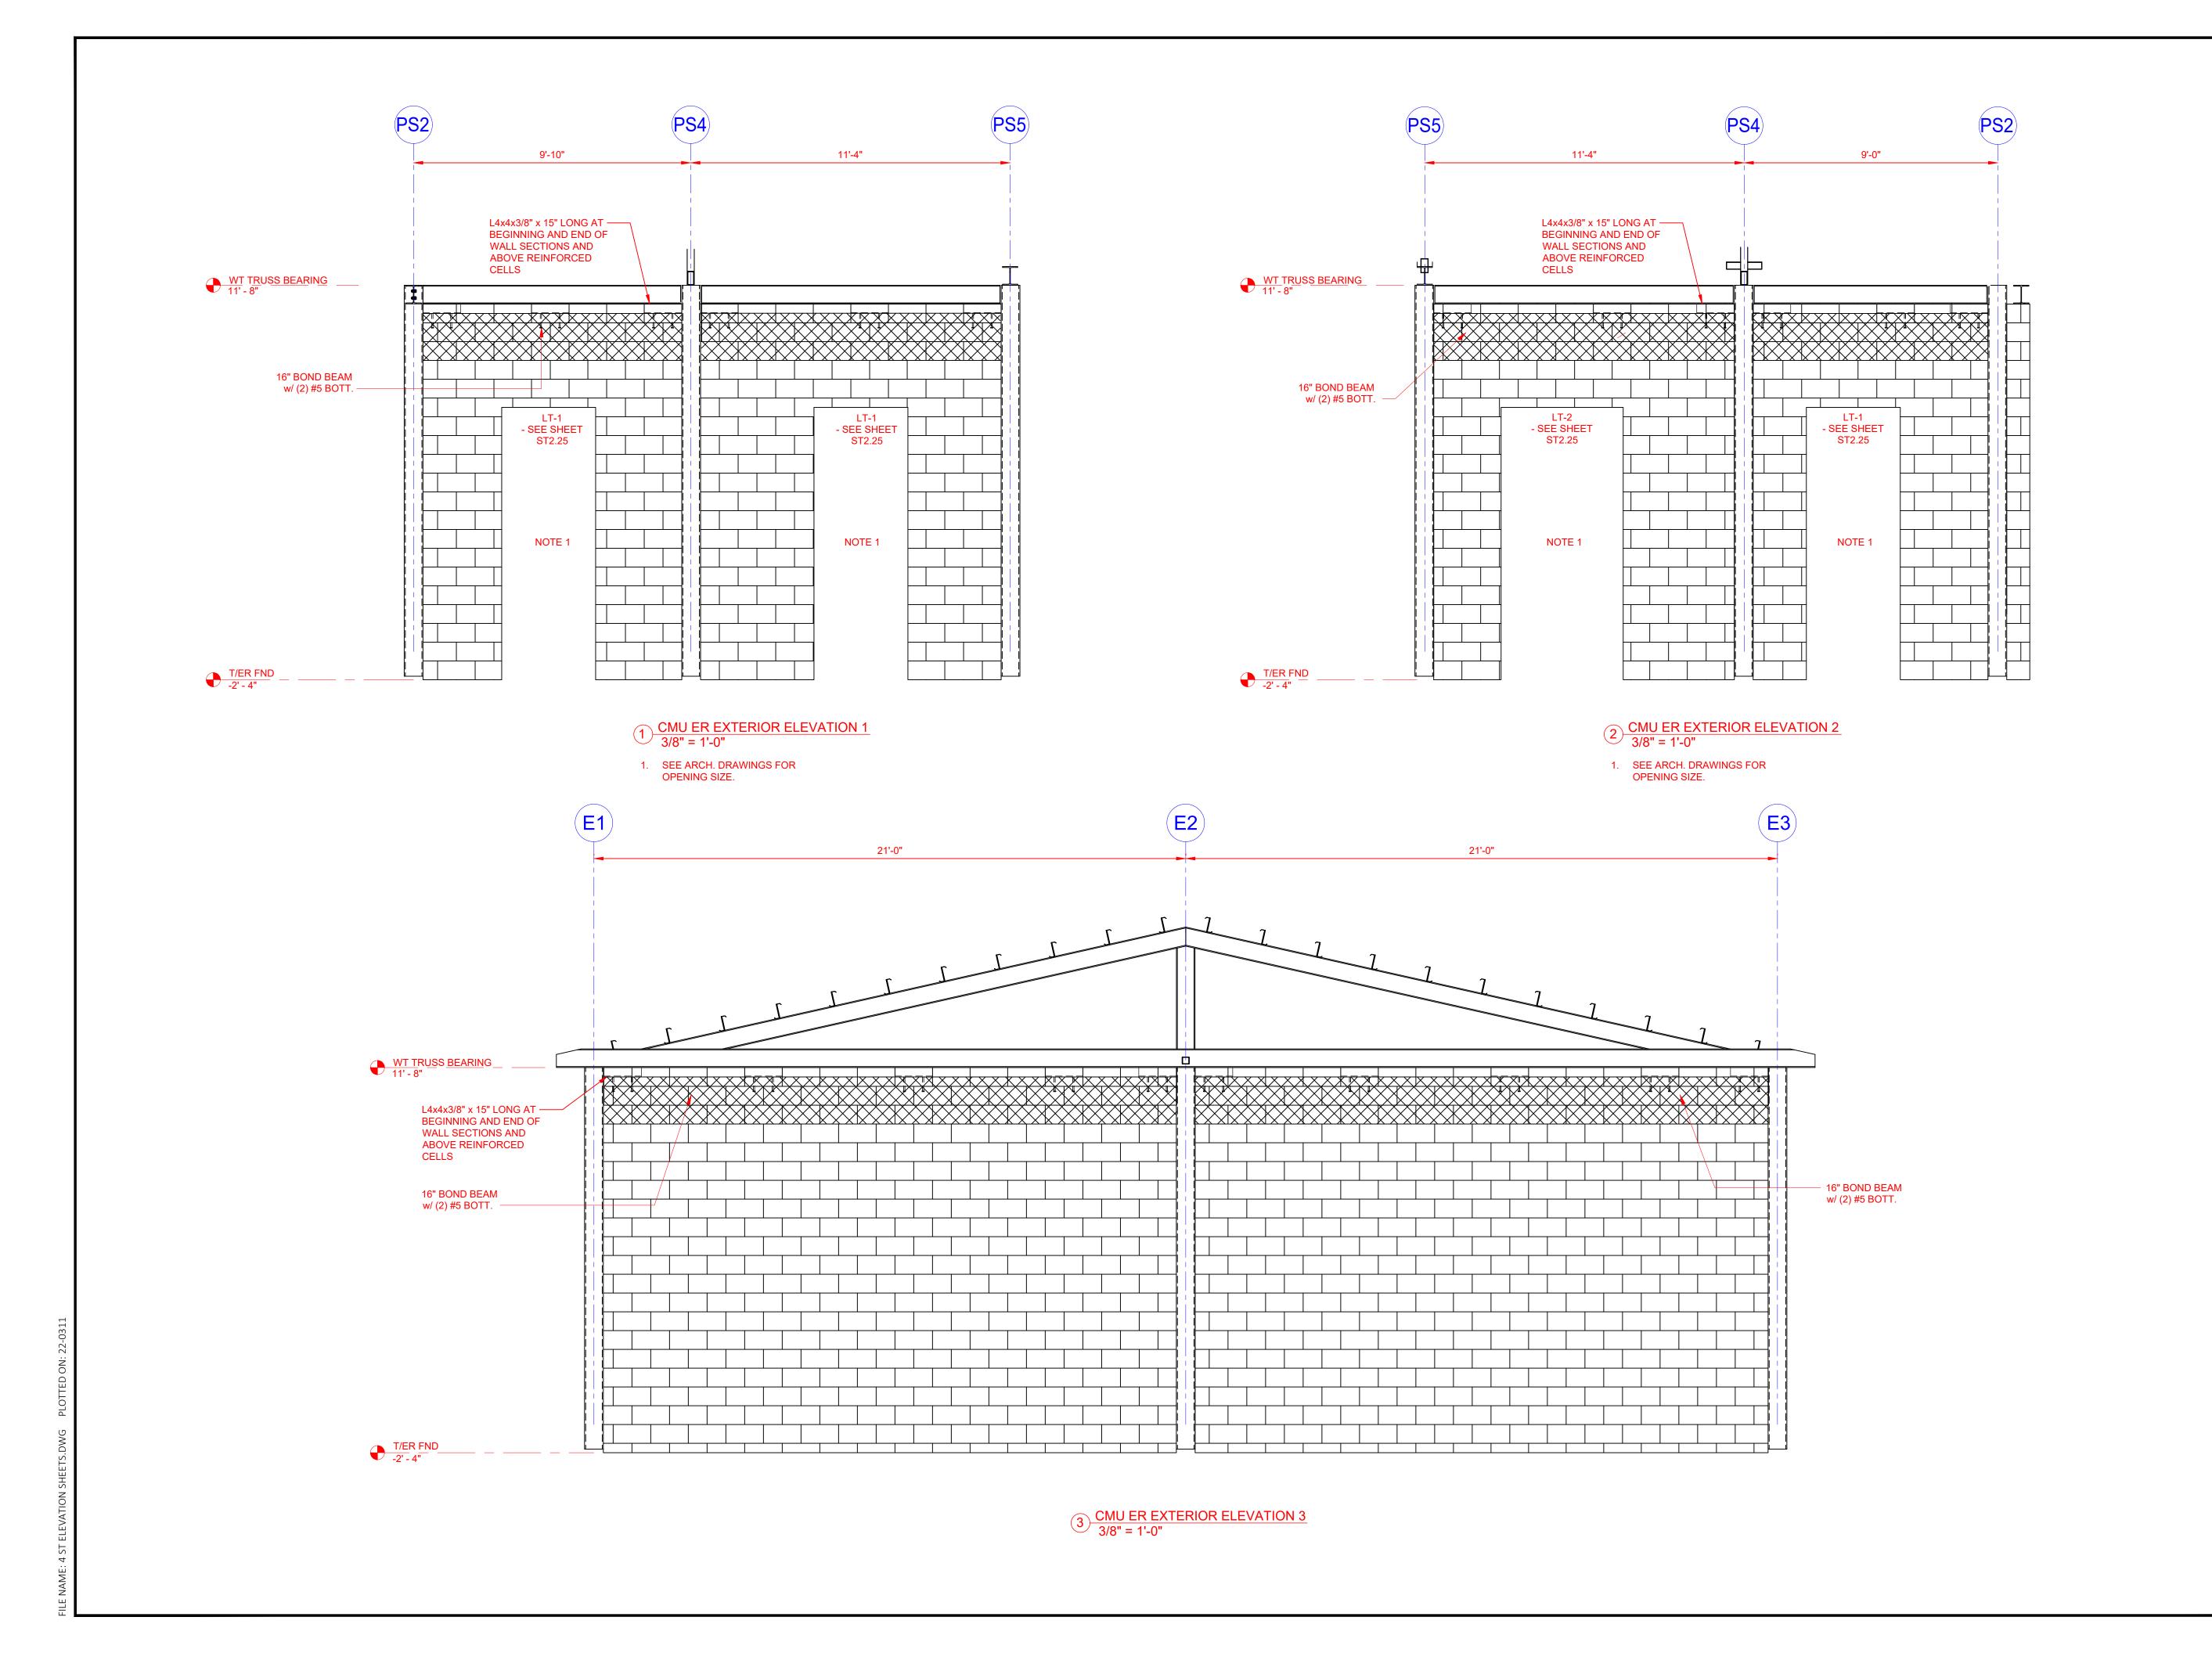



PROJECT:

TIDAL

NOTE OF THE PROJECT:


Tidal Wave Auto Spa 3039 W US-90 Lake City, FL 32055 Columbia County

PROTOTYPE DA

PROTOTYPE DATE:
SETUP DATE:

SET NAME:

SET DATE:

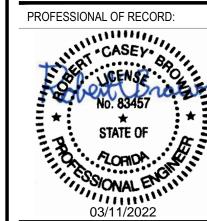

DESIGNER'S INFORMATION:



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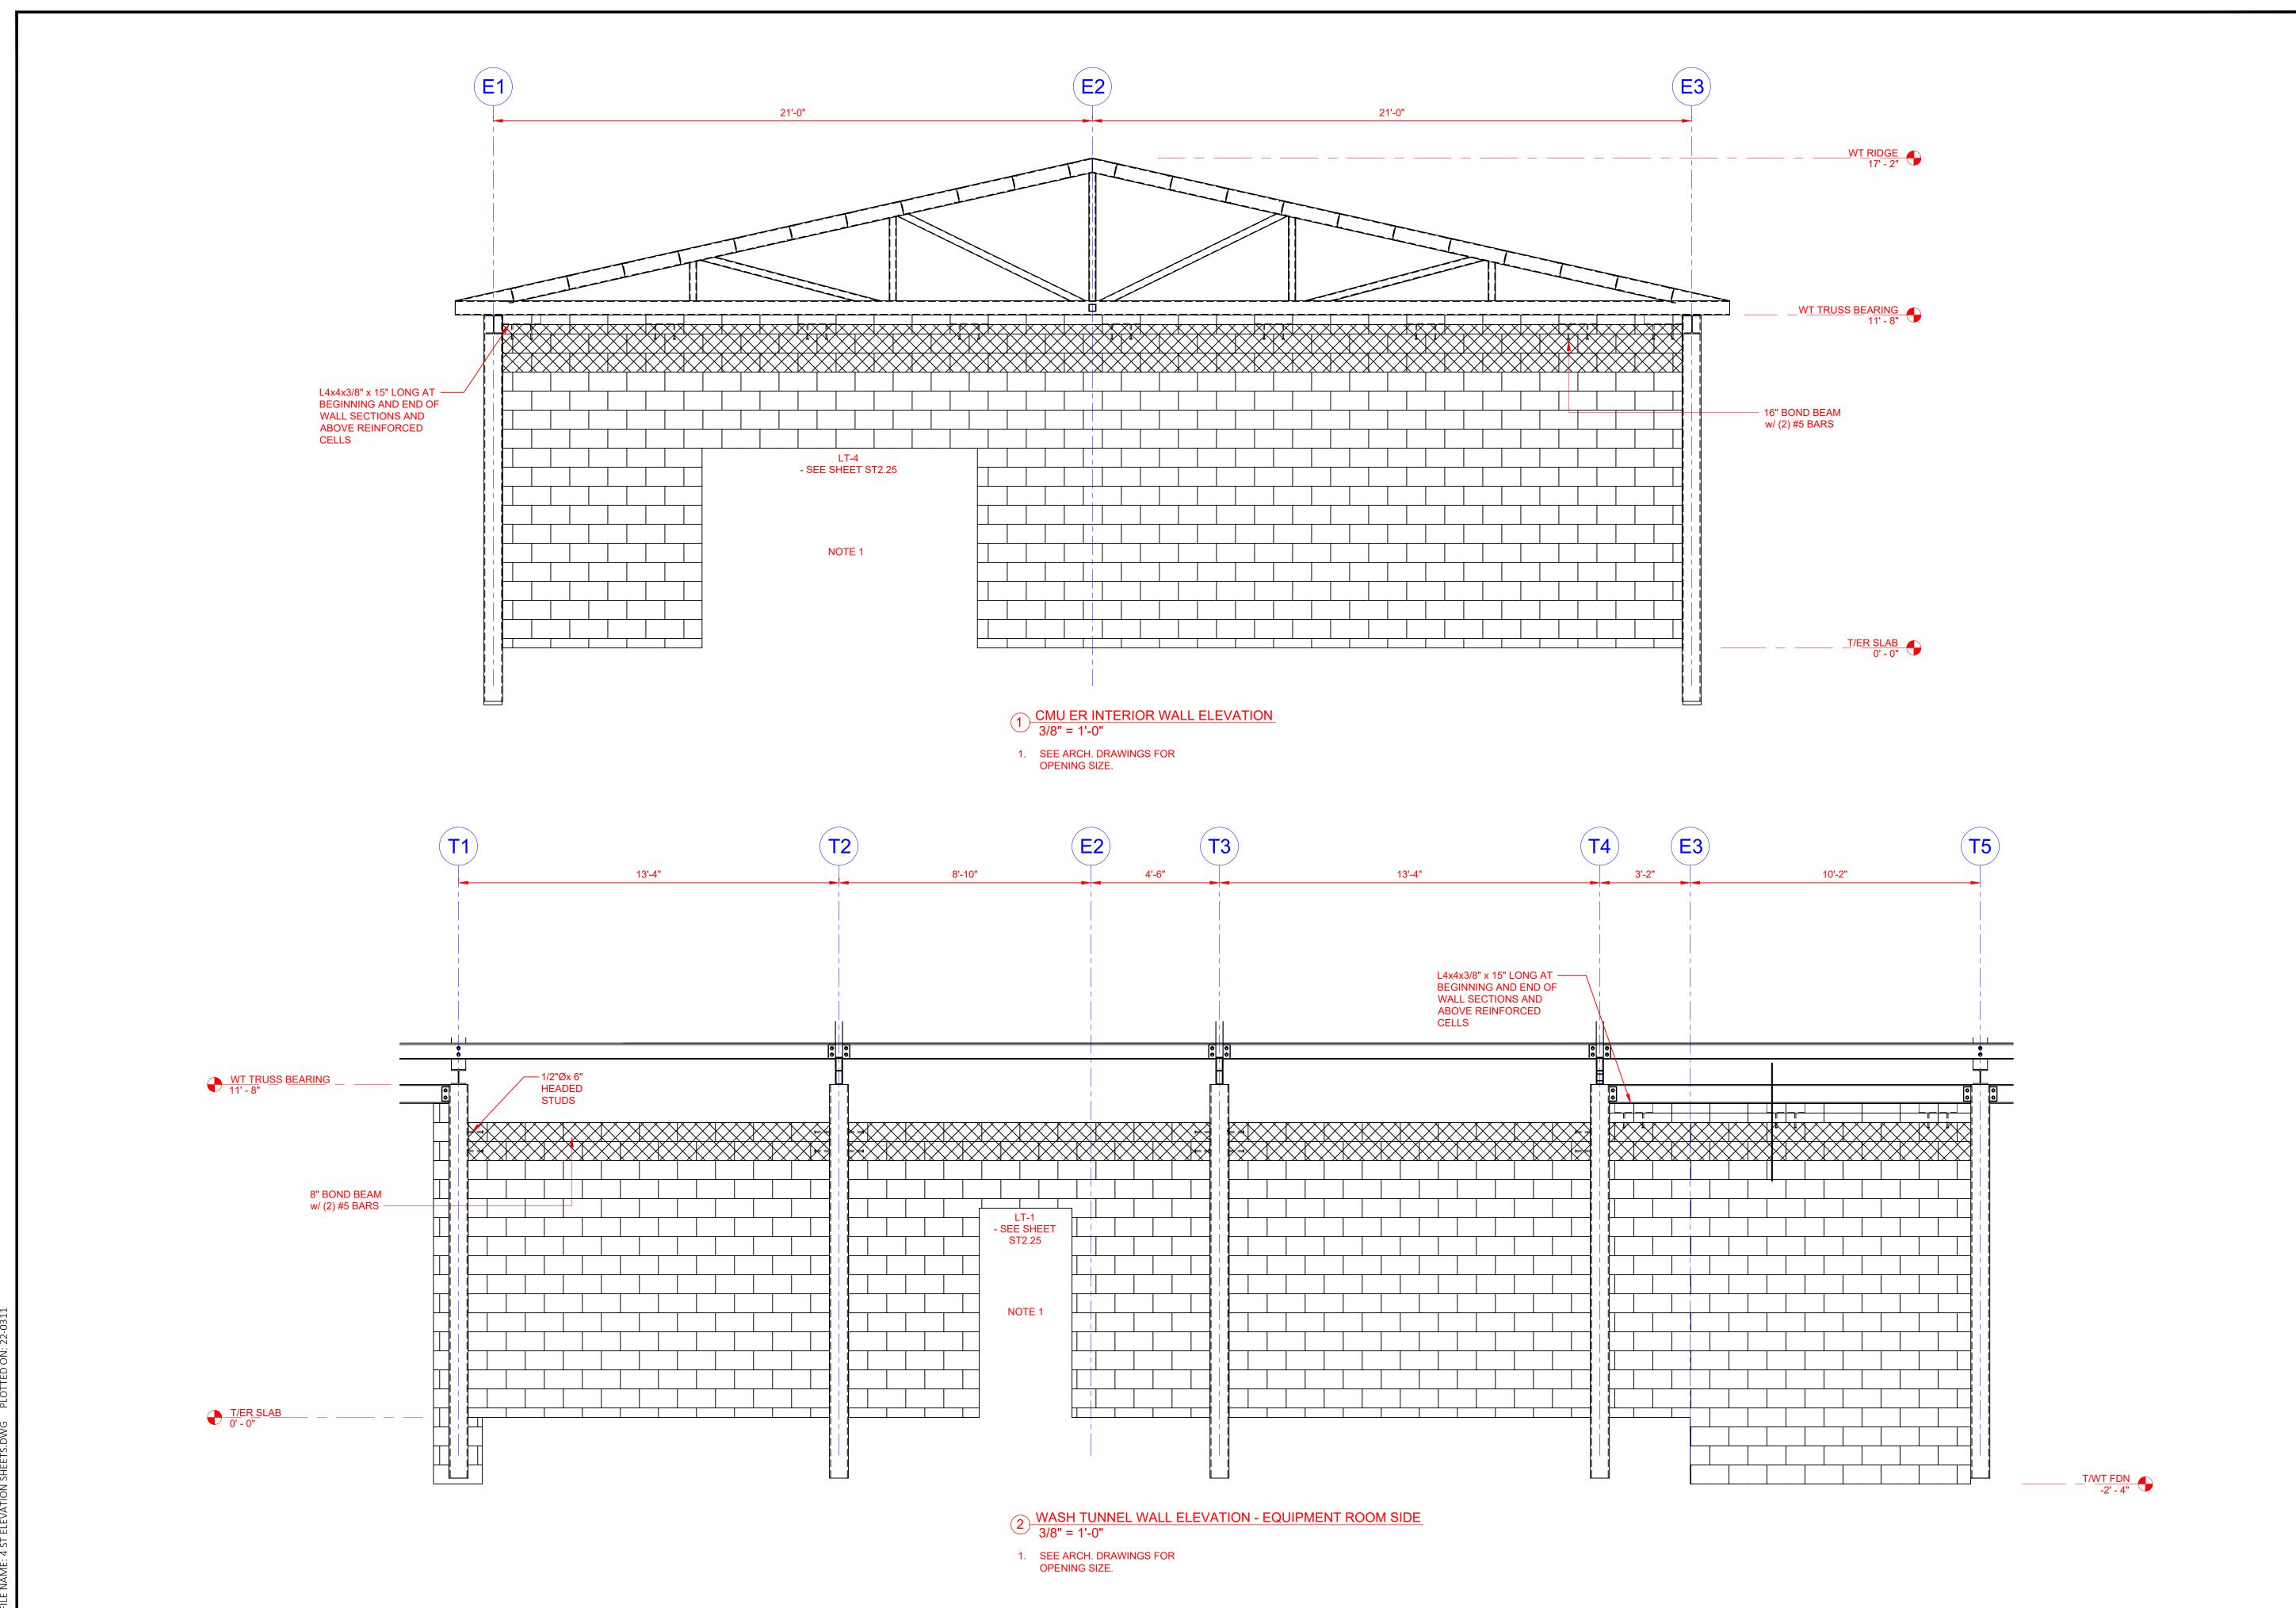
DRAWN BY: F

WASH TUNNEL CMU WALL ELEVATIONS

SHEET SCAL

SHEET SCALE:
SHEET NUMBER:

T2.22



OLSON LAND
PARTNERS, LLC
Real Estate Acquisitions & Development
4300 Legendary Drive, Suite 234
Destin, Florida 32541
T: 850.650.4353 F: 850.650.3881

PROJECT:

TIDAL

NOTE OF THE PROJECT OF THE PROJECT

Tidal Wave Auto Spa 3039 W US-90 Lake City, FL 32055 Columbia County

PROTOTYPE:

PROTOTYPE DATE:

SETUP DATE:

SET NAME:

SET DATE:

CASEY
No. 83457
STATE OF

03/11/2022
DESIGNER'S INFORMATION:



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2970 Cottage Hill Road

Mobile, AL 36606

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DESCRIPTION:	
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WASH TUNNEL CMU


WALL ELEVATIONS


SHEET SCALE:

SHEET NUMBER:

DRAWN BY:
SHEET TITLE:

ST2.23

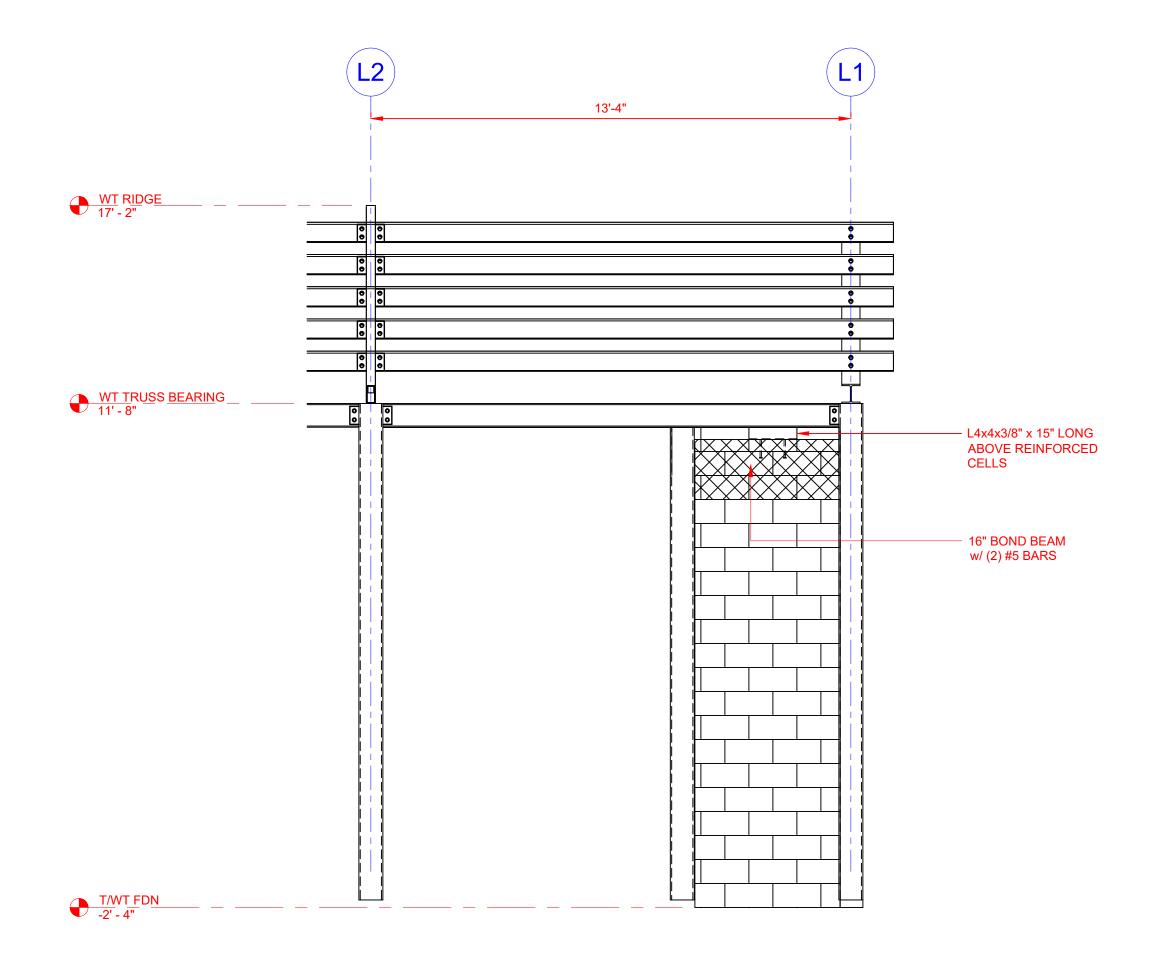

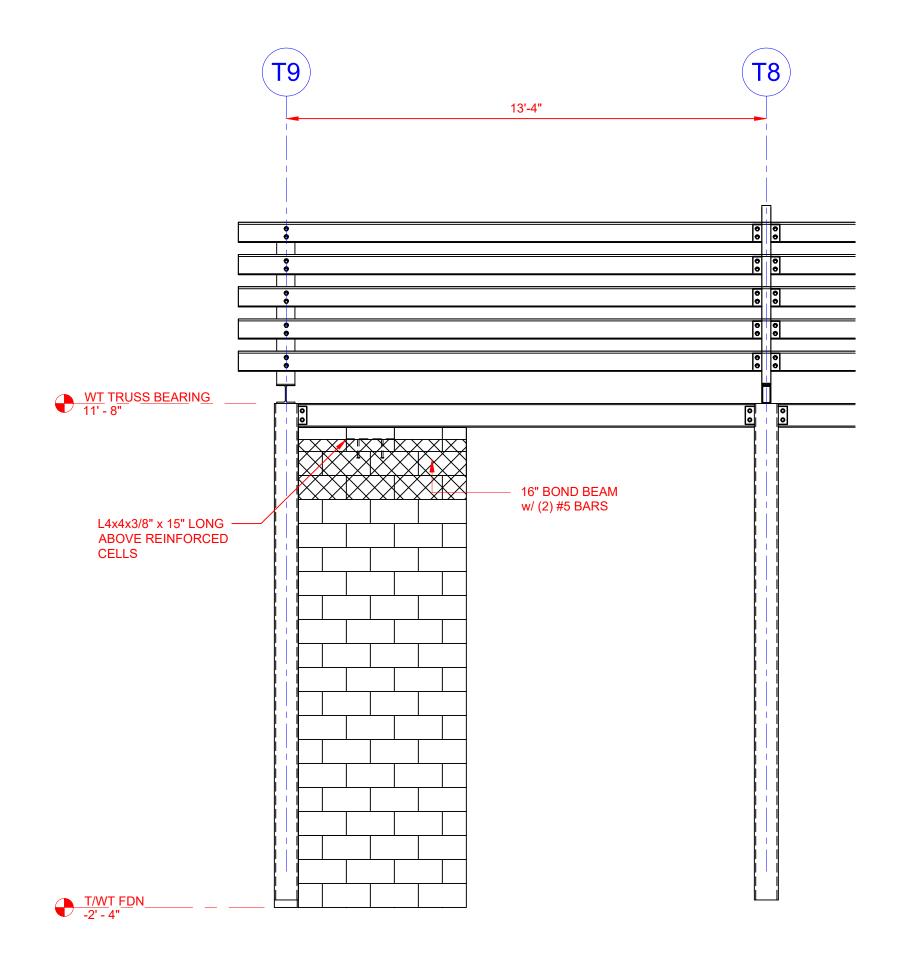

1 CMU WT EXTERIOR ELEVATION A
3/8" = 1'-0"

2 CMU WT EXTERIOR ELEVATION B 3/8" = 1'-0"



PROJECT:

TIDAL

A U T O S P

Tidal Wave Auto Spa 3039 W US-90 Lake City, FL 32055 Columbia County

PROTOTYPE:

PROTOTYPE DATE:

SETUP DATE:

SET NAME:

SELDAII

CASEY
No. 83457
STATE OF
03/11/2022

DESIGNER'S INFORMATION:



Thompson Engineering, Inc.
2970 Cottage Hill Road
Mobile, AL 36606

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SHEET DATE	SHEET DATE:	
SHEET REVIS	SIONS:	
▲ DATE:	DESCRIPTION:	
DRAWN BY:		RKN


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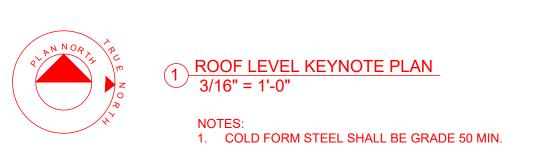
WASH TUNNEL CMU
WALL ELEVATIONS

HEET SCALE:

SHEET SCALE:
SHEET NUMBER:

ST2.24



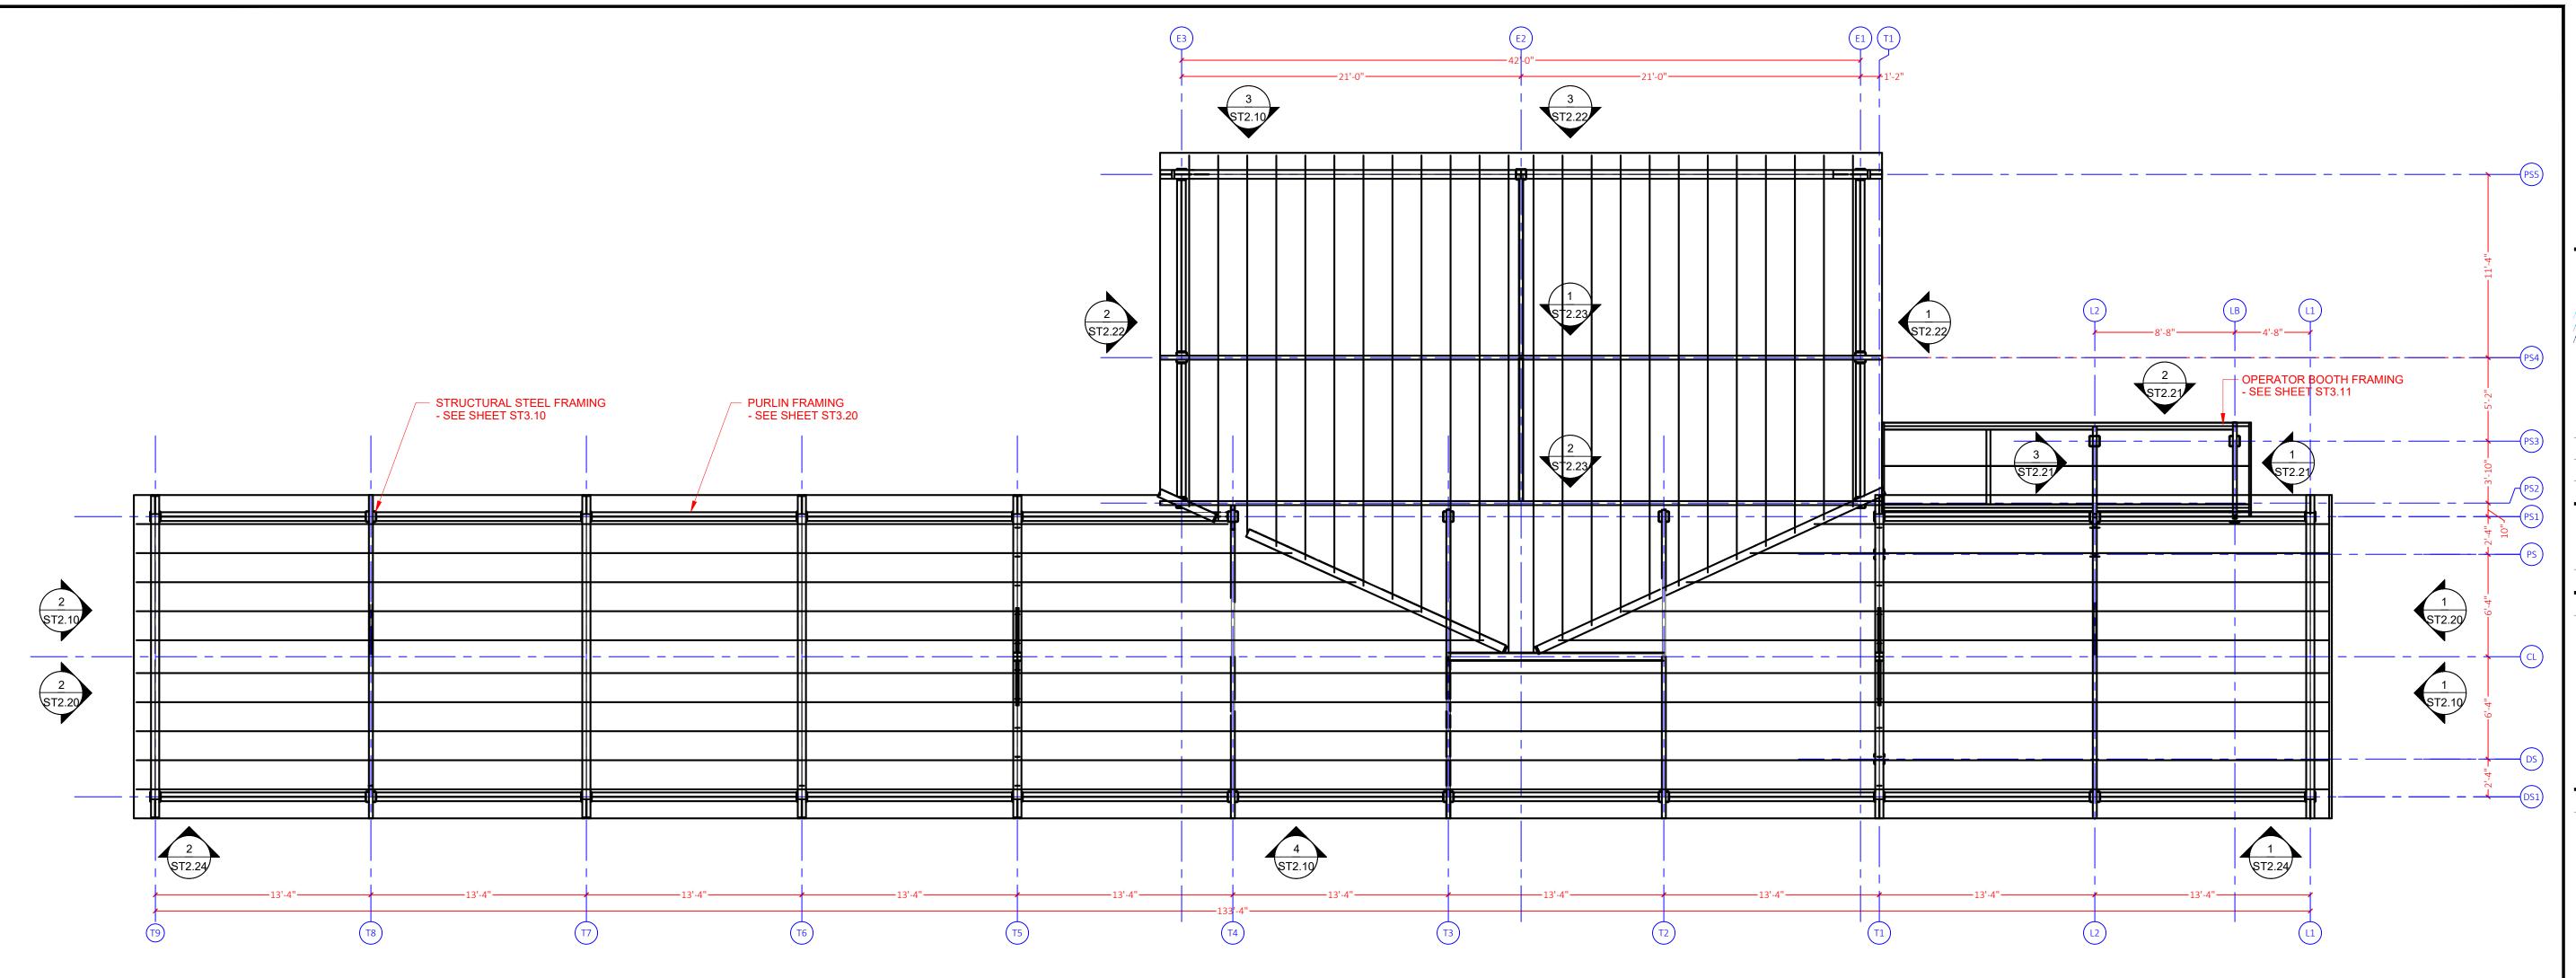



Tidal Wave Auto Spa 3039 W US-90 Lake City, FL 32055 Columbia County

PROTOTYPE DATE:

SETUP DATE: SET NAME:

PROFESSIONAL OF RECORD:

DESIGNER'S INFORMATION:

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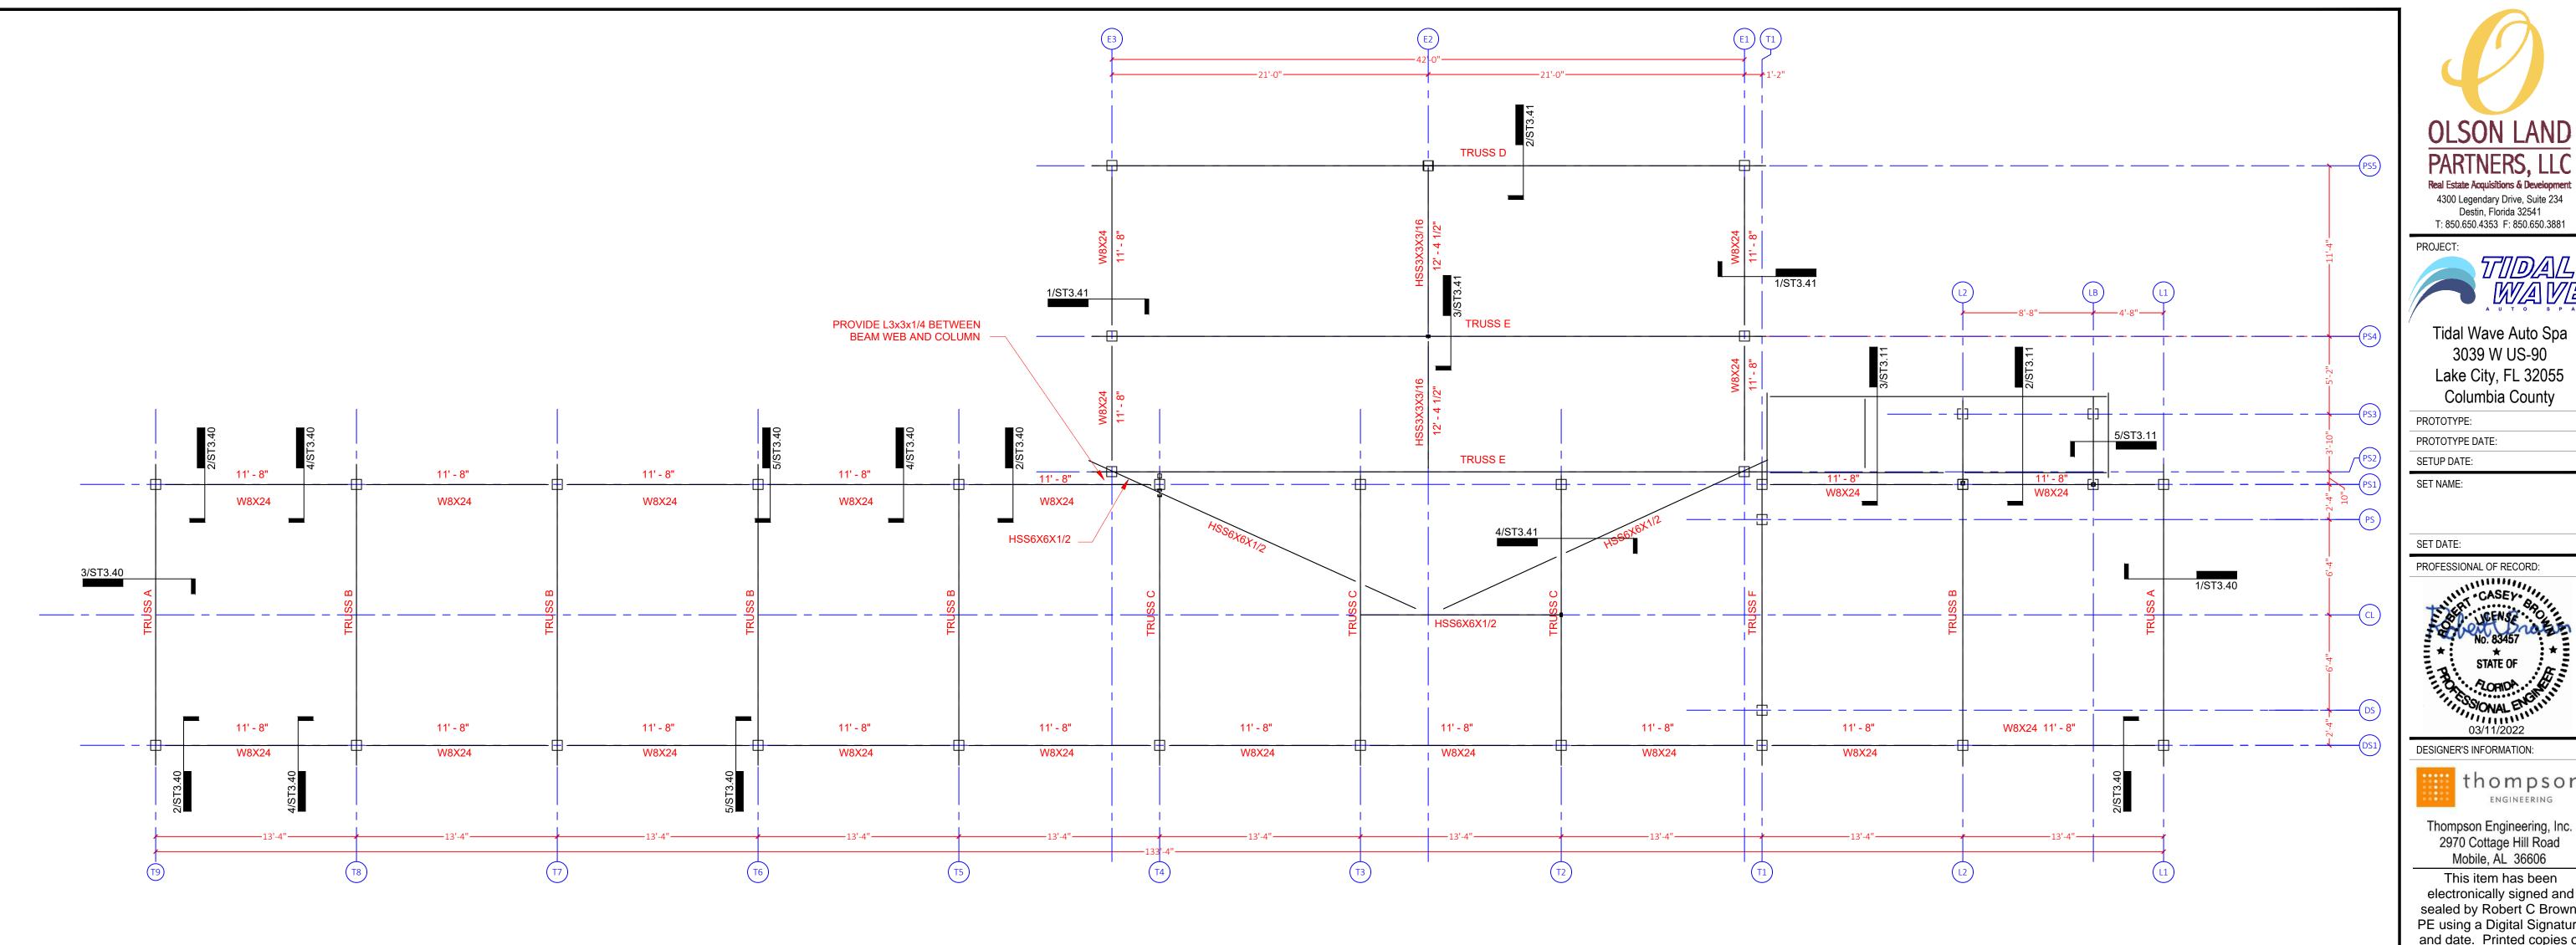
SHEET DATE:		22-0311	
SHEET REVISIONS:			
▲ DATE:	DESCRIPTION:		
	l.		

SHEET TITLE:

DRAWN BY:

ROOF LEVEL KEYNOTE PLAN

SHEET SCALE: X" = 1'-0" OR VARIES





1 ROOF STEEL FRAMING PLAN 3/16" = 1'-0" NOTES:
1. SEE SHEET ST3.00 FOR PLAN NOTES.




PROJECT:

Tidal Wave Auto Spa 3039 W US-90 Lake City, FL 32055 Columbia County

PROTOTYPE DATE:

SETUP DATE: SET NAME:

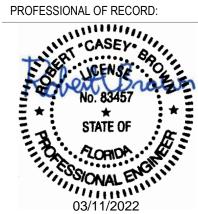

DESIGNER'S INFORMATION:

thompson ENGINEERING


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SHEET REVISIONS:		
▲ DATE:	DATE: DESCRIPTION:	
01/04/2021	REVISION #1	

DRAWN BY: SHEET TITLE:

> **ROOF STEEL FRAMING PLAN**

SHEET SCALE: X" = 1'-0" OR VARIES

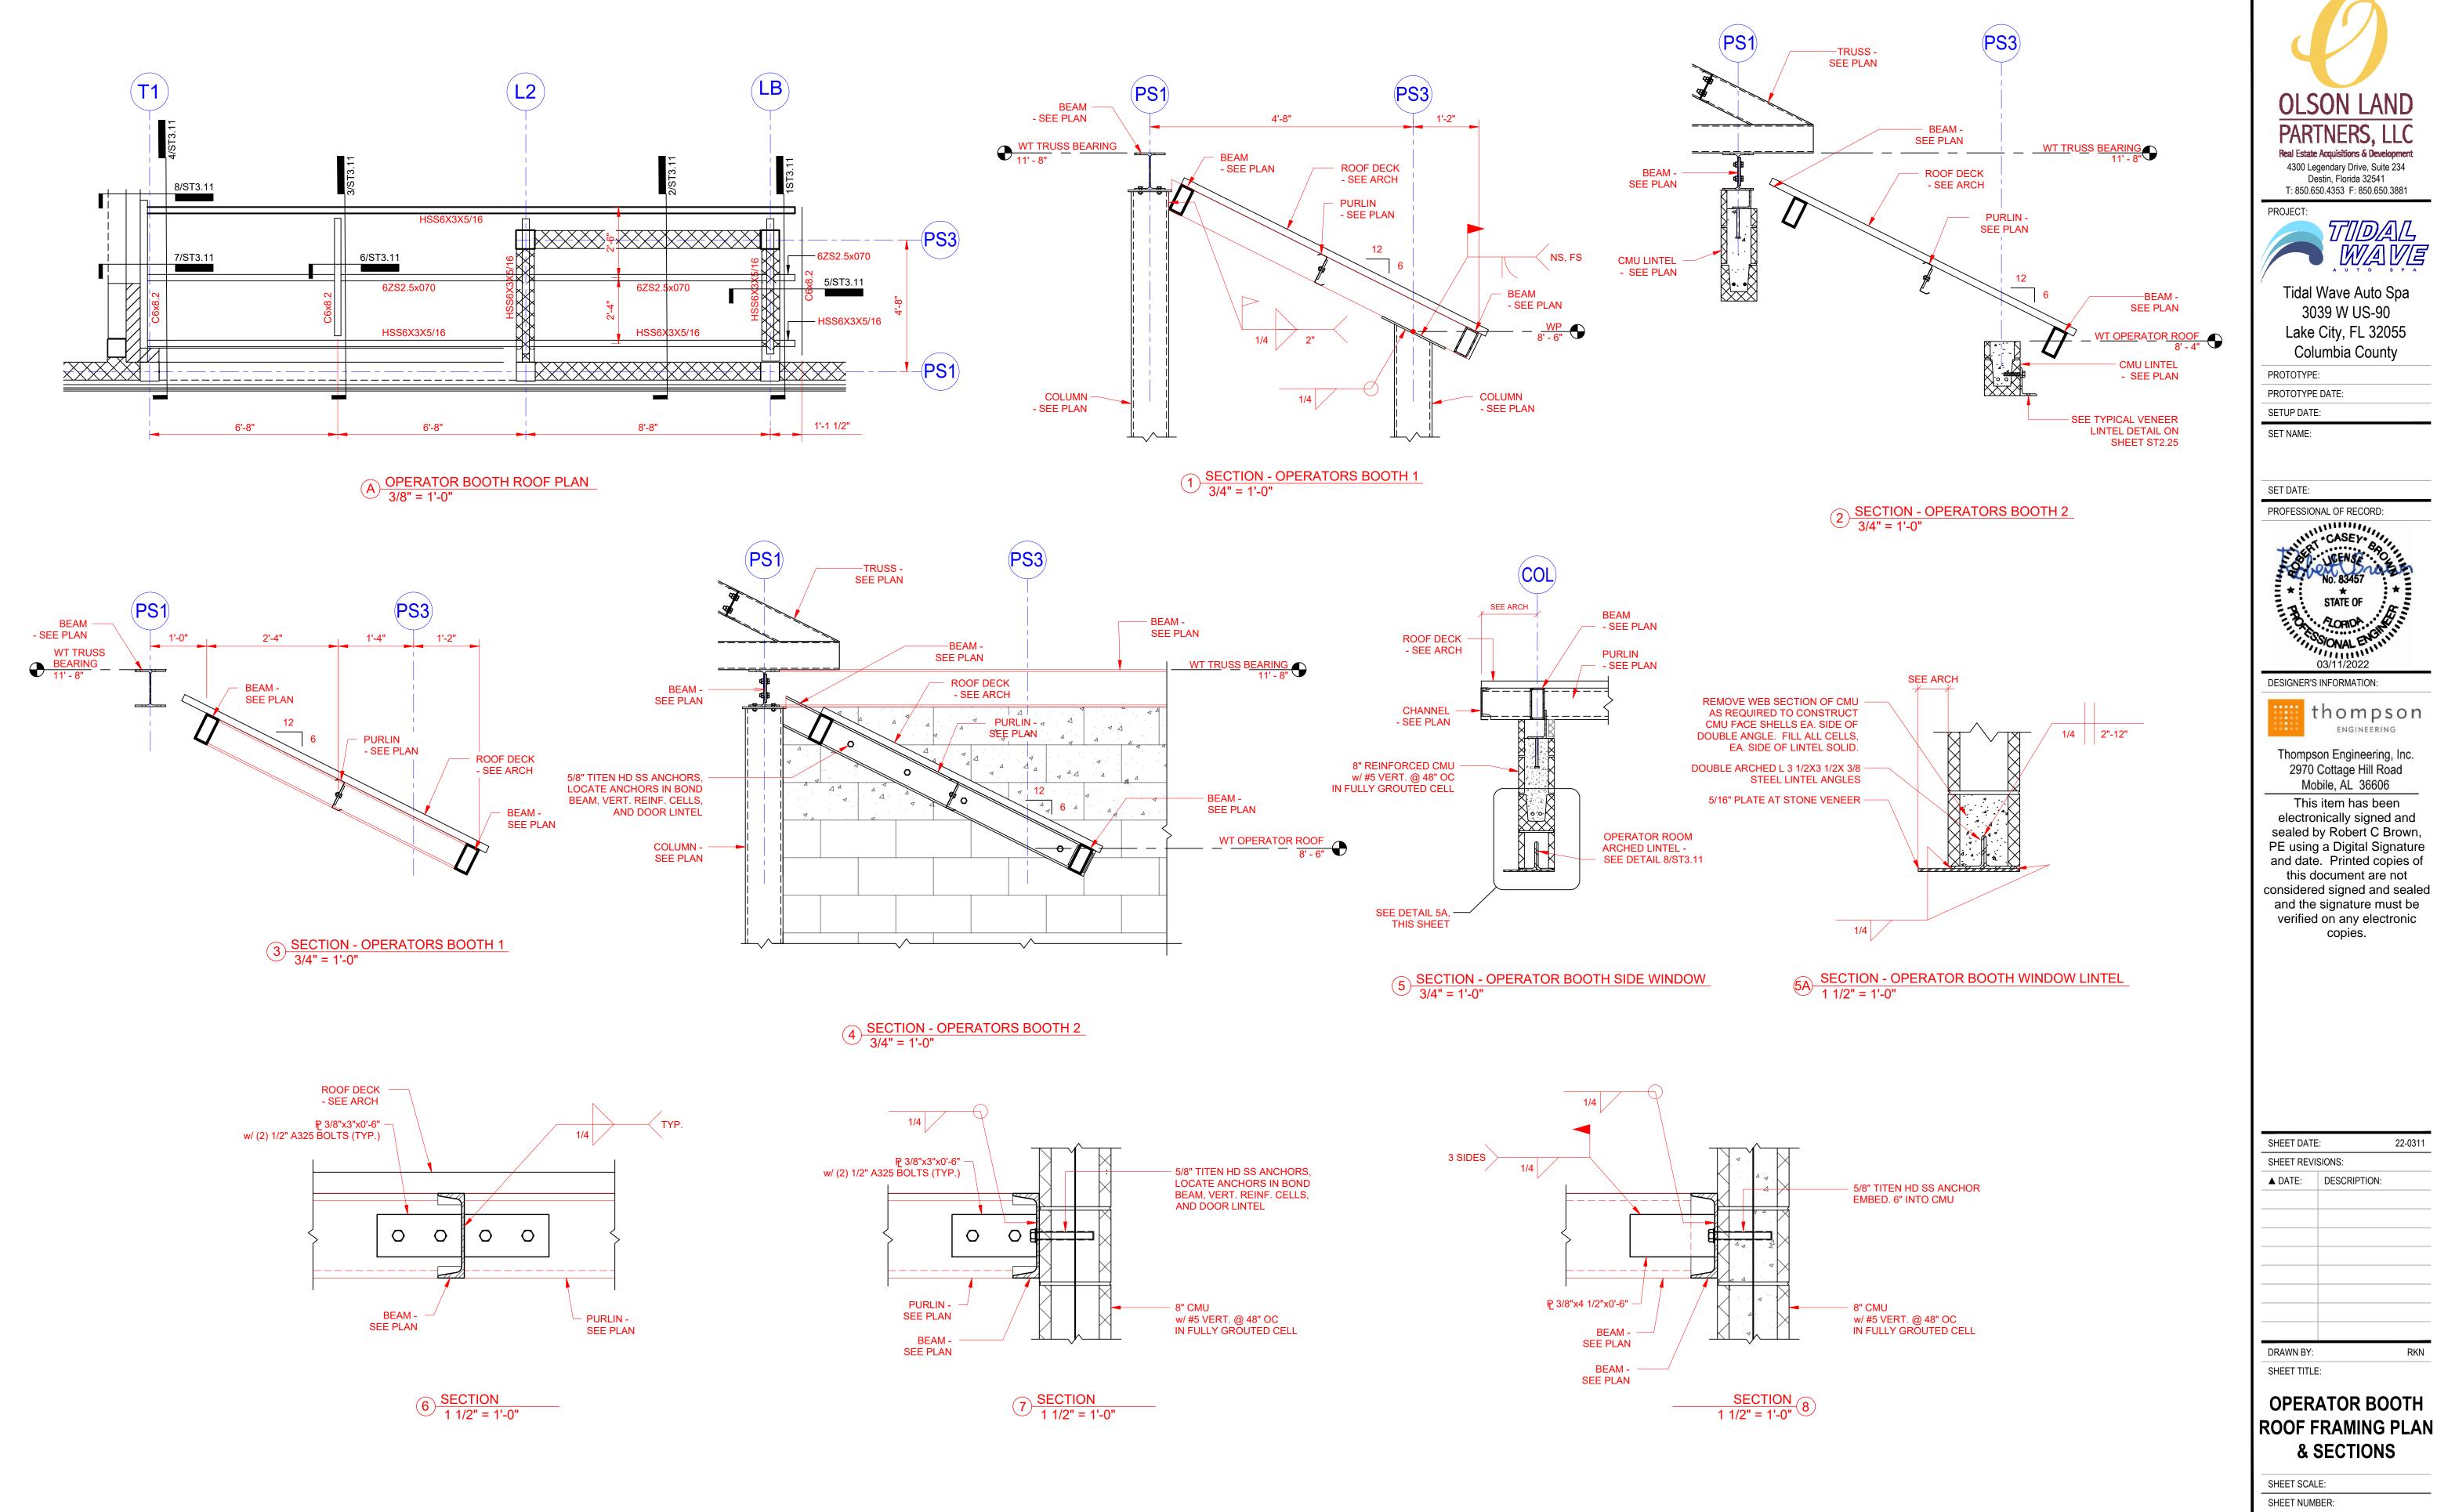

OLSON LAND 4300 Legendary Drive, Suite 234 Destin, Florida 32541 T: 850.650.4353 F: 850.650.3881


PROJECT: TIDAL WAYE

Tidal Wave Auto Spa 3039 W US-90 Lake City, FL 32055 Columbia County

PROTOTYPE: PROTOTYPE DATE:

SET NAME:

SET DATE:

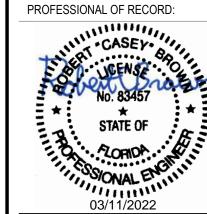

DESIGNER'S INFORMATION:

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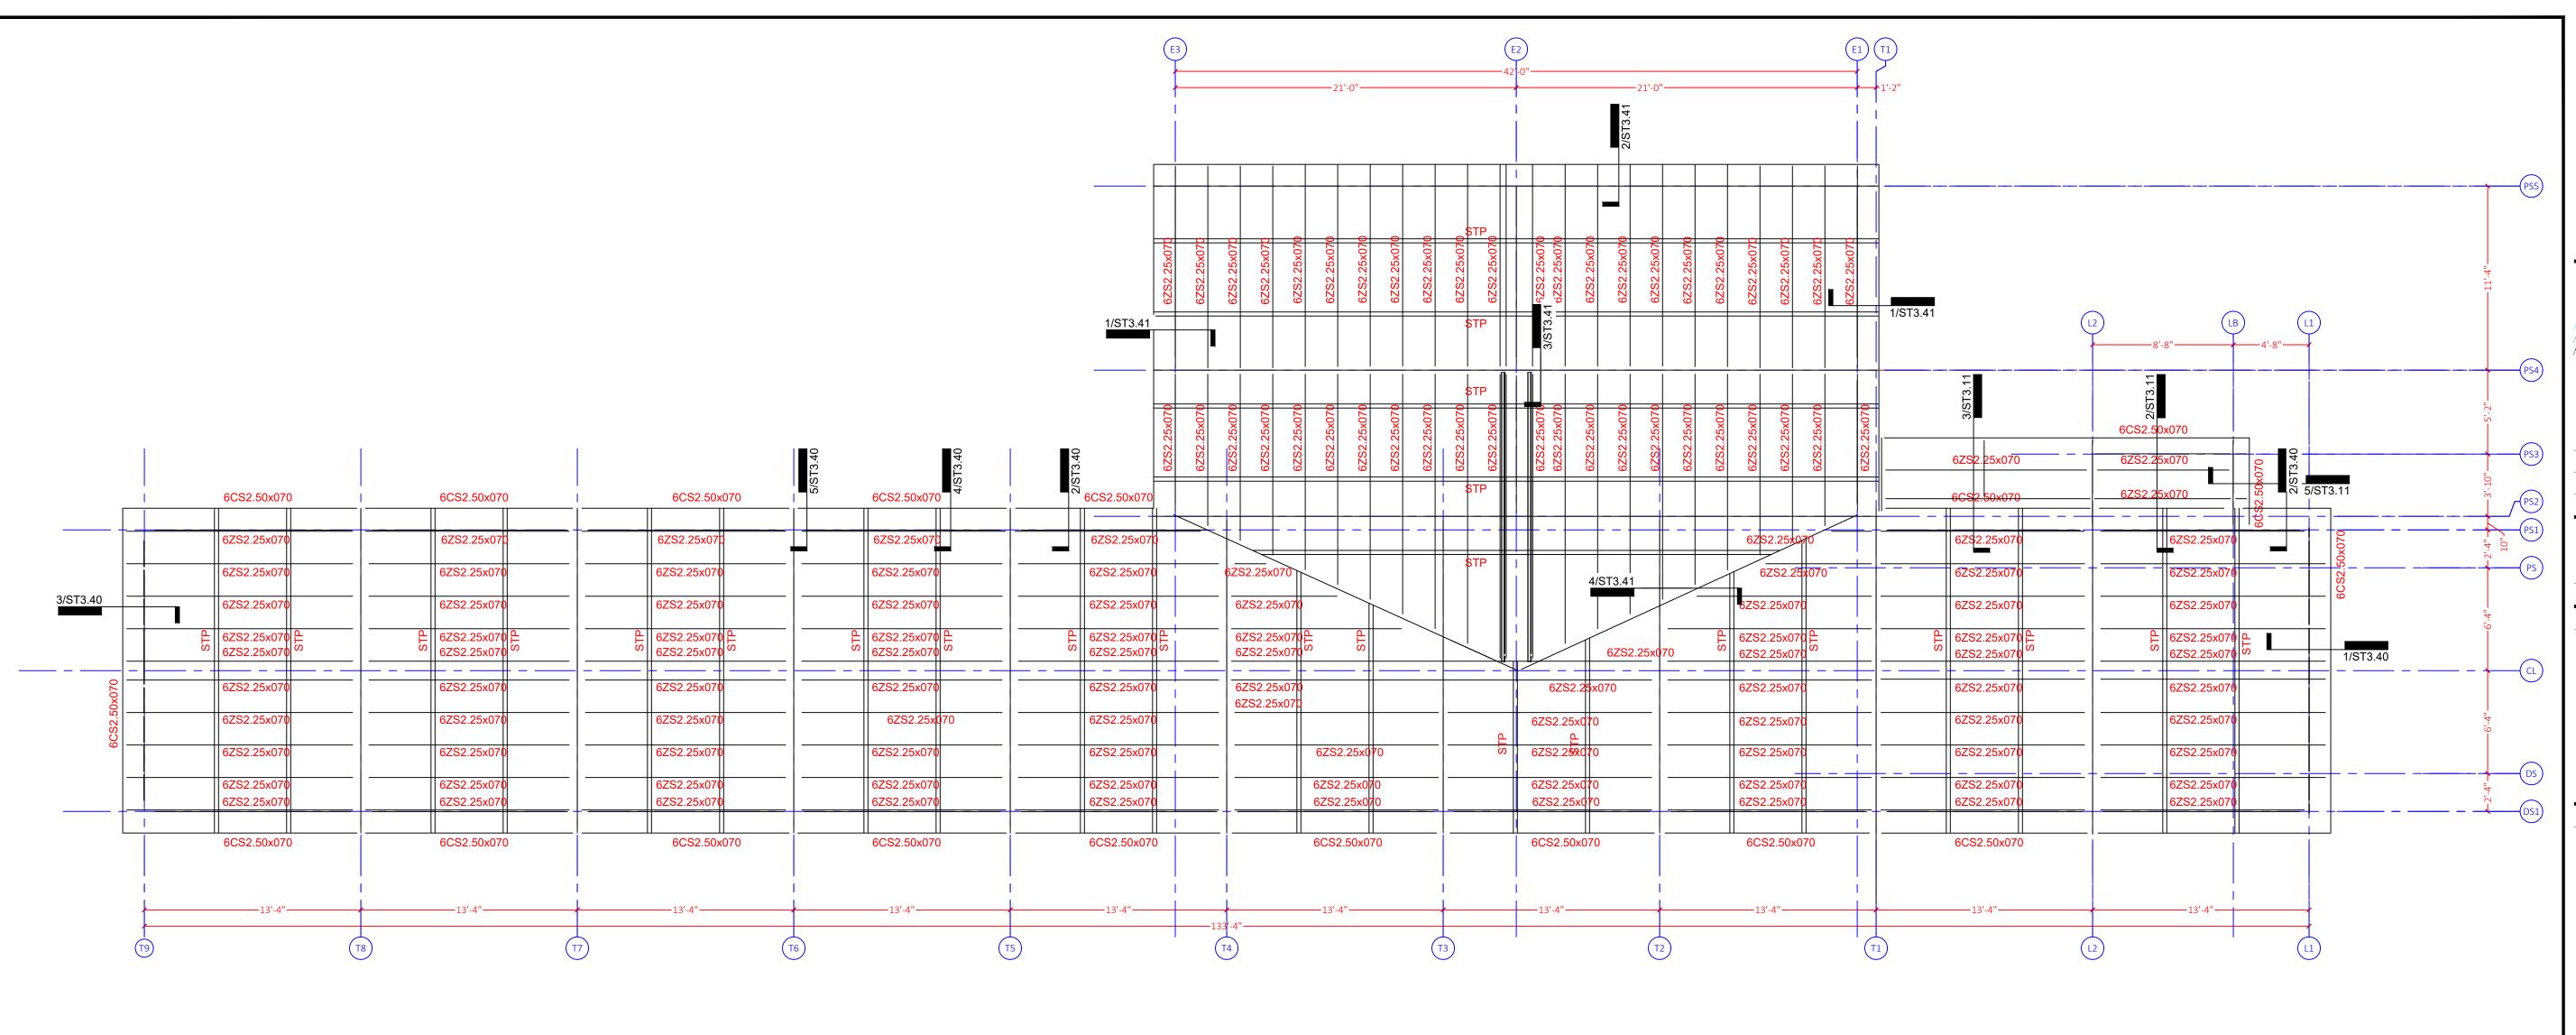
SHEET DATE:		22-0311
SHEET REVISIONS:		
▲ DATE:	DESCRIPTION:	

RKN

SHEET TITLE: **OPERATOR BOOTH**

& SECTIONS

SHEET SCALE:






1) ROOF PURLIN PLAN

NOTES: 1 SEE SHEET:

SEE SHEET ST3.00 FOR PLAN NOTES.
 COLD FORM STEEL SHALL BE GRADE 50 MIN.

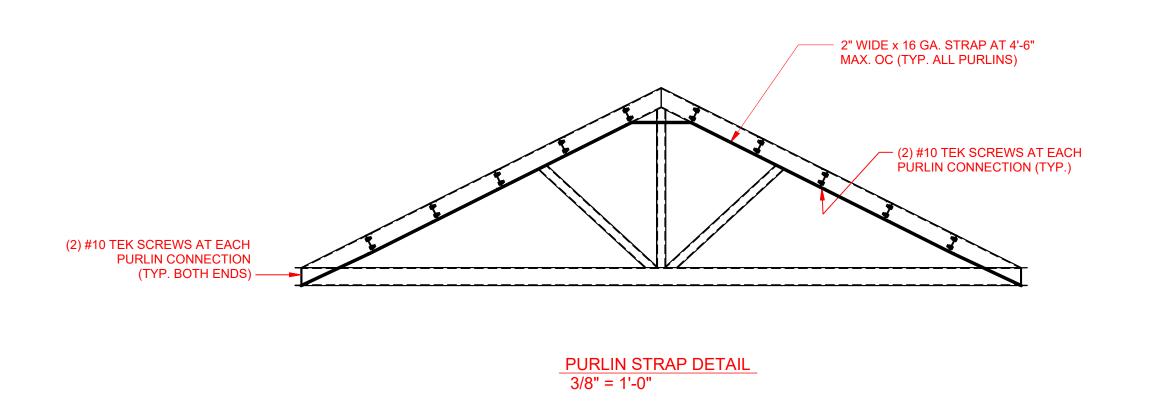



PROJECT:


Tidal Wave Auto Spa 3039 W US-90 Lake City, FL 32055 Columbia County

PROTOTYPE:

PROTOTYPE DATE:
SETUP DATE:

SET NAME:

SET DATE:

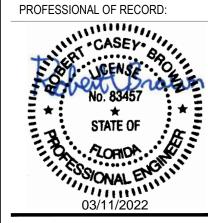

DESIGNER'S INFORMATION:



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Mobile, AL 36606

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SHEET REVISIONS:		
▲ DATE:	DESCRIPTION:	
DRAWN BY:		RKN


SHEET TITLE:

ROOF PURLIN PLAN

SHEET SCALE: X" = 1'-0" OR VARIES

SHEET SCALE:)
SHEET NUMBER:

ST3.20

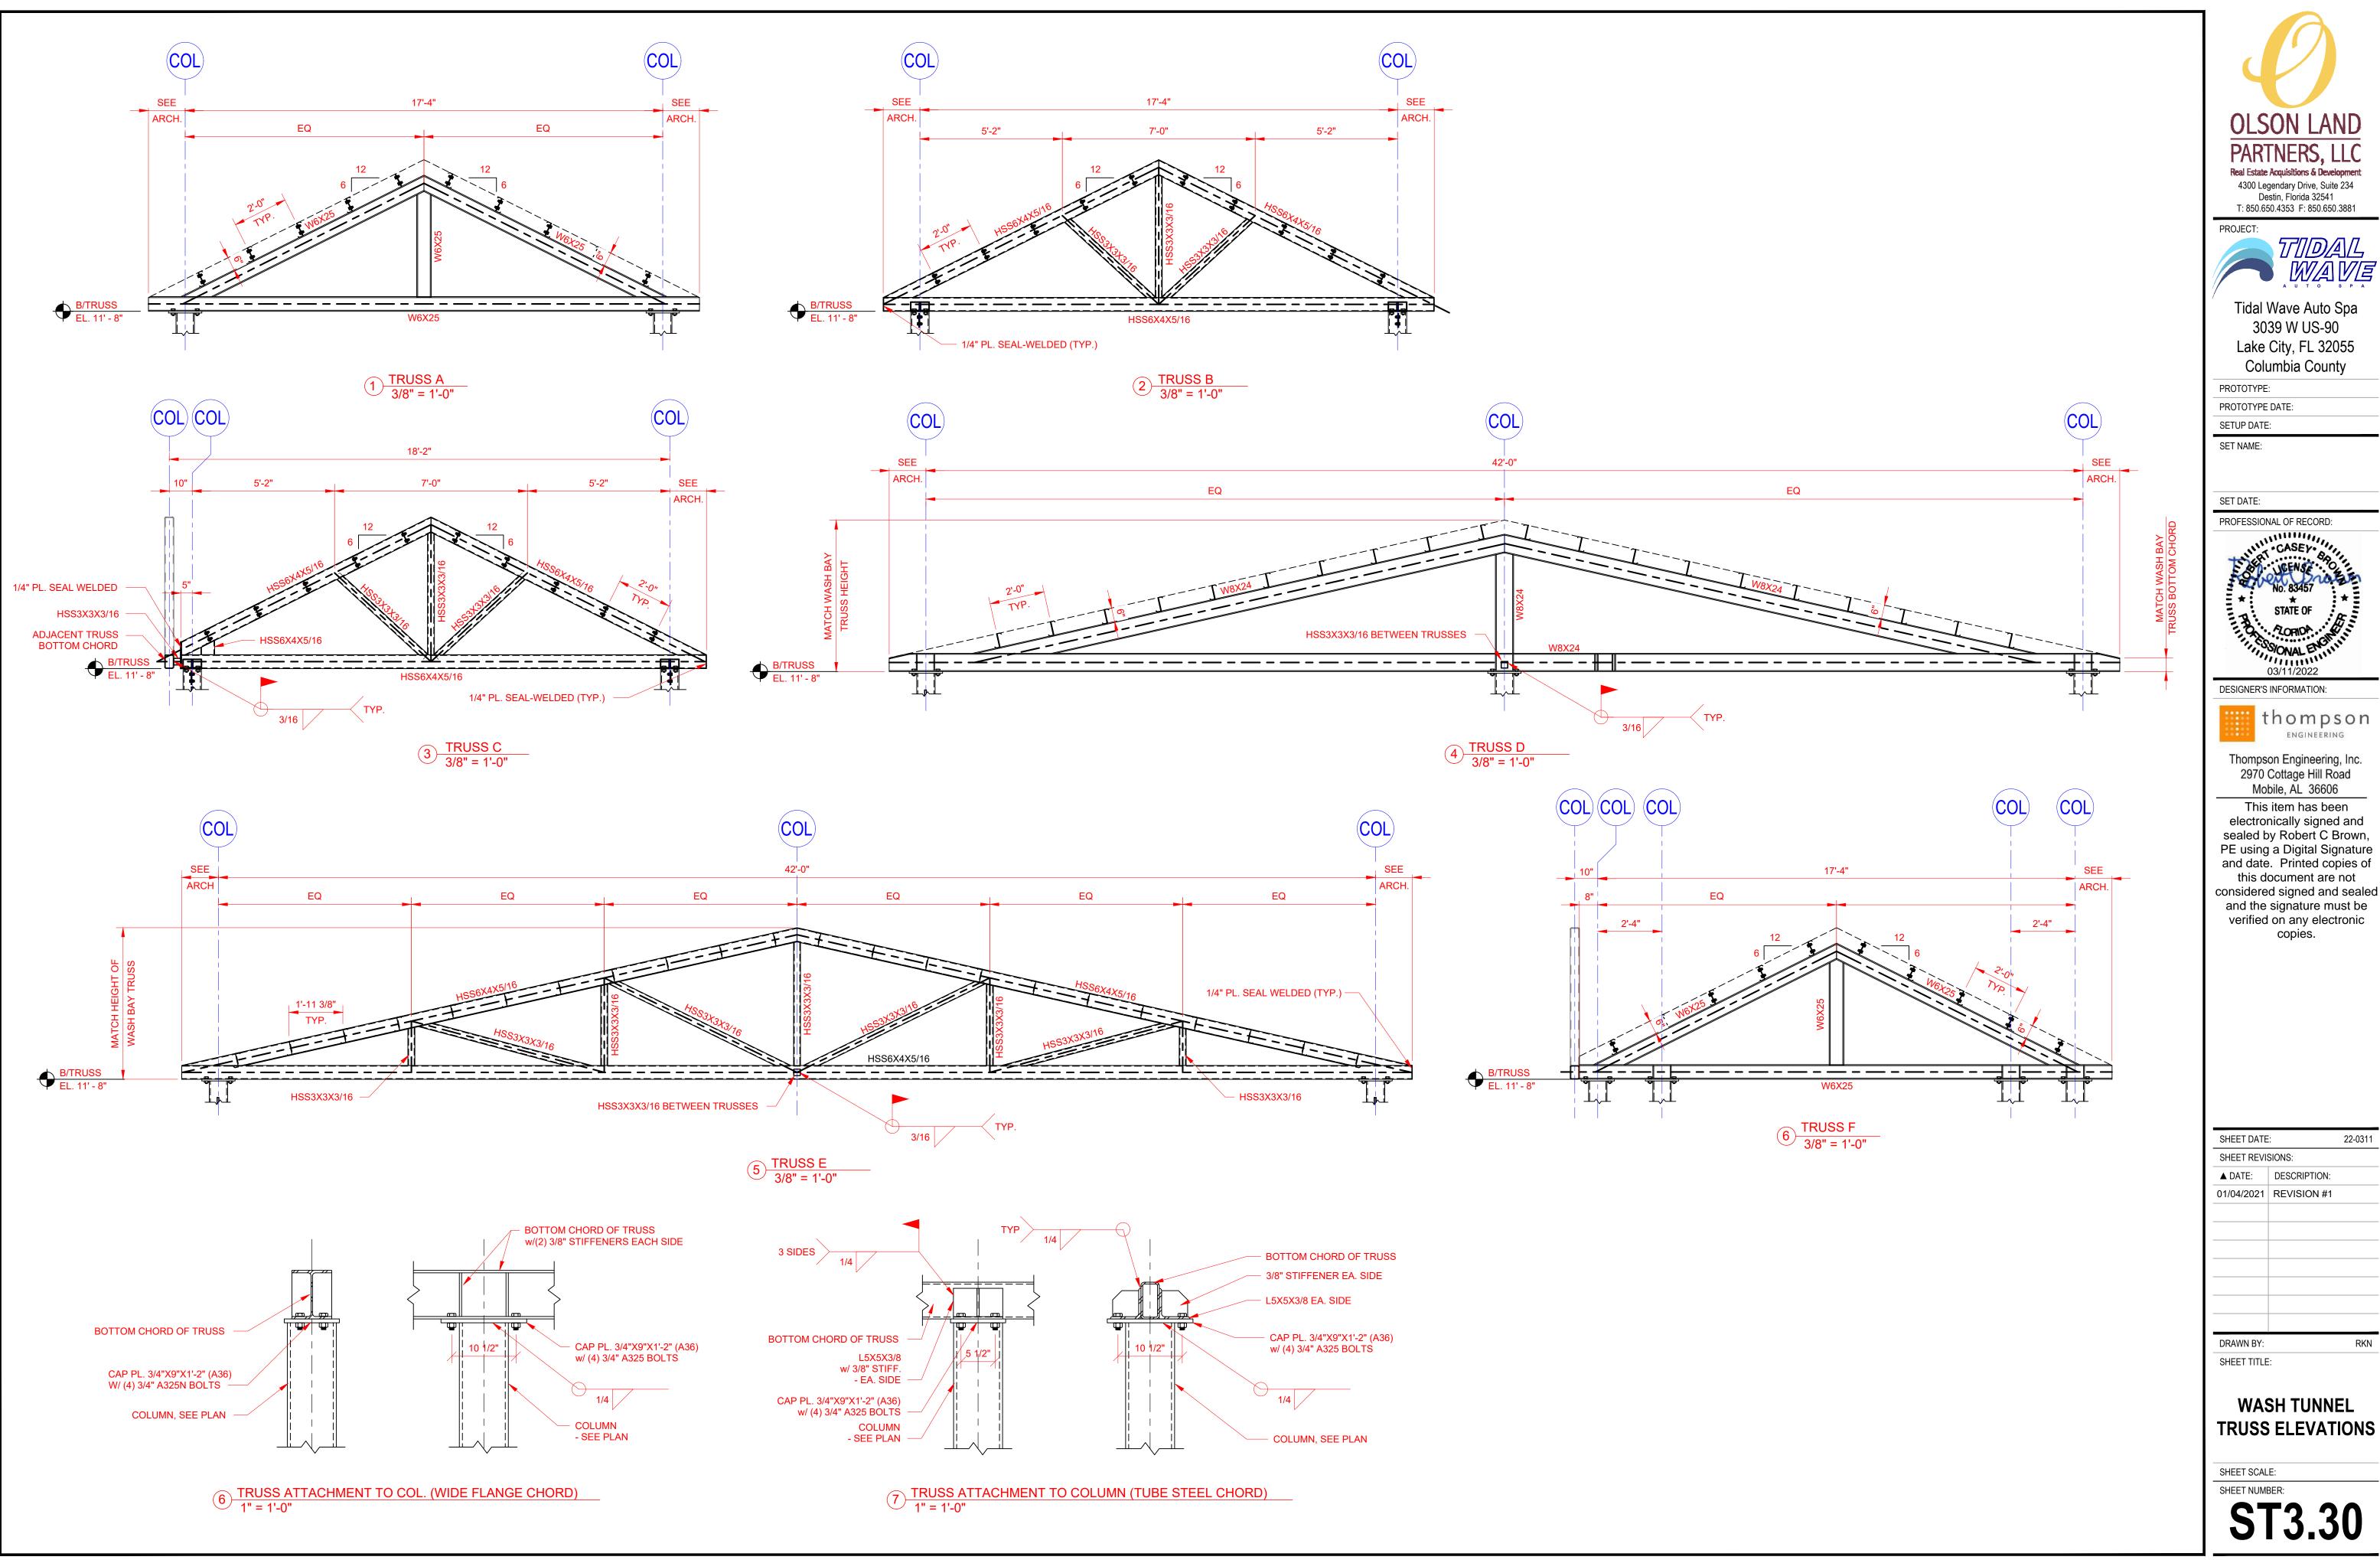

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TIDAL WAVE

Tidal Wave Auto Spa 3039 W US-90 Lake City, FL 32055 Columbia County

PROTOTYPE DATE:

PROFESSIONAL OF RECORD:


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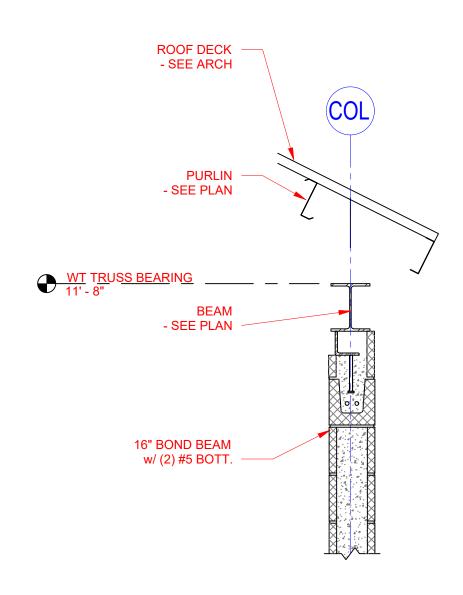
thompson ENGINEERING


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WASH TUNNEL TRUSS ELEVATIONS






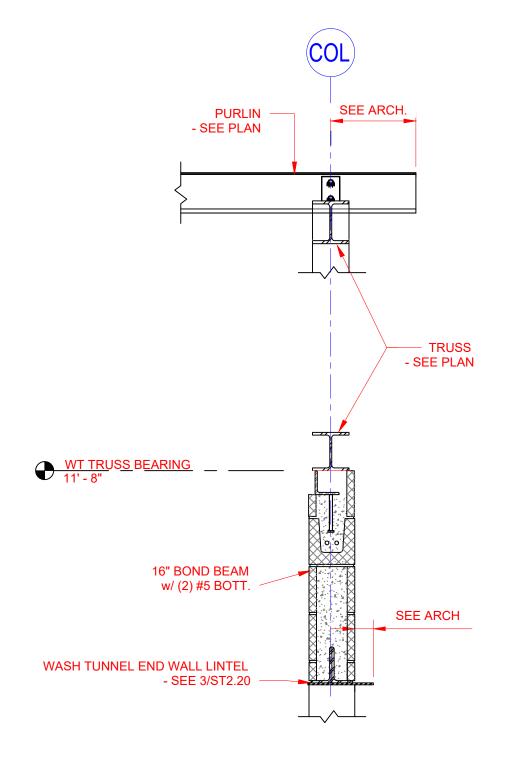


1 SECTION - WASH TUNNEL ENTRANCE 3/4" = 1'-0"

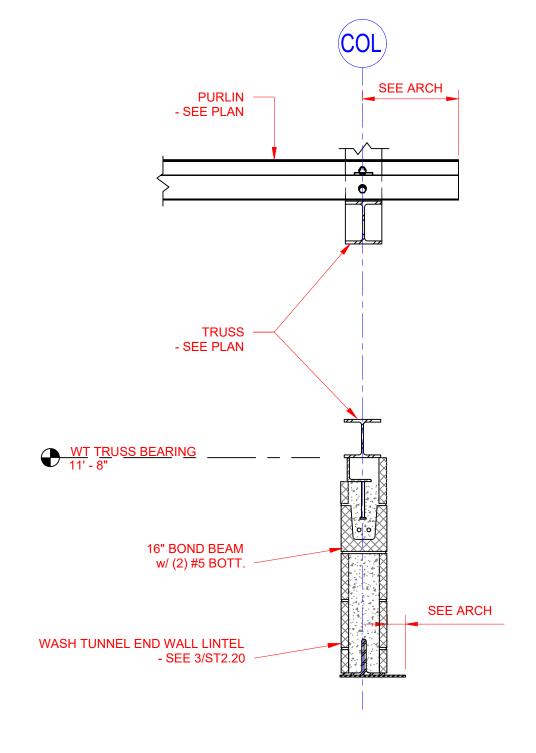2 SECTION - WASH TUNNEL SIDEWALL 3/4" = 1'-0"

3 SECTION - WASH TUNNEL EXIT 3/4" = 1'-0"

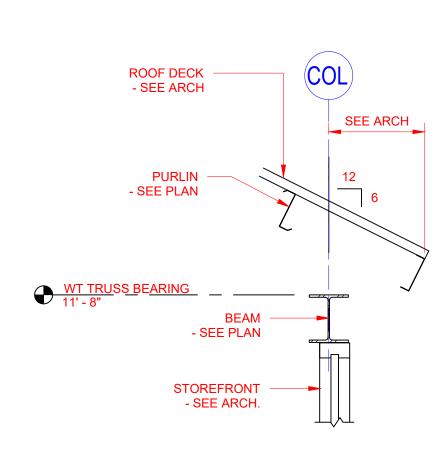

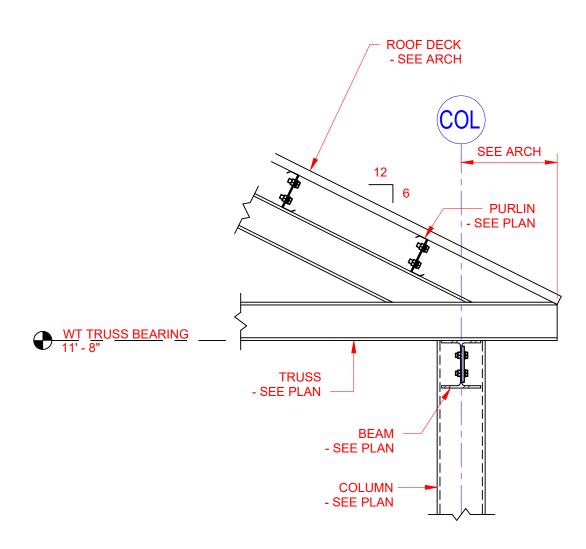

SECTION - WASH TUNNEL WINDOW ROOF EDGE
3/4" = 1'-0"

5 SECTION - WASH TUNNEL COLUMN ROOF EDGE 3/4" = 1'-0"



PROJECT:

Tidal Wave Auto Spa 3039 W US-90 Lake City, FL 32055 Columbia County

PROTOTYPE: PROTOTYPE DATE:

SET NAME:

PROFESSIONAL OF RECORD:



DESIGNER'S INFORMATION:





Thompson Engineering, Inc. 2970 Cottage Hill Road Mobile, AL 36606 This item has been electronically signed and sealed by Robert C Brown, PE using a Digital Signature and date. Printed copies of this document are not considered signed and sealed and the signature must be verified on any electronic copies.


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▲ DATE:	DESCRIPTION:	

DRAWN BY: SHEET TITLE:


WASH TUNNEL ROOF SECTIONS & DETAILS

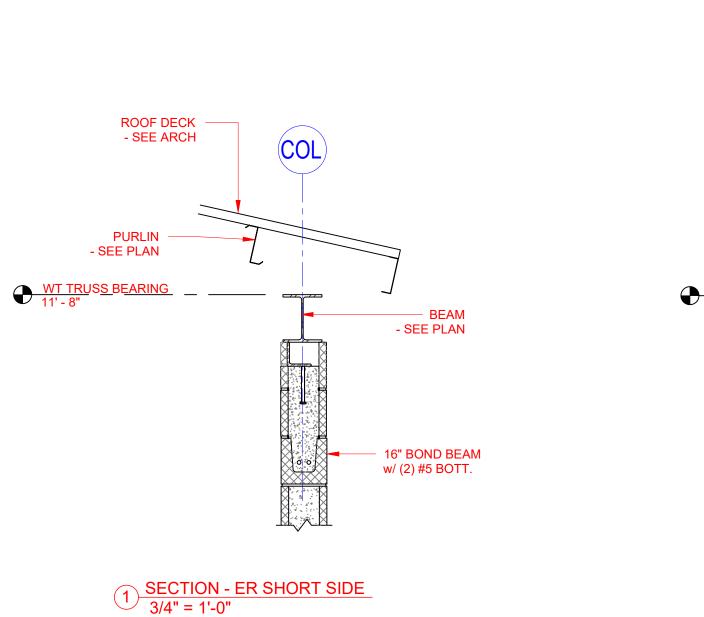

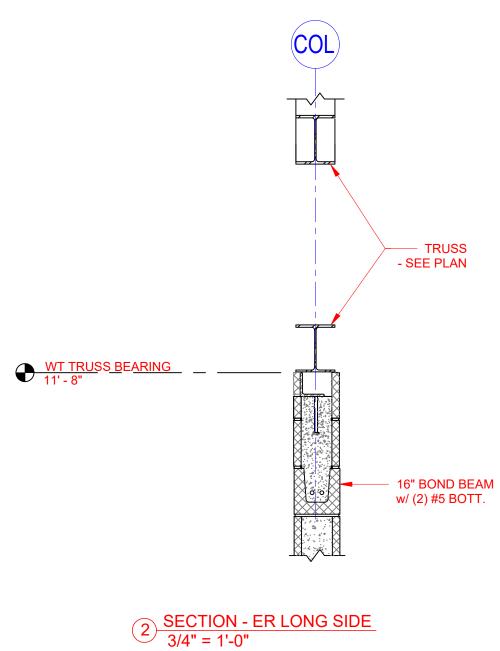

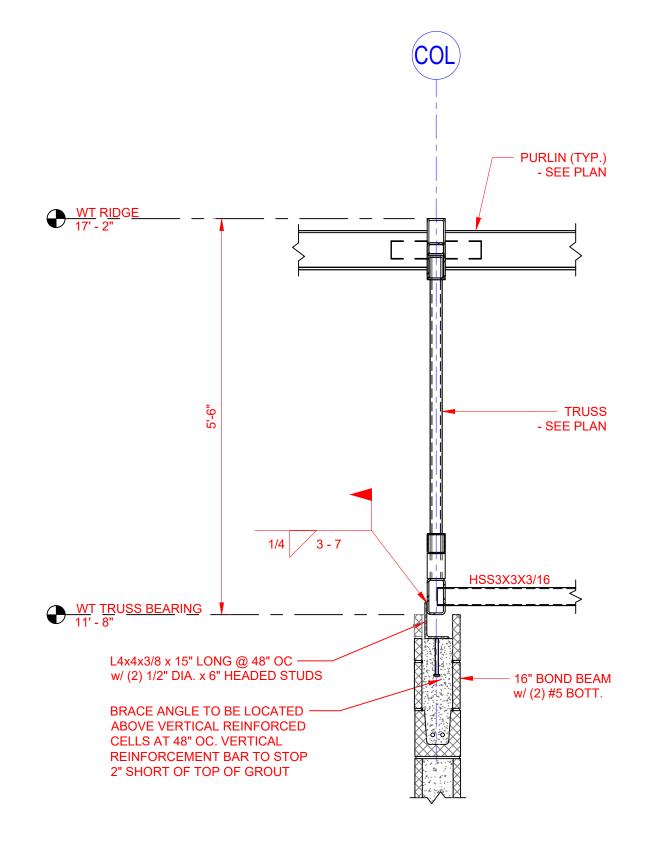

3 SECTION - ER INTERIOR TRUSS
3/4" = 1'-0"

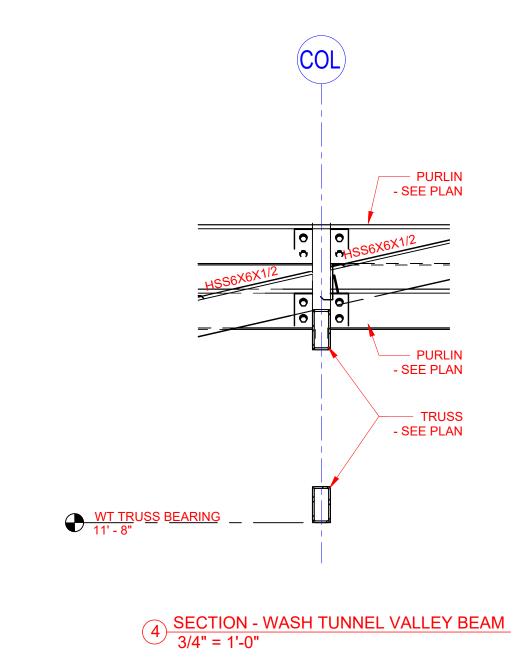

SHEET DATE: 22-0311

SHEET REVISIONS:

A DATE: DESCRIPTION:

DRAWN BY: RKN

OLSON LAND

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Tidal Wave Auto Spa 3039 W US-90 Lake City, FL 32055 Columbia County

PROJECT:

PROTOTYPE:
PROTOTYPE DATE:

SETUP DATE:
SET NAME:

SET DATE:

PROFESSIONAL OF RECORD:

03/11/2022

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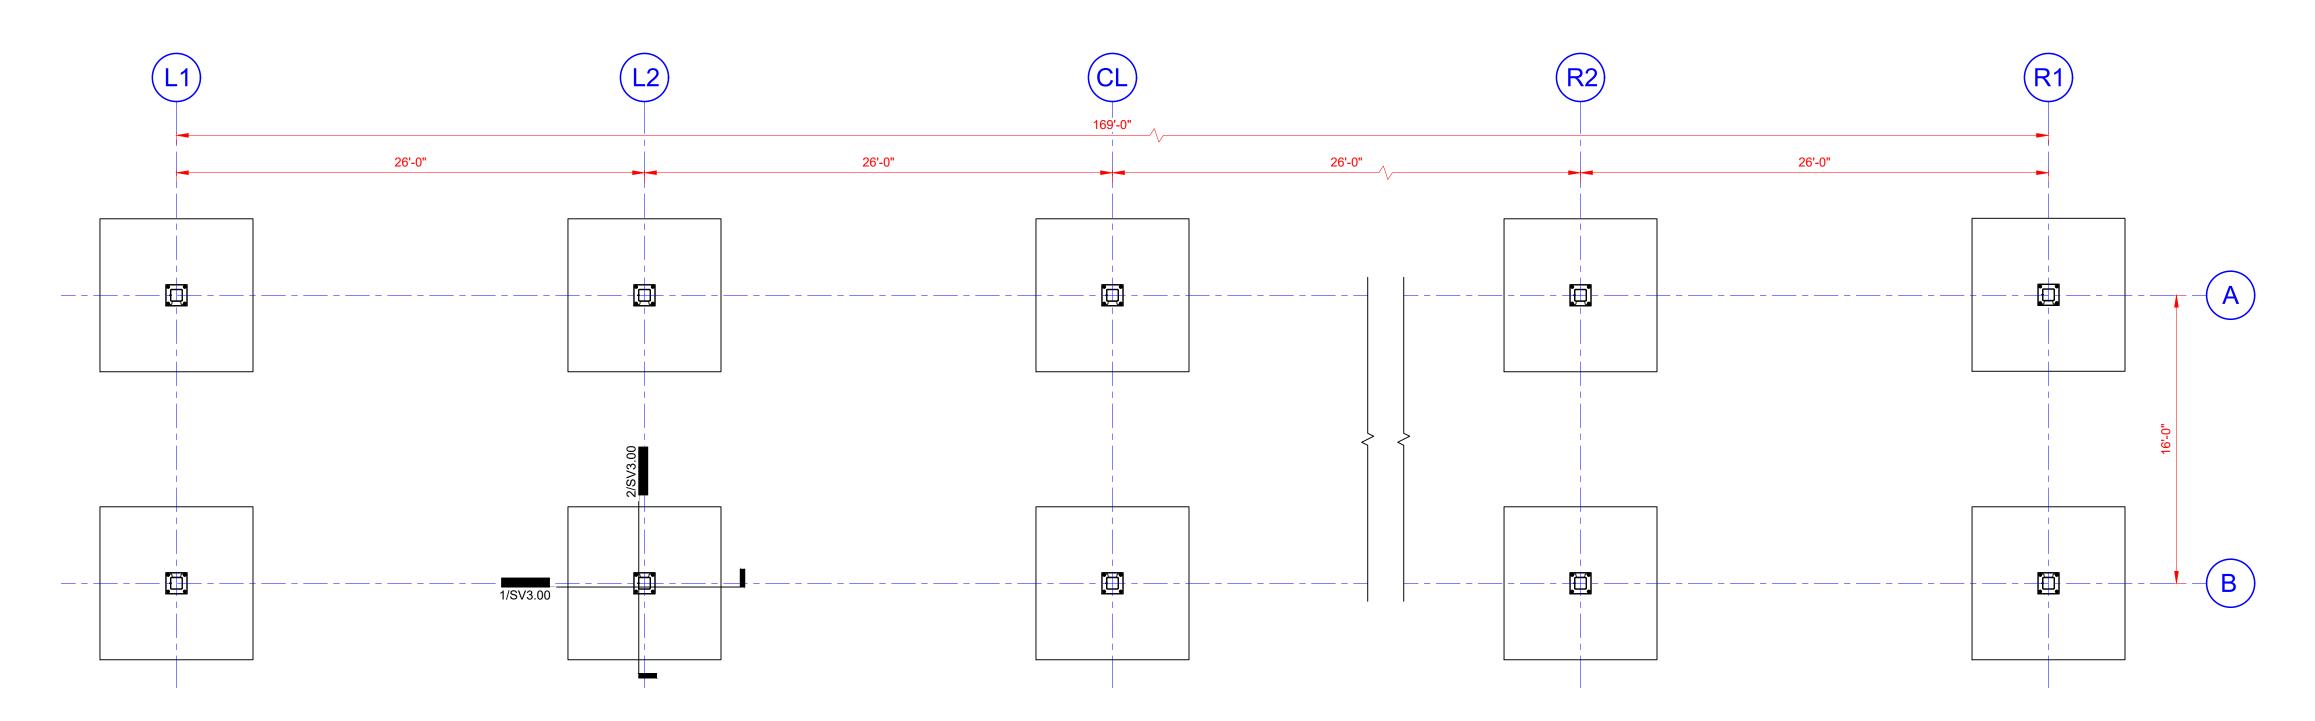
DESIGNER'S INFORMATION:

WASH TUNNEL ROOF SECTIONS & DETAILS

SHEET SCALE:

SHEET TITLE:

ST3 4



VAC CANOPY - SINGLE FOUNDATION PLAN

SCALE: 3/16" = 1'-0"

- SEE ARCHITECTURAL AND CIVIL LAYOUT DRAWINGS FOR ACTUAL NUMBER OF VAC CANOPY COLUMN LINES.
 STRUCTURAL DESIGN IS BASED ON A REFERENCE ELEVATION OF 0'-0" BEING LOCATED AT TOP OF PAVING HIGH POINT.
 TOP OF FOOTING REFERENCE ELEVATION -1'-6".
- 4. SEE CIVIL DRAWINGS FOR CONCRETE PAVING, CURB ELEVATIONS, AND DESIGN INFORMATION.



PROJECT:


Tidal Wave Auto Spa 3039 W US-90 Lake City, FL 32055 Columbia County

PROTOTYPE:

PROTOTYPE DATE:

SETUP DATE:

SET NAME:

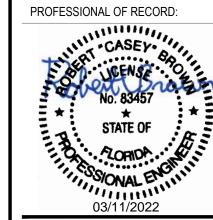

DESIGNER'S INFORMATION:



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SHEET DATE:		22-0311
SHEET REVISIONS:		
▲ DATE:	DESCRIPTION:	


DRAWN BY: SHEET TITLE:

> **VAC CANOPY -SINGLE FOUNDATION**

RKN

PLAN

SHEET SCALE:

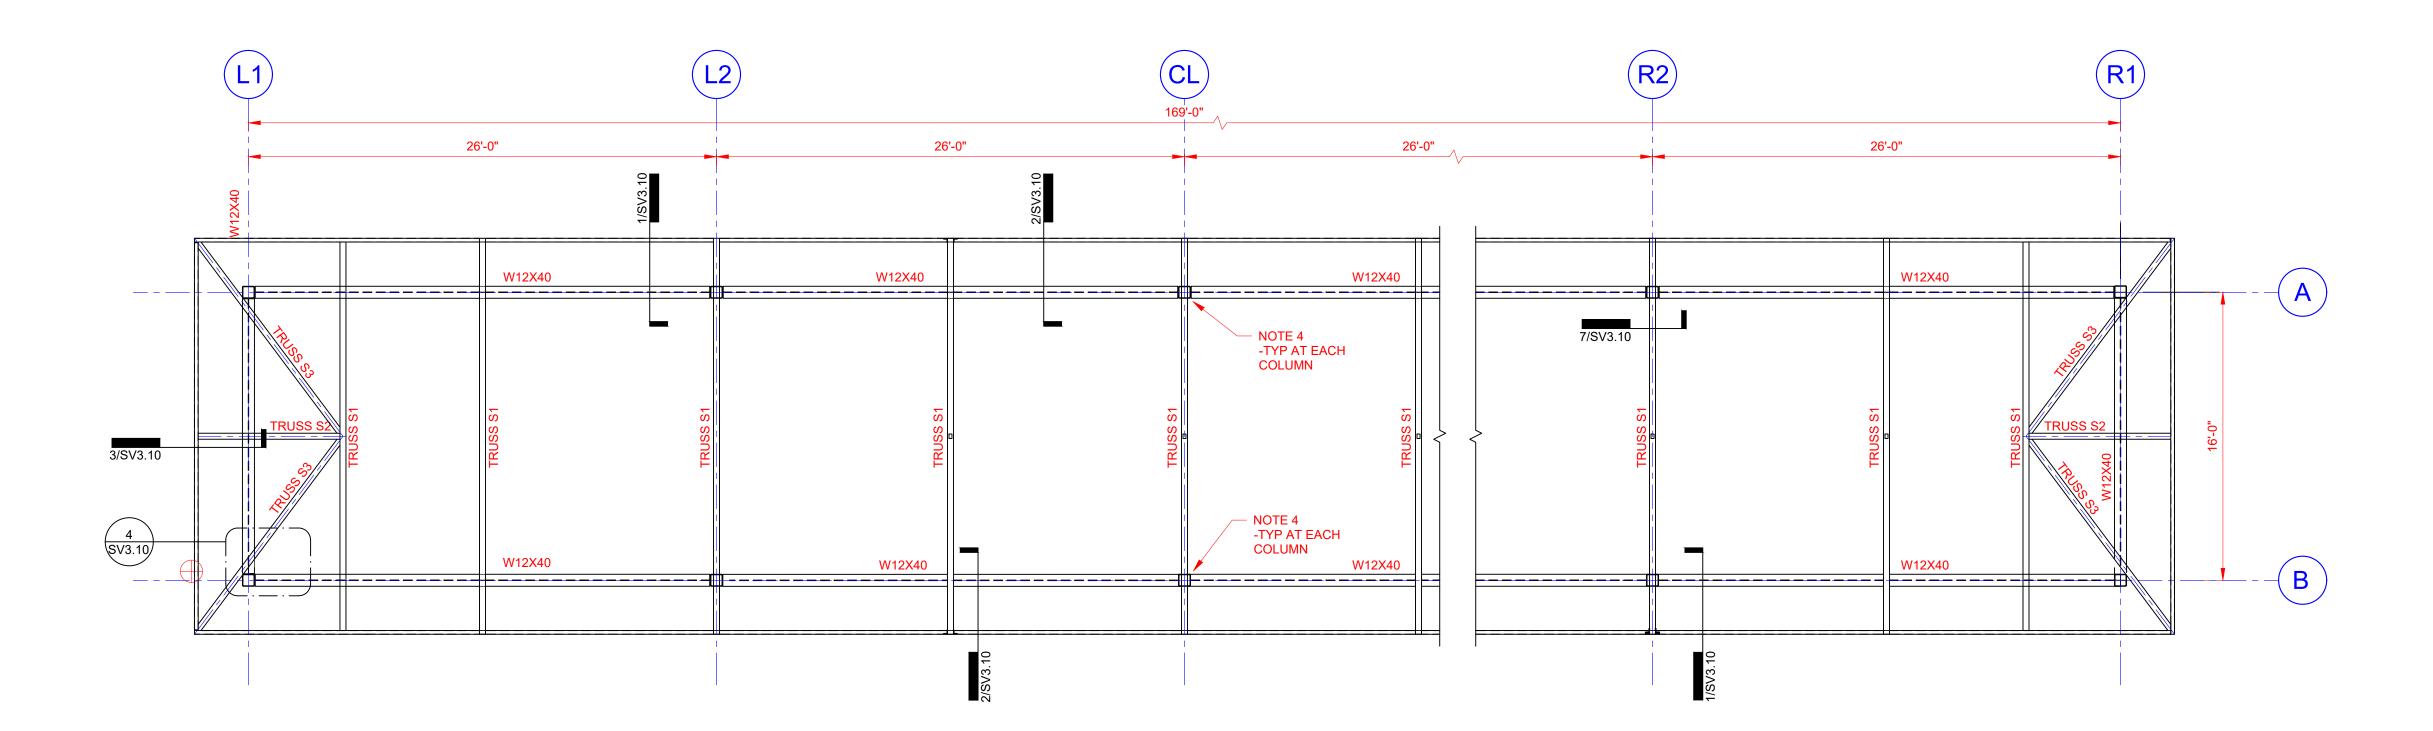

VAC CANOPY - SINGLE STEEL FRAMING PLAN

SCALE: 3/16" = 1'-0"

- 1. ELEVATIONS NOTED ARE FROM A REFERENCE ELEVATION OF 0'-0". SEE
- FOUNDATION PLAN NOTES FOR TOP OF FOUNDATION ELEVATION COORDINATION.

 2. SEE CIVIL DRAWINGS FOR CONCRETE PAVING AND CURB ELEVATIONS.

 3. TOP OF STEEL IS EITHER LEVEL OR SLOPING EVENLY BETWEEN NOTED

- 4. SEE SHEET SV3.10 FOR VAC CANISTER MOUNTING PLATE DETAIL. 5. COLUMNS ARE HSS8x8x5/16, UNLESS NOTED OTHERWISE.

4300 Legendary Drive, Suite 234 Destin, Florida 32541 T: 850.650.4353 F: 850.650.3881

PROJECT:


Tidal Wave Auto Spa 3039 W US-90 Lake City, FL 32055 Columbia County

PROTOTYPE:

PROTOTYPE DATE:

SETUP DATE:

SET NAME:

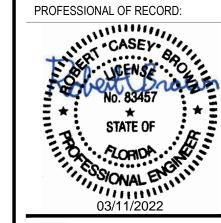

DESIGNER'S INFORMATION:




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SHEET DATE	SHEET DATE:	
SHEET REVI	SIONS:	
▲ DATE:	DESCRIPTION:	
DRAWN BY:		RKN

SHEET TITLE:

VAC CANOPY -SINGLE STEEL FRAMING PLAN

SHEET SCALE:

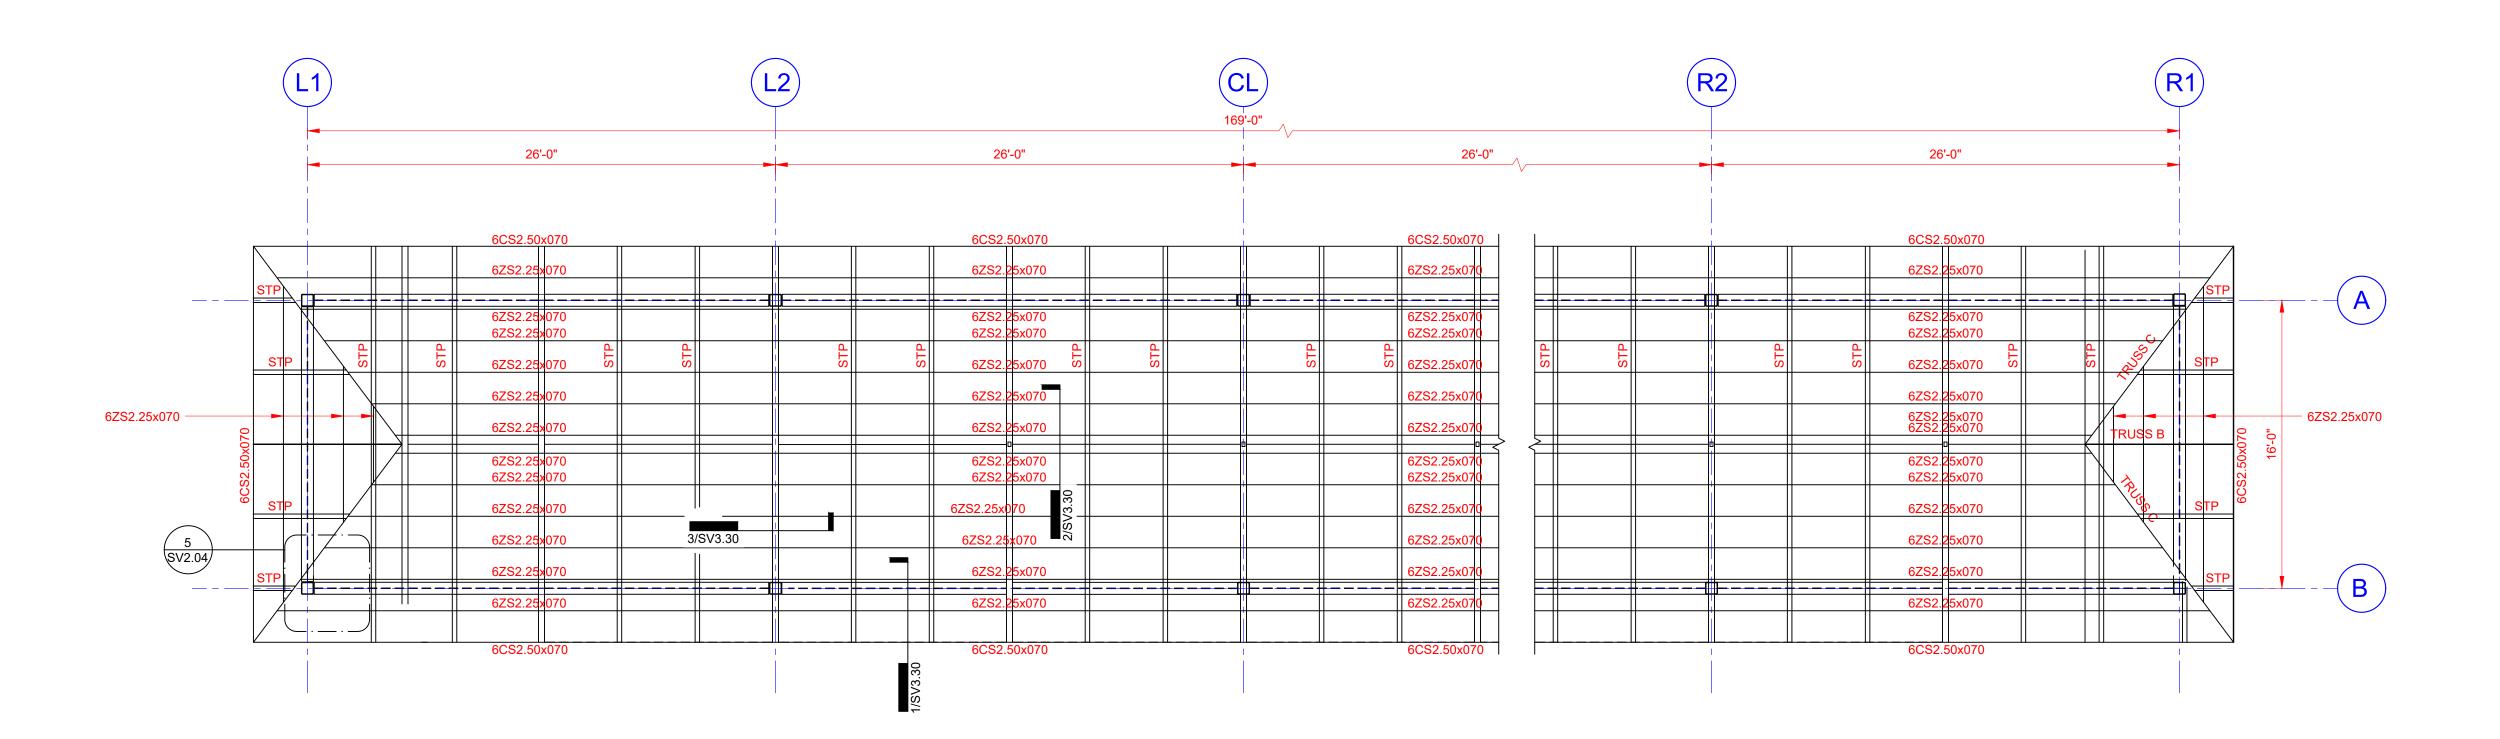

VAC CANOPY - SINGLE COLD FORMED PURLIN PLAN

SCALE: 3/16" = 1'-0"

1. SEE SECTIONS AND DETAILS FOR CONNECTION.



PROJECT:

TIDAL

A U T O S P

Tidal Wave Auto Spa 3039 W US-90 Lake City, FL 32055 Columbia County


PROTOTYPE:

PROTOTYPE DATE:

SET NAME:

OLI IV.

SET DATE:

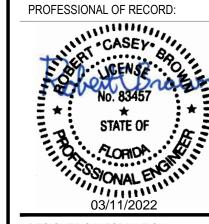

DESIGNER'S INFORMATION:



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Mobile, AL 36606

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SHEET DATE	SHEET DATE:	
SHEET REVI	SIONS:	
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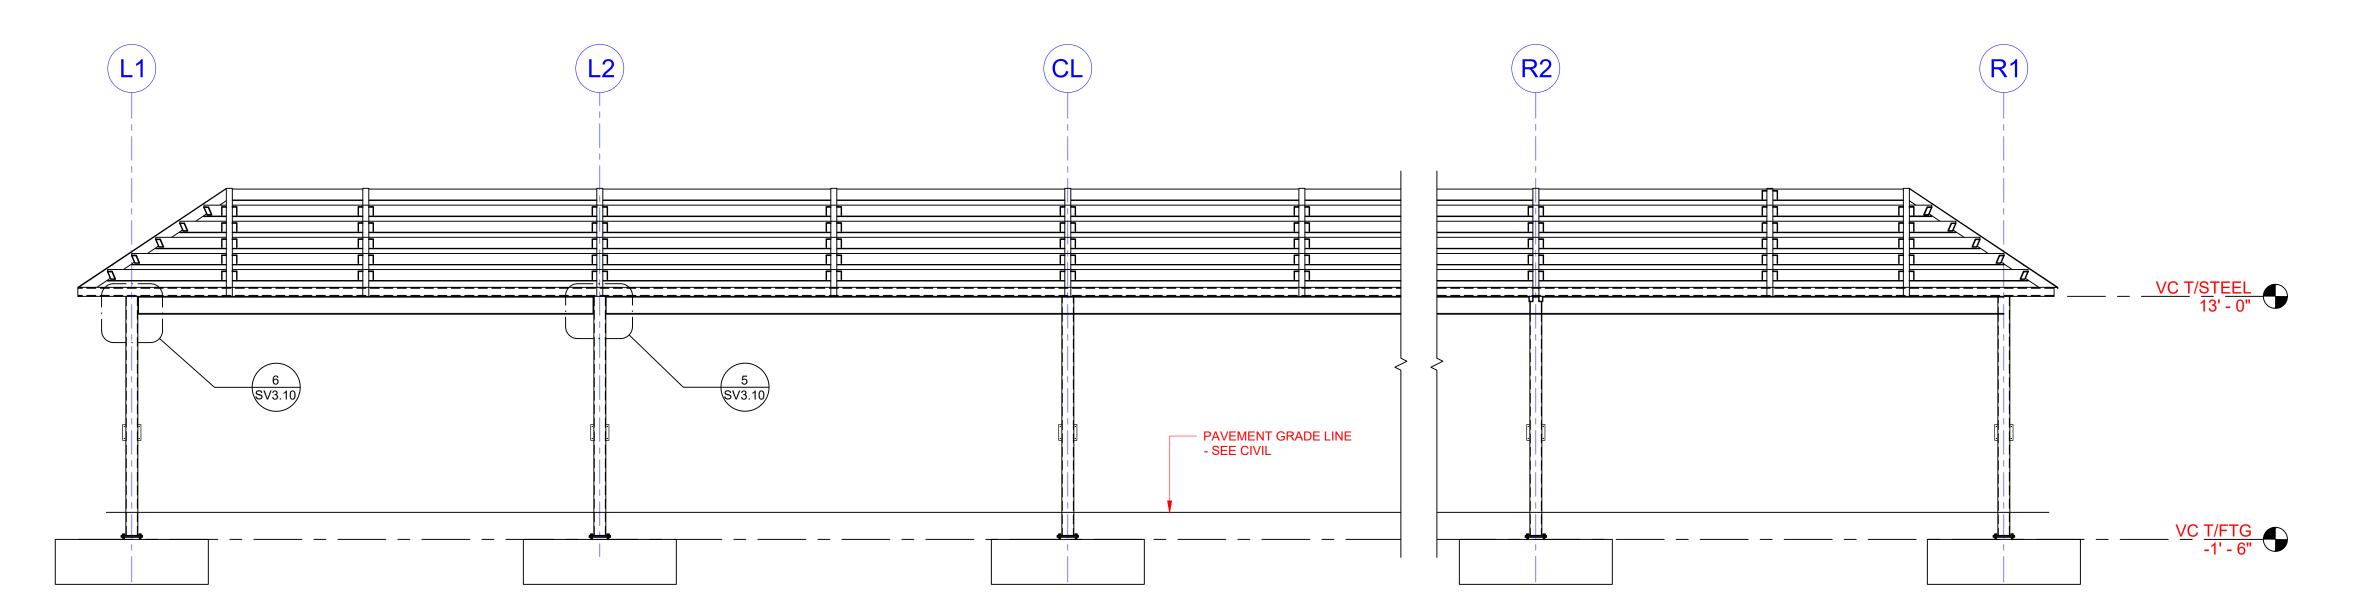
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VAC CANOPY -SINGLE COLD FORM PURLIN


PLAN

SHEET SCALE:
SHEET NUMBER:

SV1.02



1 VAC CANOPY SINGLE LONG ELEV 3/16" = 1'-0"

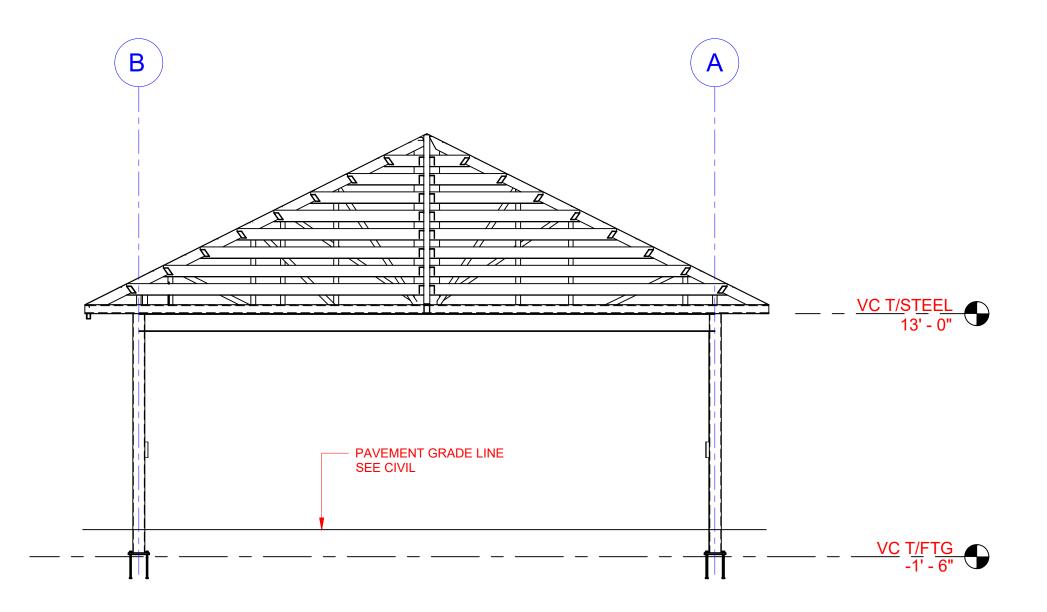

2 VAC CANOPY SINGLE SHORT ELEV 3/16" = 1'-0"




PROJECT:

Tidal Wave Auto Spa 3039 W US-90 Lake City, FL 32055 Columbia County

PROTOTYPE: PROTOTYPE DATE:

SET NAME:

SET DATE:

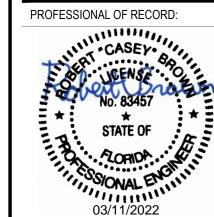

DESIGNER'S INFORMATION:




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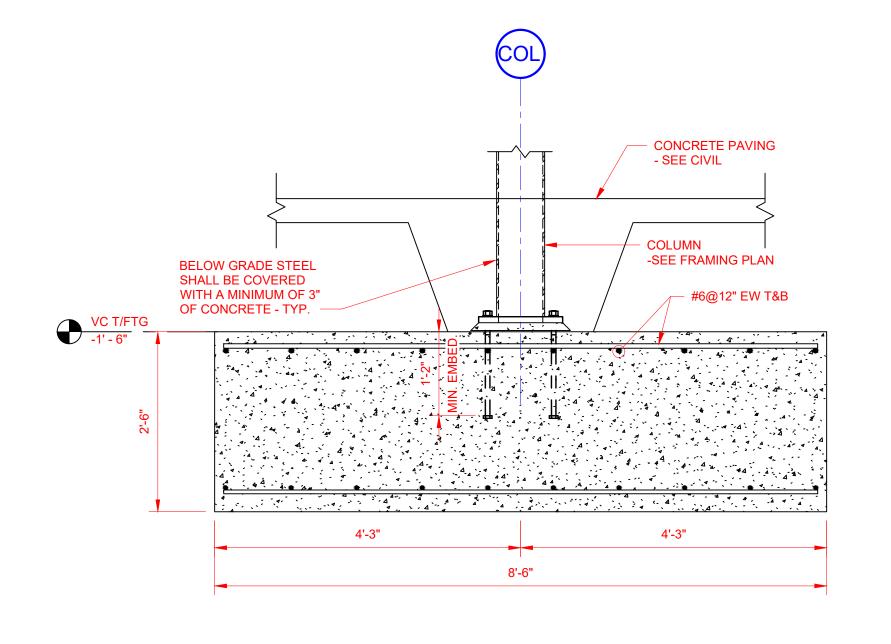
SHEET DATE:		22-0311
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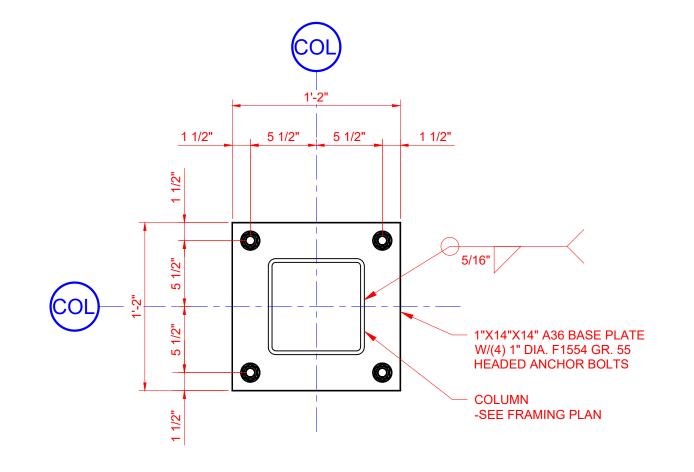
SHEET TITLE:

VAC CANOPY -SINGLE STEEL FRAMING ELEVATION


SHEET SCALE:





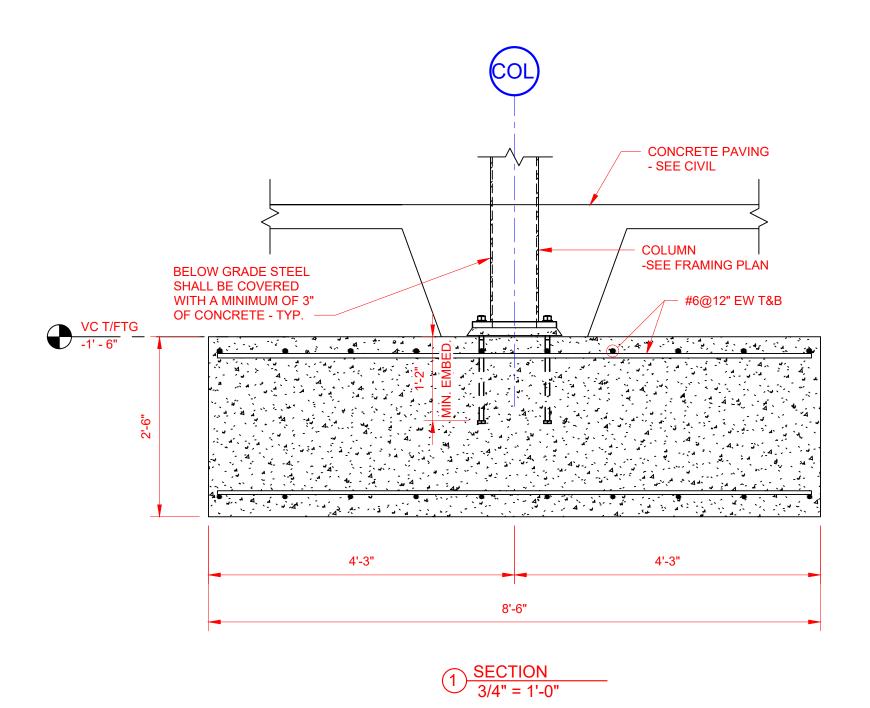



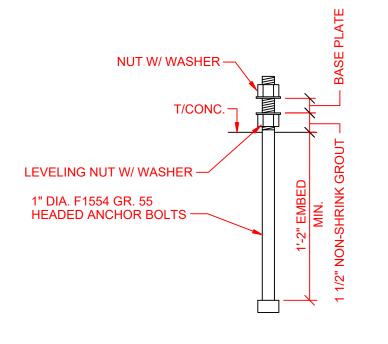

1" DIA. ANCHOR BOLT DETAIL 1 1/2" = 1'-0"



PROJECT:


Tidal Wave Auto Spa 3039 W US-90 Lake City, FL 32055 Columbia County

PROTOTYPE:

PROTOTYPE DATE: SETUP DATE:

SET NAME:

SET DATE:

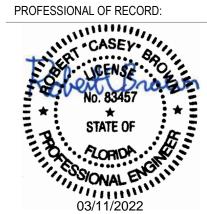

DESIGNER'S INFORMATION:



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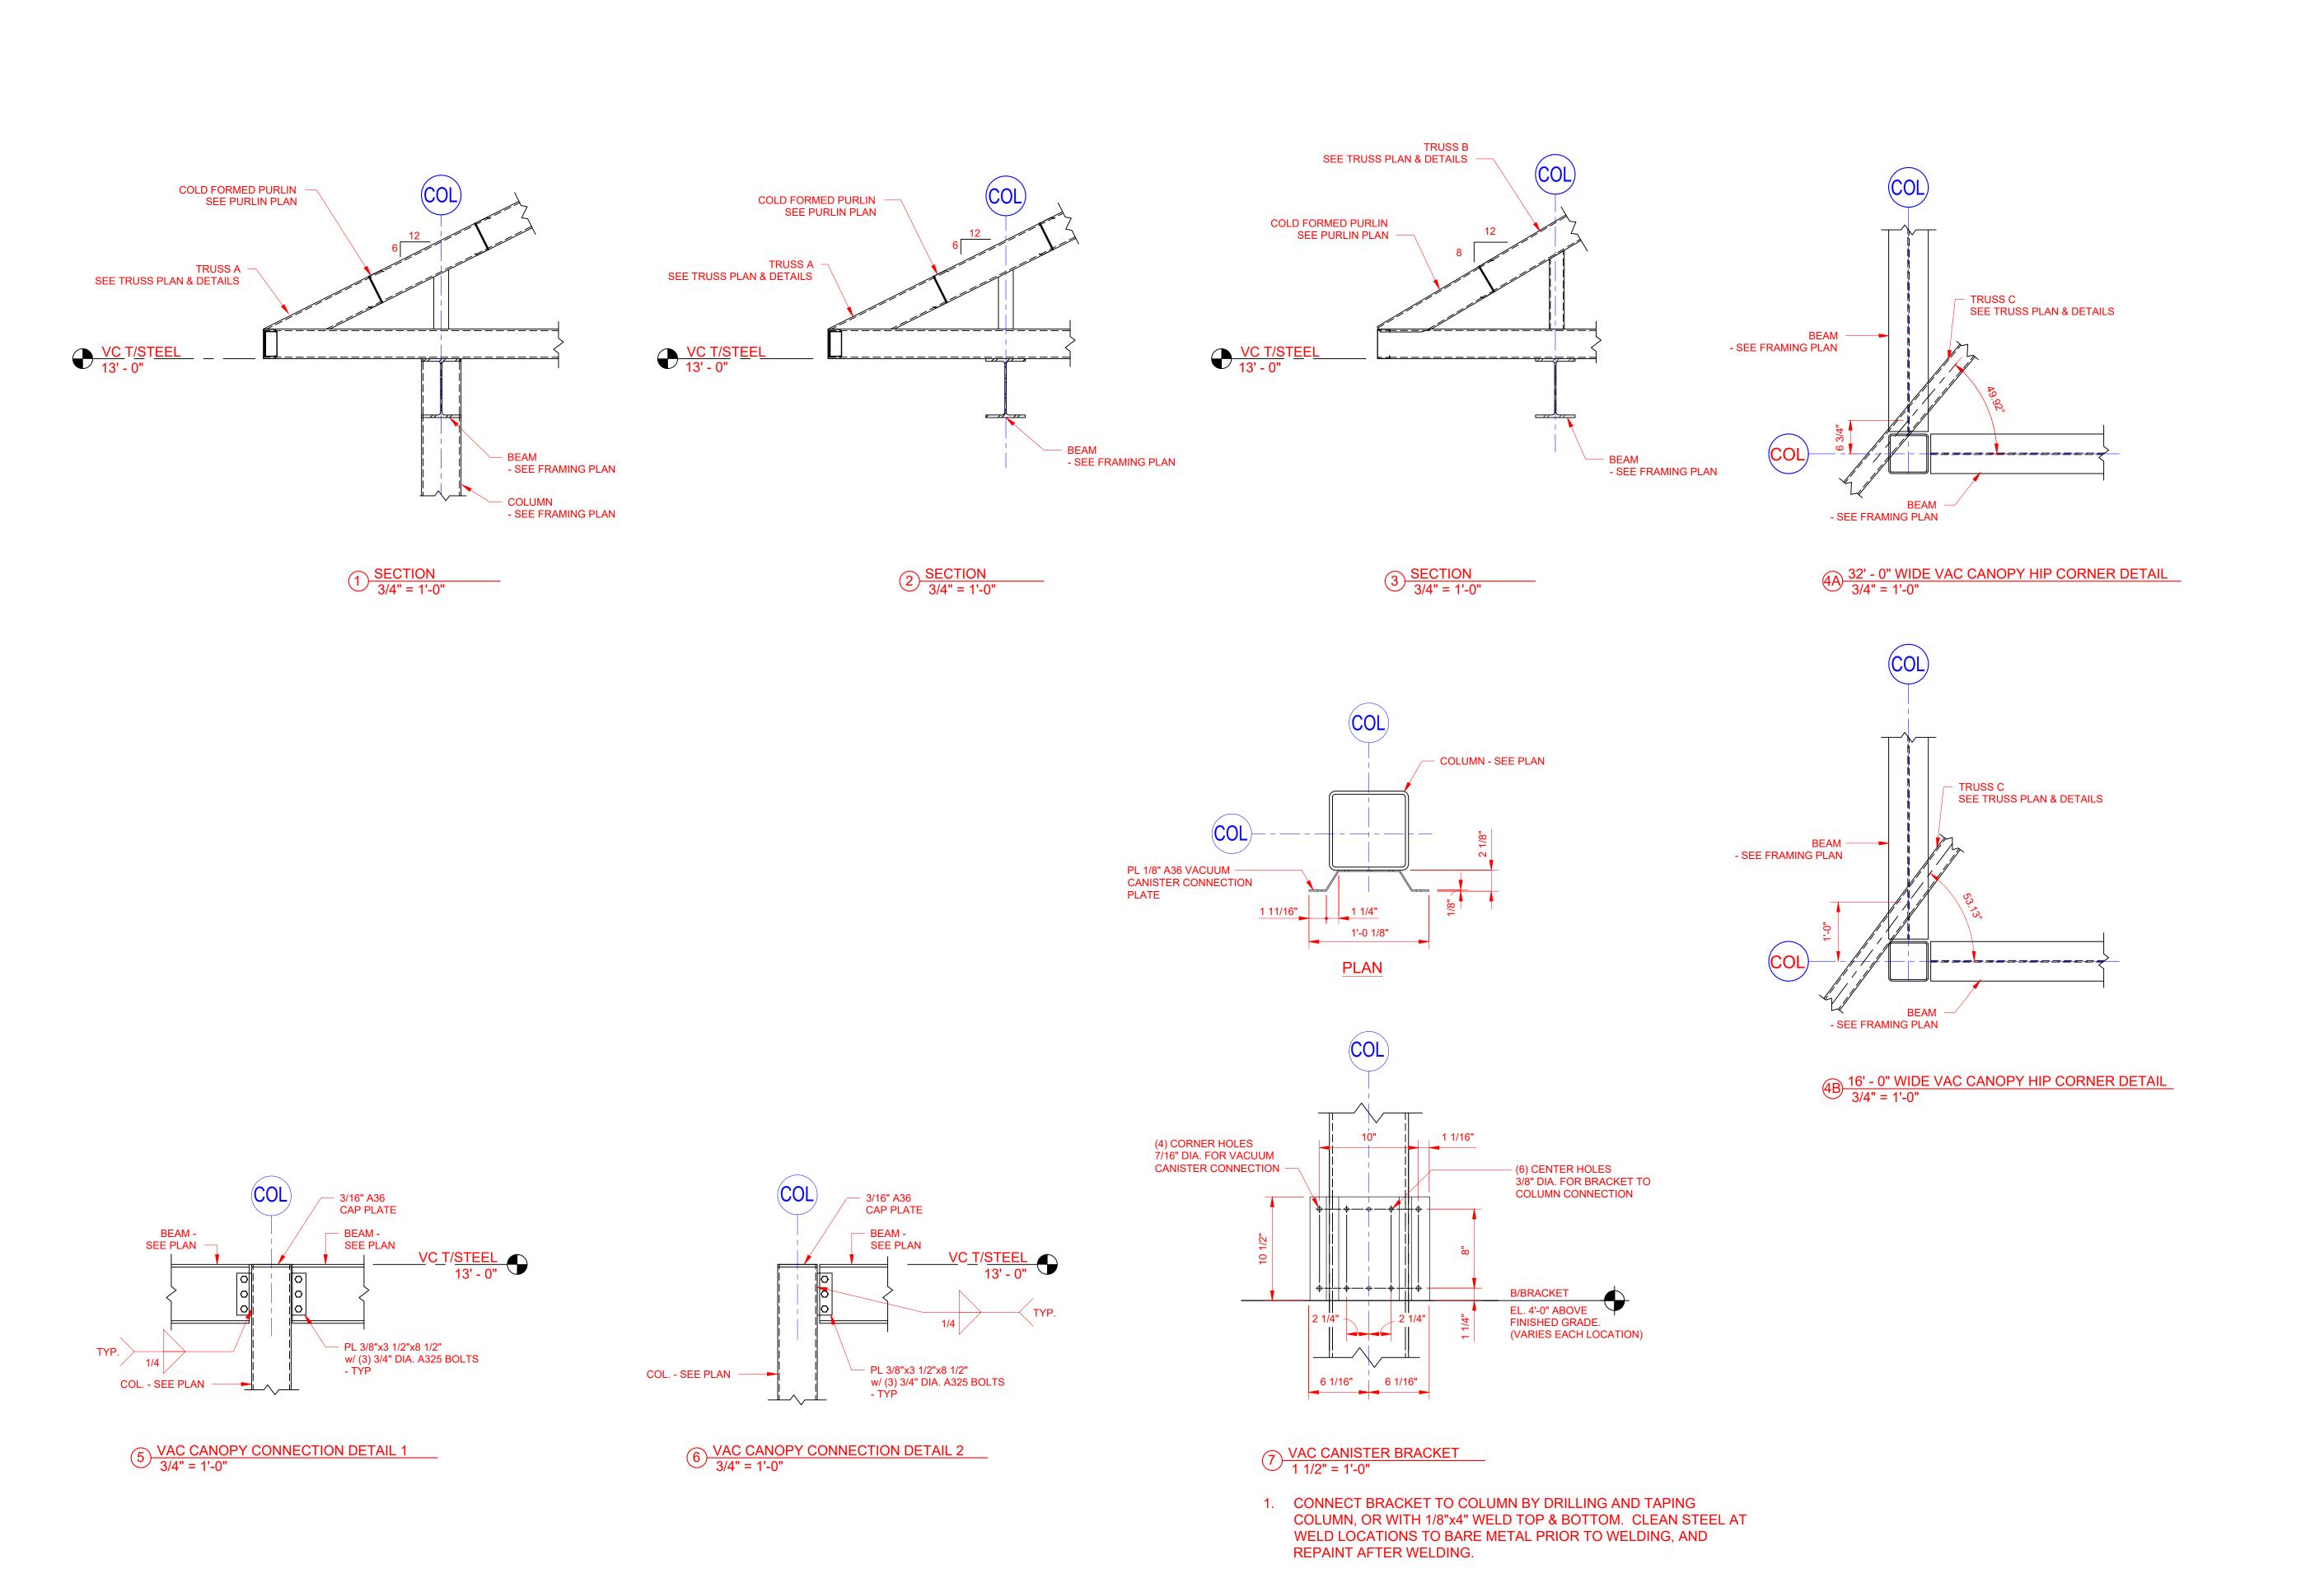
SHEET DATE:		22-0311
SHEET REVI	SIONS:	
▲ DATE:	DESCRIPTION:	
DRAWN BY:		RKN

VAC CANOPY -FOUNDATION

SHEET TITLE:

SHEET NUMBER: SV3.00

SECTIONS & DETAILS SHEET SCALE:



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PROJECT:


Tidal Wave Auto Spa 3039 W US-90 Lake City, FL 32055 Columbia County

PROTOTYPE:

PROTOTYPE DATE:

SET NAME:

SET DATE:

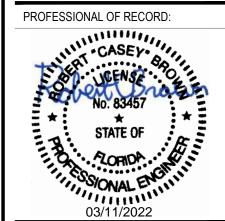

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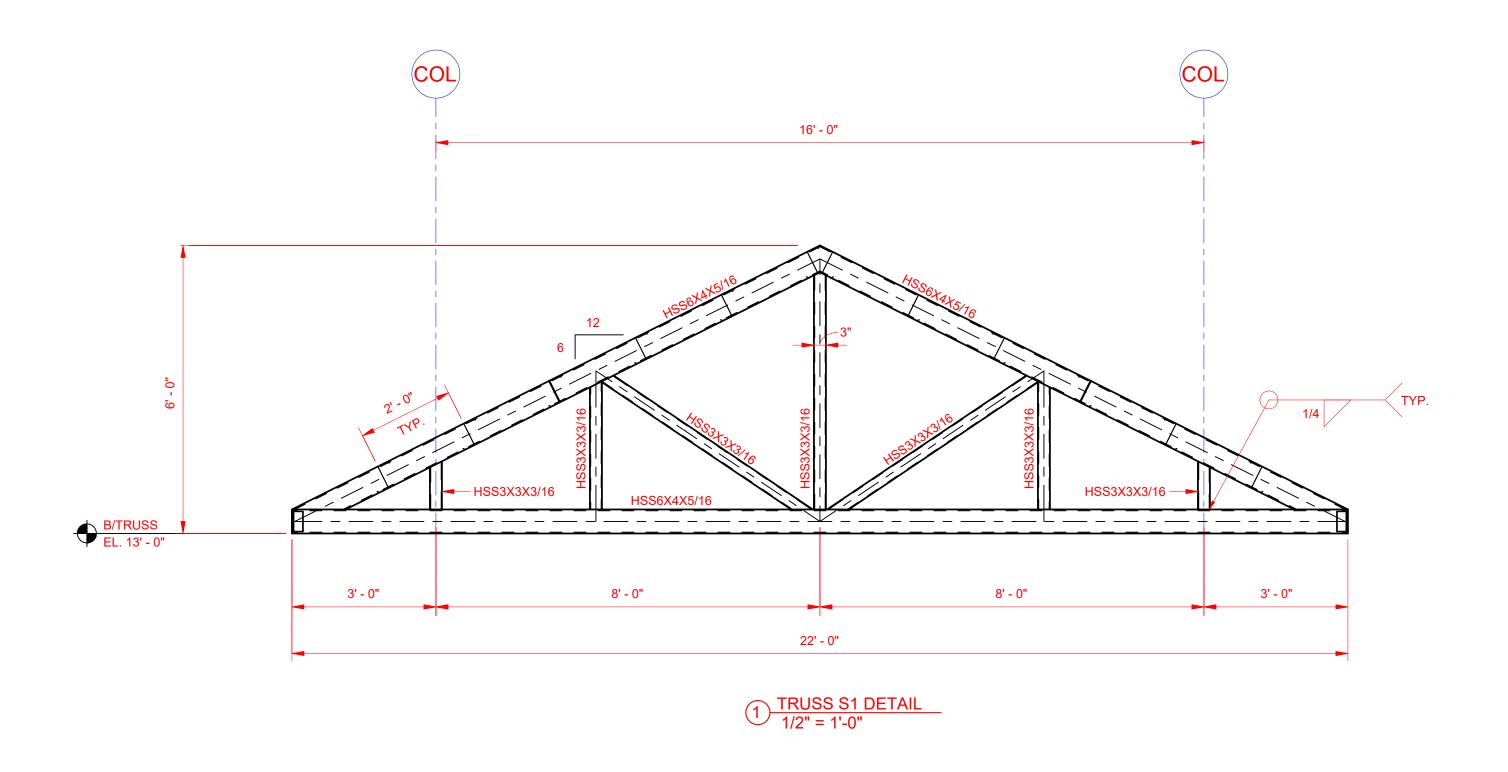
SHEET DATE: 22-0311 SHEET REVISIONS: ▲ DATE: DESCRIPTION:


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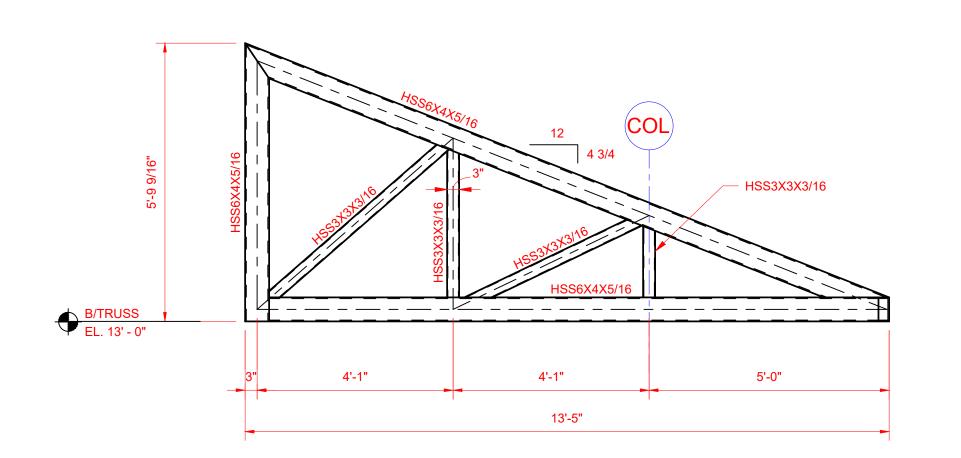
> **VAC CANOPY -ROOF SECTIONS & DETAILS**

RKN

SHEET SCALE:





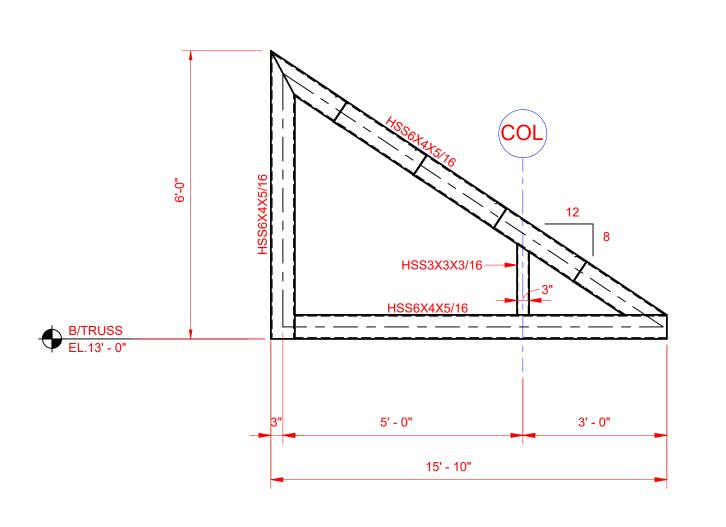

2 TRUSS S2 DETAIL
1/2" = 1'-0"

3 TRUSS S3 DETAIL 1/2" = 1'-0"

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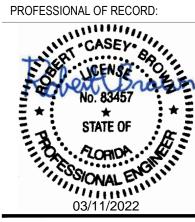
PROJECT:

Tidal Wave Auto Spa 3039 W US-90 Lake City, FL 32055 Columbia County

PROTOTYPE:

PROTOTYPE DATE:

SET NAME:



DESIGNER'S INFORMATION:



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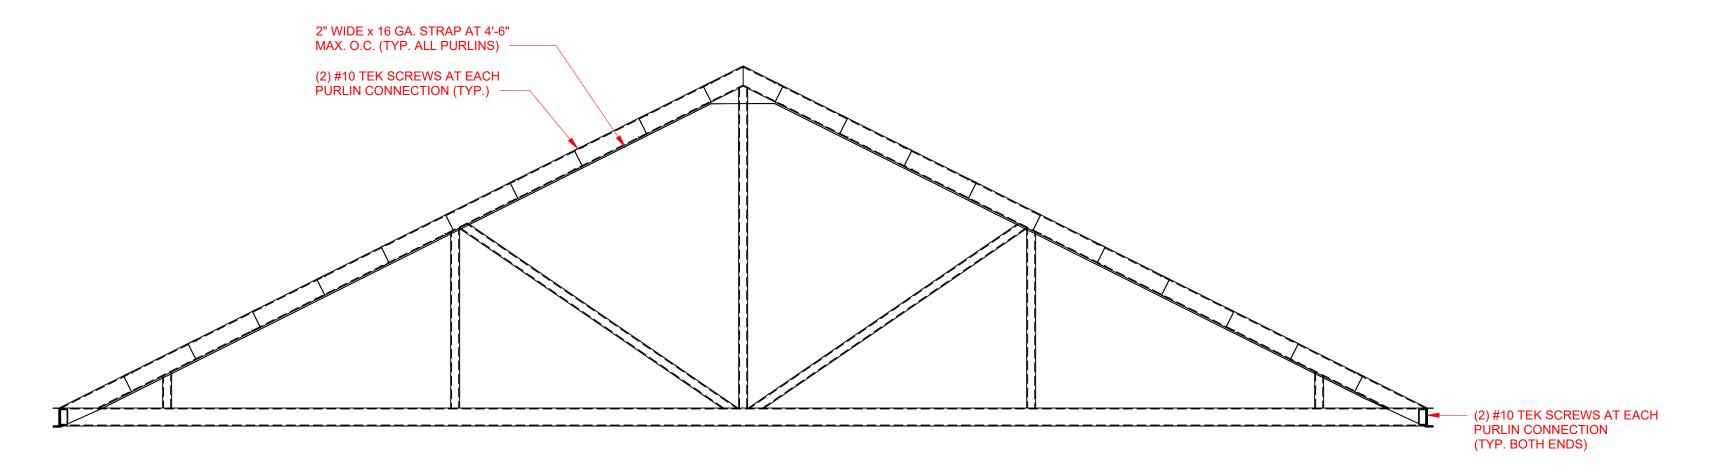
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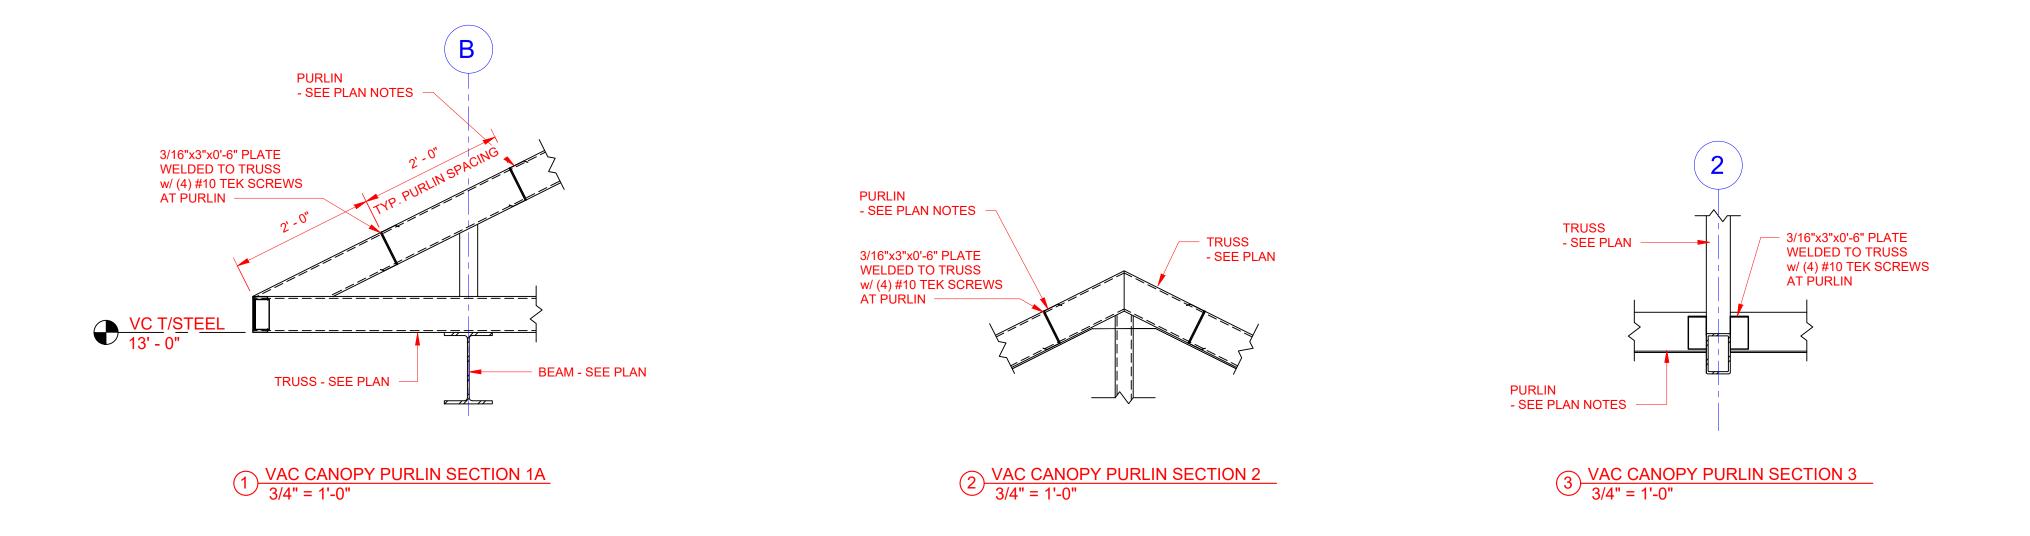
> **VAC CANOPY -**SINGLE TRUSS **ELEVATIONS**

RKN

SHEET SCALE: SHEET NUMBER:



PURLIN STRAP DETAIL SCALE: 3/8" = 1'-0"



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PROJECT:


Tidal Wave Auto Spa 3039 W US-90 Lake City, FL 32055 Columbia County

PROTOTYPE: PROTOTYPE DATE:

SETUP DATE:

SET NAME:

SET DATE:

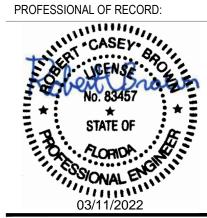

DESIGNER'S INFORMATION:



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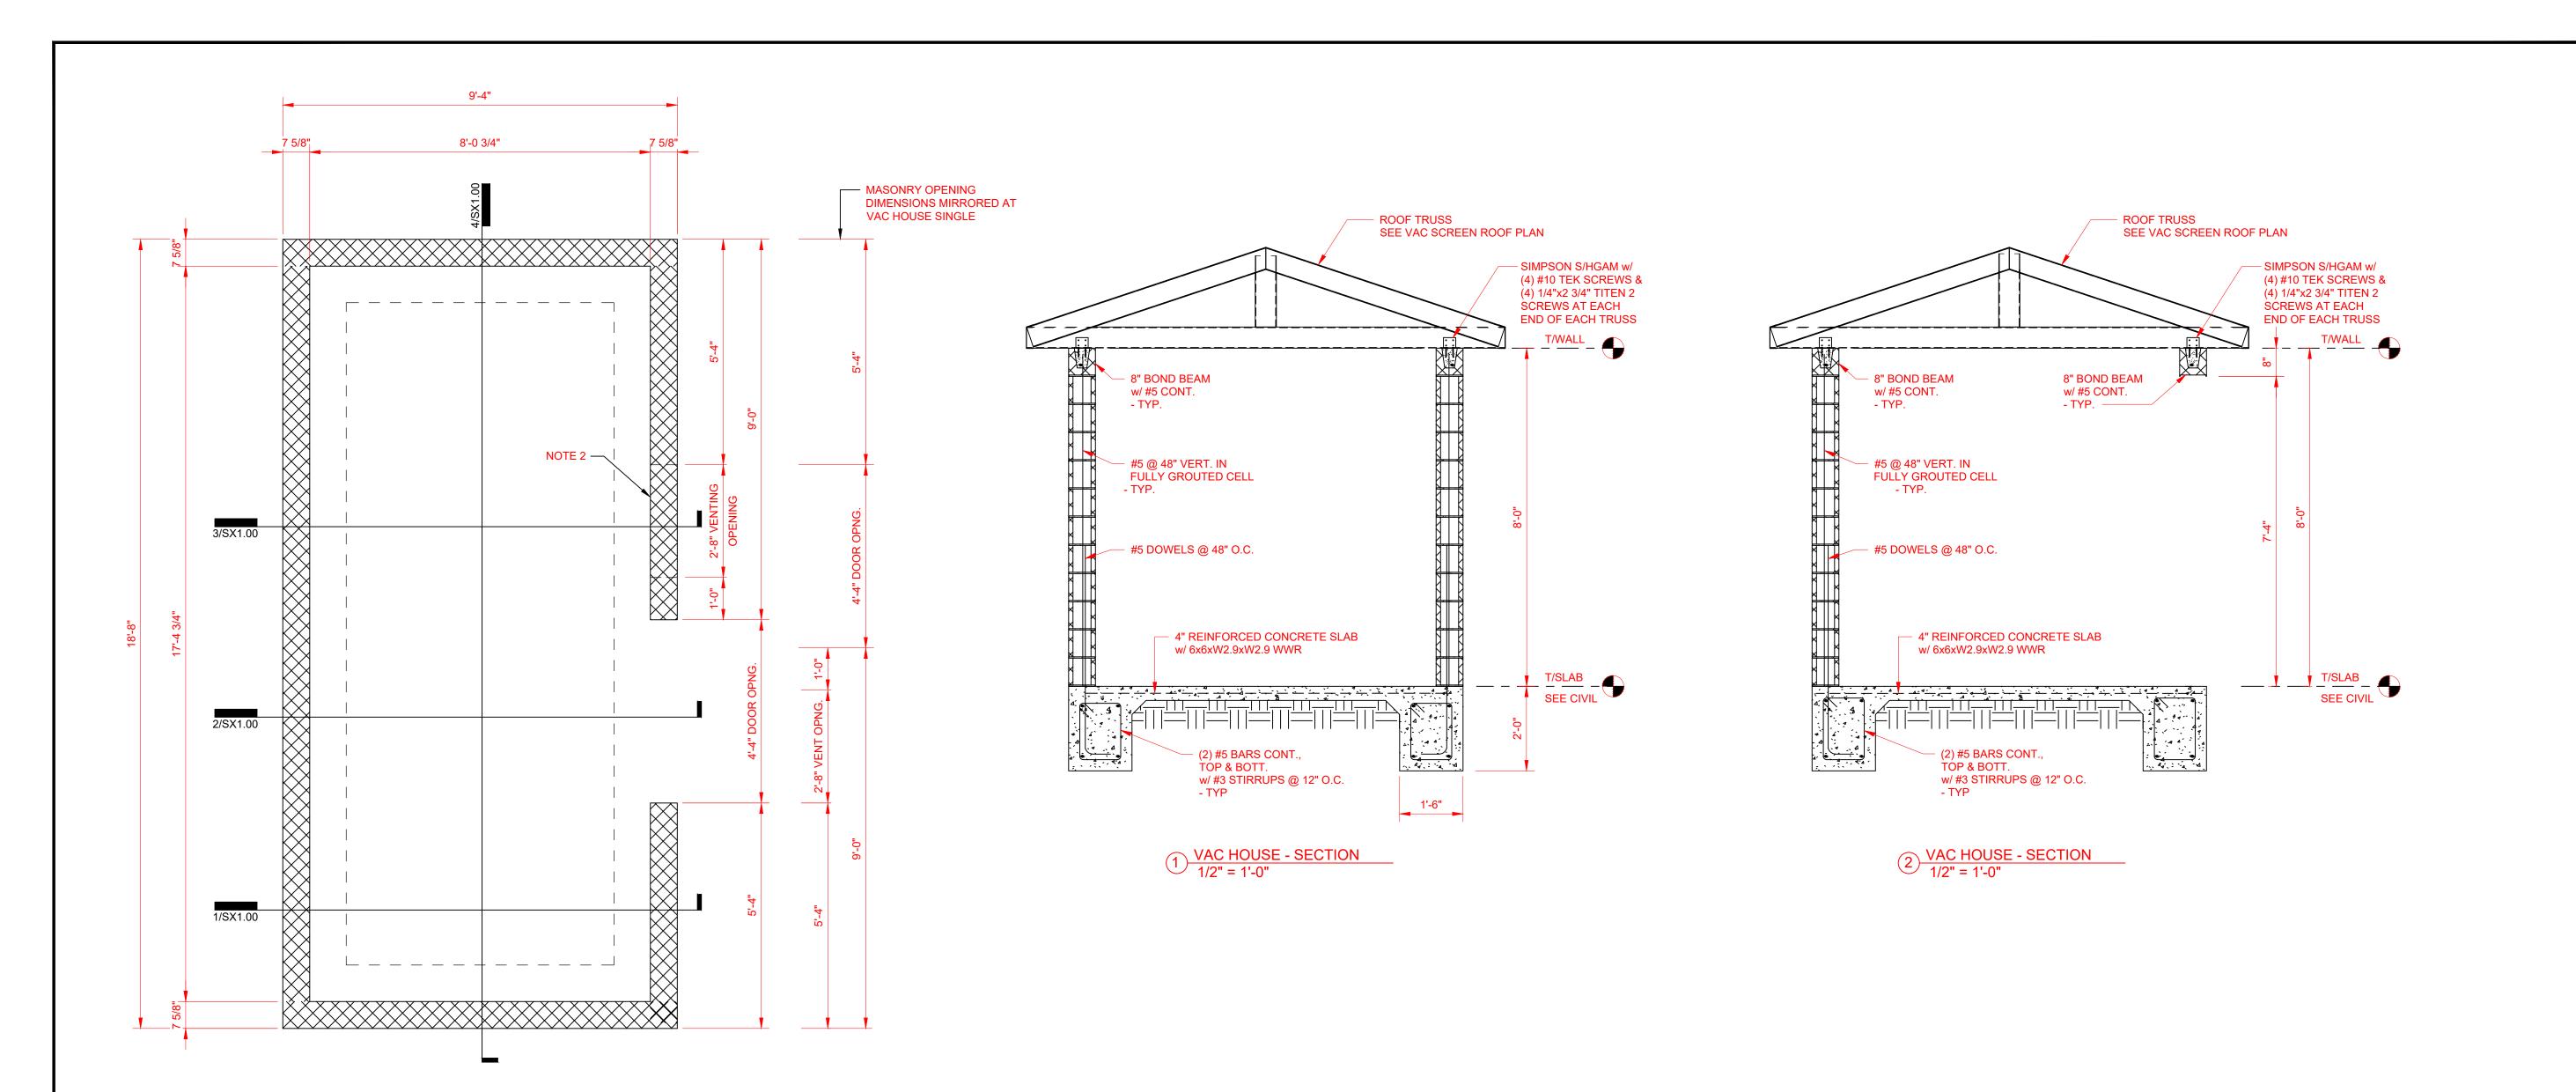
PE using a Digital Signature and date. Printed copies of this document are not considered signed and sealed and the signature must be verified on any electronic copies.

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SHEET REVI	SIONS:	
▲ DATE:	DESCRIPTION:	

DRAWN BY: SHEET TITLE:

> **VAC CANOPY -PURLIN DETAILS**

SHEET SCALE:




VAC HOUSE FOUNDATION PLAN

SCALE: 1/2" = 1'-0"

NOTE:

 SEE CIVIL FOR LOCATION, LAYOUT, AND ORIENTATION.
 COORDINATE EXISTANCE OF VENDING MACHINE OPENING W/ ARCHITECTURAL DRAWINGS. IF NO VENDING MACHINE

EXISTS, INSTALL TYPICAL MASONRY WALL SECTION.

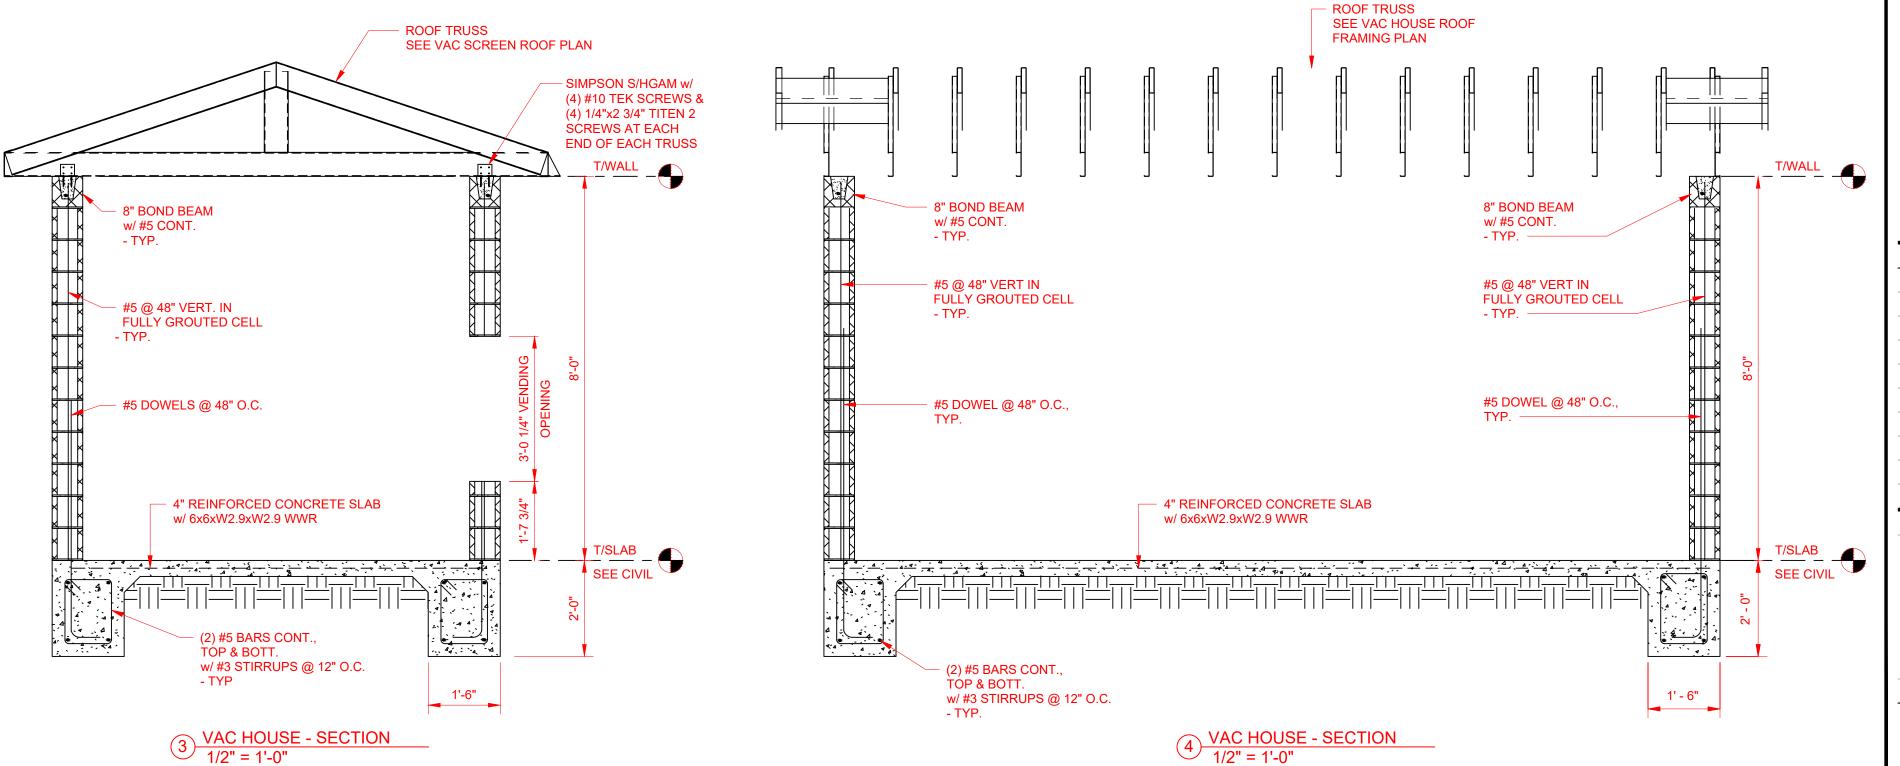

OLSON LAND
PARTNERS, LLC
Real Estate Acquisitions & Development
4300 Legendary Drive, Suite 234
Destin, Florida 32541

PROJECT:

TIDAL

NA VIE


T: 850.650.4353 F: 850.650.3881

Tidal Wave Auto Spa 3039 W US-90 Lake City, FL 32055 Columbia County

PROTOTYPE:
PROTOTYPE DATE:
SETUP DATE:

SET NAME:

SET DATE:

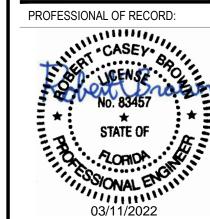

DESIGNER'S INFORMATION:



2970 Cottage Hill Road

Mobile, AL 36606

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Thompson Engineering, Inc.

SHEET DATE: 22-0311

SHEET REVISIONS:

A DATE: DESCRIPTION:

DRAWN BY: SHEET TITLE:


VAC HOUSE -FOUNDATION & WALL PLAN & SECTIONS

RKN

SHEET SCALE:

SHEET NUMBER:

AME: 7 SX MISC SHEETS.DWG PLOTTED ON: 22

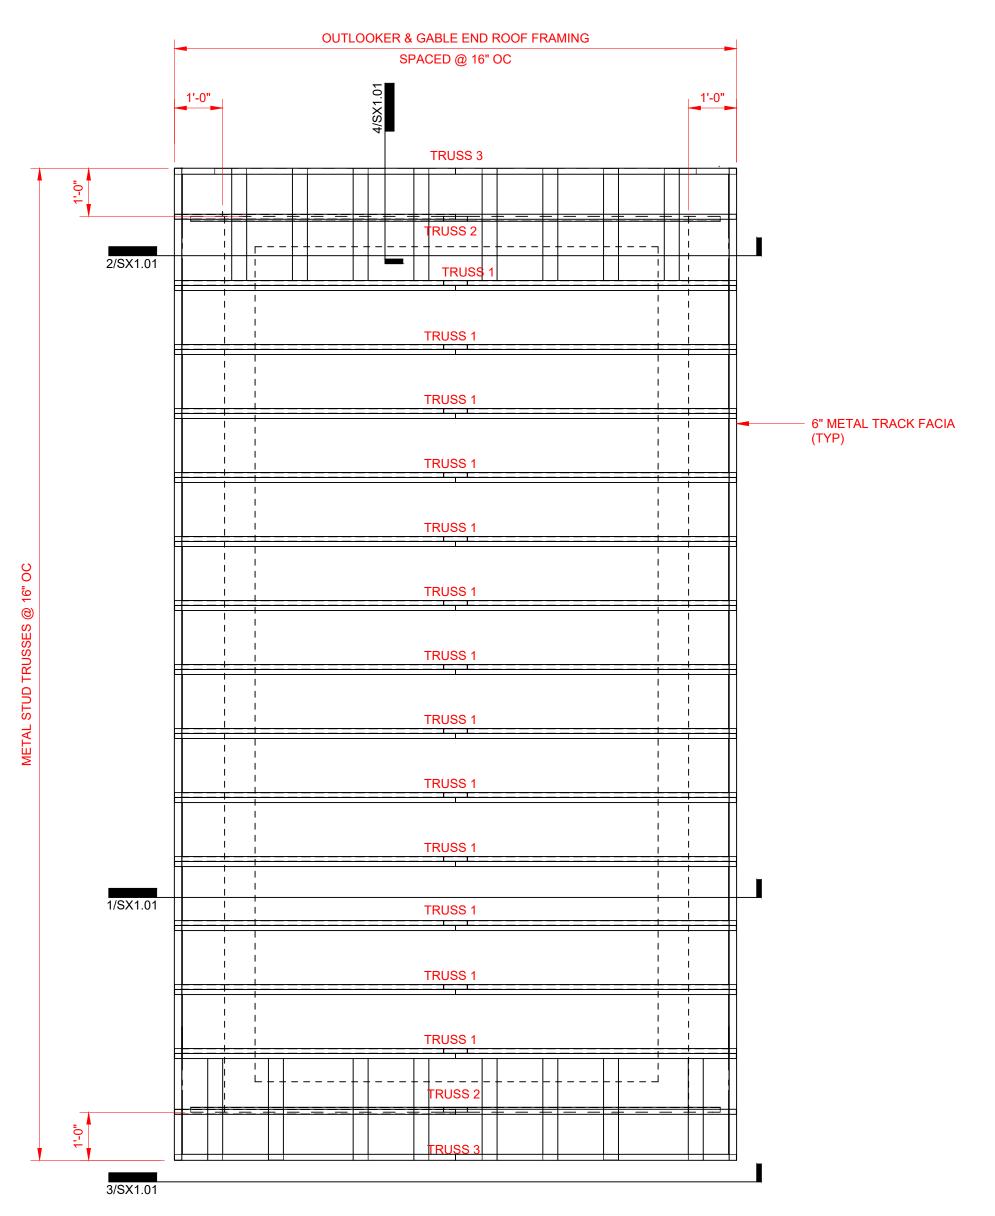



VAC HOUSE ROOF PLAN

1. SEE CIVIL FOR LOCATION, LAYOUT, AND ORIENTATION.

SCALE: 1/2" = 1'-0"

NOTE:

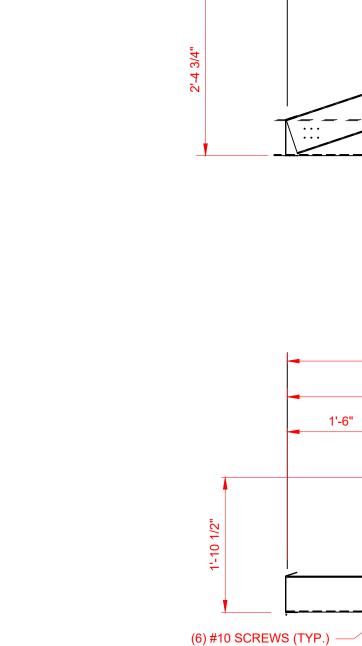

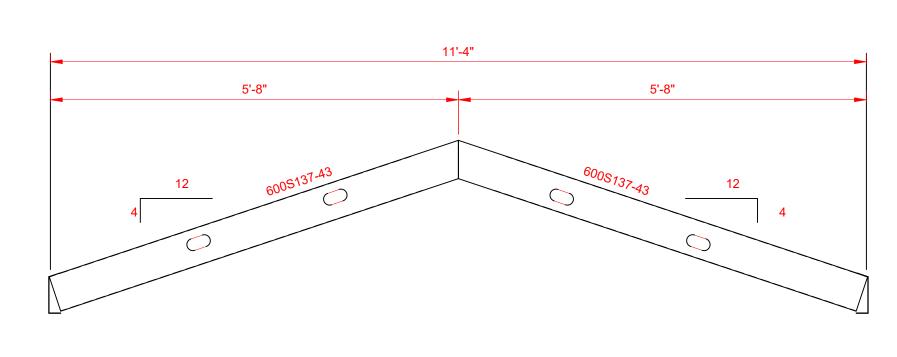

11'-4"

1 VAC HOUSE TRUSS 1 3/4" = 1'-0"

2 VAC HOUSE TRUSS 2 3/4" = 1'-0"

11'-4"

5'-8"

SIMPSON HTP PLATEw/ (6) #10 SCREWS T&B (12 TOTAL)

5'-8"

SIMPSON HTP PLATE
w/ (6) #10 SCREWS T&B (12 TOTAL)

1'-6"

4'-2"

5'-8"


5'-8"

1'-6"

600S137-43

4'-2"

3 VAC HOUSE TRUSS 3
3/4" = 1'-0"

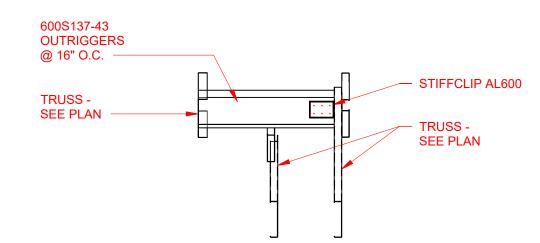

4 VAC HOUSE GABLE END SECTION
3/4" = 1'-0"



— (6) #10 SCREWS (TYP.)

Tidal Wave Auto Spa 3039 W US-90 Lake City, FL 32055 Columbia County

4300 Legendary Drive, Suite 234 Destin, Florida 32541 T: 850.650.4353 F: 850.650.3881

PROTOTYPE: PROTOTYPE DATE:

SETUP DATE: SET NAME:

PROJECT:

SET DATE:

PROFESSIONAL OF RECORD: 03/11/2022

DESIGNER'S INFORMATION:



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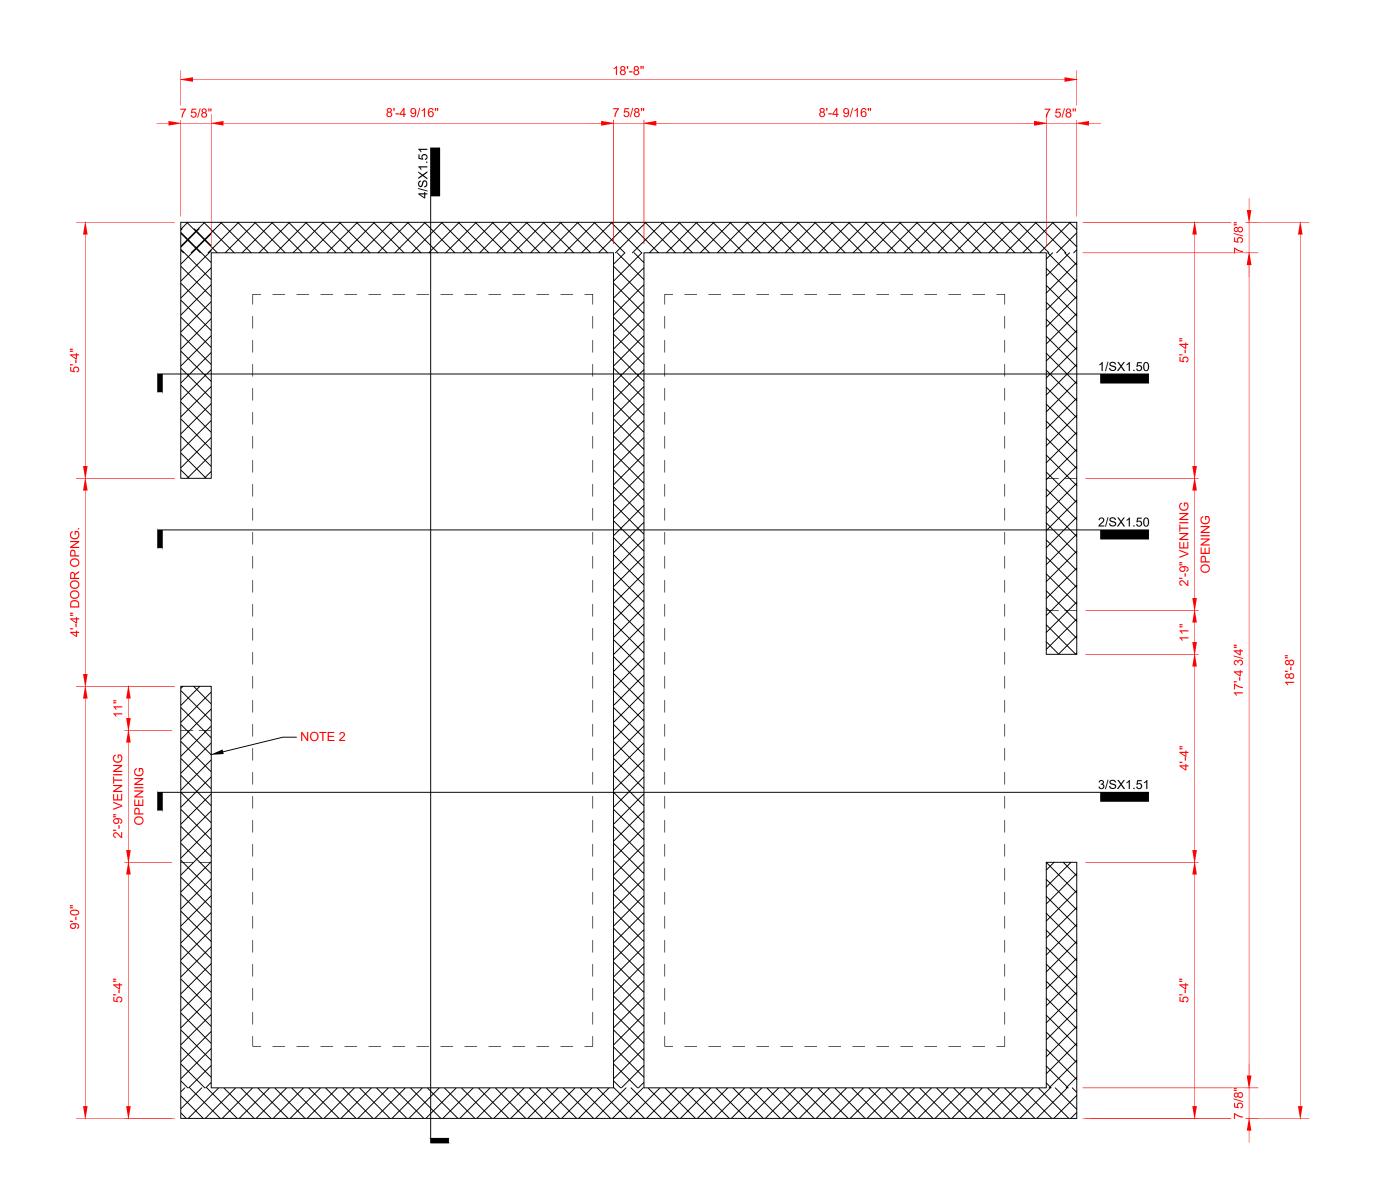
SHEET DATE: 22-0311 SHEET REVISIONS: ▲ DATE: DESCRIPTION:


DRAWN BY: SHEET TITLE:

> **VAC HOUSE -ROOF PLAN & SECTIONS**


RKN

SHEET SCALE:



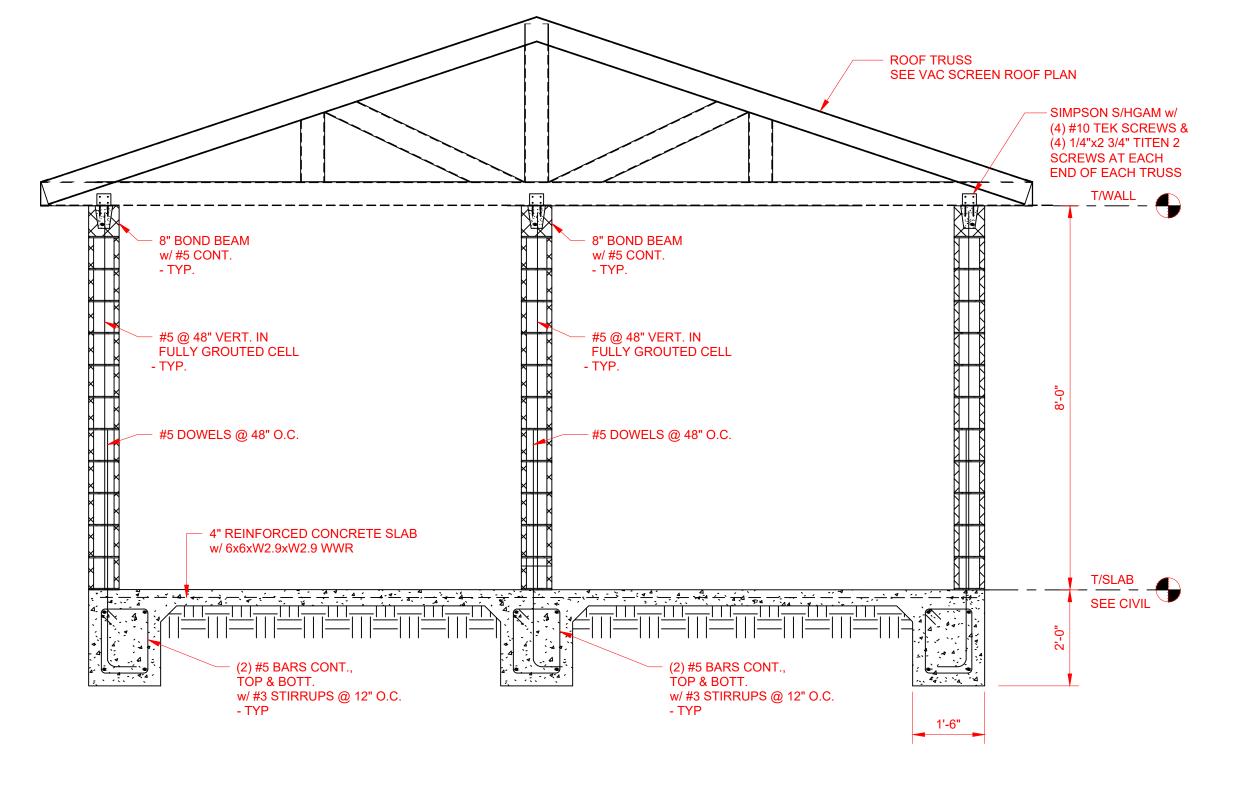

1 VAC HOUSE - SECTION 1/2" = 1'-0"

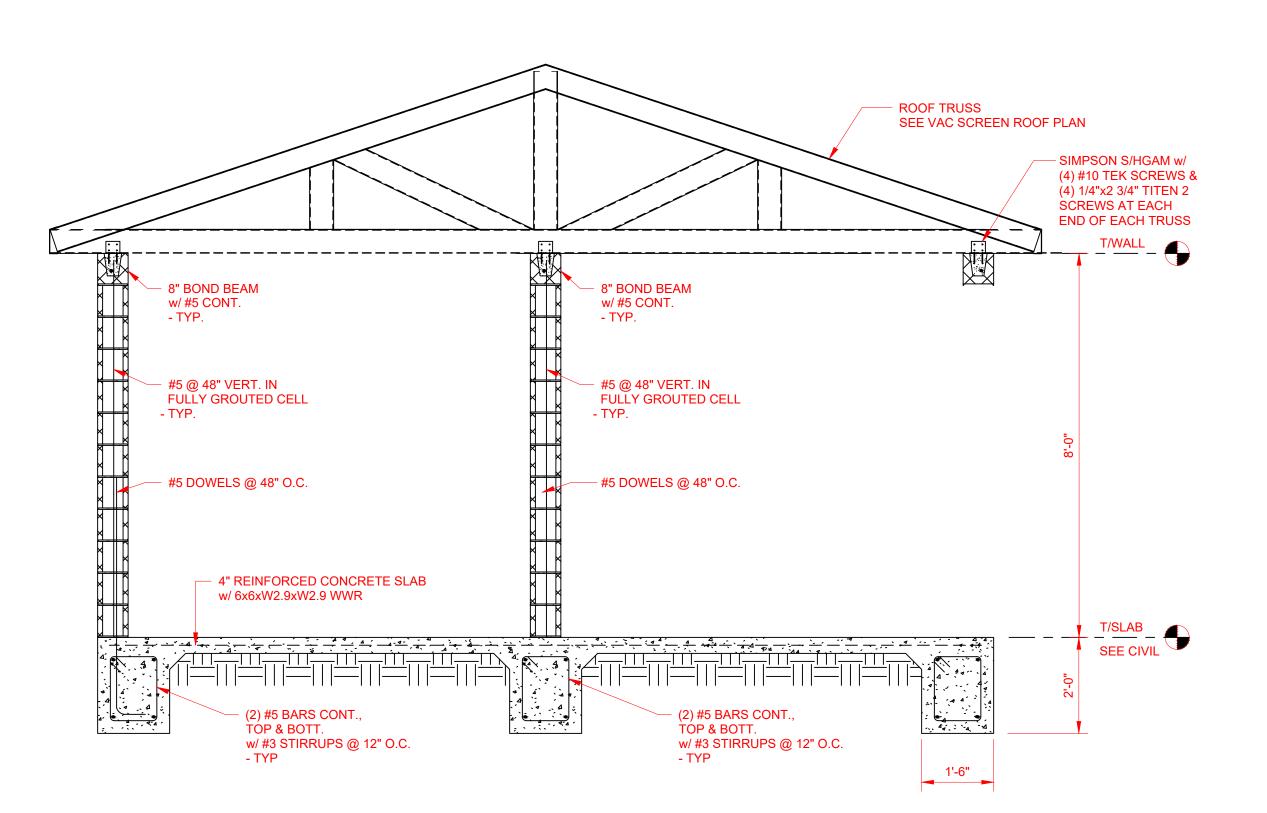

2 VAC HOUSE - SECTION
1/2" = 1'-0"



NOTE:

- 1. SEE CIVIL FOR LOCATION, LAYOUT, AND ORIENTATION.
- 2. COORDINATE EXISTANCE OF VENDING MACHINE OPENING w/ ARCHITECTURAL DRAWINGS. IF NO VENDING MACHINE EXISTS, INSTALL TYPICAL MASONRY WALL SECTION.



PROJECT:

TODAL

AUTOS SPA


Tidal Wave Auto Spa 3039 W US-90 Lake City, FL 32055 Columbia County

PROTOTYPE:
PROTOTYPE DATE:

SET NAME:

SETUP DATE:

SET DATE:
PROFESSIONAL OF R

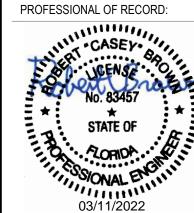

DESIGNER'S INFORMATION:



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▲ DATE:	DESCRIPTION:	

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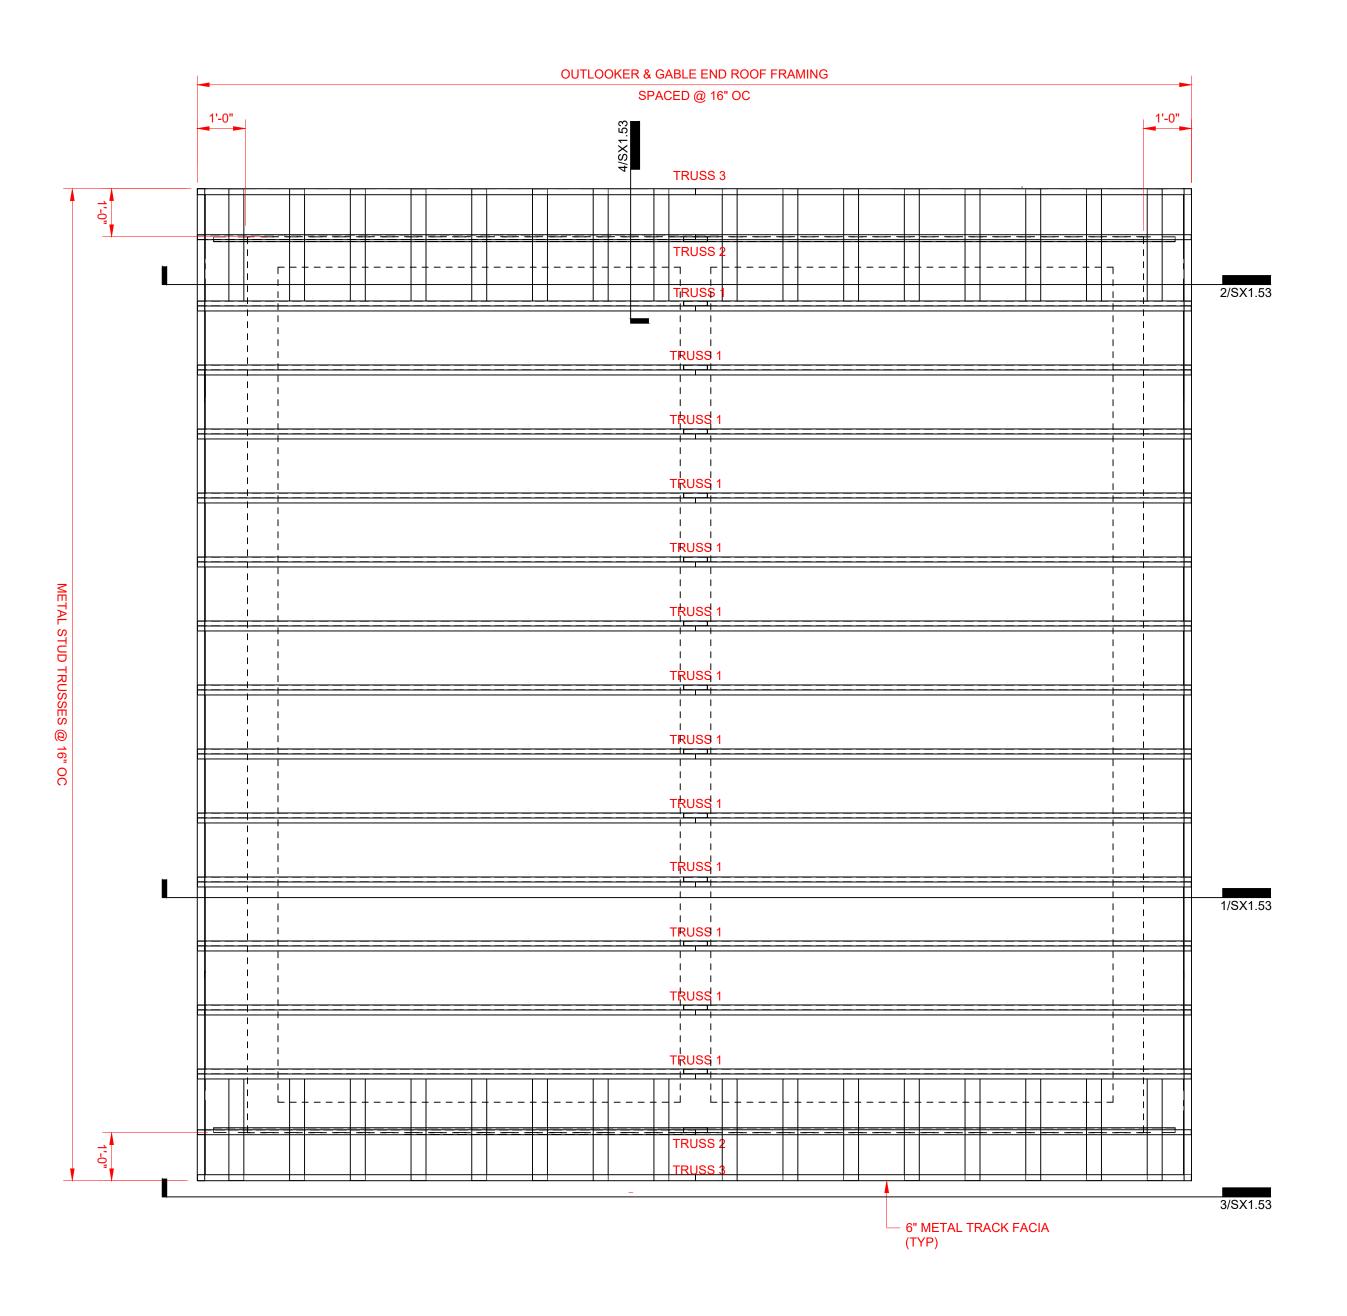
VAC HOUSE -FOUNDATION & WALL PLAN & SECTIONS

RKN

HEET SCALE:

SHEET SCALE:
SHEET NUMBER:

SX1.50



VAC HOUSE ROOF PLAN

SCALE: 1/2" = 1'-0"

NOTE:

1. SEE CIVIL FOR LOCATION, LAYOUT, AND ORIENTATION.



PROJECT:

Tidal Wave Auto Spa 3039 W US-90 Lake City, FL 32055


Columbia County

PROTOTYPE:

PROTOTYPE DATE:

SETUP DATE:

SET NAME:

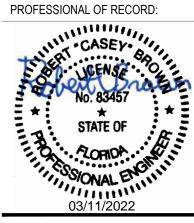

DESIGNER'S INFORMATION:



Thompson Engineering, Inc. 2970 Cottage Hill Road Mobile, AL 36606


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> **VAC HOUSE -ROOF PLAN**


SHEET SCALE:




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SHEET REVI	SIONS:	
▲ DATE:	DESCRIPTION:	

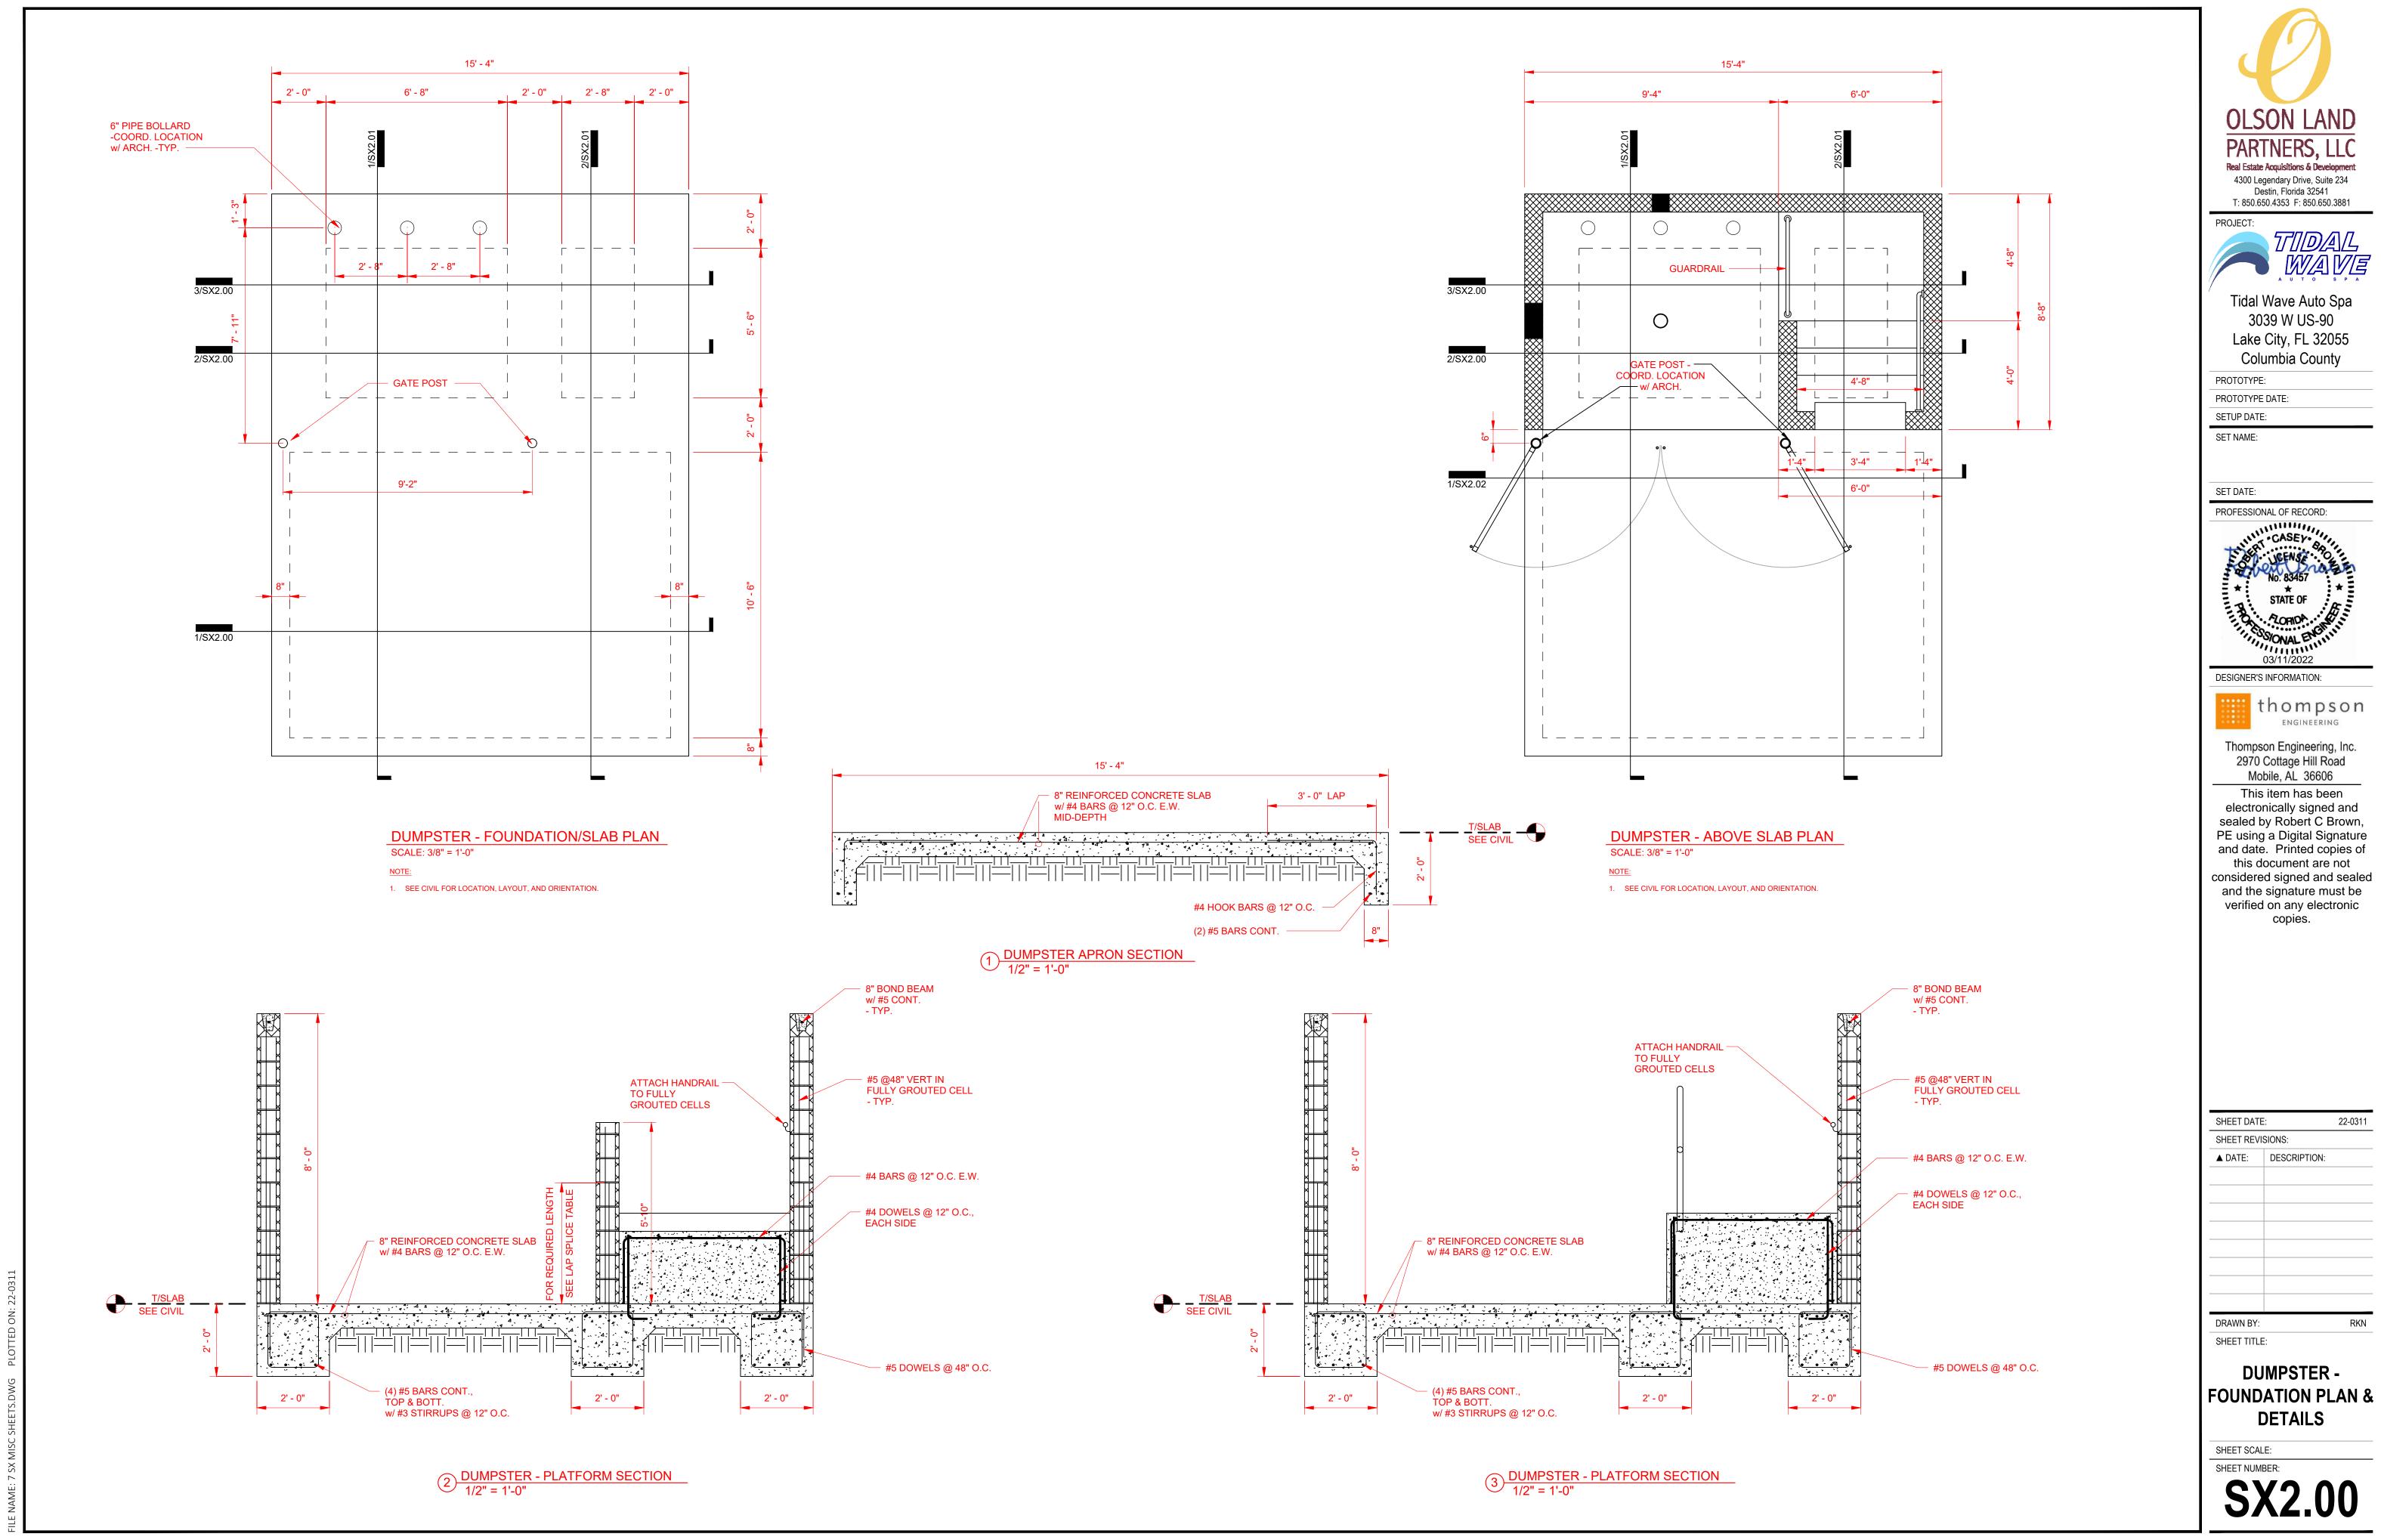

1) DUMPSTER - SECTION 1/2" = 1'-0"

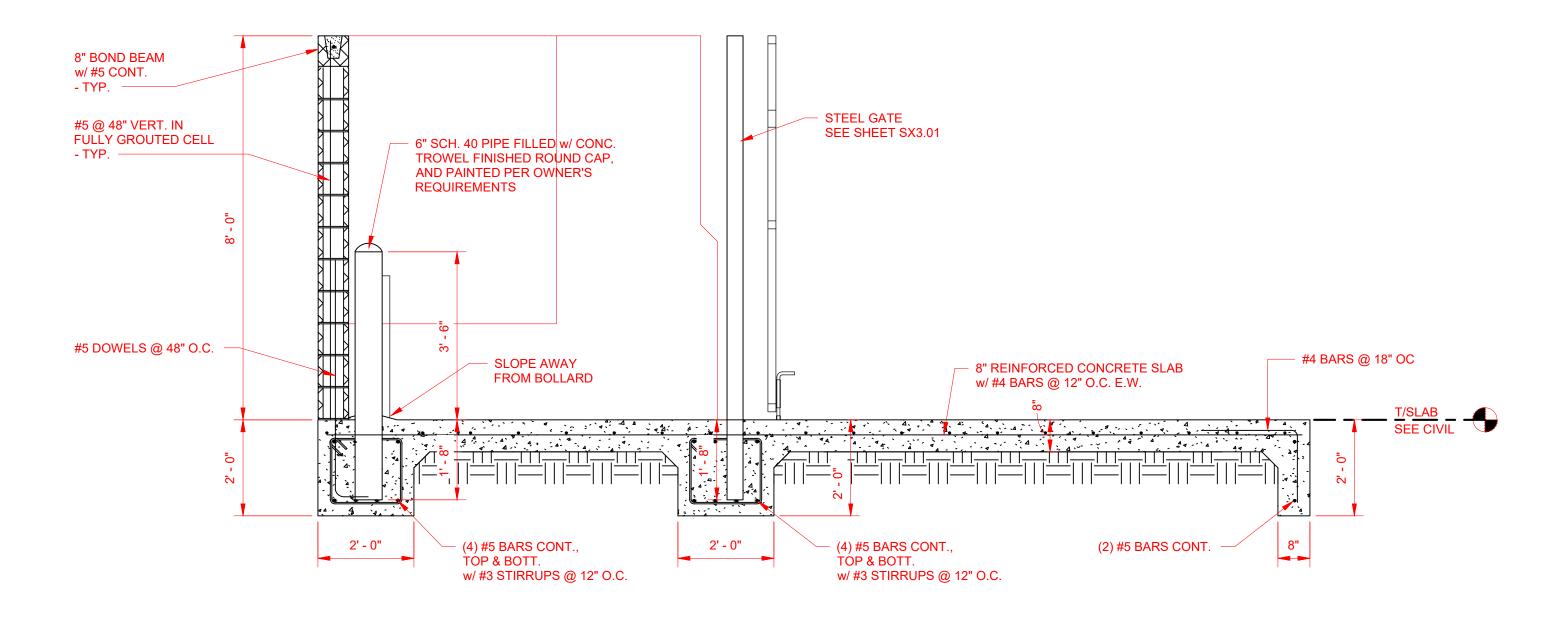

2 DUMPSTER - SECTION
1/2" = 1'-0"

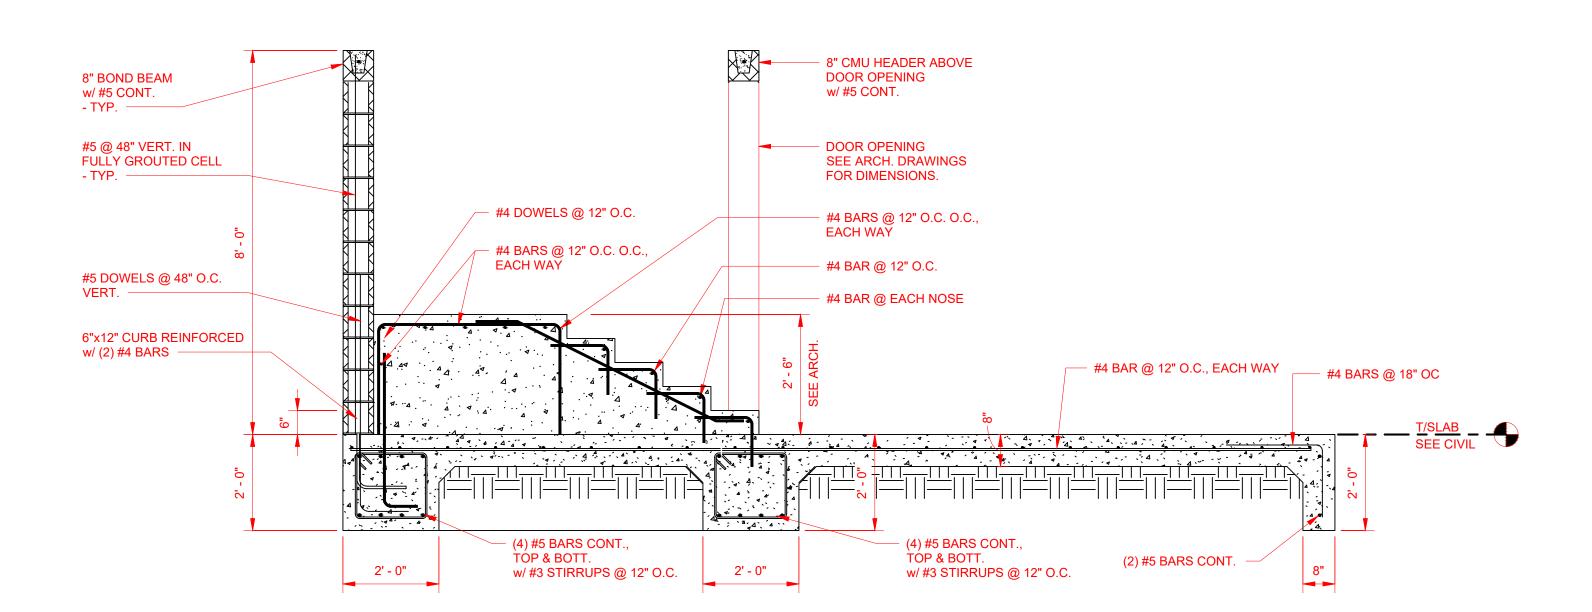

PROJECT: TIDAL WAVE

Tidal Wave Auto Spa 3039 W US-90 Lake City, FL 32055 Columbia County

PROTOTYPE:

PROTOTYPE DATE:

SETUP DATE: SET NAME:

SET DATE:

PROFESSIONAL OF RECORD:



DESIGNER'S INFORMATION:



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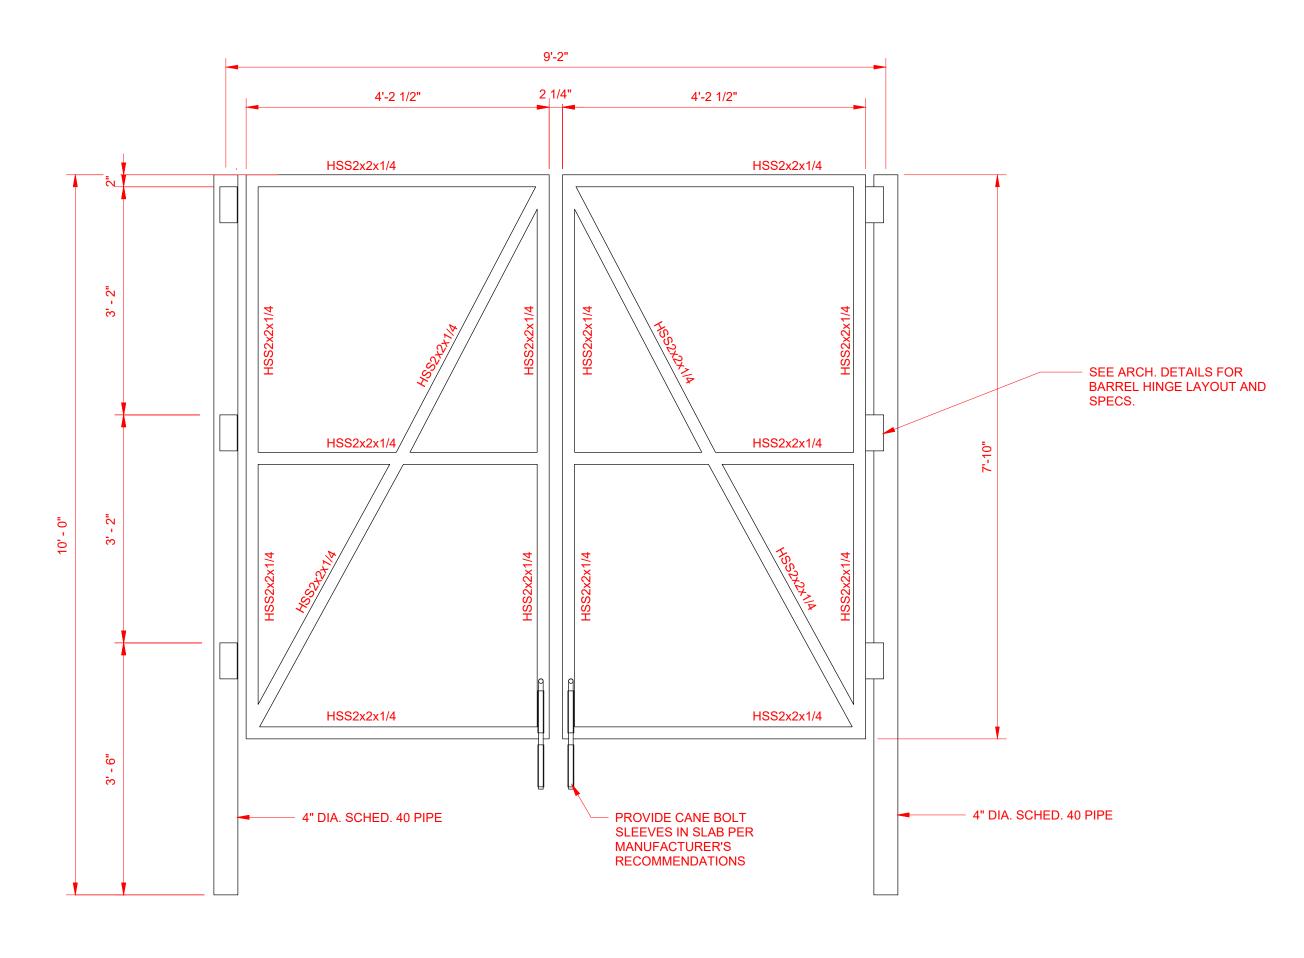
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SHEET REVI	SIONS:	
▲ DATE:	DESCRIPTION:	


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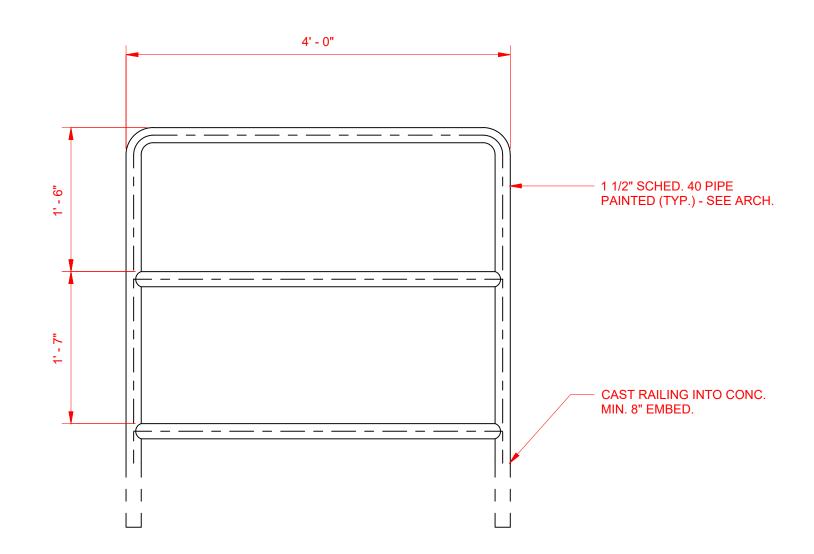
DUMPSTER -CMU PLAN, SECTIONS & DETAILS

RKN

SHEET SCALE:





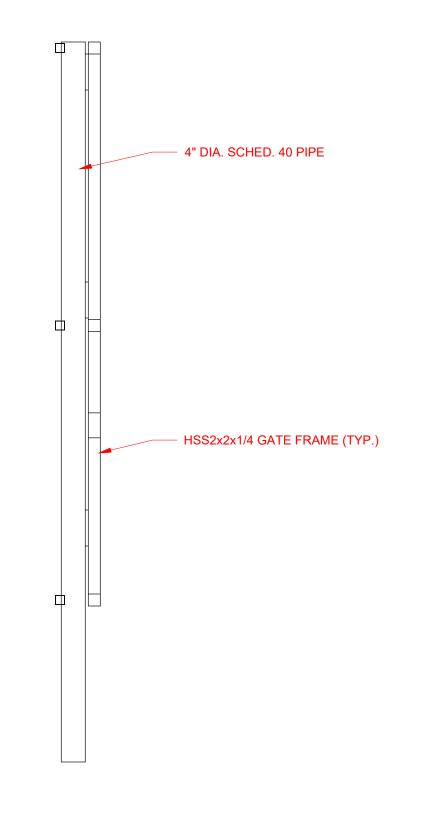

1 GATE ELEVATION
3/4" = 1'-0"

3 RAILING ELEVATION
1" = 1'-0"



Tidal Wave Auto Spa 3039 W US-90 Lake City, FL 32055 Columbia County

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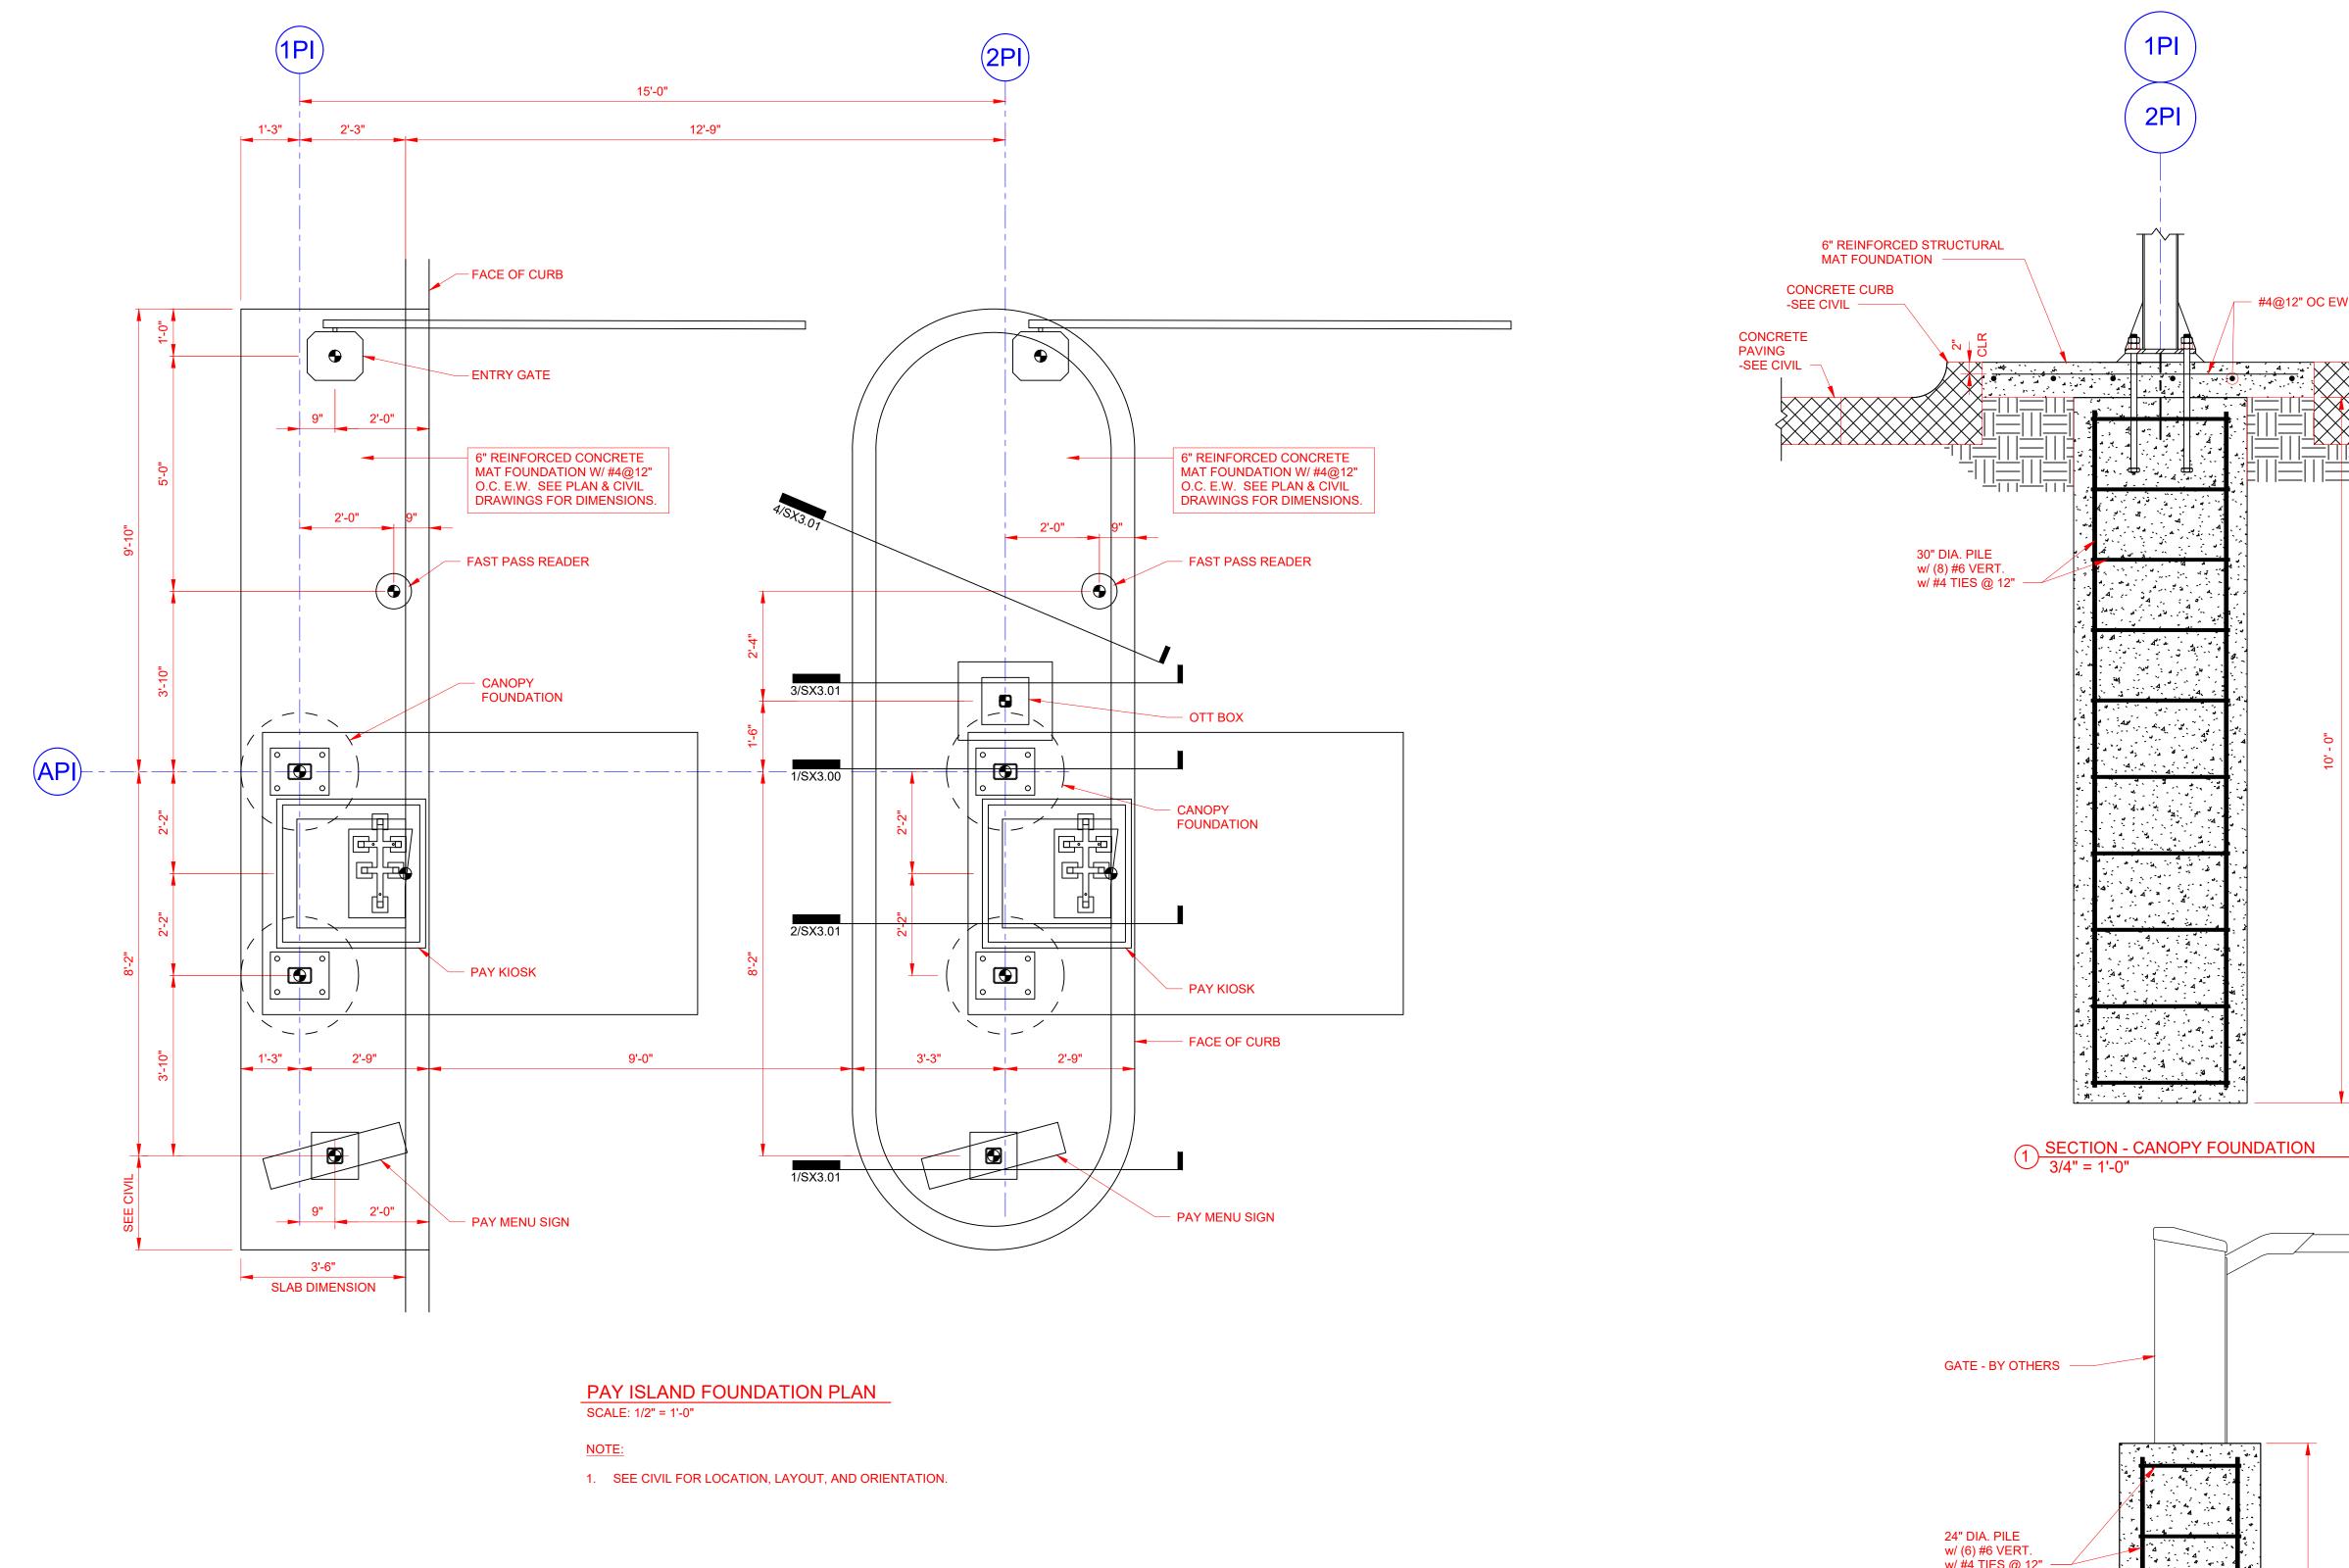
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SHEET REVI	SIONS:	
▲ DATE:	DESCRIPTION:	

DUMPSTER -STEEL GATE &


RAILING

DRAWN BY: SHEET TITLE:

SHEET SCALE: SHEET NUMBER:



- #4@12" OC EW T/SLAB SEE CIVIL

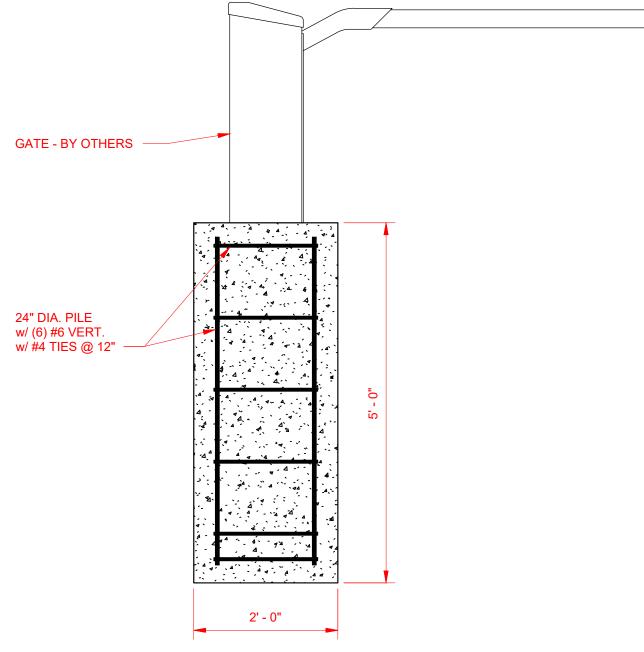

2 SECTION - FREE STANDING PAY GATE
3/4" = 1'-0"

Real Estate Acquisitions & Development 4300 Legendary Drive, Suite 234 Destin, Florida 32541 T: 850.650.4353 F: 850.650.3881

PROJECT:

TIDAL WAVE

Tidal Wave Auto Spa 3039 W US-90 Lake City, FL 32055 Columbia County

PROTOTYPE: PROTOTYPE DATE:

SETUP DATE: SET NAME:

SET DATE:

PROFESSIONAL OF RECORD:

03/11/2022

DESIGNER'S INFORMATION:

thompson ENGINEERING

Thompson Engineering, Inc.

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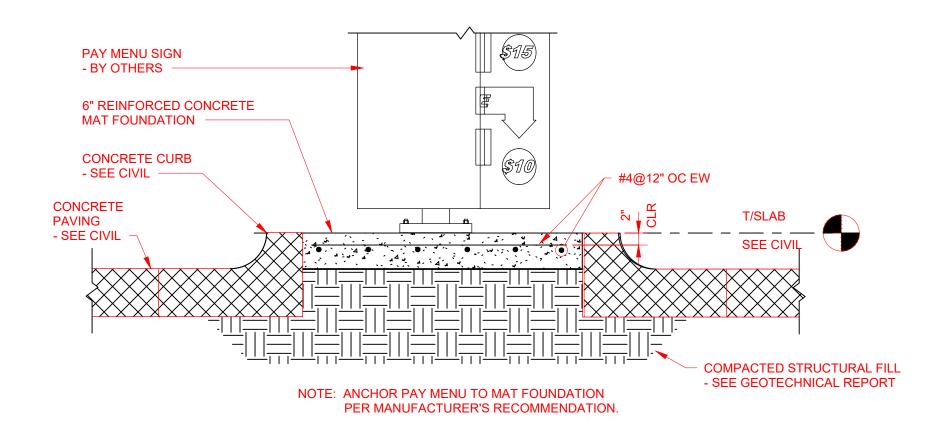
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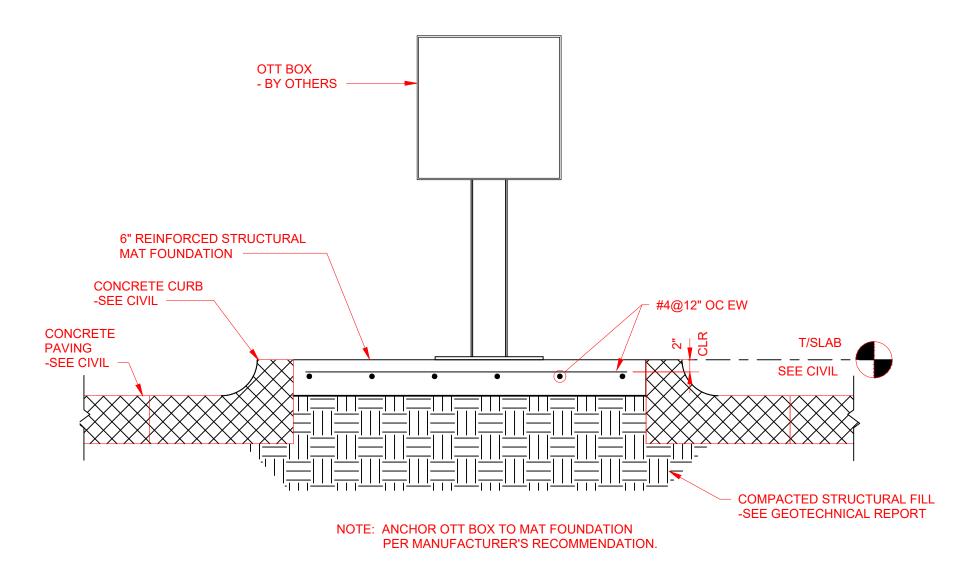
DRAWN BY: SHEET TITLE:

PAY ISLAND -FOUNDATION PLAN SECTIONS & DETAILS


SHEET SCALE:




1 SECTION - PAY MENU FOUNDATION 3/4" = 1'-0"



3 SECTION - OTT BOX FOUNDATION
3/4" = 1'-0"

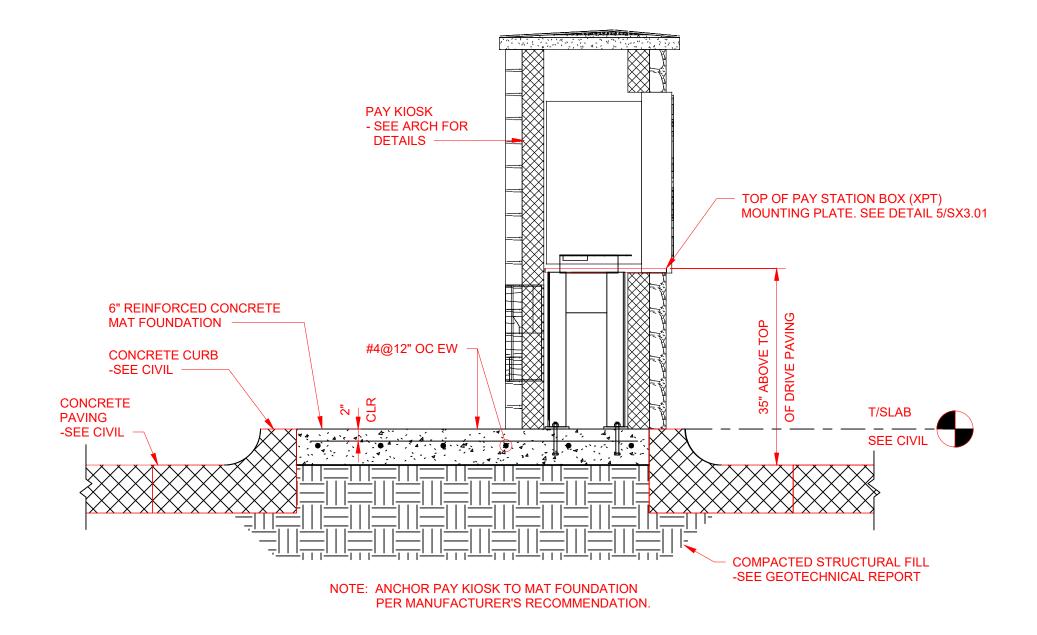


2 SECTION - PAY KIOSK FOUNDATION 3/4" = 1'-0"

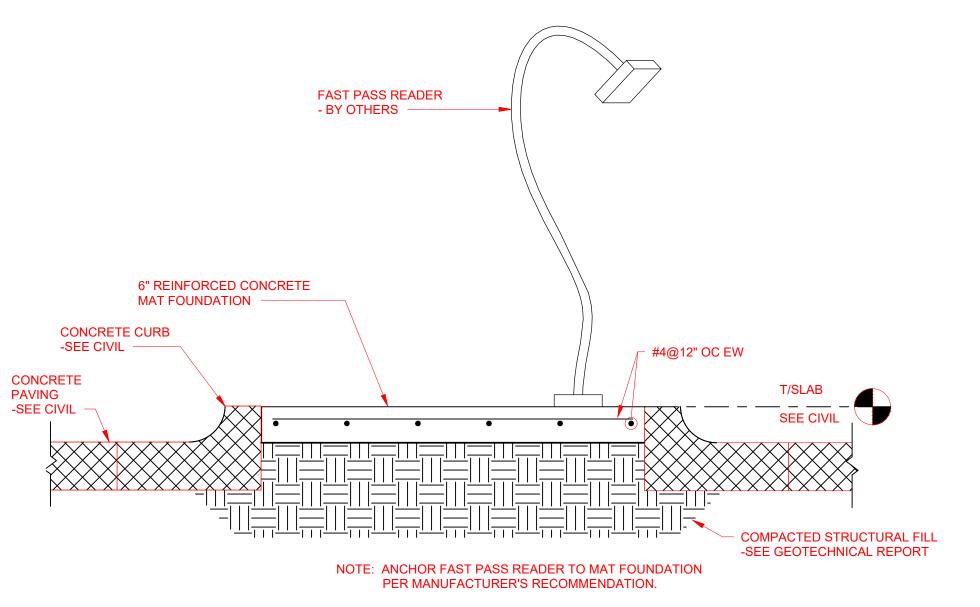


SECTION - FAST PASS READER

FOUNDATION

3/4" = 1'-0"

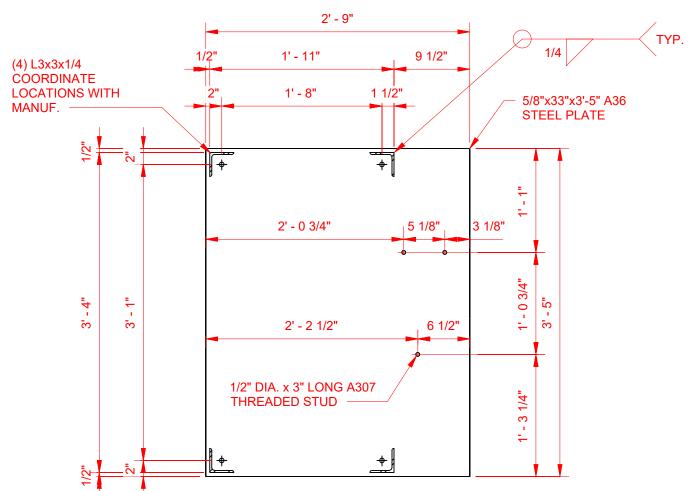

PAY STATION BOX (XPT) MOUNTING

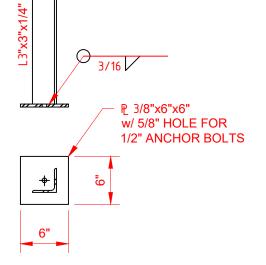

6 DETAIL 1" = 1'-0"






Tidal Wave Auto Spa 3039 W US-90 Lake City, FL 32055 Columbia County

PROTOTYPE:

PROTOTYPE DATE:

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DRAWN BY:		RKN


PAY ISLAND -FOUNDATION SECTIONS & DETAILS

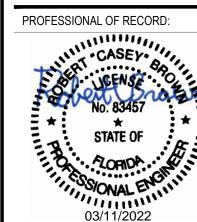
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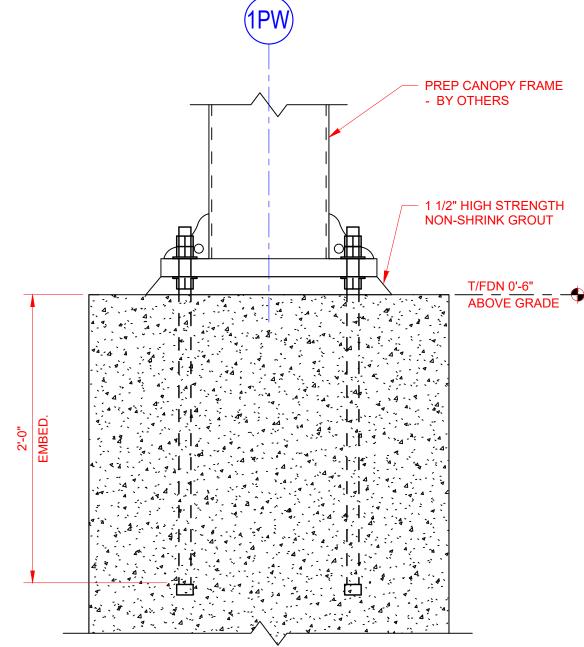
SHEET TITLE:

SHEET NUMBER:

SX3.01



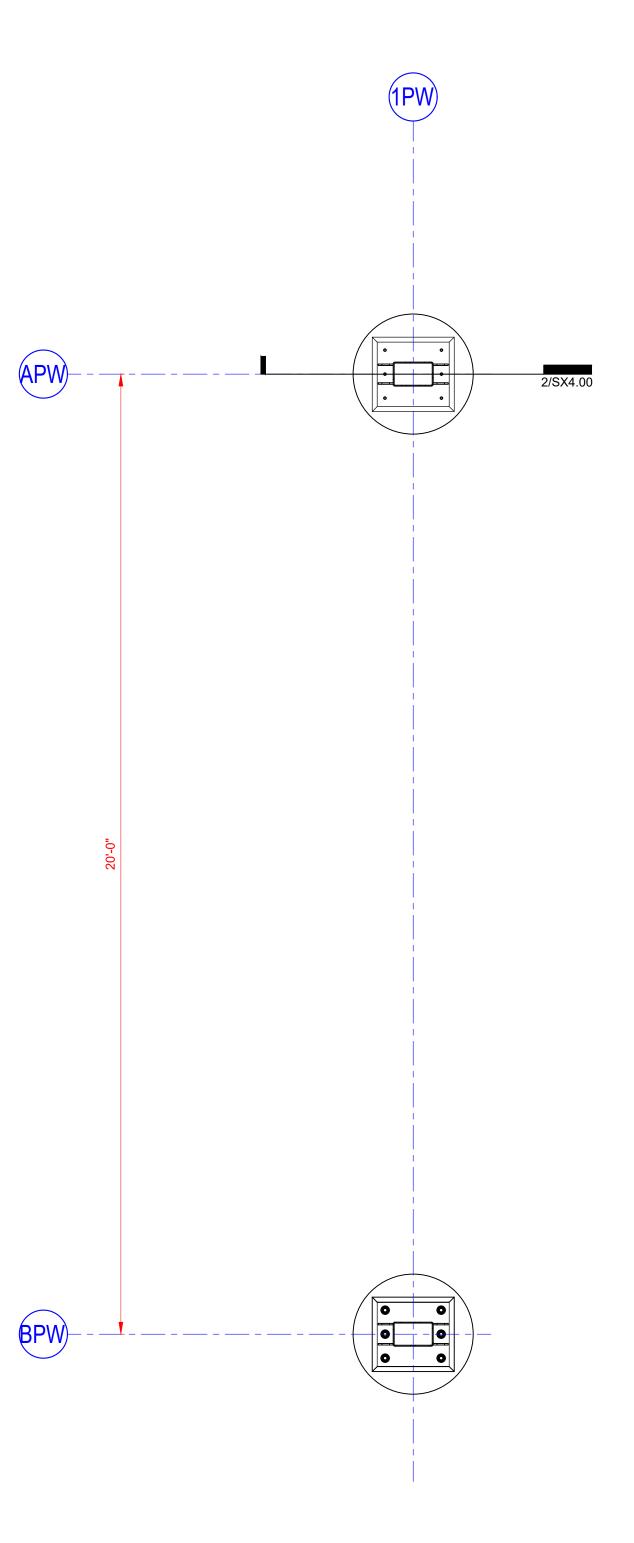

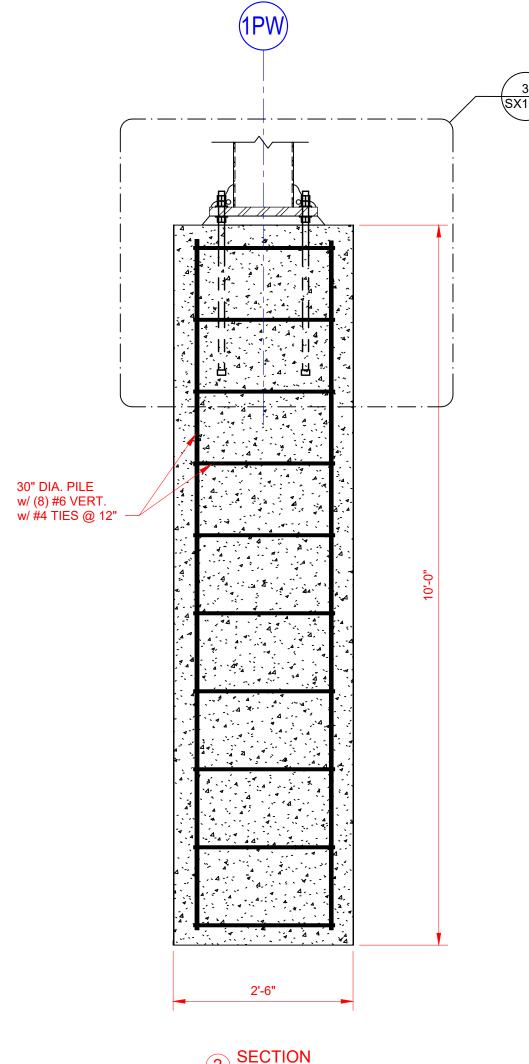


3 PREP CANOPY FDN DETAIL 1 1/2" = 1'-0"



SCALE: 1/2" = 1'-0"

- PREP CANOPY FRAME DESIGNED BY OTHERS. COORDINATE ANCHOR BOLT LAYOUT WITH FRAME DESIGNER.
- 2. SEE CIVIL DRAWINGS FOR CONCRETE PAVING INFORMATION.
- 3. DESIGN BASED ON A TOP OF FOOTING ELEVATION OF 0'-6" ABOVE GRADE.
- SEE CIVIL FOR GRADE ELEVATION.
 4. TOP OF FOUNDATION ELEVATIONS TO BE EQUAL.

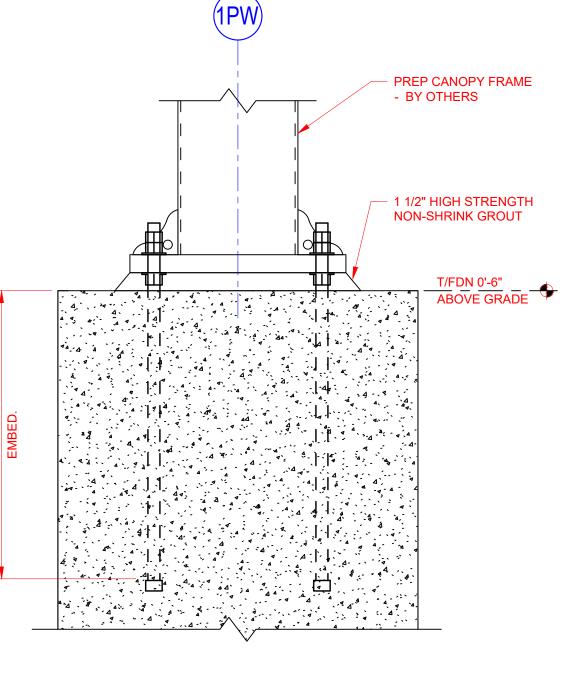

DESIGNER'S INFORMATION:



03/11/2022

4300 Legendary Drive, Suite 234 Destin, Florida 32541 T: 850.650.4353 F: 850.650.3881

Tidal Wave Auto Spa 3039 W US-90

Lake City, FL 32055 Columbia County

PROJECT:

PROTOTYPE: PROTOTYPE DATE:

SETUP DATE: SET NAME:

SET DATE:

PROFESSIONAL OF RECORD:

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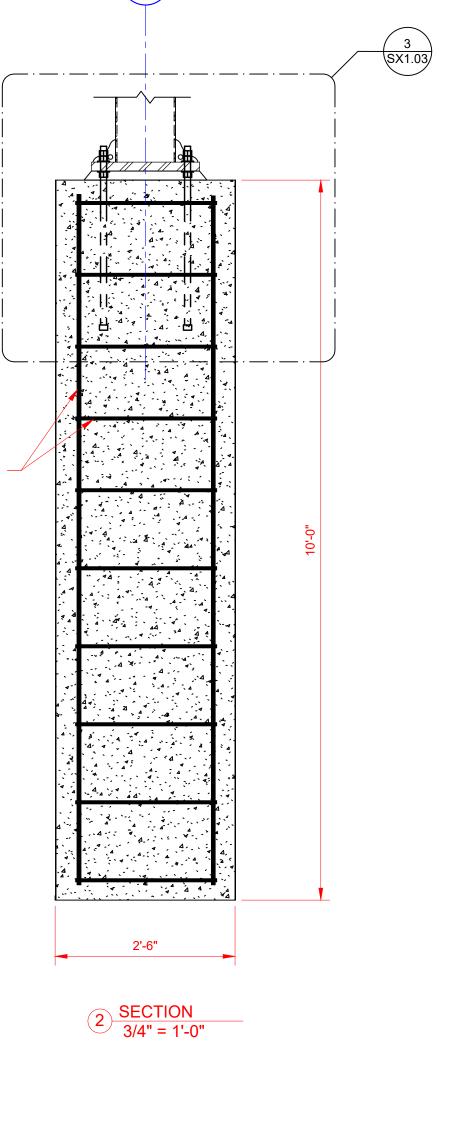
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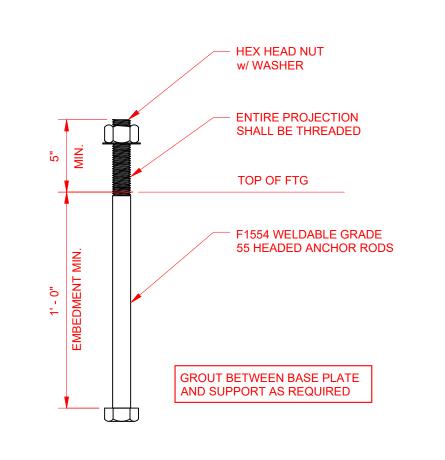
SHEET DATE	SHEET DATE:	
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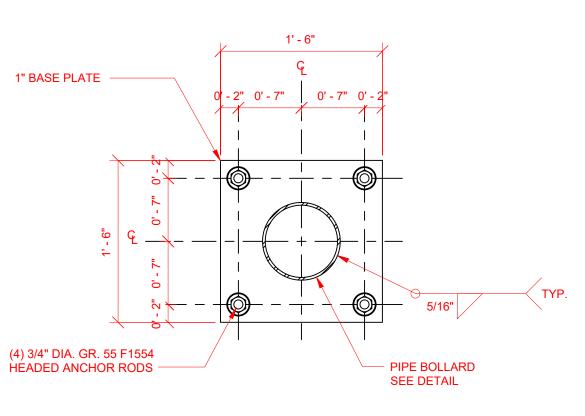
PREP CANOPY -PLAN AND DETAILS

SHEET SCALE:






BOLLARD AT FOUNDATION ANCHOR ROD




BOLLARD AT FOUNDATION BASE PLATE

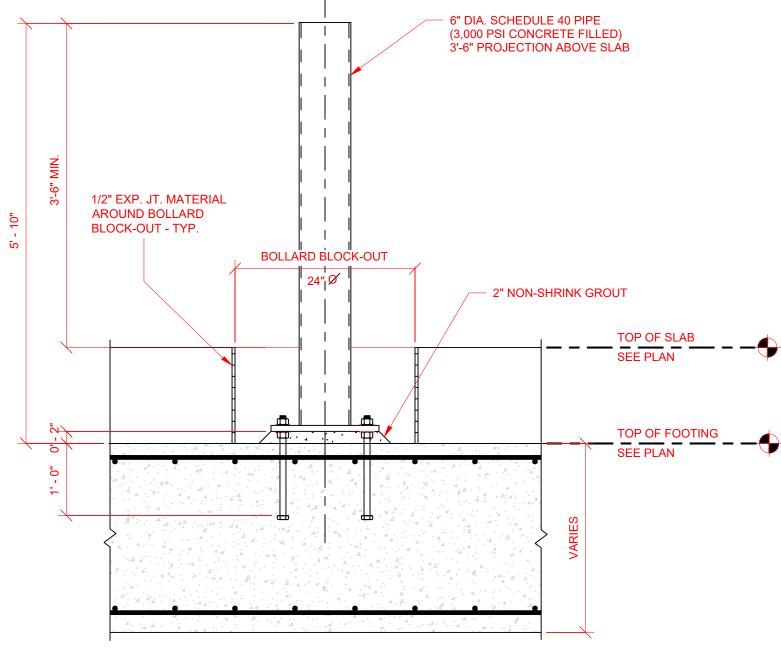


BOLLARD AT FOUNDATION DETAIL

1. POST TO BE PRIMED PRIOR TO SETTING IN CONCRETE. 2. SEE ARCH. DRAWINGS FOR PLASTIC BOLLARD SLEEVE REQUIREMENTS. 3. COORDINATE LOCATIONS WITH ARCHITECTURAL AND CIVIL DRAWINGS.

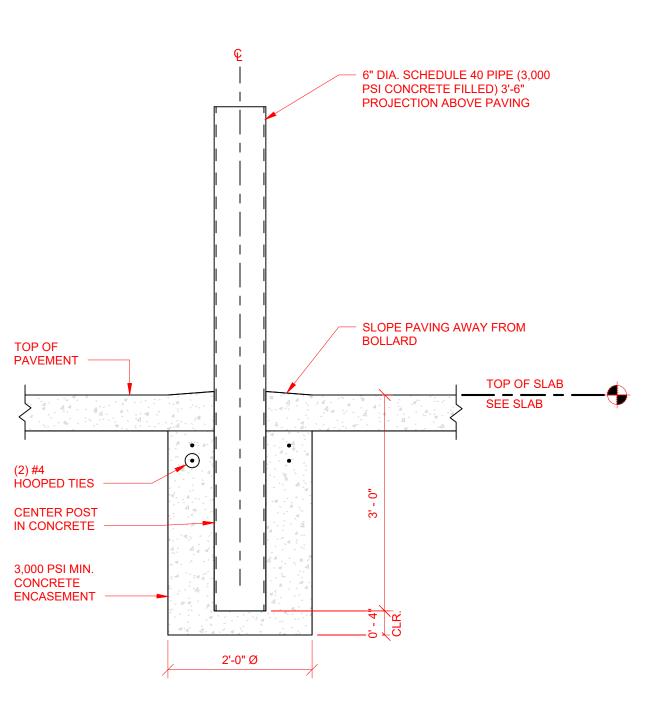


BOLLARD AT PAVING DETAIL

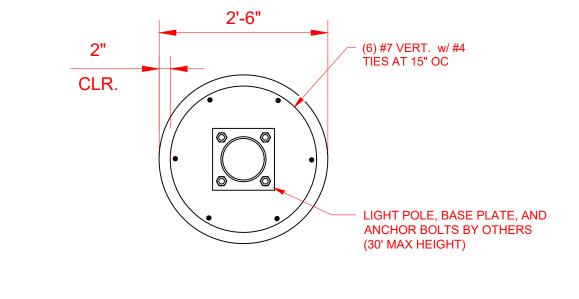

LIGHT POLE, BASE PLATE, AND ANCHOR BOLTS BY OTHERS (30' MAX HEIGHT)

CONCRETE LIGHT POLE BASE SHALL BE FINISH PAINTED. REFER

TO ARCHITECTURAL FOR MATERIAL FINISH AND COLOR.

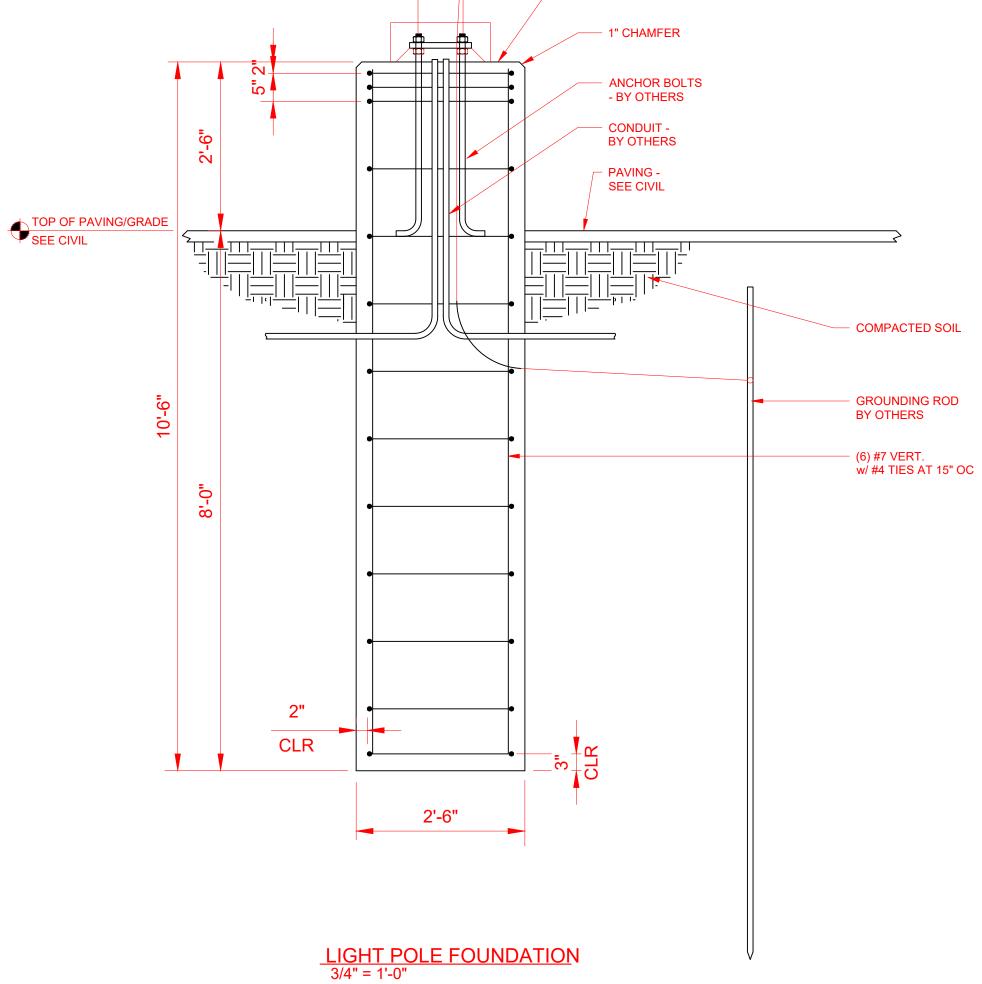

1. CONCRETE SHALL BE 3,000 PSI PER SHEET SN0.03

CAST-IN-PLACE CONCRETE SCHEDULE "FOUNDATION" ROW.
2. #4 SPIRAL REINFORCEMENT WITH 4" PITCH MAY BE USED IN

PLACE OF INDIVIDUAL TIES.
3. FOUNDATION IS DESIGNED FOR A 30' MAXIMUM POLE HEIGHT.



TIDAL WAVE

Tidal Wave Auto Spa 3039 W US-90 Lake City, FL 32055 Columbia County

PROTOTYPE:

PROTOTYPE DATE:

SETUP DATE: SET NAME:

SET DATE:

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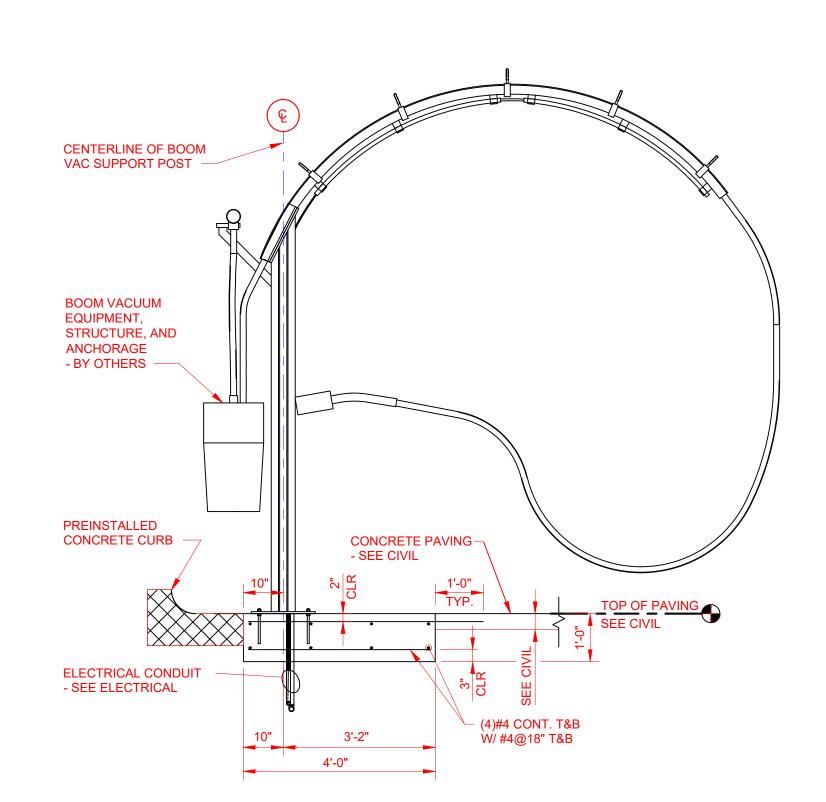
SHEET DATE: 22-0311 SHEET REVISIONS: ▲ DATE: DESCRIPTION:

DRAWN BY: RKN SHEET TITLE:

MISC. STRUCTURAL **ELEMENTS**

SHEET SCALE:

SHEET NUMBER:



BOOM VAC FOUNDATION DETAIL

- 1. BOOM VACUUM FOUNDATIONS ARE DESIGNED FOR USE WHERE FABRIC CANOPIES ARE DESIGNED AS TEAR AWAY OR ARE NOT USED. IF NON-TEAR AWAY CANOPIES ARE TO BE INSTALLED, CONTACT THE ENGINEER FOR EVALUATION OF THE
- FOUNDATION. SEE CIVIL FOR LOCATION, LAYOUT, AND ORIENTATION.
 BOOM VACUUM CONTINUOUS STRIP FOUNDATION TO BEGIN 2' BEFORE THE FIRST
- POST AND END 2' PAST THE LAST POST. COORDINATE WITH CIVIL ENGINEER.
- 4. BOOM VACUUM FOUNDATIONS MAY BE PLACED INTEGRAL WITH SITE NORMAL
- CONCRETE PAVING OR PLACED INDEPENDENTLY PRIOR TO INSTALLING PAVING. FOUNDATION SHALL NOT BE CONSTRUCTED OF PERVIOUS OR ASPHALT PAVING.