DATE <u>03/0</u>	1/2007		bia Count mit Expires One				PERMIT 000025583
APPLICANT	BOB MC		mit Expires one		PHONE	754-8679	
ADDRESS	289	NW CORINTH D	R	LAKE C	ITY		FL 32055
OWNER	FRED &	DANA KINGRY			PHONE	758-7504	
ADDRESS	165	SW RED MAPLE	WAY	LAKE C	ITY		FL 32055
CONTRACTO	OR MI	CHAEL DELAHOZ			PHONE	754-8678	
LOCATION C	F PROPER	TY 90W, TI	ON DEPUTY JEFF	DAVIS,TR ON	PINE MOUN	IT, TL	
		RED M	APLE WAY, 3RD ON	LEFT			
TYPE DEVEL	OPMENT	POOL ENCLOS	SURE	ESTIMATED	COST OF CC	NSTRUCTIO	N 24000.00
HEATED FLO	OOR AREA		TOTAL	AREA		HEIGHT	STORIES
FOUNDATIO	N	WA	LLS	ROOF PITC	н		FLOOR
LAND USE &	ZONING	RSF-2			MAX	. HEIGHT	
Minimum Set	Back Requi	rments: STREE	T-FRONT 25	5.00	REAR	15.00	SIDE 10.00
NO. EX.D.U.	1	FLOOD ZONE	E NA	DEVELO	PMENT PERI	MIT NO.	_
PARCEL ID	02.45.16	-02732-118	SUBDIVI	CION I AID	REL LAKE		
				 		AL ACRES	
LOT <u>18</u>	BLOCK	PHASE	UNIT		1017	AL ACRES	
Driveway Conr COMMENTS:		Septic Tank Number	er LU & Z	Coning checked	ру Арр	proved for Issu	ance New Resident
						Check # or	Cash 3316
		FOR B	BUILDING & ZOI	NING DEPA	RTMENT	ONLY	(footer/Slab)
Temporary Pov	wer		Foundation			_ Monolithic	
		date/app. by		date/app.	by		date/app. by
Under slab roug	gh-in pluml		Sla			Sheathi	ng/Nailing
Framing			app. by		app. by		date/app. by
	date/ar	pp. by	Rough-in plumbin	ig above slab an	d below wood	1 floor	date/app. by
Electrical roug	gh-in	. •	Heat & Air Duct			Davi haam (T	
		date/app. by	Hour de / Mr Duot	date/ap		Peri. beam (L	date/app. by
Permanent pow			C.O. Final	-		Culvert _	
		ate/app. by		date/app. by			date/app. by
M/H tie downs,	blocking, e	electricity and plumbin		/app. by	_	Pool	
Reconnection			_ Pump pole		Utility Po	le	date/app. by
		date/app. by		date/app. by		date/app	•
M/H Pole da	te/app. by		ravel Trailer	date/app. by		Re-roof	date/app. by
				date/app. by			auto app. oy
BUILDING PE	RMIT FEE	\$ 120.00	_ CERTIFICATION	FEE\$	0.00	SURCHAR	RGE FEE \$
MISC. FEES \$	0.00	ZONIN	G CERT. FEE \$ 50).00 FIRE F	EE\$ 0.00	WA	ASTE FEE \$
	•		OOD ZONE FEE \$				QTAL FEE 170.00
					•	_//	X/ 170.00
INSPECTORS	OFFICE			CLERI	S OFFICE		77

NOTICE: IN ADDITION TO THE REQUIREMENTS OF THIS PERMIT, THERE MAY BE ADDITIONAL RESTRICTIONS APPLICABLE TO THIS PROPERTY THAT MAY BE FOUND IN THE PUBLIC RECORDS OF THIS COUNTY. AND THERE MAY BE ADDITIONAL PERMITS REQUIRED FROM OTHER GOVERNMENTAL ENTITIES SUCH AS WATER MANAGEMENT DISTRICTS, STATE AGENCIES, OR FEDERAL AGENCIES.

"WARNING TO OWNER: YOUR FAILURE TO RECORD A NOTICE OF COMMENCEMENT MAY RESULT IN YOUR PAYING TWICE FOR IMPROVEMENTS TO YOUR PROPERTY. IF YOU INTEND TO OBTAIN FINANCING, CONSULT WITH YOUR LENDER OR AN ATTORNEY BEFORE RECORDING YOUR NOTICE OF COMMENCEMENT."

This Permit Must Be Prominently Posted on Premises During Construction

PLEASE NOTIFY THE COLUMBIA COUNTY BUILDING DEPARTMENT AT LEAST 24 HOURS IN ADVANCE OF EACH INSPECTION, IN ORDER THAT IT MAY BE MADE WITHOUT DELAY OR INCONVIENCE, PHONE 758-1008. THIS PERMIT IS NOT VALID UNLESS THE WORK AUTHORIZED BY IT IS COMMENCED WITHIN 6 MONTHS AFTER ISSUANCE.

The Issuance of this Permit Does Not Waive Compliance by Permittee with Deed Restrictions.

Columbia County Building Permit Application

For Office Use Only Application # 070 2- 70 Date	Received 426 By JW Permit	# 25583
Application Approved by - Zoning Official Dat	te 2/28/01 Plans Examiner 8KJ7H	
Flood Zone VA Development Permit VA Zoni	ing RSF-2 Land Use Plan Map Cate	gory RUD
Comments		
NOC OFEH Deed or PA Site Plan	State Road Info 🛭 Parent Parcel # 🗘 D	evelopment Permit
18 / 1.00	Fax 386-755	
Name Authorized Person Signing Permit 1/2000 W	1x105h Phone 356-75	54-8679
Address 289 MW Corinth Dr Lake City	FL 33055	
Owners Name Mingery Freda Donc	Phone 376-757	1-7504
911 Address 165 SW Red Made Way hak	elity F1 32055	
Contractors Name Michael A Dela Hoz	Phone 356-75	XX218-6
Address 927 Hickory St Altamonte Spir	mcs. F1 32701	
Fee Simple Owner Name & Address 1\14	*	
Bonding Co. Name & Address 1/1 / A		
Architect/Engineer Name & Address		
Mortgage Lenders Name & Address 1/14		
Circle the correct power company - FL Power & Light - C	Clay Flec Suwannee Valley Flec	Progressive Energy
Property ID Number 3: 45-16-02732-118	Estimated Cost of Construction	/
Subdivision Name haute bake	Lot \\\ Block \ Ur	
Driving Directions 90 W to Left on Deputy	Left Davis to Ron	
100 7 1 00 1 1 1 1 0	2 Brd on Left	IIIE
	300000000000000000000000000000000000000	
Type of Construction Pool Enclosure	Number of Existing Dwellings on Pro	norts \
Total Acreage 5 Lot Size 417.80 Do you need a - C		
Actual Distance of Structure from Property Lines - Front	∇ Side 52^{l} Side 32^{l}	Rear 47
Total Building Height Number of Stories \	Na	of Pitch
Application is hereby made to obtain a permit to do work an installation has commenced prior to the issuance of a permi	d installations as indicated. I certify the	it no work or
all laws regulating construction in this jurisdiction.		
OWNERS AFFIDAVIT: I hereby certify that all the foregoing is compliance with all applicable laws and regulating construct	nformation is accurate and all work will tion and zoning.	be done in
WARNING TO OWNER: YOUR FAILURE TO RECORD A NOT	ICE OF COMMENCMENT MAY RESULT	IN YOU PAYING
TWICE FOR IMPROVEMENTS TO YOUR PROPERTY. IF YOU LENDER OR ATTORNEY BEFORE RECORDING YOUR NOTICE.	INTEND TO OBTAIN FINANCING CON-	SULT WITH YOUR
1 Drood while	SE OF COMMENCEMENT.	111
Owner Builder or Authorized Person by Notarized Letter	- Mu av	May
Comer builder of Authorized Person by Notarized Letter	Contractor Signature Contractors License Number	0 N561.50
STATE OF FLORIDA COUNTY OF COLUMBIA	Competency Card Number	200001
		an G.S. McIntosh
Sworn to (or affirmed) and subscribed before me	VILL ROUNCE Expires	ission # DD371494 8 November 14, 2008
	AND AND WALLE TO Bended Trey Fo	in - Insurance, Inc. 809-365-7919
Personally known or Produced Identification	Notary Signature	(Revised Sept. 2006)

(Revised Sept. 2006)

NOTICE OF COMMENCEMENT FORM COLUMBIA COUNTY, FLORIDA

THE UNDERSIGNED hereby gives notice that improvement will be made to certain real property, and in accordance with Chapter 713, Florida Statutes, the following information is provided in this Notice of Commencement.

Tax Parcel ID Number 03 -48.16-037 32-118

1.	Description of property: (legal description of the pro	perty and street address or 911 address)
	LOT TO BY HAILTEN LARGE US T	er recorded in Plat Book 1 299910
	165 Su Red Maple Way 1	UKE CIAH F1 27022
	*	
		enclosure
2.	General description of improvement: YOO	MONSHIE
•	Owner Name & Address XIVC 074 , Fred	
3.	Owner Name & Address TIVOPTY FIELD	* DONG
	1162 20 LEG HIGHE MAY HOKE CE	Triberest in Property OWN Qr
4.	Name & Address of Fee Simple Owner (If other than	owner): Y A
	Contractor Name William Dalation	391 5-1 5115
Э.	Address & NI 1 2 2 1 1 1 2	Phone Number 386-754-8678
2	Surely Holden Name W/W	KCC111 1 29022
0.	Address Name 1777	Phone Number
	Amount of Bond	st:2007004522 Date:02/26/2007 Time:10:02
7	Lander Name W \ \ \ \ \ \ \ \ \ \ \ \ \ \ \ \ \ \	st:2007004522 Date:02/26/2007 Time:10:02 DC,P.DeWitt Cason,Columbia County B:1111 P:2241
1.	**N	a har a managemental and a second of the sec
8.	Address Persons within the State of Florida decignated by the	e Owner upon whom notices or other documents may be
se	rved as provided by section 718.13 (1)(a) 7; Fiorida Si	a Cwher upon whom houces or other documents may be attites:
	Name	Phone Number
	Address	
9.	in addition to himself/herself the owner designates	Florida Pool Englosures. Inc or
	289 MW COTINTA Dr LC to receive a con	by of the Lienor's Notice as provided in Section 713.13 (1) -
	(a) 7. Phone Number of the designee 3516-76	25018-6
10		e expiration date is 1 (one) year from the date of recording,
	(Unless a different date is specified)	
NC	TICE AS PER CHAPTER 713. Florida Statutes:	
Iħ	e owner must sign the notice of commencement and	no one else may be permitted to sign in his/her stead.
		Sworn to (or affirmed) and subscribed before
	$\mathcal{L}(\mathcal{L},\mathcal{L})$	day of 32' Felo 2007
	Waroth Xucery	NOTARY STAMPHER. Nadean G.S. McIntosh
	Signature of Owner	Commission # DD371494 Expires November 14, 2008

Signature of Notary

Columbia County Property Appraiser DB Last Updated: 2/5/2007

Parcel: 03-4S-16-02732-118

2007 Proposed Values

Search Result: 1 of 1

Tax Record Property Card Interactive GIS Map Print

Owner & Property Info

Owner's Name	KINGERY FREDRIC	KINGERY FREDRICK L & DANA B												
Site Address	RED MAPLE	RED MAPLE												
Mailing Address	165 SW RED MAPI LAKE CITY, FL 320		T.											
Use Desc. (code)	SINGLE FAM (000100)													
Neighborhood	3416.00	3416.00 Tax District 2												
UD Codes	MKTA06	Market Area	06											
Total Land Area	0.500 ACRES	0.500 ACRES												
Description	LOT 18 LAUREL LAKE S/D. ORB 978-96, WD 1007-695. WD 1108-1400. WD 1108-1403.													

GIS Aerial



Property & Assessment Values

Mkt Land Value	cnt: (1)	\$40,000.00
Ag Land Value	cnt: (0)	\$0.00
Building Value	cnt: (1)	\$181,311.00
XFOB Value	cnt: (1)	\$4,806.00
Total Appraised Value		\$226,117.00

Just Value	\$226,117.00
Class Value	\$0.00
Assessed Value	\$226,117.00
Exempt Value	\$0.00
Total Taxable Value	\$226,117.00

Sales History

Sale Date	Book/Page	Inst. Type	Sale Vimp	Sale Qual	Sale RCode	Sale Price
1/16/2007	1108/1403	WD	I	Q		\$276,000.00
9/22/2006	1108/1400	WD	I	Q		\$302,500.00
2/10/2004	1007/695	WD	I	Q		\$187,000.00

Building Characteristics

Bldg item	Bldg Desc	Year Blt	Ext. Walls	Heated S.F.	Actual S.F.	Bidg Value									
1	SINGLE FAM (000100)	2003	WD FR Stucco (16)	2483	3385	\$181,311.00									
	Note: All S.F. calculations are based on exterior building dimensions.														

Extra Features & Out Buildings

Code	Desc	Year Blt	Value	Units	Dims	Condition (% Good)
0166	CONC,PAVMT	2003	\$4,806.00	1602.000	0 x 0 x 0	(.00)

Land Breakdown

Lnd Code	Desc	Units	Adjustments	Eff Rate	Lnd Value		
000100	SFR (MKT)	1.000 LT - (.500AC)	1.00/1.00/1.00/1.00	\$40,000.00	\$40,000.00		

Columbia County Property Appraiser

DB Last Updated: 2/5/2007

LOT 19 15' SET TRANSFORMER ELECTRIC BOX **ELECTRIC** METER 30.00 LOT 18 .57.63° S. LOTTERING TO STATE WAY TO THE STATE MASS. 15' SETBACK 184.94' (FIELD) 185.00' (PLAT) 5.67 43 54 W. 5.67 30'59'V. LOT 17

NOTE: ALL PROPERTY CORNERS AS SHOWN HEREON ARE IDENTIFIED TO BE BAILEY, BISHOP & LANE, L.B. # 6685.

CERTIFIED TO

FREDERICK L. KINGERY
DANA B. KINGERY
CARTUS HOME LOANS
CENSTAR TITLE INSURANCE COMPANY
FLORIDA RELOCATION CLOSING SERVICES

FIELD BOOK: 260 PAGE(S): 71


SURVEYOR'S CERTIFICATIO

I HEREBY CERTIFY THAT THIS SURVEY WAS MADE UNDER MY RE-TECHNICAL STANDARDS AS SET FORTH BY THE FLORIDA BOARD I IN CHAPTER 61G17-6, FLORIDA ADMINISTRATIVE CODE, PURSUANT

01/02/07 FIELD SURVEY DATE 01/02/07 DRAVING DATE

NOTE: UNLESS IT BEARS THE SIGNATURE AND THE DRIGINAL RAISED MAPPER THIS DRAWING, SKETCH, PLAT OR MAP IS FOR INFORMATION

BOUNDARY SURVEY IN SECTION 3, TOWNSHIP 4 SOUTH, COLUMBIA COUNTY, FLORIDA. RANGE 16 EAST,

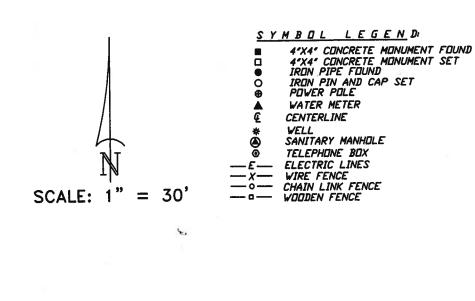

LOT 18 OF 'LAUREL LAKE' AS PER PLAT THEREOF RECORDED IN PLAT BOOK 7, PAGES 9 & 10 OF THE PUBLIC RECORDS OF COLUMBIA COUNTY, FLORIDA.

SURVEYOR'S NOTES

BOUNDARY BASED ON MONUMENTATION FOUND IN ACCORDANCE WITH THE RETRACEMENT OF

BOUNDARY BASED ON MUNUMENTATION FOUND IN ACCURDANCE WITH THE RETRACEMENT OF THE ORIGINAL SURVEY FOR SAID PLAT OF RECORD.


BEARINGS ARE BASED ON SAID PLAT OF RECORD.

THIS PARCEL IS IN ZONE 'X' AND IS DETERMINED TO BE OUTSIDE THE 500 YEAR FLOOD PLAIN AS PER FLOOD RATE MAP, DATED 6 JANUARY, 1988 COMMUNITY PANEL NUMBER 120070 0175 B. HOWEVER, THE FLOOD INSURANCE RATE MAPS ARE SUBJECT TO CHANGE. THE IMPROVEMENTS, IF ANY, INDICATED ON THIS SURVEY DRAWING ARE AS LOCATED ON DATE OF FIELD SURVEY AS SHOWN HEREON.

IF THEY EXIST, NO UNDERGROUND ENCROACHMENTS AND/OR UTILITIES WERE LOCATED FOR THIS SURVEY EXCEPT AS SHOWN HEREON.
THIS SURVEY WAS COMPLETED WITHOUT THE BENEFIT OF A TITLE COMMITMENT OR A TITLE

: CHARGE AND HEETS THE HINDHUN SIDNAL SURVEYORS AND MAPPERS TON 472.027, FLORIDA STATUTES.

P.R.M. 3

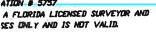



LAND SURVEYORS AND MAPPERS

830 WEST DUVAL STREET LAKE CITY, FLORIDA 32055 (386)752-7163 FAX (386)752-5573

WORK ORDER # L-18045

DO KIM & ASSOCIATES, LLC CONSULTING STRUCTURAL ENGINEERS

January 30, 2007

RE: Extension Request for Master Set Screen Enclosure Plans for Florida Pool Enclosures, Inc.

Dear Building Official:

I respectfully request that you extend the Master Set Filing until July 31, 2007 or until notified otherwise with your building department.


As you are aware, the Florida Board of Professional Engineers (FBPE) is currently reviewing the practice of Master set filing of aluminum structures. Their current position is that the use of master set filing of aluminum structures is still valid. The FBPE is continuing to look into this matter and a potentially new practice rule governing the design of aluminum structures is currently undergoing rule making. Sometime in 2007, the FBPE should provide better guidelines as to the continuing use of master set filing. Therefore, I request that these plans already filed for use as a master set plan for Florida Pool Enclosures, Inc. be valid until July 31, 2007, or until otherwise notified. Thank you again for your assistance.

If you or any member of your staff has any questions, please feel free to contact me.

Sincerely,


Do Kim, P.E. (FL #49497)


FILE COPY

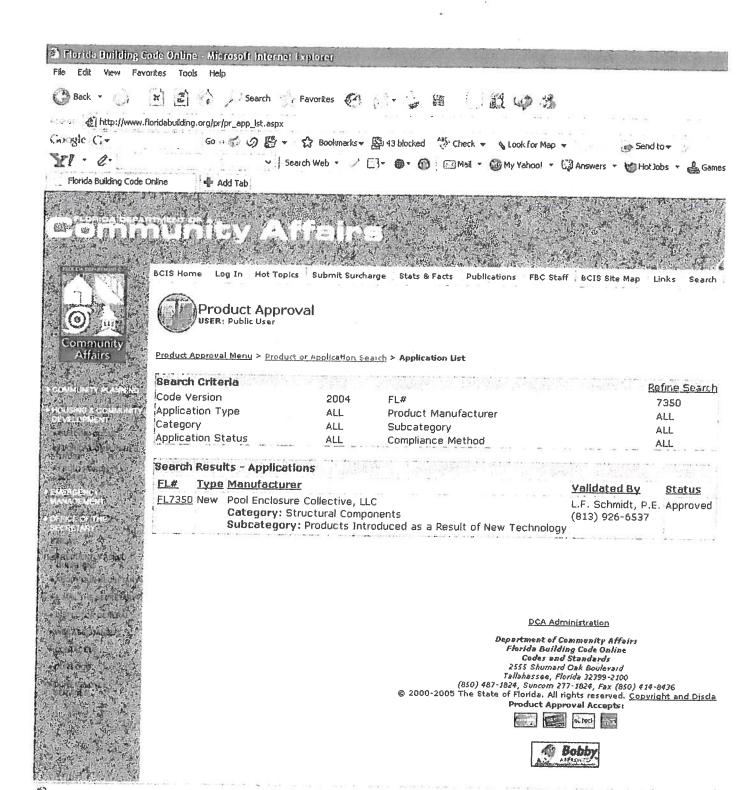



POOL ENGLOSURE COLLECTIVE, ררם

P.O. BOX 10039, TAMPA, FL PH. (813)857-9955 33679

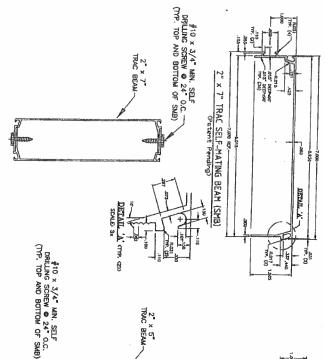

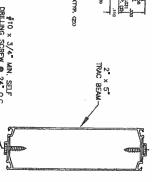

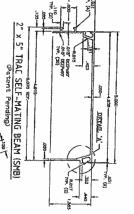

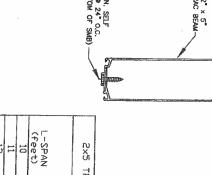

25	₽4	ಬ್ಬ	25	21	20	19	18	17	16	15	14	13.67	13	12	11	10	(feet)	CXC IXEC
417.3	450.4	483.6	516.7	549.9	583.0	616.2	649.3	682.4	715.6	748.7	781.9	792.8	837.4	903.9	970.5	21	ALLOWABLE	(Patent Pending)
4.31"												1.49"				0.68"	SPECIMEN DEFL. AT ALLOW. LOAD P (inches)	NG BEAM

_	_	т-		_		_		_	-	_	T-	1			_	_	_	_	_	_	, .				_			-	_		·		
40	39	38	37	36	ဒ္ဌ	34	33	သည	31	30	29	85 82	27	95	25	24	23	22	21	20	19	18	17	16	15	14	13	27	11	10	(feet)	1	2×7 TR
378.7	388.2	397.7	407.2	416.7	426.2	435.7	445.2	454.6	464.1	473.6	483.1	492.6	502.1	511.6	521.1	579.0	637.0	695.0	753.0	811.0	869.0	927.0	984.9	1042.9	1100.9	1158.9	1216.9	1274.9	1332.9	1390.9	LOAD-P (lbs)		RAC SELF-MATI
6.15"															2.40"						/							/		7	ALTEW: I		TING BEAM

	SHEET 1 OF 1	FL-1114	DRAMING NO.:	CHK BY: WWI	DWG. BY: AEM	SCALE: N.T.S.	DATE: 08-04-C	1	08/11/06	REVISED	LOAD	CHAR	- -
1	Ĺ	14		₹	Ď	S	E I	1	08/11/06	REVISED	LOAD	CHAR	r
1	-	ĺ	- 1	-	-		8	NO.	DATE				
Į		L	_								REV	SIONS	3
•	D 2	006	R	.w.	BL	IILD	ING	CON	BULTANTE	INC.			

4

-	PRODUCT:	(
	2x5 TRAC SELF—MATING BEAM 2x7 TRAC SELF—MATING BEAM	
/WH	PART OR ASSEMBLY: SCREEN ENCLOSURE COMPONENT	


Currents Prepared By:


R BUILDING CONSULTANTS, INC.
P.O. Box 250 Volrico FL 33595
Phone No.: B13.859.9197

Florida Board of Professional Engineers
Cartificate Of Authorizating No. 9813

Wendell W. Heney, P.E. No. 54158 Prepared By:

HOST STRUTURE (NEW OR EXISTING) PURLINS (TYP.) SOF WAT (JA) ALL SIDE WALL COLUMNS/POSTS SHALL BE TRAC BEAM SMB (FL -PRODUCT APPROVAL # 7350) CHAIR RAIL (TYP.) ALL PRIMARY ROOF BEAMS
SHALL BE TRAC BEAM SMB (FL
PRODUCT APPROVAL # 7350) 'ROOF DIAGONAL BRACING (TYP.) SEE GENERAL NOTE 14: NOTE: Sketch is only a representation of a Dome Style Enclosure. Contractor shall provide detailed layout drawings. TYPICAL DOME-ROOF "K" BRACING (OPTIONAL) FRONT WALL (TYP.) SEE SON PORIN ALL PRIMARY COLUMNS/POSTS SHALL BE TRAC BEAM SMB (FL PRODUCT APPROVAL # 7350) CABLE BRACING (TYP.) COLUMN /POST HEIGHT (TYP.) SSOCIATES, LLC CW 26887
3600 HENDERSON BLVD., SUITE 106
Tampa, FL 33684 Drawing No. - 060905 3300 Henderson Blvd., Suite 106 Tampa, FL 33609 Tel: (813) 874-5900 Fax: (813) 874-5959 CHECKED BY: \triangleright \triangleright \triangleright DO KIM CLIENT: Florida Pool Enclosures, INC CONSULTING STRUCTURAL ENGINEERS 9/05 SHEET 1 OF 7 **DESCRIPTION:** ISSUED Description Screen Enclosure Details DYK
DYK
AS SHOWN
9/05/06

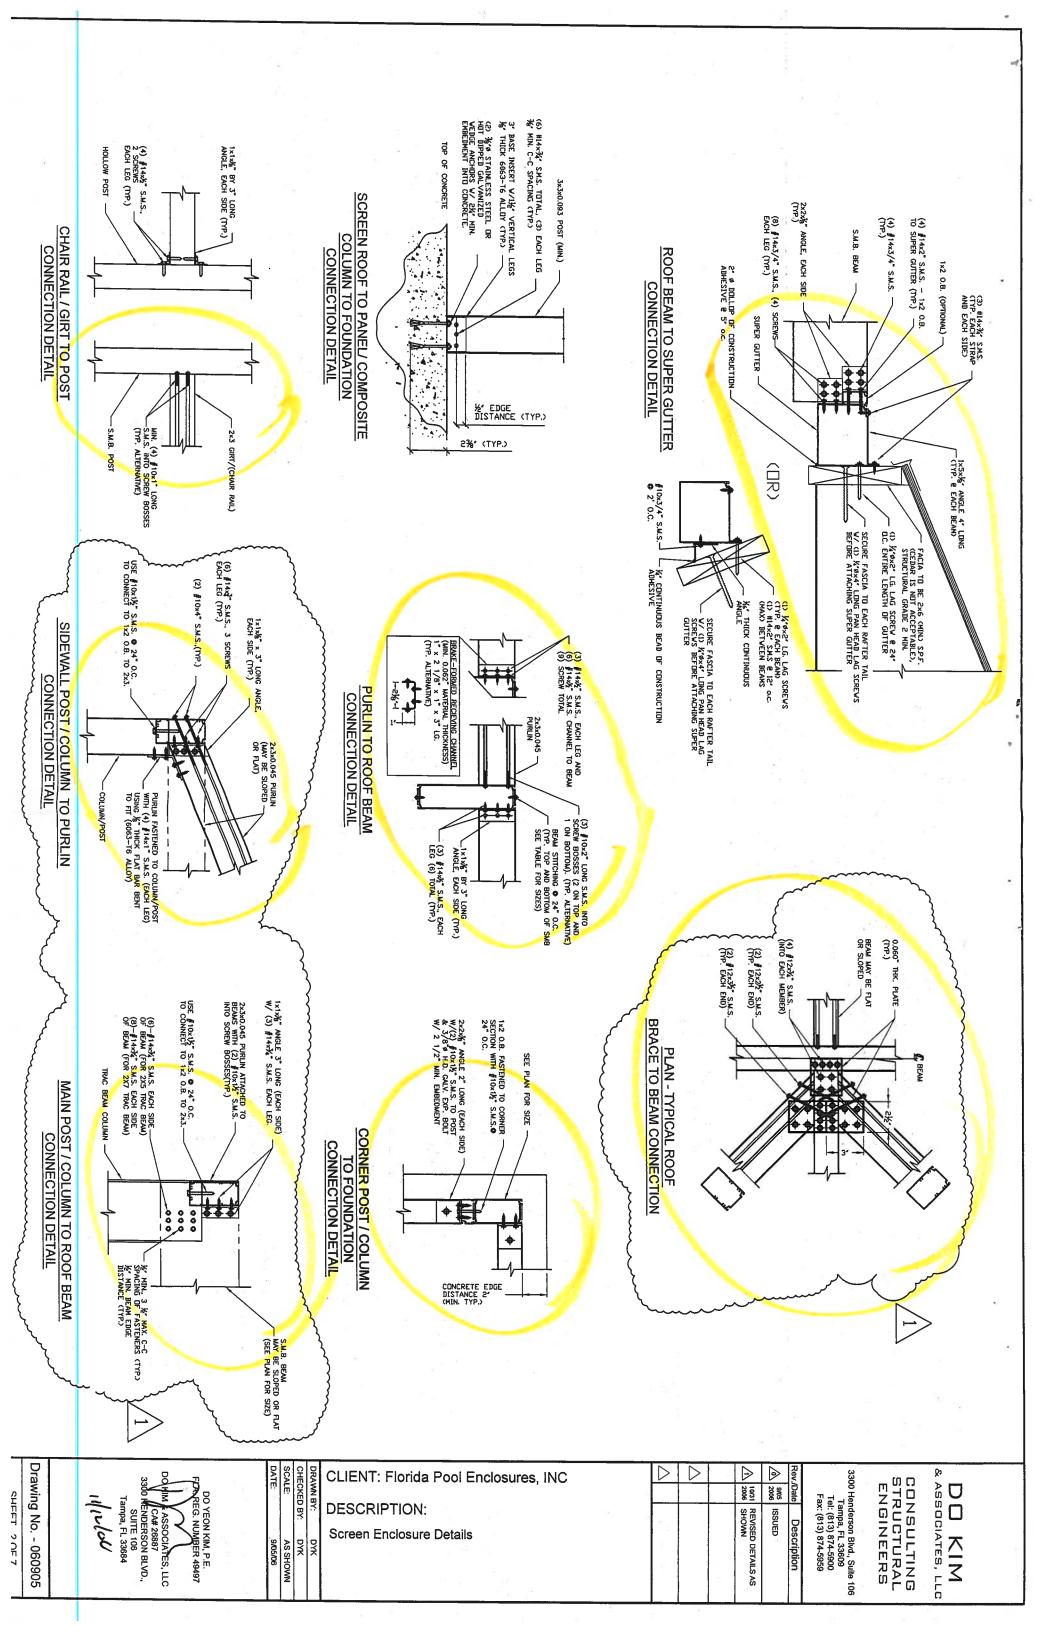

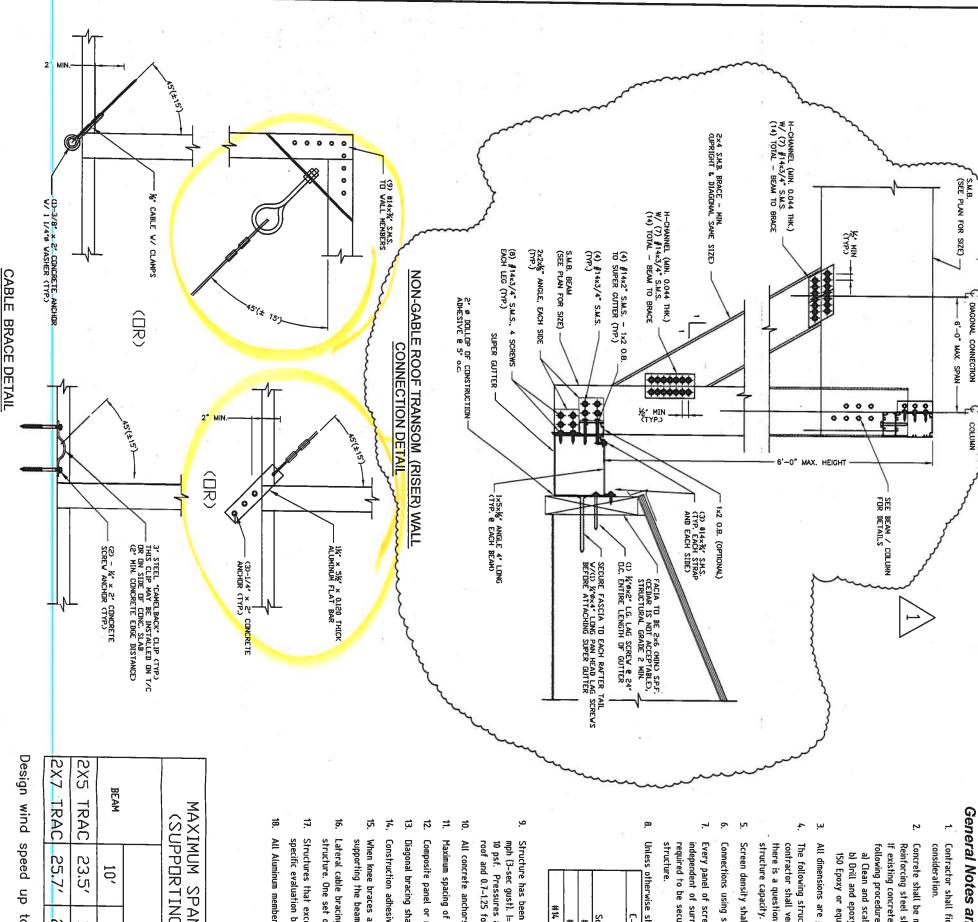

General Notes and Specifications:

- Contractor shall field verify all dimensions before construction and shall notify engineer of discrepancies for immediate
- Concrete shall be minimum 28 day compressive strength of f'c=2500 psi, and be in accordance with the requirements of ACI 318. Reinforcing steel shall have a min. yield strength of 40,000 psi (grade 40) and be provided with cover in accordance with ACI 318. If existing concrete slabs/footings are deemed satisfactory, it may be incorporated into new slab/footing by observing the

& ASSOCIATES, LLC

DO KIM

CONSULTING STRUCTURAL

ENGINEERS

following procedure: a) Clean and scabble all connecting edges.
b) Drill and epoxy embed #5 reinforcing placed @ 12" O.C. mid depth. The rebar should be embedded a min. of 7" (using Hilti HY

All dimensions are provided by contractor, DO Kim & Associates, LLC have made interpretations where necessary.

- 150 Epoxy or equal approved), leaving 24" exposed to be incorporated into new slab/footing.
- The following structures are designed to be attached to block and wood frame structures of adequate structural capacity. The contractor shall verify that the host structure is in good condition and of sufficient strength to hold the proposed addition. If there is a question about the host structure, the owner (at his own expense) shall hire an architect or engineer to verify host

3300 Henderson Blvd., Suite 106 Tampa, FL 33609 Tel: (813) 874-5900 Fax: (813) 874-5959

- Screen density shall be a maximum of 20×20 mesh.
- Connections using screw bosses shall have minimum (4)-#10x1" per connection unless shown otherwise.

D

2006

REVISED DETAILS AS SHOWN

⋑

9/05 2006

ISSUED

Description

- independent of surrounding panels. This requirement shall required to be secured to rigid diagonal bracing members. Every panel of screen mesh shall be fastened securely in place with spline. shall include purlins and chair/kickplate rails. Screen mesh panels are not sers. Screen mesh is incidental to the structural integrity of the overall Each panel shall be fastened at all sides,
- Unless otherwise shown, screws shall have minimum edge distance and center-to-center distances as shown in this table.

$\overline{}$				
#14 (1/4")	#12	#10	Screw	C-1022 Low Cart
0.250	0.219	0.188	Nominal Screw Diameter (in)	C-1022 Low Carbon Steel SMS & Self-Drilling (TEK) Screws (Industry Standard Screws)
2"	٠٠/١	5/ "	Minimum Edge Distance	ng (TEK) Screws (Industry :
5/2	»/ «	34.	Minimum Center to Center Distance	Standard Screws)

- Structure has been designed to meet the 2004 FBC with 2006 supplements. Project is sited where the basic wind speed is 120 mph (3-sec gust). I=0.77 for screen enclosures. Exposure B. Design wind pressures are from 2004 FBC. Minimum design pressure is 10 psf. Pressures are based on wind tunnel testing with main wind force resisting system coefficient, GCp, of +/-0.25 for screen roof and 0.7-1.25 for walls.
- All concrete anchors shall be Simpson Strong-Tie Wedge All Anchors or Titian Screws or approved equal.
- Maximum spacing of Purlins shall be less than 8'-0" o.c. Maximum spacing of Chair Rails (Girts) shall be less than 9'-0"
- Composite panel or riser panel metal shall be of aluminum alloy 3105-H15 or 3105-H25.
- Diagonal bracing shall be installed on all roof screen panels that have at least one side adjacent to an exterior screen wall.

CLIENT: Florida Pool Enclosures, INC

- Construction adhesive shall meet ASTM C-557. MIN shear strength @ 7 days = 425 P.S.I.
- supporting the beam. When knee braces are utilized at uprights and beams, beam spans shown in tables are from the interior side of the knee brace
- Structures that exceed 38 feet of beam span or heights exceeding 25 feet or are located in Exposure C shall require site Laferal cable bracing shall be provided at each screened wall parallel to host structure, unless it is directly attached to host structure. One set of cable braces shall be provided for each 500 sf of screened wall area that the wind load is being applied.
- All Aluminum members shall be 6063-T6 Alloy unless otherwise noted. Trac Beams shall be 6005-T5 Alloy. specific evaluation by the engineer of record.

CHECKED BY:

9/05/06 Ŋ AS SHOWN

DESCRIPTION:

Screen Enclosure Details

BEAM		US)	MAXI
10′		PPORTI	MIM ND
15′	TR	NG SCR	ANO FI
20′	TRIBUTARY WIDTH	EEN RO	
25′	ЭΤΗ	(SUPPORTING SCREEN ROOF ONLY)	MAXIMIM SPANS FIR CARRIER REAMS
30′		3	VM/

֓֞֜֜֜֜֜֜֜֜֓֓֓֓֓֓֓֓֓֓֓֓֓֓֓֓֓֓֓֓֓֓֡֓֜֜֜֓֓֓֓֡֓֜֜֜֜֓֡֓֜֜֓֡֓֜֜֜֡֓֡֓֜֜֜֡֡֓֜֜֜֜֡֡֜֜֜֡֡֡֡֜֜֜֜֜֜	`		Stitching
00		Beam Size	Screw @
=			24" o.c.
25′	30′	2" x 4" x 0.046 x 0.100	#8 x ½"
1		2" x 5" x 0.050 x 0.116	#8 x 1/3"
15.0′	13.5	2" x 6" x 0.050 x 0.120	#10 x %"
		2" x 7" x 0.055 x 0.120	#10 x %"
18.1′	16.6′	2" x 8" x 0.072 x 0.224	#12 x X"
		2" x 9" x 0.072 x 0.224	#12 x %"
iure B		2" x 9" x 0.082 x 0.306	#14 x %"
(2" × 10" × 0.092 × 0.389 #14 × ¾"	#14 x ¾"

2	Ŋ	2	2	2	2	2					ıœ
2" x 9" x 0.082 x 0.306	2" x 9" x 0.072 x 0.224	2" x 8" x 0.072 x 0.224	2" x 7" x 0.055 x 0.120	2" x 6" x 0.050 x 0.120	2" x 5" x 0.050 x 0.116	2" x 4" x 0.046 x 0.100				S.M.B.'s (NOT FOR TRAC BEAMS)	Beam Stitching Screw for all Legacy
×	×	×	" ×	×	×	×		Be		S	Ť.
000	0.0	0.0	0.0	0.0	0.0	0.0		Beam Size		S	hin
×	72 ×	2 ×	55	50	50 >	46)		jize			25
0.3	0.2	0.2	0.1	0.1	ô	× 0.				×	rew
90	24	24	20	20	ᇙ	100				RA	for
#14 x %"	#	#	#	#	#	#	2	S	S.	照	all.
×	#12 x %"	#12 x %"	#10 x %"	#10 x %"	#8 × 1/5"	#8 × ½"	24" o.c.	Screw @	Beam Stitching	<u>₩</u>	Le
3/,"	1,7%	×	×	*	3,	2,	ΞĔ	e	ji a	<u> </u>	асу
		Т				_				_	1
				÷						15	
Γ	_	L		ŧ						//5	9
				ŧ	•	330	- B			/5	(6)
				÷	Tai	3300 HE	₩ K	_	→ DO		
				#2	Tampa	SUI SUI	DD KM & AS		DO YEC		
			[1]/		Tampa, FL	SUITE SUITE	CA#26	3	DO YEON K		
			[1]/20	1 1 1	Tampa, FL 336	SUITE 106	CA#26887		DO YEON KIM,		
			[1]	1 101	Tampa, FL 33684	SUITE 106	CA#16887	2	DO YEON KIM, P.E		
			[1]	1101	Tampa, FL 33684	SUITE 106	CA#46887		DO YEON KIM, P.E.		8

Drawing No. - 060905

ö

120


mph. Exposure

22.3′ 19.8′


20.1'


17.0′

CHEET 2 OF 7

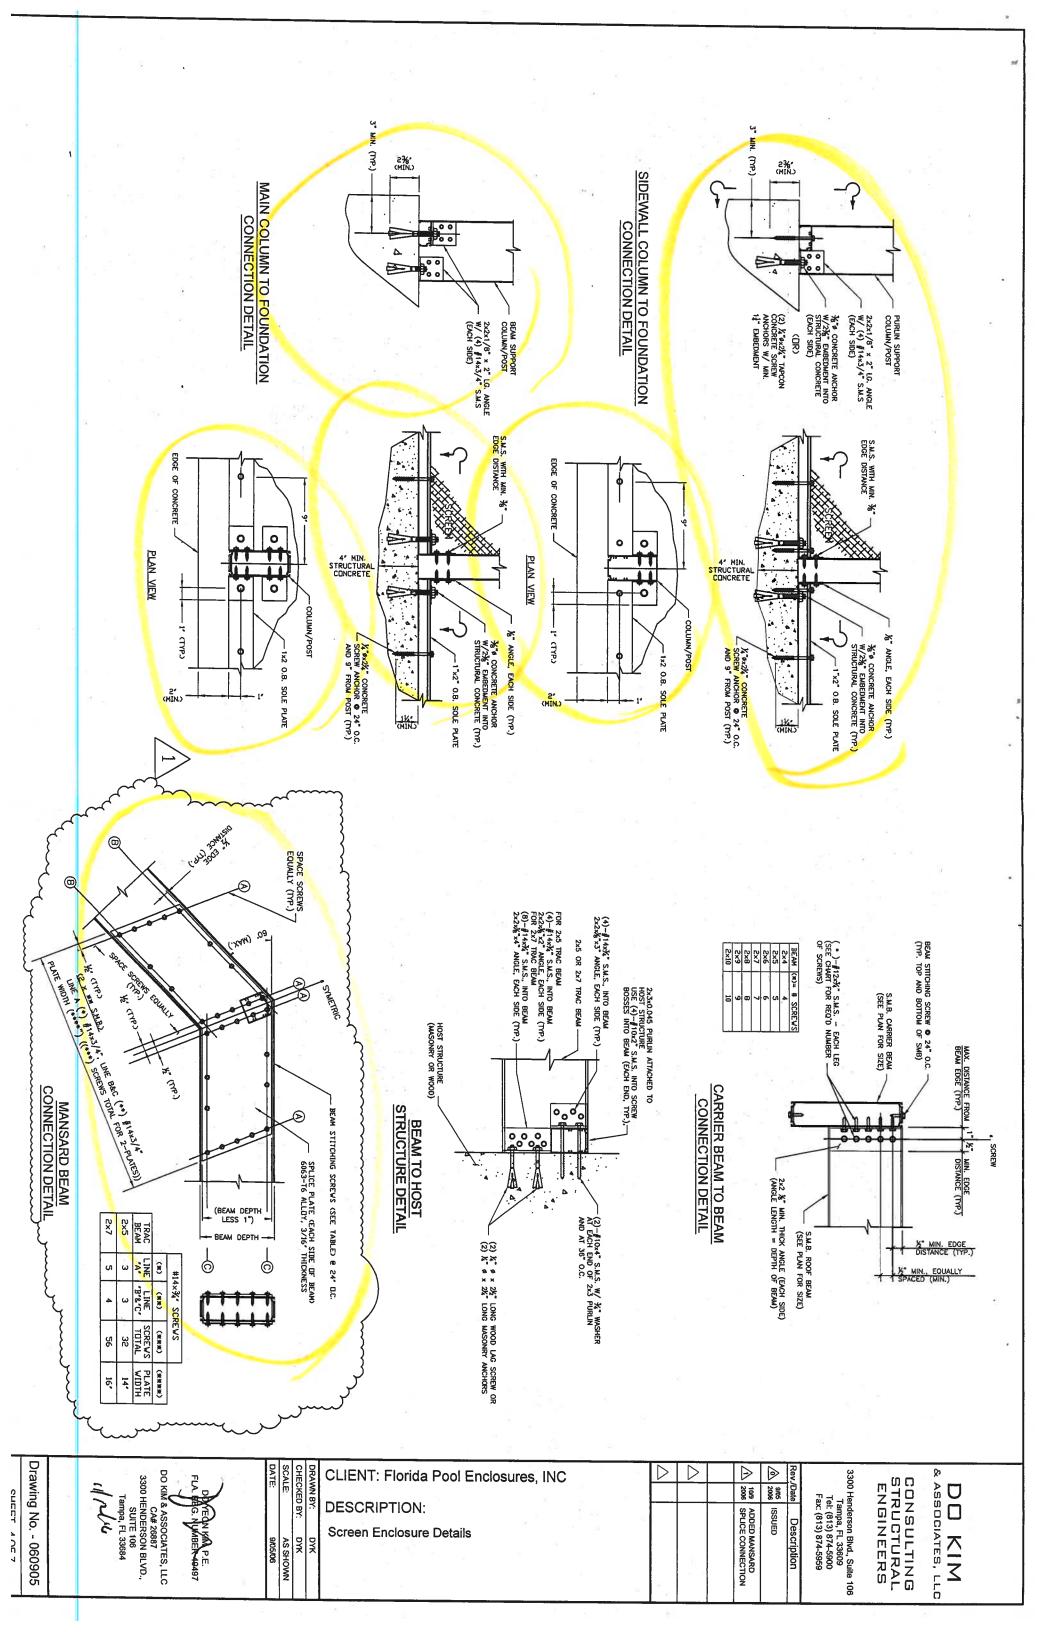

Trac Beam (FL State Product Approval #7350) Pool Enclosure Collective, LLC

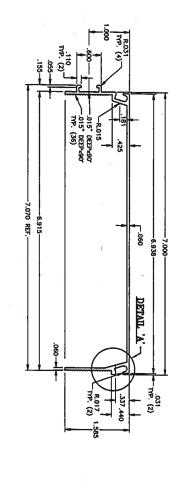

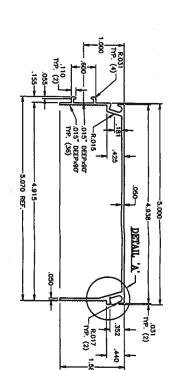

BEAM TO BEAM SPACING (ft)

110 mph

120 mph

130

죵

140

₹

150 mph

CONSULTING STRUCTURAL ENGINEERS

ი გxე

TRAC BEAM

RULF

BEAM

SPAN)

DO KIM

6′ I.C.

5′ O.C.

ά

П.C. П.C.

52, 52, 52, 52,

52, 52, 55, 52

22,94′

21.36′

20.35

Rev./Date Description

23.51′

22.16′

21.33′

55, വ്


23.06′

22,12′

3300 Henderson Blvd., Suite 106 Tampa, FL 33609 Tel: (813) 874-5900 Fax: (813) 874-5959


24.12′

23,27′

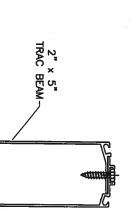

#10 x 3/4" MIN. SELF
DRILLING SCREW @ 24" O.C. —
(TYP. TOP AND BOTTOM OF SMB)

2" × 7" TRAC BEAM-

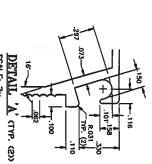

SPACING (ft)

110 mph

120 mph

130 mph

140 mph

150

ď

υ χς

TRAC

BEAM

(COLUMN HEIGHT)

δ

П.C.

7′ O.C.

16,89′ 18.57′

15.00

13.00′

12.15′

11.24′

.C.

15.11′

13.52′

12,28′

11.13′

10.12′

5′ O.C.

20.31′

19.00′ 17.00′


17.01′

15.00′


14.57′

13.07′

12,28′ 13.33′

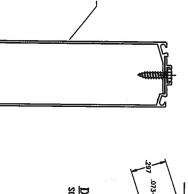

CTYP. (2))

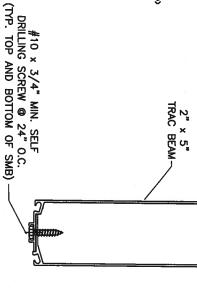

BEAM TO BEAM SPACING (ft)

110 mph

120 mph

130 mph

140 mph

150 mph

2×7

TRAC

BEAM

(ROOF

BEAM

SPAN)

5′ D.C.

37.82′

37.62

34.63′

31.23′

6' O.C.

35.18′

35.01

31.23′

27.37

23.61′ 28.00′

7' O.C.

32.65′

32,43

28.00′

8′ □.C.

30.00′

29,82

24.76′

23.21′ 23,48′

22.61′

23.05′

	2" ×	
	x 5" T	
, ,	TRAC S	

2" x 7" TRAC SELF-MATING BEAM (SMB)

(patent pending)

	×
	5"
(-	TRAC
(patent pending)	SELF
pend	-MAT
ina)	NG.
	BEAM
i	x 5" TRAC SELF-MATING BEAM (SMB)
	_

BEAM TO BEAM SPACING (ft)

110 mph

120 mph

130

ď

140

ďg

150 mph

2×7

TRAC

BEAM

COLUMN

HEIGHT)

5′ D.C.

23.04'

20,53′

19,59′

22.22

21.47 22,42'

19.20′ 20.34′ 21.48′

17.80′

16.68′

19.21′

18.08′

7′ D.C. 6' D.C.

8′ □.C.

20.55′ 21,41′

19,59′ 20.53′

18,08′

16.58′

15.08′

TRAC BEAM Notes:

- Refer to Florida Product Approval #FL7350.
- Drawings are illustrative purposes only.

 Allowable spans tables are based on 2004 Florida Building Code with
 2006 Updates. Wind loads are based on Chapter 20 and Table 2004.4.
- ტ Maximum allowable deflections limits of L/60 L/80 in HVHZ have also been checked. have been checked.


DATE:	SCA	CHE	DRAWN	CLIENT: Florida Pool Enclosures, INC	\triangleright	\triangleright	\triangleright	\triangleright	⋑
m	ΑLE:	CHECKED BY:	WN BY:						9/05 2006
-		BY:	≾	DESCRIPTION:					ISSUED
و	>	D	D	Screen Enclosure Details					E
9/05/06	AS SHOWN	DYK	DYK		:				
	Ň								
	ž								


HENDERSON BLVD., SUITE 106 Tampa, FL 33684 CA# 16887


Drawing No. - 060905


20/2/01

SHEET 5 OF 7

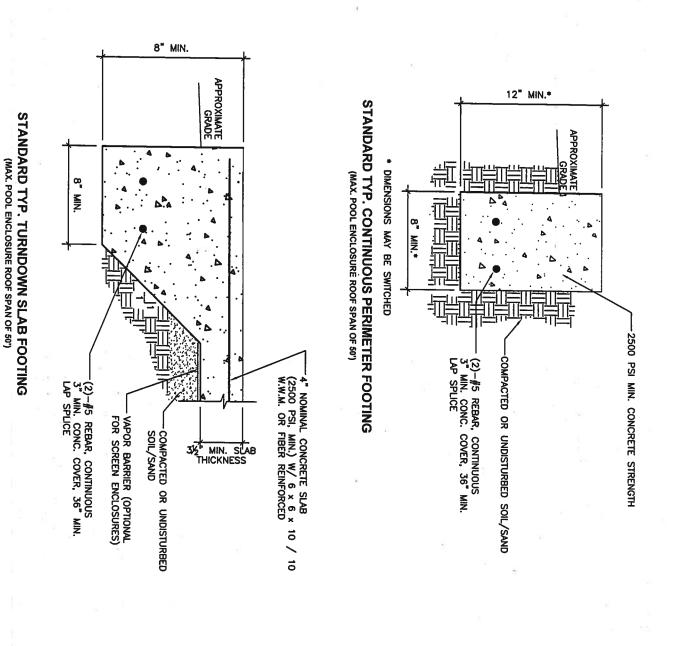

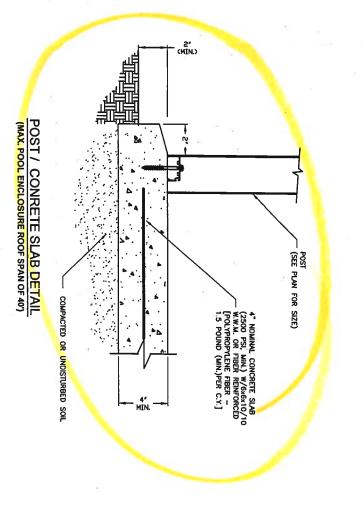

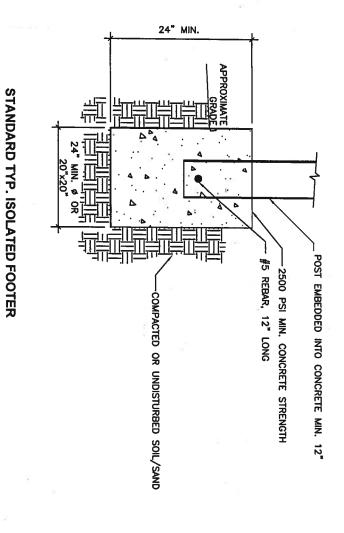

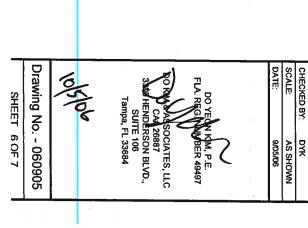

CLIENT: Florida Pool Enclosures, INC


DESCRIPTION:

Screen Enclosure Details

ISSUED

CONSULTING STRUCTURAL ENGINEERS

& ASSOCIATES, LLC

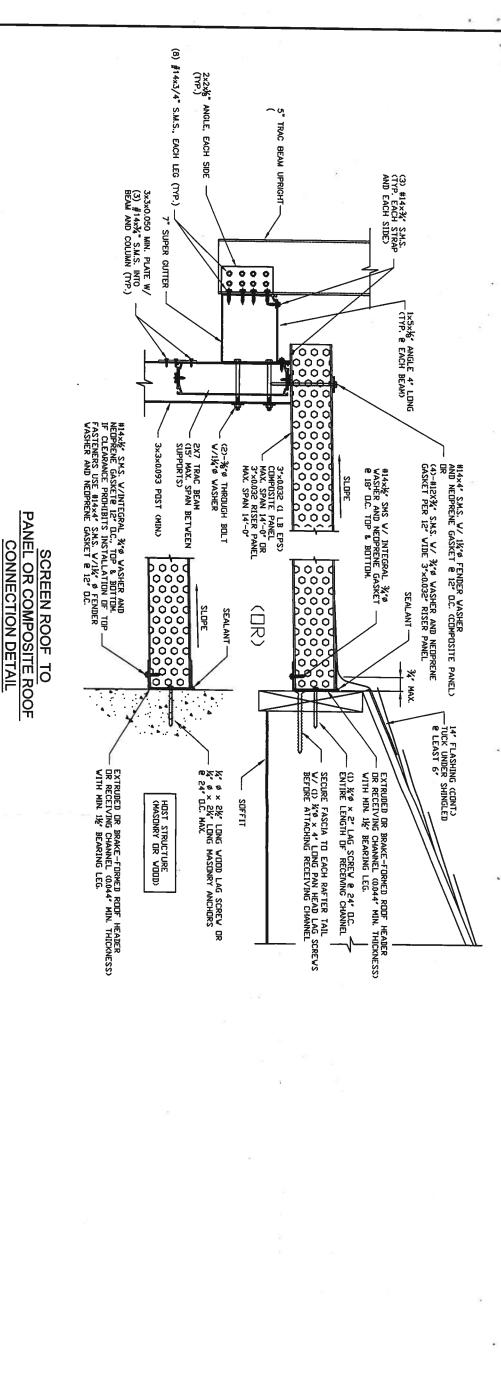

CLIENT: Florida Pool Enclosures, INC **DESCRIPTION:** Screen Enclosure Details

		_			
\triangle	Δ	\triangleright	(a)	Rev.	
			9/05 2006	Rev./Date	=5
.00			ISSUED	Description	

CONSULTING STRUCTURAL ENGINEERS & ASSOCIATES, LLC

SHEET 7 OF 7

Drawing No. - 060905