

STANDARD HEADER SCHEDULE

0'-0" UP TO 6'-0" OPENINGS  
DOUBLE 2x8 No.2 SOUTHERN PINE WITH 1/2" O8B SOLID CONTINUOUS SPACER GLUED AND NAILED WITH 10d x 0.128" x 3" NAIL6 IN 2 ROW6 # 12" O.C. STAGGERED EACH 6IDE WITH 1 - 6IMP6ON M6TA16 TOP AND 1 - 6IMP6ON 6PH4R BOTTOM EACH 6IDE OF OPENING WITH 1 - HEADER 6TUD AND 1 FULL HEIGHT 6TUD6 EACH 6IDE OF OPENING


6'-0" UP TO 9'-0" OPENINGS  
DOUBLE 2x12 No.2 SOUTHERN PINE WITH 1/2" O8B SOLID CONTINUOUS SPACER GLUED AND NAILED WITH 10d x 0.128" x 3" NAIL6 IN 2 ROW6 # 12" O.C. STAGGERED EACH 6IDE WITH 1 - 6IMP6ON M6TA16 TOP AND 2 - 6IMP6ON 6PH4R BOTTOM EACH 6IDE OF OPENING WITH 1 - HEADER 6TUD AND 2 FULL HEIGHT 6TUD6 EACH 6IDE OF OPENING

9'-0" UP TO 16'-0" OPENINGS  
DOUBLE 2x12 No.2 SOUTHERN PINE WITH 1/2" O8B SOLID CONTINUOUS SPACER GLUED AND NAILED WITH 10d x 0.128" x 3" NAIL6 IN 2 ROW6 # 12" O.C. STAGGERED EACH 6IDE WITH 3 - 6IMP6ON M6TA16 EACH 6IDE OF OPENING WITH 2 - HEADER 6TUD6 AND 3 FULL HEIGHT 6TUD6 EACH 6IDE OF OPENING

16'-0" GARAGE DOOR OPENINGS  
2 PLY 1 1/4" x 11 1/8" 2.0E MICROLAMM LVL HEADER GLUED AND NAILED WITH 10d x 0.128" x 3" NAIL6 IN 2 ROW6 # 12" O.C. STAGGERED EACH 6IDE WITH 3 - 6IMP6ON M6TA16 EACH 6IDE OF OPENING WITH 2 - HEADER 6TUD6 AND 3 FULL HEIGHT 6TUD6 EACH 6IDE OF OPENING

WOOD STRUCTURAL NOTES

- TEMPORARY BRACING OF THE STRUCTURE DURING ERECTION, REQUIRED FOR SAFE AND STABLE CONSTRUCTION, SHALL BE THE SOLE RESPONSIBILITY OF THE CONTRACTOR SO ENGAGED. TEMPORARY & PERMANENT BRACING OF ROOF TRUSSES SHALL BE AS PER THE STANDARD GUIDELINES OF THE "TRUSS PLATE INSTITUTE".
- ALL TRUSSES SHALL BE DESIGNED BY A LICENSED PROFESSIONAL ENGINEER & SHALL BE SIGNED AND SEALED BY SAME. TRUSS DESIGN SHALL INCLUDE PLACEMENT PLANS, TRUSS DETAILS, TRUSS TO TRUSS CONNECTIONS & THE STANDARD SPECIFICATIONS & RECOMMENDATIONS OF INSTALLATION OF THE "TRUSS PLATE INSTITUTE".
- WOOD STUDS IN EXTERIOR WALLS & INTERIOR BEARING WALLS SHALL BE NOT LESS THAN N.2 HEM-FIR OR BETTER.
- CONNECTORS FOR WOOD FRAMING SHALL BE GALVANIZED METAL OR BLACK METAL AS MANUFACTURED OR AS CALLED FOR IN THE PLANS AND BE OF A DESIGN SUITABLE FOR THE LOADS AND USE INTENDED. REFER TO THE JOINT REINFORCEMENT SCHEDULE FOR PRINCIPLE CONNECTIONS.

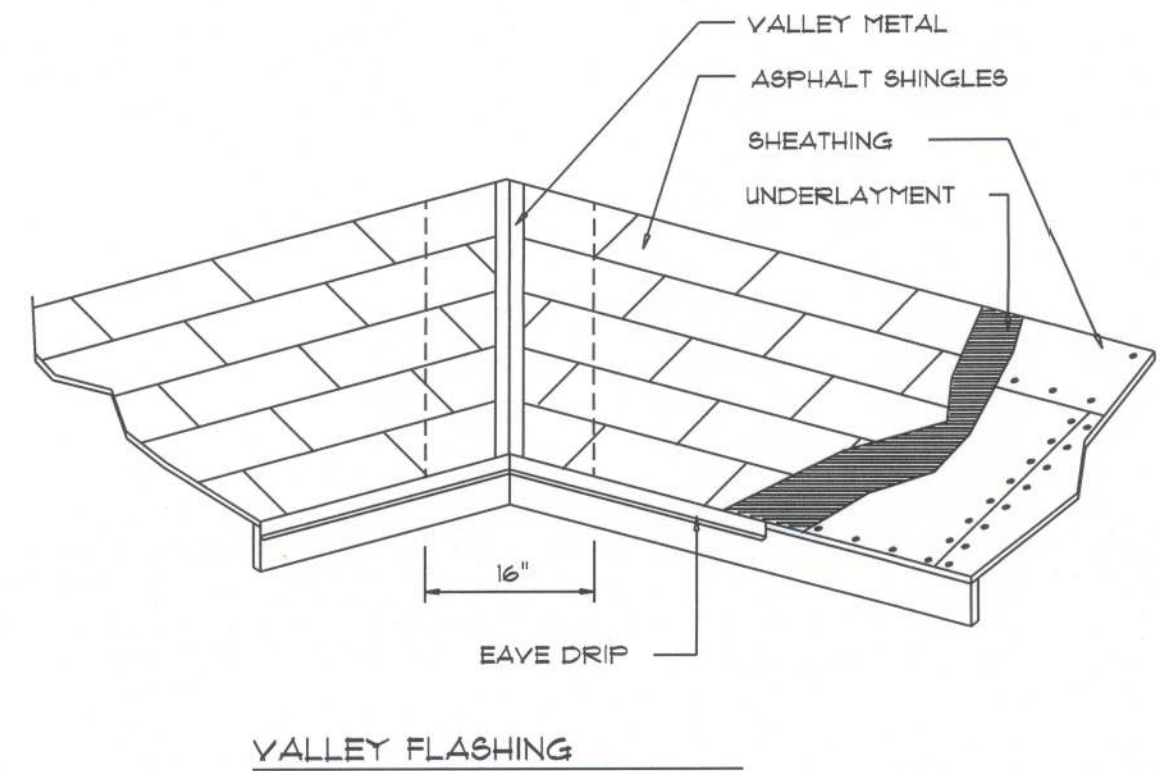

ROOFING METALS for FLASHING/ROOFING MINIMUM THICKNESS REQUIREMENTS			
MATERIAL	MINIMUM THICKNESS (in)	GAGE	WEIGHT (OZ.)
COPPER			16
ALUMINUM	0.024		
STAINLESS STEEL		28	
GALVANIZED STEEL	0.0119	26 (ZINC COATED G90)	
ZINC ALLOY LEAD PAINTED TERNE	0.021		40 20


Roofing/Flashing DETS.

SCALE: NONE

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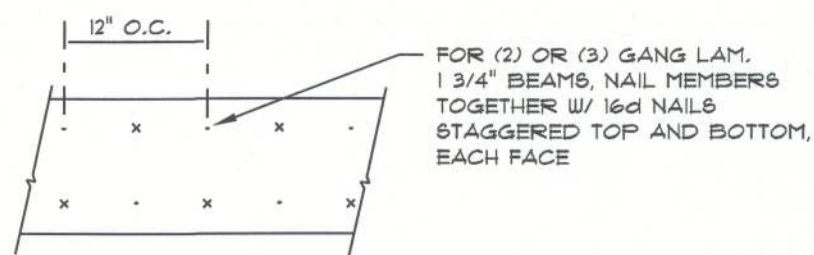
GENERAL TRUSS NOTES:

- TRUSSES SHALL BE DESIGNED BY A LICENSED ENGINEER, AND IN ACCORDANCE WITH THE REQUIREMENTS OF THE "NATIONAL FOREST PRODUCTS ASSOCIATION" MANUAL FOR "STRESS RATED LUMBER AND ITS CONNECTIONS", LATEST ED., ALONG W/ THE "TRUSS PLATE INSTITUTE" SUGGESTED GUIDELINES FOR TEMPORARY AND PERMANENT BRACING, AND HANDLING OF TRUSSES. TRUSS SHOP DRAWINGS SHALL INCLUDE TRUSS DESIGN, PLACEMENT PLANS, DETS. & TRUSS TO TRUSS CONNECTIONS.
- TRUSS SHOP DRAWINGS SHALL BE SIGNED & SEALED BY THE DESIGNING ENGINEER.
- FOLLOWING DEVELOPMENT OF TRUSS SHOP DRAWINGS, ADJUSTMENTS TO THE ANCHOR REQUIREMENTS MAY BE REQUIRED DEPENDING ON THE ENGINEERED GRAVITY AND WIND UPLIFT REQUIREMENTS OF TRUSSES OR GIRDERS. THE CONTRACTOR SHALL MAKE AVAILABLE A COMPLETE SET OF TRUSS SHOP DRAWINGS TO THE ARCHITECT FOR THE PURPOSE OF REVIEW OF LOADS IMPOSED ON THE BALANCE OF THE STRUCTURE. ANY SUCH REQUIRED CHANGE SHALL BE INCORPORATED INTO THE CONSTRUCTION OF THIS STRUCTURE.

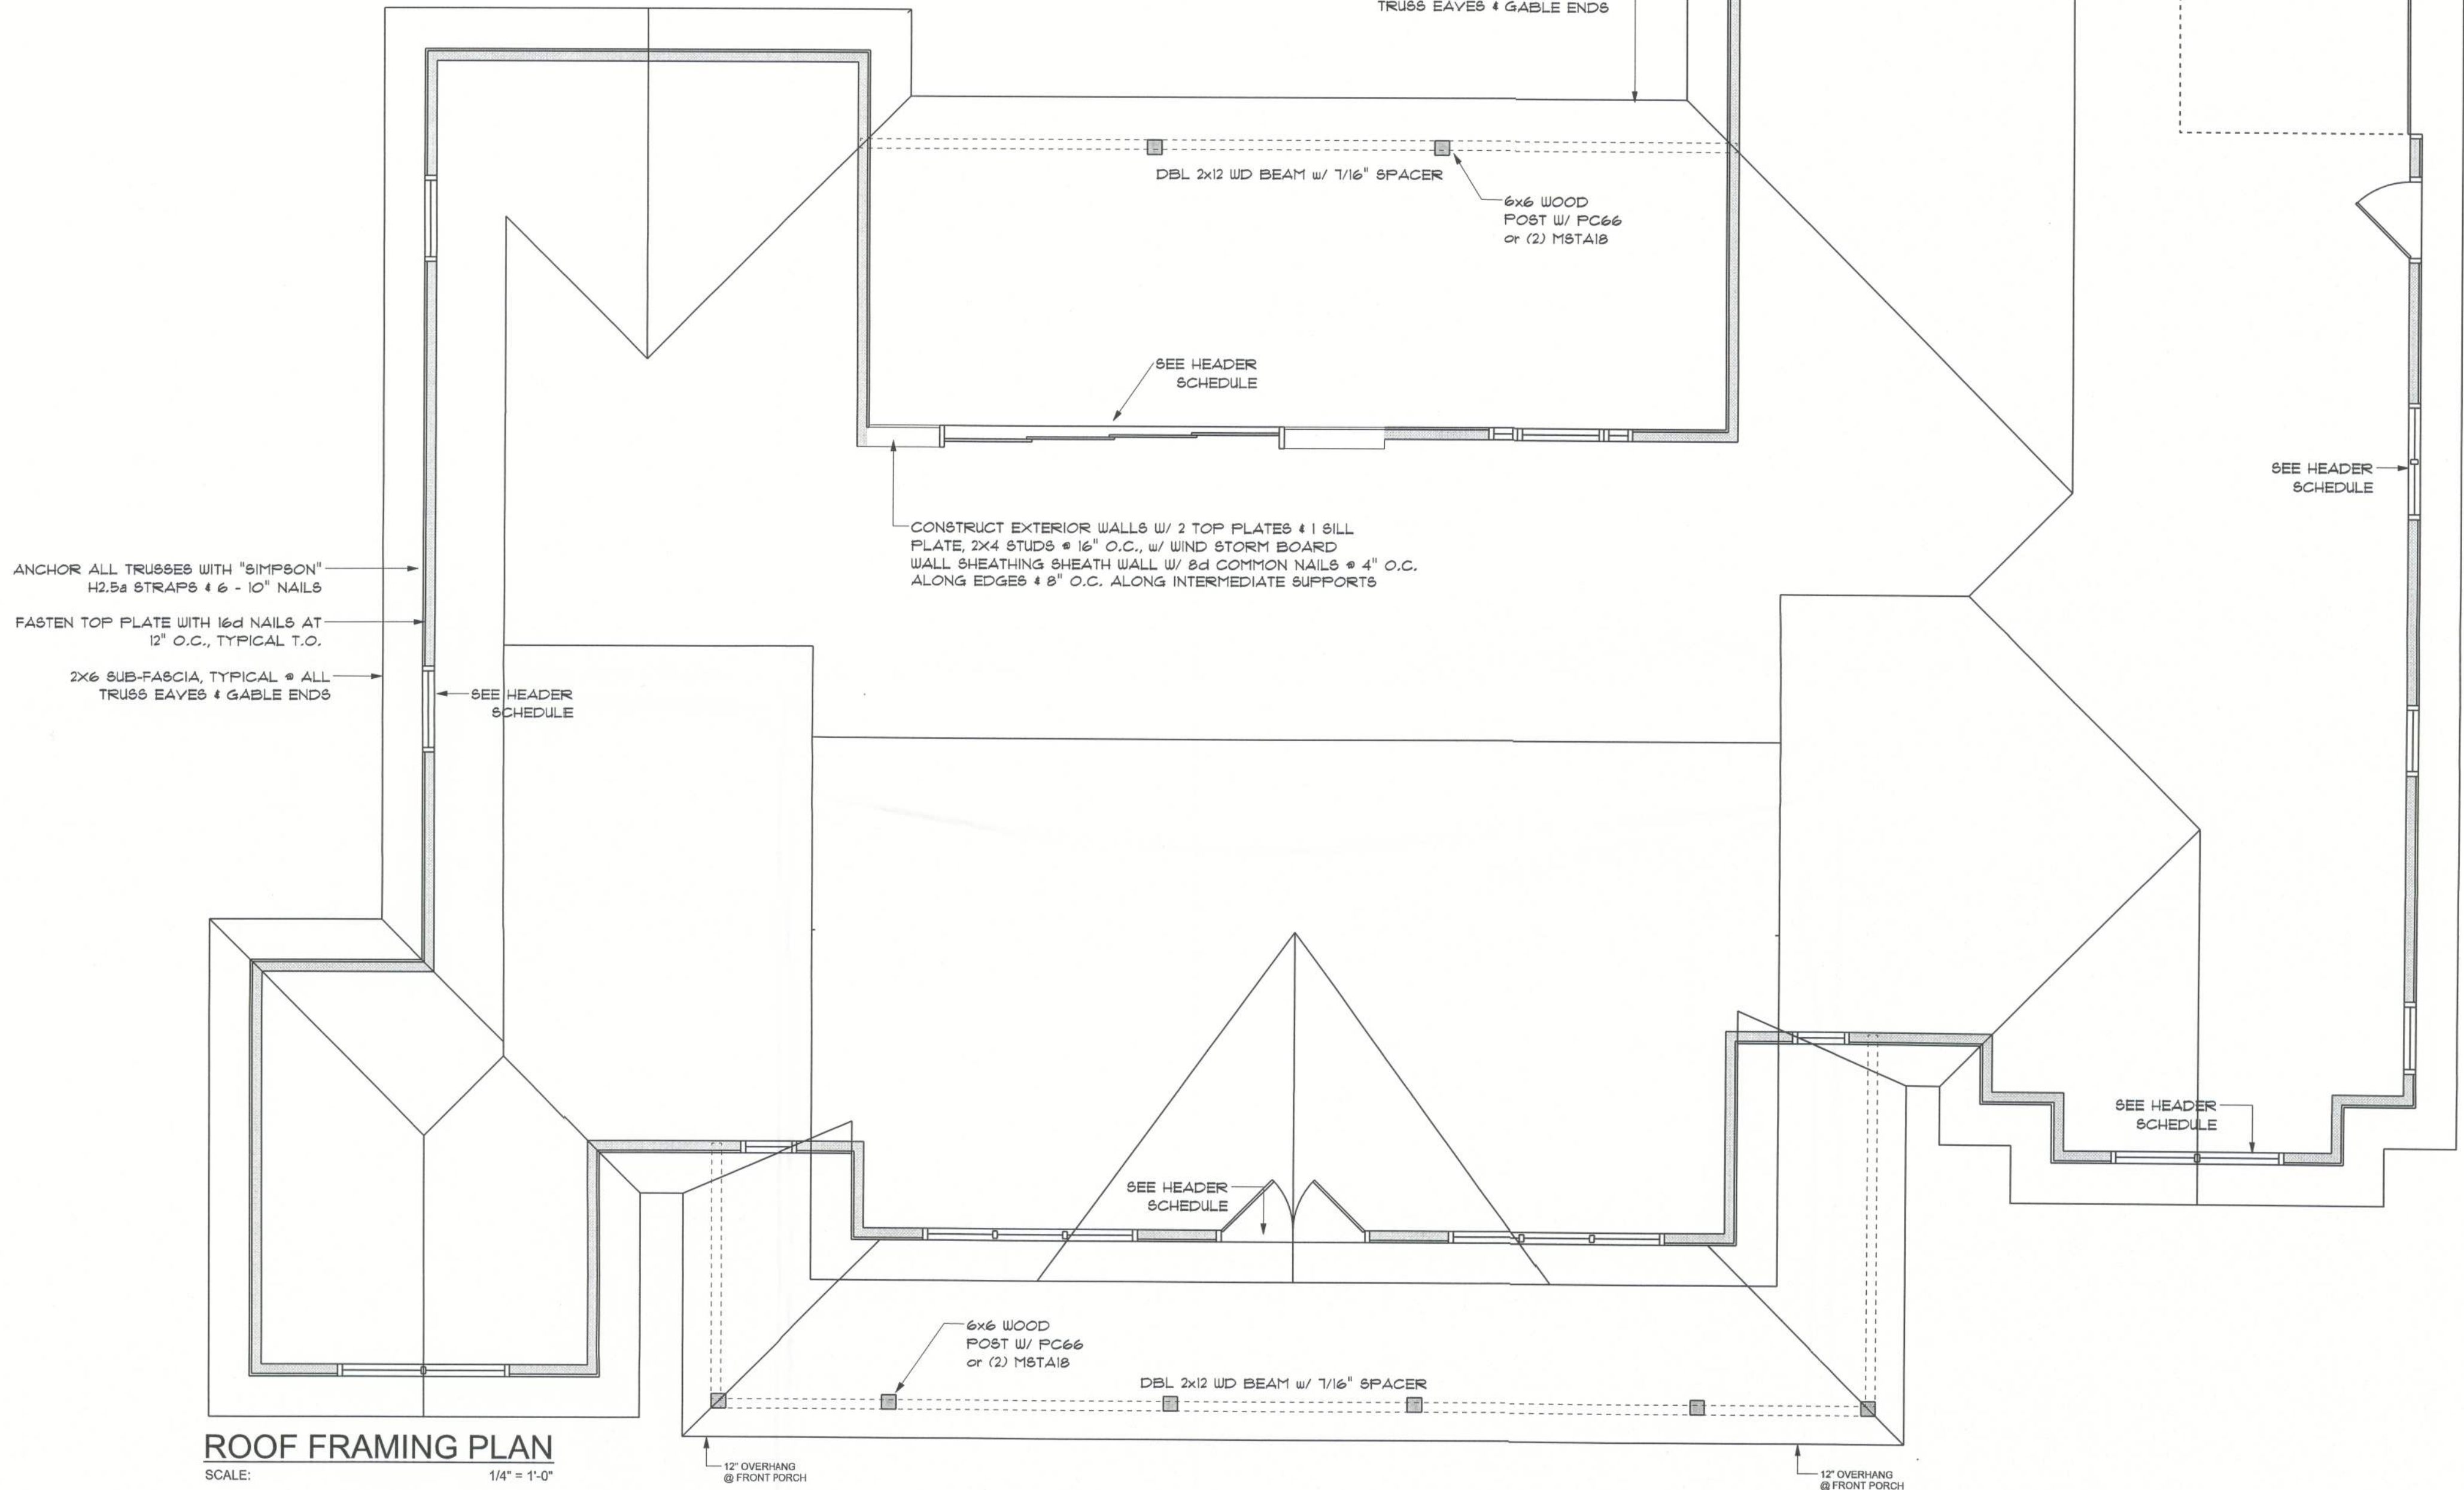


ROOF FRAMING PLAN

SCALE: 1/4" = 1'-0"



MULTIPLE GANG LAM. DETAIL

NOT TO SCALE

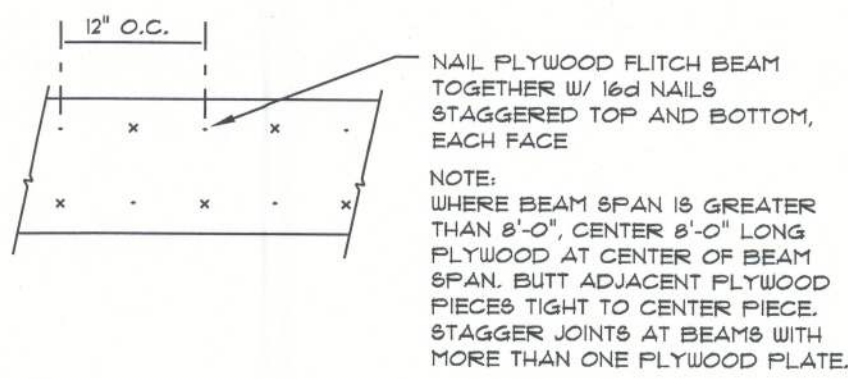

PLYWOOD FLITCH BEAM DETAIL

NOT TO SCALE

ROOF PLAN NOTES

- R-1 SEE ELEVATIONS FOR ROOF PITCH
- R-2 ALL OVERHANGS 18" (12" on gables) UNLESS OTHERWISE NOTED
- R-3 ATTIC VENTILATION NOT REQUIRED ON SPRAY FOAM INSULATED ATTICS
- R-4 SEE EXTERIOR ELEVATIONS AND FLOOR PLANS TO VERIFY PLATE AND HEEL HEIGHTS

NOTE!  
THE DESIGN WIND SPEED FOR THIS PROJECT IS 130 MPH PER FBC 1609 AND LOCAL JURISDICTION REQUIREMENTS

NOTE!  
ANCHOR GIRDER TRUSS(ES) TO HEADER WITH 2 "6IMP6ON" LGT(2, 3 OR 4), ANCHOR HEADER TO KING 6TUD6 W/ 2 "6IMP6ON" 6T2Z EA. END - TYP., T.O.

REVISIONS
Mar. 31st, 2023
April 19th, 2023

CUSTOM HOME FOR:  
**Vaughn Residence**  
COLUMBIA COUNTY, FLORIDA

**NICHOLAS PAUL GEISLER ARCHITECT**  
1768 NW Brown Rd.  
Lake City, FL 32055  
N.C.A.R.B. Certified

SHEET NUMBER  
**S.2**  
OF 4 SHEETS

N. P. GEISLER  
R  
Digitally signed by: N. P. GEISLER  
DN: cn = N. P. GEISLER email =  
ngeisler47@gmail.com C = US O = AR0007005  
OU = N.P. GEISLER  
Date: 2023.09.21 08:16:05 -0500  
AR0007005