
## **HUDSON RESIDENCE**

11.63 kW PV SYSTEM 444 SE HORIZON GLEN, LAKE CITY, FL 32025

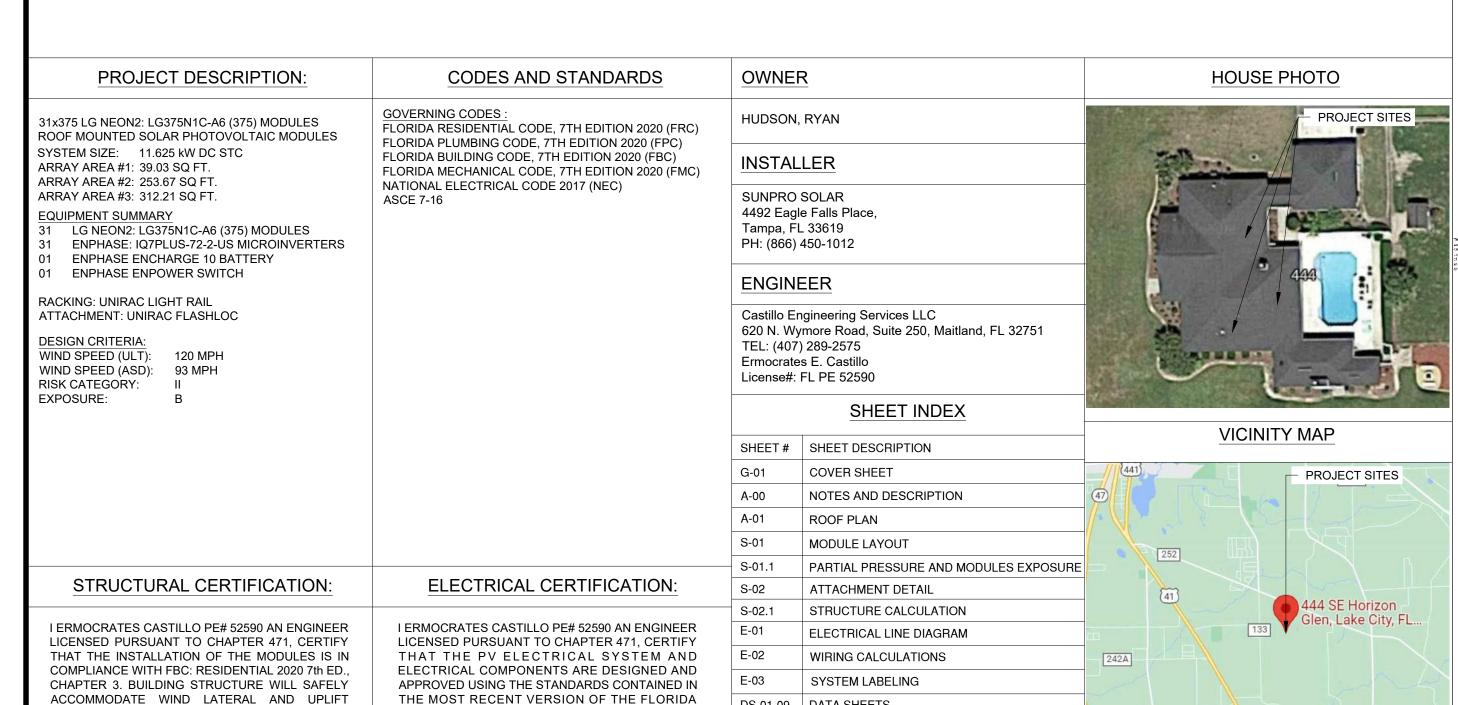

DS-01-09

BUILDING CODE. FBC 107, THE NEC 2017, AND THOSE SET FORTH BY THE FLORIDA SOLAR

ENERGY CENTER CERTIFICATION.

FORCES, AND EQUIPMENT DEAD LOADS.

DATA SHEETS

#### Castillo ( Engineering 🕓 SOLAR DONE RIGHT®

#### **CASTILLO ENGINEERING** SERVICES, LLC

COA # 28345 620 N. WYMORE ROAD, SUITE 250, MAITLAND, FL 32751

TEL: (407) 289-2575 ERMOCRATES E. CASTILLO - FL PE 52590

COPYRIGHTED BY CASTILLO ENGINEERING SERVICES, LLC

REVISIONS						
ESCRIPTION	DATE	REV				

PROJECT INSTALLER



der tax tekn Andron ratif ktyrat kward by Emiren-wa Doubley Phe In Ditta andrait Than Affant Phe In- Japal Bankay, Intrae same The Japal Bankay, Intrae same (doubler) 310 for Strated same

HORIZON GLEN, CITY, FL 32025

444 SE I LAKE (

PROJECT NAME

RESIDENCE

HUDSON

SHEET NAME


**COVER SHEET** 

SHEET SIZE

**ANSIB** 11" X 17"

SHEET NUMBER

G-01

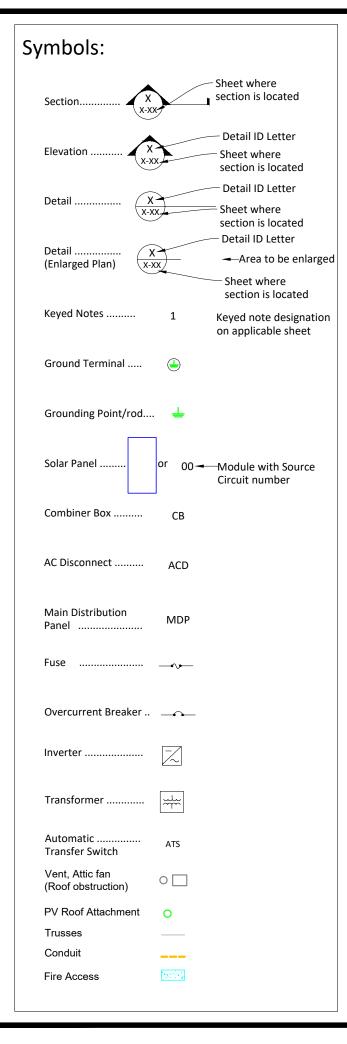

Abbrevia	tions:
AC	Alternating Current
ACD	AC Disconnect
APPROX	Approximate
AWG	American Wire Gauge
BAT	Battery
СВ	Combiner Box
DC	Direct Current
DISC	Disconnect
(E)	Existing
EL	Elevation
EQ	Equal
GP	Generation Panel
JB	Junction Box
MCB	Main Combiner Box
MFR	Manufacturer
MID	Microgrid Interconnect Device
MIN	Minimum
MISC	Miscellaneous
MDP	Main Distribution Panel
(N)	New
NAVD	North American Vertical datum
OCPD	OverCurrent Protection Device
POCC	Point Of Common Coupling
PV	Photovoltaic
SF	Squarefoot/feet
STC	Standard Test Conditions
SD	Soladeck
TBD	To Be Determined
TYP	Typical
UNO	Unless Noted Otherwise
UM	Utility meter
VIF	Verify In Field


Weather Proof

WP

#### **System Description**

This system is a grid-tied, PV system, with PV generation consisting of 31x375 LG NEON2: LG375N1C-A6 (375W) Modules with a combined STC rated dc output power of 11,625W. The modules are connected into 31 Enphase: IQ7PLUS-72-2-US microinverters. The inverter has electronic maximum power point tracking to maximize energy captured by the PV modules. The inverter also has an internal ground fault detection and interruption device that is set to disconnect the array in the event that a ground fault that exceeds one ampere should occur. The inverter has DC and AC disconnect integrated system and labels are provided as required by the National Electrical Code.

When the sun is shining, power from the PV array is fed into the inverter, where it is converted from DC to AC. The inverter output is then used to contribute to the power requirements of the occupancy. If PV power meets the requirements of the loads of the occupancy, any remaining PV power is sold back to the utility. When utility power is available, but PV power is not available, building loads are supplied by the utility.

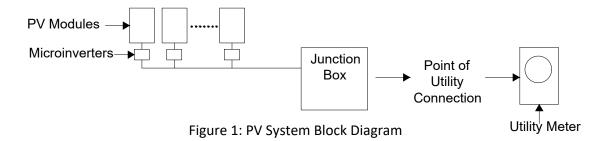

The inverter meets the requirements of IEEE 1547 and UL 1741.


#### **FALL PROTECTION:**

ANCHORAGES USED FOR ATTACHMENT OF PERSONAL FALL ARREST EQUIPMENT MUST BE INDEPENDENT OF ANY ANCHORAGE BEING USED TO SUPPORT OR SUSPEND PLATFORMS, AND CAPABLE OF SUPPORTING AT LEAST 5,000 POUNDS PER EMPLOYEE ATTACHED, OR MUST BE DESIGNED AND USED AS FOLLOWS:

- AS PART OF A COMPLETE PERSONAL FALL ARREST SYSTEM WHICH MAINTAINS A SAFETY FACTOR OF AT LEAST TWO.
- UNDER THE SUPERVISION OF A QUALIFIED PERSON

#### ADDITIONAL INFORMATION

- 29 CFR 1926 SUBPART M, FALL PROTECTION. OSHA STANDARD.
- 1926.502. FALL PROTECTION SYSTEMS CRITERIA AND PRACTICES 1926.502(D)(15)

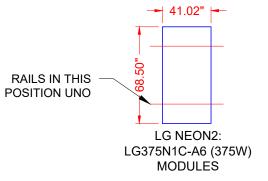

PSF
125
88



DESCRIPTION DATE

PROJECT INSTALLER



PROJECT NAME


RESIDENCE HUDSON

HORIZON GLE CITY, FL 32025

NOTES AND DESCRIPTION


SHEET SIZE ANSI B 11" X 17"

SHEET NUMBER A-00

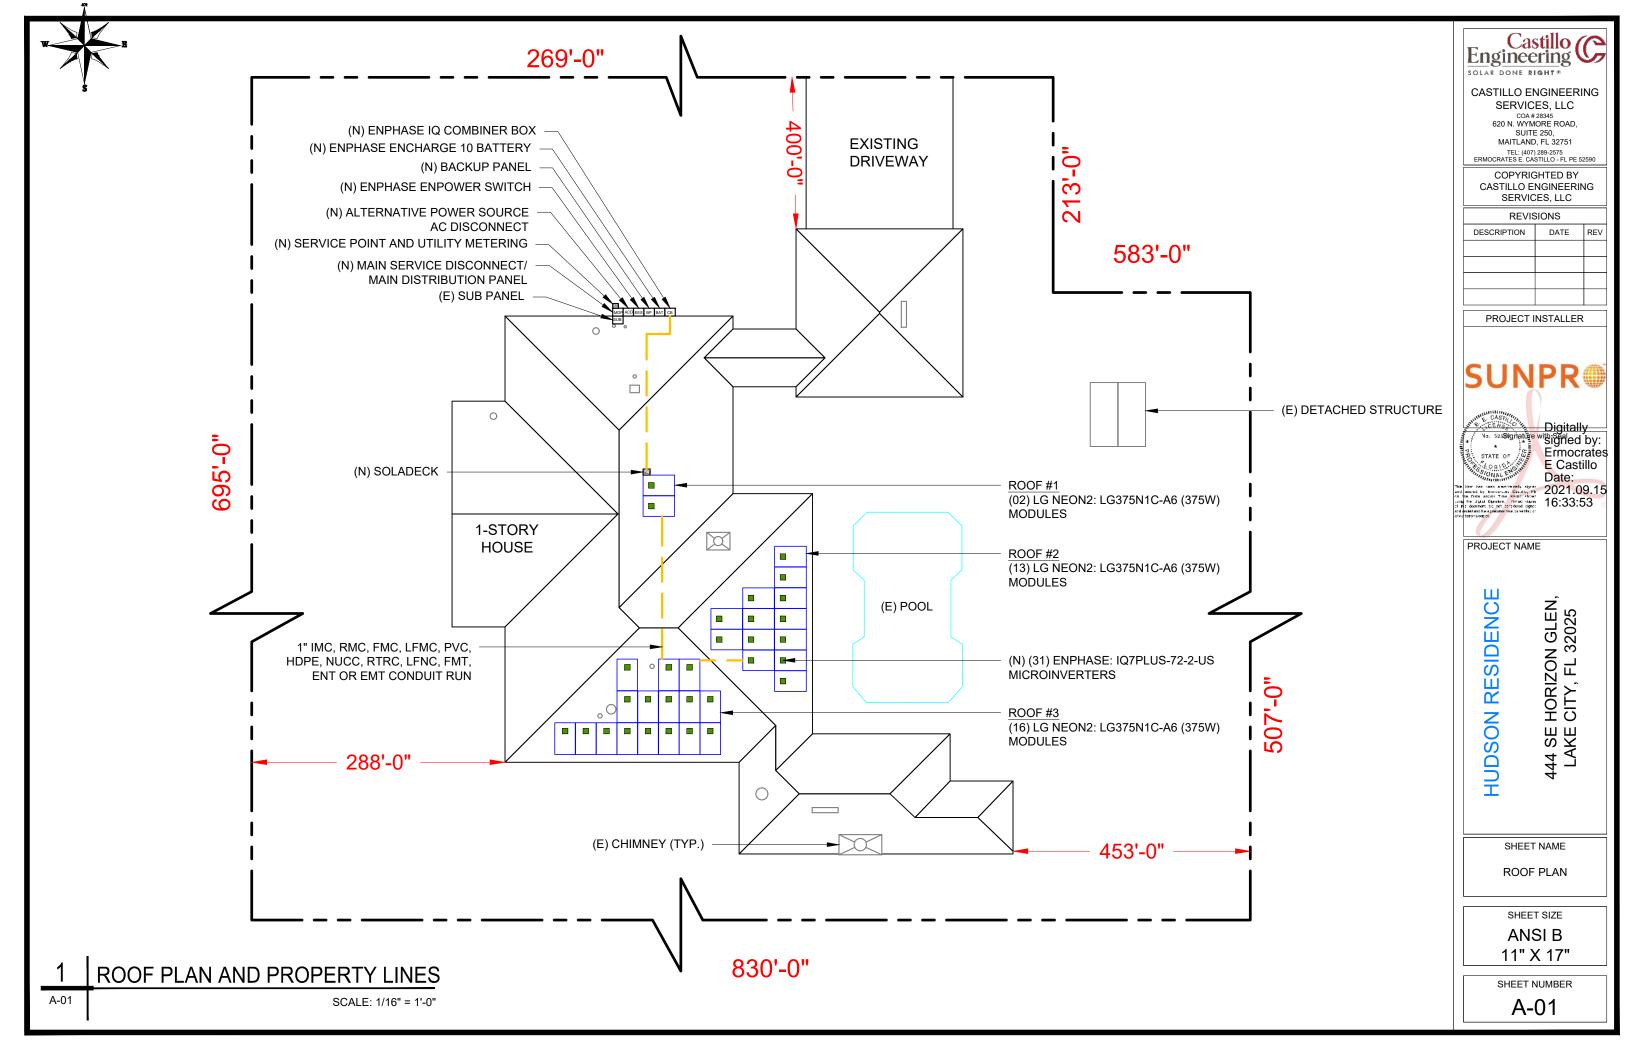

#### MODULE TYPE, DIMENSIONS & WEIGHT


NUMBER OF MODULES = 31 MODULES MODULE TYPE = LG NEON2: LG375N1C-A6 (375W) MODULES MODULE WEIGHT = 41.01 LBS / 18.6 KG. MODULE DIMENSIONS = 68.50"x 41.02" = 19.51 SF

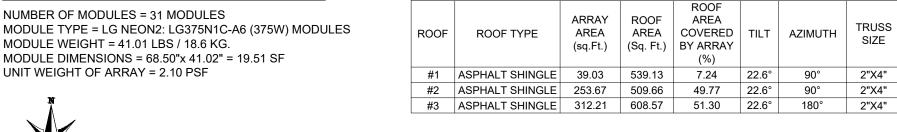



#### (E) FRONT YARD

ARRAY AREA & ROOF AREA CALC'S

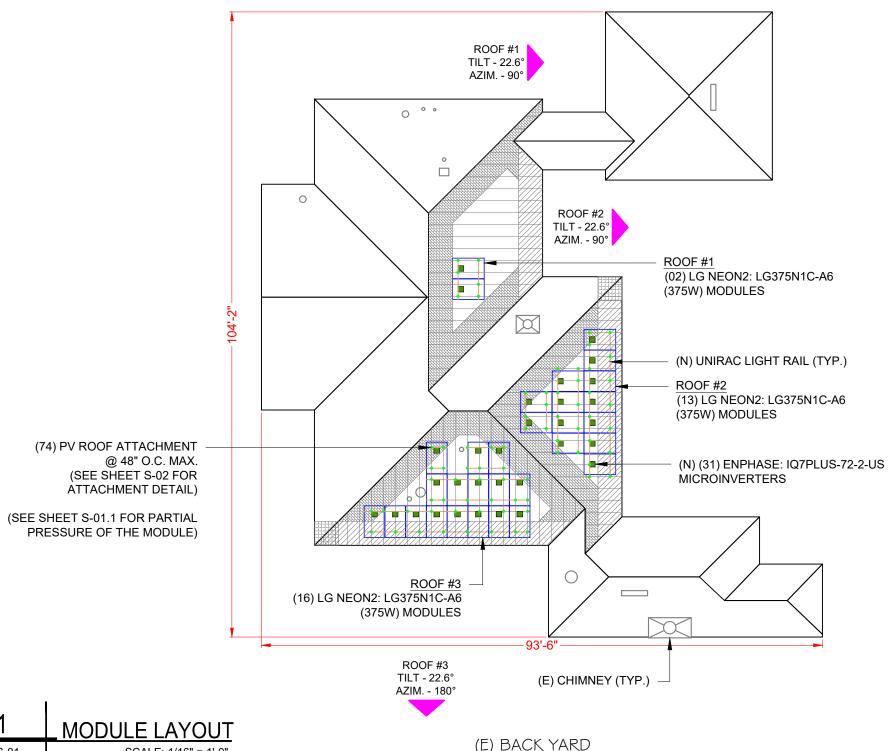

#### GENERAL INSTALLATION PLAN NOTES:

**TRUSS** 

SPACING

24" O.C.

24" O.C.

24" O.C.

1) ROOF ATTACHMENTS TO SYP TRUSSES SHALL BE INSTALLED AS SHOWN IN SHEET S-02 AND AS FOLLOWS FOR EACH WIND ZONE:

WIND	NON - EXPOS	SED MODULES	EDGE / EXPOSED MODULES		
ZONES	SPAN	CANTILEVER	SPAN	CANTILEVER	
ZONE 1	4' - 0"	1' - 4"	4' - 0"	1' - 4"	
ZONE 1'	Х	Х	Х	Х	
ZONE 2e	4' - 0"	1' - 4"	4' - 0"	1' - 4"	
ZONE 2n	Х	Х	Х	Х	
ZONE 2r	4' - 0"	1' - 4"	4' - 0"	1' - 4"	
ZONE 3e	4' - 0"	1' - 4"	4' - 0"	1' - 4"	
ZONE 3r	Х	X	Х	Х	

SEE SHEET S-02.1 FOR SUPPORTING CALCULATIONS.

- 2) EXISTING RESIDENTIAL BUILDING IS AN ASPHALT SHINGLE ROOF WITH MEAN ROOF HEIGHT IS 15 FT AND SYP 2"X4" ROOF TRUSSES SPACED 24" O.C. EXISTING ROOF SLOPE FOR SOLAR SYSTEM RETROFIT IS 22.6 DEGREES. CONTRACTOR TO FIELD VERIFY AND SHALL REPORT TO THE ENGINEER IF ANY DISCREPANCIES EXIST BETWEEN PLANS AND IN **FIELD** CONDITIONS.
- \* I CERTIFY THAT THE INSTALLATION OF THE MODULES IS IN COMPLIANCE WITH FBC: RESIDENTIAL 2020 7th ED. CHAPTER 3. BUILDING STRUCTURE WILL SAFELY ACCOMMODATE WIND LATERAL AND UPLIFT FORCES AND EQUIPMENT DEAD LOADS. \*



- WIND ZONE 1 (TYP)

- WIND ZONE 2e (TYP)

- WIND ZONE 2n (TYP)

- WIND ZONE 2r (TYP)

- WIND ZONE 3r (TYP)

- WIND ZONE 3e (TYP)

Engineering C SOLAR DONE RIGHT

#### **CASTILLO ENGINEERING** SERVICES, LLC

COA # 28345 620 N. WYMORE ROAD, SUITE 250. MAITLAND, FL 32751

TEL: (407) 289-2575 ERMOCRATES E. CASTILLO - FL PE 52590 **COPYRIGHTED BY CASTILLO ENGINEERING** 

SERVICES, LLC

REVISIONS						
DESCRIPTION	DATE	REV				

PROJECT INSTALLER



Digitally va 528 ignature with signed by: Ermocrates STATE OF E Castillo Date: The life has been endroned stayed and award in the second of the production of the second of the production of the second of the

PROJECT NAME

HORIZON GLEN, CITY, FL 32025 **HUDSON RESIDENC** 444 SE LAKE

SHEET NAME

MODULE LAYOUT

SHEET SIZE ANSI B

11" X 17"


SHEET NUMBER S-01

S-01

SCALE: 1/16" = 1'-0"



#### (E) FRONT YARD

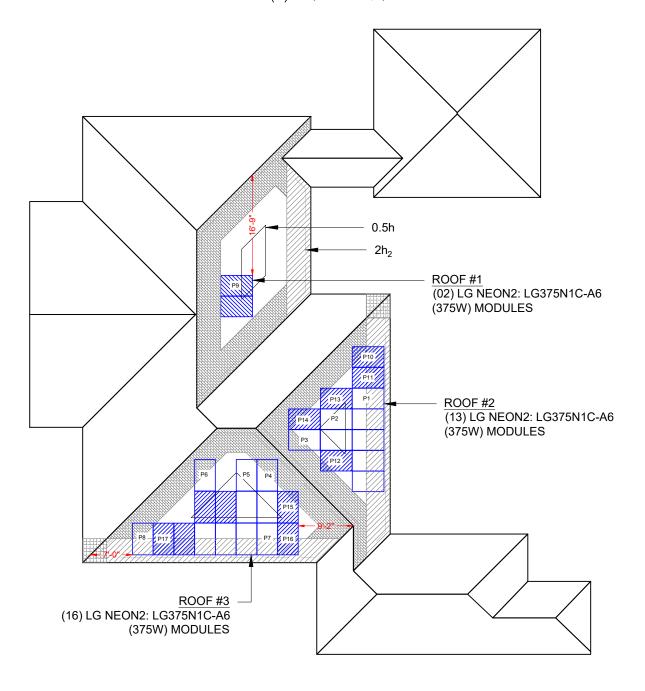

(E) BACK YARD

SCALE: 1/16" = 1'-0"

DISTANCE : 0' - 10" 0.5h DISTANCE: 7' - 6"

NOTE: PARTIAL PRESSURES OF THE WIND ZONES ON PRESSURES. ANY CHANGES IN LAYOUT SHOULD BE REPORTED BACK TO THE ENGINEER OF RECORD.

#### FOR NON- EXPOSED MODULES

1	1'	2e	2n	2r	3e	3r
16	0	16	0	16	16	0

Module Size	19.51	Sq. ft.
-------------	-------	---------

	Non-Exposed modules							
	1	1'	2e	2n	2r	3e	3r	Pressure
P1	8.58	0	10.93	0	0	0	0	16.00
P2	19.51	0	0	0	0	0	0	16.00
P3	11.53	0	0	0	7.98	0	0	16.00
P4	10.75	0	0	0	8.76	0	0	16.00
P5	19.30	0	0	0	0.21	0	0	16.00
P6	10.34	0	0	0	9.17	0	0	16.00
P7	9.54	0	9.97	0	0	0	0	16.00
P8	2.29	0	9.97	0	7.25	0	0	16.00

#### FOR EXPOSED MODULES

1	1'	2e	2n	2r	3e	3r
16	0	21.6	0	21.6	21.6	0

Module Size	19.51	Sq. ft.
	10.01	JU. 11

	Exposed modules							
	1	1'	2e	2n	2r	3e	3r	Pressure
P9	19.51	0	0	0	0	0	0	16.00
P10	3.50	0	10.94	0	5.07	0	0	20.60
P11	8.57	0	10.94	0	0	0	0	19.14
P12	17.32	0	0	0	2.19	0	0	16.63
P13	18.17	0	0	0	1.34	0	0	16.39
P14	13.09	0	0	0	6.42	0	0	17.84
P15	16.84	0	0	0	2.67	0	0	16.77
P16	9.54	0	0	0	9.97	0	0	18.86
P17	9.41	0	9.97	0	0.13	0	0	18.90

ALLOWABLE MODULE UPLIFT PRESSURE 2 RAILS: 88 PSF

### **LEGEND**

- EXPOSED MODULE

- EDGE MODULE

- NON- EXPOSED MODULE

- MISSING MODULE

- MIN. MODULE EDGE DISTANCE LINE

- MODULE EXPOSURE LINE

- WIND ZONE 1 (TYP)



- WIND ZONE 2e (TYP) - WIND ZONE 2n (TYP)



- WIND ZONE 2r (TYP)



- WIND ZONE 3r (TYP)



- WIND ZONE 3e (TYP)

Engineering C

**CASTILLO ENGINEERING** SERVICES, LLC

COA # 28345 620 N. WYMORE ROAD, SUITE 250,

MAITLAND, FL 32751 TEL: (407) 289-2575 ERMOCRATES E. CASTILLO - FL PE 52590

COPYRIGHTED BY CASTILLO ENGINEERING SERVICES, LLC

REVISIONS

DESCRIPTION	DATE	REV

PROJECT INSTALLER

**SUNPR** 

STATE OF CASTILLO Date: The liter has been a action rate styres on the first action in the action in the control of the

PROJECT NAME

**HUDSON RESIDENC** 

444 SE HORIZON GLEN LAKE CITY, FL 32025

SHEET NAME


PARTIAL PRESSURE AND MODULES EXPOSURE

> SHEET SIZE ANSI B

11" X 17"

SHEET NUMBER S-01.1

ALL MODULES HAVE BEEN VERIFIED AND ARE WITHIN THE ALLOWABLE PER THE MANUFACTURER SPECIFICATION, INSTALLER SHOULD FOLLOW THE LAYOUT TO AVOID HIGHER ZONAL PARTIAL

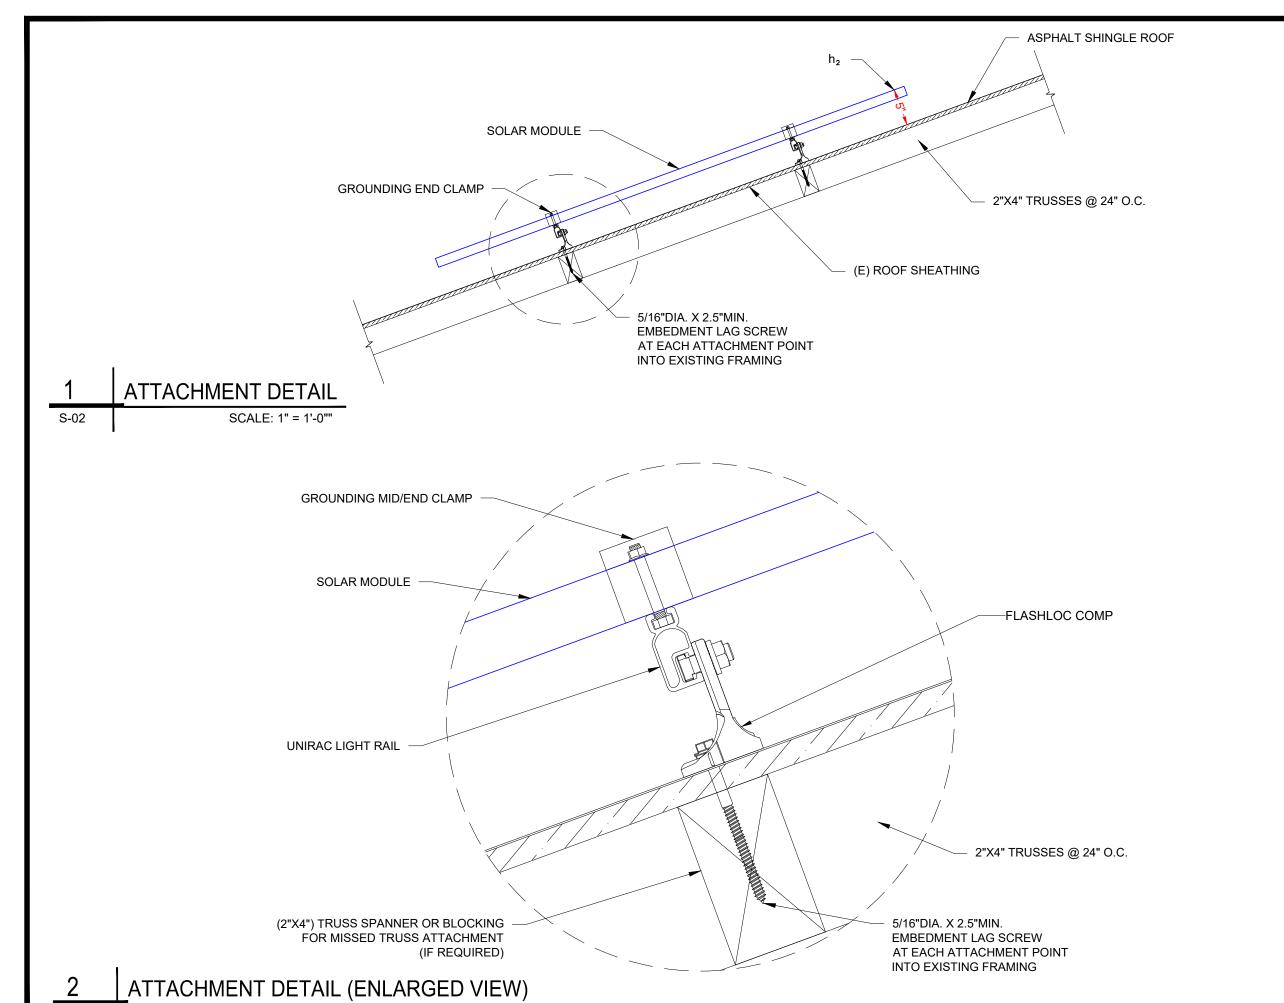

SCALE: 1"=2"

S-02

Castillo Engineering C

CASTILLO ENGINEERING SERVICES, LLC

COA# 28345 620 N. WYMORE ROAD, SUITE 250, MAITLAND, FL 32751 TEL: (407) 289-2575 ERMOCRATES E. CASTILLO - FL PE 52590

COPYRIGHTED BY CASTILLO ENGINEERING

SERVICES, LLC REVISIONS

DESCRIPTION	DATE	REV

PROJECT INSTALLER



Digitally

Vo. 52 Segripature with Signed by:
Ermocrates
E Castillo
Date:
2021.09.15

This limit has the antique with the signed would be broad and the signed with the signed would be broad wheet do be broad with the signed with the signe

PROJECT NAME

**HUDSON RESIDENCE** 

444 SE HORIZON GLEN, LAKE CITY, FL 32025

SHEET NAME

ATTACHMENT DETAIL

SHEET SIZE ANSI B

11" X 17"

SHEET NUMBER

S-02

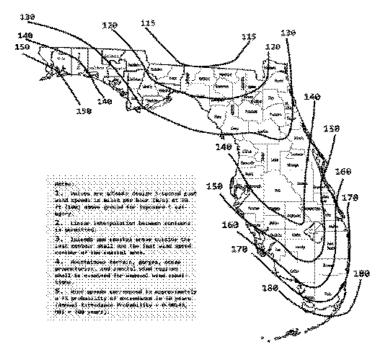


Figure 1683.3(1) ULTIMATE DESIGN WIND SPEEDS,  $V_{\rm M,T}$  FOR RISK CATEGORY II BUILDINGS AND OTHER STRUCTURES

#### WIND LOAD CALCULATIONS FOR MODULES INSTALLED ON ROOFS WITH A HEIGHT LESS THAN 60'

		SITE INFORMATION		
FBC VERSION	2020	RISK CATEGORY	II.	
MEAN ROOF HEIGHT (ft)	15.0	EXPOSURE CATEGORY	В	
ROOF LENGTH (ft)	104.0	ROOF SLOPE	5 /12	
ROOF WIDTH (ft)	94.0	ROOF SLOPE (°)	22.6	
PARAPET HEIGHT (ft)	0.0	ROOF TYPE	HIP	
MODULE LENGTH (in)	68.5	ULTIMATE WIND SPEED	120 mph	
MODULE WIDTH (in)	41.02	NOMINAL WIND SPEED	93 mph	
MODULE ORIENTATION	PORTRAIT	EXPOSURE FACTOR (C <sub>0</sub> )	1.000	
MODULE AREA (sq. ft.)	19.51	TEMPERATURE FACTOR (C <sub>1</sub> )	1.000	
GROUND SNOW LOAD (psf)	0.0	IMPORTANCE FACTOR (Is)	1.000	
DEAD LOAD (psf)	3.0	SLOPE FACTOR (Cs)	0.910	
SLOPED ROOF SNOW LOAD (psf)	0.0	$K_D$	0.850	
EFFECTIVE WIND AREA (ft²)	19.5	K <sub>ZT</sub>	1.000	
GROUND ELEVATION (ft)	121.0	Ke	0.996	
HVHZ	NO	Kz	0.575	

	DESIGN	CALCULA	TIONS			
VELOCITY PRESSURE (q) = .00256*	KEKZKZTKDV <sup>2</sup>					
VELOCITY PRESSURE(ASD)	10.8 psf					
WIDTH OF PRESSURE COEFFICIENT	94' * 10%	=	9.4'	ZONE WIDTH A	4 FT	
	15' * 40%	=	6'	ZONE 2 WIDTH	N/A	(FOR (°) < 7°)
				ZONE 3 WIDTH	N/A	(FOR (°) < 7°)
EXTERNAL PRESSURE COEFFICIENT	ZONE 1	0.584	-1.226			
	ZONE 1'	0.584	X			
	ZONE 2e	0.584	-1.777			
	ZONE 2n	0.584	X			
	ZONE 2r	0.584	-1.777			
	ZONE 3e	0.584	-1.777			
	ZONE 3r	0.584	X			
NTERNAL PRESSURE COEFFICIENT (+/-)	0.18					

DESIGN PRESSURES							
ROOF ZONE	DOWN	UP					
1	16.0	-15.1	psf				
1'	16.0	X	psf				
2e	16.0	-21.1	psf	Module allowable uplift pressure	88	psf	
2n	16.0	X	psf	Module allowable down pressure	125	psf	
2r	16.0	-21.1	psf				
3e	16.0	-21.1	psf				
3r	16.0	X	psf				

	ARRA	Y FACTORS		
ARRAY EDGE FACTOR (EXPOSED)	1.5	SOLAR PANEL PRESSURE	0.60207	
ARRAY EDGE FACTOR (NON-EXPOSED)	1	EQUALIZATION FACTOR	0.68387	

		ADJUST	ED DESIGN PR	ESSURES
ROOF ZONE	DOWN	UP (Exposed)	UP (N. Expose	ed)
1	16.0	-16.0	-16.0	psf
1'	16.0	X	X	psf
2e	16.0	-21.6	-16.0	psf
2n	16.0	X	X	psf
2r	16.0	-21.6	-16.0	psf
3e	16.0	-21.6	-16.0	psf
3r	16.0	X	X	psf

ATTACHMENTS USED				
ATTACHMENT MODEL	Lag Bolts- Shingle			
ATTACHMENT STRENGTH	476	lbs		

		MAX DES	SIGN LOADS AL	LOWABLE		
LIMIT MAX SPAN TO		48	in			
RAFTER/SEAM SPACING	3	24	in	NO. OF RAILS	Exposed:	2 Non. Exp: 2
ROOF ZONE	DOWN	UP (Exposed)	UP (N. Expose	ed)	SPANS (E)	SPANS (N.E)
1	182.7	182.7	182.7	lbs	48 in	48 in
1'	0.0	X	X	lbs	X in	X in
2e	182.7	246.5	182.7	lbs	48 in	48 in
2n	0.0	X	X	lbs	X in	X in
2r	182.7	246.5	182,7	lbs	48 in	48 in
3e	182.7	246.5	182.7	lbs	48 in	48 in
3r	0.0	×	X	lbs	X in	Xin



#### CASTILLO ENGINEERING

SERVICES, LLC

COA # 28345
620 N. WYMORE ROAD,
SUITE 250,
MAITLAND, FL 32751

TEL: (407) 289-2575
ERMOCRATES E. CASTILLO - FL PE 52590

CASTILLO ENGINEERING SERVICES, LLC
REVISIONS

REVISIONS			
DESCRIPTION	DATE	REV	

PROJECT INSTALLER

## **SUNPR**



PROJECT NAME


HUDSON RESIDENCE

SHEET NAME
STRUCTURE
CALCULATION

444 SE HORIZON GLEN, LAKE CITY, FL 32025

ANSI B

SHEET NUMBER

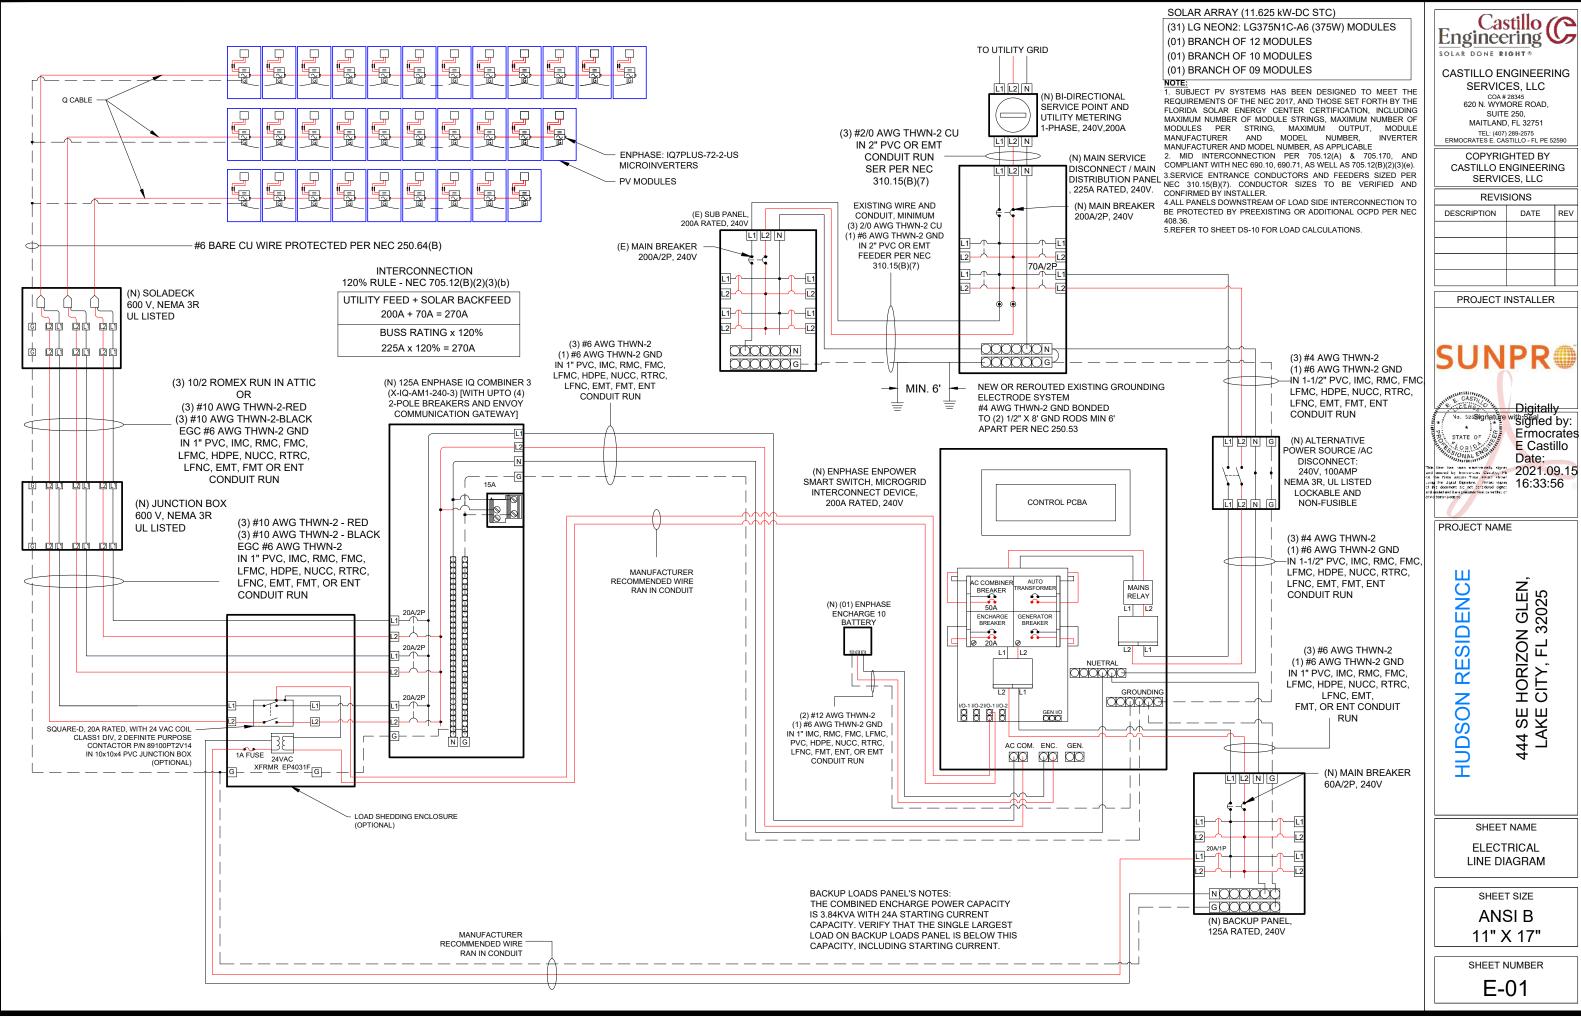

Castillo 🌘 Engineering **5** 

Ermocrates

#### **ELECTRICAL CALCULATION**

MODULE MANUFACTURER	LG
MODULE MODEL	LG375N1C-A6
INVERTER MANUFACTURER	ENPHAGE
INVERTER MODEL	ENPHASE IQ 7 PLUS
MODULES/BRANCH CIRCUIT 1	12
MODULES/BRANCH CIRCUIT 2	10
MODULES/BRANCH CIRCUIT 3	9
TOTAL ARRAY POWER (KW)	11.63
SYSTEM AC VOLTABE	240V 1-PHASE

	MODULE P	ROPERTIE	s
Voc	41.8	lsc	11.35
VMPP	35.3	IMP	10.63
TC Voc	-0.26%/°C	TC VMP	-0.34%/°C
PMP	375.0	NOCT	45 °C

DESIGN TEMPERAT	URE
MIN. AMBIENT TEMP. °F	32
MAX. AMBIENT TEMP. °F	117
CALCULATED MAX. VOC	45
DALGULATED MIN VMP	28
CONDUIT FILL	
NUMBER OF CONDUITS	1

INVERTER PROPERTIES			
DUTPUT VOLTAGE	240 L-L 1-PH		
MAX INPUT DC VOLTAGE	60 VDC		
□PERATING RANGE	16 - 60 Vpc		
MPPT VOLTAGE RANGE	27 - 45 VDC		
START VOLTAGE	22 Voc		
MAX INPUT POWER	440 WDG		
CONTINUOUS AC POWER	290 VA		

AMPACITY CA	LCULTIONS									
CIRCUIT	Мах Амра	1.25 x MAX AMPS	AWG	90 °C Ampagity	AMBIENT TEMP °F	TEMP DERATE	CONDUIT FILL	FILL DERATE	DERATED AMPAGITY	MAXIMUM CIRCUIT BREAKER
CIRCUIT 1	14.5	18.1	#10	40	130	0.76	6	0.8	24.32	20 A
CIRCUIT 2	12.1	15.1	#10	40	130	0.76	6	0.8	24.32	20 A
CIRCUIT 3	10.9	13.6	#10	40	130	0.76	6	0.8	24.32	20 A
ENPHASE COMBINER DUTPUT	37.5	46.8	#6	75	95	0.96	3	Т	72	50 A
ENPOWER TO BACKUP PANEL	48.0	60.0	#6	75	95	0.96	3	13	72	60 A
ENPOWER TO ENGHARGE	16.0	20.0	#12	30	95	0.96	3	1	28.8	20 A
ENPOWER TO MAIN PANEL	53.5	66.8	#4	95	95	0.96	3	1	91.2	70 A

VOLTAGE DROP CALCULATIONS		1000		gs as	
CIRCUIT	AWG	CIRCULAR MILLS	1	v	MAX LENGTH
CIRCUIT 1	#10	10380	14.5	240	133 FEET
CIRCUIT 2	#10	10380	12.1	240	160 FEET
CIRCUIT 3	#10	10380	10.9	240	178 FEET
ENPHASE COMBINER OUTPUT	#6	26240	37.5	240	130 FEET
ENPOWER TO BACKUP PANEL	#6	26240	48.0	240	102 FEET
ENPOWER TO ENCHARGE	#12	6530	16.0	240	76 FEET
ENPOWER TO MAIN PANEL	#4	41740	53.5	240	145 FEET

TEMP DERATE BASED ON NEC TABLE 310.15(B)(2)(A)

MAXIMUM CIRCUIT VOLTAGE DROP

CONDUIT FILL DERATE BASED ON NEC TABLE 310.15(B)(3)(A)

MAXIMUM VOC CALCULATED USING MODULE MANUFACTURE TEMPERATURE COEFFICIENTS PER NEC 690.7(A)

UNLESS OTHERWISE SPECIFIED, ALL WIRING MUST BE THUN OR THWN-2 COPPER

N ANY CELL INDICATES THAT THE SYSTEM IS SAFE AND COMPLIES WITH NEC REGULERMENTS

NEDRMATION INPUT BY SYSTEM DESIGNER

INFORMATION OBTAINED FROM MANUFACTURER DATASHEETS

ELECTRICAL	NOTES
------------	-------

- ALL EQUIPMENT TO BE LISTED BY UL OR OTHER NRTL, AND LABELED FOR ITS APPLICATION.
- ALL CONDUCTORS SHALL BE COPPER, RATED FOR 600 V AND 90 DEGREE C WET ENVIRONMENT. THE TERMINALS ARE RATED FOR 75 DEGREE C.
- 3. THE WIRES ARE SIZED ACCORDING TO NEC 110.14.
- WIRING, CONDUIT, AND RACEWAYS MOUNTED ON ROOFTOPS SHALL BE ROUTED DIRECTLY TO, AND LOCATED AS CLOSE AS POSSIBLE TO THE NEAREST RIDGE, HIP, OR VALLEY.
- WORKING CLEARANCES AROUND ALL NEW AND EXISTING ELECTRICAL EQUIPMENT SHALL COMPLY WITH NEC 110.26.
- DRAWINGS INDICATE THE GENERAL ARRANGEMENT OF SYSTEMS. CONTRACTOR SHALL FURNISH ALL NECESSARY OUTLETS, SUPPORTS, FITTINGS AND ACCESSORIES TO FULFILL APPLICABLE CODES AND
- 7. WHERE SIZES OF JUNCTION BOXES, RACEWAYS, AND CONDUITS ARE NOT SPECIFIED, THE CONTRACTOR SHALL SIZE THEM ACCORDINGLY.
- ALL WIRE TERMINATIONS SHALL BE APPROPRIATELY LABELED AND READILY VISIBLE.
- MODULE GROUNDING CLIPS TO BE INSTALLED BETWEEN MODULE FRAME AND MODULE SUPPORT RAIL, PER THE GROUNDING CLIP MANUFACTURER'S INSTRUCTION.
- 10. MODULE SUPPORT RAIL TO BE BONDED TO CONTINUOUS COPPER G.E.C. VIA WEEB LUG OR ILSCO GBL-4DBT LAY-IN LUG.
- 11. THE POLARITY OF THE GROUNDED CONDUCTORS IS NEGATIVE.
- 12. UTILITY HAS 24-HR UNRESTRICTED ACCESS TO ALL PHOTOVOLTAIC SYSTEM COMPONENTS LOCATED AT THE SERVICE ENTRANCE.
- 13. MODULES CONFORM TO AND ARE LISTED UNDER UL 1703.
- 14. RACKING CONFORMS TO AND IS LISTED UNDER UL 2703.
- 15. CONDUCTORS EXPOSED TO SUNLIGHT SHALL BE LISTED AS SUNLIGHT RESISTANT PER NEC ARTICLE 300.6 (C) (1) AND ARTICLE 310.10 (D).
- 16. CONDUCTORS EXPOSED TO WET LOCATIONS SHALL BE SUITABLE FOR USE IN WET LOCATIONS PER NEC ARTICLE 310.10 (C).
- 17. THIS SYSTEM IS EQUIPPED WITH RAPID SHUTDOWN OF PV CONDUCTORS IN COMPLIANCE WITH NEC 690.12.
- 18. LABELING IN COMPLIANCE WITH NEC 690.12 AND 690.56(C) IS SHOWN ON SHEET E-03.
- 19. ALL CONDUITS TO BE INSTALLED A MIN OF 7/8" ABOVE THE ROOF SURFACE.

I ERMOCRATES CASTILLO PE# 52590 AN ENGINEER LICENSED PURSUANT TO CHAPTER 471, CERTIFY THAT THE PV ELECTRICAL SYSTEM AND ELECTRICAL COMPONENTS ARE DESIGNED AND APPROVED USING THE STANDARDS CONTAINED IN THE MOST RECENT VERSION OF THE FLORIDA BUILDING CODE, FBC 107. THE NEC 2017, AND THOSE SET FORTH BY THE FLORIDA SOLAR ENERGY CENTER CERTIFICATION.



CASTILLO ENGINEERING

SERVICES, LLC COA # 28345 620 N. WYMORE ROAD, SUITE 250, MAITLAND, FL 32751

TEL: (407) 289-2575 ERMOCRATES E. CASTILLO - FL PE 52590 COPYRIGHTED BY CASTILLO ENGINEERING

SERVICES, LLC

TEVIOIONO						
DESCRIPTION	DATE	REV				

PROJECT INSTALLER





PROJECT NAME

STATE OF

RESIDENC HUDSON

HORIZON GLEN, CITY, FL 32025 144 SE | LAKE (

SHEET NAME

WIRING CALCULATIONS

SHEET SIZE **ANSIB** 

11" X 17"

SHEET NUMBER E-02

## **WARNING**

#### **ELECTRIC SHOCK HAZARD**

TERMINALS ON BOTH LINE AND LOAD SIDES MAY BE ENERGIZED IN THE OPEN POSITION

LABEL LOCATION:

AC DISCONNECT, POINT OF INTERCONNECTION (PER CODE: NEC 690.13(B))

WARNING DUAL POWER SOURCE ECOND SOURCE IS PHOTOVOLTAIC SYSTEM

LABEL LOCATION: POINT OF INTERCONNECTION (PER CODE: NEC 705.12(B)(2)(3)(b))

### **RAPID SHUTDOWN SWITCH FOR SOLAR PV SYSTEM**

LABEL LOCATION: AC DISCONNECT (PER CODE: NEC690.56(C)(3))

ADHESIVE FASTENED SIGNS:

- THE LABEL SHALL BE SUITABLE FOR THE ENVIRONMENT WHERE IT IS INSTALLED.
- WHERE REQUIRED ELSEWHERE IN THIS CODE, ALL FIELD APPLIED LABELS, WARNINGS, AND MARKINGS SHOULD COMPLY WITH ANSI Z535.4 [NEC 110.21(B) FIELD MARKING] • ADHESIVE FASTENED SIGNS MAY BE ACCEPTABLE IF PROPERLY ADHERED. VINYL SIGNS SHALL BE WEATHER **RESISTANT [IFC 605.11.1.3]**

### 11.63 kW SOLAR **DISCONNECT LOCATED**

AC DISCONNECT, POINT OF INTERCONNECTION (PER CODE: NEC690.54)

## AC COMBINER BOX

LABEL LOCATION: COMBINER BOX (PER CODE: NEC690.52)

> **PHOTOVOLTAIC SYSTEM MICROINVERTERS LOCATED UNDER EACH PV MODULE IN ROOF TOP ARRAY**

LABEL LOCATION: **INVFRTFR** (PER CODE: NEC690.52)

### PHOTOVOLTAIC SYSTEM AC DISCONNECT RATED AC OPERATING CURRENT 53.5 AMPS AC NOMINAL OPERATING VOLTAGE 240 VOLTS

LABEL LOCATION:
AC DISCONNECT, POINT OF INTERCONNECTION (PER CODE: NEC690.54)

#### WARNING

INVERTER OUTPUT CONNECTION DO NOT RELOCATE THIS OVERCURRENT DEVICE

LABEL LOCATION: POINT OF INTERCONNECTION

(PER CODE: NEC 705.12(B)(2)(3)(b))


DATA PER PANEL

**NOMINAL OPERATING AC VOLTAGE -**240 **NOMINAL OPERATING AC FREQUENCY-**60 MAXIMUM AC POWER-290 **MAXIMUM AC CURRENT-** 1.21 MAXIMUM OVERCURRENT DEVICE RATING 20 FOR AC MODULE PROTECTION PER CIRCUIT-

LABEL LOCATION: COMBINER BOX (PER CODE: NEC690.52)

## SOLAR PV SYSTEM EQUIPPED WITH RAPID SHUTDOWN

TURN RAPID SHUTDOWN SWITCH TO THE "OFF" POSITION TO SHUT DOWN PV SYSTEM AND REDUCE SHOCK HAZARD IN THE ARRAY

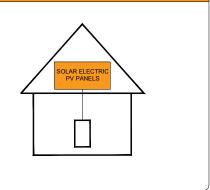

AC DISCONNECT. POINT OF INTERCONNECTION (PER CODE: NEC 690.56(C)(1)(a), IFC 605.11.3.1(1)

## AC DISCONNECT


LABEL LOCATION: AC DISCONNECT, POINT OF INTERCONNECTION (PER CODE: NEC690.54)

## **BREAKER**


LABEL LOCATION: POINT OF INTERCONNECTION (PER CODE: NEC 705.12(B)(2)(3)(b))

## **CAUTION:**

POWER TO THIS BUILDING IS ALSO SUPPLIED FROM THE FOLLOWING SOURCES WITH DISCONNECTS LOCATED **AS SHOWN** 

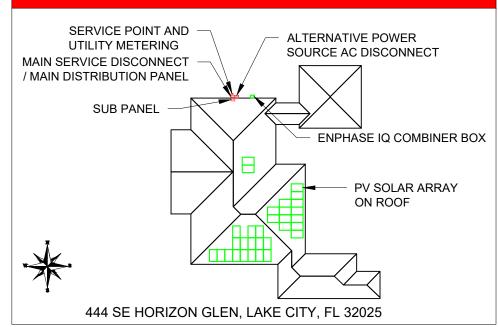

MAIN SERVICE DISCONNECT / MAIN DISTRIBUTION PANEL. PV DISCONNECT (TEXT HEIGHT SHOULD BE A MINIMUM OF 3/8") (PER CODE: NEC 690.56(B) AND NEC 705.10)

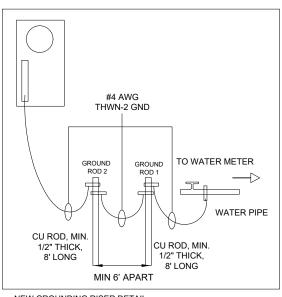

NEW GROUNDING RISER DETAIL

Castillo (^ Engineering  $\smile$ SOLAR DONE PIGHT®

#### **CASTILLO ENGINEERING** SERVICES, LLC

COA # 28345 620 N. WYMORE ROAD, SUITE 250, MAITLAND, FL 32751

TEL: (407) 289-2575 ERMOCRATES E. CASTILLO - FL PE 52590 COPYRIGHTED BY

**CASTILLO ENGINEERING** SERVICES, LLC REVISIONS

DESCRIPTION DATE

PROJECT INSTALLER



withighled by: Ermocrates E Castillo Date: the lies has been a active rate, signed and up to rate and the signed by the rate of the r

PROJECT NAME

STATE OF

RESIDENC HUDSON

N GLEN, 32025 HORIZON CITY, FL 32 144 SE | LAKE (

SHEET NAME

SYSTEM LABELING

SHEET SIZE **ANSIB** 11" X 17"

SHEET NUMBER

E-03

# LG NeON®2

LG375N1C-A6



### 375W

The LG NeON® 2 is LG's best selling solar module and one of the most powerful and versatile modules on the market today. The cells are designed to appear all-black at a distance, and the performance warranty guarantees 90.6% of labeled power output at 25 years.









#### Features



#### Enhanced Performance Warranty

LG NeON® 2 has an enhanced performance warranty. After 25 years, LG NeON® 2 is guaranteed at least 90.6% of initial performance.



#### 25-Year Limited Product Warranty

The NeON® 2 is covered by a 25-year limited product warranty. In addition, up to \$450 of labor costs will be covered in the rare case that a module needs to be repaired or replaced.



#### Solid Performance on Hot Days

LG NeON® 2 performs well on hot days due to its low temperature coefficient.



#### Roof Aesthetics

LG NeON® 2 has been designed with aesthetics in mind using thinner wires that appear all black at a distance.

#### When you go solar, ask for the brand you can trust: LG Solar

#### About LG Electronics USA, Inc.

LG Electronics is a global leader in electronic products in the clean energy markets by offering solar PV panels and energy storage systems. The company first embarked on a solar energy source research program in 1985, supported by LG Group's vast experience in the semi-conductor, LCD, chemistry and materials industries. In 2010, LG Solar successfully released its Rirst Monox% eneries to the market, which is now available in 32 countries. The NeON® (previous Monox® NeON), NeON®2, NeON®2, NeON®2, Selected won the "intersolar AWARD" in 2013, 2015 and 2016, which demonstrators LG's leadership and innovation in the solar industry.



## LG NeON<sup>®</sup>2



#### LG375N1C-A6

#### General Data

60

Cell Properties (Material/Type)	Monocrystalline/N-type
Cell Maker	LG
Cell Configuration	60 Cells (6 x 10)
Module Dimensions (L x W x H)	1,740mm x 1,042mm x 40mm
VVeight	18.6 kg
Glass (Material)	Tempered Glass with AR Coating
Backsheet (Color)	White
Frame (Material)	Anodized Aluminium
Junction Box (Protection Degree)	IP 68 with 3 Bypass Diodes
Cables (Length)	1,100mm x 2EA
Connector (Type/Maker)	MC 4/MC

#### Certifications and Warranty

	IEC 61215-1/-1-1/2 : 2016, IEC 61730-1/2 : 2016 UL 61730-1 : 2017, UL 61730-2 : 2017
Certifications*	ISO 9001, ISO 14001, ISO 50001
	OHSAS 18001
Salt Mist Corrosion Test	IEC 61701:2012 Severity 6
Ammonia Corrosion Test	IEC 62716 : 2013
Module Fire Performance	Type 1 (UL 61730)
Fire Rating	Class C (UL 790, ULC/ORD C 1703)
Solar Module Product Warranty	25 Year Limited
Solar Module Output Warranty	Linear Warranty*

\*Improved: 1\* year 98.5%, from 2-24th year: 0.33%/year down, 90.6% at year 25

#### Temperature Characteristics


. 4.1.16.42.42.42.4			
NMOT*	[°C]	42 ± 3	
Pmax	[%/°C]	-0.34	
Voc	[%/°C]	-0.26	
Isc	[%/°C]	0.03	

\*NMOT (Nominal Module Operating Temperature): Irradiance 800 W/m², Ambient temperature 20°C, Wind speed 1 m/s, Spectrum AM 1.5

#### Electrical Properties (NMOT)

Model		LG375N1C-A6	
Maximum Power (Pmax)	[W]	281	
MPP Voltage (Vmpp)	[V]	33.2	
MPP Current (Impp)	[A]	8.48	
Open Circuit Voltage (Voc)	[V]	39.4	
Short Circuit Current (Isc)	[A]	9.13	

#### I-V Curves

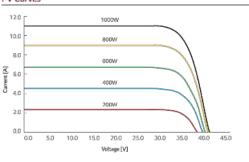

#### Electrical Properties (STC\*)

Model		LG375N1C-A6
Maximum Power (Pmax)	[W]	375
MPP Voltage (Vmpp)	[V]	35.3
MPP Current (Impp)	[A]	10.63
Open Circuit Voltage (Voc, ± 5%)	[V]	41.8
Short Circuit Current (Isc,±5%)	[A]	11.35
Module Efficiency	[%]	20.7
Bifaciality Coefficient of Power	[%]	10
Power Tolerance	[%]	0~+3

#### Operating Conditions


Operating Temperature	[°C]	-40 ~+85	
Maximum System Voltage	[V]	1,000	
Maximum Series Fuse Rating	[A]	20	
Mechanical Test Load* (Front)	[Pa/psf]	5,400	
Mechanical Test Load" (Rear)	[Pa/psf]	4,000	

"Based on IEC 61215-2: 2016 (Test Load – Design Load x Safety Factor (1.5))
Mischanical Test Loads 6,000Pa / 5,400Pa based on IEC 61215: 2005

#### Packaging Configuration

Number of Modules per Pallet	[EA]	25
Number of Modules per 40' Container	[EA]	650
Number of Modules per 53' Container	[EA]	850
Packaging Box Dimensions (L x W x H)	[mm]	1,790 x 1,120 x 1,213
Packaging Box Dimensions (L x W x H)	[in]	70.5 x 44.1 x 47.8
Packaging Box Gross Weight	[kg]	500
Packaging Box Gross Weight	[lb]	1,102

#### Dimensions (mm/inch)

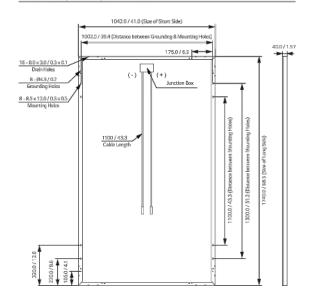



LG Electronics USA, Inc. Solar Business Division 2000 Millbrook Drive Lincolnshire, IL 60069 www.lg-solar.com Product specifications are subject to change without notice. LG375N1C-A6\_AUS.pdf 012221

© 2021 LG Electronics USA, Inc. All rights reserved.

### Castillo C Engineering

#### CASTILLO ENGINEERING SERVICES, LLC

COA #28345 620 N. WYMORE ROAD, SUITE 250, MAITLAND, FL 32751 TEL: (407) 289-2575

TEL: (407) 289-2575 ERMOCRATES E. CASTILLO - FL PE 52590

#### COPYRIGHTED BY CASTILLO ENGINEERING SERVICES, LLC

REVISIONS		
DESCRIPTION	DATE	REV

PROJECT INSTALLER



PROJECT NAME

RESIDENCE

HUDSON

444 SE HORIZON GLEN, LAKE CITY, FL 32025

SHEET NAME

DATA SHEET

ANSI B

SHEET NUMBER



LG Electronics U.S.A., Inc. 111 Sylvan Avenue Englewood Cliffs, NJ 07632 201.816.2000

Friday, February 5, 2021

#### RE: Mechanical Load Testing to Determine Structural Performance under Uniform Static Pressure

To: Castillo Engineering,


Upon your request we have conducted in house tests to determine the structural performance of the LG Module frames listed below. Our test results meet the requirements you presented in our conference call on January 29<sup>th</sup>. We will present the test criteria, results, and product limitations that may result from these test conditions in this letter.

The specifications and conditions presented in this letter apply retroactively to the following LG module(s);

	2 Rails	3 Rails
Front	9,000Pa	9,000Pa
Rear	6,350Pa	9,000Pa
Model	LGxxxN1C(K)-N5(L5), LGxxxN1C(K)-A6(B6)	
	LGxxxQ1C(K)-V5, LGxxxQ1C(K)-A6	

\*The result is based on test load.

Our R&D department has tested these modules to determine the structural performance of under uniform static loading to represent the effects of a wind load on the module. This test was designed only to determine structural performance; the revised specifications apply only to the mechanical performance of the module. A safety factor of 1.5 should be applied to these test loads for obtaining design loads. It is not recommend designing any system to the full test load.

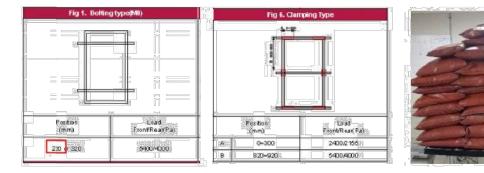

The scope of this test does not include electrical functionality or performance testing. Subjecting the module to these pressures may result in power degradation or total power loss. The electrical function and power generation warranties and specifications of these products are not altered by this document.

If you have any additional questions or concerns about this letter or the test protocol, contact your LG Solar Sales Representative.



#### CASTILLO ENGINEERING

SERVICES, LLC COA# 28345 620 N. WYMORE ROAD, SUITE 250, MAITLAND, FL 32751

MAITLAND, FL 32751 TEL: (407) 289-2575 ERMOCRATES E. CASTILLO - FL PE 52590

COPYRIGHTED BY CASTILLO ENGINEERING SERVICES, LLC

SIONS	
DATE	REV

PROJECT INSTALLER





HORIZON GLEN, CITY, FL 32025

PROJECT NAME

HUDSON RESIDENCE

SHEET NAME

DATA SHEET

ANSI B

SHEET NUMBER

Data Sheet **Enphase Microinverters** Region: US

## **Enphase** IQ 7 and IQ 7+ **Microinverters**

The high-powered smart grid-ready Enphase IQ 7 Micro™ and Enphase IQ 7+ Micro™ dramatically simplify the installation process while achieving the highest system efficiency.

Part of the Enphase IQ System, the IQ 7 and IQ 7+ Microinverters integrate seamlessly with the Enphase IQ Envoy™, Enphase Q Aggregator™, Enphase IQ Battery™, and the Enphase Enlighten™ monitoring and analysis software.

IQ Series Microinverters extend the reliability standards set forth by previous generations and undergo over a million hours of power-on testing, enabling Enphase to provide an industry-leading warranty of up to 25 years.



- · Lightweight and simple
- · Faster installation with improved, lighter two-wire cabling
- · Built-in rapid shutdown compliant (NEC 2014 & 2017)

#### Productive and Reliable

- · Optimized for high powered 60-cell and 72-cell\* modules
- · More than a million hours of testing
- · Class II double-insulated enclosure
- UL listed

#### Smart Grid Ready

- · Complies with advanced grid support, voltage and frequency ride-through requirements
- · Remotely updates to respond to changing grid requirements
- Configurable for varying grid profiles
- Meets CA Rule 21 (UL 1741-SA)
- \* The IQ 7+ Micro is required to support 72-cell modules.



To learn more about Enphase offerings, visit enphase.com



#### Enphase IQ 7 and IQ 7+ Microinverters

INPUT DATA (DC)	IQ7-60-2-US		IQ7PLUS-72-2	-US
Commonly used module pairings <sup>1</sup>	235 W - 350 W +		235 W - 440 W	+
Module compatibility	60-cell PV modu	ules only	60-cell and 72-	cell PV modules
Maximum input DC voltage	48 V		60 V	
Peak power tracking voltage	27 V - 37 V		27 V - 45 V	
Operating range	16 V - 48 V		16 V - 60 V	
Min/Max start voltage	22 V / 48 V		22 V / 60 V	
Max DC short circuit current (module Isc)	15 A		15 A	
Overvoltage class DC port	II		II	
DC port backfeed current	0 A		0 A	
PV array configuration			tional DC side protec 20A per branch circ	
OUTPUT DATA (AC)	IQ 7 Microinve	erter	IQ 7+ Microin	verter
Peak output power	250 VA		295 VA	
Maximum continuous output power	240 VA		290 VA	
Nominal (L-L) voltage/range <sup>2</sup>	240 V / 211-264 V	208 V / 183-229 V	240 V / 211-264 V	208 V / 183-229 V
Maximum continuous output current	1.0 A	1.15 A	1.21 A	1.39 A
Nominal frequency	60 Hz		60 Hz	
Extended frequency range	47 - 68 Hz		47 - 68 Hz	
AC short circuit fault current over 3 cycles	5.8 Arms		5.8 Arms	
Maximum units per 20 A (L-L) branch circuit <sup>a</sup>	16 (240 VAC) 13 (208 VAC)		13 (240 VAC) 11 (208 VAC)	
Overvoltage class AC port	Ш		III	
AC port backfeed current	0 A		0 A	
Power factor setting	1.0		1.0	
Power factor (adjustable)	0.7 leading 0.	7 lagging	0.7 leading 0.	.7 lagging
EFFICIENCY	@240 V	@208 V	@240 V	@208 V
Peak CEC efficiency	97.6 %	97.6 %	97.5 %	97.3 %
CEC weighted efficiency	97.0 %	97.0 %	97.0 %	97.0 %
MECHANICAL DATA	IQ 7 Microinve	rter		
Ambient temperature range	-40°C to +65°C			
Relative humidity range	4% to 100% (cor	ndensina)		
Connector type	MC4 (or Amphe	nol H4 UTX with	additional Q-DCC-5	adapter)
Dimensions (WxHxD)		nm x 30.2 mm (w		
Weight	1.08 kg (2.38 lbs	*		
Cooling	Natural convection - No fans			
Approved for wet locations	Yes			
Pollution degree	PD3			
Enclosure		insulated corros	ion resistant polyme	ric enclosure
Environmental category / UV exposure rating	NEMA Type 6 / 6		on resistant polymo	ne en en en en en en
FEATURES	.12.11.11/1007			
Communication	Power Line Com	nmunication (PLO	2)	
Monitoring	Enlighten Mana	ger and MyEnligh	nten monitoring option of an Enphase IQ En	
Disconnecting means	The AC and DC	•	been evaluated and	approved by UL for use as the load-break
Compliance	CAN/CSA-C22.2 This product is I NEC-2017 section	741/IEEÉ1547, F0 2 NO. 107.1-01 UL Listed as PV F on 690.12 and C2	2.1-2015 Rule 64-21	ICES-0003 Class B, Jipment and conforms with NEC-2014 and 8 Rapid Shutdown of PV Systems, for AC acturer's instructions.

- No enforced DC/AC ratio. See the compatibility calculator at <a href="https://enphase.com/en-us/support/module-compatibility.">https://enphase.com/en-us/support/module-compatibility.</a>
   Nominal voltage range can be extended beyond nominal if required by the utility.
   Limits may vary. Refer to local requirements to define the number of microinverters per branch in your area.

#### To learn more about Enphase offerings, visit enphase.com

@ 2018 Enphase Energy. All rights reserved. All trademarks or brands used are the property of Enphase Energy, Inc. 2018-02-08



### CASTILLO ENGINEERING

SERVICES, LLC COA # 28345 620 N. WYMORE ROAD, SUITE 250, MAITLAND, FL 32751 TEL: (407) 289-2575 ERMOCRATES E. CASTILLO - FL PE 52590

COPYRIGHTED BY **CASTILLO ENGINEERING** SERVICES, LLC

REVISIONS				
DESCRIPTION	DATE	REV		

PROJECT INSTALLER





PROJECT NAME

HUDSON RESIDENCE

HORIZON GLEN, CITY, FL 32025 444 SE I LAKE (

SHEET NAME

DATA SHEET

SHEET SIZE ANSI B 11" X 17"

**ENPHASE.** 

SHEET NUMBER

Data Sheet **Enphase Networking** 

## **Enphase IQ Combiner 3**

(X-IQ-AM1-240-3)

The Enphase IQ Combiner 3™ with Enphase IQ Envoy™ consolidates interconnection equipment into a single enclosure and streamlines PV and storage installations by providing a consistent, pre-wired solution for residential applications. It offers up to four 2-pole input circuits and Eaton BR series busbar assembly.



#### Smart

- · Includes IQ Envoy for communication and control
- · Flexible networking supports Wi-Fi, Ethernet, or cellular
- · Optional AC receptacle available for PLC bridge
- · Provides production metering and optional consumption
- · Supports Ensemble Communications Kit for communication with Enphase Encharge™ storage and Enphase Enpower™ smart switch

#### Simple

- · Reduced size from previous combiner
- · Centered mounting brackets support single stud mounting
- · Supports back and side conduit entry
- · Up to four 2-pole branch circuits for 240 VAC plug-in breakers (not included)
- · 80 A total PV or storage branch circuits

#### Reliable

- · Durable NRTL-certified NEMA type 3R enclosure
- · Five-year limited warranty
- UL listed



**Enphase IQ Combiner 3** 

#### MODEL NUMBER IQ Combiner 3 IQ Combiner 3 with Enphase IQ Envoy™ printed circuit board for integrated revenue grade PV X-IQ-AM1-240-3 production metering (ANSI C12.20 +/- 0.5%) and optional\* consumption monitoring (+/- 2.5%). ACCESSORIES and REPLACEMENT PARTS (not included, order separately) Enphase Mobile Connect CELLMODEM-03 (4G/12-year data plan) Plug and play industrial grade cellular modem with data plan for systems up to 60 CELLMODEM-01 (3G/5-year data plan) microinverters. (Available in the US, Canada, Mexico, Puerto Rico, and the US Virgin Islands, CELLMODEM-M1 (4G based LTE-M/5-year data plan) where there is adequate cellular service in the installation area.) Consumption Monitoring\* CT Split core current transformers enable whole home consumption metering (+/- 2.5%). CT-200-SPLIT on monitoring is required for Enphase Storage Systems Ensemble Communications Kit Installed at the IQ Envoy. For communications with Enphase Encharge™ storage and Enphase Enpower™ smart switch. Includes USB cable for connection to IQ Envoy or Enphase IQ Combiner™ COMMS-KIT-01 and allows wireless communication with Encharge and Enpower. Supports Eaton BR210, BR215, BR220, BR230, BR240, BR250, and BR260 circuit breakers. Circuit Breakers BRK-10A-2-240 Circuit breaker, 2 pole, 10A, Eaton BR210 BRK-15A-2-240 Circuit breaker, 2 pole, 15A, Eaton BR215 Circuit breaker, 2 pole, 20A, Eaton BR220 BRK-20A-2P-240 EPLC-01 Power line carrier (communication bridge pair), quantity - one pair XA-SOLARSHIELD-ES Replace the default solar shield with this Ensemble Combiner Solar Shield to match the look and feel of the Enphase Enpower™ smart switch and the Enphase Encharge™ storage system XA-PLUG-120-3 Accessory receptacle for Power Line Carrier in IQ Combiner 3 (required for EPLC-01) XA-ENV-PCBA-3 Replacement IQ Envoy printed circuit board (PCB) for Combiner 3 **ELECTRICAL SPECIFICATIONS** Rating Continuous duty System voltage 120/240 VAC, 60 Hz Eaton BR series busbar rating 125 A Max. continuous current rating (output to grid) 65 A 90 A Max. fuse/circuit rating (output) Branch circuits (solar and/or storage) Up to four 2-pole Eaton BR series Distributed Generation (DG) breakers only (not included) Max. continuous current rating (input from PV) 64 A 80 A of distributed generation / 95 A with IQ Envoy breaker included Max. total branch circuit breaker rating (input) Envoy breaker 10A or 15A rating GE Q-line/Siemens Type QP /Eaton BR series included 200 A solid core pre-installed and wired to IQ Envoy Production Metering CT MECHANICAL DATA $49.5 \times 37.5 \times 16.8 \text{ cm}$ (19.5" x 14.75" x 6.63"). Height is 21.06" (53.5 cm with mounting brackets). Dimensions (WxHxD) Weight 7.5 kg (16.5 lbs) -40° C to +46° C (-40° to 115° F) Ambient temperature range Cooling Natural convection, plus heat shield Enclosure environmental rating Outdoor, NRTL-certified, NEMA type 3R, polycarbonate construction · 20 A to 50 A breaker inputs: 14 to 4 AWG copper conductors Wire sizes - 60 A breaker branch input: 4 to 1/0 AWG copper conductors Main lug combined output: 10 to 2/0 AWG copper conductors Neutral and ground: 14 to 1/0 copper conductors Always follow local code requirements for conductor sizing. Altitude To 2000 meters (6,560 feet) **INTERNET CONNECTION OPTIONS** Integrated Wi-Fi 802.11b/g/n Ethernet Optional, 802.3, Cat5E (or Cat 6) UTP Ethernet cable (not included) Cellular CELLMODEM-M1 4G based LTE-M cellular modem (not included). Note that an Enphase Mobile Connect cellular modem is required for all Ensemble installations COMPLIANCE Compliance, Combiner UL 1741, CAN/CSA C22.2 No. 107.1, 47 CFR, Part 15, Class B, ICES 003 Production metering: ANSI C12.20 accuracy class 0.5 (PV production)

#### To learn more about Enphase offerings, visit enphase.com

Compliance, IQ Envoy

© 2021 Enphase Energy. All rights reserved. Enphase, the Enphase logo, IQ Combiner 3, and other trademarks or service names are the trademarks of Enphase Energy, Inc. Data subject to change. 2021-05-20

UL 60601-1/CANCSA 22.2 No. 61010-1





#### **CASTILLO ENGINEERING**

SERVICES, LLC COA # 28345 620 N. WYMORE ROAD, SUITE 250, MAITLAND, FL 32751

TEL: (407) 289-2575 ERMOCRATES E. CASTILLO - FL PE 52590 COPYRIGHTED BY

**CASTILLO ENGINEERING** SERVICES, LLC

REVISIONS DESCRIPTION DATE REV

PROJECT INSTALLER



Digitally withighled by: Ermocrates E Castillo Date: his lies has been a extracted, styre: 2021.09.15 in the role architecture beautiful to the role of the role architecture the role of the role architecture that is a fault beautiful to the role of th

HORIZON GLEN CITY, FL 32025

144 SE | LAKE (

PROJECT NAME

STATE OF

RESIDENC HUDSON

SHEET NAME

**DATA SHEET** 

SHEET SIZE **ANSIB** 11" X 17"

SHEET NUMBER **DS-04** 

To learn more about Enphase offerings, visit enphase.com

Data Sheet Enphase Ensemble energy management system

## **Enphase Enpower**

The **Enphase Enpower**™ smart switch connects the home to grid power, the Encharge storage system, and solar PV. It provides microgrid interconnection device (MID) functionality by automatically detecting and seamlessly transitioning the home energy system from grid power to backup power in the event of a grid failure. It consolidates interconnection equipment into a single enclosure and streamlines grid independent capabilities of PV and storage installations by providing a consistent, pre-wired solution for residential applications.



#### Reliable

- · Durable NEMA type 3R enclosure
- Ten-year limited warranty

#### Smart

- · Controls safe connectivity to the grid
- · Automatically detects grid outages
- · Provides seamless transition to backup

#### Simple

- · Connects to the load or service equipment1 side of the main load panel
- Centered mounting brackets support single stud mounting
- Supports conduit entry from the bottom, bottom left side, and bottom right side
- · Supports whole home and partial home backup and subpanel backup
- · Up to 200A main breaker support
- · Includes neutral-forming transformer for split phase 120/240V backup operation
- 1. Enpower is not suitable for use as service equipment in



#### **Enphase Enpower**

MODEL NUMBER		
EP200G101-M240US00	Enphase Enpower smart switch with neutral-forming transformer (MID), breakers, and screws. Streamlines grid-independent capat	
ACCESSORIES and REPLACEMENT PART	·s	
XA-E3-PCBA-ENS	Replacement Enpower controller printed circuit board	
Circuit breakers (as needed) <sup>2,3</sup> BRK-100A-2P-240V BRK-125A-2P-240V BRK-150A-2P-240V BRK-175A-2P-240V BRK-200A-2P-240V BRK-20A-2P-240V-B BRK-30A-2P-240V-B BRK-30A-2P-240V BRK-40A-2P-240V BRK-40A-2P-240V BRK-40A-2P-240V	Not included, must order separately:  • Main breaker, 2 pole, 100A, 25kAIC, CSR2100N or CSR2100  • Main breaker, 2 pole, 125A, 25kAIC, CSR2125N  • Main breaker, 2 pole, 150A, 25kAIC, CSR2150N  • Main breaker, 2 pole, 175A, 25kAIC, CSR2175N  • Main breaker, 2 pole, 200A, 25kAIC, CSR2200N  • Circuit breaker, 2 pole, 200A, 10kAIC, BR220B  • Circuit breaker, 2 pole, 30A, 10kAIC, BR230B  • Circuit breaker, 2 pole, 40A, 10kAIC, BR240B  • Circuit breaker, 2 pole, 60A, 10kAIC, BR260  • Circuit breaker, 2 pole, 80A, 10kAIC, BR260	
EP200G-HNDL-R1	Enpower installation handle kit (order separately)	
ELECTRICAL SPECIFICATIONS		
Assembly rating	Continuous operation at 100% of its rating	
Nominal voltage / range (L-L)	240 VAC / 100 - 310 VAC	
Voltage measurement accuracy	±1% V nominal (±1.2V L-N and ±2.4V L-L)	
Nominal frequency / range	60 Hz / 56 - 63 Hz	
Frequency measurement accuracy	±0.1 Hz	
Maximum continuous current rating	160A	
Maximum output overcurrent protection device	200A	
Maximum input overcurrent protection device	200A	
Maximum overcurrent protection device rating for storage branch circuit <sup>4</sup>	80A	
Maximum overcurrent protection device rating for PV combiner branch circuit <sup>4</sup>	80A	
Neutral Forming Transformer (NFT)	Breaker rating (pre-installed): 40A between L1 and Neutral; 40A Continuous rated power: 3600VA     Maximum continuous unbalance current: 30A @ 120V     Peak rated power: 8800VA for 30 seconds     Peak unbalanced current: 80A @ 120V for 30 seconds	between L2 and Neutral
MECHANICAL DATA		
Dimensions (WxHxD)	50cm x 91.6cm x 24.6cm (19.7 in x 36 in x 9.7 in)	
Weight	38.5 kg (85 lbs)	
Ambient temperature range	-40° C to +50° C (-40° F to 122° F)	
Cooling	Natural convection, plus heat shield	
Enclosure environmental rating	Outdoor, NEMA type 3R, polycarbonate construction	
Altitude	To 2500 meters (8200 feet)	
WIRE SIZES		
Connections	Main lugs, backup load lugs, and CSR breakers     BR breakers (wire provided)     AC combiner lugs, Encharge lugs, and generator (reserved for future use) lugs     Neutral (large lugs)	Cu/AL: 2 AWG - 300 KCMIL 6 AWG 14 AWG - 2 AWG Cu/AL: 6 AWG - 300 KCMIL
Neutral and ground bars	Large holes (5/16-24 UNF) Small holes (10-32 UNF)	14 AWG - 1/0 AWG 14 AWG - 6 AWG
COMPLIANCE		
Compliance	UL 1741, UL 1741 SA, UL1998, UL869A³, UL67°, UL508°, UL50E° CSA 22.2 No. 107.1, 47 CFR, Part 15, Class B, ICES 003, AC156.	

Compatible with BRHDK125 Hold-Down Kit to comply with 2017 NEC 710.15E for back-fed circuit breakers.
 The kAIC of Enpower is the same as the kAIC of the main breaker being installed as listed.
 Not included, installer must provide properly rated breaker per circuit breaker its above.
 Sections from these standards were used during the safety evaluation and included in the UL 1741 listing.

#### To learn more about Enphase offerings, visit **enphase.com**

© 2020 Enphase Energy, All rights reserved. Enphase, the Enphase logo, Enpower, and other trademarks or service names are the trademarks of Enphase Energy, Inc. Data subject to change. 2020-06-16



Castillo C Engineering C

### CASTILLO ENGINEERING

SERVICES, LLC COA # 28345 620 N. WYMORE ROAD, SUITE 250, MAITLAND, FL 32751 TEL: (407) 289-2575 ERMOCRATES E. CASTILLO - FL PE 52590

COPYRIGHTED BY CASTILLO ENGINEERING SERVICES, LLC

REVISIONS				
DESCRIPTION	DATE	REV		

PROJECT INSTALLER



the list has been actionally styres and successful and sound by temperature Display Per 2021.09.15 in the list has been action for the list through the list of th

Date:

HORIZON GLEN, CITY, FL 32025

444 SE | LAKE (

PROJECT NAME

RESIDENC HUDSON

SHEET NAME

DATA SHEET

SHEET SIZE ANSI B 11" X 17"

SHEET NUMBER **DS-05** 

To learn more about Enphase offerings, visit enphase.com

# **Enphase Encharge 10**

The Enphase Encharge 10™ all-in-one AC-coupled storage system is reliable, smart, simple, and safe. It is comprised of three base Encharge 3™ storage units, has a total usable energy capacity of 10.08 kWh and twelve embedded grid-forming microinverters with 3.84 kW power rating. It provides backup capability and installers can quickly design the right system size to meet the needs of both new and retrofit solar customers.



#### Reliable

- · Proven high reliability IQ Series Microinverters
- · Ten-year limited warranty
- · Three independent Encharge storage base units
- · Twelve embedded IQ 8X-BAT Microinverters
- Passive cooling (no moving parts/fans)

#### Smart

- · Grid-forming capability for backup operation
- · Remote software and firmware upgrade
- · Mobile app-based monitoring and control
- · Support for self consumption
- · Utility time of use (TOU) optimization

#### Simple

- · Fully integrated AC battery system
- · Quick and easy plug-and-play installation
- · Interconnects with standard household AC wiring

#### Safe

- · Cells safety tested
- Lithium iron phosphate (LFP) chemistry for maximum safety and longevity



### **Enphase Encharge 10**

ENCHARGE-10-1P-NA	Encharge 10 battery storage system with integrated Enphase Microinverters and battery management unit (BMU). Includes: - Three Encharge 3.36 kWh base units (B03-A01-US00-1-3) - One Encharge 10 cover kit with cover, wall mounting bracket, watertight conduit hubs, and interconnect kit for wiring between batteries (B10-C-1050-0)
ACCESSORIES	
ENCHARGE-HNDL-R1	One set of Encharge base unit installation handles
OUTPUT (AC)	@ 240 VAC¹
Rated (continuous) output power	3.84 kVA
Peak output power	5.7 kVA (10 seconds)
Nominal voltage / range	240 / 211 - 264 VAC
Nominal frequency / range	60 / 57 — 61 Hz
Rated output current	16 A
Peak output current	24.6A (10 seconds)
Power factor (adjustable)	0.85 leading 0.85 lagging
Maximum units per 20 A branch circuit	1 unit (single phase)
Interconnection	Single-phase
Maximum AC short circuit fault current over 3 cycles	69.6 Arms
Round trip efficiency <sup>2</sup>	89%
BATTERY	
Total capacity	10.5 kWh
Usable capacity	10.08 kWh
Round trip efficiency	96%
Nominal DC voltage	67.2 V
Maximum DC voltage	73.5 V
Ambient operating temperature range	-15° C to 55° C (5° F to 131° F) non-condensing
Optimum operating temperature range	0° C to 30° C (32° F to 86° F)
Chemistry	Lithium iron phosphate (LFP)
MECHANICAL DATA	
Dimensions (WxHxD)	1070 mm x 664 mm x 319 mm (42.13 in x 26.14 in x 12.56 in)
Weight	Three individual 44.2 kg (97.4 lbs) base units plus 21.1 kg (48.7 lbs) cover and mounting bracket; total 154.7 kg (341 lbs)
Enclosure	Outdoor - NEMA type 3R
IQ 8X-BAT microinverter enclosure	NEMA type 6
Cooling	Natural convection – No fans
Altitude	Up to 2500 meters (8200 feet)
Mounting	Wall mount
FEATURES AND COMPLIANCE	
Compatibility	Compatible with grid-tied PV systems. Compatible with Enphase M215/M250 and IQ Series Micros, Enphase Enpower, and Enphase IQ Envoy for backup operation.
Communication	Wireless 2.4 GHz
Services	Backup, self-consumption, TOU, Demand Charge, NEM Integrity
Monitoring	Enlighten Manager and MyEnlighten monitoring options; API integration
Compliance	UL 9540, UN 38.3, UL 9540A, UL 1998, UL 991, NEMA Type 3R, AC156 EMI: 47 CFR, Part 15, Class B, ICES 003 Cell Module: UL 1973, UN 38.3 Inverters: UL 62109-1, IEC 62109-2, UL 1741SA, CAN/CSA C22.2 No. 107.1-16, and IEEE 154
LIMITED WARRANTY	
Limited Warranty³	>70% capacity, up to 10 years or 4000 cycles

- Supported in backup/off grid operations
   AC to Battery to AC at 50% power rating.
- 3. Whichever occurs first. Restrictions apply.

#### To learn more about Enphase offerings, visit enphase.com

© 2021 Enphase Energy. All rights reserved. Enphase, the Enphase logo, Encharge 10, and other trademarks or service names are the trademarks of Enphase Energy, Inc. Data subject to change. 2021-03-01





CASTILLO ENGINEERING

SERVICES, LLC
CO.4 # 28345
620 N. WYMORE ROAD,
SUITE 250,
MAITLAND, FL 32751
TEL: (407) 289-2575
ERMOCRATES E. CASTILLO - FL PE 52590

COPYRIGHTED BY CASTILLO ENGINEERING SERVICES, LLC

REVISIONS				
DESCRIPTION	DATE	REV		

PROJECT INSTALLER



the lies has been another rate, styre: 2021.09.15 in the first stand another rate, styre: 2021.09.15 in the first another rate from the first stand in Justice Standard, three beautiful for Justice Standard (Justice Standard Communication of Standard Co

Date:

HORIZON GLEN, CITY, FL 32025

444 SE I LAKE (

PROJECT NAME

HUDSON RESIDENCE

SHEET NAME

DATA SHEET

SHEET SIZE

ANSI B

11" X 17"

SHEET NUMBER


DS-06

To learn more about Enphase offerings, visit enphase.com

# **SOLAR**MOUNT



**SOLARMOUNT** defined the standard in solar racking. Features are designed to get installers off the roof faster. Our grounding & bonding process eliminates copper wire and grounding straps to reduce costs. Systems can be configured with standard or light rail to meet your design requirements at the lowest cost possible. The superior aesthetics package provides a streamlined clean edge for enhanced curb appeal, with no special brackets required for installation.

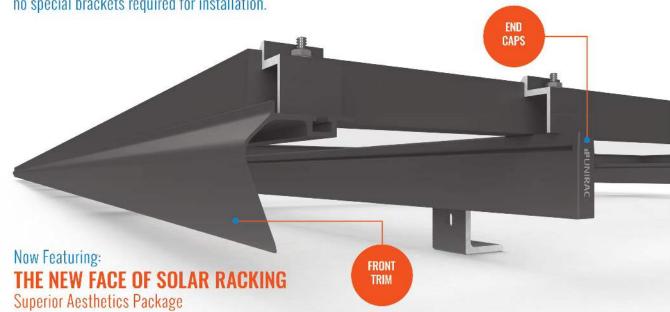







SMALL IS THE NEXT NEW BIG THING Light Rail is Fully Compatible with all SM Components Featuring Google Map Capabilities within U Builder



## **FAST INSTALLATION. SUPERIOR AESTHETICS**

OPTIMIZED COMPONENTS . VERSATILITY . DESIGN TOOLS . QUALITY PROVIDER

# **SOLAR**MOUNT



## **OPTIMIZED COMPONENTS**

labor time. Our new grounding & bonding process eliminates copper wire and grounding


#### **ONE PRODUCT - MANY APPLICATIONS**

Quickly set modules flush to the roof or at a desired tilt angle. Change module to outperform your projects financial and aesthetic aspirations

### **AUTOMATED DESIGN TOOL**

#### DESIGN PLATFORM AT YOUR SERVICE

Save time by creating a user profile, and recall preferences and projects automatically. need to print results and send to a distributor, just click and share

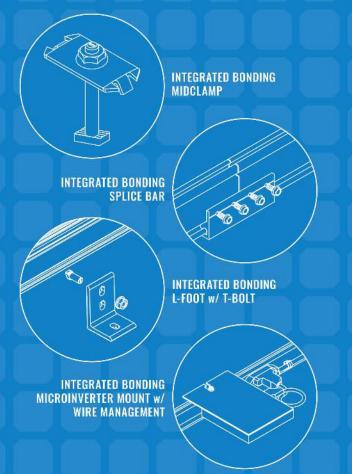



### UNIRAC CUSTOMER SERVICE MEANS THE HIGHEST LEVEL OF PRODUCT SUPPORT















#### **TECHNICAL SUPPORT**

#### **CERTIFIED QUALITY PROVIDER**

#### **BANKABLE WARRANTY**

PROTECT YOUR REPUTATION WITH QUALITY RACKING SOLUTIONS BACKED BY ENGINEERING EXCELLENCE AND A SUPERIOR SUPPLY CHAIN

# Castillo C Engineering C

#### **CASTILLO ENGINEERING** SERVICES, LLC

SUITE 250, MAITLAND, FL 32751

TEL: (407) 289-2575 ERMOCRATES E. CASTILLO - FL PE 5259

COPYRIGHTED BY **CASTILLO ENGINEERING** SERVICES, LLC

REVISIONS

DESCRIPTION	DATE	REV

PROJECT INSTALLER



Ermocrates E Castillo Date: liter Dat Jahn a Antico rest, styres ward by Emiserus Disalty FE 2021.09.15 h. Data and The street Price Gauss for FE 2021.09.15 h. Data and The street Price Gauss for State Control of the Control of t

PROJECT NAME

**HUDSON RESIDENCE** 

44 SE HORIZON GLEN, LAKE CITY, FL 32025

DATA SHEET

SHEET SIZE

**ANSIB** 11" X 17"

SHEET NUMBER

## **FLASH** LOC



**FLASHLOC** is the ultimate attachment for composition shingle and rolled comp roofs. The all-in-one mount installs fast — no kneeling on hot roofs to install flashing, no prying or cutting shingles, no pulling nails. Simply drive the lag bolt and inject sealant into the base. **FLASH**LOC's patented TRIPLE SEAL technology preserves the roof and protects the penetration with a permanent pressure seal. Kitted with lag bolts, sealant, and hardware for maximum convenience. Don't just divert water, **LOC** it out!





#### PROTECT THE ROOF

Install a high-strength waterproof attachment without lifting, prying or damaging shingles.



#### LOC OUT WATER

With an outer shield 1 contour-conforming gasket 2 and pressurized sealant chamber 3 the Triple Seal to create a permanent pressure seal technology delivers a 100% waterproof connection.



#### HIGH-SPEED INSTALL

Simply drive lag bolt and inject sealant into the port 4

## **FLASH** LOC

**INSTALLATION GUIDE** 





Snap chalk lines for attachment rows. On shingle roofs, snap lines 1-3/4" below upslope edge of shingle course. Locate rafters and mark attachment locations.

At each location, drill a 7/32" pilot hole. Clean roof surface of dirt, debris, snow, and ice. Next, BACKFILL ALL PILOT HOLES WITH SEALANT.

NOTE: Space mounts per racking system install specifications.



#### STEP 1: SECURE

Place FLASHLOC over pilot hole with lag on down-slope side. Align indicator marks on sides of mount with chalk line. Pass included lag bolt and sealing washer through FLASHLOC into pilot hole. Drive lag bolt until mount is held firmly in place.

NOTE: The EPDM in the sealing washer will expand beyond the edge of the metal washer when proper torque is applied.



#### STEP 2: SEAL

Insert tip of UNIRAC provided sealant into port. Inject until sealant exits both vents.

Continue array installation, attaching rails to mounts with provided T-bolts.



NOTE: When FLASHLOC is installed over gap between shingle tabs or vertical joints, fill gap/joint with sealant between mount and upslope edge of shingle course.

NOTE: When installing included rail attachment hardware, torque nut to 30 ft/lbs.

USE ONLY UNIRAC APPROVED SEALANTS: Chemlink Duralink 50 (included in kit) or Chemlink M-1

## FASTER INSTALLATION. 25-YEAR WARRANTY.

FOR QUESTIONS OR CUSTOMER SERVICE VISIT UNIRAC.COM OR CALL (505) 248-2702

## FASTER INSTALLATION. 25-YEAR WARRANTY.

FOR QUESTIONS OR CUSTOMER SERVICE VISIT UNIRAC.COM OR CALL (505) 248-2702

### Castillo C Engineering C SOLAR DONE RIGHT®

#### CASTILLO ENGINEERING SERVICES, LLC

COA # 28345 620 N. WYMORE ROAD, SUITE 250, MAITLAND, FL 32751

TEL: (407) 289-2575 ERMOCRATES E. CASTILLO - FL PE 52590

COPYRIGHTED BY **CASTILLO ENGINEERING** SERVICES, LLC

## DESCRIPTION DATE REV

PROJECT INSTALLER



PROJECT NAME

**HUDSON RESIDENCE** 


HORIZON GLEN, CITY, FL 32025

144 SE I LAKE (

DATA SHEET

SHEET SIZE **ANSIB** 11" X 17"

SHEET NUMBER

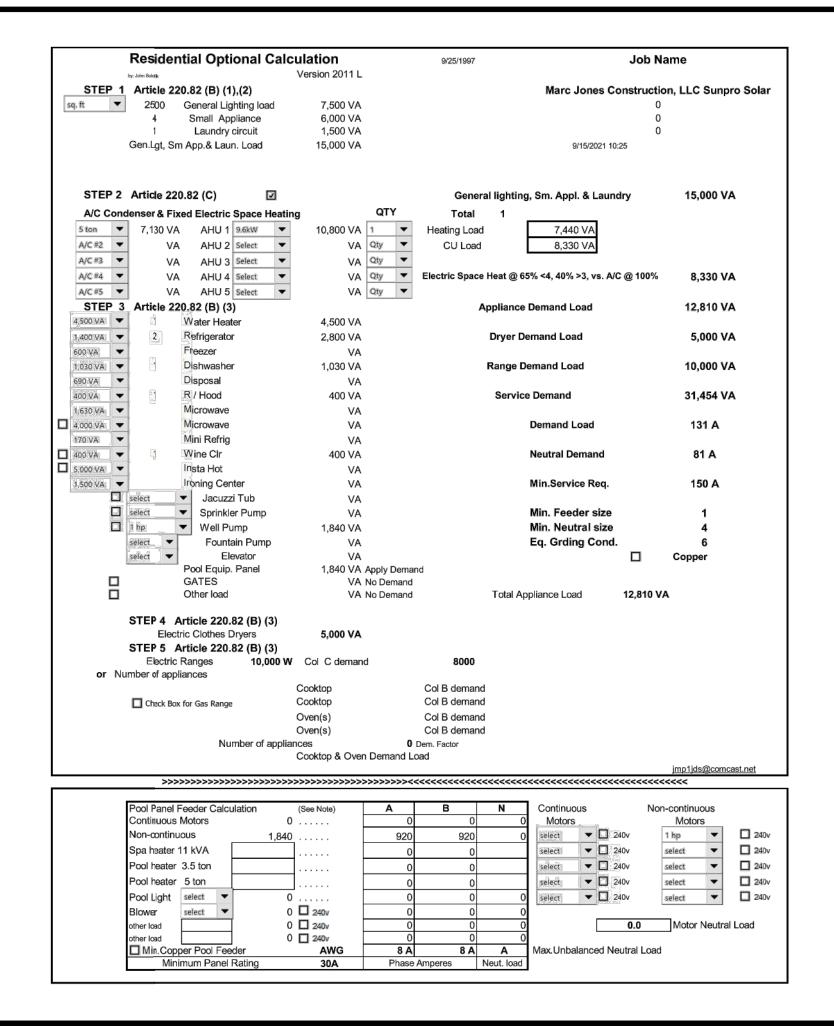

Castillo C Engineering
SOLAR DONE RIGHT®

CASTILLO ENGINEERING

SERVICES, LLC COA # 28345 620 N. WYMORE ROAD, SUITE 250, MAITLAND, FL 32751

TEL: (407) 289-2575 ERMOCRATES E. CASTILLO - FL PE 52590

COPYRIGHTED BY **CASTILLO ENGINEERING** SERVICES, LLC

REVISIONS DESCRIPTION DATE REV

PROJECT INSTALLER



Digitally withighled by: Ermocrates E Castillo Date: liker has same andrien rolls styret award by binner was Dearlies, they have did beginner and their short for Just Espains. In roll could to downer just for contributed digner.

E HORIZON GLEN, E CITY, FL 32025

444 SE I LAKE (

PROJECT NAME

STATE OF

**HUDSON RESIDENC** 

SHEET NAME

DATA SHEET

SHEET SIZE **ANSIB** 11" X 17"

SHEET NUMBER