GENERAL:

T1.D TITLE SHEET OPTION "D"

CIVIL:

C1.D PREFERRED SITE PLAN OPTION "D"

C2.D PREFERRED GRADING PLAN OPTION "

C3.D GENERAL SITE NOTES OPTION "D"

C4.D DETAILS OPTION "D"

C5.D ALTERNATE SITE PLAN OPTION "D"

OWNER:

F1.D FIXTURE PLAN OPTION "D"

ARCHITECTURAL:

A1.D	FLOOR PLAN OPTION "D"	
A2.D	EXTERIOR ELEVATIONS OPTION "D"	
A3.D	SECTIONS AND DETAILS OPTION "D"	
A4.D	SCHEDULES OPTION "D"	
A5.D	DOOR DETAILS OPTION "D"	
A6.D	TOILET PLAN & DETAILS OPTION "D"	
A7.D	SIGN DETAILS OPTION "D"	

STRUCTURAL:

S1.D	STRUCTURAL NOTES OPTION "D"
S2.D	CONCRETE SUMMARY OPTION "D"
S1 of 1:	Revised Foundation

ELECTRICAL:

E1.D	POWER PLAN OPTION "D"
E2.D	LIGHTING PLAN OPTION "D"
E3.D	POWER POLE DETAILS OPTION "D"
E4.D	POWER POLE DETAILS OPTION "D"
E5.D	ELECTRICAL PANELS OPTION "D"
EMS1.D	SENSOR LOCATION PLAN OPTION "D"
EMS2.D	CPU TERMINAL DIAGRAM OPTION "D"
EMS3.D	EMS PANEL AND CONTROLS OPTION "D"
EMS4.D	EMS PANEL AND CONTROLS OPTION "D"
ES1.D	ELECTRICAL SITE LIGHTING PLAN OPTION "I

MECHANICAL:

M1.D HVAC LAYOUT & SCHEDULE OPTION "D"

PLUMBING:

P1.D PLUMBING PLANS OPTION "D"

P2.D PLUMBING DETAILS & RISER DIAGRAMS OPTION "D"


SQUARE FOOTAGE LEGEND										
TOTAL SQUARE FOOTAGE	9,100 S.F.									
OVERALL BUILDING DIMENSIONS	70'-0" X 130'-0"									
SALES FLOOR DIMENSIONS	68'-0" X 107'-6"									
SALES AREA	7,232 S.F.									
STOCK ROOM AREA	1,012 S.F.									
CLEAR OFFICE AREA	145 S.F.									
REST RM, BREAK RM & HALL AREA	223 S.F.									

DEVELOPER'S COMMENTS IN BLUE

Nd a part of permit pakage. See GTC Design Group Site Plan.

SIDE ENTRY WITH RIGHT REAR EXIT OPTION "D"

STORE # 11562

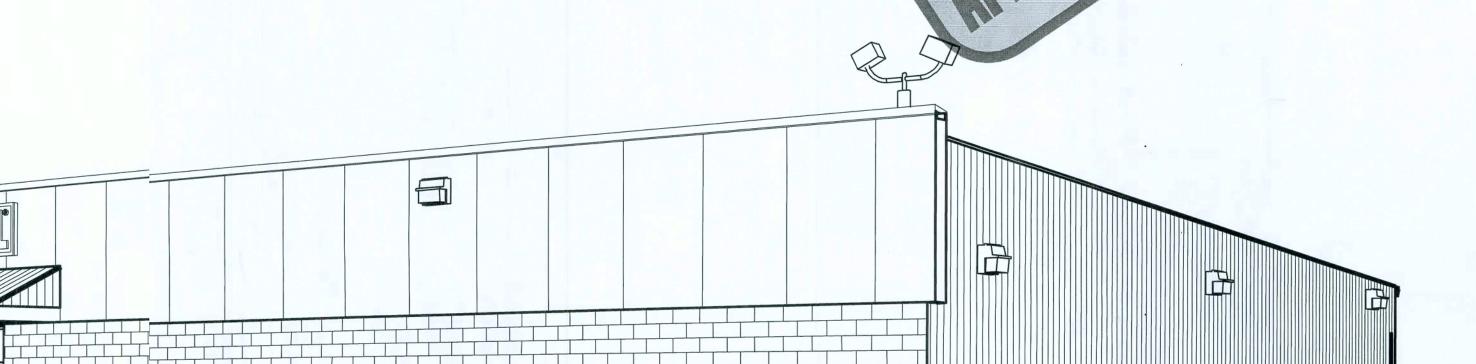



Bulding Group Occupancy: Group M

Construction Type: I I I-Unprotected

Maximum Occupancy: 273

Baic Wind Speed: 110 MPH

Bulding Code: FBC 2004

Wnd Exposure: "B"

*Approval of this set of plans does not revoke the contracted standard provided by the prototypical building plans attached to the lease agreement. Dollar General Prototypical plans shall continue to be the standard set forth for finishes, hardware, and design intent.

APIROVED

By J:ff Steele at 2:28 pm, Mar 03, 2009

NOTE:

BUILDING MUST COMPLY WITH ALL BUILDING (FEDERAL, STATE AND LOCAL) FIRE, ADA AND HEALTH DEPARTMENT CODES.

NO TAPERED OR INTERIOR COLOMIS ALLOWED — O

METAL BUILDING COLUMNS SHALL BE STRAIGHT APERED COLUMNS & INTERIOR COLUMNS REQUIRE WRITTEN APPROVAL. MAINTAIN INTERIOR CLEARANCE OF 68'-1 1/4" BETWEEN FACE OF COLUMNS ON SALES FLOOR.

AL PROTOTYPICAL
PLAN INQUIRIES MAY BE
DILECTED TO THE
DULAR GENERAL
AMOCAD-STORET
DEIGN DEPARTMENT
AT(615), 855-4753 OR
CONSTRUCTIONCAD@
DULARGENERAL.COM



UPDATE WITH ATTACHED VENDOR LIST

	REQUIRED NATIONAL ACC	OUNT VENDORS		
	COMPANY	CONTACTS	PHONE #	REQUIRED ITEMS
	BASS SECURITY SERVICE, INC.	NATIONAL ACCOUNT SALES	888-774-3400 EXT. 2022	DOOR HARDWARE AND RESTROOM ACCESSORIES
	MC CUE CORPORATION	DENISE CURRMAN	800-800-8503 EXT. 290	CART BUMPERS AND CORNER GUARDS PART# 9014 TRIMKIT
	LENNOX	JOSHUA PLUMMER	800-367-6285 OPT.1	HVAC UNITS - (LOW GAS) KGA060S4B-DG / ELEC.) KCA060S4B-DG
	CARRIER	ALISON HARTMAN	800-690-1081	HVAC UNITS - (HIGH GAS) 48TCFA06A1A3A0A0A0A1-DG
	SHERWIN WILLIAMS	LOCAL SHERWIN WILLIAMS STORE		PAINT, PRIMER, CONCRETE SEALER AND BLOCK FILLER
	STANLEY DOORS	ART BULLMAN RYAN DRISCOLL	636-391-1508 800-648-1401 OPT. 2, EXT. 6	AUTOMATIC DOORS AND STORE FRONT GLAZING SYSTEM
	D&P CUSTOM LIGHTING	NATIONAL ACCOUNT SALES	800-251-2200	CUSTOM POWER POLES
9	EMERSON CLIMATE TECHHNOLOGIES	PETE STEVENS	770-425-2724	EMS SUPPLIER
	RETROPLATE SYSTEMS	LEO HENDERSON general-dollar@retroplatesystem.com	888-942-3144	CONCRETE POLISHING SYSTEMS
	CONSOLIDATED ELECTRIVICAL DISTRIBUTORS	ROBERT DECKER	270-781-2229	ELECTRICAL, LIGHTING SUPPLIES

OPTIONAL NATIONAL ACCOUNT VENDORS

COMPANY	CONTACTS	PHONE #	REQUIRED ITEMS
LIBERTY BUILDING SYSTEEMS	DAVID ENGLISH	877-505-4596	PRE-ENGINEERED METAL BUILDING
STAR BUILDING SYSTEMS	JEFF HORN	866-664-8899	PRE-ENGINEERED METAL BUILDING
NUCOR BUILDING SYSTEEMS	TY DAVENPORT	803-799-9708	PRE-ENGINEERED METAL BUILDING
CASCO	JOHN HARRIS	314-821-1100	PROFESSIONAL SERVICES

NATIONAL ACCOUNT & CONTACT INFORMATION SUBJECT TO CHANGE

TITLE SHEET OPTION "D"



DATE

05/19/03

SHEET NUMBER

T1.D




	RVICES, IN(C. 888-774-3400 EXT. 2022					
BASS	S SECUJRITY PARTS					
402-1/2B-26D	IVES WALL STOP					
54-US32D	BURNS; PUSH PLATE					
8400-S32D-8X34	IVES KI(CK PLATE					
5410-32D-26D-GRIP	BURNS; PULL PLATE					
W101S-DANE-626	FALCON PASSAGE LEVERSET					
W581PD-DANE-626	FALCON STOREROOM LEVERSET					
2670-28	VON DUPRIN GUARD-X EXIT ALARM LOCK					
7015SC8-26D *	IICO RINM CYLINDER					
2609 **	VON DUPRIN GUARD-X DOUBLE DOOR STRIKE					
DDH-2250 **	DETEX DOUBLE DOOR HOLDER					
5400	HAGER≀ DOOR CLOSER					
TA3310PC	TACO DOOR VIEWER					
DS/1000MB	DOOR SSCOPE (FOR RECEIVING EXIT DOOR)					
425 HD - 6 FT.	NATIONAL GUARD HD THRESHOLD (FOR RECEIVING EXIT DOOR)					
452B26D-4	IVES 4" ' DOOR HOLDER					
608Z	8" DOOR HOLDER					
B155	BOBRICOK 24 OZ. SOAP DISPENSER					
T-1024-36-SS	BREY-K <rause mirror<="" td=""></rause>					
B2740	BOBRICK DOUBLE TOILET TISSUE DISPENSER					
B253	BOBRICK PAPER TOWEL HOLDER					
D-7816-SS	BREY-K <rause 36"="" bar<="" grab="" td=""></rause>					
D-7815-SS	BREY-K <rause 42"="" bar<="" grab="" td=""></rause>					
D-7812-SS	BREY-K <rause 18"="" bar<="" grab="" td=""></rause>					

* MUST HAVE ONE RIM PER EXXIT DEVICE.


** MUST HAVE DOUBLE DOOR STRIKE AND TWO DOUBLE DOOR HOLDERS FOR ALL DOUBLE EXXIT DOORS.




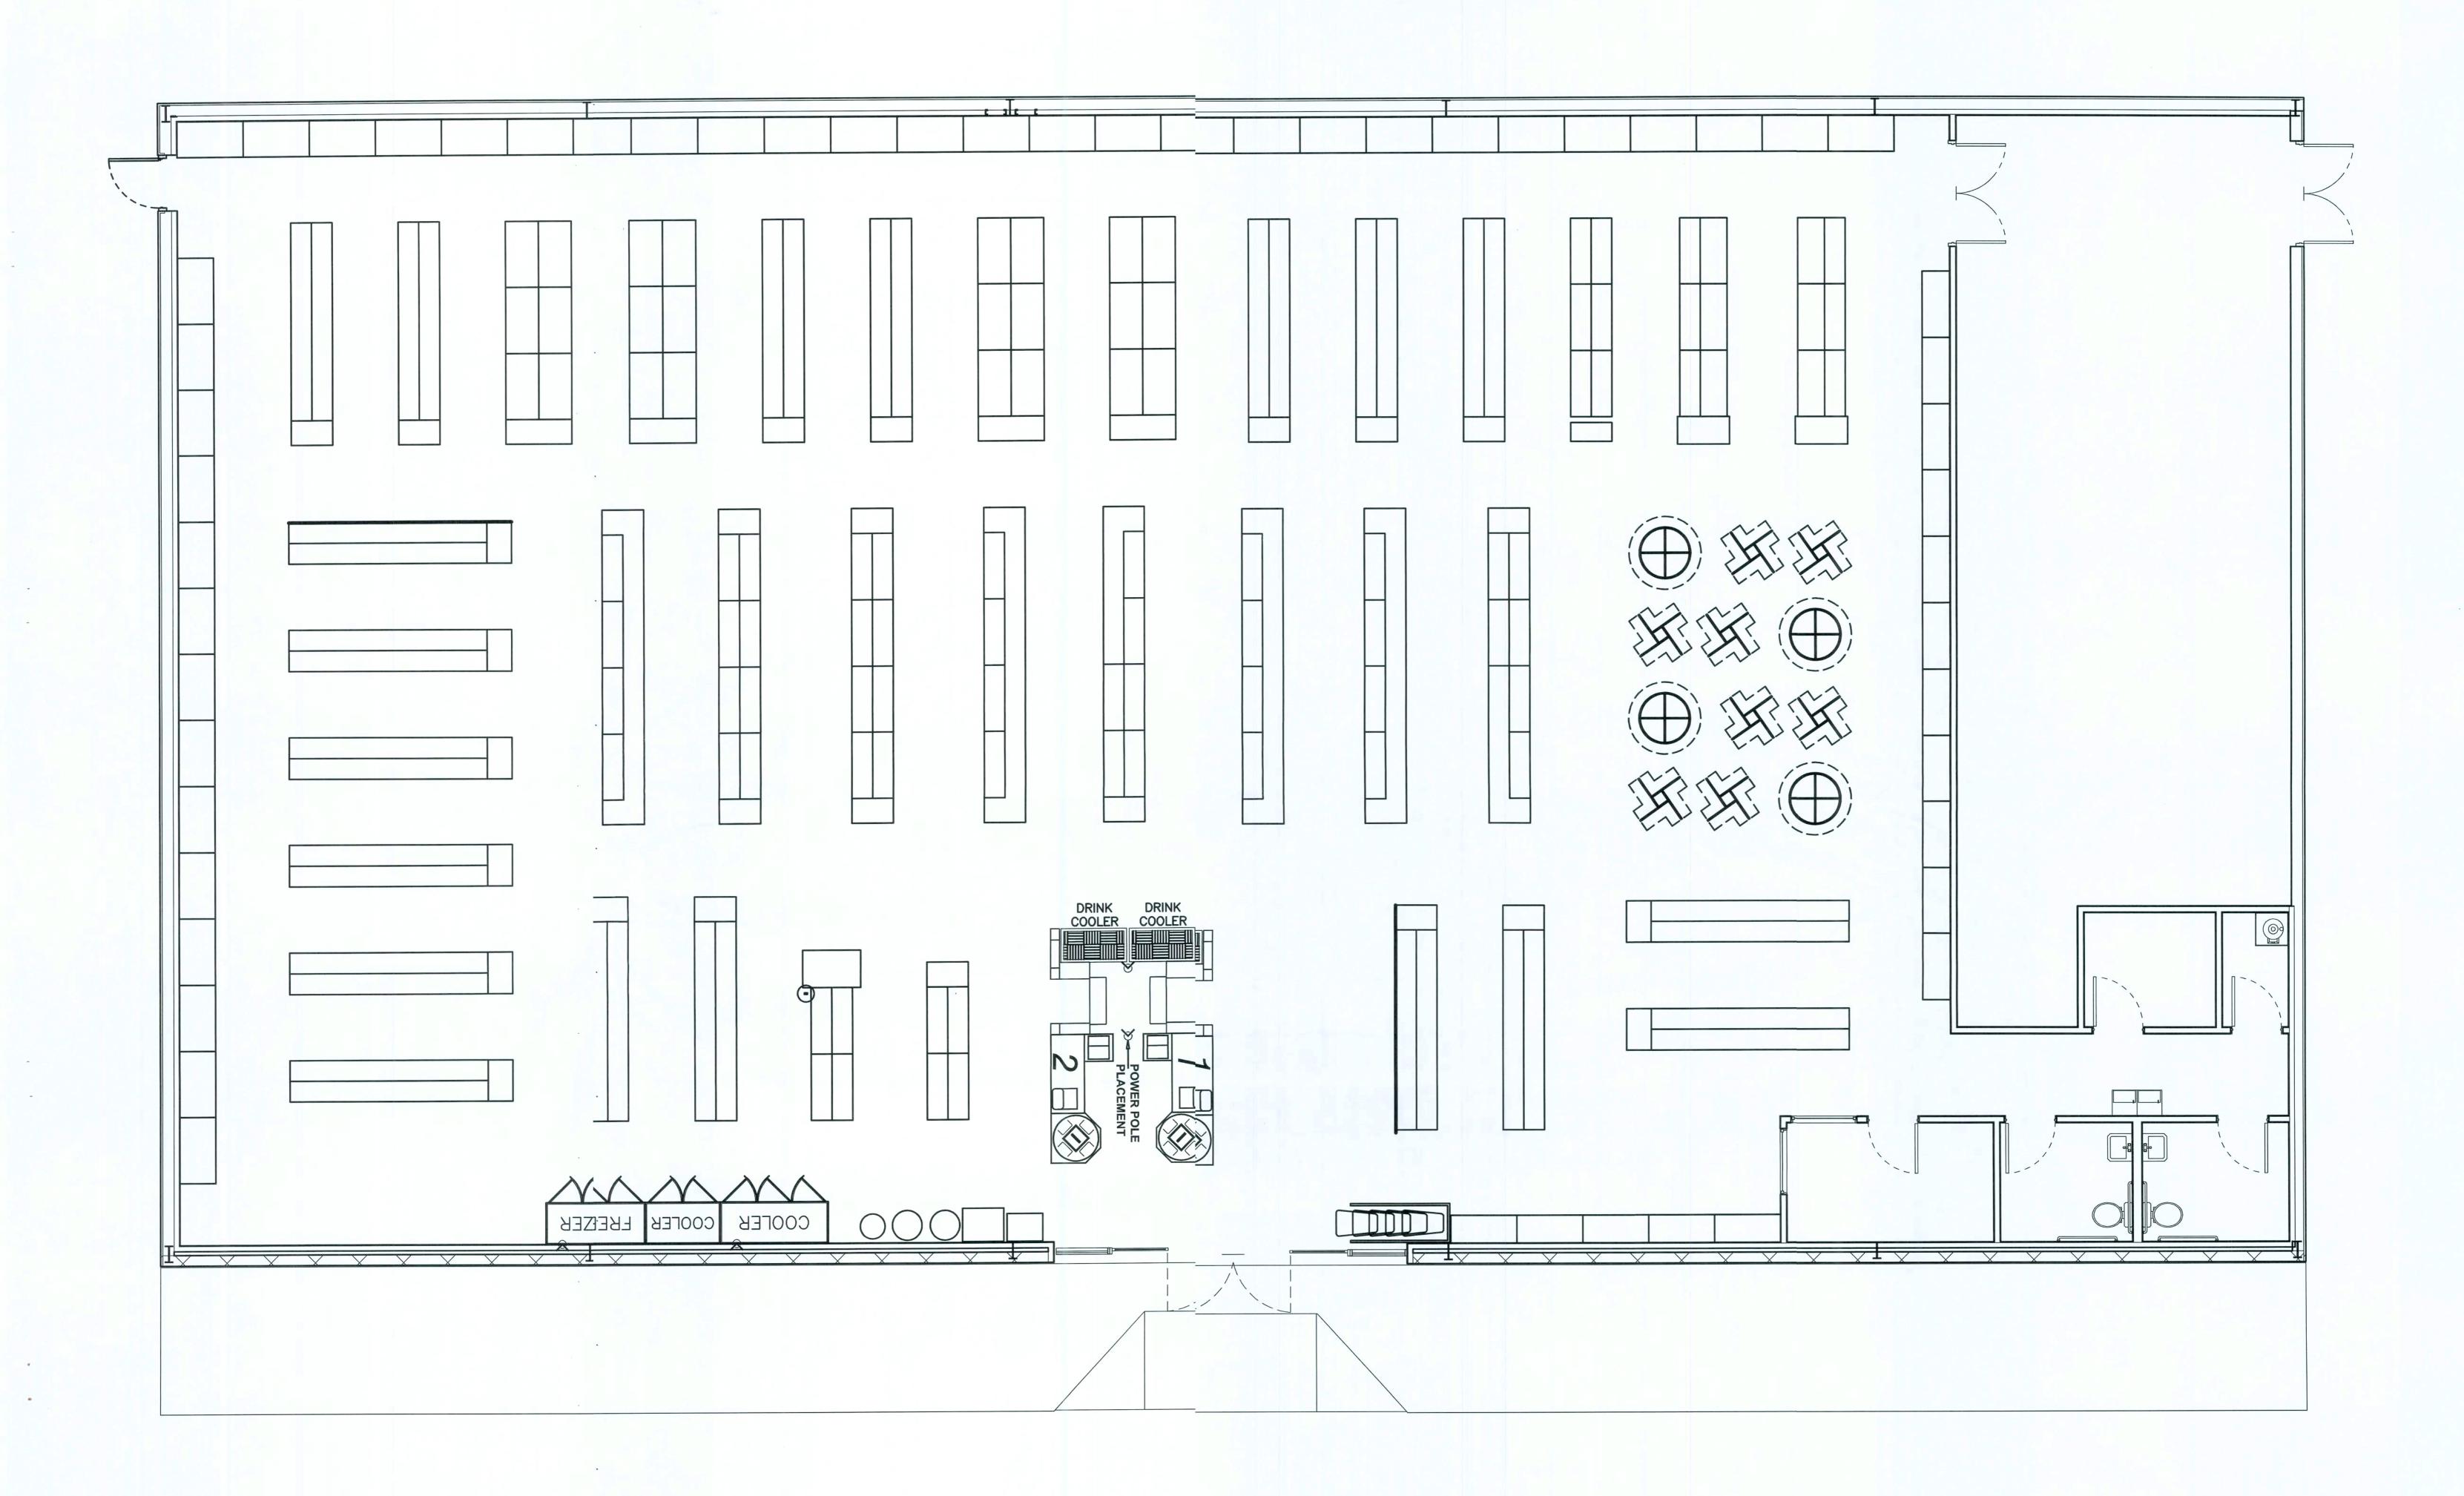


Current PLAN D approved as of Dec. 2008

Minos 27 Man 2169

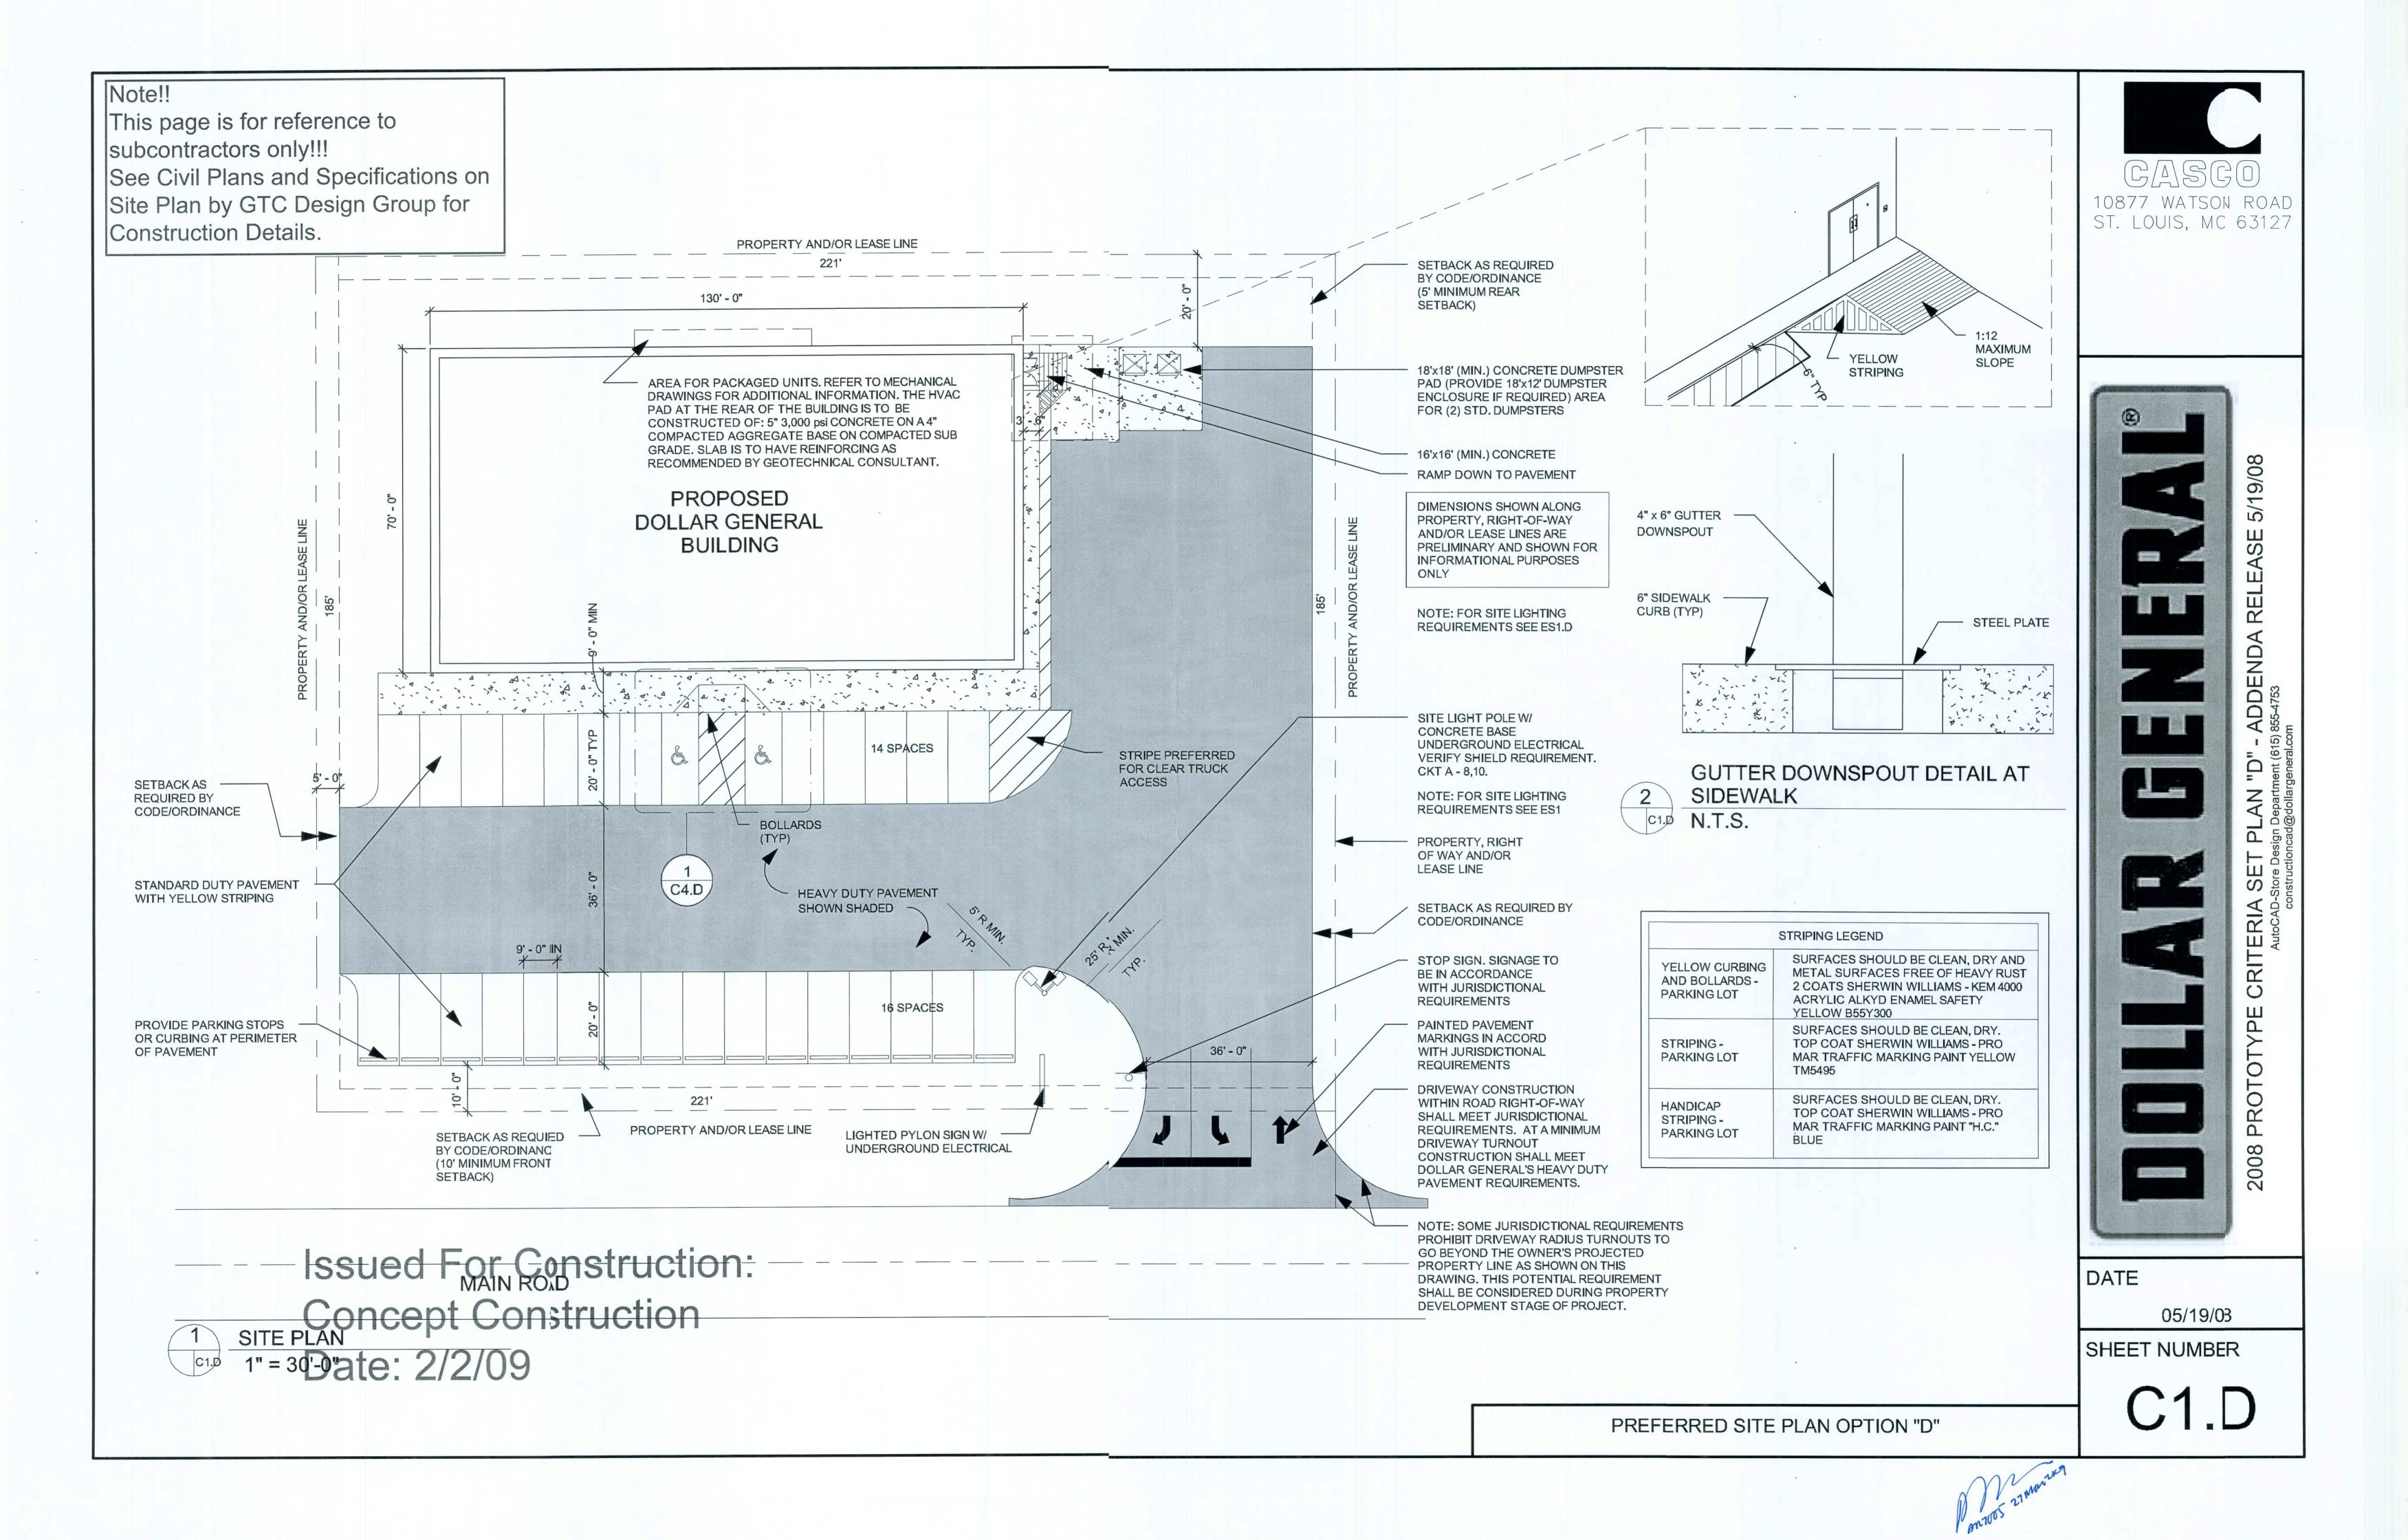

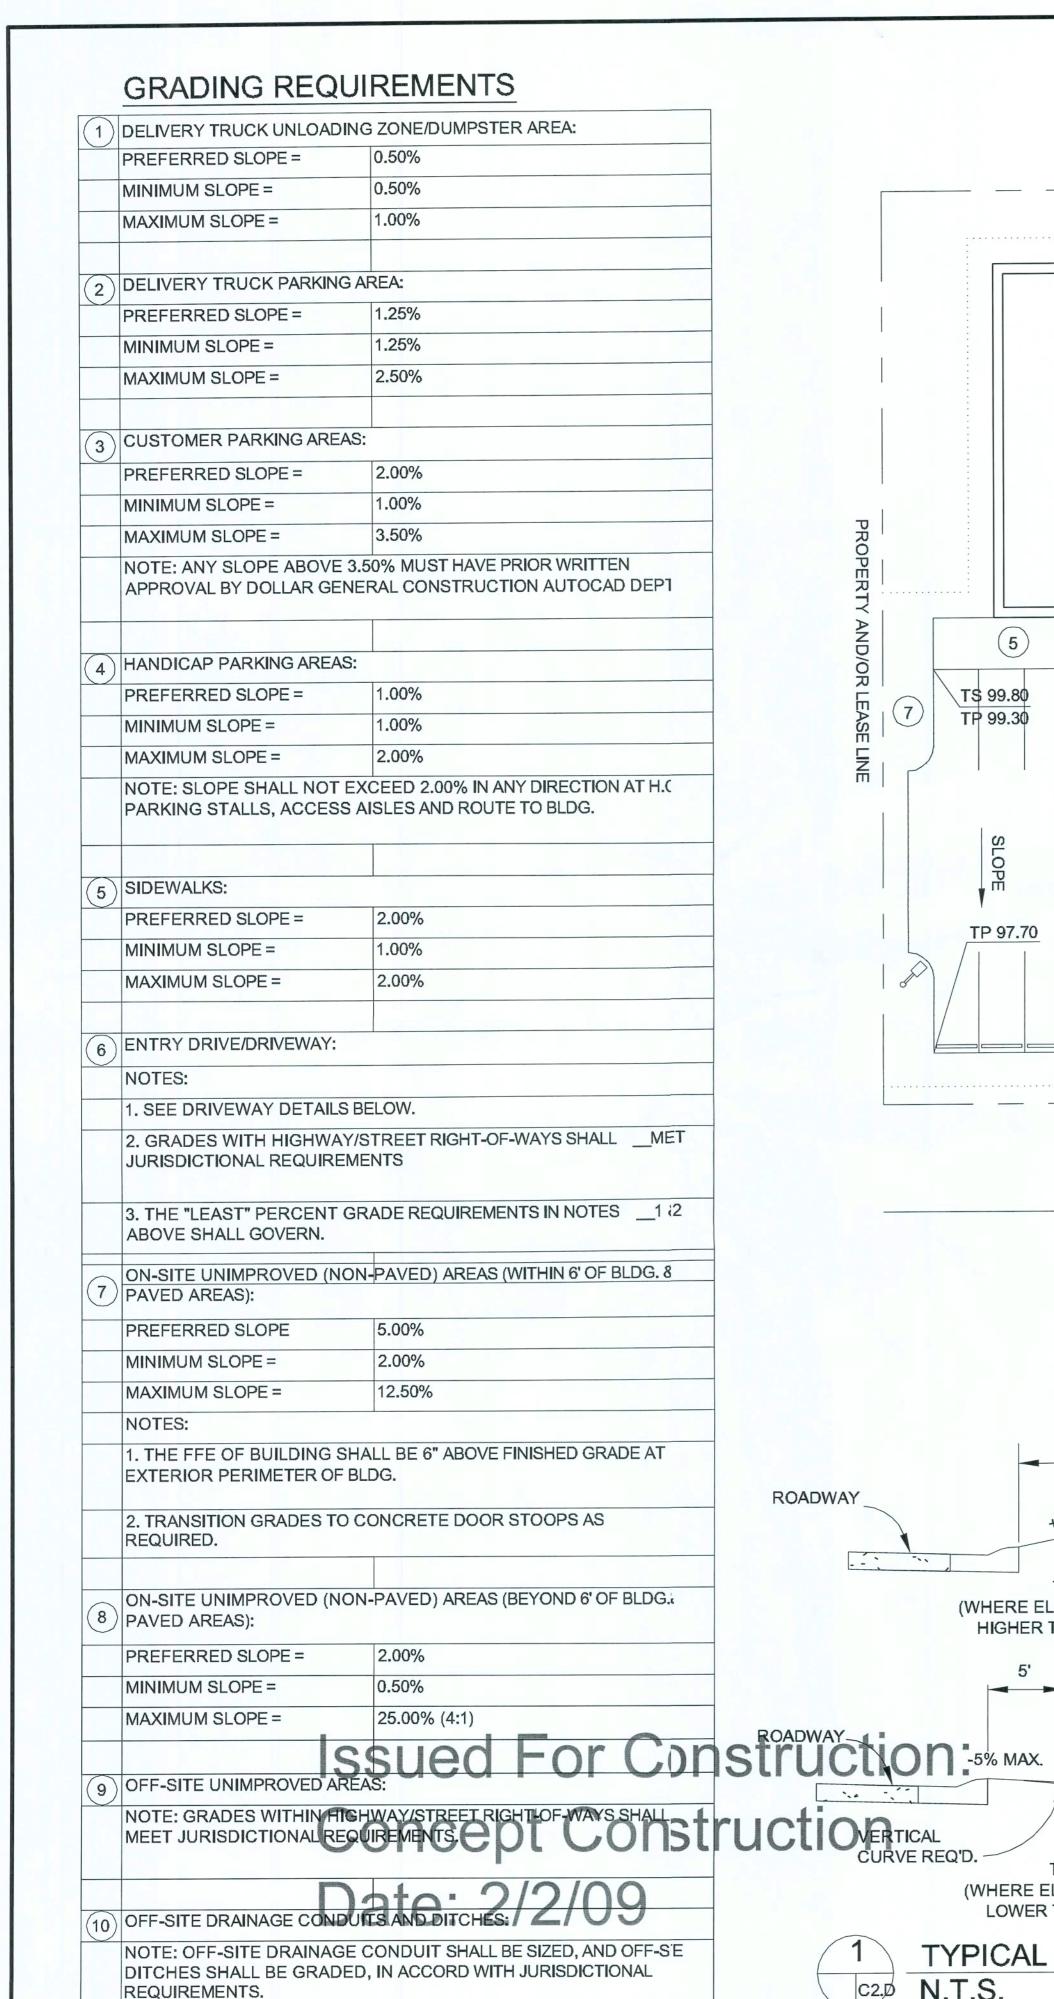

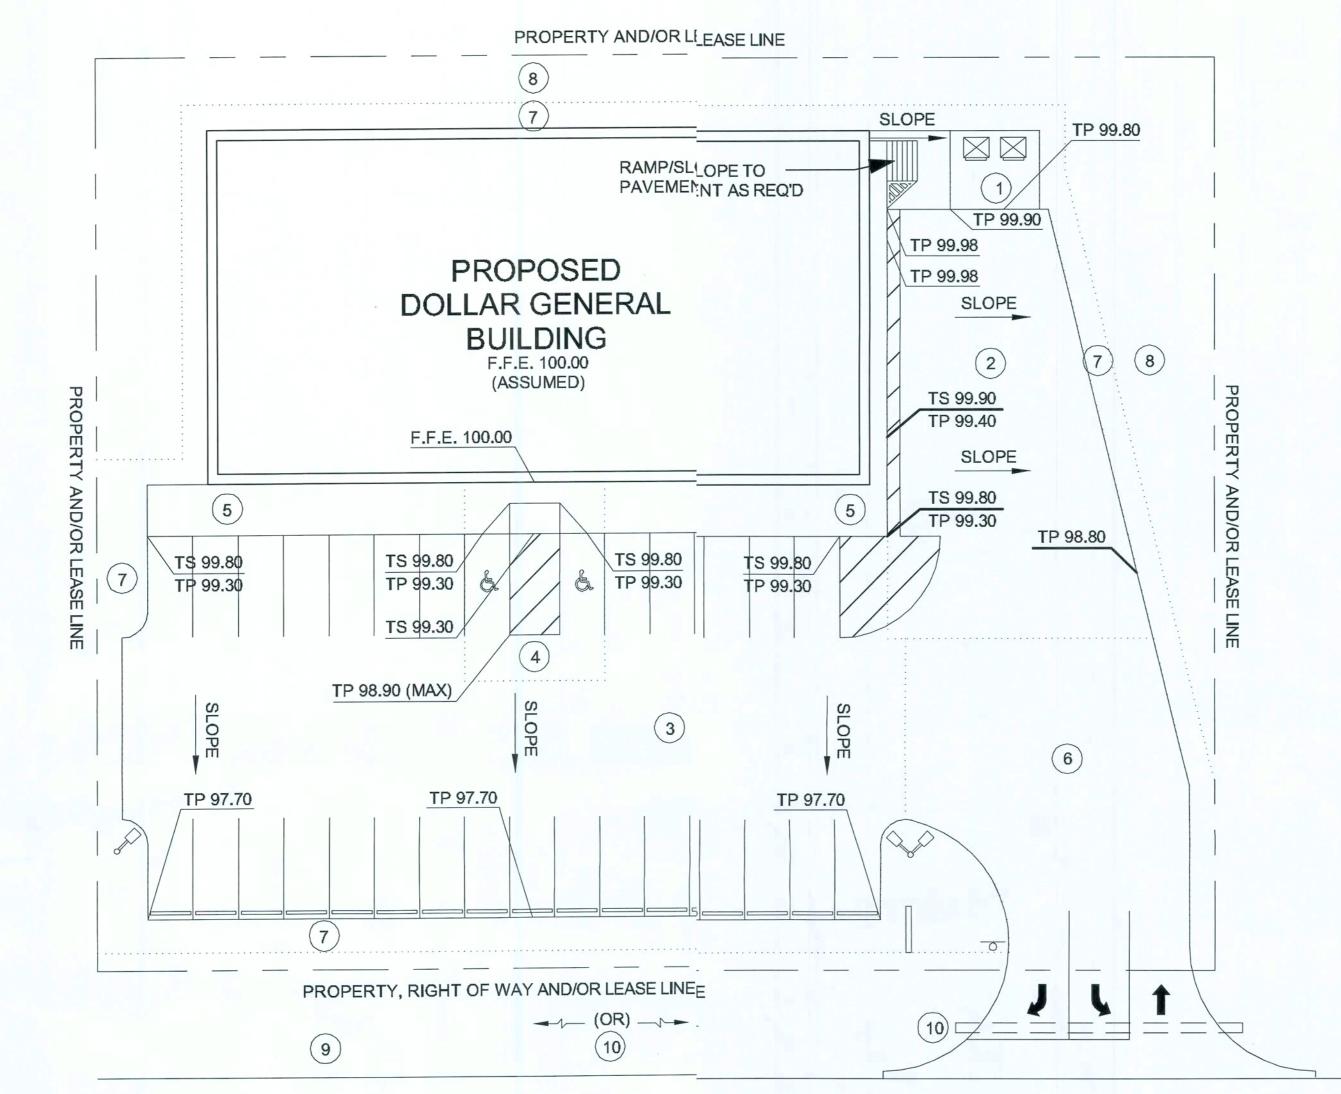

PARKING ; LOT

PARKINGG LOT

VARIES

CURVE REQ'D.

+8.5% MAX.

TYPICAL DRIVEWAY

(WHERE ELEVATION OF PARKING LOT IS

HIGHER THAN ADJACENT ROADWAY)

VARIES

CURVE REQ'D.

VERTICAL

-8.5% MAX.

TYPICAL DRIVEWAY

(WHERE ELEVATION OF PARKING LOT IS

TYPICAL DRIVEWAY DETAIL

N.T.S.

LOWER THAN ADJACENT ROADWAY)

GRADING GENERAL NOTES:

1. PREFERRED GRADING PLAN SHOWN HEREIN IS PROVIDED FOR INFORMATIONAL AND PRELIMINARY PURPOSES ONLY. DEVELOPER SHALL SUBMIT DESIGN GRADING PLAN TO DOLLAR GENERAL FOR PRIOR APPROVAL. PRELIMINARY GRADING PLAN SHOWN HEREIN DOES NOT INCLUDE ANY PROVISIONS FOR STORM WATER DETENTION OR OTHER POTENTIAL JURISDICTIONAL REQUIREMENTS.

2. A STORM WATER POLLUTION PREVENTION PLAN (SWPPP) SHALL BE COMPLETED FOR THIS PROJECT IN ACCORDANCE WITH JURISDICTIONAL REQUIREMENTS.

3. SPOT GRADES SHOWN ARE BASED ON SIDEWALKS HAVING A 6" HIGH INTEGRAL CURB AT PERIMETER (PARKING LOT FRONT & SIDE).

4. GRADES SHOWN HEREIN DO NOT ASSUME ANY LEDGES AT BUILDING PERIMETER FOR BRICK VENEER OR METAL BUILDING WALL PANELS.

5. PLAN SHOWN HEREIN IS BASED ON PAVEMENT WITHOUT CURBS AND/OR GUTTERS. PLAN IS BASED ON SHEET FLOW TO EARTHEN DITCHES BEYOND THE EDGES OF THE PAVEMENT.

LEGEND

FINISH FLOOR ELEVATION (ASSUMED)

TOP OF SIDEWALK ELEVATION

TOP OF FINISH PAVEMENT ELEVATION

Note!!

This page is for reference to subcontractors only!!! See Civil Plans and Specifications on Site Plan by GTC Design Group for Construction Details.

DRIVEWAY DETAIL NOTES:

1. DRIVEWAYS SHALL BE CONSTRUCTED IN ACCORDANCE WITH JURISDICTIONAL REQUIREMENTS AND DOLLAR GENERAL REQUIREMENTS SHOWN HEREIN. DRIVEWAY GRADES SHOWN HEREIN ARE DOLLAR GENERAL'S PREFERRED MAXIMUM AND MINIMUM GRADES. IT IS UNDERSTOOD THAT EXCEPTIONS TO THESE REQUIREMENTS MAY BE REQUIRED AT SOME SITES BASED ON ACCEPTABLE GRADING REQUIREMENTS AT DIFFERENT GEOGRAPHIC REGIONS THROUGHOUT THE USA. HOWEVER, ANY EXCEPTIONS SHALL BE SUBMITTED TO DOLLAR GENERAL AUTOCAD/STORE DESIGN DEPARTMENT FOR PRIOR APPROVAL. SUBMITTAL SHALL INCLUDE DATA INDICATING THAT PROPOSED DESIGN IS IN ACCORDANCE WITH JURISDICTIONAL (CITY, COUNTY, STATE, ETC.) ACCEPTABLE STANDARDS. DATA SHALL INCLUDE DRAWING DETAILS, LOCAL JURISDICTIONAL APPROVALS (LETTERS, PERMITS, COPIES OF LOCAL DESIGN GUIDELINES, ETC.), AND ENGINEERING DATA THAT ILLUSTRATES THAT A TYPICAL DOLLAR GENERAL TRACTOR TRAILER DELIVERY TRUCK CAN ACCESS THE SITE WITHIN NORMAL OR REASONABLE MANEUVERING TOLERANCES. SUBMITTAL SHALL INCLUDED A SIGNED AND PROFESSIONAL SEALED LETTER FROM A LICENSED CIVIL ENGINEER CERTIFYING THAT THE DESIGN IS IN AND EGRESS REQUIREMENTS SHOULD BE VERIFIED THROUGH DOLLAR GENERAL AUTOCAD - STORE DESIGN DEPARMTMENT. DEVELOPER SHALL CONTACT DOLLAR GENERAL AUTOCAD/STORE DESIGN DEPARTMENT TO DETERMINE WHICH TYPE OF DELIVERY TRUCK THE DESIGN SHALL BE BASED UPON.

2. VERIFY JURISDICTIONAL REQUIREMENTS WILL ALLOW THE PAVEMENT TO SLOPE DIRECTLY TO THE ROAD AS SHOWN ON THE DETAIL WHERE THE PARKING LOT IS HIGHER THAN THE ROAD ELEVATION. RATHER, THE PAVEMENT MUST SLOPE DOWNWARD, AWAY FROM THE ROAD, FOR A REQUIRED DISTANCE PRIOR TO SLOPING UPWARD TO THE SITE. REF DET 1/C1.D.

PREFERRED GRADING PLAN OPTION "A"



5/19/08 AS REL ADDEND/ PLAN sign Departm SET -ERIA CRIT PROT 2008

DATE

05/19/08

SHEET NUMBER

A. GENERAL CIVIL SITEWORK NOTES:

- 1. THE CIVIL SITEWORK DRAWINGS IN THIS PACKAGE ARE PROVIDED TONDICATE MINIMUM STANDARDS FOR DOLLAR GENERAL NEW STORE DEVELOPMENTS. IT IS OT INTENDED, NOR WILL BE ACCEPTABLE BY DOLLAR GENERAL, AS FINAL CIVIL SITEWORK DRAWING AND/OR SPECIFICATIONS FOR NEW STORE SITE DEVELOPMENTS. COORDINATE SITE SPECIFIC PLAS WITH ALL DISCIPLINES.
- 2. PRIOR TO CONSTRUCTION DEVELOPER SHALL PROVIDE DOLLAR GENRAL AUTOCAD/STORE DESIGN DEPARTMENT A COMPLETE SET OF CIVIL SITEWORK DRAWINGS STAMPD BY A CIVIL ENGINEER LICENSED IN THE STATE IN WHICH THE DEVELOPMENT IS PROPOSED. DOLLAR GEERAL SHALL APPROVE ENGINEERED DRAWINGS PRIOR TO DEVELOPER STARTING CONSTRUCTION. ANY MAJO MODIFICATIONS OF THE DRAWINGS, AFTER INITIAL APPROVAL, SHALL BE RESUBMITTED TO DOLLAR GENERAL FOR PRIOR APPROVAL. ANY CHANGES MADE THAT ARE NOT APPROVED BY DOLLAFGENERAL AUTOCAD/STORE DESIGN DEPARTMENT, MAY NOT BE ACCEPTABLE, AND MAY REQUIRE RECONSTRCTION.
- 3. A BOUNDARY AND TOPOGRAPHIC SURVEY SHALL BE INCLUDED IN TH CIVIL SITEWORK DRAWINGS SUBMITTED TO DOLLAR GENERAL. THE DRAWINGS SHALL BE STAMPED IN A PROFESSIONAL LICENSED SURVEYOR REGISTERED IN THE STATE IN WHICH THE DEVELOMENT IS PROPOSED. TOPOGRAPHIC SURVEY SHALL SHOW UTILITIES (ABOVE AND UNDERGROND) AND EXISTING GRADE CONTOURS AT ONE (1') INTERVALS. TOPOGRAPHIC SURVEY SHAL EXTEND BEYOND THE PROPERTY BOUNDARY AS REQUIRED TO SHOW LOCAL STREETS, NARBY INTERSECTIONS, ADJACENT DITCHES, ETC. AS ITEMS PERTAIN TO NEW DEVELOPMENT.
- 4. A UTILITY PLAN SHALL BE INCLUDED IN THE CIVIL SITEWORK DRAWING.
 THE PLAN SHALL INCLUDE UTILITIES REQUIRED FOR BUILDING SERVICES
 AND ANY UTILITY MAIN IMPROVEMENTS THAT MAY BE REQUIRED. UTILIT DETAILS SHALL BE
 INCLUDED IN THE DRAWINGS. UTILITIES SHALL BE DESIGNED AND INSTALED IN ACCORDANCE WITH
 ALL JURIDICTIONAL REQUIREMENTS.
- 5. DEVELOPER AND/OR CONTRACTOR IS RESPONSIBLE FOR ANY NATIONAL, STATE AND/OR LOCAL STORM WATER POLLUTION PREVENTION PLAN (SWPPP) REQUIREMENTSEROSION CONTROL MEASURES SHALL BE INSTALL AS REQUIRED TO INSURE THAT NO SEDIMNT IS CONVEYED OFF THE SITE TO ADJACENT PROPERTIES. AT A MINIMUM, CONTRACTOR/DEVELCER SHALL SEED, FERTILIZE AND MULCH ALL DISTURBED AREAS. A SUITABLE STAND OF GRASS SHALBE OBTAINED AT ALL UNIMPROVED AND NON-LANDSCAPED AREAS.
- 6. PROVISIONS FOR LOCAL AND/OR REGIONAL LANDSCAPING REQUIREMNTS, INCLUDING LANDSCAPING IRRIGATION, ARE NOT SHOWN ON THESE DRAWINGS. DEELOPER SHALL PROVIDE LANDSCAPING IN ACCORDANCE WITH JURISDICTIONAL REQUIREMENTS.
- 7. HANDICAP REQUIREMENTS SHOWN ON THE DRAWINGS ARE MINIMUM EQUIREMENTS.

 DEVELOPMENT SHALL BE IN ACCORDANCE WITH FEDERAL AND LOCAL RQUIREMENTS FOR HANDICAP ACCESSIBILITY, INCLUDING BUT NOT LIMITED TO THE AMERICAN WITH ESABILITIES ACT ACCESSIBILITY GUIDELINES.
- 8. PRIOR TO FINAL ACCEPTANCE OF STORE BY DOLLAR GENERAL, THE ITE SHALL BE CLEAN OF ALL DEBRIS AND TRASH.
- 9. DEVELOPER SHALL OBTAIN ALL JURISDICTIONAL APPROVALS AND PEMITS REQUIRED FOR THE DEVELOPMENT.
- 10. WHERE OFFSITE WORK IS REQUIRED FOR THE DEVELOPMENT, SUCHAS DOT STREET IMPROVEMENTS, UTILITY IMPROVEMENTS, ETC., DEVELOPER SHALL INCOPPORATE THE IMPROVEMENTS AND/OR OFFSITE DESIGN DRAWINGS INTO THE DOLLARGENERAL SITEWORK DRAWINGS.
- 11. DOLLAR GENERAL MINIMUM PAVEMENT RECOMMENDATIONS MUST E MET. DEVIATIONS WILL REQUIRE A GEOTECHNICAL INVESTIGATION INCLUDING DESIGN RECOMENDATIONS AND APPROVAL BY DOLLAR GENERAL AUTOCAD-STORE DESIGN

B. SITE ELECTRICAL AND SIGNAGE GENERAL NOTES:

- 1. UNDERGROUND ELECTRICAL SERVICE IS PREFERRED FOR DOLLAR GNERAL DEVELOPMENTS. TRANSFORMER PAD DESIGN SHALL BE PROVIDED BY ELECTRICAL UTILIY PROVIDER AND SHALL BE BOLLARD PROTECTED WHEN LOCATED IN A HAZARDOUS AREA.
- 2. SITE LIGHTING SHALL BE DESIGNED TO PROVIDE A MINIMUM OF TWO OOT-CANDLES AT THE PARKING LOT AREAS, BUILDING ENTRANCES, DUMPSTER AREA AND TRUK DELIVERY AREA. THE OUTER PERIMETER OF THE BUILDING SHALL BE LIGHTED FOR SECURITY SITE LIGHTING SHALL BE INSTALLED ALONG THE WALLS OF THE BUILDING AND POLE MOUNTED ATHE PERIMETER OF THE PARKING LOT.
- 3. REQUIRED POLE MOUNTED LIGHTING: 25' HEIGHT POLES WITH 1,000 WITT METAL HALIDE HEADS
- 4. REQUIRED WALL MOUNTED LIGHTING: 400 WATE METAL HALIDE WALL'ACKS WITH TIMER AND PHOTOCELL
- 5. REQUIRED BULL HORN LIGHTING: 400 WATT METAL HAZIDE FLOOD LIGH

- 6. LIGHTED PYLON SIGN: PROVIDE CONDUIT FROM ELEECTRICAL PANEL TO LOCATION OF THE PYLON SIGN BASE. BURY CONDUIT TO PYLON. THE CONDUIT IS TO BE 1" AND HAVE ONE SET OF 10/2 WIRE WITH GROUND AND A 20-AMP 2-POLE BREAKER AT THE PANEL. A TEMPORARY 3' TALL WIRING STAKE SHALL BE PROVIDED AT THE PYLON SIGN LOCATION UJNTIL THE SIGN IS PERMANENTLY INSTALLED.
- 7. LIGHTED BUILDING SIGN: PROVIDE CONDUIT FROM FELECTRICAL PANEL TO THE CENTER OF THE SIGN CANOPY. THE CONDUIT IS TO BE 1" AND HAVE ONE SEET OF 10/2 WIRE WITH GROUND AND A 20-AMP 2-POLE BREAKER AT THE PANEL. BUILDING CANOPY MUST BE SUFFICIENTLY BUILT TO SUPPORT THE DOLLAR GENERAL SIGN. SIGN WEIGHT UP TO 1,400 LBBS. NOTE: IF THE LEASE SPECIFIES A 5'-0" X 40'-0" BUILDING SIGN OR 24" LETTER SET (OR LARGER), 2 QTTY. 10/2 WIRE WITH GROUND AND 2 QTY. 20 AMP CIRCUITS REQUIRED.
- 8. UNDERGROUND ELECTRICAL SHALL BE PROVIDED TO THE SITE LIGHT POLES.
- 9. THE FINAL PYLON SIGN CONNECTION AND UNDERGIROUND CONDUIT IS LANDLORD RESPONSIBILITY.
- 10. DOLLAR GENERAL VENDOR PRICING FOR LIGHTING WALL PACKS AND POLE LIGHT FIXTURES IS AVAILABLE FROM CED ELECTRICAL; CON TACT ROBERT DECKER AT 270-781-2229. IF STANDARD DG LIGHTING DOES NOT MEET JURISDICTIONNAL REQUIREMENTS, CONTACT CED FOR ALTERNATIVE SITE SPECIFIC PHOTOMETRIC CALCULATIONS.

C. SITE PLAN GENERAL NOTES:

- 1. THE SITE PLAN IS BASED ON MINIMUM REQUIREMENTS FOR SITE ACCESS, PARKING AND FREIGHT DELIVERY. DEVIATIONS FROM THIS PLAN SHALL INSURE PROPER SITE ACCESS FOR DOLLAR GENERAL'S FREIGHT TRUCKS DURING NORMAL BUSINNESS (OPERATING) HOURS. ON-SITE DELIVERY TRUCK MANEUVERING PATHS SHALL BE DESIGNED UTTILIZING DOLLAR GENERAL'S 73-FOOT LONG FREIGHT TRUCK. PATHS SHALL BE UNOBSTRUCTED AAND FREE OF LANDSCAPE ISLANDS, SIGNS, LIGHT POLES, BOLLARDS, ETC. HEAVY DUTY PAVEMENT IS RREQUIRED ALONG THE ENTIRE DELIVERY TRUCK (MANEUVERING) PATH.
- 2. A MINIMUM OF 30 PARKING SPACES, WHICH INCLUDDE 2 H.C. ACCESSIBLE SPACES, ARE REQUIRED FOR THIS DEVELOPMENT. THE NUMBER OF PARKING SPACES SHALL BE INCREASED AS REQUIRED BY JURISDICTIONAL REQUIREMENTS. IF ADDITIONAL PARRKING SPACES ARE REQUIRED OR PROVIDED, THE TOTAL NUMBER OF H.C. SPACES SHALL BE INCREASED IN ACCORDANCE WITH ADA REQUIREMENTS.
- 3. STANDARD PARKING SPACES SHALL HAVE MINIMUM SIZE OF 9'X 20' UNLESS LOCAL JURISDICTION REQUIRE LARGER SPACES. PARKING SPACE STRIPING SHALL BE STANDARD 90 DEGREE STYLE. MINIMUM SIZE OF H.C. PARKING SPACES AND / ACCESS ISLES ARE SHOWN ON DETAILS.
- 4. PAINTED STANDARD PARKING SPACE AND ISLAND STRIPE COLOR SHALL BE YELLOW FOR ASPHALT PAVEMENT AND CONCRETE PAVEMENT. COLOR FOR FPAINTED H.C. ACCESSIBLE PARKING SPACE STRIPES, ACCESS ISLE OR ISLAND STRIPES, H.C. SYMEBOLS, SHALL BE "H.C." BLUE COLOR. BOLLARDS SHALL BE PAINTED YELLOW. PAINT SHALL BE REFLECTIVE TYPE.
- 5. PAINTED FIRE LANE STRIPING OR PAINTED CURBS \$ SHALL BE PROVIDED AS REQUIRED BY JURISDICTIONAL REQUIREMENTS.
- 6. CONCRETE PARKING STOPS SHALL BE USED AT PARKING SPACES ALONG THE OUTER PERIMETER OF PARKING LOT WHEN CONCRETE CURBS ARE NOT USED.).
- 7. CONCRETE PARKING STOPS SHALL NOT BE USED A THE FRONT OF THE BUILDING OR ALONG THE PERIMETER (ADJACENT) TO THE BUILDING.
- 8. THE SIDEWALK AT THE FRONT OF THE BUILDING SHALL BE A MINIMUM OF 9-FEET WIDE. THE SIDEWALK SHALL INCLUDE A 9-FOOT MINIMUM WIDE ALDA ACCESSIBLE RAMP CENTERED ABOUT THE STORE MAIN ENTRANCE. SIDEWALKS ALONG OTHER SSIDES OF BUILDING SHALL BE MINIMUM 3'-6" WIDE. SIDEWALKS ADJACENT TO BUILDING SLABS SHALL HAVE SEALED ISOLATION JOINTS AND SHALL BE 6" HIGH ABOVE EXTERIOR OR PAVEMENT FINISH GRADES.

- 9. PORTLAND CEMENT SIDEWALKS SHALL BE MINIMUM 4" THICK WITH A 6" HIGH CURB AT ALL PAVEMENT TRANSITIONS, USE WELDED WIRE FABRIC OR FIBER REINFORCING.
- 10. THE PREFERRED WIDTH OF SITE DRIVEWAYS IS 36' WITH ONE ENTRANCE LANE AND TWO (RIGHT TURN AND LEFT TURN) EXIT LANES. WHERE SITE CONSTRAINTS DO NOT ALLOW THE PREFERRED WIDTH, 26' SHALL BE USED AS THE MINIMUM WIDTH, WITH ONE ENTRANCE AND ONE EXIT LANE. IF THE 26' WIDE ENTRANCE IS USED, THERE SHALL BE ADEQUATE DRIVEWAY DEPTH TO INSURE DELIVERY TRUCK MANEUVERABILITY.
- 11. DRIVEWAY CONSTRUCTION WITHIN ROAD RIGHT-OF-WAYS, INCLUDES RADIUS SIZES, PAVEMENT MARKINGS, DRIVEWAY WIDTHS, ETC., SHALL BE IN ACCORDANCE WITH JURISDICTIONAL REQUIREMENTS.
- 12. A 25' MINIMUM RADIUS SHALL BE USED FOR ON-SITE DRIVEWAY TURNOUTS AS SHOWN ON PLAN. THE OFF-SITE RADIUS THAT ADJOINS THE MAIN ROAD SHALL BE 50' (WHERE POSSIBLE) ON ENTRANCES THAT WILL BE UTILIZED FOR FREIGHT TRUCK DELIVERY AND NO LESS THAN 25' ON ENTRANCES WHERE DELIVERY TRUCKS WILL NOT BE ALLOWED TO ACCESS.
- 13. SITE PLANS SHALL UTILIZE DOLLAR GENERAL'S PROTOTYPICAL BUILDING DESIGN WITH 70'-0" BY 130'-0" DIMENSIONS. SHOULD SITE CONSTRAINTS NOT ALLOW THE PROTOTYPICAL BUILDING DESIGN, DEVELOPER SHALL CONTACT DOLLAR GENERAL AUTOCAD/ STORE DESIGN DEPARTMENT FOR OPTIONS AND APPROVAL.
- 14. THE BUILDING MAIN ENTRANCE SHALL BE ORIENTED ON THE SITE TO FACE THE MAIN ACCESS ROAD. PARKING SHOULD BE CONCENTRATED AT THE FRONT OF THE STORE.
- 15. THE ACTUAL LOCATION FOR THE PYLON SIGN SHALL BE SITUATED FOR OPTIMUM VISIBILITY ALONG THE MAIN FRONT TRAFFIC CORRIDOR.
- 16. THE LANE OR DRIVE BETWEEN PARKING SPACES SHALL HAVE A MINIMUM WIDTH OF 30' WHEN LANE IS HEAVY DUTY PAVEMENT AND USED FOR FREIGHT TRUCK MANEUVERING. THE LANE SHALL HAVE A MINIMUM WIDTH OF 26' WHEN THE LANE IS CONSTRUCTED OF STANDARD DUTY PAVEMENT AND NOT USED FOR FREIGHT TRUCK MANEUVERING.
- 17. BUILDING CORNERS ADJACENT TO PAVED AREAS SHALL BE BOLLARD PROTECTED.
 ABOVEGROUND UTILITY APPURTENANCES, SUCH AS METERS, FIRE HYDRANTS IN PAVED AREAS, ETC.
 SHALL BE BOLLARD PROTECTED.
- 18. UTILITY APPURTENANCES (METERS, TRANSFORMERS; ETC.) AT THE BUILDING SHALL BE BOLLARD PROTECTED IN PAVED AREA.
- 19. CONCRETE SPLASH BLOCKS SHALL BE INSTALLED AT ALL BUILDING DOWNSPOUTS THAT ARE NOT DISCHARGING ON CONCRETE PAVEMENT. DOWNSPOUTS SHALL NOT BE ALLOWED TO DISCHARGE ON CONCRETE SIDEWALKS. SEE DETAIL ON 2/C1.D
- 20. DUMPSTER AND DELIVERY PADS SHALL BE CONSTRUCTED OF HEAVY DUTY PAVEMENT AS DETAILED ON THE DRAWINGS. AN ENCLOSURE SHALL BE PROVIDED ON THE DUMPSTER PAD IF REQUIRED BY JURISDICTIONAL REQUIREMENTS. SANITARY SEWER AND DOMESTIC HOT WATER SHALL BE PROVIDED AT DUMPSTER AREA IF REQUIRED BY JURISDICTIONAL REQUIREMENTS.

Note!!

This page is for reference to subcontractors only!!!

See Civil Plans and Specifications on Site Plan by GTC Design Group for Construction Details.

GASGO

10877 WATSON ROAD
ST. LOUIS, MO 63127



DATE


05/19/08

SHEET NUMBER

С3 Г

GENERAL SITE NOTES OPTION "A"

My man way me 2005

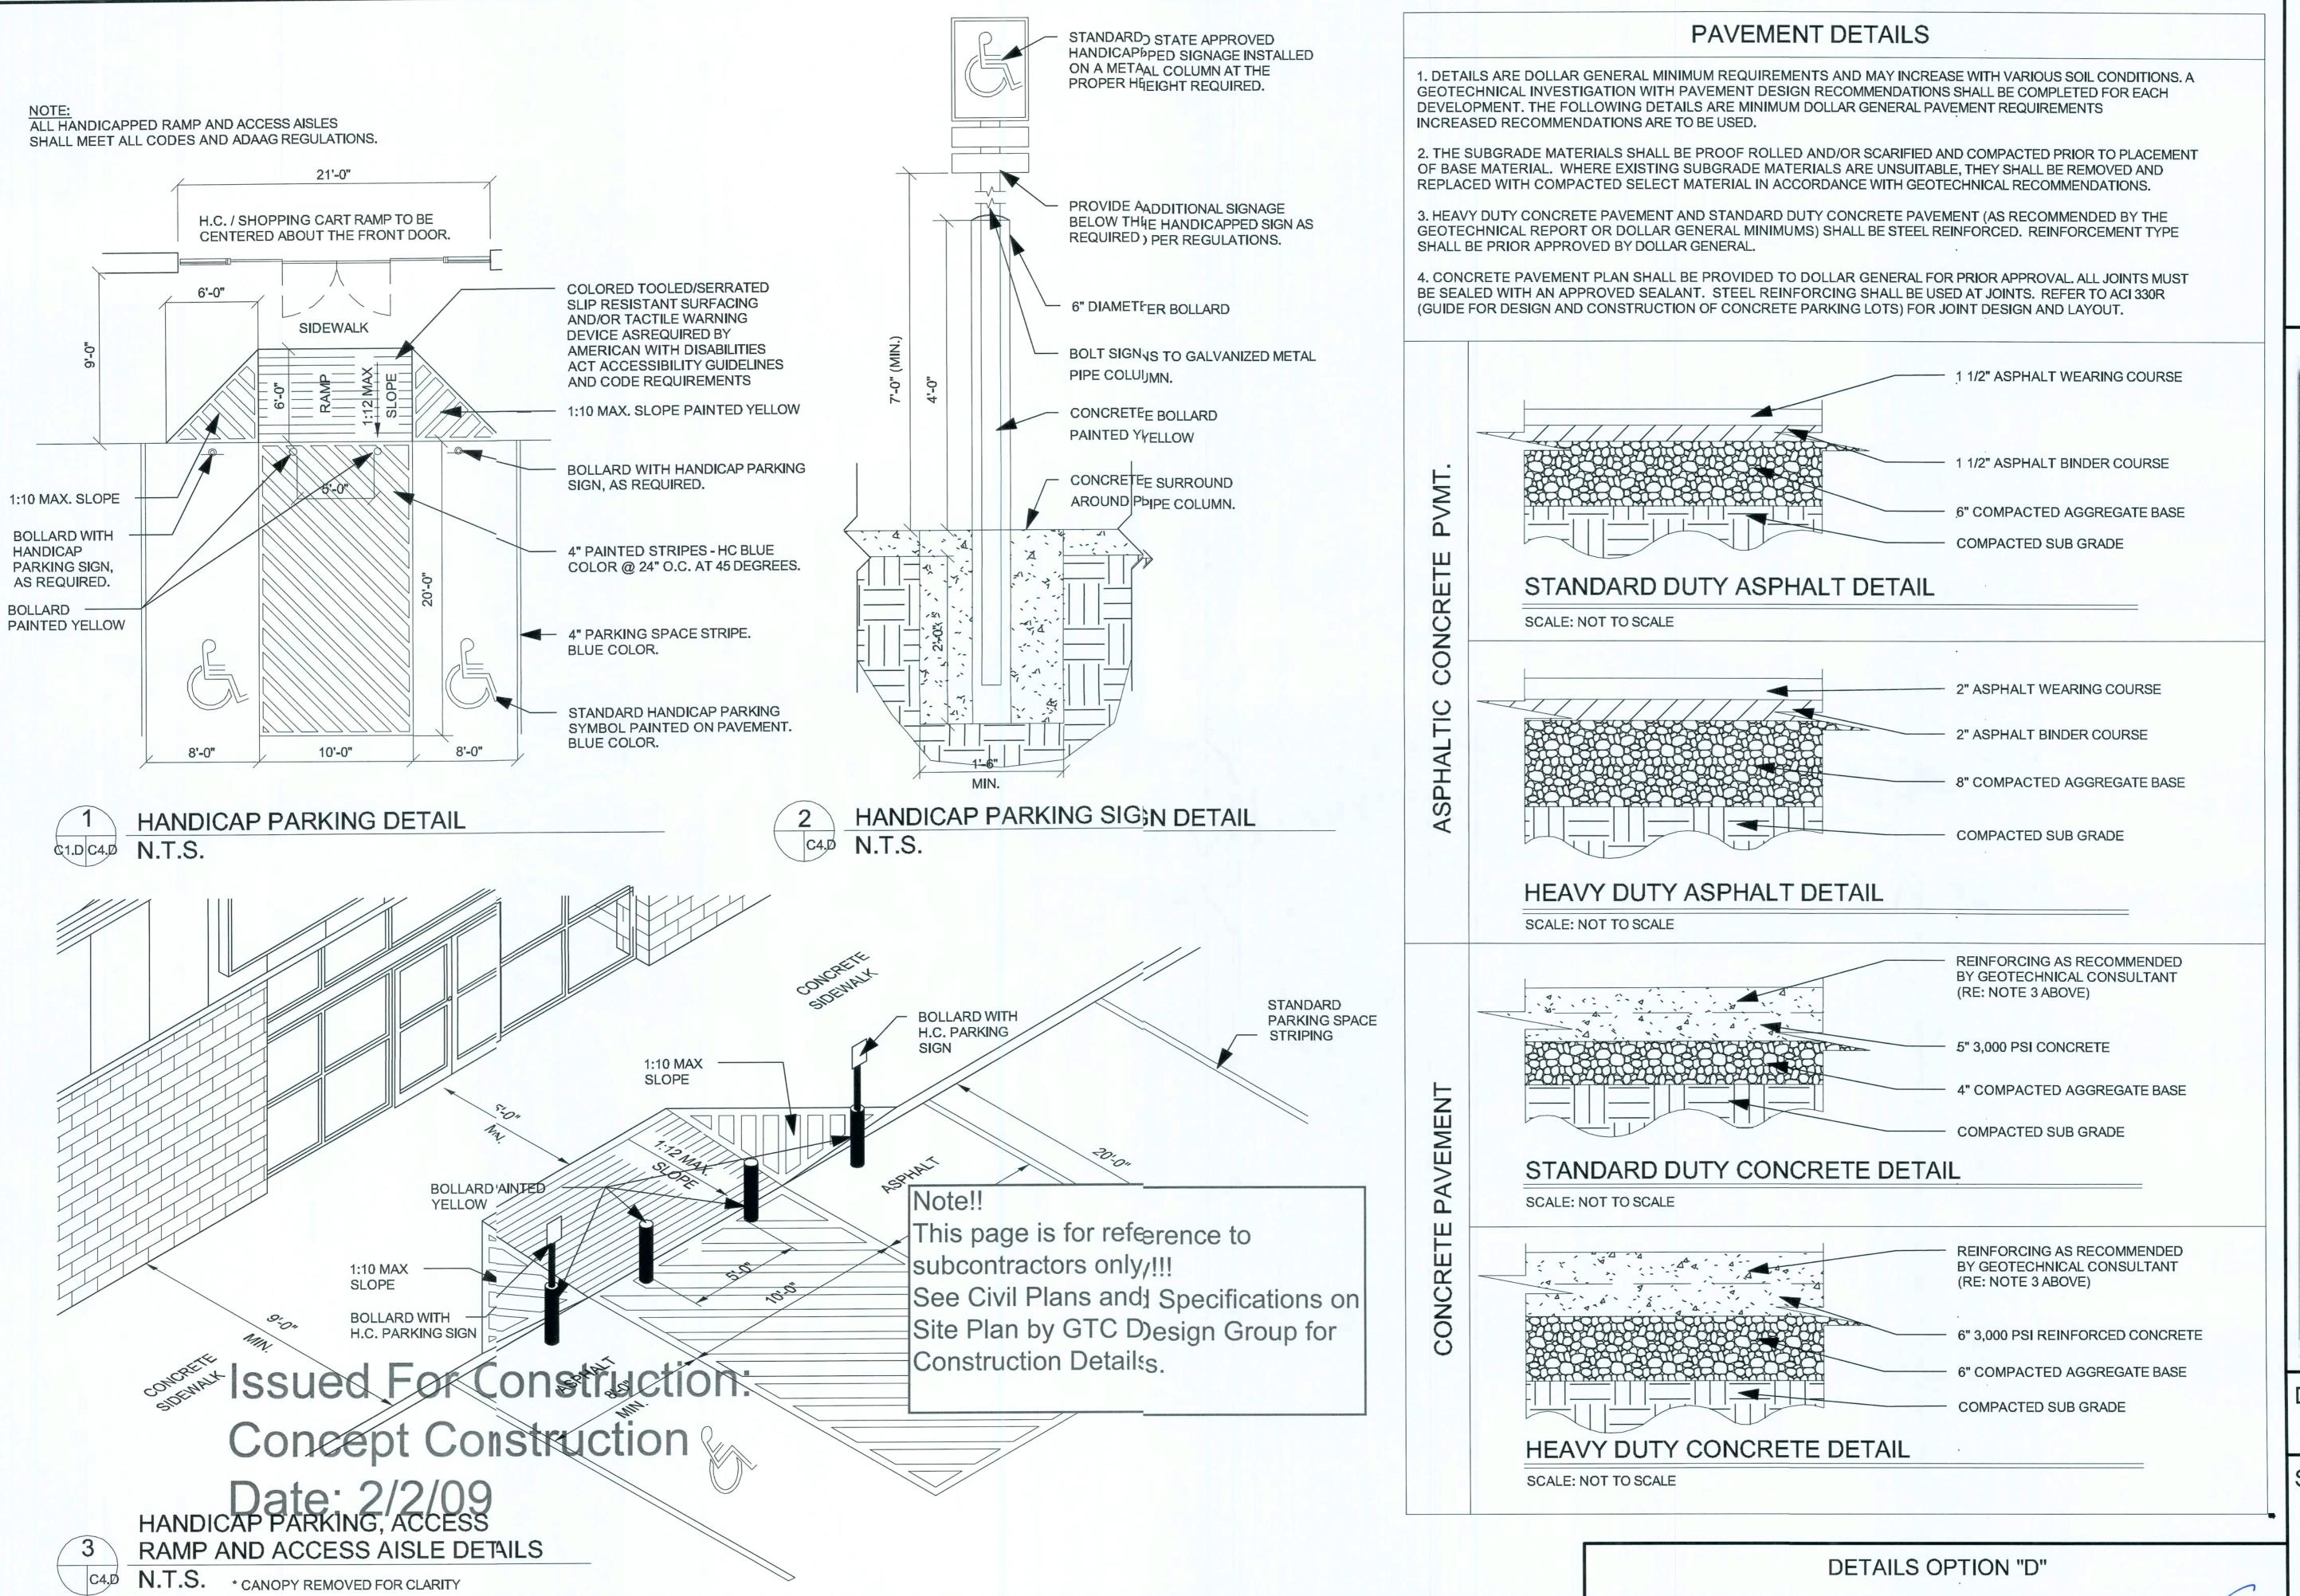

GASGO 10877 WATSON ROAD ST. LOUIS, NO 63127

DATE

05/19/08

SHEET NUMBER

C4.D

Note!!

This page is for reference only!!!
See Civil Plans and Specifications on SitePlan by
GTC Design Group for Construction Detais.

SITE PARKING LOT

1. USE PAVING SPECIFICATIONS NOTED ON SHEET C4.A UNLESS A CERTIFIED GEOTECH REPORT SPECIFIES AN ALTERNATE REQUIREMENT (SEE PAGE C FOR DETAILS) AND IS APPROVED BY DOLLAR GENERAL AUTOCAL STORE DESIGN DEPARTMENT.

2. PROVIDE PARKING LOT IN3OOD CONDITION, PROPERLY STRIPED WITH YELLOW PAINT. MINIMM OF 30 PARKING SPACES REQUIRED, INCLUDING A MINIMUM OF TVO HANDICAP ACCESSIBLE SPACES (PROPERLY MARKED, SIGNE, AND ADA COMPLIANT).

3. PROPER ACCESS FOR DOLAR GENERAL'S FREIGHT TRUCKS (FREIGHT TRUCKS ARE APPIOXIMATELY 73'-0" IN TOTAL LENGTH) ARE REQUIRED DURING NORIAL BUSINESS HOURS. THIS INCLUDES A TRUCK PATH THAT IS FREIOF LANDSCAPE ISLANDS, SIGNS, LIGHT POLES, AND OTHER BARRIES WHILE MAINTAINING WIDE RADIUS CURVES ON ALL ENTRANCE; AND EXITS. HEAVY DUTY PAVING (SEE PAGE C4.A FOR SPECIFICATINS) REQUIRED FOR TRUCK PATHS.

4. PROVIDE PROTECTION (BLLARDS, GUARD RAILS, OR EQUIVALENT) FOR ELECTRIC GAS, HVAC, AND WATER METERS THAT ARE IN POTENTIALLY HAZAROUS LOCATIONS.

 CONTRACTOR WILL COMPETE ALL SITE WORK: FINAL GRADING, LANDSCAPING, SEEDING, PAING, RETENTION, AND REMOVAL OF DEBRIS.

6. PROVIDE AND INSTALL COCRETE SPLASH BLOCKS AT ALL UNPAVED DOWN SPOUT LOCATIONS.

7. ROUTE DOWNSPOUTS UNER SIDEWALKS AS DETAILED IN 2/C1.B AT ALL SIDEWALK LOCATION!

8. PLEASE NOTE THAT THER SHOULD NOT BE ANY PARKING STOPS LOCATED DIRECTLY IN FRON OF OR DIRECTLY ADJACENT TO THE BUILDING.

9. EROSION CONTROL AROUD PROPERTY IS REQUIRED BY CONTRACTOR.

10. CONTRACTOR IS RESPOSIBLE FOR ESTABLISHING ALL SEEDING AND LANDSCAPING. ALL LOGL LANDSCAPE REQUIREMENTS MUST BE MET.

11. THE GRADE FOR THE PAYD TRUCK RECEIVING LANE IS NOT TO EXCEED 2.5%. IF THIS CONDIION CANNOT BE MET, NOTIFY THE DOLLAR GENERAL AUTOCAESTORE DESIGN DEPARTMENT IN WRITING WITH PROPOSED GADING PLAN FOR APPROVAL.

12. THE GRADE FOR THE PAYED PARKING AREA IS NOT TO EXCEED 3.5%. IF THIS CONDITION CAINOT BE MET, NOTIFY THE DOLLAR GENERAL AUTOCAD/ STORE ESIGN DEPARTMENT WRITING WITH PROPOSED GRADING PLAN PR APPROVAL.


13. THE CONCRETE DELIVER TRUCK RECEIVING PAD MUST BE 16'X16'. THE CONCRETE PAD/JUST SLOPE AWAY FROM THE BUILDING AT 1/8" PER FOOT.

14. THE CONCRETE DUMPSTR PAD MUST BE 18' X 18'.

15. IF REQUIRED, THE DUMPSER ENCLOSURE MUST BE 18' WIDE BY 12' DEEP

16. CURBING OR CONCRETE ARKING STOPS SHOULD BE LOCATED AT PERIMETER PARKING ZONS ONLY.

Issued For Construction:
Concept Construction
Date: 2/2/09

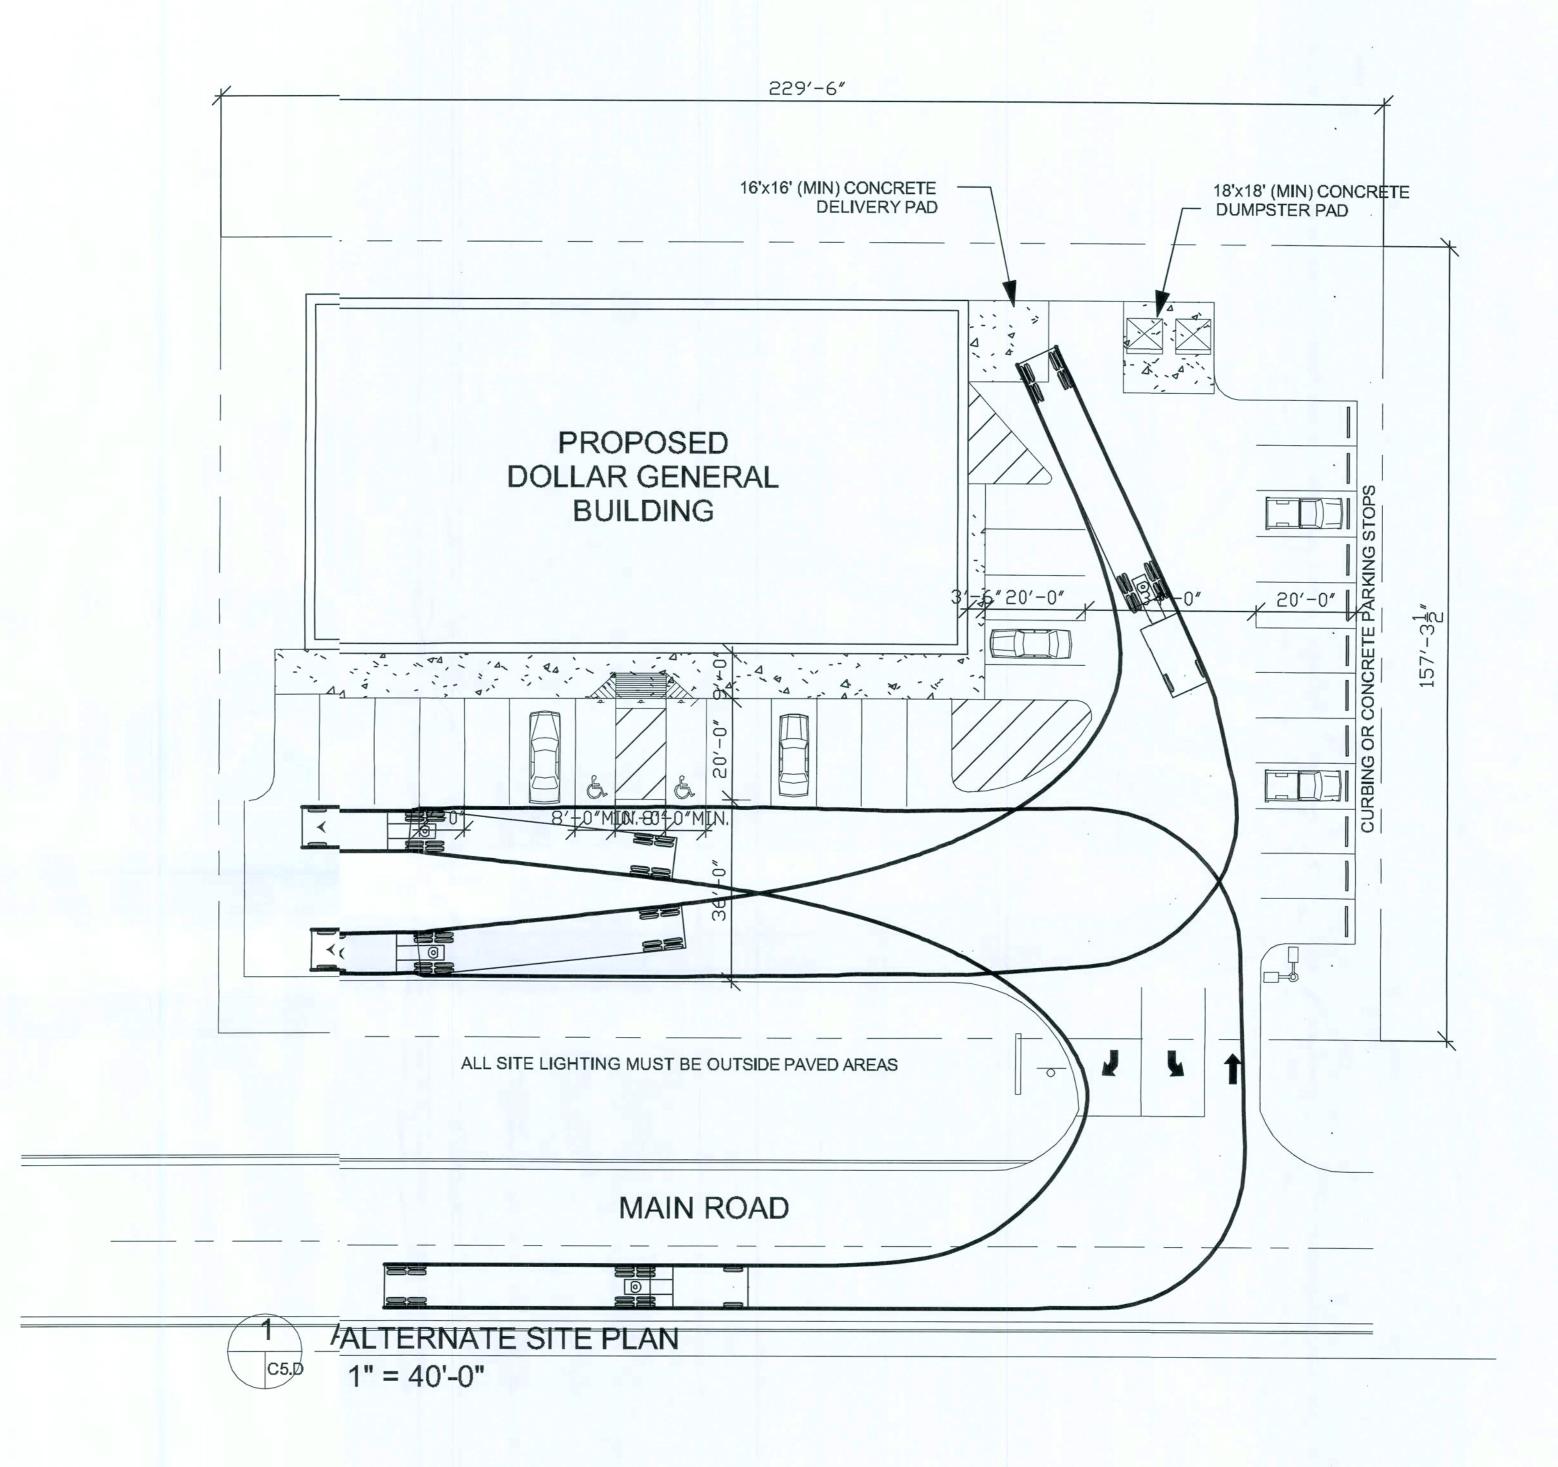

GASGO 10877 WATSON ROAD ST. LOUIS, MC 63127



DATE

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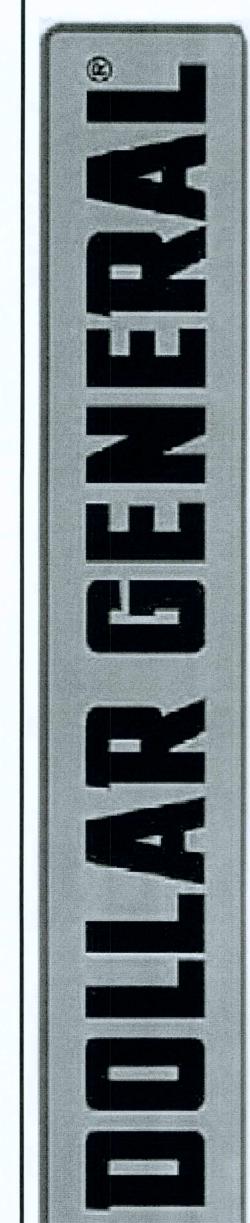
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ALTERNATE SITE PLANS OPTION "D"



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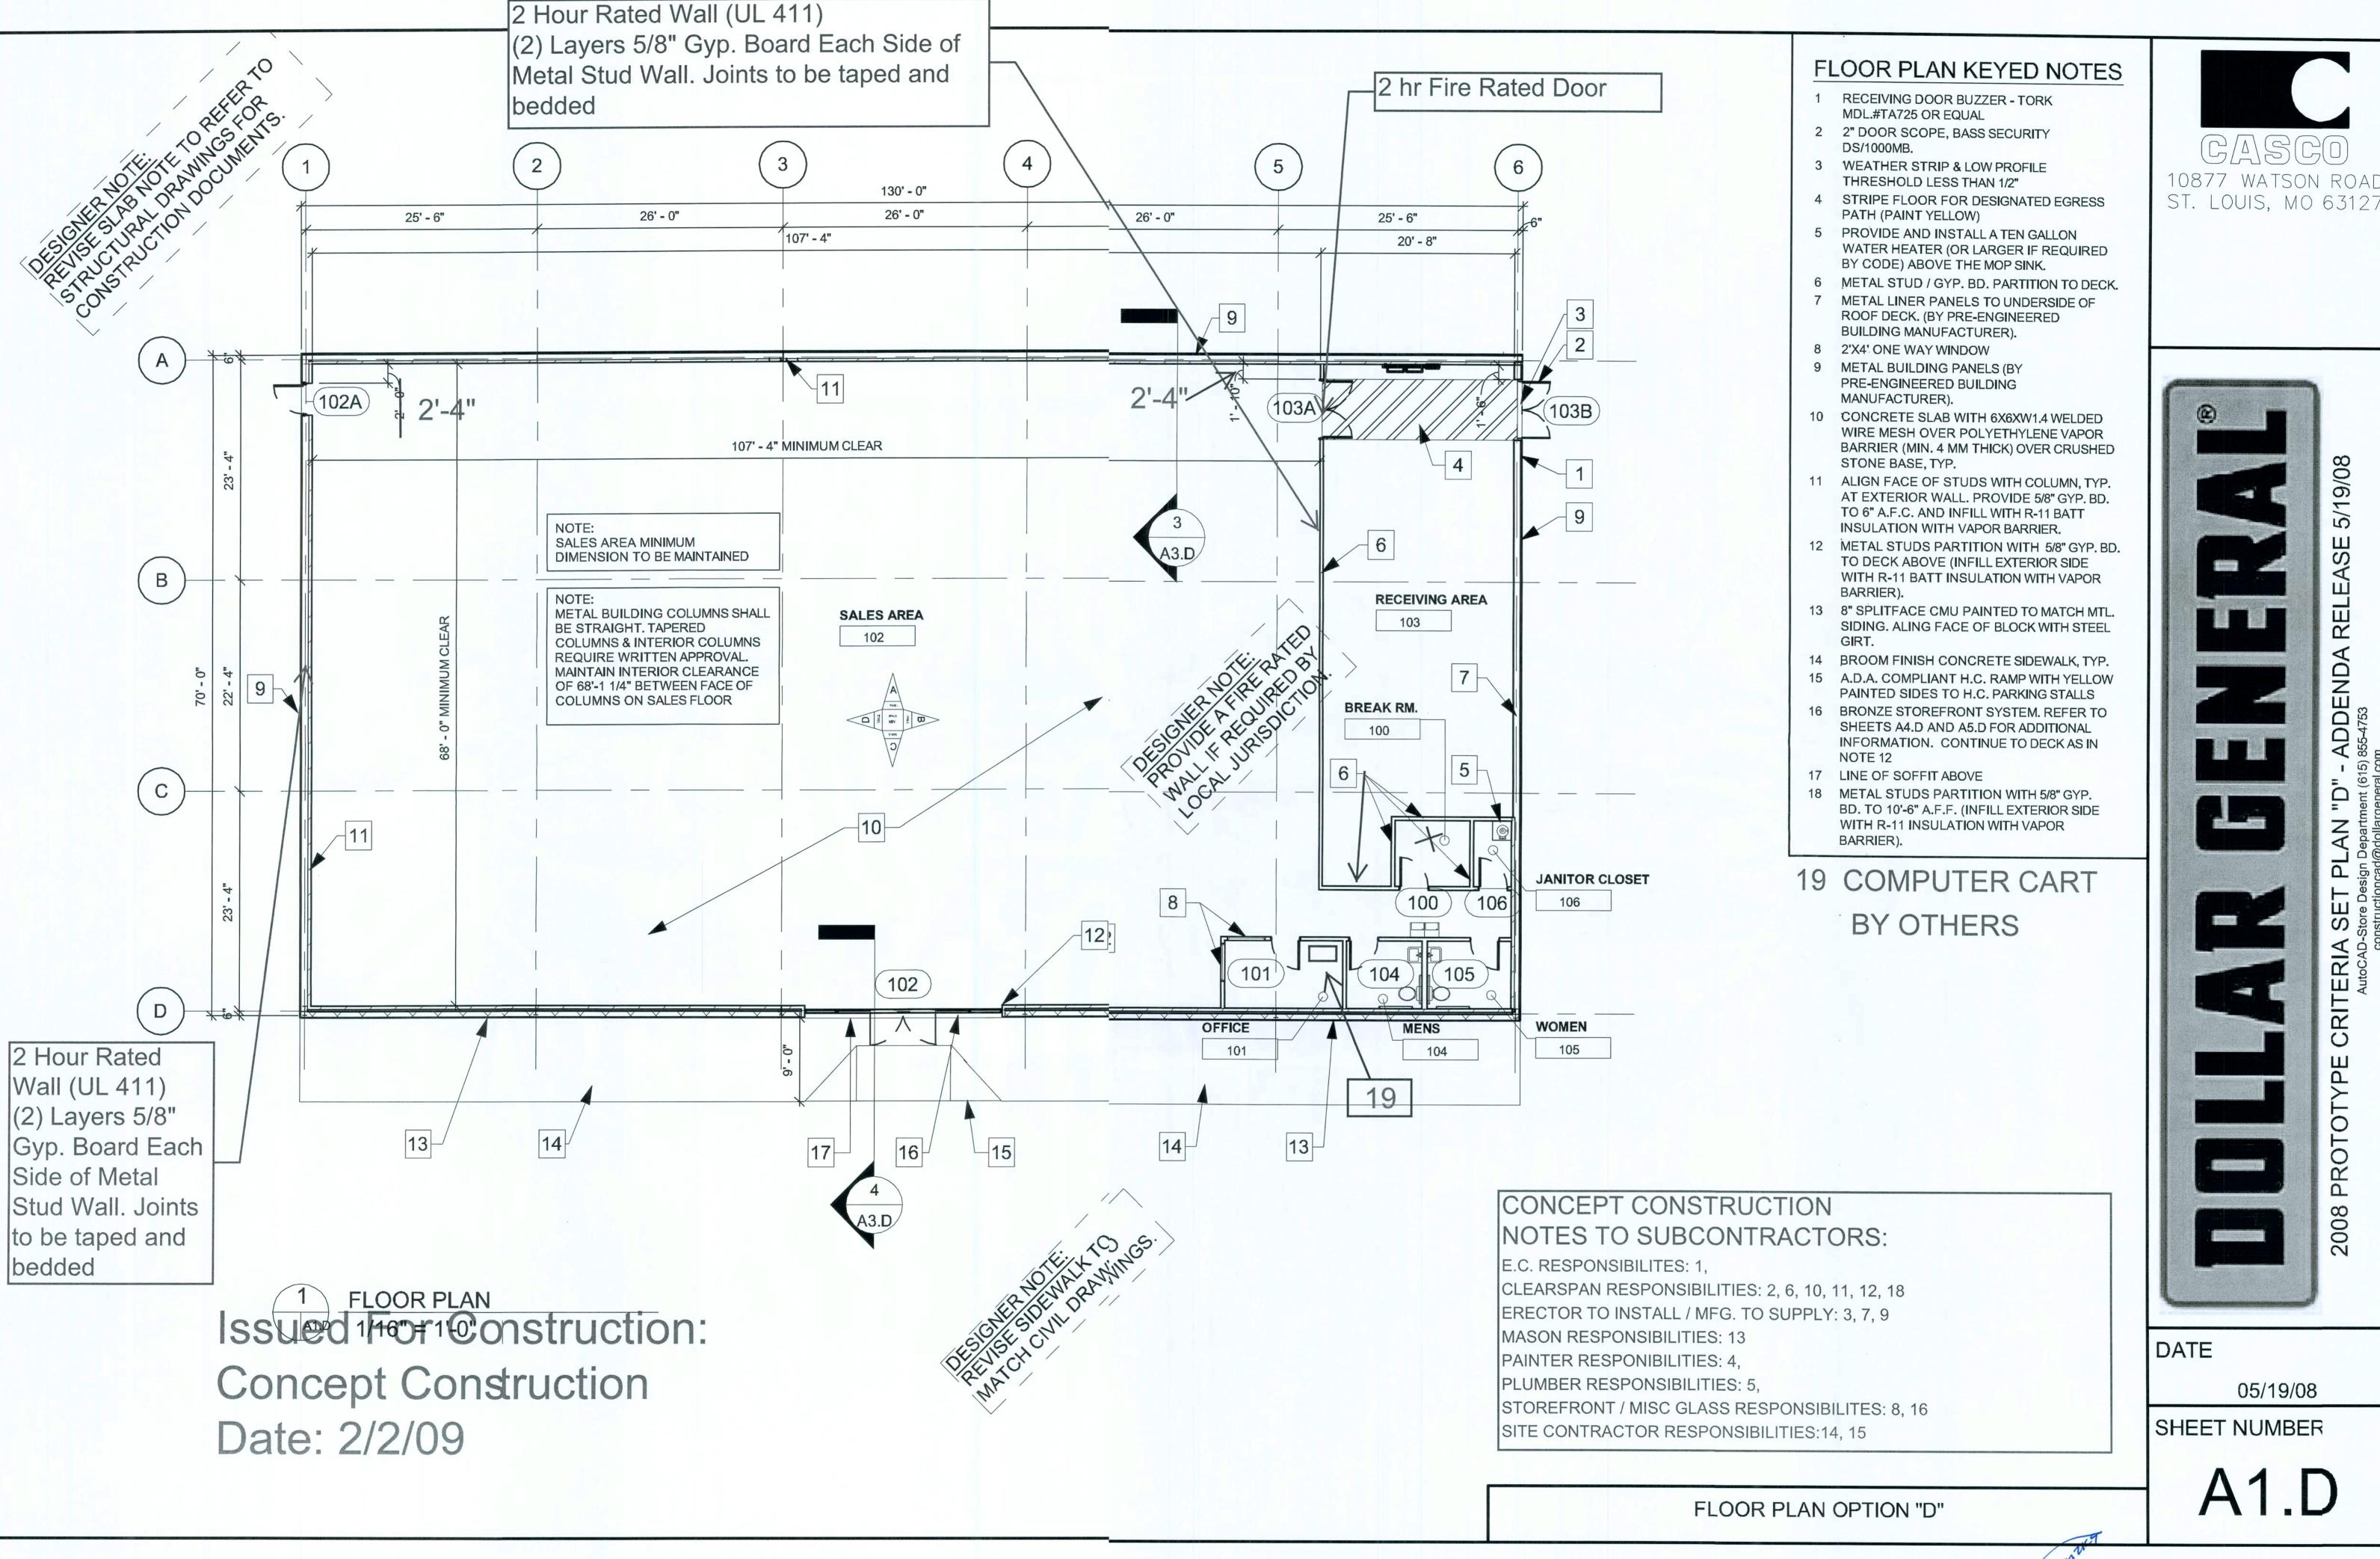
UPDATE WITH ATTACHED REVISED FIXTURE PLAN

NOTE: IF THE LOCATION OF ANY ITEM (INCLUDING DOORS) CHANGES, PLEASE CONSULT THE DOLLAR GENERAL CONSTRUCTION DE'ARTMENT FOR COOLER RECEPTACLE LOCATON.

> Issued For Construction: Concept Construction Date: 2/2/09

NOTE: PLEASE NCOTE THAT THE ORIENTATION OF THE RESTROOMS) AND THE OFFICE ALWAYS STAY THE SAME REGARDLESS OF THE LOCATION OF THE RECEIVING DOORS.

FIXTURE PLAN OPTION "D"





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ADDENDA





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GASGO 10877 WATSCN ROAD ST. LOUIS, MO 63127

5/19/08

ADDENDA 865-4753

PLAN sign Depart

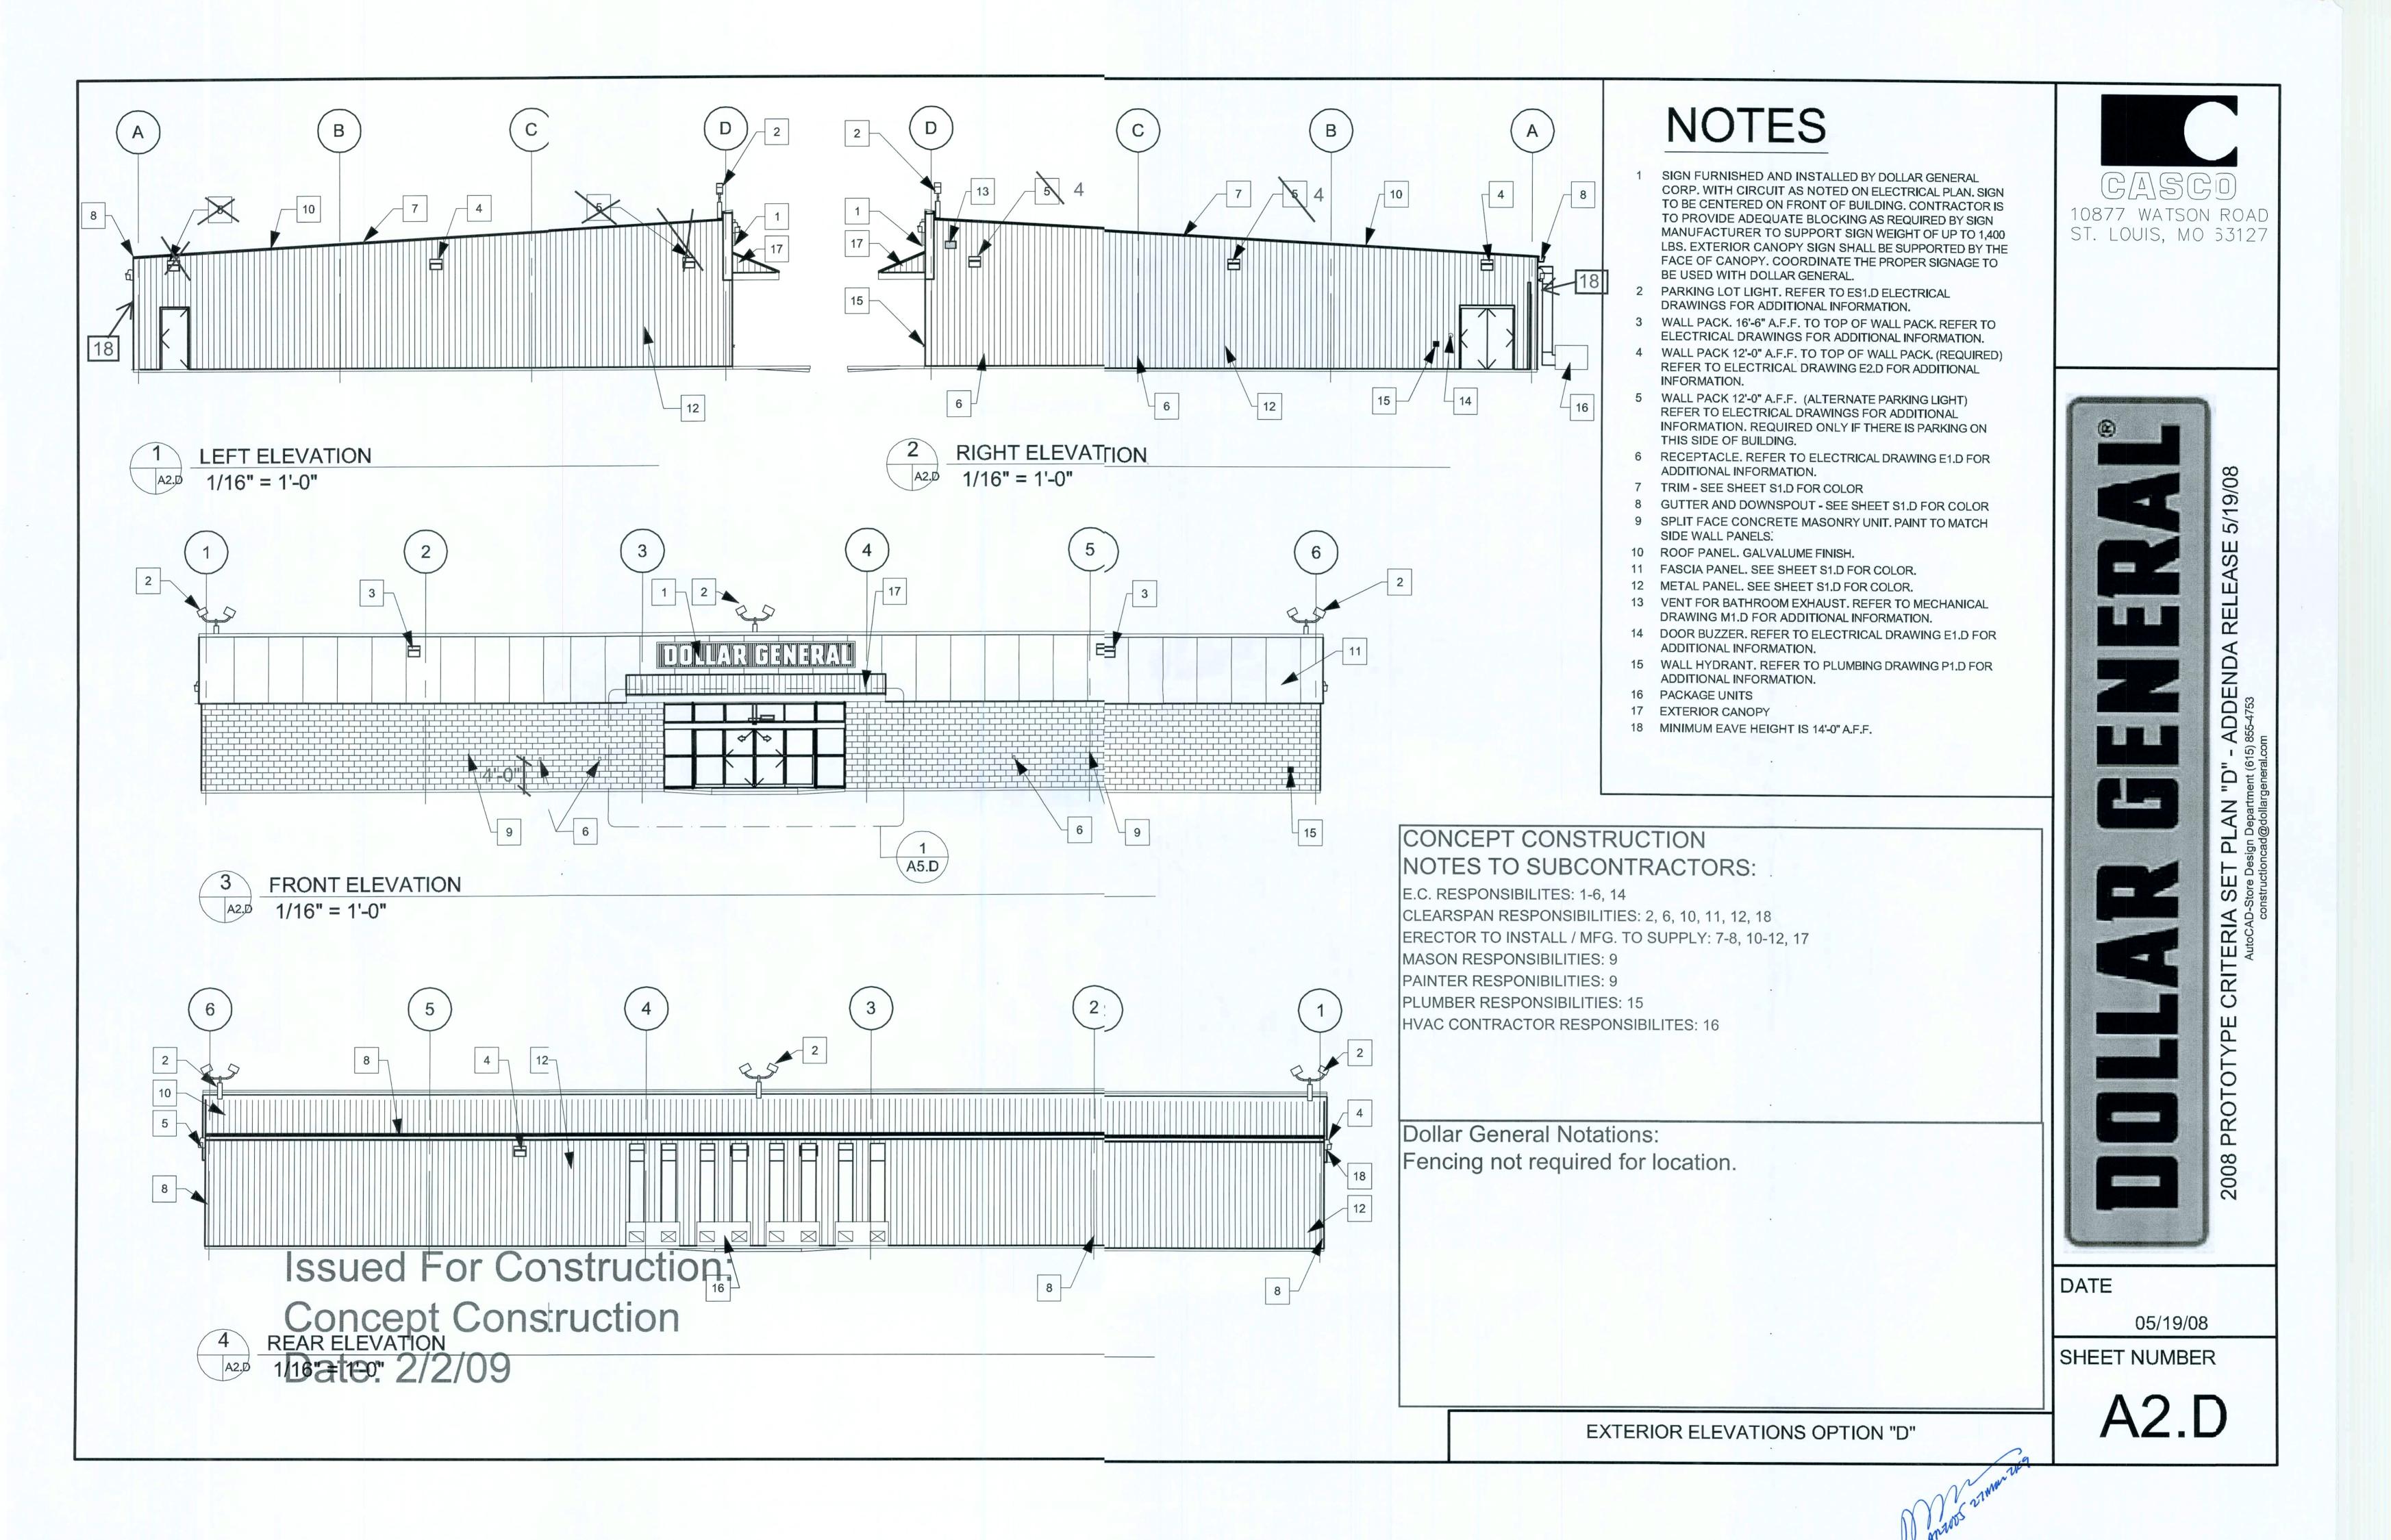RITERIA AutoCAD-S
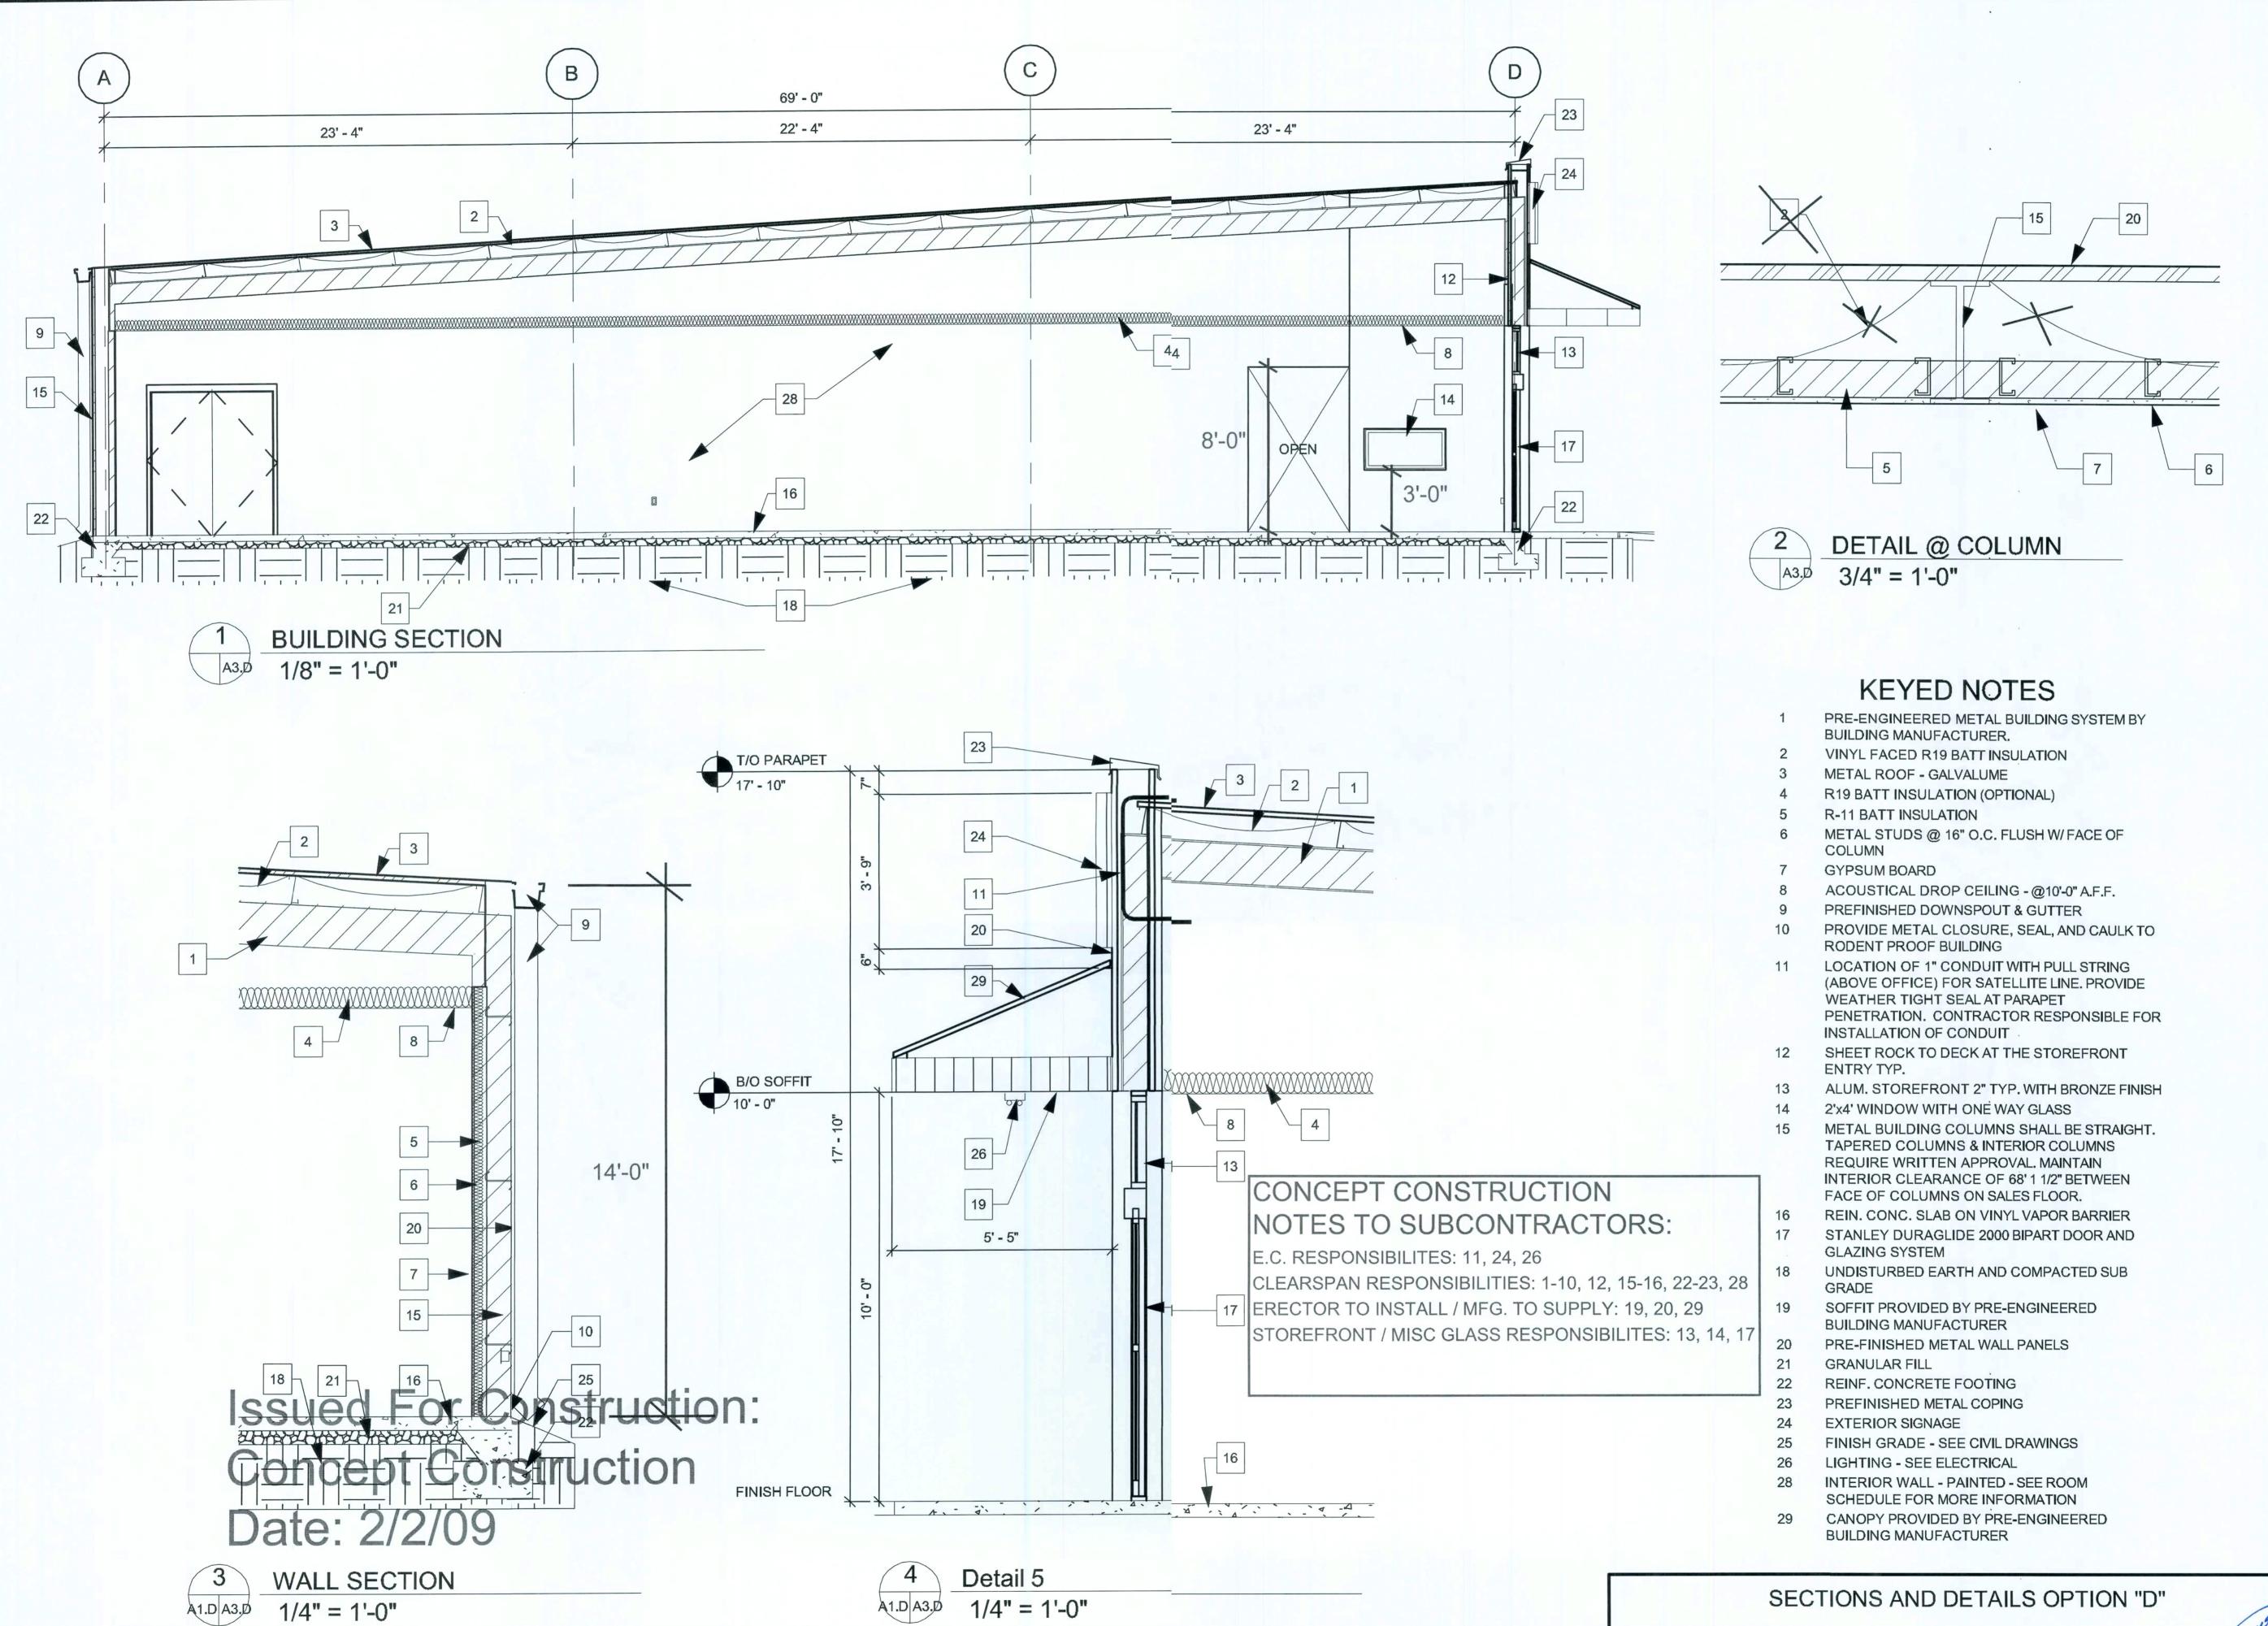
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PROTOTYPE

2008

DATE

05/19/08

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ON "D"

_									RO	OOM SCHEDULE							
	RQOI	М	FLO	OR	BASI		AV	VALL	В\	WALL	C	WALL	DV	VALL	CEILING	CEILING	
10	NAM		ERIAL	FINISH	MATERIAL	FINISH	MATERIAL	FINISH	MATERIAL	FINISH	MATERIAL	FINISH	MATERIAL	FINISH	MATERIAL	FINISH	REMARKS
	BREAK RM.	CONC		RETROPLATE 99 SEALER	4" RUBBER / VINYL BASE	LACK		SHERWIN WILLIAMS PAINT ANTIQUE WHITE, LATEX SEMI GLOSS PRODUCT #B31W404	GYPSUM BOARD	SHERWIN WILLIZIAMS PAINT ANTIQUEE WHITE, LATEX SEMI GLCOSS PRODUCT #B31\W404	GYPSUM BOARD	SHERWIN WILLIAMS PAINT ANTIQUE WHITE, LATEX SEMI GLOSS PRODUCT #B31W404	GYPSUM BOARD	SHERWIN WILLIAMS PAINT ANTIQUE WHITE, LATEX SEMI GLOSS PRODUCT #B31W404	2' X 4' ACCOUSTICAL CEILING 8'-0" A.F.F.	WHITE	FINISH ALL WALLS TO THE ROOF DEC
01 0	OFFICE		RETE P		4" RUBBER / VINYL BASE	LACK	GYPSUM BOARD	SHERWIN WILLIAMS PAINT ANTIQUE WHITE, LATEX SEMI GLOSS PRODUCT #B31W404	GYPSUM BOARD	SHERWIN WILLI, IAMS PAINT ANTIQUEE WHITE, LATEX SEMI GL(OSS PRODUCT #B31\(\partial W404\)	GYPSUM BOARD	SHERWIN WILLIAMS PAINT ANTIQUE WHITE, LATEX SEMI GLOSS PRODUCT #B31W404	GYPSUM BOARD	SHERWIN WILLIAMS PAINT ANTIQUE WHITE, LATEX SEMI GLOSS PRODUCT #B31W404	2' X 4' · ACCOUSTICAL CEILING 9-0" A.F.F	WHITE	FINISH ALL WALLS TO THE ROOF DEC
02 8	SALES AREA	CONC FLOC POLIS	R HED (RETROPLATE POLISHED CONCRETE WITH RETROPLATE 99 SEALER	4" RUBBER / VINYL BASE	LACK		SHERWIN WILLIAMS PAINT ANTIQUE WHITE, LATEX SEMI GLOSS PRODUCT #B31W404	GYPSUM BOARD TO ROOF DECK	SHERWIN WILLI, IAMS PAINT ANTIQUEE WHITE, LATEX SEMI GL(OSS PRODUCT #B31\W404	GYPSUM BOARD TO 10'-6" A.F.F.	SHERWIN WILLIAMS PAINT ANTIQUE WHITE, LATEX SEMI GLOSS PRODUCT #B31W404	GYPSUM BOARD TO 10'-0"	SHERWIN WILLIAMS PAINT ANTIQUE WHITE LATEX SEMI GLOSS PRODUCT #B31W404	2' X 4' ACCOUSTICAL CEILING	WHITE	FINISH PERMITER WALLS TO ROOF DECK
03 F	RECEIVING			RETROPLATE 99	N/A			LIGHT STONE	METAL LINER PANEL	LIGHT STONE	GYPSUM BOARD	TAPED. PAINTED IF REQUIRED BY CODE. MTL LINER PANEL TO DECK AS ALT.	GYPSUM BOARD	TAPED PAINTED IF REQUIRED BY CODE. MIL LINER PANEL TO DECK AS ALT.	EXPOSED TO STRUCTURE ABOVE	N/A	FINISH ALL WALLS
04 N	MENS		RETE F		4" RUBBER / VINYL BASE		GYPSUM BOARD/ FIBERGLASS REINFORCED PANEL-WHITE	FIBERGLASS REINFORCED PANEL-WHITE	GYPSUM BOARD/ FIBERGLASS REINFORCED PANEL-WHITE	FIBERGLASS REINFORCED PANEL-WHITE	GYPSUM BOARD/ FIBERGLASS REINFORCED PANEL-WHITE	FIBERGLASS REINFORCED PANEL-WHITE	GYPSUM BOARD FIBERGLASS REINFORCED PANEL-WHITE	FIBERGLASS REINFORCED PANEL-WHITE	2' X 4' ACCOUSTICAL CEILING	WHITE	FINISH EXTERIOR WALLS TO THE ROOF DECK
05 V	VOMEN		RETE R SEALED	RETROPLATE 99 SEALER	4" RUBBER / VINYL BASE		GYPSUM BOARD/ FIBERGLASS REINFORCED PANEL-WHITE	FIBERGLASS REINFORCED RANEL-WHITE	GYPSUM BOARD/ FIBERGLASS REINFORCED PANEL-WHITE	FIBERGLASS REINFORCED PANEL-WHITE	GYPSUM BOARD/ FIBERGLASS REINFORCED PANEL-WHITE	FIBERGLASS REINFORCED PANEL-WHITE	GYPSUM BOARD/ FIBERGLASS REINFORCED PANEL-WHITE	FIBERGLASS REINFORCED PANEL-WHITE	2' X 4' ACCOUSTICAL CEILING 8'-0" A.F.F.	WHITE	FINISH EXTERIOR WALLS TO THE ROOF DECK
06 J	IANITOR CL		RETE R		4" RUBBER / VINYL BASE		FIBERGLASS REINFORCED PANEL-WHITE TO 48" A.F.F GYPSUM BOARD ABOVE	FIBERGLASS REINFORCED PANEL-WHITE	FIBERGLASS REINFORCED PANEL-WHITE TO 48" A.F.F GYPSUM BOARD ABOVE	FIBERGLASS REINFORCED PANEL-WHITE	FIBERGLASS REINFORCED PANEL-WHITE TO 48" A.F.F GYPSUM BOARD ABOVE	FIBERGLASS REINFORCED PANEL-WHITE	FIBERGLASS REINFORCED PANEL-WHITE TO 48" A.F.F GYPSUM BOARD ABOVE	FIBERGLASS REINFORCED PANEL-WHITE	2' X 4' ACCOUSTICAL CEILING 8'-0" A.F.F.	WHITE	FINISH EXTERIOR WALLS TO THE ROOF DECK
									DC	OOR SCHED ULE							
			DOO	7													
O.	Туре	WIDTH	HEIGHT	THICKNES					ARDWARE					REMARKS			
00	A	3' - 0"	7' - 0"	0' - 1 3/4"			ALCON PASSAGE MODER MODEL#TA3310PC	DEL #E101S-DANE-626 (NO	O KEY REQ'D), DOOR C	LOSER: "DOR "O" MMATIC MO	DEL#SC94-AL, WALL	SOLID CORE WOOD DO	OR OR HOLLOW CORE	METAL DOOR PAINTED TO	MATCH THE WALL	SURFACE.	
01	А	3' - 0"	7' - 0"	0' - 1 3/4"	LEVER: DOOF	RIANDLE FA		ODEL #W581PD-DANE-62	26 (KEY #1), DOOR CLO	SER: DOR "O" MAT TIC MODE	L#SC94-AL, WALL STOP	, SOLID WOOD DOOR OF	R HOLLOW CORE METAI	DOOR PAINTED TO MATO	CH THE WALL SURFA	ACE.	
)2	E .	16" - 0"7/8".	Ø' - 9"					Y DOLLAR GENERAL ARE	A MANAGER W/ INSTA-KI	EY LOCKING CYLINDER		STANLEY DURA-GLIDE	SERIES 2000 21'-0" BI-PA	ART WITH TRANSOM AND	GLASS. BRONZE FIN	JISH	

			DOOF	~	
NO.	Туре	WIDTH	HEIGHT	THICKNESS	DOOR HARDWARE
100	А	3' - 0"	7' - 0"	0' - 1 3/4"	LEVER: DOOR HANDLE FALCON PASSAGE MODEL #E101S-DANE-626 (NO KEY REQ'D), DOOR CLOSER: "DOR "O" MATIC MODEL #SC94-AL, WALL STOP, TACO DOR VIEWER MODEL #TA3310PC
101	А	3' - 0"	7' - 0"	0' - 1 3/4"	LEVER: DOORIANDLE FALCON STOREROOM MODEL #W581PD-DANE-626 (KEY #1), DOOR CLOSER: DOR "O" MAT TIC MODEL #SC94-AL, WALL STOP, TACO DOOR VEWER MODEL #TA3310PC
102	Е	. 16" - 0"7/8".	Ø' - 9"		BY DOOR MANIFACTURER TO BE RE-KEYED BY DOLLAR GENERAL AREA MANAGER W/ INSTA-KEY LOCKING CYLINDER
102A	С	3' - 0"	7' - 0"	0' - 1 3/4"	DOOR CLOSE!: DOR "O" MATIC MODEL #SC94-AL, PANIC HARDWARE: VON DUPRIN GUARD X LOCK MODEL #2670-LUS28
103A	В	6' - 0"	7' - 0"	0' - 1 3/4"	PULL HANDLE3" KICK PLATE, DOOR CLOSER: DOR "O" MATIC MODEL #SC94-AL, PUSH PLATE, A KICK DOWN DOODR STOP
103B	D	6' - 0"	7' - 0"	0' - 1 3/4"	PANIC HARDWRE: VON DUPRIN GUARD X LOCK MODEL #2670-US28, DETEX: DOUBLE DOOR HOLDER MODEL #DIJDH-2250 TOP & BOTTOM, DOOR CLOSER: DORO" MATIC MODEL #SC94-AL, PULL HANDLE, 2" DOOR SCOPE: MODEL #DIS 1000MB, 8" KICK DOWN DOOR STOP MODEL #612Z FROM BASS SECURI'ES HD LOW PROFILE HC THRESHOLD, 1/2" MAX. WITH SMOOTH TRANSITION
104	Α	3' - 0"	7' - 0"	0' - 1 3/4"	LEVER: DOORIANDLE FALCON STOREROOM MODEL #W581PD-DANE-626 (KEY #2), DOOR CLOSER: DOR "O" MAT TIC MODEL #SC94-AL, WALL STOR
105	А	3' - 0"	7' - 0"	0' - 1 3/4"	LEVER: DOORIANDLE FALCON STROEROOM MODEL #W581PD-DANE-626 (KEY #2), DOOR CLOSER: DOR "O" MAT TIC MODEL #SC94-AL, WALL STOP
106	Е	3' - 0"	7' - 0"	0' - 1 3/4"	LEVER: DOORIANDLE FALCON STOREROOM MODEL #W581PD-DANE 626 (KEY #2), DOOR CLOSER: DOR "O" MAT TIC MODEL #SC94-AL, WALL STOP

COMPANY	CONTACTS	PHONE #	REQUIRED ITEMS
BASS SECURITY SERVICES, INC.	NATIONAL ACCOUNT SALES	888-774-3400 EXT. 2022	OOOR HARDWARE AND RESTROOM ACCESSORIES
MC CUE CORPORATION	DENISE CURRMAN	800-800-8503 EXT. 290	CART BUMPERS AND CORNER GUARDS PART# 9014 TRIMKIT
LENNOX	JOSHUA PLUMMER	800-367-6285 OPT.1	HVAC UNITS - (LOW GAS) KGA060S4B-DG / ELEC.) KCA060S4B-DG
CARRIER	ALISON HARTMAN	800-690-1081	HVAC UNITS - (HIGH GAS) 48TCFA06A1A3A0A0A0A1-DG
SHERWIN WILLIAMS	LOCAL SHERWIN WILLIAMS STOP		PAINT, PRIMER, CONCRETE SEALER AND BLOCK FILLER
STANLEY DOORS	ART BULLMAN RYAN DRISCOLL	636-391-1508 800-648-1401 OPT. 2, EXT. 6	AUTOMATIC DOORS AND STORE FRONT GLAZING SYSTEM
D&P CUSTOM LIGHTING	NATIONAL ACCOUNT SALES	800-251-2200	CUSTOM POWER POLES
EMERSON CLIMATE TECHNOLOGIES	PETE STEVENS	770-425-2724	EMS SUPPLIER
RETROPLATE SYSTEMS	LEO HENDERSON general-dollar@retroplatesystem.co	888-942-3144	CONCRETE POLISHING SYSTEMS
CONSOLIDATED ELECTRICAL DISTRIBUTO	RS ROBERT DECKER	270-781-2229	ELECTRICAL, LIGHTING SUPPLIES

OPTIONAL NATIONAL ACCOUNT VENDORS OS LICTION												
COMPANY	CONTACTS	PHONE#	REQUIRED ITEMS									
LIBERTY BUILDING SYSTEMS	1 DAVIDENGEISH	877-505-4596	PRE-ENGINEERED METAL BUILDING									
STAR BUILDING SYSTEMS	JEFRHORN / US	866-664-8899	PRE-ENGINEERED METAL BUILDING									
NUCER BUILDING SYSTEMS	TY DAVENPORT	803-799-9708	PRE-ENGINEERED METAL BUILDING									
CASCO	JOHN HARRIS	314-821-1100	PROFESSIONAL SERVICES									
VATIONAL ACCOUNT 8	CONTACT INFORMATIO	SUBJECT TO CH	HANGE									

FIRE RATED DOORS, SOLID CORE WOOD DOOR OR HOLLOW CORE METAL DOOR PAINTED TO MATCH THE CORRESPONDING SURFACES.

FIRE RATED DOORS, SOLID CORE WOOD DOOR OR HOLLOW METAL DOOR PAINTED TO MATCH THE WALL SURFACE.

PAINTED TO MATCH THE CORRESPONDING SURFACES.


SOLID CORE WOOD DOOR OR HOLLOW CORE METAL DOOR PAINTED TO MATCH THE WALL SURFACE.

SOLID CORE WOOD DOOR OR HOLLOW CORE METAL DOOR PAINTED TO MATCH THE WALL SURFACE.

SOLID CORE WOOD DOOR OR HOLLOW CORE METAL DOOR PAINTED TO MATCH THE WALL SURFACE.

UPDATE THIS SHEET WITH

ATTACHED REVISD SCHEDULES

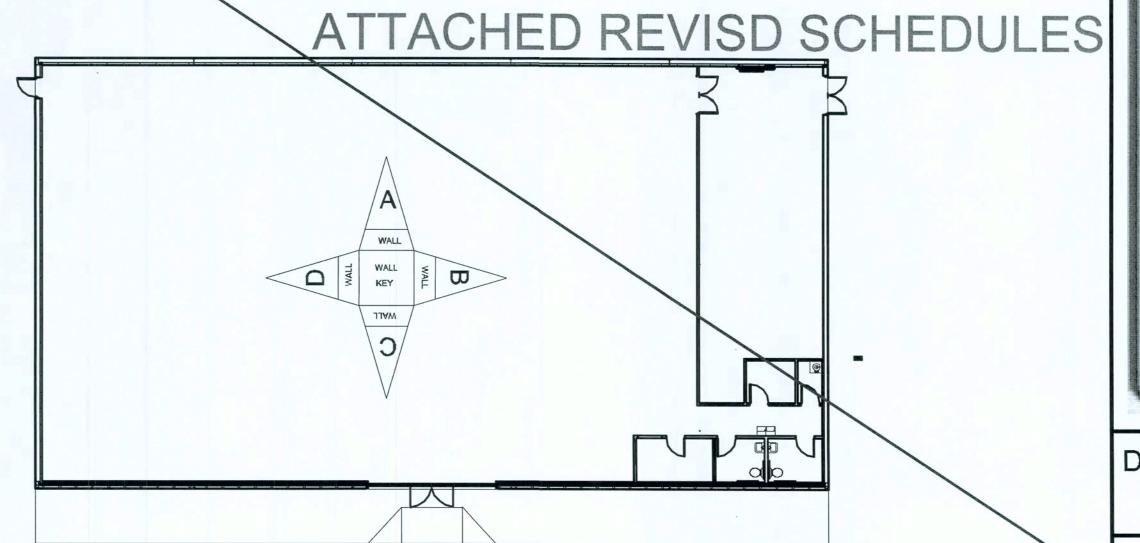

SCHEDULES OPTION "D"



5/19/08

DATE

05/19/08

SHEET NUMBER

A4.E

D" Manual Mines


								RC	OOM SCHE DULE							
	ROOM	FLC	OOR	ВА	NSE	ΑV	VALL	BV	VALL	C	WALL	DV	VALL	CEILING	CEILING	
NO	NAME	MATERIAL	FINISH	MATERIA	LFINISH	MATERIAL	FINISH	MATERIAL	FINISH	MATERIAL	FINISH	MATERIAL	FINISH	MATERIAL	FINISH	REMARKS
	BREAK RM.	FLOOR SEALED	S.W. ACRYLIC SILICONE, SILK CHOCOLATE #HC-117	4" RUBBER / VINYL BASE		GYPSUM BOARD TO ROOF DECK	SHERWIN WILLIAMS PAINT ANTIQUE WHITE, LATEX SEMI GLOSS PRODUCT #B31W404	TO 8'-0"	SHERWIN WILLLIAMS PAINT ANTIQUUE WHITE, LATEX SEMI GGLOSS PRODUCT #B331W404	GYPSUM BOARD TO 8'-0"	SHERWIN WILLIAMS PAINT ANTIQUE WHITE, LATEX SEMI GLOSS PRODUCT #B31W404	GYPSUM BOARD TO ROOF DECK	SHERWIN WILLIAMS PAINT ANTIQUE WHITE, LATEX SEMI GLOSS PRODUCT #B31W404	2' X 4' ACCOUSTICAL CEILING 8'-0" A.F.F.	WHITE	
101 C		CONCRETE FLOOR SEALED	S.W. ACRYLIC	4" RUBBER / VINYL BASE		GYPSUM BOARD TO 8'-0" AFF	SHERWIN WILLIAMS PAINT ANTIQUE WHITE, LATEX SEMI GLOSS PRODUCT #B31W404	TO 8'-0"	PAINT ANTIQUUE WHITE, LATEX SEMI GGLOSS PRODUCT #B331W404	GYPSUM BOARD TO 8'-0"	SEMI GLOSS PRODUCT #B31W404	TO 8'-0"	SHERWIN WILLIAMS PAINT ANTIQUE WHITE, LATEX SEMI GLOSS PRODUCT #B31W404	2' X 4' ACCOUSTICAL CEILING 8'-0" A.F.F.	WHITE	
102 5	SALES AREA	CONCRETE FLOOR POLISHED	RETROPLATE POLISHED CONCRETE WITH RETROPLATE 99 SEALER	4" RUBBER / VINYL BASE			SHERWIN WILLIAMS PAINT ANTIQUE WHITE, LATEX SEMI GLOSS PRODUCT #B31W404	GYPSUM BOARD TO ROOF DECK	SHERWIN WILLLIAMS PAINT ANTIQUUE WHITE, LATEX SEMI GGLOSS PRODUCT #B331W404	GYPSUM BOARD TO 10'-0" A.F.F.	SHERWIN WILLIAMS PAINT ANTIQUE WHITE, LATEX SEMI GLOSS PRODUCT #B31W404	GYPSUM BOARD TO 10'-0"	SHERWIN WILLIAMS PAINT ANTIQUE WHITE, LATEX SEMI GLOSS PRODUCT #B31W404	2' X 4' ACCOUSTICAL CEILING @ 10' AFF	WHITE	
103 F		CONCRETE FLOOR SEALED	S.W. ACRYLIC	N/A	N/A	METAL LINER PANEL TO ROOF DECK	LIGHT STONE	METAL LINER PANEL TO ROOF DECK	LIGHT STONE	GYPSUM BOARD TO ROOF DECK	TAPED. PAINTED IF REQUIRED BY CODE. MTL LINER PANEL TO DECK AS ALT.	GYPSUM BOARD TO ROOF DECK	TAPED. PAINTED IF REQUIRED BY CODE. MTL LINER PANEL TO DECK AS ALT.	EXPOSED TO STRUCTURE ABOVE	N/A	
104 N		CONCRETE FLOOR SEALED	S.W. ACRYLIC	4" RUBBER / VINYL BASE		GYPSUM BOARD TO 8'-0" AFF	FIBERGLASS REINFORCED PANEL-WHITE 8'-0" HIGH	GYPSUM BOARD TO 8'-0" AFF	FIBERGLASS REINFORCED) PANEL-WHITE= 8'-0" HIGH	GYPSUM BOARD TO 8'-0" AFF	FIBERGLASS REINFORCED PANEL-WHITE 8'-0" HIGH	GYPSUM BOARD TO 8'-0" AFF	FIBERGLASS REINFORCED PANEL-WHITE 8'-0" HIGH	2' X 4' ACCOUSTICAL CEILING @ 8'-0" AFF	WHITE	
105 V	WOMEN	CONCRETE FLOOR SEALED	S.W. ACRYLIC	4" RUBBER / VINYL BASE		GYPSUM BOARD TO 8'-0" AFF	FIBERGLASS REINFORCED PANEL-WHITE 8'-0" HIGH	GYPSUM BOARD TO 8'-0" AFF	FIBERGLASS REINFORCED) PANEL-WHITEE 8'-0" HIGH	GYPSUM BOARD TO 8'-0" AFF	FIBERGLASS REINFORCED PANEL-WHITE 8'-0" HIGH	GYPSUM BOARD TO 8'-0" AFF	FIBERGLASS REINFORCED PANEL-WHITE 8'-0" HIGH	2' X 4' ACCOUSTICAL CEILING 8'-0" A.F.F.	WHITE	
106	JANITOR CLOSET	CONCRETE FLOOR SEALED	S.W. ACRYLIC	4" RUBBER / VINYL BASE		GYPSUM BOARD TO ROOF DECK	FRP WHITE - 4'x4', PAINT ABOVE SW ANTIQUE WHITE, LATEX SEMI GLOSS #B31W404	GYPSUM BOARD TO 8'-0" AFF	FRP WHITE - 4'x4', PAINT ABOVE SW ANNTIQUE WHITE, LATEXX SEMI GLOSS #B31WW404	GYPSUM BOARD TO 8'-0" AFF	SHERWIN WILLIAMS PAINT ANTIQUE WHITE, LATEX SEMI GLOSS PRODUCT #B31W404	GYPSUM BOARD TO 8'-0" AFF	SHERWIN WILLIAMS PAINT ANTIQUE WHITE, LATEX SEMI GLOSS PRODUCT #B31W404	2' X 4' ACCOUSTICAL CEILING 8'-0" A.F.F.	WHITE	FRP = FIBERGLASS REINFORCED PANELS

					DOOK SCHEEDULE	
	DOOR		3			
NO.	Type	Type WIDTH HEIGHT THICKNESS				REMARKS
100	A	3' - 0"	7' - 0"		LEVER: DOC HANDLE FALCON PASSAGE MODEL #E101S-DANE-626 (NO KEY REQ'D), DOOR CLOSER: "DOR "("O" MATIC MODEL #SC94-AL, WALL STOP, TACOOOR VIEWER MODEL #TA3310PC	SOLID CORE WOOD DOOR OR HOLLOW CORE METAL DOOR PAINTED TO MATCH THE WALL SURFACE.
101	А	3' - 0"	7' - 0"		TACO DOOR/IEWER MODEL #TA3310PC	SOLID CORE WOOD DOOR OR HOLLOW CORE METAL DOOR PAINTED TO MATCH THE WALL SURFACE.
102	Е	6'-0"	7'-0"			STANLEY DURA-GLIDE SERIES 2000 21'-0" BI-PART WITH TRANSOM AND GLASS. BRONZE FINISH
102A	С	3' - 0"	7' - 0"	0' - 1 3/4"		FIRE RATED DOORS, SOLID CORE WOOD DOOR OR HOLLOW CORE METAL DOOR PAINTED TO MATCH THE CORRESPONDING SURFACES.
103A	В	6' - 0"	7' - 0"	0' - 1 3/4"	PULL HANDE, 8" KICK PLATE, DOOR CLOSER: DOR "O" MATIC MODEL #SC94-AL, PUSH PLATE	FIRE RATED DOORS, SOLID CORE WOOD DOOR OR HOLLOW METAL DOOR PAINTED TO MATCH THE WALL SURFACE.
103B	D	6' - 0"	7' - 0"	0' - 1 3/4"	CLOSER: DC "O" MATIC MODEL #SC94-AL, PULL HANDLE, 2" DOOR SCOPE: MODEL #DS 1000MB, 8" KICK DOVWN DOOR STOP MODEL #612Z FROM BASS SECURITIES, BASS SECURITIES - NATIONAL GUARD HD LOW PROFILE HC THRESHOLD # 425 HD - 6'-0", 1/2" MAX. WITH SMOOTH TRANSITION	
104	A	3' - 0"	7' - 0"	0' - 1 3/4"	LEVER: DOα HANDLE FALCON STOREROOM MODEL #W581PD-DANE-626 (KEY #2), DOOR CLOSER: DOR "O" MATIC MODEL #SC94-AL, WALL STOP	SOLID CORE WOOD DOOR OR HOLLOW CORE METAL DOOR PAINTED TO MATCH THE WALL SURFACE.
105	А	3' - 0"	7' - 0"	0' - 1 3/4"	LEVER: DOC HANDLE FALCON STOREROOM MODEL #W581PD-DANE-626 (KEY #2), DOOR CLOSER: DOR "O" MATIC MODEL #SC94-AL, WALL STOP	
106	E	3' - 0"	7' - 0"	0' - 1 3/4"	LEVER: DOC HANDLE FALCON STOREROOM MODEL #W581PD-DANE-626 (KEY #2), DOOR CLOSER: DOR "O" MATIC MODEL #SC94-AL, WALL STOP	SOLID CORE WOOD DOOR OR HOLLOW CORE METAL DOOR PAINTED TO MATCH THE WALL SURFACE.

COMPANY	CONTACTS	PHONE #	REQUIRED ITEMS
BASS SECURITY SERVICES, INC.	NATIONAL ACCOUNT SALES	888-774-3400 EXT. 2022	DOOR HARDWARE AND RESTROOM ACCESSORIESS
MC CUE CORPORATION	DENISE CURRMAN	800-800-8503 EXT. 290	CART BUMPERS & CORNER GUARDS PART #9014 TRIMKIT
LENNOX	JOSHUA PLUMMER	800-367-6285 OPT.1	HVAC UNITS - (LOW GAS) KGA072S4BN / ELEC.) KC/A072S4BN
CARRIER	DEBORAH ROY-JONES	800-690-1086	HVAC UNITS - (HIGH GAS) 48TCFA06A1A3A0A0A0A1 _{1-DG}
SHERWIN WILLIAMS	LOCAL SHERWIN WILLIAMS STRE		PAINT, PRIMER, CONCRETE SEALER AND BLOCK FI-ILLER
STANLEY DOORS	ART BULLMAN RYAN DRISCOLL	636-391-1508 800-648-1401 OPT. 2, EXT. 6	AUTOMATIC DOORS AND STORE FRONT GLAZING SYSTEM
D&P CUSTOM LIGHTING	NATIONAL ACCOUNT SALES	800-251-2200	CUSTOM POWER POLES
EMERSON CLIMATE TECHNOLOGIES	WEBSITE: http://dollargeneralbid.ectsolutionset	USER NAME: dollargeneralbid PASSWORD: dollargeneralbid	EMS SUPPLIER NOTE: CUSTOMIZED DOLLAR GENEERAL EMS PANEL REQUIRES STORE #, CITY, STATE, ZIP CODEE & QTY. OF HVAC UNITS OF THE INSTALL SITE WHEN ORDERING.
RETROPLATE SYSTEMS	LEO HENDERSON general-dollar@retroplatesystem.om	888-942-3144	CONCRETE POLISHING SYSTEMS
COMMERCIAL LIGHTING INDUSTRIES	DARRYL ZIDE darryl@commercial-lighting.net	800-755-0155	ELECTRICAL, LIGHTING SUPPLIES IN THE FOLLOWI/ING STATES: AL, AR, AZ, CO, CT, DE, IA, IL, IN, KS, KY, LA, MA, MCD, MI, MN, MO MS, NE, NH, NJ, NM, NY, OH, PA, RI, SD, TN, TX, UT, VT, WI
HARRIS LIGHTING	SHENNEL JOHNSON sjohnson@harrislights.com	904-284-1220 EXT. 262	ELECTRICAL, LIGHTING SUPPLIES IN THE FOLLOWI/ING STATES: FL, GA, NC, SC, VA, WV.

OPTIONAL NATIONAL	AL ACCOUNT VEND	ORS		
COMPANY	CONTACTS	PHONE #	REQUIRED ITEMS	
LIBERTY BUILDING SYSTEMS	DAVID ENGLISH	877-505-4596	PRE-ENGINEERED METAL BUILDING	
STAR BUILDING SYSTEMS	JEFF HORN	866-664-8899	PRE-ENGINEERED METAL BUILDING	
NUCOR BUILDING SYSTEMS	BURT SHELL	717-735-7766 EXT. 225	PRE-ENGINEERED METAL BUILDING	

NATIONAL ACCOUNT & CONTACT INFORMATION SUBJECT TO CHANGE

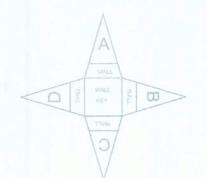


SCHEDULES OPTION "D"


A4.D




E.C. RESPONSIBILITES: Wire for door alarms and all dor automation and low voltage devices.

Clearspan Responsibilities: Provide and additional hardwae for exterior doors (not provided by Liberty Building Systems) Irovide & interior doors and hardware.

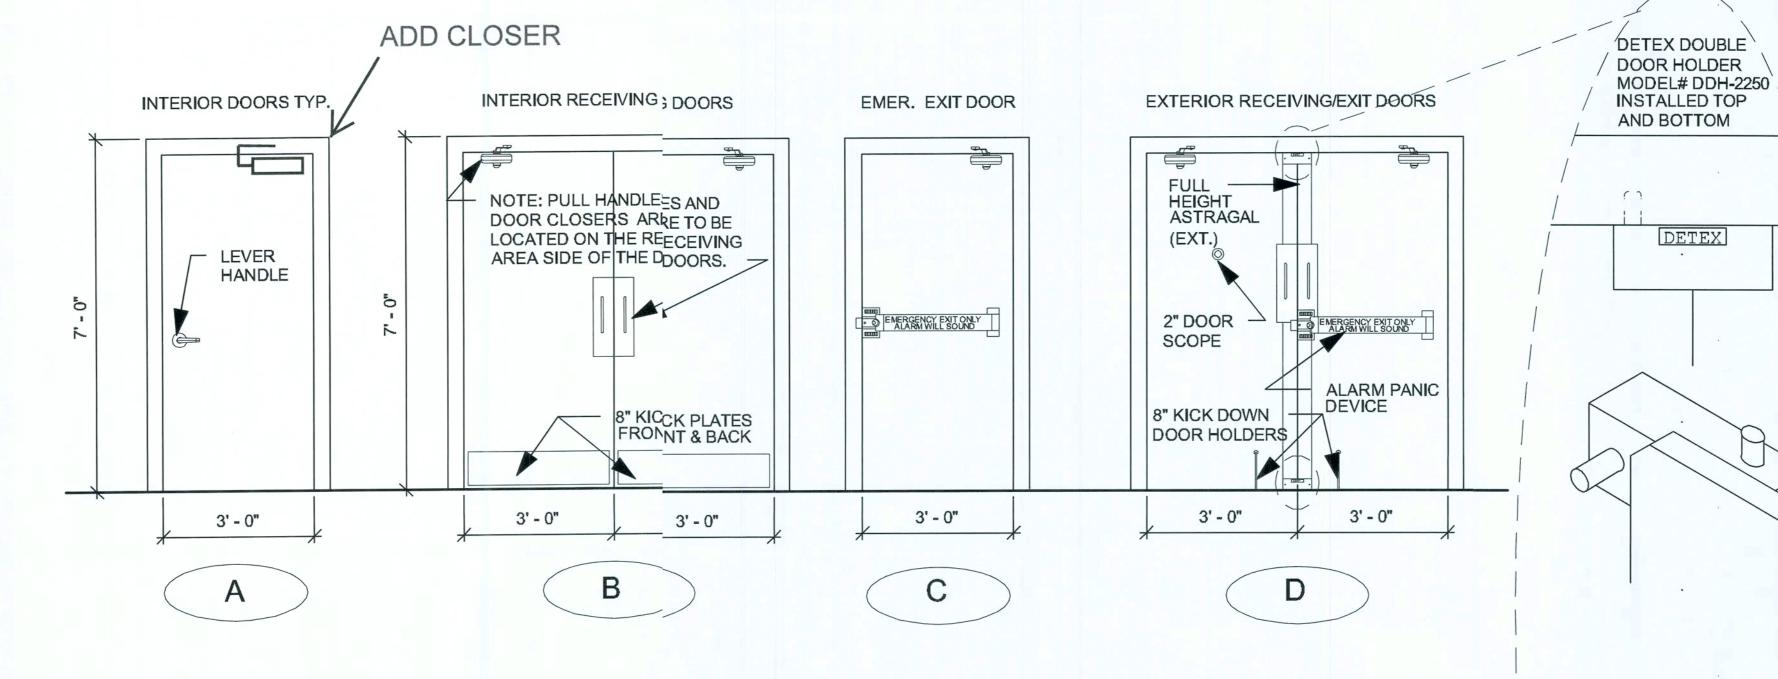

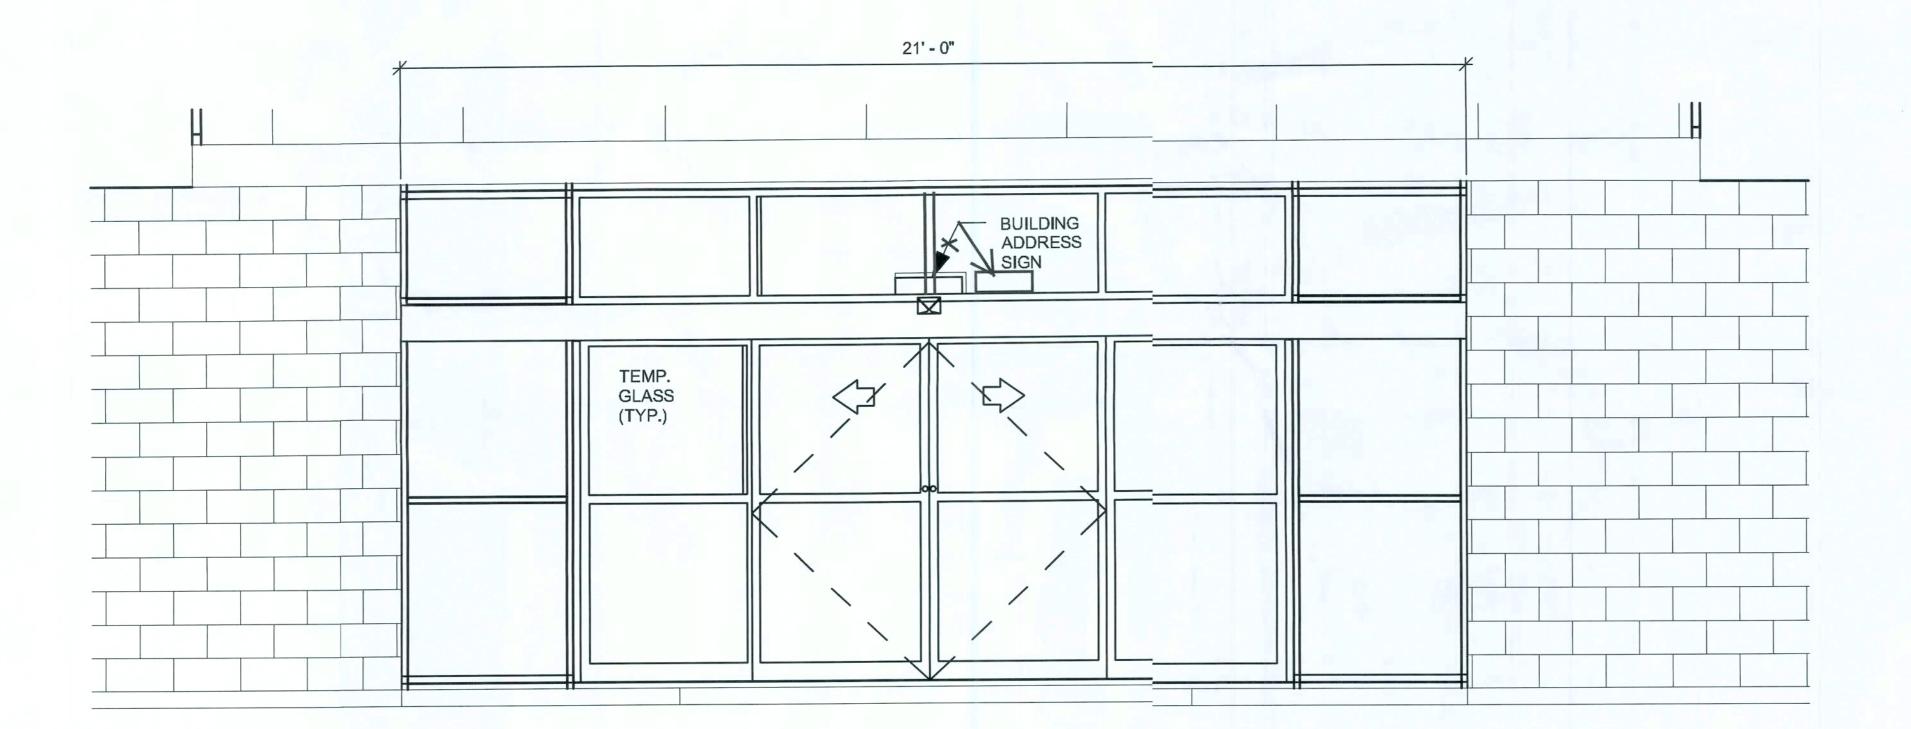

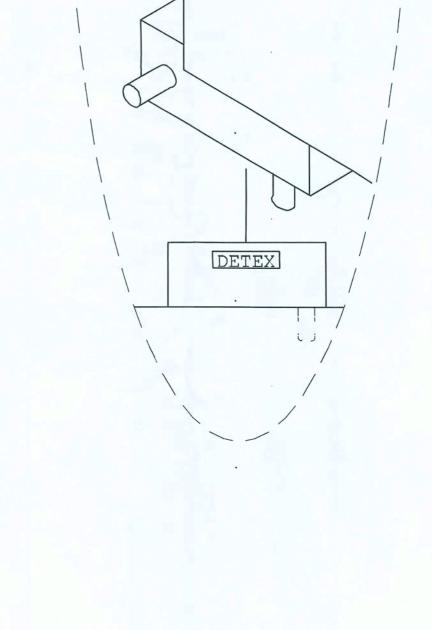

DETEX DOUBLE

AND BOTTOM

DETEX

Issued Dependent Struction:

A2.D A5.D 1/4" = 1'-0"

Concept Construction

Date: 2/2/09

NOTE: BI-PART DOORS AND ENTIRE STOREFRONT GLAZING SYSTEM PROVIDED BY STANLEY.




DATE


05/19/08

SHEET NUMBER

A5.D

DOOR DETAILS OPTION "D"

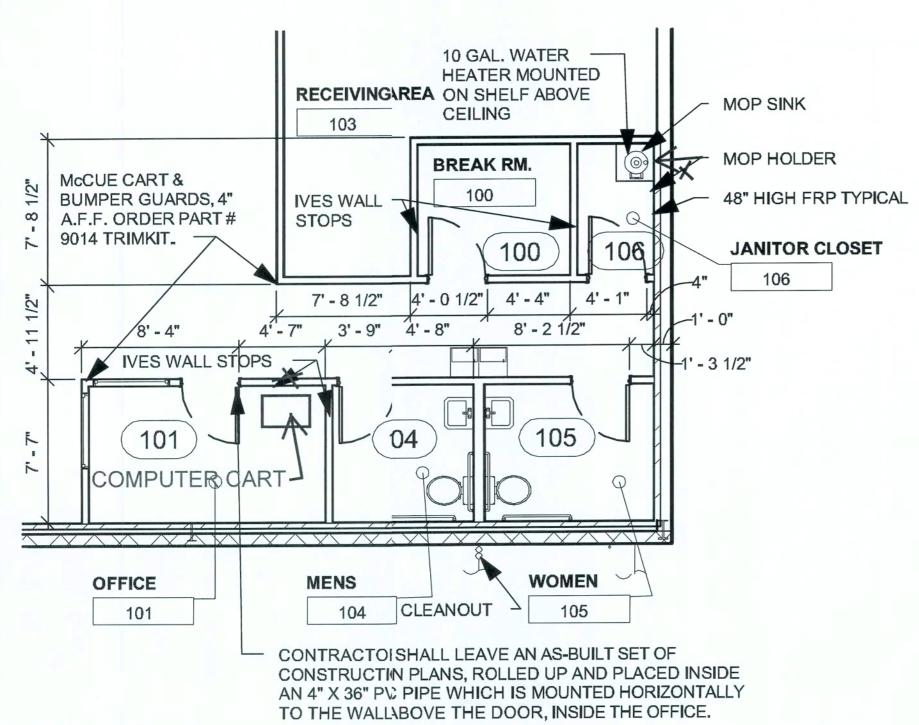

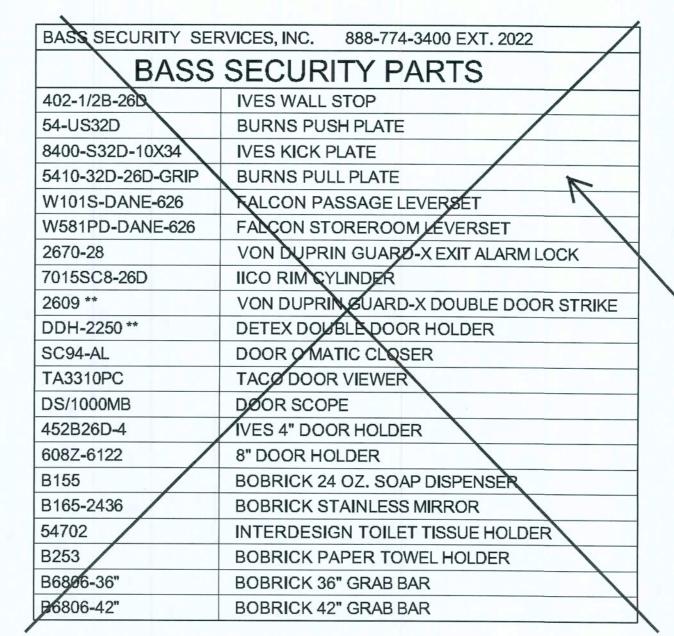

10877 WATSON ROAD ST. LOUIS, MO 63127

5/19/08

EAS

ADDENDA 866 (783

CRITERIA


PROTOTYPE


2008


USE ATTACHED UPDATED LIST


RESTROOM/OFFICE PLAN

3/32" = 1'-0"

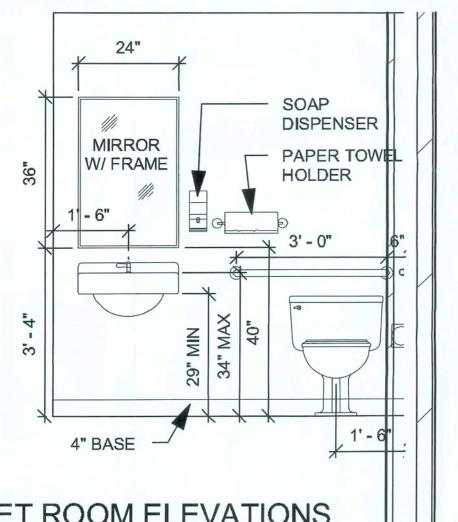

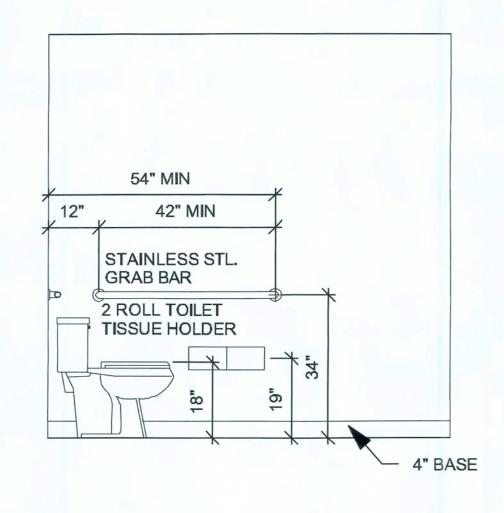


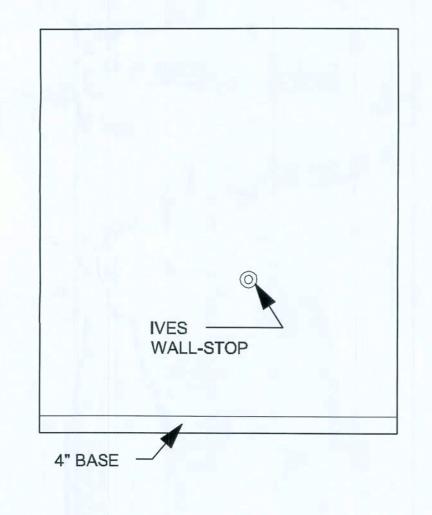

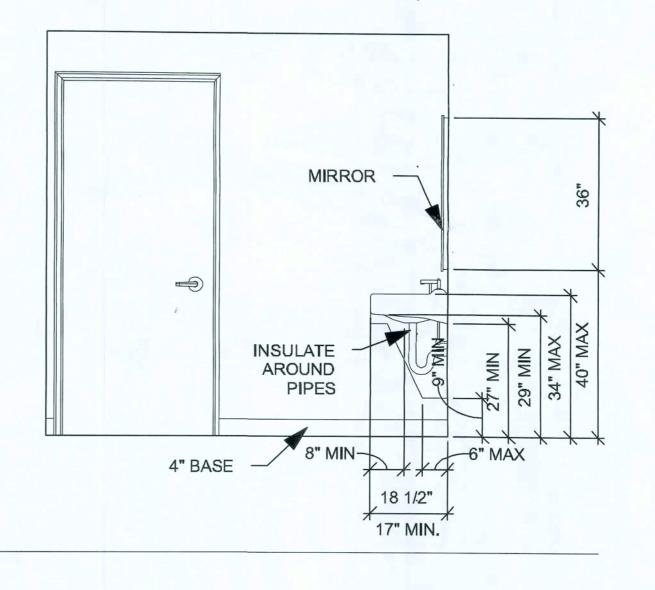





TOILET ROOM ELEVATIONS 1/4" = 1'-0"

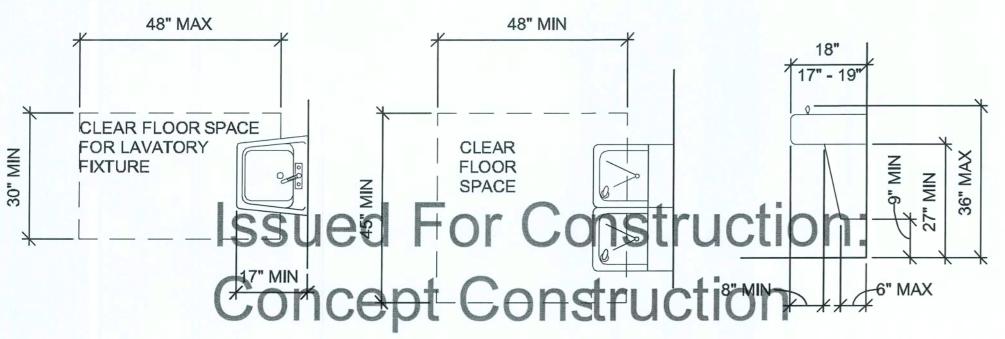

Date: 2/2/09
A.D.A. CLEARANCES 1/4" = 1'-0"

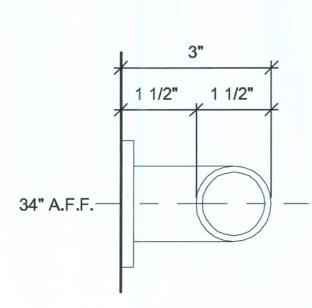

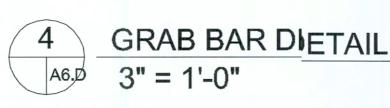

CONCEPT CONSTRUCTION

Plumber: Provide & Install| all grab bars and

bathroom accessories including tissue holders,

addition to all standard plumbing requirements.

interior doors and associaated hardware.

soap dispensers, towel hoolders, pipe insulation in

Clearspan Responsibilitiess: Provide and install all

SUBCONTRACTFORS:

NOTES TO

REST ROOMS

1. ALL STORES MUST INCLUDE 2 REST ROOMS, EVEN WHEN NOT REQUIRED BY CODE. ANY VARIATION MUST BE APPROVED, IN WRITING, BY THE DOLLAR GENERAL CONSTRUCTION AUTOCAD DEPARTMENT.

2. REST ROOMS MUST COMPLY WITH ALL BUILDING (FEDERAL, STATE, AND LOCAL) FIRE, AND HEALTH DEPARTMENT CODES. ADA REQUIREMENTS MUST ALSO BE MET IN BOTH RESTROOMS. SOME CODES MAY REQUIRE ADDITIONAL TOILETS OR LAVATORIES. PLEASE CONTACT DOLLAR GENERAL CONSTRUCTION AUTOCAD DEPARTMENT FOR ALTERNATE PLANS FOR THESE SITUATIONS.

3. PROVIDE AND INSTALL 3' X 2' MIRROR (OR LARGER IF REQUIRED BY CODE) IN REST ROOMS ABOVE LAVATORY.

4. CONTRACTOR TO INSTALL SOAP DISPENSERS, TOILET PAPER HOLDERS, DOOR CLOSERS, DOOR HOLDERS, EXHAUST FANS, AND ALL BASS SECURITY PARTS IN BOTH RESTROOMS.

DATE

05/19/08

SHEET NUMBER

A6.D

TOILET PLAN & DETAILS OPTION "D"

STANDARD SIGN SPECIFICATIONS

	BOX SIGNS	
SIZE	AMPS / WATTS	WEIGH.
3' x 23'	2.5 AMPS / 292 WATTS	485 LB\$
3'-9" x 26'	5.0 AMPS / 584 WATTS	695 LB5
5' x 40'	10 AMPS / 1168 WATTS	1400 LB.
1' x 4'	0.70 AMPS / 65 WATTS	30 LBS

	INDIVIDUAL LETTERS	4	
	WARM CLIMATE AMPS	WEIGH	
SIZE	COLD CLIMATE AMPS	VVLIGI	
	30MA - 7.88 AMPS	210 LB	
18" LTRS	60MA - 15.75 AMPS	210 LB	
	30MA - 7.88 AMPS	0.45.1.0	
24" LTRS	60MA - 15.75 AMPS	245 LB	
	30MA - 9.75 AMPS	220 L B	
30" LTRS	60MA - 19.00 AMPS	330 LB	
	30MA - 12.00 AMPS	400 L B	
36" LTRS	60MA - 24.00 AMPS	400 LB	

	PYLON SIGNS	
SIZE	AMPS / WATTS	WEIGH
4' x 8'	1.7 AMPS / 198 WATTS	250 LB.
5' x 10'	3.4 AMPS / 396 WATTS	389 LB.
6' x 16'	5.0 AMPS / 584 WATTS	750 LB.

SIGN SPECIFICATIONS

1. BUILDING SIGNS: PROVIDE CONDUIT FROM ELECTRICAL PANL TO THE CENTER OF THE SIGN CANOPY. THE CONDUIT IS TO BE 1" AD HAVE ONE SET OF 10/2 WIRE WITH GROUND AND A 20-AMP BREKER AT THE PANEL. BUILDING CANOPY MUST BE SUFFICIENTLY BUIL TO SUPPORT THE DOLLAR GENERAL SIGN UP TO 1400 LBS. NOTE: ITHE LEASE SPECIFIES A 5'-0" X 40'-0" BUILDING SIGN OR 24" LETTER ST (OR LARGER), 2 qty. - 10/2 WIRE WITH GROUND AND 2 qty. 20 AMP CIRUITS


2. PYLON SIGNS: PROVIDE CONDUIT FROM ELECTRICAL PANEL D LOCATION OF THE PYLON SIGN BASE. BURY CONDUIT UNDER PRKING AREA. THE CONDUIT IS TO BE 1" AND HAVE ONE SET OF 10/2 WIE WITH GROUND AND A 20-AMP BREAKER AT THE PANEL.


3. FINAL ELECTRICAL CONNECTIONS FOR SIGN SHALL BE THE O/NERS RESPONSIBILITY AFTER SIGNS ARE INSTALLED.


4. TIMERS AND PHOTOCELL COMBINATION ARE USED FOR ALL EXTERIOR SIGNS.

5. SEE CHART ABOVE FOR SIGN SPEC'S.

6. SEE SHEE S1.D FOR MOUNTING SUPPORT DETAILS

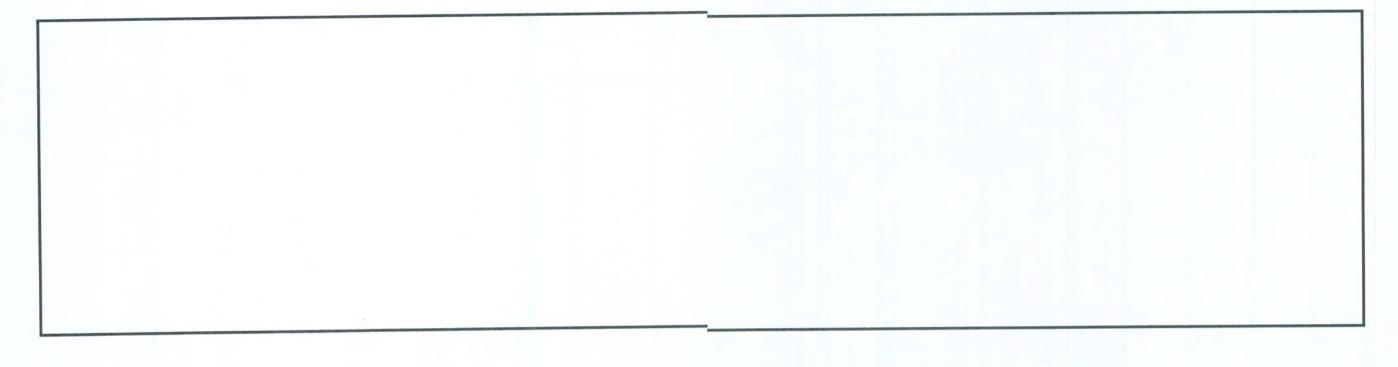

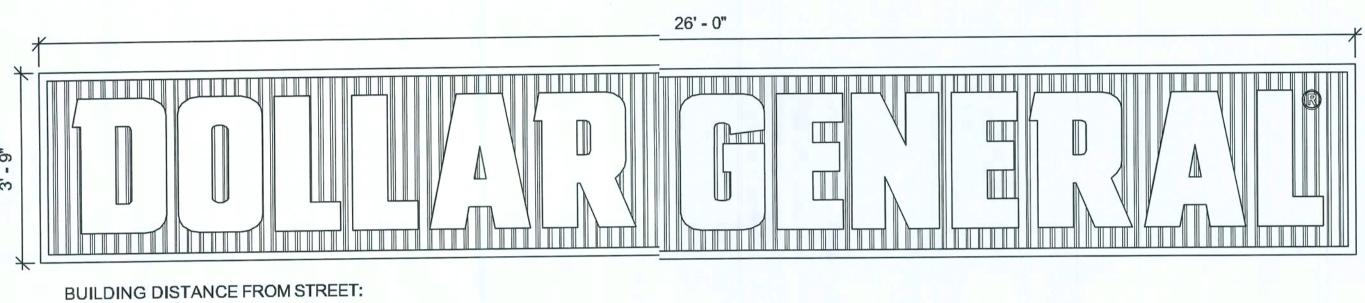


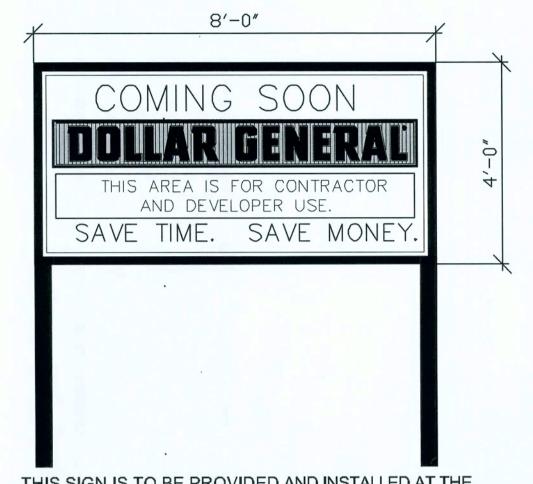





Note!! See Plan Addendum 2 & 3 for additional sign details

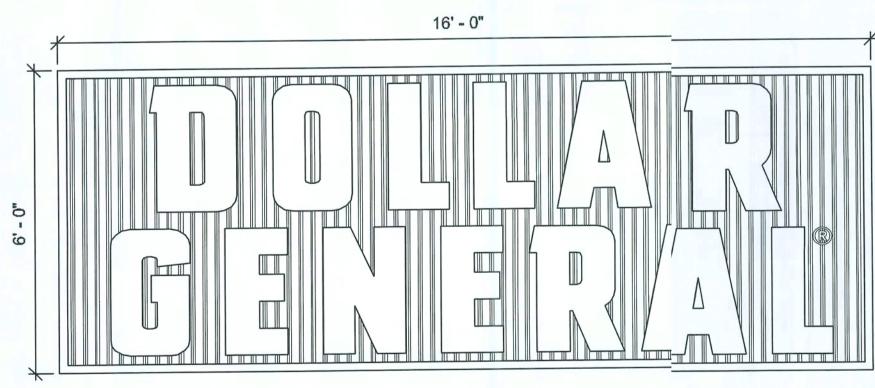

CONCEPT CONSTRUCTION NOTES TO SUBCONTRACTORS:

Electrician shall coordinate proper sizing with contractor prior to wiring signs

SIGN DETAILS OPTION "D"

10877 WATSON ROAD ST. LOUIS, MO 63127

DATE

05/19/08

SHEET NUMBER


	PEMB	LIBERT	Y BUILDING	SYSTEMS	3		STAR	BUILDING	SYSTEMS	3		NUC	NUCOR BUILDING SYSTEMS			
	VENDOR	ATTN: D	AVID ENGLI	SH (8	77) 505-459	6	ATTN:	JEFF HOF	RN	866-664	1 - 8899 ₉	ATT	N: TY DAVE	NPORT	803-799-9	
EXTERIOR FINISHES EXTERIOR FINISHES ARE TO MATCH OR BE EQUAL TO LIBERTY METAL BUILDING SYSTEM'S FINISH SELECTION	LIGHT-10MF	BURWISHED	BROWZE	POLAR WHIT	GAL VALUMA	LIGHT STO	MEDIUM BROW	BRONZE	POLARM	GALVALUMA	SM. LHOIT	MEDIUME	BRONZE	POLARM	GALVALIME	
GUTTERS	0					0					00					
DOWN SPOUTS	0					0					°0					
SIDE AND REAR METAL WALL PANELS RECEIVING & EMER. EXIT DOORS	۰					۰					°°					
ARCHITECTURAL BLOCK AT BUILDING FACADE SHOULD BE PRE FINISHED OR PAINTED (2 COATS - LOXON XP MASONRY COATING A24W400 SERIES) TO MATCH THE WALL MTL. PANEL	0					0					° ₀					
FLAT METAL SOFFIT AT STOREFRONT VESTIBULE				0					0					0		
BUILDING PARAPET WALL		0					0					•				
STANLEY STOREFRONT SYSTEM			0					0					0			
ROOF					0					0	- 6-1				0	

OPTIONAL NATIONAL A	CCOUNT VENDORS			
COMPANY	CONTACTS	PHONE #	REQUIRED ITEMS	
LIBERTY BUILDING SYSTEMS	DAVID ENGLISH	877-505-4596	PRE-ENGINEERED METAL BUILDING	USE ATTACHED UPDATED LIST
STAR BUILDING SYSTEMS	JEFF HORN	866-664-8899	PRE-ENGINEERED METAL BUILDING	OSE ATTACHED OF DATED LIST
NUCOR BUILDING SYSTEMS	TY DAVENPOR	803-799-9708	PRE-ENGINEERED METAL BUILDING	
CASCO	JOHN HARRIS	314-821-1100	PROFESSIONAL SERVICES	

NATIONAL ACCOUNT & CONTACT IN: ORMATION SUBJECT TO CHANGE

PREFERRED LOCATION OF NON-PENETRATING SATELLITE MOUNT (ABOVE OFFICE)

ANDREW CORP. MODEL # 611005701 OR ANDREW CORP. MODEL #611005702

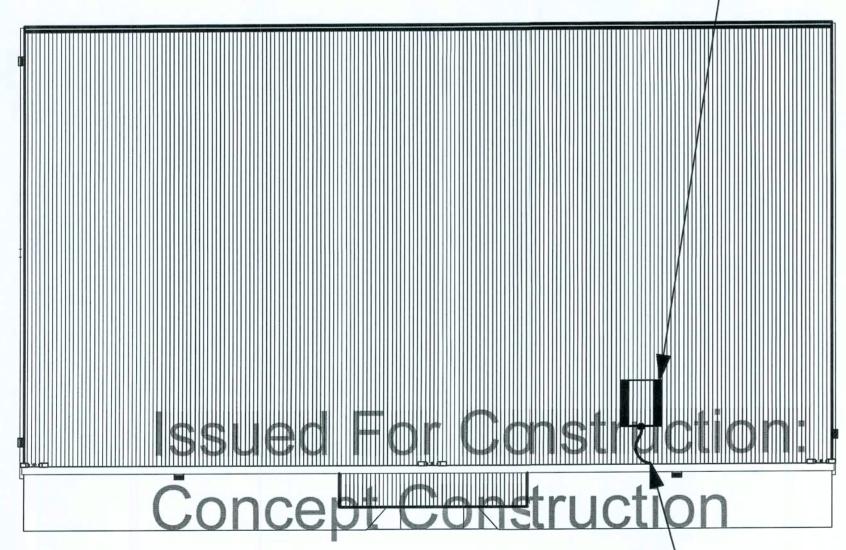

Date: 2/2/09

1 SATELLITE LOCATION KE' 1/32" = 1'-0"

LOCATION OF CONDUIT (ABOVE OFFICE) FOR SATELLITE LINE. PROVIDE WEATHER TIGHT SEAL AT PARAPET PENETRATION.

STRUCTURAL NOTES:

The pre-manufactured metal building structure, concrete foundation, and interior concrete slab shall be designed, detailed, fabricated, and constructed in accordance with all applicable codes, standards and regulations. The most stringent requirements apply where inconsistencies occur between the Applicable Standards. In the absence of other criteria, loadings shall conform to the 2006 edition of the International Building Code.

The scope of the pre-manufactured metal building structure shall include the design, engineering, fabrication, delivery, and erection of the complete structural steel framing and exterior skin package. The metal building manufacturer shall be certified by American Institute of Steel Construction (AISC) Metal Building Certification Program.

The front fascia shall have (3) 12" perlins (mounted vertically so that the 12" face is against the building metal siding. These perlins shall be centered over the entrance and spaced 96" apart to provide adequate support for signage which may weigh up to 1,400 lbs.



5/19/08 ADDENDA 865-4763 CRITERIA AutoCAD-8 PROTOTYPE 2008

DATE

05/19/08

SHEET NUMBER

S1.D

STRUCTURAL NOTES OPTION "D"

FLOOR SLAB

The conscete foundation and interior concrete slab shall be desined, detailed, and constructed to provide the safe and serviceable support of the re-manufactured metal building structure and all prescribed loads applied thereto and sall conform to the latest editions of all applicable standards of the American Concrete Intitute. The soil sub-grade shall be prepared in accordance with site specific written recommendations provided by a registered Professional Geotechnical Engineer licensed in the sate where the project is located. In the absence of such recommendations, the soil subgrade shall be prepared in accordance with the prescriptive requirements of the applicablemodel building code. Maintain 68' 1 1/2" from face of column to face of column width n sales floor.

The concrete foundation and concrete slab construction shall met the following minimum performance requirements:

- (A) Minimum foundation bearing depths relative to final adjacengrade:
 - (1) Site specific maximum frost penetration.
 - (2) Depth required to attain minimum recommended/prescribed beitring pressure.
 - (3) Depth required to limit settlement/heave to maximum vales established herein.
- (B) Maximum vertical settlement/heaving of foundation and/or iterior concrete slab over the time span of 25 years:
 - (1) 1" total.
 - (2) 1/2" differential across a horizontal distance of fifty feet
- (C) Floor slab thickness shall be a minimum of 4" thick with WWI.
 - (1) No fiber reinforced concrete is allowed.
- (D) Interior concrete slab levelness and flatness requirements: (1) Levelness factor, 1/8" in 20'-0".

POLISHED CONCRETE FLOOR SUMMARY

- A. This section includes the following:
 - 1. Grinding & Polishing of Concrete
 - 2. Application of Retroplate 99 Densifier
 - 3. Application of Retro Guard.
 - 4. Installation of standard gray Polyurea joint fill.
 - 5. Mandatory pre slab meeting.

B. Related Work:

- 1. Section 03300 Cast-In-Place Concrete
- C. CORPORATE ACCOUNT MANAGER: LEO HENDERSON PH 888-942-3144

EMAIL: LEO@RETROPLATESYSTEM.COM < mailto: LEO@RETROPLATESYSTEM.COM >

- ***ALL APPLICATORS ARE TO BE APPROVED IN WRITING (N ADVANCED FLOOR PRODUCTS LETTERHEAD REFERENCING DOLLAR GENERAL
- A. Pre-Installation Conference:
- 1. Schedule and conduct pre-installation conference at Projct site to establish guidelines and expectations for scheduling of floor treatment aplication, degree of polish, concrete finish specifications, floor flatness, and similar issues. Ensure attendance at Pre-Installation Conference by at least:
 - A. Dollar General Project Manager
 - B. Flatwork Contractor
 - C. Land lord's representative
 - D. Prime Contractor
 - E. Applicable subcontractors
 - F. Certified applicator

B. Product Variations: RetroPlate

1. The variegated colors and appearance are unique to eaclconcrete surface and depend on the chemical composition, mix design, porosity, getexture and color of the concrete substrate. Mottling and wide variations in color an intensity may occur. If contaminants remain on the surface, the penetration of the RetoPlate may be blocked. Concrete from different loads orpours, and in patched areas, my appear significantly different from adjacent areas, when treated with RetroPlate.

Issued For Construction: B. DIAMOND GRINDING AND POLISHING DISCS
Only grinding and polishing discs distributed by Adviranced Floor Products are to be used.

C. Fly Ash:

1. No more than 20% of the weight of the Portland Cemenshould be substituted with fly ash. If fly ash is to be substituted Class C is minimum.

Date: 2/2/09

QUALITY ASSURANCE

A. Installer Qualifications:

- 1. Use a Dollar General certified installer and addequate number of skilled workman who are approved in writing by the manufacturer for Dollar General projectits, NO EXCEPTIONS
- 2. Applicator shall be familiar with the specified requirements and the methods needed for proper performance of work of this section. Applicator must I have availability of proper equipment to perform work within scope of this project on a timely basis. Applicator should have successfully performed a minimum of 5 projects of at least 5000 square feet each.

B. Manufacturer's Certification:

1. Provide letter of certification from Advanced FFloor Products stating that installer is certified for Dollar General Project Not all applicators are approveed

C. Protection:

- 1. No satisfactory chemical or cleaning procedur re is available to remove petroleum stains from the concrete surface. Prevention is therefore essential.
 - A. All Hydraulic powered equipment must bbe diapered to avoid staining of the concrete.
 - B. No trade will park vehicles on the inside slab. If necessary to complete their scope of work, drop cloths will be placed under r vehicles at all times.
 - C. No pipe cutting machine will be used on the inside floor slab.
 - D. Steel will not be placed on interior slab too avoid rust staining.
 - E. All equipment must be equipped with nor n-marking tires.
 - F. Do not drag or drop equipment or materiaal across the slab which will scratch or chip it.
 - G. Protect the floor from drywall mud splatters.

DELIVERY, STORAGE AND HANDLING

- A. Deliver materials in original containers, with seals unbroken, bearing manufacturer labels indicating brand name and directions for storage.
- B. Dispense special concrete finish material from factory numbered and sealed containers. Maintain record of container numbers.

PROJECT CONDITIONS

- A. Environmental limitations: Comply with manufacturer's written instructions for substrate temperature and moisture content, ambient temperature and humidity, ventilation, and other conditions affecting topping performance.
 - Concrete must have an average Floor Flatneess rating of at least 40 +/- 5.
 - 2. Concrete must have an average Floor Leveliness rating of at least 40 +/- 5.
 - 3. Concrete must be cured a minimum of 28 daays or as directed by the manufacturer before application of Retro Plate can begin.
 - 4. Application of Retro-Plate shall take place phrior to installation of equipment, thus providing a complete, uninhibited concrete slab for application.
 - B. Close areas to traffic during floor application.
- C. The completed Retroplate slab will be covered to prevent damage by the other trades during store completion.
 - D. Land ford will be responsible for providing a dumpster for disposal of products.

PART 2 - PRODUCTS

MATERIALS AND MANUFACTURERS

- A. HARDENING/SEALING AGENT (No substitution)
- 1. RetroPlate 99 manufactured by Advanced Flosor Products, Inc., P.O. Box 50533, Provo, Utah 84605 LEO HENDERSON 801.602.0095 CELL: 888.942.31444;
- DOLLAR GENERAL@RETROPLATESYSTEM.COM
- A. Performance Criteria:
 - I. Abrasion Resistance: ASTM C779 Up to 400% increase in abrasion resistance.
 - II. Impact Strength: ASTM C805 Up to 21% increase impact strength.
 - III. Ultra Violet Light and Water Spray: ASTM/ G23-81 No adverse effect to ultra violet and water
 - IV. Reflectivity: Up to 30% increase in reflectivity.
- 2. Polyurea joint filler to be used in all control joilints. Standard grey color. All joints are to be filled
- at the discretion of the certified installer.
- 3. Retroguard Heavy Duty Stain Inhibitor and Seealer: (No substitution)
- 4. Ameripolish "Edge Tint" (Concrete Gray)
- (No Substitutions).

RELATED MATERIALS

- A. Water:
- 1. Potable and on site
 - B. Temporary power for grinding and polishing esquipment will be provided by installer.

PART 3- EXECUTION

SURFACE CONDITIONS:

- A. GC or rep. to examine substrate, with installer present, for conditions affecting performance of finish. Correct conditions detrimental to timely and proper work. Do not proceed until unsatisfactory conditions are corrected.
- B. GC or rep. to verify that base slab meet finish and surface profile requirements in Division 3 Section
- Cast-In-Place Concrete, and Project Conditions above. C. Prior to application, verify that floor surfaces are free of construction latent's.
- APPLICATOR ACCEPTS THE FLOOR THEY AND THEY ALONE ARE SOLELY

RESPONSIBLE FOR THE SPECIFICATIONS TO BE MET.

- A. PLANITARY EQUIPMENT ONLY, NO EXCEPTIONS'
- 1. Initial grinding will be done with a machine with Planetary concrete grinding
- It gives the best preliminary scratch pattern needed for a good finished sheen.
- 2. Machines with at least 32 inch grinding area are required.

B. SCOPE OF WORK

EQUIPMENT:

The following RetroPlate process must be used. The following process will be used depending on the condition of the slab. Floors should be started using a 50 or 80 Grit Resin pad. A concrete grinding machine with Planetary Heads must be used. The remaining process follows:

New Construction

- 1. This process will require the use of 50 or 80 Grit resin diamond. Multiple passes may be required. Salt & Pepper aggregate will be exposed.
- 2. Grind the floor with 120 grit resin diamonds. Multiple passes may be required.
- 3. Clean/scrub the floor via automatic scrubber with soft brushes/white pads to remove all dirt and debris from the floor. Allow floor to air dry.
- 4. Apply a Retroplate to entire surface at 200 sq. ft per gallon and maintain wet state for
 - a minimum of 60 minutes.
- 5. Flush floor clean after material is spent and allow to air dry.
- 6. Grind the floor with 220 grit resin diamonds. Multiple passes may be required.
- Polish the floor with 400 grit resin diamonds. Multiple passes may be required. Polish the floor with 800 grit resin diamonds. Multiple passes may be required.
- Apply Retro Guard at a rate of 1200-1500 sq. ft per gallon.
- 10. High speed burnish with 800 grit or higher Twister pad. Multiple passes may be required.
- 11. Chase and fill grout joints with Polyurea.
- 12. Use "Edge Tint" around the edges.
- *** Applicator reserves the right to alter or add any steps in order to ensure that the floor is 100% acceptable to the owner and meets required specifications for a "level two shine."

WORKMANSHIP AND CLEANING:

- A. The premises shall be kept clean and free of debris at all times.
- B. Remove spatter from adjoining surfaces, as necessary.
- C. Repair damages to surface caused by cleaning operations. D. Remove debris from jobsite in accordance with local regulations.
- SPECIFIC QUALIFICATIONS / EXCLUSIONS (NOTE: This section, though not mandatory, will greatly improve the understanding and necessary procedures for performing this work properly.)
- A. No other trades will be allowed in the area being worked on due to possible safety and floor contamination issues.
- B. The areas to receive the RetroPlate 99 System will be delivered to the applicator in clean and swept condition. All equipment and supplies will be removed prior to turning the space over to the applicator. If the applicator is required to clean the space, and/or move other's supplies, staging and equipment, it will be done at time and materials.
- C. PROTECTION OF THE FLOOR FOLLOWING THE APPLICATION OF THE RETROPLATE 99 SYSTEM AND POLISHING IS THE RESPONSIBILITY OF THE OWNER.
- D. Upon completion the applicator will deliver a "level two shine" defined as at a distance of 30-35 feet. Light reflection will be well defined.

10877 WATSON ROAD

ST. LOUIS, MC 63127



05/19/03

SHEET NUMBER

CONCRETE SUMMARY OPTION "D"

FLOOR SLAB

The concrete foundation and interior concrete slab shall be desiged, detailed, and constructed to provide the safe and serviceable support of the premanufactured metal building structure and all prescribed loads applied thereto and shall conform to the latest editions of all applicable standards of the American Concrete Instute. The soil sub-grade shall be prepared in accordance with site specific written recommendations provided by a registered Professional Geotechnical Engineer licensed in the stæ where the project is located. In the absence of such recommendations, the soil sub-grade shall be prepared in accordance with the prescriptive requirements of the applicable model building code. Maintain 68' 1 1/2" from face of column to face of column width orsales floor.

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- (A) Minimum foundation bearing depths relative to final adjacent çade:
 - (1) Site specific maximum frost penetration.
 - (2) Depth required to attain minimum recommended/prescribd soil bearing pressure.
 - (3) Depth required to limit settlement/heave to maximum valus established herein.
- (B) Maximum vertical settlement/heaving of foundation and/or intrior concrete slab over the time span of 25 years:
 - (1) 1" total.
 - (2) ½" differential across a horizontal distance of fifty feet.
- (C) Floor slab thickness shall be a minimum of 4" thick with WWN
- (1) No fiber reinforced concrete is allowed.
- (D) Interior concrete slab levelness and flatness requirements:
- (1) Levelness factor, 1/8" in 20'-0".

POLISHED CONCRETE FLOOR SUMMARY

- A. This section includes the following:
 - Grinding & Polishing of Concrete
 Application of Retroplate 99 Densifier
- 3. Application of Retro Guard.
- 4. Installation of standard gray Polyurea joint fill.
- 5. Mandatory pre slab meeting.

B. Related Work:

- 1. Section 03300 Cast-In-Place Concrete
- C. CORPORATE ACCOUNT MANAGER: LEO HENDERSON PH 888-942-3144
- EMAIL: LEO@RETROPLATESYSTEM.COM

***ALL APPLICATORS ARE TO BE APPROVED IN WRITING OI ADVANCED FLOOR PRODUCTS LETTERHEAD REFERENCING DOLLAR GENERA..

A. Pre-Installation Conference:

- 1. Schedule and conduct pre-installation conference at Projec site to establish guidelines and expectations for scheduling of floor treatmet application, degree of polish, concrete finish specification, floor flatnes; and similar issues. Ensure attendance at Pre-Installation Conference ly at least:
 - A. Dollar General Project Manager
 - B. Flatwork Contractor
 - C. Land lord's representative
 - D. Prime Contractor
 - E. Applicable subcontractors
 - F. Certified applicator

B. Product Variations: Retroplate

1. The variegated colors and appearance are unique to each:oncrete surface and depend on the chemical composition, mix design, porosity, ae, texture and color of the concrete substrate. Mottling and wide variations in color and itensity may occur. If contaminants remain on the surface, the penetration of the Retrolate may be blocked. Concrete from different loads or pours, and in patched areas, ma appear significantly different from adjacent areas, when treated with Retroplate.

C. Fly Ash:

1. No more than 20% of the weight of the Portland Cement hould be substituted with fly ash. If fly ash is to be substituted, Class C is minimum.

QUALITY ASSURANCE

A. Installer Qualifications:

- 1. Use a Dollar General certified installer adequate number oskilled workman who are approved in writing by the manufacturer for Dollar Generabrojects, NO EXCEPTIONS.
- 2. Applicator shall be familiar with the specified requirementand the methods needed for proper performance of work of this section. Applicator just have availability of proper equipment to perform work within scope of this project on a timely basis. Applicator should have successfully performed a minimum of 5 projects of at least 5000 square feet each.

B. Manufacturer's Certification:

1. Provide letter of certification from Advanced Floor Product stating that installer is certified for Dollar General Project Not all applicators are aproved.

C. Protection:

- 1. No satisfactory chemical or cleaning procedure i is available to remove petroleum stains from the concrete surface. Prevention is therefore essentitial.
 - A. All Hydraulic powered equipment must be diapered to avoid staining of the concrete.
 - B. No trade will park vehicles on the inside slab. If necessary to complete their scope of work, drop cloths will be placed under vehicles at all times.
 - of work, drop cloths will be placed under Veehicles at all times

 C. No pipe cutting machine will be used on the inside floor slab.
 - D. Steel will not be placed on interior slab to εavoid rust staining.
 - E. All equipment must be equipped with non-Lmarking tires.
 - F. Do not drag or drop equipment or material | across the slab which will scratch or chip it.
- G. Protect the floor from drywall mud splatters_S.

DELIVERY. STORAGE AND HANDLING

A. Deliver materials in original containers, with seals unbroken, bearing manufacturer labels indicating brand name and directions for storage.

B. Dispense special concrete finish material from factobry numbered and sealed containers. Maintain record of container numbers.

PROJECT CONDITIONS

- A. Environmental limitations: Comply with manufactur_{irer}'s written instructions for substrate temperature and moisture content, ambient temperature and humidity, ventilation, and other conditions affecting topping performance.
 - 1. Concrete must have an average Floor Flatnesss rating of at least 40 +/- 5.
 - 2. Concrete must have an average Floor Levelneess rating of at least 40 +/- 5.
 - 3. Concrete must be cured a minimum of 28 days or as directed by the manufacturer before application of Retro Plate can begin.
- 4. Application of Retro-Plate shall take place prio_{or} to installation of equipment, thus providing a complete, uninhibited concrete slab for application.
- B. Close areas to traffic during floor application.
- C. The completed Retroplate slab will be covered to prevent damage by the other trades during store completion.
- D. Landlord will be responsible for providing a dur_{impster} for disposal of products.

PART 2 - PRODUCTS

MATERIALS AND MANUFACTURERS

- A. HARDENING/SEALING AGENT (No substitution)
 - 1. Retroplate 99 manufactured by Advanced Floor Products, Inc., P.O. Box 50533, Provo, Utah 84605 LEO HENDERSON 801.602.0095 CELL: 888.942.3144: DOLLAR GENERAL@RETROPLATESYSTEM.I.COM
 - A. Performance Criteria:
 - I. Abrasion Resistance: ASTM C779 Up to 4000% increase in abrasion resistance.
 - II. Impact Strength: ASTM C805 Up to 21% increase impact strength.
 - III. Ultra Violet Light and Water Spray: ASTM G23-81 No adverse effect to ultra violet & water spray.
 - IV. Reflectivity: Up to 30% increase in reflectivity.
 - 2. Polyurea joint filler to be used in all control joints. Standard gray color. All joints are to be filled at the discretion of the certified installer.
- 3. Retroguard Heavy Duty Stain Inhibitor and Sealiler: (No substitution)
- 4. Ameripolish "Edge Tint" (Midnight Black)
- B. DIAMOND GRINDING AND POLISHING DISCS
- Only grinding and polishing discs distributed by Advanaced Floor Products are to be used. (No Substitutions).

RELATED MATERIALS

- A. Water:
- 1. Potable and on site.
- A. Temporary power for grinding and polishing equipment will be provided by installer.

PART 3- EXECUTION

SURFACE CONDITIONS:

- A. GC or rep. to examine substrate, with installer pressent, for conditions affecting performance of finish. Correct conditions detriment to timely and proper work. Do not proceed until unsatisfactory conditions are corrected.
- B. GC or rep. to verify that base slab meet finish and surface profile requirements in Division 3 Section
- Cast-In-Place Concrete, and Project Conditions above.
- C. Prior to application, verify that floor surfaces are free of construction latent's.

 ONCE APPLICATOR ACCEPTS THE FLOOR THEEY AND THEY ALONE ARE SOLELY RESPONSIBLE FOR THE SPECIFICATIONS TO BE MET.

WORKMANSHIP AND CLEANING:

- A. The premises shall be kept clean and free of debriss at all times.
- B. Remove spatter from adjoining surfaces, as necess_{sary}.
 C. Repair damages to surface caused by cleaning op_{erations}.
- D. Remove debris from jobsite in accordance with local regulations.

- **SPECIFIC QUALIFICATIONS / EXCLUSIONS:** (NOTE: This section, though not mandatory, will greatly improve the understanding and necessary procedures for performing this work properly.)
- A. No other trades will be allowed in the area being worked on due to possible safety and floor contamination issues.
- B. The areas to receive the Retroplate 99 System will be delivered to the applicator in clean and swept condition. All equipment and supplies will be removed prior to turning the space over to the applicator. If the applicator is required to clean the space, and/or move other's supplies, staging and equipment, it will be done at time and materials.
- C. PROTECTION OF THE FLOOR FOLLOWING THE APPLICATION OF THE RETROPLATE 99 SYSTEM AND POLISHING IS THE RESPONSIBILITY OF THE OWNER.





DATE


11/13/08

SHEET NUMBER

S2.A

CONCRETE SUMMARY OPTION "A"

Manner M

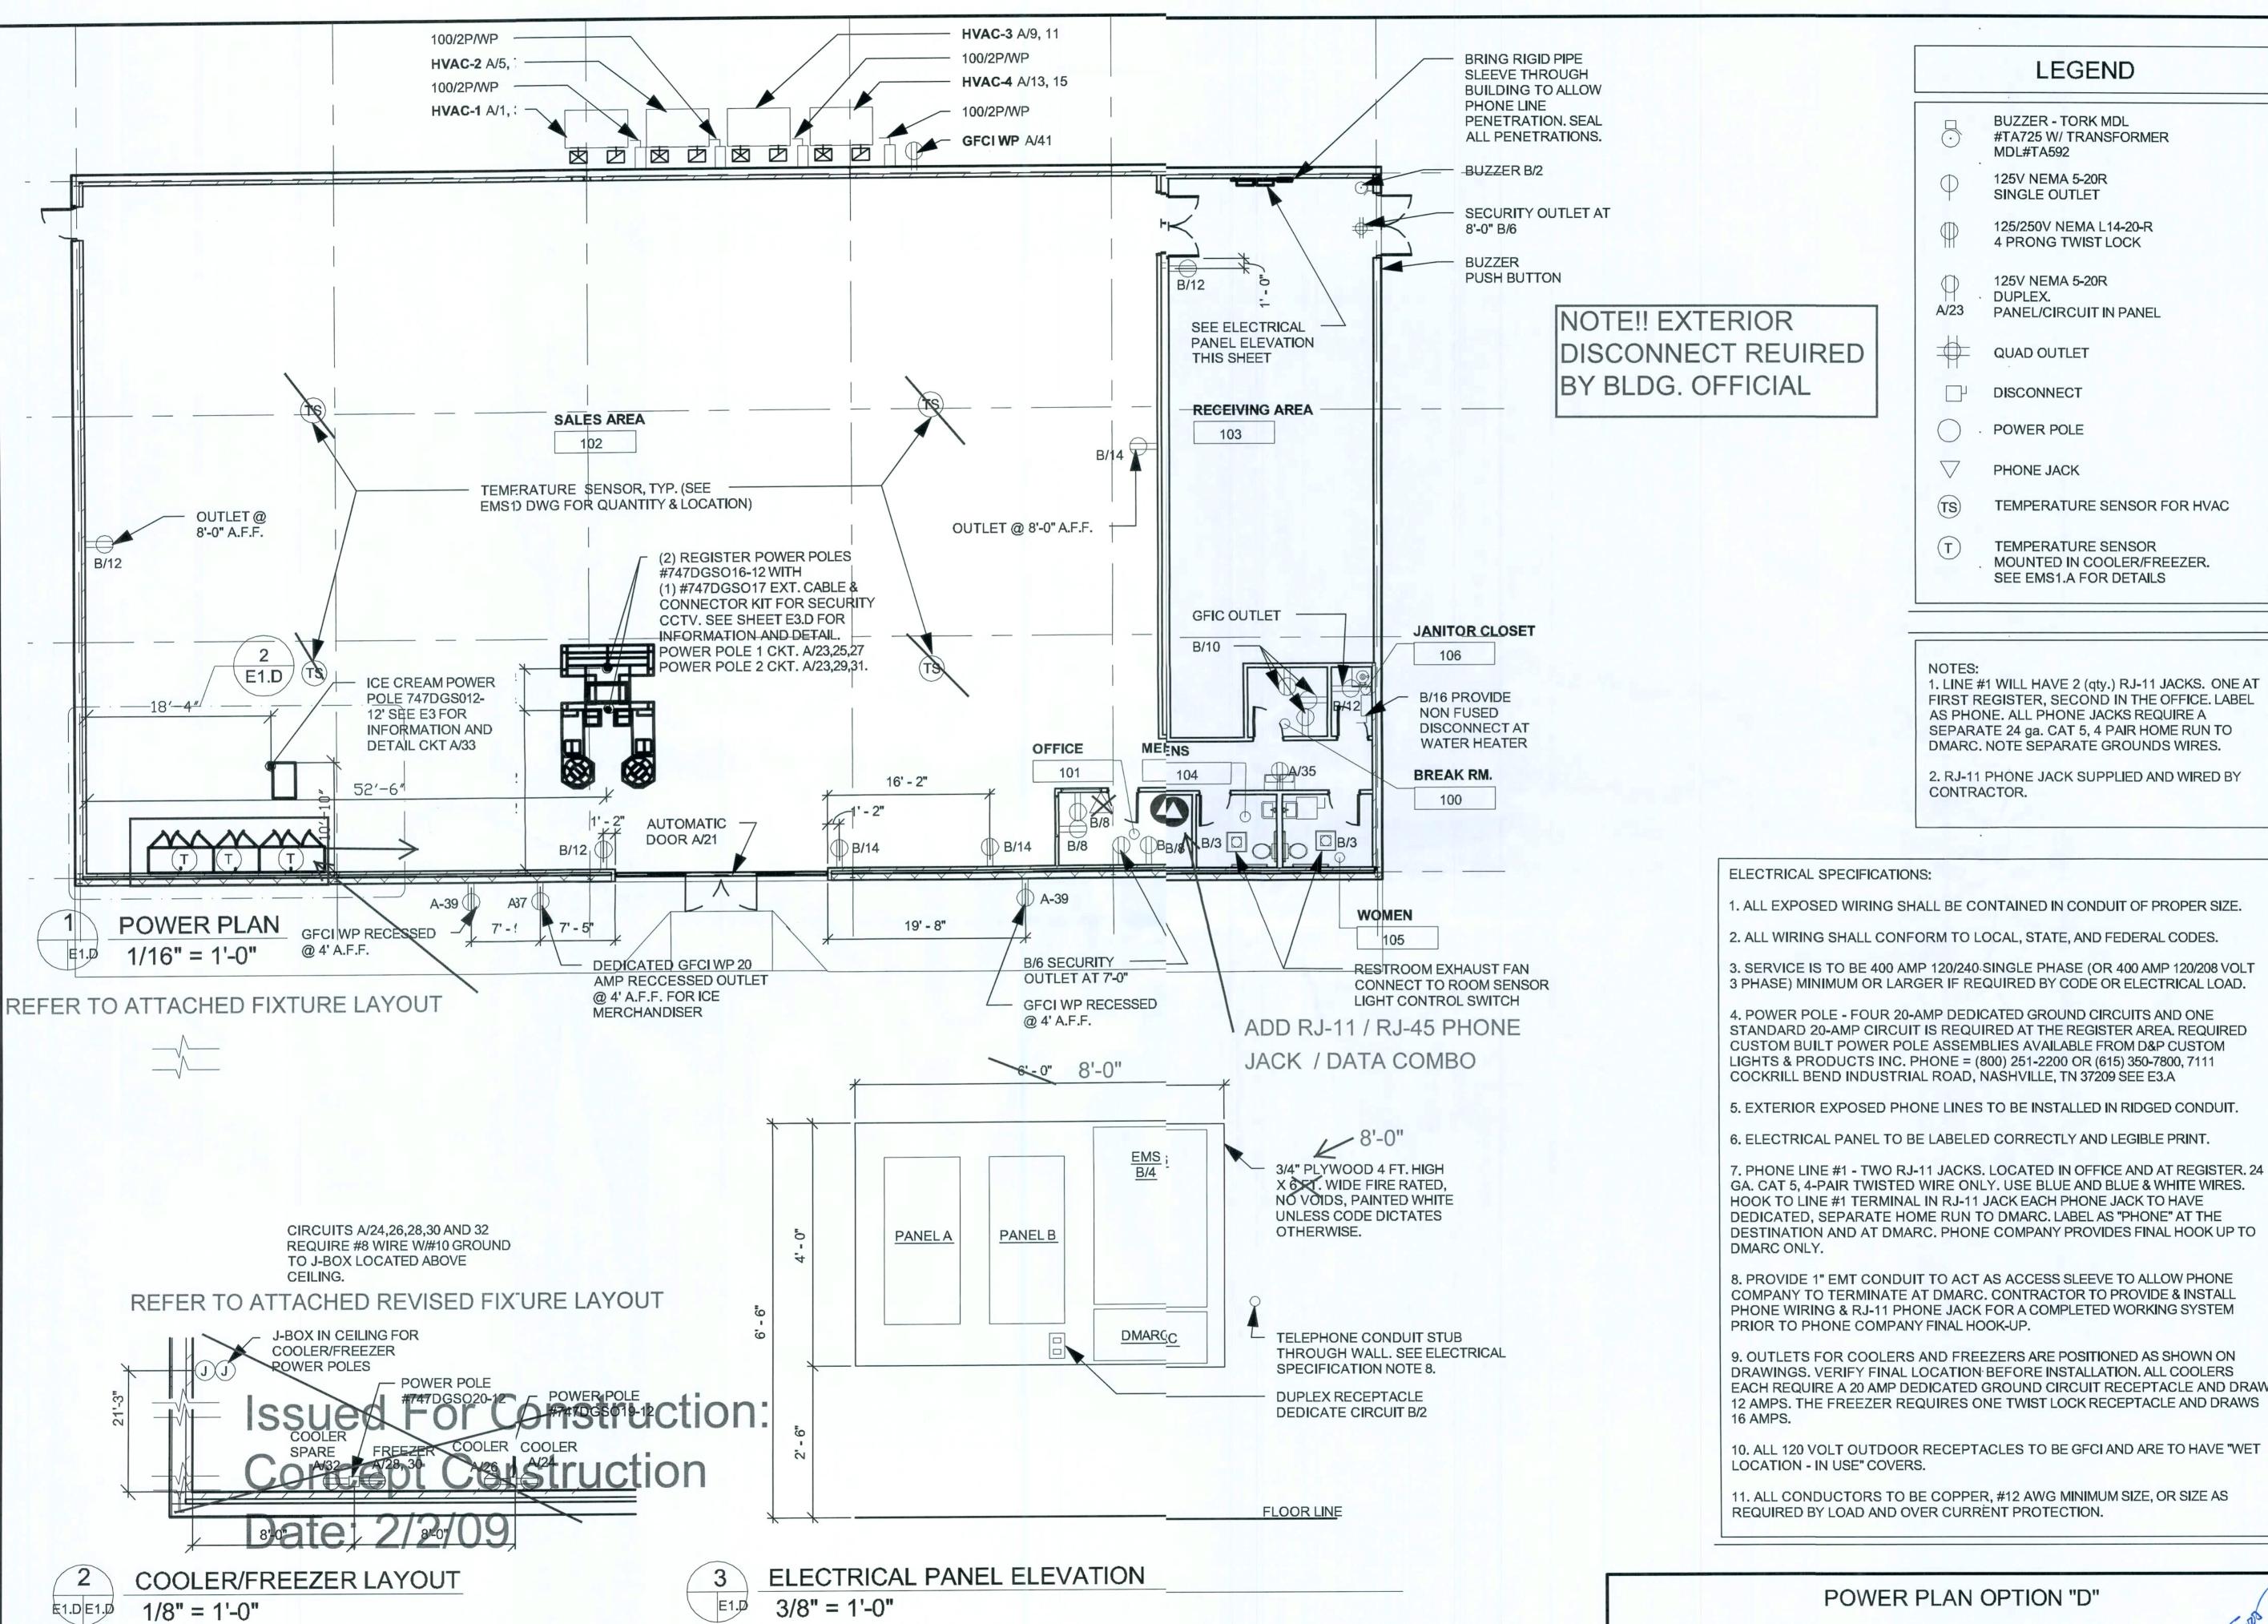

TEMPERATURE SENSOR FOR HVAC

1. LINE #1 WILL HAVE 2 (qty.) RJ-11 JACKS. ONE AT FIRST REGISTER, SECOND IN THE OFFICE. LABEL SEPARATE 24 ga. CAT 5, 4 PAIR HOME RUN TO DMARC. NOTE SEPARATE GROUNDS WIRES.

2. RJ-11 PHONE JACK SUPPLIED AND WIRED BY

1. ALL EXPOSED WIRING SHALL BE CONTAINED IN CONDUIT OF PROPER SIZE.

3. SERVICE IS TO BE 400 AMP 120/240 SINGLE PHASE (OR 400 AMP 120/208 VOLT 3 PHASE) MINIMUM OR LARGER IF REQUIRED BY CODE OR ELECTRICAL LOAD.

STANDARD 20-AMP CIRCUIT IS REQUIRED AT THE REGISTER AREA. REQUIRED CUSTOM BUILT POWER POLE ASSEMBLIES AVAILABLE FROM D&P CUSTOM LIGHTS & PRODUCTS INC. PHONE = (800) 251-2200 OR (615) 350-7800, 7111

GA. CAT 5, 4-PAIR TWISTED WIRE ONLY. USE BLUE AND BLUE & WHITE WIRES. DEDICATED, SEPARATE HOME RUN TO DMARC. LABEL AS "PHONE" AT THE DESTINATION AND AT DMARC. PHONE COMPANY PROVIDES FINAL HOOK UP TO

8. PROVIDE 1" EMT CONDUIT TO ACT AS ACCESS SLEEVE TO ALLOW PHONE COMPANY TO TERMINATE AT DMARC. CONTRACTOR TO PROVIDE & INSTALL PHONE WIRING & RJ-11 PHONE JACK FOR A COMPLETED WORKING SYSTEM

9. OUTLETS FOR COOLERS AND FREEZERS ARE POSITIONED AS SHOWN ON DRAWINGS. VERIFY FINAL LOCATION BEFORE INSTALLATION. ALL COOLERS EACH REQUIRE A 20 AMP DEDICATED GROUND CIRCUIT RECEPTACLE AND DRAW 12 AMPS. THE FREEZER REQUIRES ONE TWIST LOCK RECEPTACLE AND DRAWS

10. ALL 120 VOLT OUTDOOR RECEPTACLES TO BE GFCI AND ARE TO HAVE "WET

10877 WATSON ROAD

ST. LOUIS, MO 63127

END S ERIA AutoCAD-2008

DATE

05/19/08

SHEET NUMBER

ADVANCED FLOOR PRODUCTS CORPORATI ACCOUNT DOLLAR GENERAL STORES WORK OIDER

National Account Number 2008-07

levised 10/10/08

New Store Construction – Approximately 7352 Sq Feet of RetrPlate Per Store

The Sales area and hall will be finished to a **High gloss level 3 hine**.

Definition of expected shine

High Gloss: Reflective shine in which, at a distance of 30', thereflectivity is clearly defined.

- A. The sales area and hall are the only areas to Receive Poshing
- B. The receiving area, offices and restrooms will be finished by the landlords GC with Silicone Acrylic Concrete sealer

Approximately 540 linear ft of polyurea joint fill (Standard Gra) will be required.

C. Additional linear footage of joint fill will be completed s an extra at \$2.00 per LF

Projects will be completed using only Advanced Floor Products products

Product Requirements

- A. RetroPlate 99 (no substitute densifier) 55 Gals pr store.
- B. RetroGuard 2-5 Gallon pails
- C. Ameripolish Edge Tint (Part A&B) (Midnight Back)
- D. Standard Poly Urea Gray joint fill (Applicators goice)
- E. Diamonds purchased in sets to equip the particulr machine. Grits needed:
- F. 40, 50 or 80 metal diamonds
- G. 100/120, 200/220, 400. 800 resin diamonds
- H. 800, 1500 and 3000 grit Twister pad is to be use to burnish.

All work will be completed per this work order.

Qualifications:

- 1. All applicators of the RetroPlate System mut have the work experience and be certified by Advanced Flor Products of Springville, Utah.
- 2. Applicator must possess a letter of Certification from Advanced Floor Products 1203 W, Spring Creek Place, Springville, UT 84663.
 - a. The Applicator must have satisfactorly installed RetroPlate in a minimum of 5 projects of at least 6000 sq feet.
 - b. The Certified person in the companymust be present on the job during all phases of the installatin.
 - c. Applicator will provide the recommoded grinding machines and Advanced Floor Products Diamods

SCOPE OF WORK

The following RetroPlate process will be used as a guide for RetroPlate process and is the Manufacturers application recommendation. Keep in mind that the applicator will finish the floor to a nice level 3 high gloss shine. Applicators will alter the steps as necessary to achieve the required level 3 high gloss shine. ((see definition of shine pg 1)

- 1. Start the Grind using 40, 50 or 880 grit Metal pad depending on the need. (Multiple passes will be reequired for each step) Make sure that the previous "Scratch Pattern" is taken out before proceeding.
- 2. Clean the floor.
- 3. Grind floor using 100/120 grit poad.
- 4. Clean the floor
- 5. Grind the floor with a 200/220 ggrit pad.
- 6. Clean floor
- 7. Apply RetroPlate 99 to the surface at 200 sq ft per gallon, scrubbing product in into floor and allowing product to soak until turning slick. If it becomes sticky, dampen thee sticky areas with water and scrub in, leaving the product on the floor for 60 minutes.
- 8. Clean up excessive RetroPlate 999. Let the floor dry, overnight if possible.
- 9. Continue the polishing process rusing 400 and 800 Grit pads. (800/1500/3000 Grit Twister pand, multiple passes, to finish.)
- 10. Ameripolish Edge Tint (Midniglight Black) will be applied around the perimeter of the sales floor and I hall extending out 4 inches.
- 11. Edge tint will be applied using aa Paasche sprayer at 40psi.
- 12. Edge tint will be applied with a cut off line under the door edge at the receiving, office and restroom entrances.
- 13. Chase, clean and fill approximattely 540 linear feet of joints with Standard Gray polyurea joint fill.
- 14. Apply RetroGuard sealer to the entire sales floor and hall surface at a rate of 1200-1500 ft per gallon.

FLOORS WILL BE FINISHED TO A MINIMUM LEVEL 3 HIGH GLOSS SHINE

- A. High Gloss: Reflective shine in which, at a l distance of 30', the reflectivity is clearly defined.
- B. Sample photos attached of required results

CONCRETE FLOOR CONDITIONS:

- 1. Sealing, Hardening and Polishing of Concrete Surface.
- A. Concrete must be in place a minimum of 28 days or as directed by the manufacturer before application can begin.
- B. Concrete Floor will be finished to a minimum FF and FL of 40 +/- 5.
- C. Only a certified applicator shall apply RetroPlate 99. Applicable procedures must be followed as recommended by the product manufacturer and as required to match approved test sample.
- D. Polish to the required level 3 high gloss shine.

WORKMANSHIP AND CLEANING

- A. The premises shall be kept clean and free of debris at all times.
- B. Remove spatter from adjoining surfaces.
- C. Remove debris from jobsite. Dispose of materials in separate, closed containers in accordance with local regulations.
- D. Upon completion of the installation of the Retroplate system, the Applicator will meet with the Supervisor of Construction and /or the Dollar General Construction Manager. They will walk through and will sign off that the work is satisfactory.
- E. Upon completion email completion photos with store location, address and date completed to:
- F. <u>Leo@Retroplatesystem.com</u>
- G. Mike@Retroplatesystem.com
- H. cprojmgr@dollargeneral.com


(See the last page of this document for required photos)

Questions regarding this work order procedure contact Leo Henderson or Mike Pinckney, Corporate Accounts, at (888) 942-3144

REQUIRED PHOTOS:

The following layout shows the required photos to be taken at completion. (Make sure the overhead lights are on for your photos.

- 1. From each corner of the receiving area, facing the opposite corner.
- 2. Hall (inside entrance stores, one picture from each end of the hall).
- 3. Standing 10' from the entrance facing the entrance.

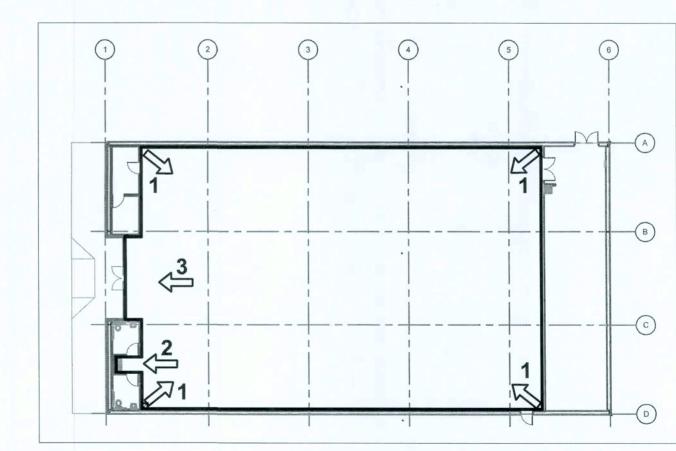

DOLLAR GENERAL - RETROPLATE WORK ORDER OPTION,"A"



ST. LOUIS, MO 63127

AutoCAD-Store Design Department (615) 855-4753

ATE


DATE

11/13/08

SHEET NUMBER

S3.A

Manusca Markos

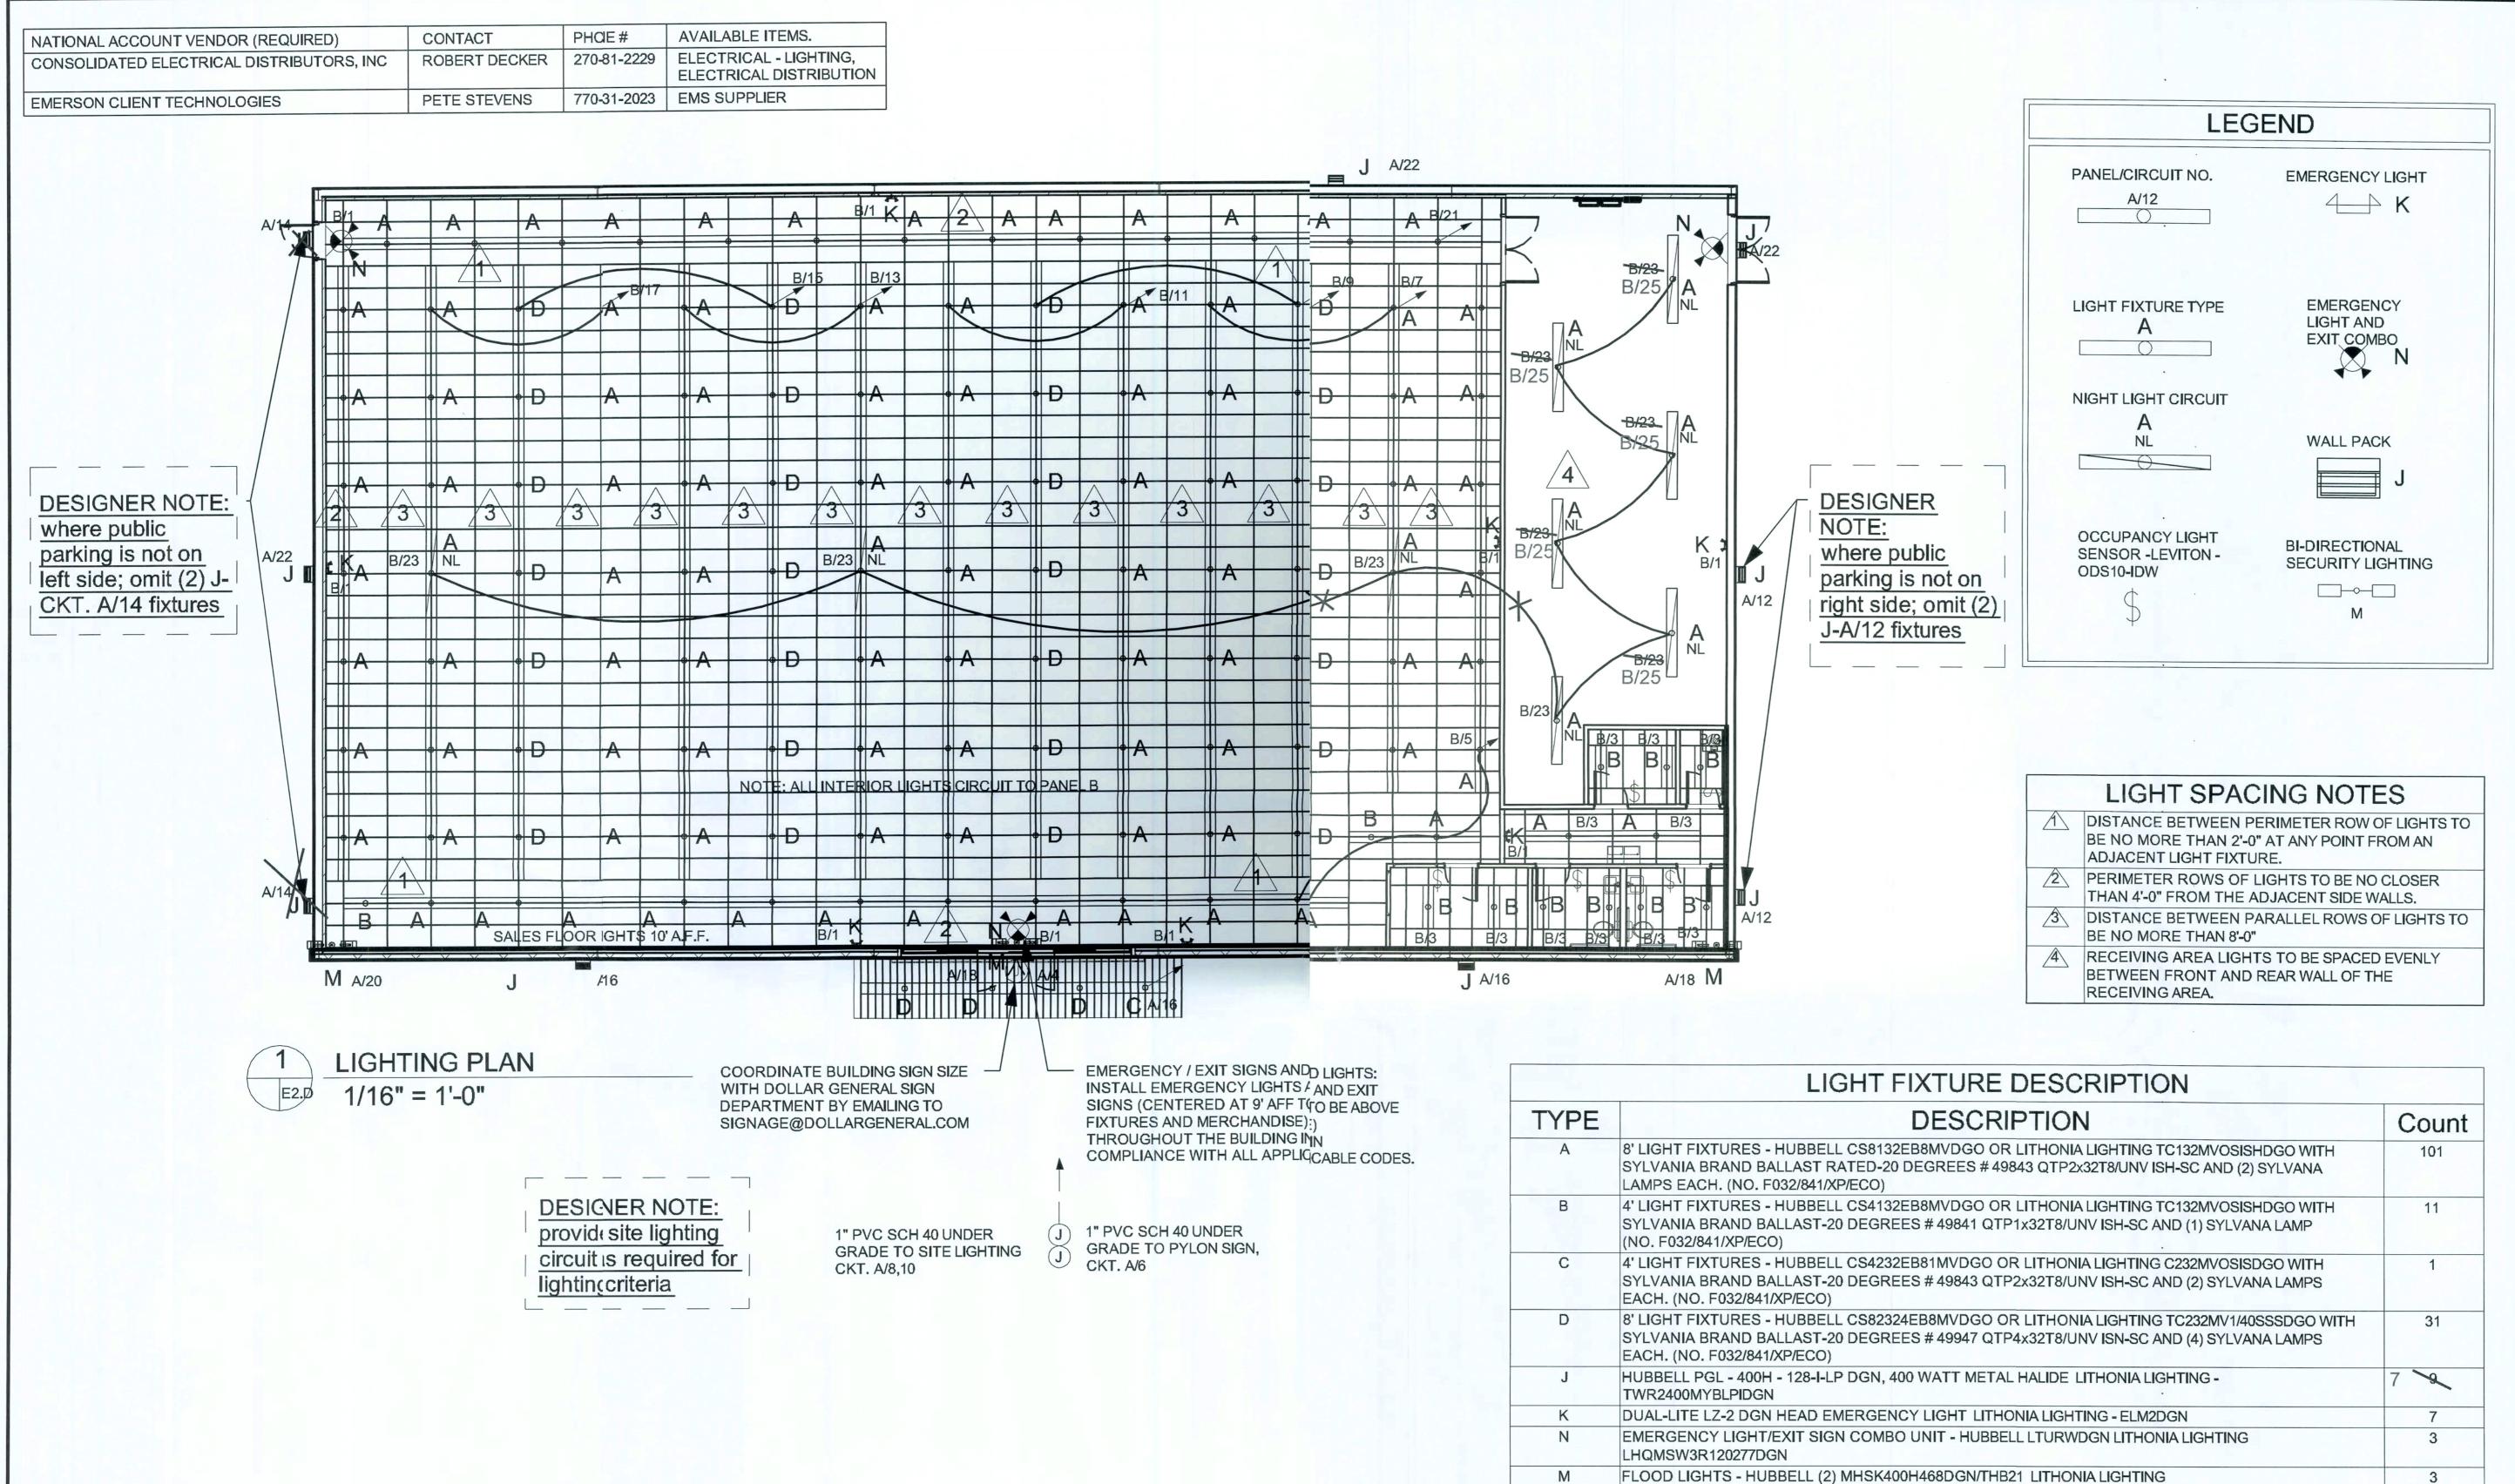

Issued For Construction:

Concept Construction

Date: 2/2/09

LIGHTING PLAN OPTION "D"

HOOKER HANGER TO BE USED TO MOUNT LIGHT FIXTURES TO CEILING GRID. HUBBELL - CSZT LITHONIA LIGHTING - HRC1J48

NOTE 1: IN LIEU OF TYPE "N" EMERGENCY/EXIT COMBINATION LIGHT A STANDARD EXIT LIGHT MAY BE SUBSTITUTED. USE DUAL

(2)TFR400MTATBISLPIDGN/BS28DDBU

LITE LTURNW DGN, LESS HEADS, EXIT LIGHT - LITHONIA LIGHTING - LHOMSW3R120/277DGN.

GASGO

10877 WATSON ROAD
ST. LOUIS, MO 63127


2008 PROTOTYPE CRITERIA SET PLAN "D" - ADDENDA RELEASE 5/19/08


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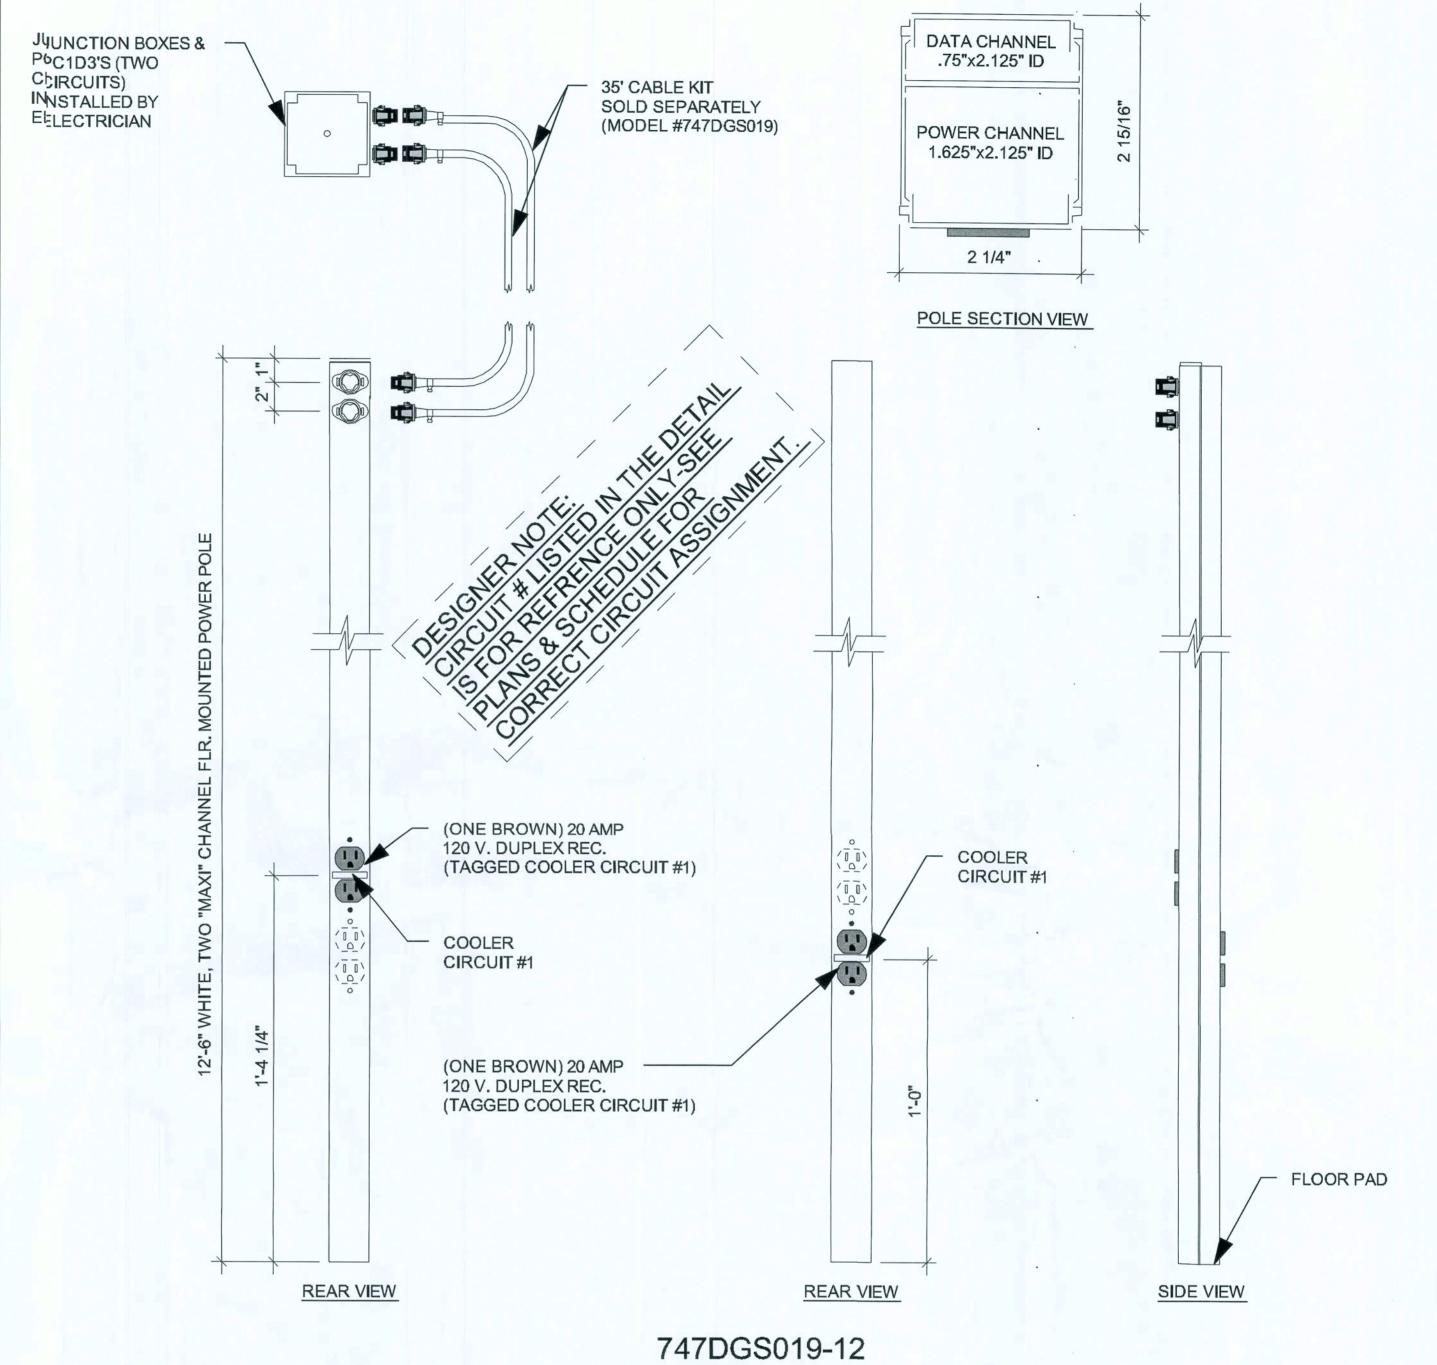
05/19/08

SHEET NUMBER

E2.D



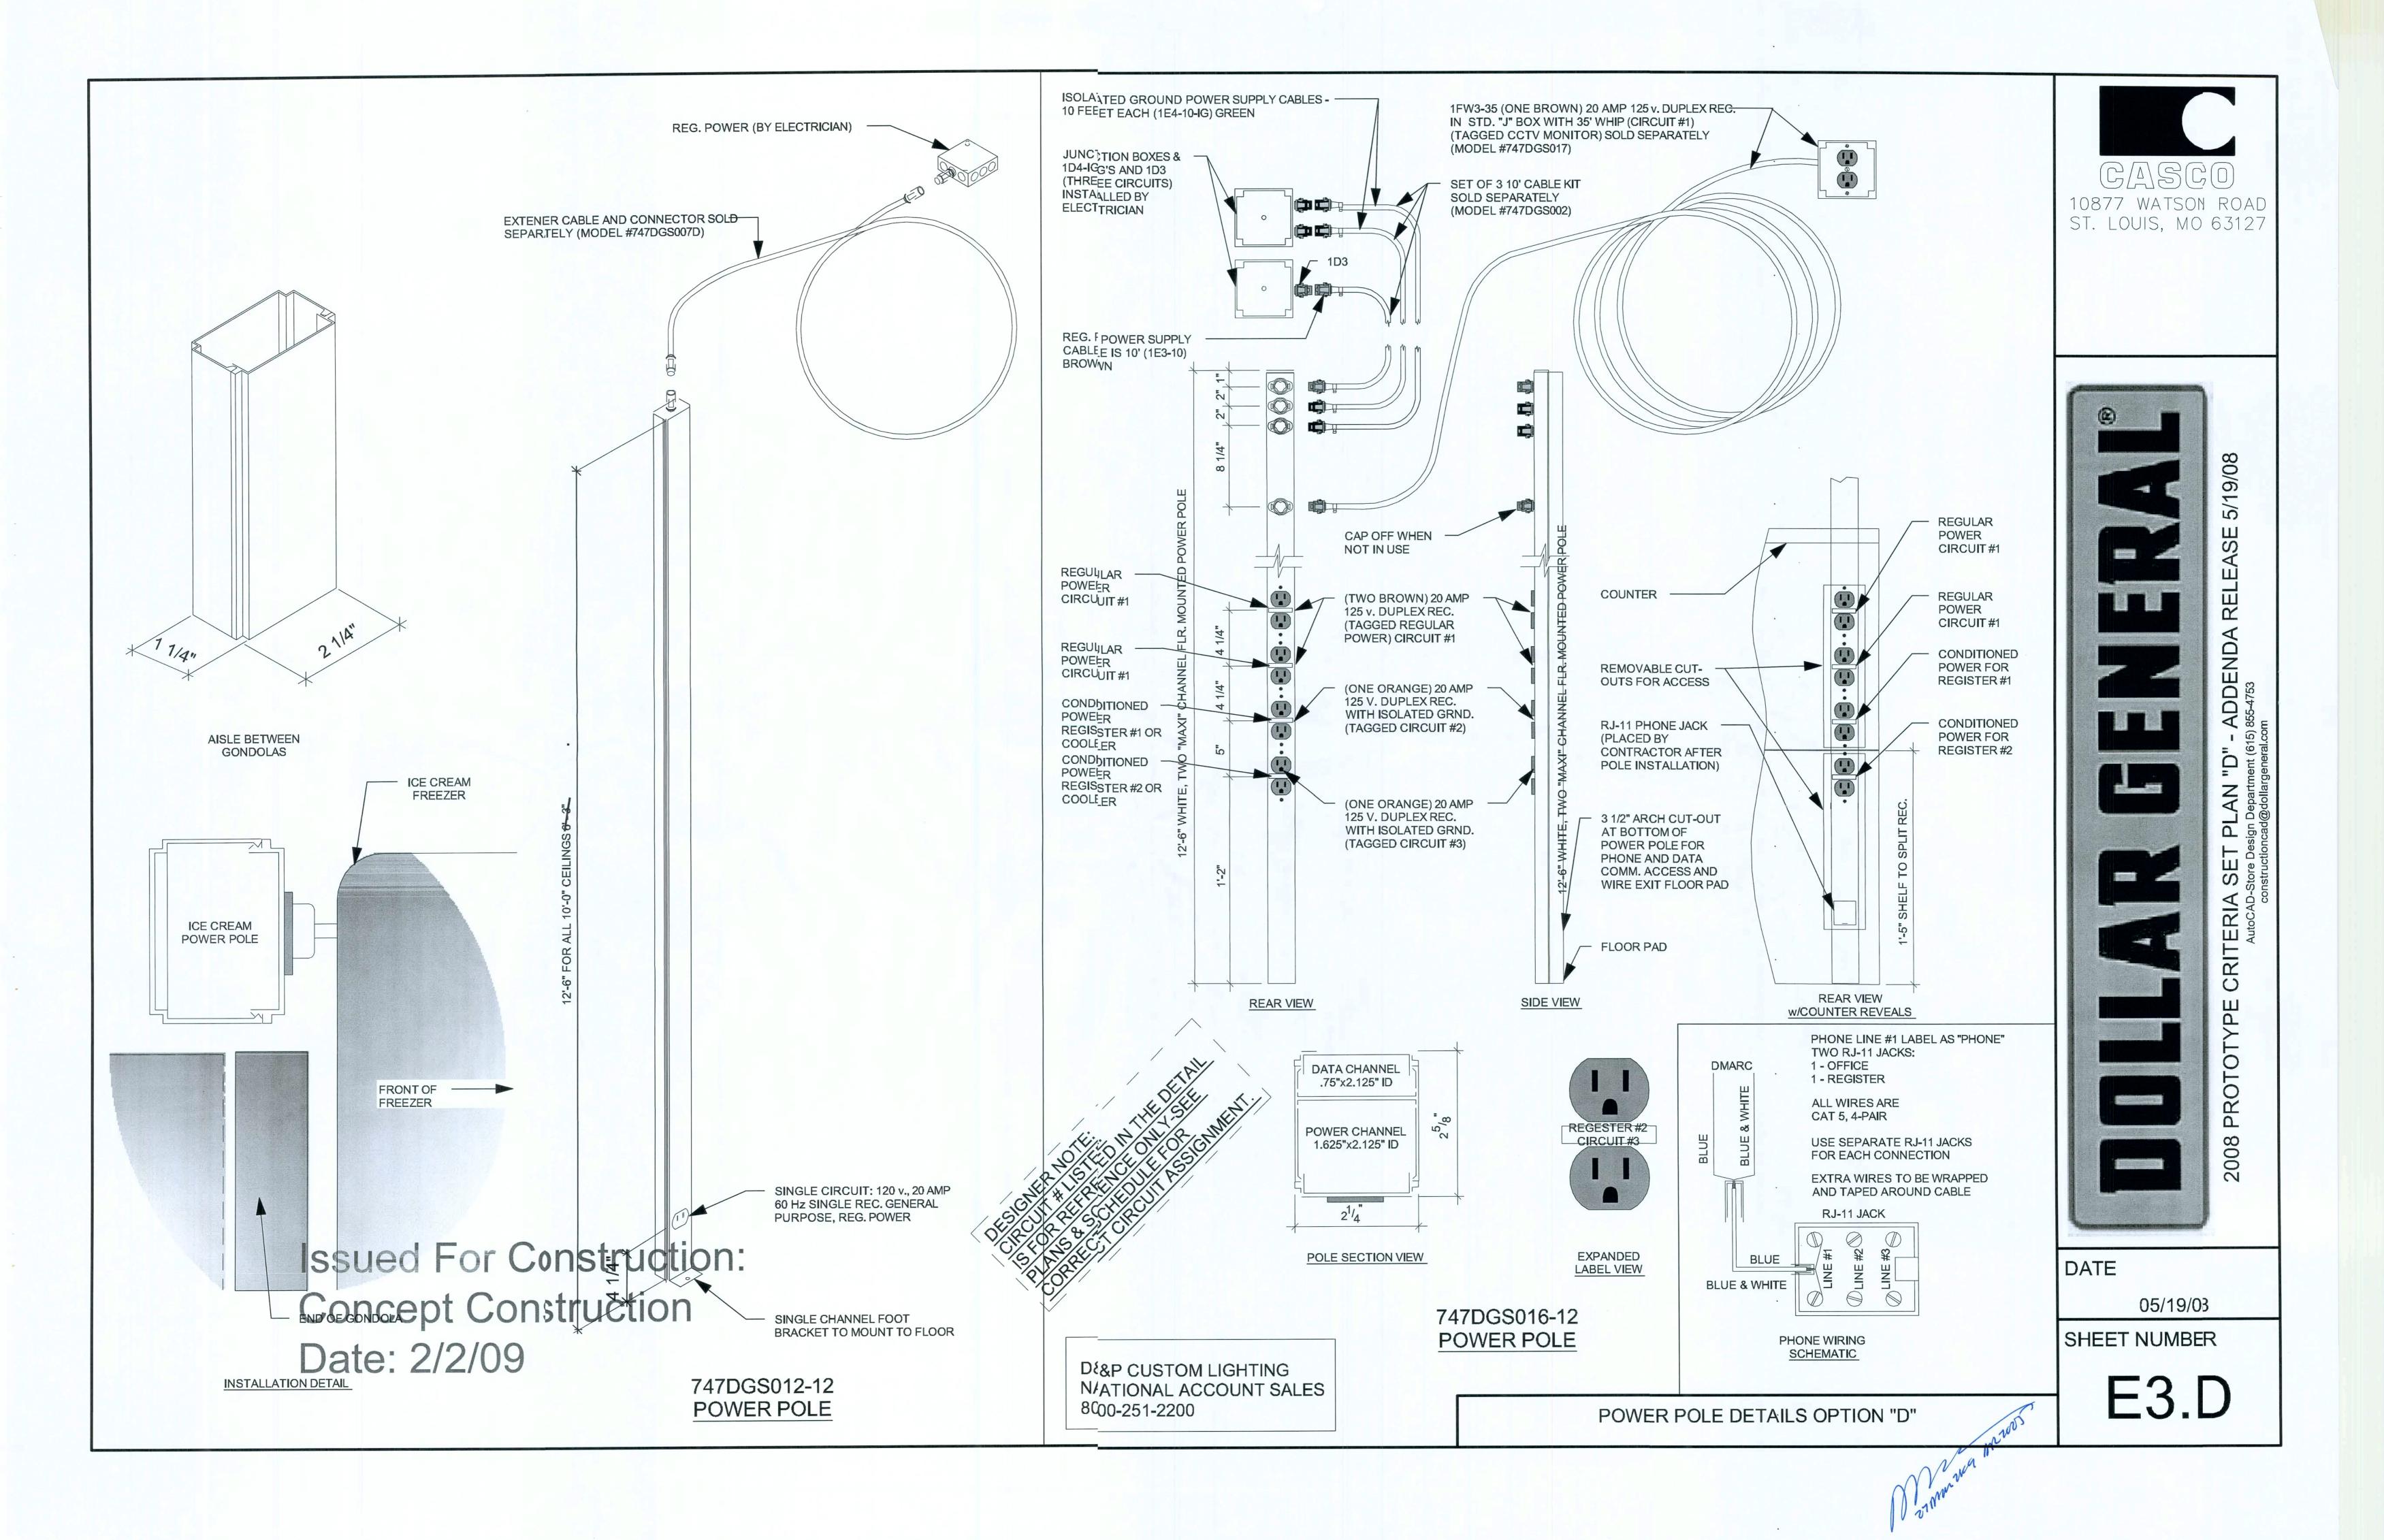

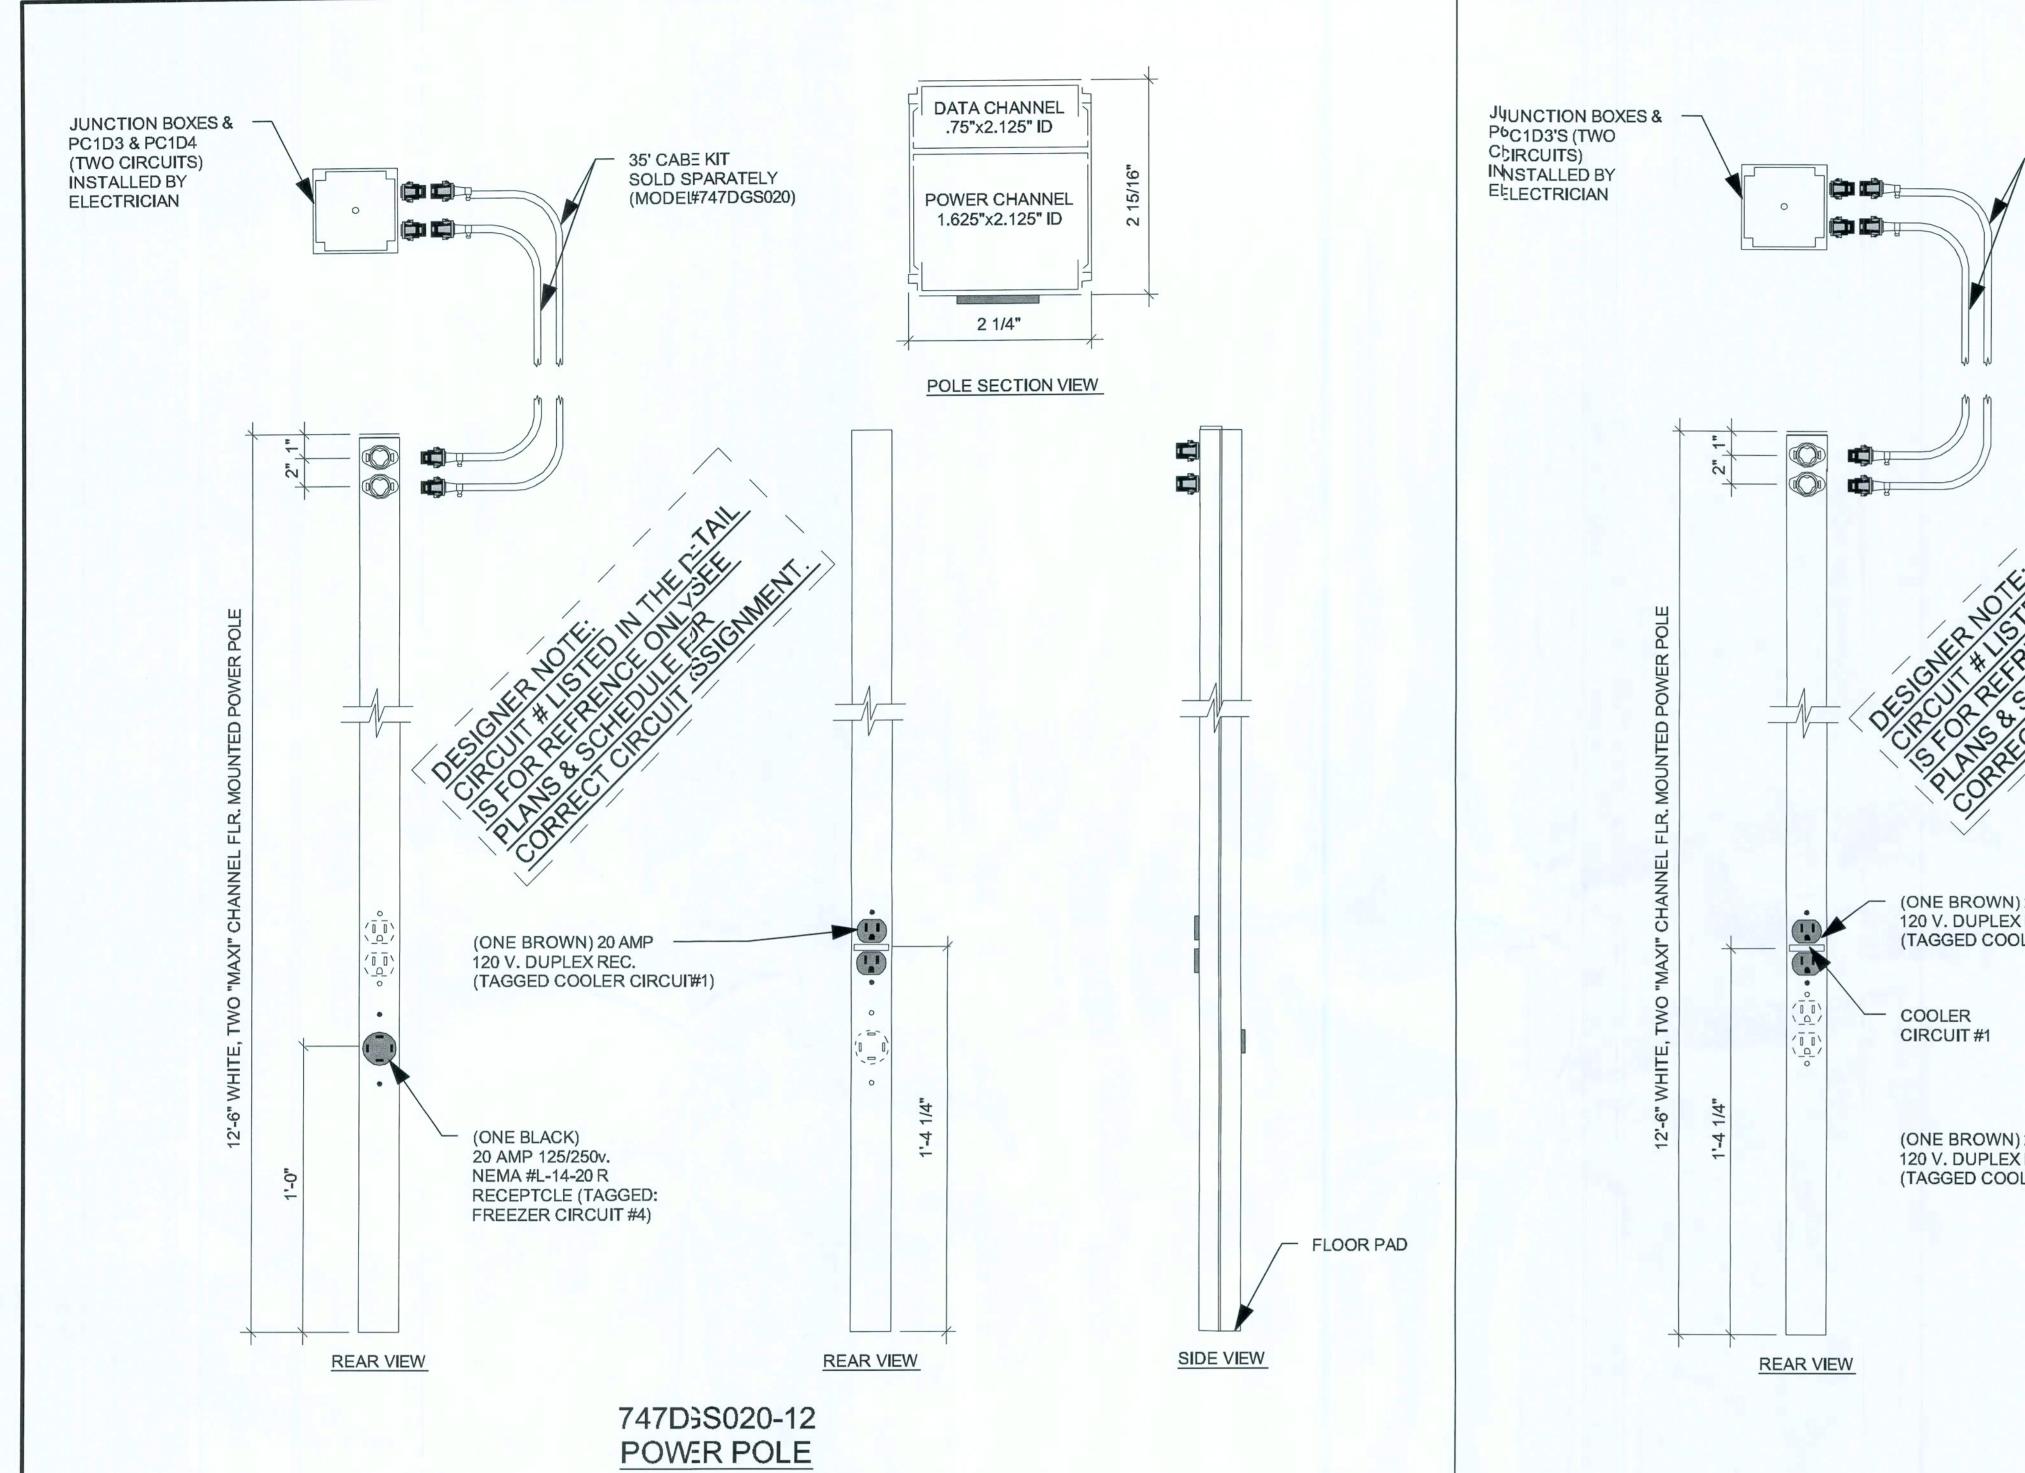

	REGISTER	AND ICECREAM POWER POLES AND COMPONENTS	
Qty.	D&P Part Number	Power Pole Descripon	Price
2	747DGS016-12	12' 2CH REGULAPOLE W/2-C & 1-D CONNECTOR DRW #2004-12	\$168.00 e _{ea}
2	747DGS002	10ft Cable Kit (set c3 whips)	\$95.00 eaa
1	747DGS012-12	12' Single Channel:e Cream Pole DRW #854-12	\$115.00
1	747DGS014CSSUEC	1E3-10 Extender Cole & Connector for Ice Cream Pole	\$31.00
	133464	COOLERFREEZER POWER POLES	
Qty.	D&P Part Number	Power Pole Descriport CCCOO Cable kit for 120 vocooler	Price
1	747DGS019	Cable kit for 120 vocooler	\$184.00
1	747DGS019-12	120 Volt 2 CIR. Coer pole	\$178.00
1	747DGS020 2 7	120/250 Cable kit fccooler	\$165.00
1	747DGS020-12	120/250 volt 2 circu Cooler pole with NEMA L1420 connection	\$202.00
1	747DGS017	35' Whip Assembly //J-Box	\$68.00

D&P CUSTOM LIGHTING NATIONAL ACCOUNT SALES 800-251-2200

POWER POLE

ELECTRICAL PANELS OPTION "D"





DATE

05/19/08

SHEET NUMBER

E4.D

SURF	FACE	PANEL A	12	0/240 V, 3 Ø	AVAILABLE)	MCB 400A	i			
	ACE	PANEL A	12	0/208 V, 1 Ø	4W	, 40 A (A	ALTERNA	ATE)	MCB 400A	
	FACE	PANEL A	120/208 V, 3 Ø 4W, 40 A (UPGRADE ALTERNATE)						MCB 600A	
CKT #	1Ø	3Ø			DS KW 3 Ø	/ (Ø		DESCRIPTIO	N	CKT #
1	1 Ø HVAC		\cap					AUTOMATIC	DOOR	2
3	UNIT #1	8 Ø HVAC UNIT #1	\cap				\cap	SPAR	E	4
5	1 Ø HVAC		\cap				\cap	SPAR	E	6
7	UNIT #2		$\overline{}$				\cap	SPAR	E	8
9	1 Ø HVAC	3 Ø HVAC UNIT #2	N				\cap	SPAR	E	10
11	UNIT #3		\cap				\cap	SPAR	E	12
13	1 Ø HVAC	3 Ø HVAC UNIT #3	\cap				\cap	SPAR	E	14
15	UNIT #4		\cap				\cap	COOLE	ER	16
17	1 Ø HVAC		\cap				\cap	SPAR	E	18
19	UNIT #5 IF REQUIRED		\cap				2	COOLE	ER	20
21	SPARE	3 Ø HVAC UNIT #4	\cap				\cap	SPAR	E	22
23	SPARE	OHIT # 1	\cap					FREEZ	ER	24
25	WATER	HEATER AT	\cap							26
27	RES ⁻	TROOMS						SPAR	E	28
29		HEATER AT	\cap				\cap	SPAR	E	30
31		NG (SPARE ON S C AND D)	\cap				\cap	SPAR	E	32
33	ICE CREAM	1 POWER POLE	\cap					SPAR	E	34
35	DRINKIN	G FOUNTAIN	\cap					SPAR	E	36
37	OUTDOOR ICE	E MERCHANDISER	\cap					0.711		38
39	OUTDOOR D	PRINK VENDING	\cap					PANEL	. В	40
41	OUTDOOL	R HVAC REC.	0					17,142		42

PANEL A NOTES: 1) THE EXISTING BREAKER CONFIGURATION IS PROVIDED TO DEMONSTRTE THE PREFERRED LOCATION AND TYPICAL 2) PANEL A TO BE SERVICE ENTRANCE RATED WITH AIC RATING OF 22K MIMUM.

4) BREAKERS SERVICING HVAC EQUIP AND MOTOR LOADS (COOLERS, FREZERS, ETC) TO BE HACR.

6) CIRCLED CIRCUIT DENOTES BREAKER LOCKS 7) SHADED CIRCUIT DENOTES ROUTING TO THE EMS PANEL

OVERHEAD OR UNDERGROUND SERVICE ENRANCE PER UTILITY AND SITE-SPECIFIC CONDITION WIRING TO BE SIZED PER LOCAL CODE REGIREMENT PROVIDE INDOOR MAIN SERVICE DISCONNET ONLY IF A DISCONNECT IS REQ'D BY UTILITY OR LOCAL CODE. SEEK DOLLAR; ENERAL STORE DESIGN APPROVAL. 400 A, MCB, 10/208 V., 3 PH., 4 W. - 42 CIRCUIT #2, #6G, 1 12"C 200 A., ML0, 12/240 V., 1 PH., 3 W. - 42 CIRCUIT ed For Construction: Date: 2/2 AT EXTERIOR ISCONNECT IF IT IS

ELECTRICAL PANEL SCHEMATIC

N.T.S.

MLO MCB PANEL B 120/240 V, 1 Ø, 3W, 200 A **FLUSH** LOADS KW DESCRIPTION DESCRIPTION **EMERGENCY/EXIT LIGHTS TELEPHONE BOARD** BREAKROOM / OFFICE / RESTROOM LIGHTS **ENERGY MANAGEMENT** 5 SALES LIGHTS - ROW 1/ENTRY SECURITY OUTLETS SALES LIGHTS - ROW 2 & 4 OFFICE OUTLETS SALES LIGHTS - ROW 3 & 6 **BREAK ROOM OUTLETS** SALES LIGHTS - ROW 5 & 7 LEFT SIDE SALES OUTLETS 13 | SALES LIGHTS - ROW 8 & 10 RIGHT SIDE SALES OUTLETS 15 | SALES LIGHTS - ROW 9 & 12 **SPARES** 17 SALES LIGHTS - ROW 11 & 13 **SPARES** SALES LIGHTS - LEFT 20 **SPARES** PERIMETER SALES LIGHTS - RIGHT 22 **SPARES** PERIMETER **BUILDING SIGN** POWER POLE 1 BROWN PYLON SIGN POWER POLE 1 CKT POWER POLE 1 KT 2 SITE LIGHT 29 SITE LIGHT POWER POLE 2 BROWN RIGHT EXT. WALL LIGHTS POWER POLE 2 CKT 1 LEFT EXT. WALL LIGHTS POWER POLE 2 CKT 2 FRONT EXT. WALL/ CANOPY LIGHTS POWER POLE 3 (IF REQUIRED) 36 POWER POLE 3 (IF REQUIRED) 38 FRONT RIGHT FLOOD POWER POLE 3 (IF REQUIRED) (40) FRONT LEFT FLOOD RECEIVING / NIGHT LIGHTS EXTERIOR DUSK/DAWN

1) CIRCLED CIRCUIT DENOTES BREAKKER LOCKS 2) ALL BREAKERS 20/1 UNO

NOTE: FOR THREE PHASE DESIGNS, \ WE WILL BE REQUIRING A MINIMUM OF 24 TONS OF HVAC. THIS MAY BE ACHIEVED BY USING (4) 6 TON UNITS FROM OUR NATIONAL ACCOUNT PROVIDERS CARRIER, LENNOX, OR YORK.

APPROVAL BY THE DOLLAR GENERALL STORE DESIGN DEPARTMENT.

8) BREAKERS SERVICING LIGHTS TO BE HID RATED.

PANEL B NOTES:

		REQUIRED CARRIER OR LENNOX UNITS										
MFG	STANDARD	UPGFRADE	TONAGE	Gas Input	MODEL NUMBER	Size						
CARRIER	3	44	5 Ton	High Gas	48TCFA06A1A3A0A0A0	60						
LENNOX	4	55	5 Ton	Low Gas	KGA060S4BS	70						
LENNOX	4	55	5 Ton	Electric	KCA060S4BN	80						
LENNOX		44	6 Ton	Low Gas	KGA072S4BS	VERIFY						
LENNOX		44	6 Ton	Electric	KCA072S4BN	VERIFY						

CARRIER NATIONAL ACCOUNTTS - ALISON HARTMAN - PHONE # 800-690-1081


LENNOX NATIONAL ACCOUNTSs - JOSHUA PLUMMER - PHONE# 800-367-6285 OPT. 2

ELEC. UNITS REQUIRE A SINGLLE POINT KIT AND 7.5 KW HEAT STRIP. ALL UNITS REQUIRE MANUAL (OR ECONOMIZER DAMPERS

NEW ELECTRICAL PANEL CRITÉRIA FOR THREE PHASE

400 AMP SERVICE

USE ATTACHED UPDATED SHEET E.5 DATED 11.13.08

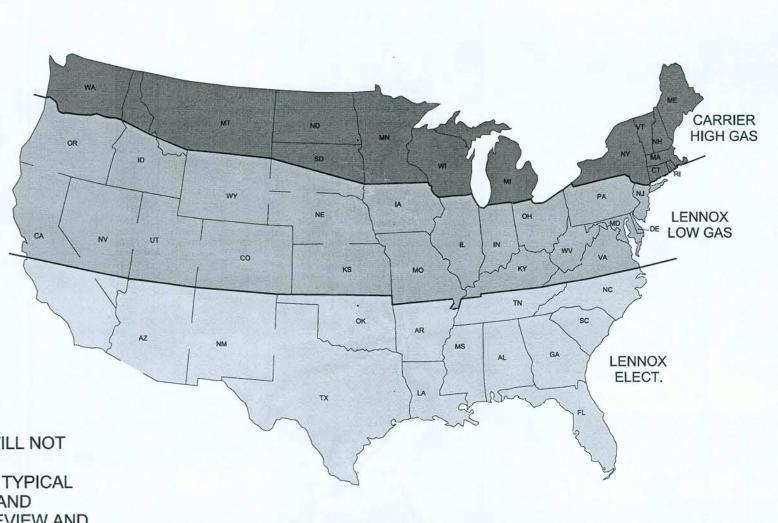

NOTE: PROPANE IS NOT ALLOWED AS A SUBSTITUTE FOR GAS OR ELECTRIC SERVICE UNLESS APPROVED BY DG AUTOCAD STORE DESIGN. IF PROPANE IS USED, TANKS ARE REQUIRED TO BE BURIED.

Note!!!!

In the event of a contradiction between page E5 and any other Construction Documents. Page E5 shall prevail.


CASCO 10877 WATSON ROAD ST. LOUIS, MO 63127

DATE

10/30/08

SHEET NUMBER

NEW ELECTRICAL PANEL CRITERIA FOR THREE PHASE

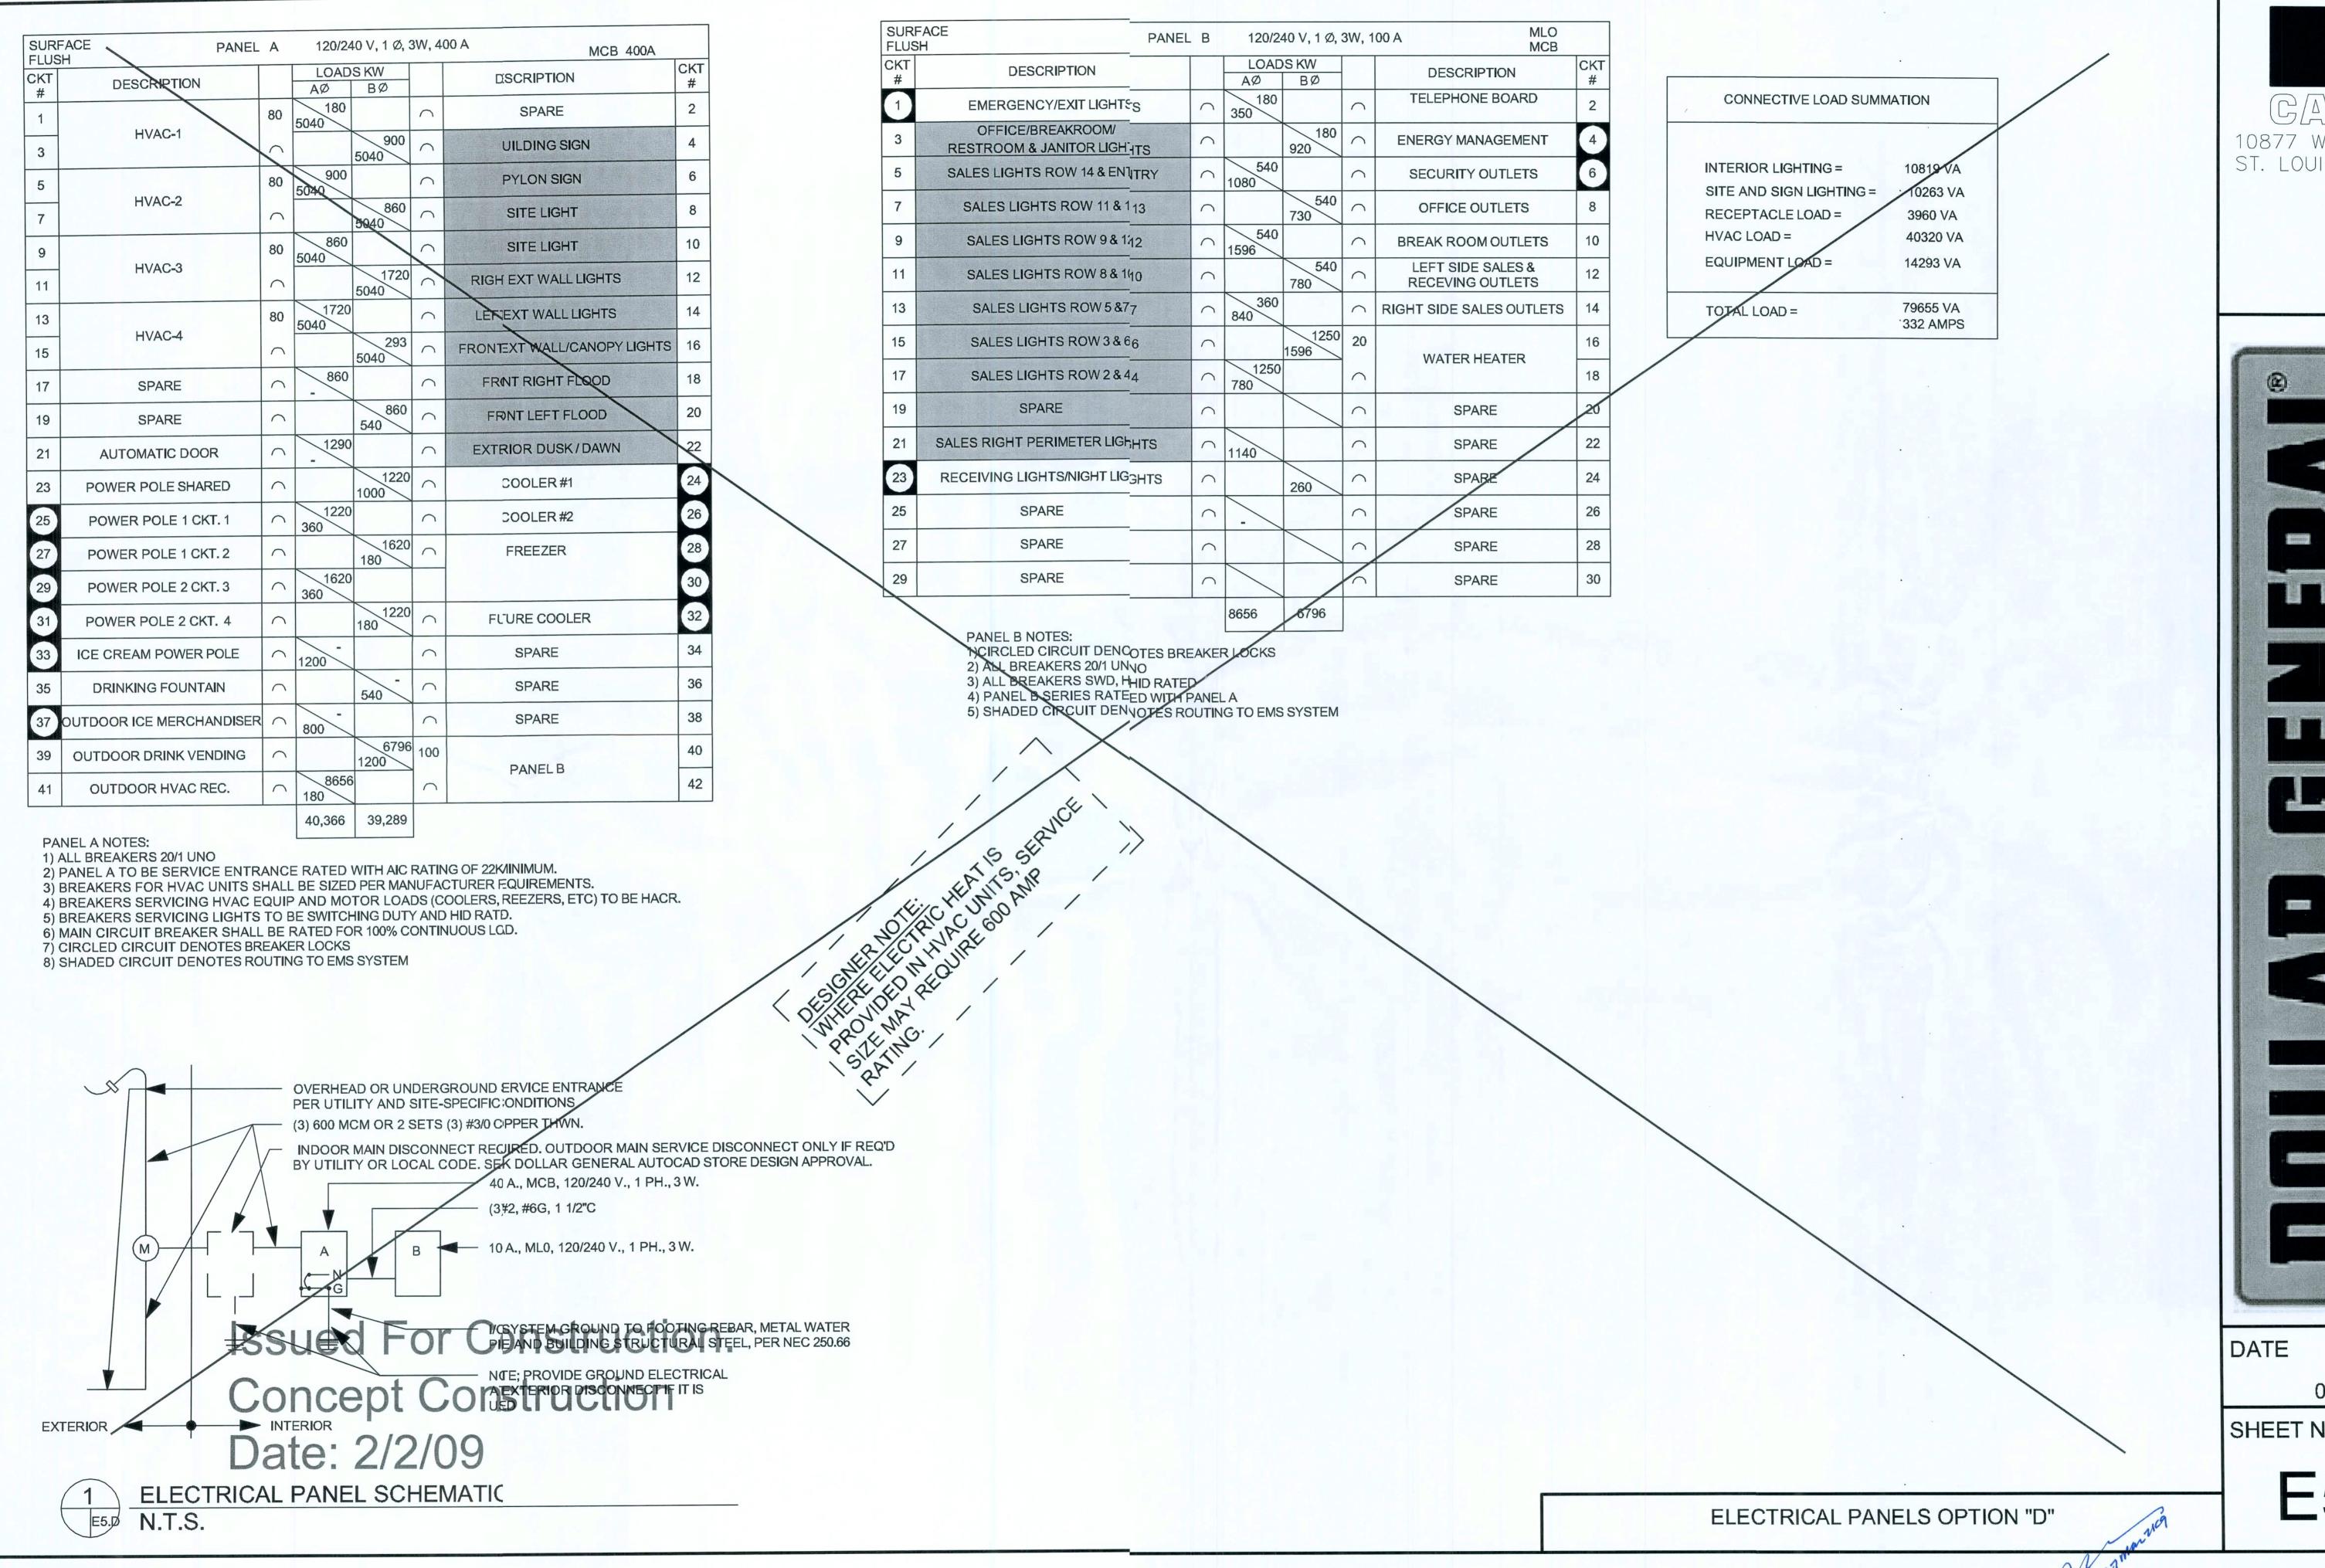



5/19/08

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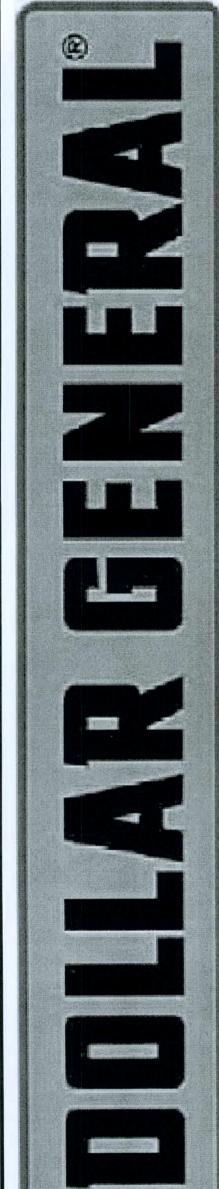
ADDEND/) 855-4753

ERIA AutoCAD-8

CRIT

PROTOT

2008



05/19/08

SHEET NUMBER

E5.D

SURF. FLUSH		FLUSH PANEL A		12	0/208 V, 3	AVAILABLE)	MCB 400A					
SURF	ACE	PANEL A		120/240 V, 1 Ø 3W,I00 A (ALTERNATE)						MCB 400A		
SURF	ACE	PANEL A		120/240 V, 1 Ø 3W,300 A (UPGRADE ALTERNAT) MCB 600A		
CKT	1Ø	1Ø 3Ø			A Ø	OADS KI B Ø	N CØ		DESCRIPTIO	ON	CKT #	
1					AD	0.0	0.0		AUTOMATI	C DOOR	2	
3	1 Ø HVAC UNIT #1	3 Ø HVA UNIT #							SPAF	RE	4	
5	1 Ø HVAC	UNIT #	. 1						SPAF	RE	6	
7	UNIT #2	the state of the s							SPAF	RE	8	
9	4 67 10 (A C	3 Ø HVAC							SPAF	RE	10	
11	1 Ø HVAC UNIT #3	UNIT #	-2						SPAF	RE	12	
13	1 Ø HV/AC			0					SPECIALTY US	SE OUTLET	12	
15	1 Ø HVAC UNIT #4	3 Ø HVA							COOL	ER	16	
17	1 Ø HVAC UNIT #5	UNIT #	.S						SPAF	RE	18	
19	IF UPGRADE REQUIRED								COOL	ER	20	
21	SPARE	3 Ø HVA UNIT #		\cap					SPAF	RE	22	
23	SPARE	OIIII II		\cap					FREEZ	'ER	24	
25	WATER I	HEATER AT							TINELZ	.LIX	26	
27	REST	ROOMS							SPAF	RE	28	
29		HEATER AT G (SPARE ON		\cap					SPAF	RE	30	
31		C AND D)							SPAF	RE	32	
33	ICE CREAM	POWER POLE							SPAF	RE	34	
35	DRINKING	DRINKING FOUNTAINS							SPAR	RE	36	
37	OUTDOOR ICE	MERCHANDISE	R						OI AI) -	38	
39	OUTDOOR DE	RINK VENDING						200	PANEL	_ В	40	
41	OUTDOOR H	IVAC OUTLET							. ,	WILL D		

PANEL A NOTES:


1) THE EXISTING BREAKER CONFIGURATION IS PROVIDED TO DEMONSTATE THE PREFERRED LOCATION. ALL ELECTRICAL REQUIREMENTS, LOAD CALCULATIONS AND RELATED COL REQUIREMENTS ARE TO BE PREFORMED BY A LICENSED ENGINEER TO BE SUBMITTED FOR REVIEW AND APPROVAIBY THE DOLLAR GENERAL STORE DESIGN

2) PANEL A TO BE SERVICE ENTRANCE RATED WITH AIC RATING OF 22KMINIMUM.

3) BREAKERS FOR HVAC UNITS SHALL BE SIZED PER MANUFACTURER EQUIREMENTS.

4) BREAKERS THAT SERVICE HVAC EQUIPMENT AND MOTOR LOADS (COLERS, FREEZERS, ETC) TO BE HACR.

5) BREAKERS THAT SERVICE LIGHTS TO BE HID RATED. 6) CIRCLED CIRCUIT DENOTES BREAKER LOCKS.

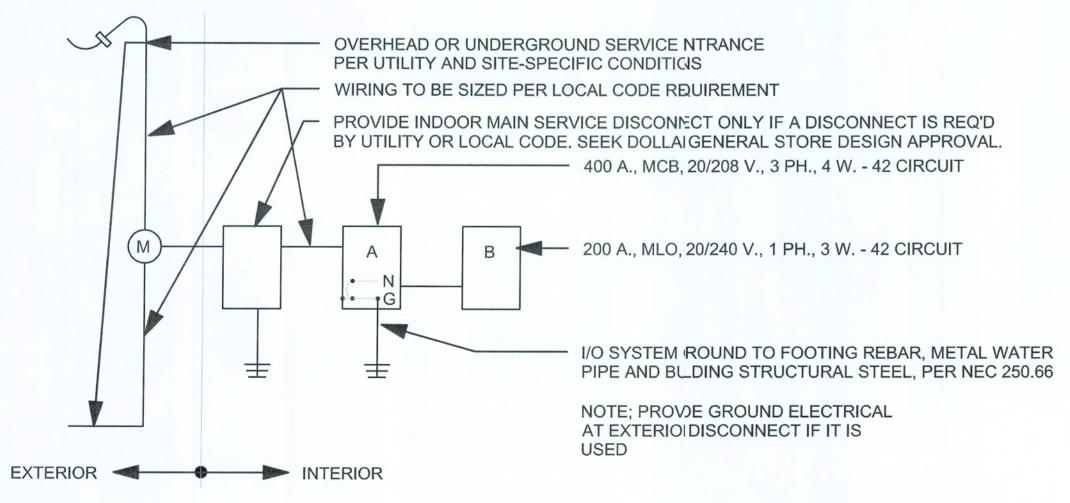

ELECTRICAL PANEL SCHEMATIC

N.T.S.

SURFACE PANIEL B MLO MCB 120/240 V, 1Ø, 3W, 200 A **FLUSH** LOADS KW CKT DESCRIPTION DESCRIPTION AØ BØ **EMERGENCY/EXIT LIGHTS** TELEPHONE BOARD BREAKROOM / OFFICE / **ENERGY MANAGEMENT** RESTROOM LIGHTS SALES LIGHTS - ROW 1/ENTRY SECURITY OUTLETS 7 SALES LIGHTS - ROW 2 & 4 OFFICE OUTLETS 9 SALES LIGHTS - ROW 3 & 6 **BREAK ROOM OUTLETS** 11 SALES LIGHTS - ROW 5 & 7 LEFT SIDE SALES OUTLETS 12 13 SALES LIGHTS - ROW 8 & 10 RIGHT SIDE SALES OUTLETS 14 15 SALES LIGHTS - ROW 9 & 12 ATM MACHINE 17 SALES LIGHTS - ROW 11 & 13 SALES/REC. NIGHTLIGHTS SALES LIGHTS - LEFT **SPARES** PERIMETER SALES LIGHTS - RIGHT **SPARES** PERIMETER 23 BUILDING SIGN POWER POLE 1 BROWN 25 PYLON SIGN POWER POLE 1 CKT 1 27 SITE LIGHT POWER POLE 1 CKT 2 29 SITE LIGHT POWER POLE 2 BROWN RIGHT EXT. WALL LIGHTS POWER POLE 2 CKT 1 LEFT EXT. WALL LIGHTS POWER POLE 2 CKT 2 FRONT EXT. WALL/ POWER POLE 3 (IF REQ'D.) CANOPY LIGHTS POWER POLE 3 (IF REQ'D.) FRONT RIGHT FLOOD POWER POLE 3 (IF REQ'D.) FRONT LEFT FLOOD EXTERIOR DUSK/DAWN SPARE

PANEL B NOTES:

1) CIRCLED CIRCUIT DENOTES BREAKKER LOCKS

2) ALL BREAKERS 20/1 UNO

3) ALL BREAKERS SWD, HID RATED

4) PANEL B SERIES RATED WITH PANIJEL A

5) SHADED CIRCUIT DENOTES ROUTIFING TO THE EMS PANEL

6) PROVIDE AND INSTALL 1 AND 2 POILE BREAKERS FOR COOLERS/ FREEZERS AS PER FINAL FIXTURE PLAN - WILL NOT EXCEED 40 AMPS ON DOUBLE POLE EBREAKERS. SINGLE POLE CIRCUITS WILL NOT EXCEED 30 AMPS. 7) THE EXISTING BREAKER CONFIGURATION IS PROVIDED TO DEMONSTRATE THE PREFERRED LOCATION. ALL ELECTRICAL REQUIREMENTS, LOAD CCALCULATIONS AND RELATED CODE REQUIREMENTS ARE TO BE PREFORMED BY A LICENSED ENGINEER TO BE SUBMITTTED FOR REVIEW AND APPROVAL BY THE DOLLAR GENERAL STORE DESIGN

8) BREAKERS THAT SERVICE LIGHTS; TO BE HID RATED.


HVAC UPGRADE NOTE: HVAC UPGRADE & SINGLE PHASE 600 AMP SERVICE ONLY REQUIRED IF DETERMINED BY DG REAL ESTATE COMMITTEE

	REQUIRED CARRIER OR LENNOX UNITS						
MFG	STANDARD	UP(GRADE	TONAGE	Gas Input	MODEL NUMBER		
CARRIER	3	4	5 Ton	High Gas	48TCFA06A1A3A0A0A0		
LENNOX	4	5	5 Ton	Low Gas	KGA060S4BS		
LENNOX	4	5	5 Ton	Electric	KCA060S4BN		
LENNOX		4	6 Ton	Low Gas	KGA072S4BS		
LENNOX		4	6 Ton	Electric	KCA072S4BN		


CARRIER NATIONAL ACCOUNTS - ALISON HARTMAN - PHONE # 800-690-1081

LENNOX NATIONAL ACCOUNTS - JOSHUA PLUMMER - PHONE# 800-367-6285 OPT. 2

ELECTRIC UNITS REQUIRE HHEAT STRIPS. ALL UNITS REQUIRE MANUAL OR ECONOMIZER DAMPERS. ELECTRICAL PANEL CRITERIA -THREE PHASE 400 AMP SERVICE PREFERRED

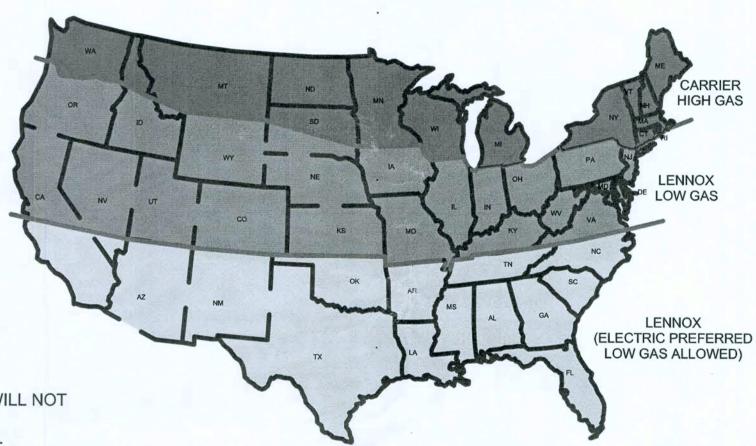

NOTE: PROPANE IS NOT ALLOWED AS A SUBSTITUTE FOR GAS OR ELECTRIC SERVICE UNLESS APPROVED BY DG AUTOCAD STORE DESIGN DEPARTMENT, IF PROPANE IS USED. TANKS ARE REQUIRED TO BE

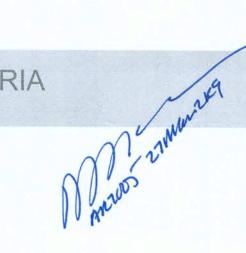

SYMBOL	DESCRIPTION	CABLE TYPE
(AT)	AHU TERMINAL STRIP	8C T-STAT CABLE
DS	DOOR CONTACT SWITCH	BELDEN 8761 OR EQUIVALENT (22AWG, 2C, STRANDED, SHIEDED)
N	NETWORK CABLE	CAT5
M	MOTION SENSOR	(18AWG, 4C, STRANDED, SHIEDED)
		LEVITON EZ-FIND ODC0S-IDW
ОТ	OUTDOOR AIR TEMP	BELDEN 8761 OR EQUIVALENT (22AWG, 2C, STRANDED, SHIEDED)
ST	SUPPLY TEMP (501-1121)	BELDEN 8761 OR EQUIVALENT (22AWG, 2C, STRANDED, SHIEDED)
T	TEMPERATURE SENSOR (501-1121)	BELDEN 8761 OR EQUIVALENT (22AWG, 2C, STRANDED, SHIEDED)
TS	TEMPERATURE SENSOR (809-6590)	BELDEN 8761 OR EQUIVALENT (22AWG, 2C, STRANDED, SHIEDED)
\$	MOTION SENSOR	LEVITON EZ-FIND ODS-10-IDV

____ MOUNT @ 8'-0" AFF

SENSOR PLAN KEYED NOTES

1 THE EXACT MOUNTING LOCATION OF THE SENSOR WILL VARY DEPENDING ON THE STORE LAYOUT AND DUCT CONFIGURATION. REFER TO SITE SPECIFIC DRAWINGS FOR EXACT SENSOR MOUNTING LOCATIONS

ELECTRICAL CONTRACTOR TO INSTALL (1) CONDUIT TO CHANNEL (3) 22AWG, 2C, STRANDED & SHIELDED LOW VOLTAGE WIRES FROM CEILING TO WALL BEHIND COOLERS & FREEZERS AND COVER JUNCTION BOX WITH SOLID WALL PLATE. WALL PENETRATION SHALL BE 6'-0" AFF AND 56'-9" FROM FRONT SALES FLOOR/BREAK ROOM WALL. PROVIDE 20' OF EXTRA COILED LOW VOLTAGE WIRE ABOVE THE CELING. DOLLAR GENERAL WILL PROVIDE FINAL CONNECTIONS TO TEMPEATURE SENSORS.

12'-0'




5/19/08 RELEASE ADDENDA I 2008

DATE

05/19/08

SHEET NUMBER


EMS1.D

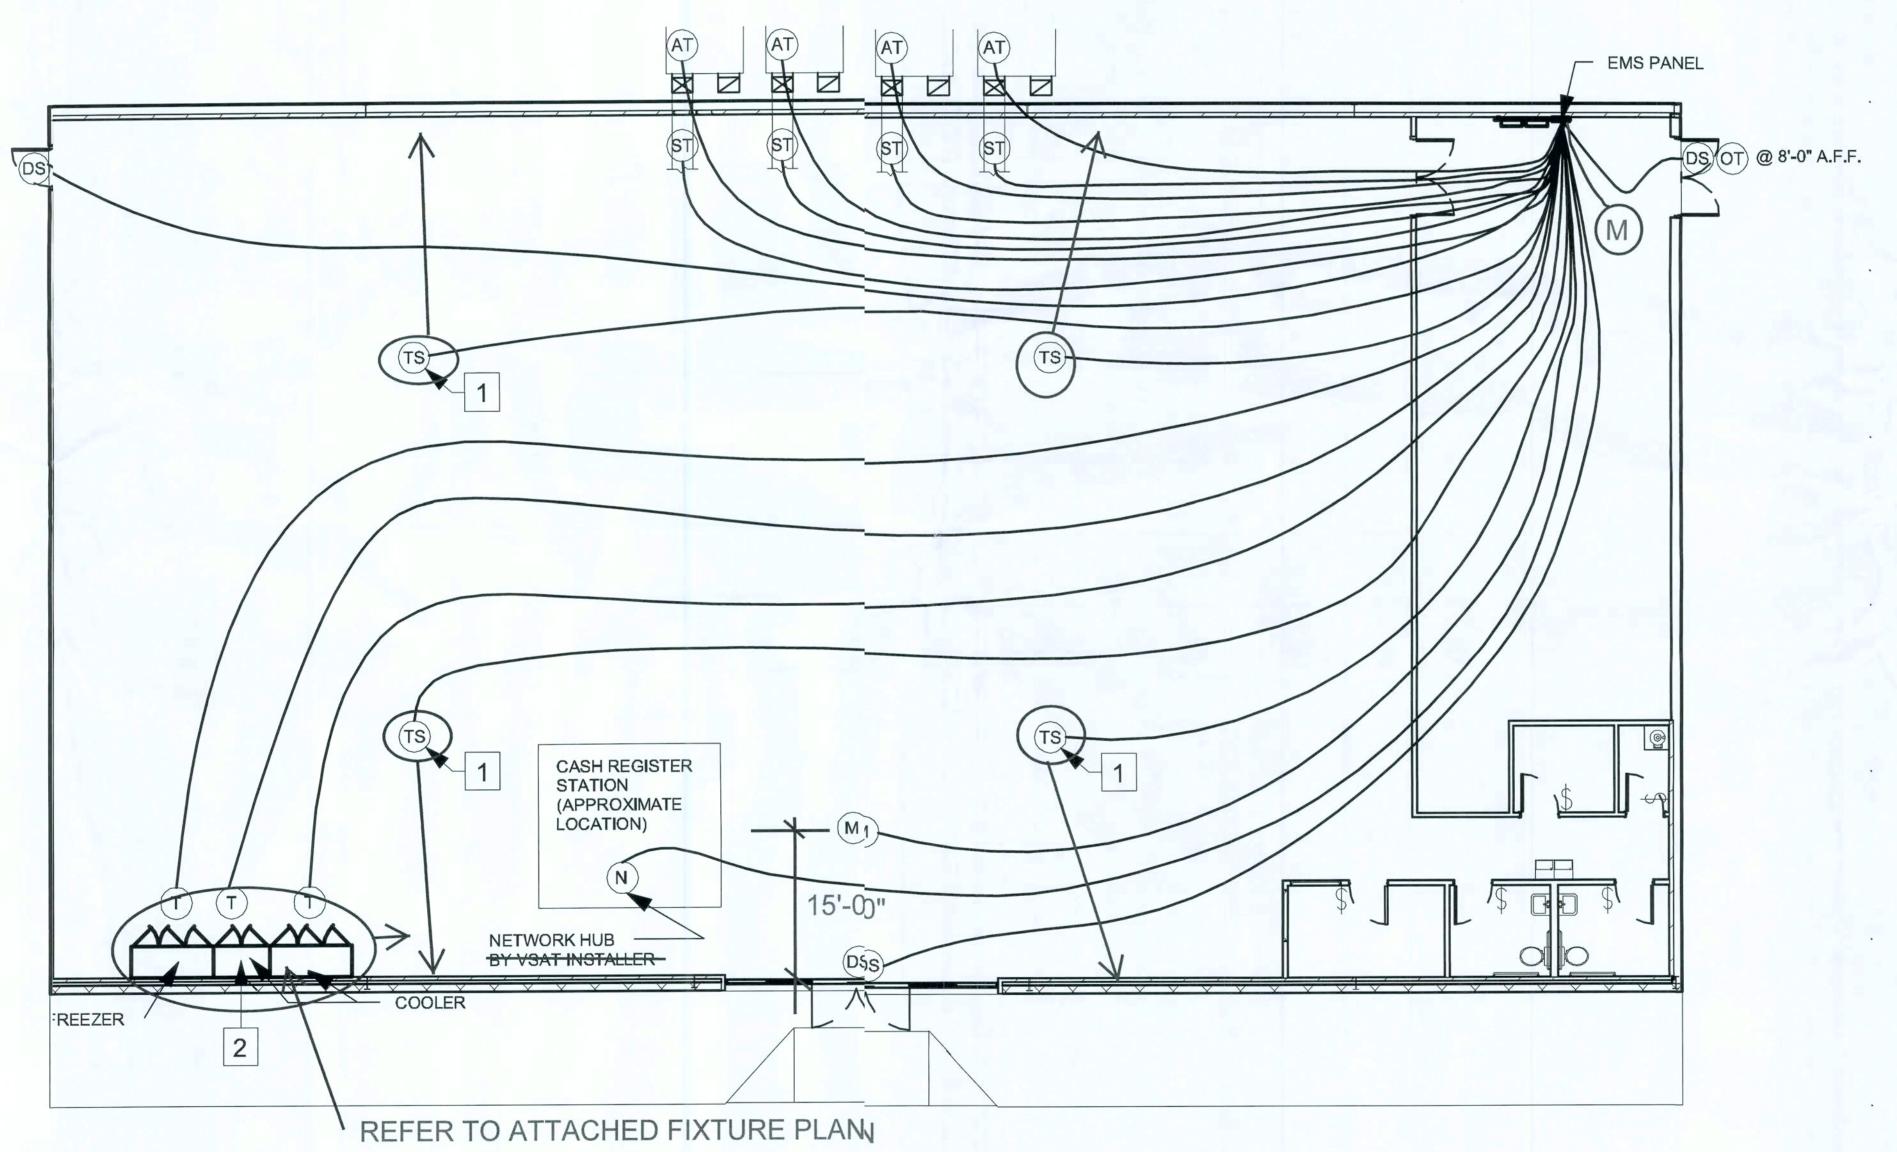

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NOTE: ALL QUESTIONS PERTAINING TO THE TRUCTION EMS PANEL, SYSTEM INSTALLATION & SETUP SHOULD BE DIRECTED TO 770425 2/124.9


SENSOR LOCATION PLAN OPTION "D"

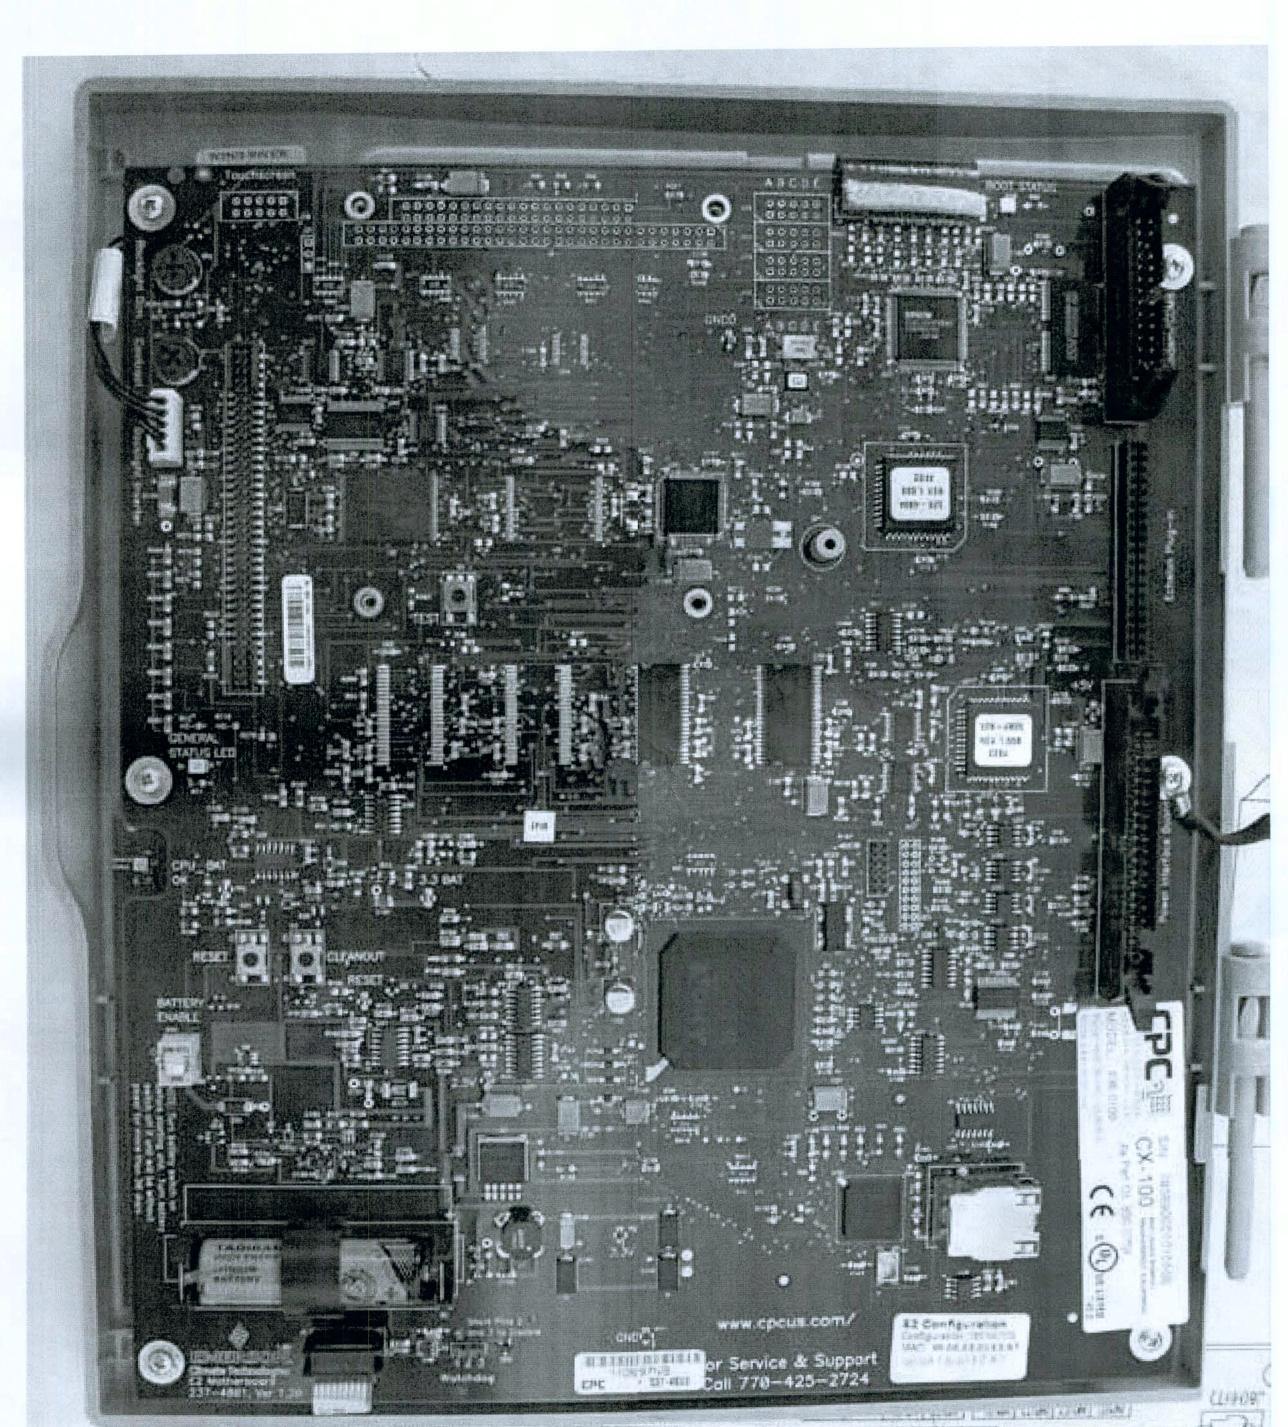

Issued For Construction:

Concept Construction

Date: 2/2/09

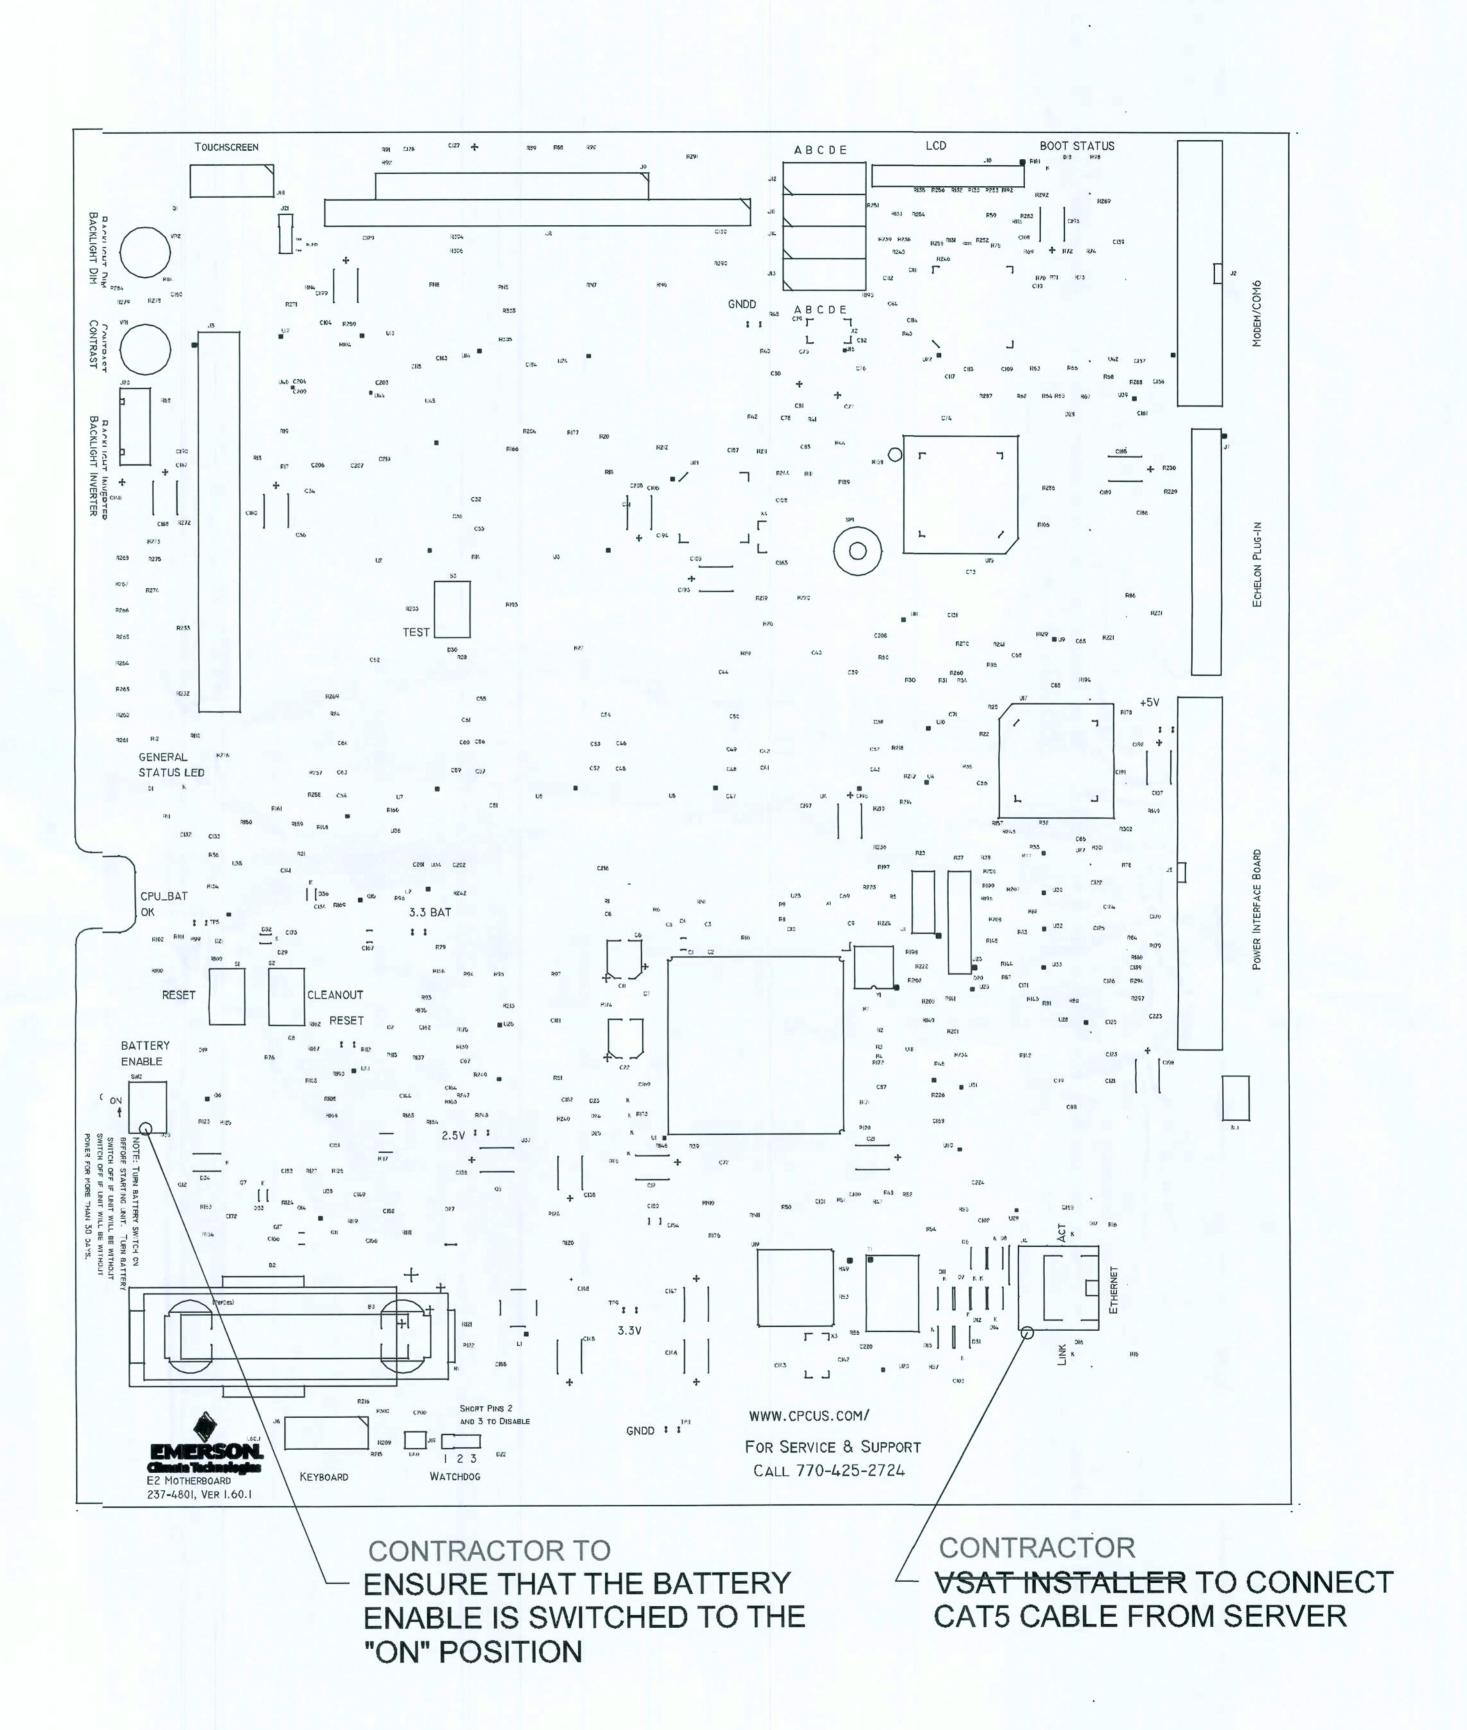

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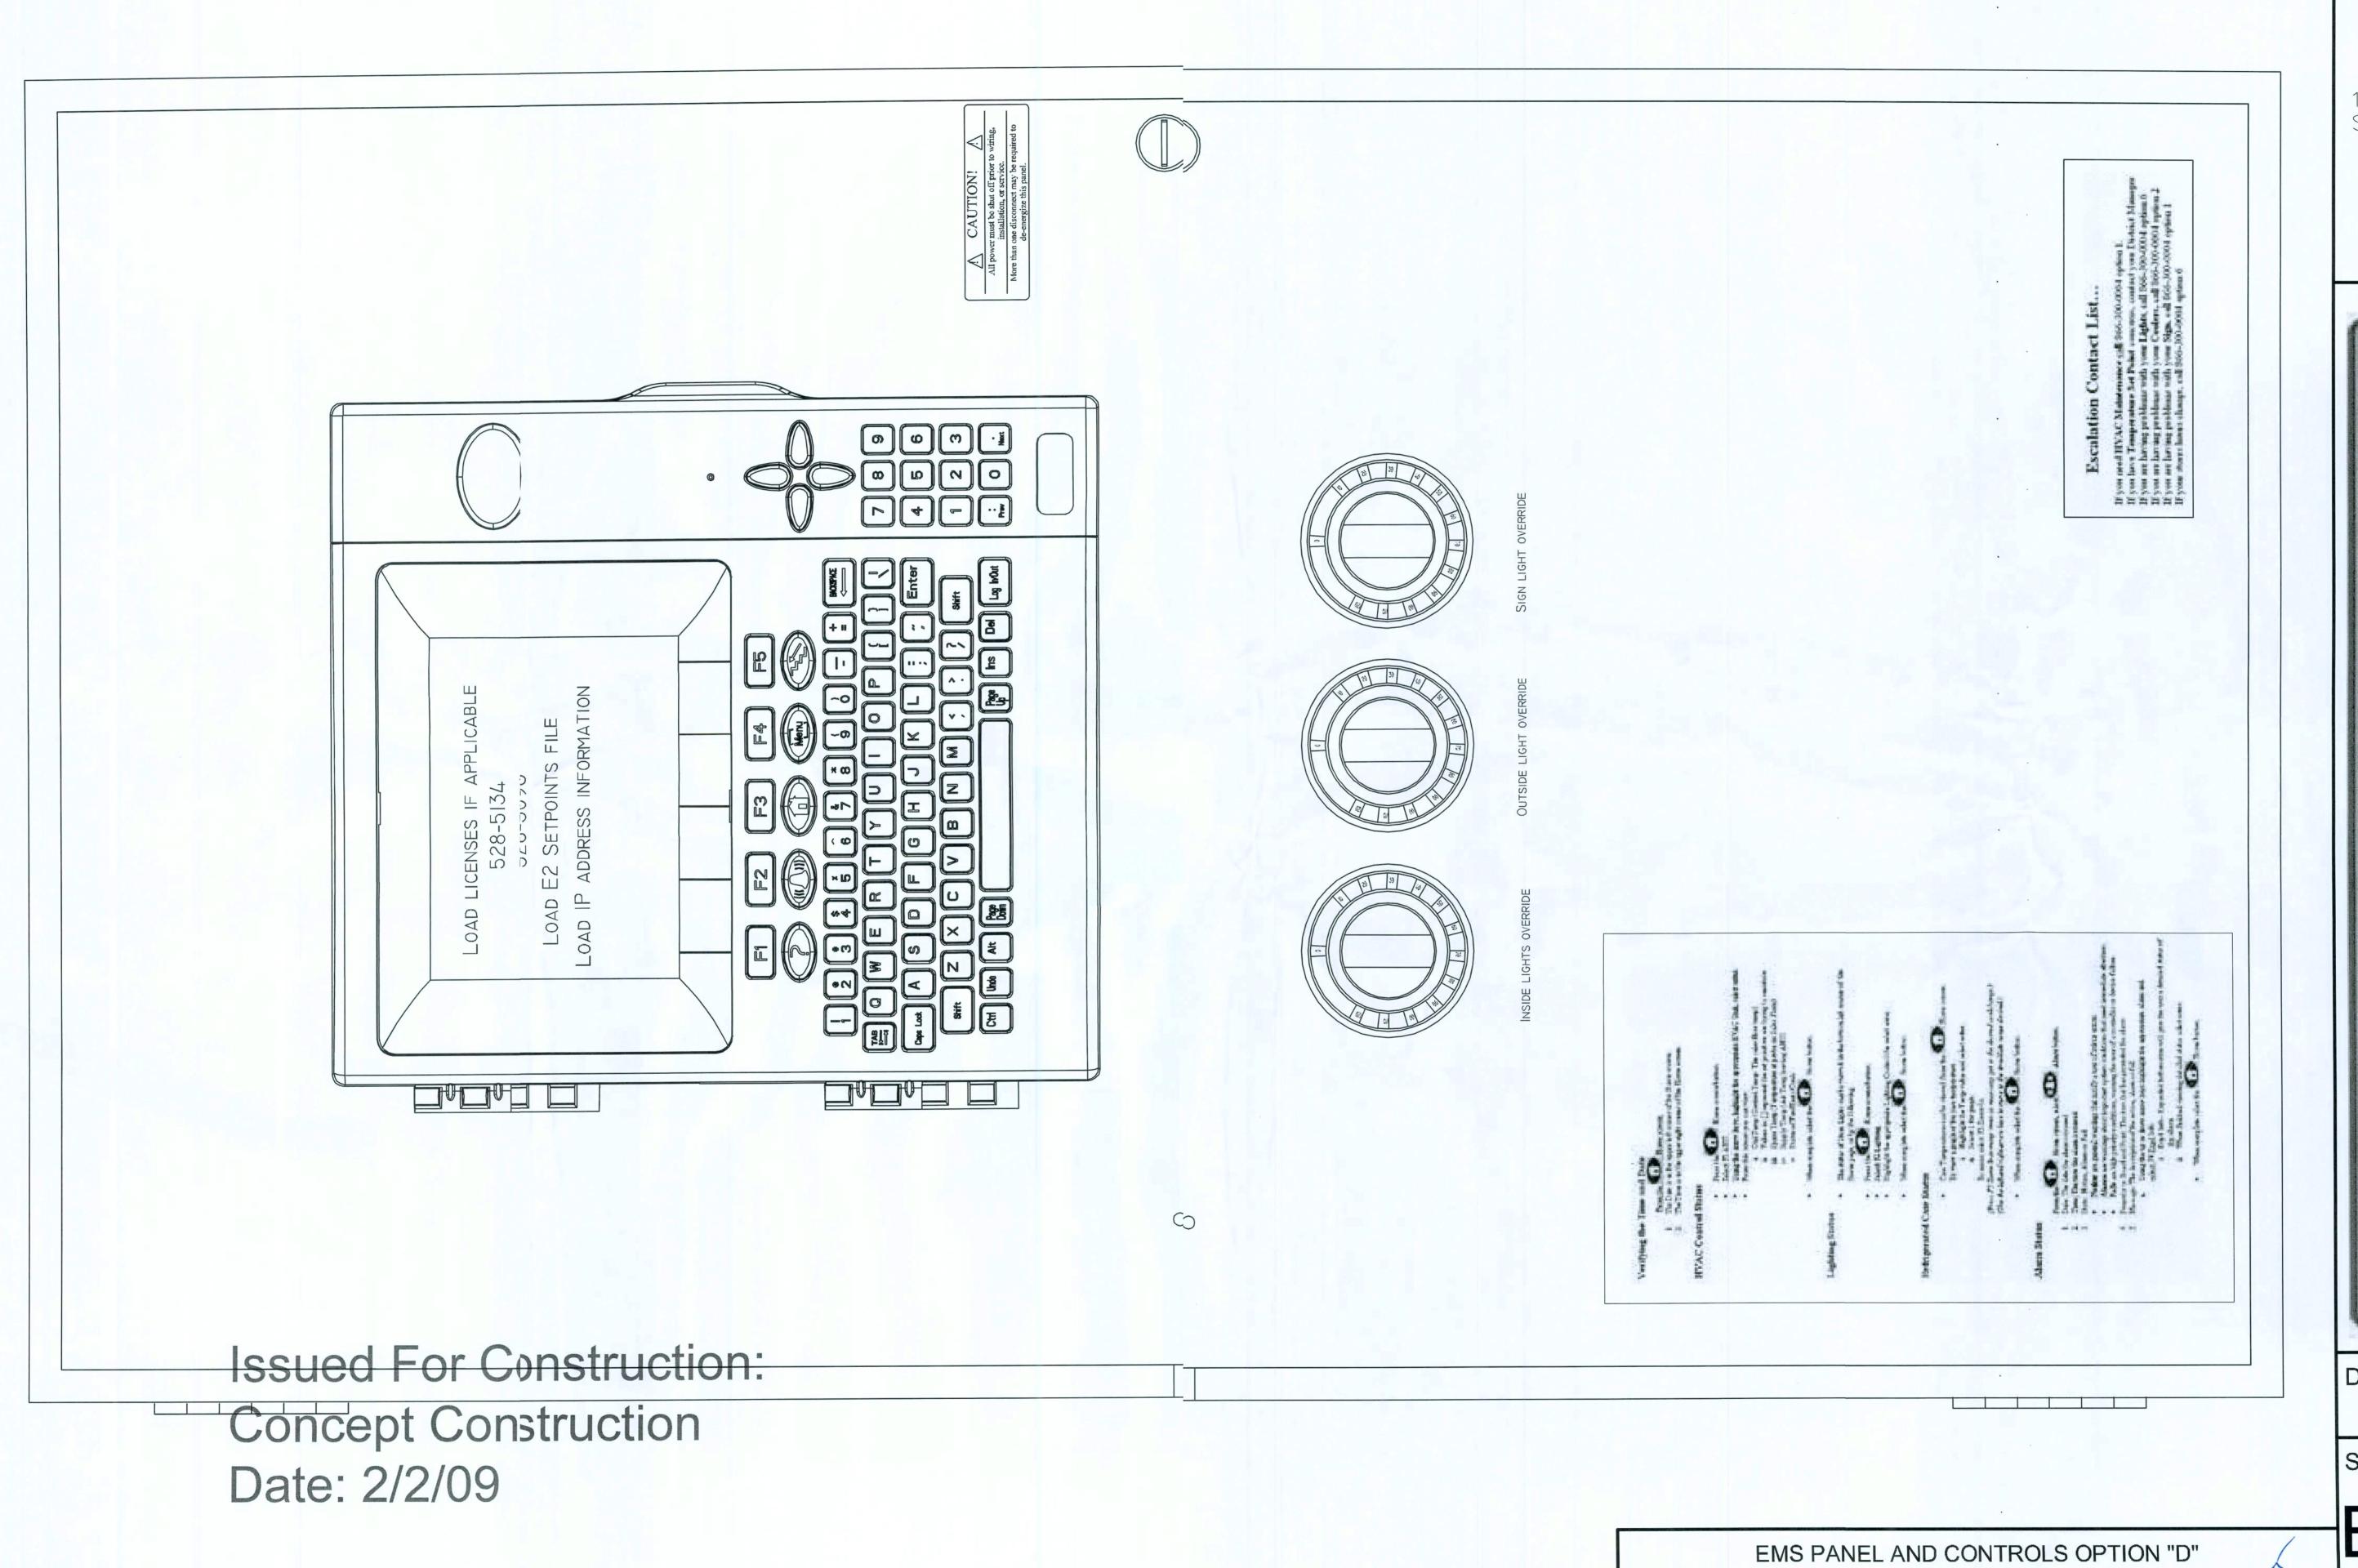
DATE

05/19/08

SHEET NUMBER

EMS2.D

SENSOR LOCATION PLAN OPTION "D"



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CRITERIA SET PLAN "D"
AutoCAD-Store Design Department (6

PROTOTYPE


2008

DATE

05/19/08

SHEET NUMBER

EMS3.D

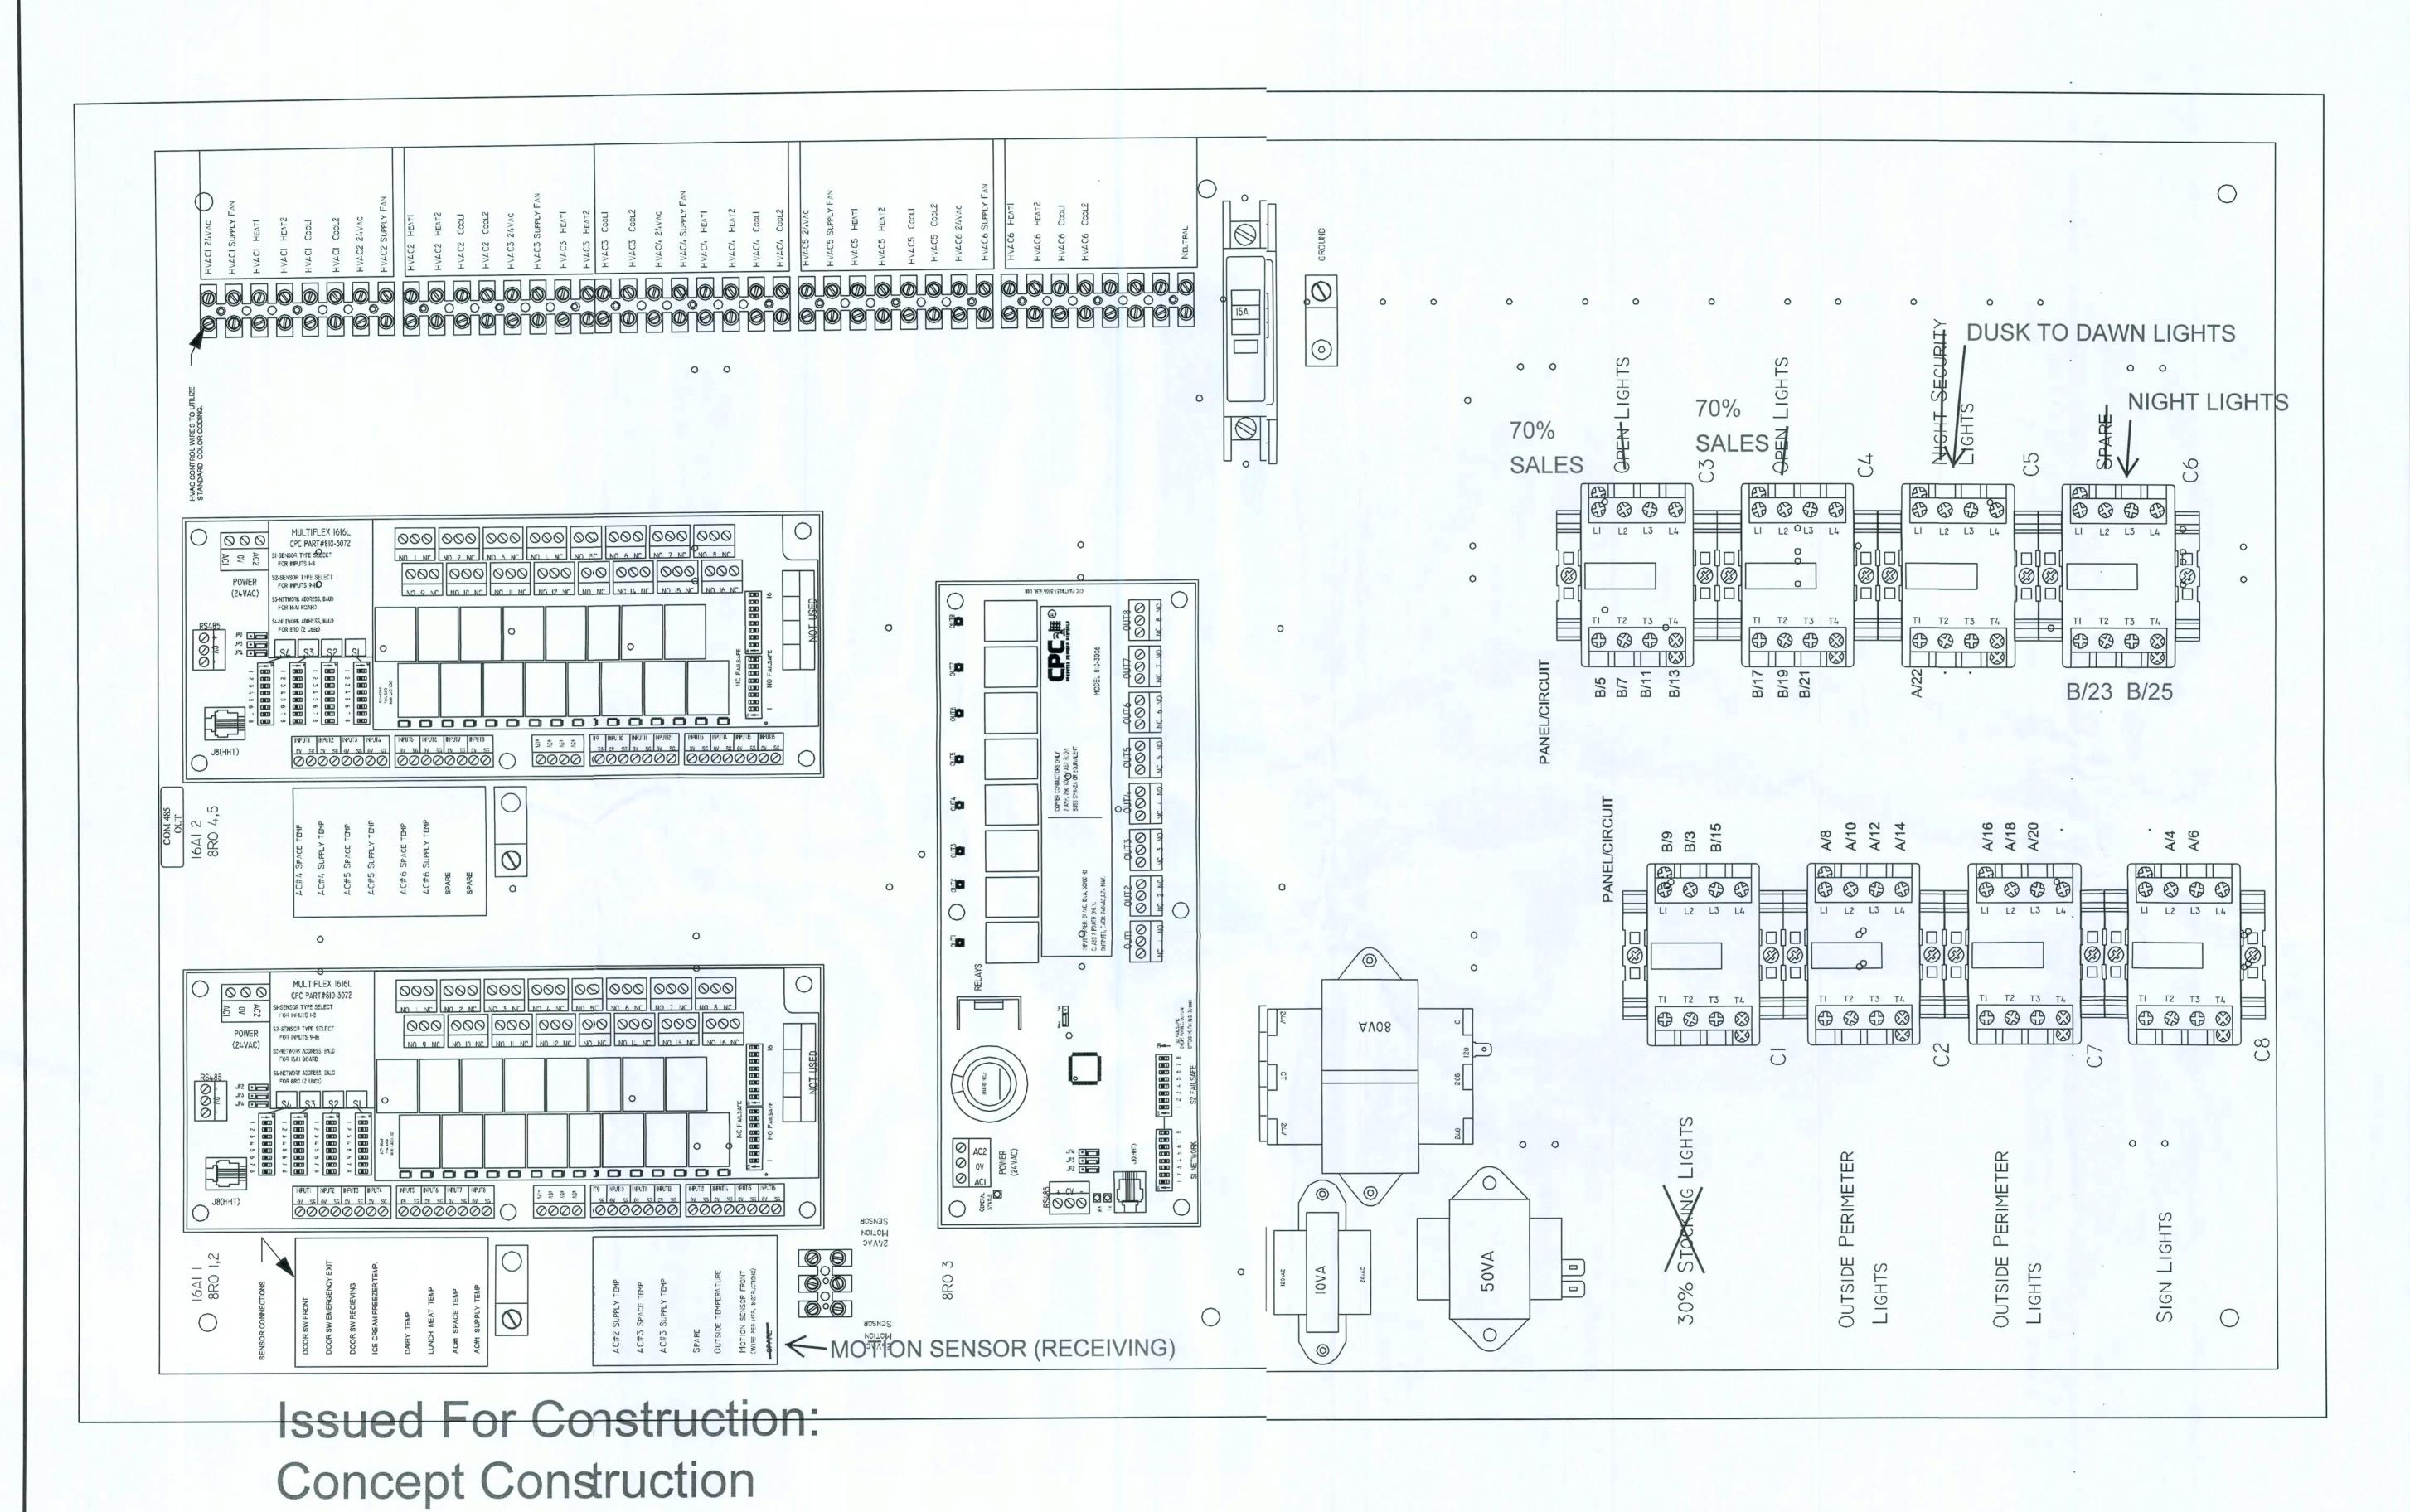

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ELECTRICAL PANELS OPTION "D"

SITE LIGHTING

1. FINAL SIGN CONNECTION AND UNDERGROUND CONDUIT IS LNDLORD RESPONSIBILITY. PROVIDE CONDUIT FROM THE ELECTRICAL PANEL TO LOCATION OF THEYLON SIGN BASE. BURY CONDUIT UNDER PARKING AREA. THE CONDUIT IS TO BE 1" AND HAVE GE SET TO 10/2 WIRE WITH GROUND AND A 20-AMP TWO POLE BREAKER AT THE PANEL. A TEMPORARY! TALL STAKE SHALL BE PROVIDED TO DESIGNATE THE PYLON SIGN LOCATION UNTIL THE SIGN IS PRMANENTLY INSTALLED. REMOVE POST AFTER SIGN IS INSTALLED.

2. SITE / PARKING LOT LIGHTING: PROVIDE ADEQUATE POLE AID/ OR WALL LIGHTING FOR NIGHT VISION AROUND ENTRY, PARKING AND DUMPSTER PAD AREAS

3. MINIMUM OF TWO FOOT-CANDLES REQUIRED FOR ALL PAVD AREAS EXCLUDING 15' PERIMETER FROM EDGE OF PAVEMENT.

4. REQUIRED LIGHTING: A COMBINATION OF POLE LIGHTS, BI-IRECTIONAL SECURITY LIGHTS AND WALL PACKS WILL BE USED. REFER TO ELECTRICAL SITE PLAN AND SHEET 2.D FOR ADDITIONAL INFORMATION

5. PLEASE NOTE THAT LIGHTING DESIGN AND LAYOUT IS SITE PECIFIC AND MAY REQUIRE ADDITIONAL LIGHTING TO COMPLY WITH SITE DESIGN CONDITIONS. THERFORE, MAKE PROVISIONS FOR MORE POLE LIGHTING WHEN A SPECIFIC SITE REQUIRES IT.

6. UNDERGROUND ELECTRICAL SHALL BE PROVIDED TO THE ITE LIGHT POLES.


7. WHERE LOCAL JURISDICTIONS DO NOT ALLOW DOLLAR GEERAL'S REQUIRED LIGHTING PLAN, AN ALTERNATE SITE LIGHTING PLAN & PHOTOMETRIC PLAN MUST BE SUBMITED FOR APPROVAL TO THE DOLLAR GENERAL AUTOCAD-STORE PLAN DEPARTMENT.

8. PHOTO METRIC SITE ANALYSIS AVAILABLE THROUGH DOLLA GENERAL VENDOR CONSOLIDATED ELECTRICAL DISTRIBUTORS CONTACT ROBERT DECKER AT (270) 781-2229.

9. DOLLAR GENERAL VENDOR PRICING FOR WALL PACKS OR DLE LIGHTING AVAILABLE FROM CONSOLIDATED ELECTRICAL DISTRIBUTORS ELECTRICAL. CONTACT ROBERT DECKER AT 2)-781-2229.

10. SEE SHEET E2.D FOR MORE INFORMATION.

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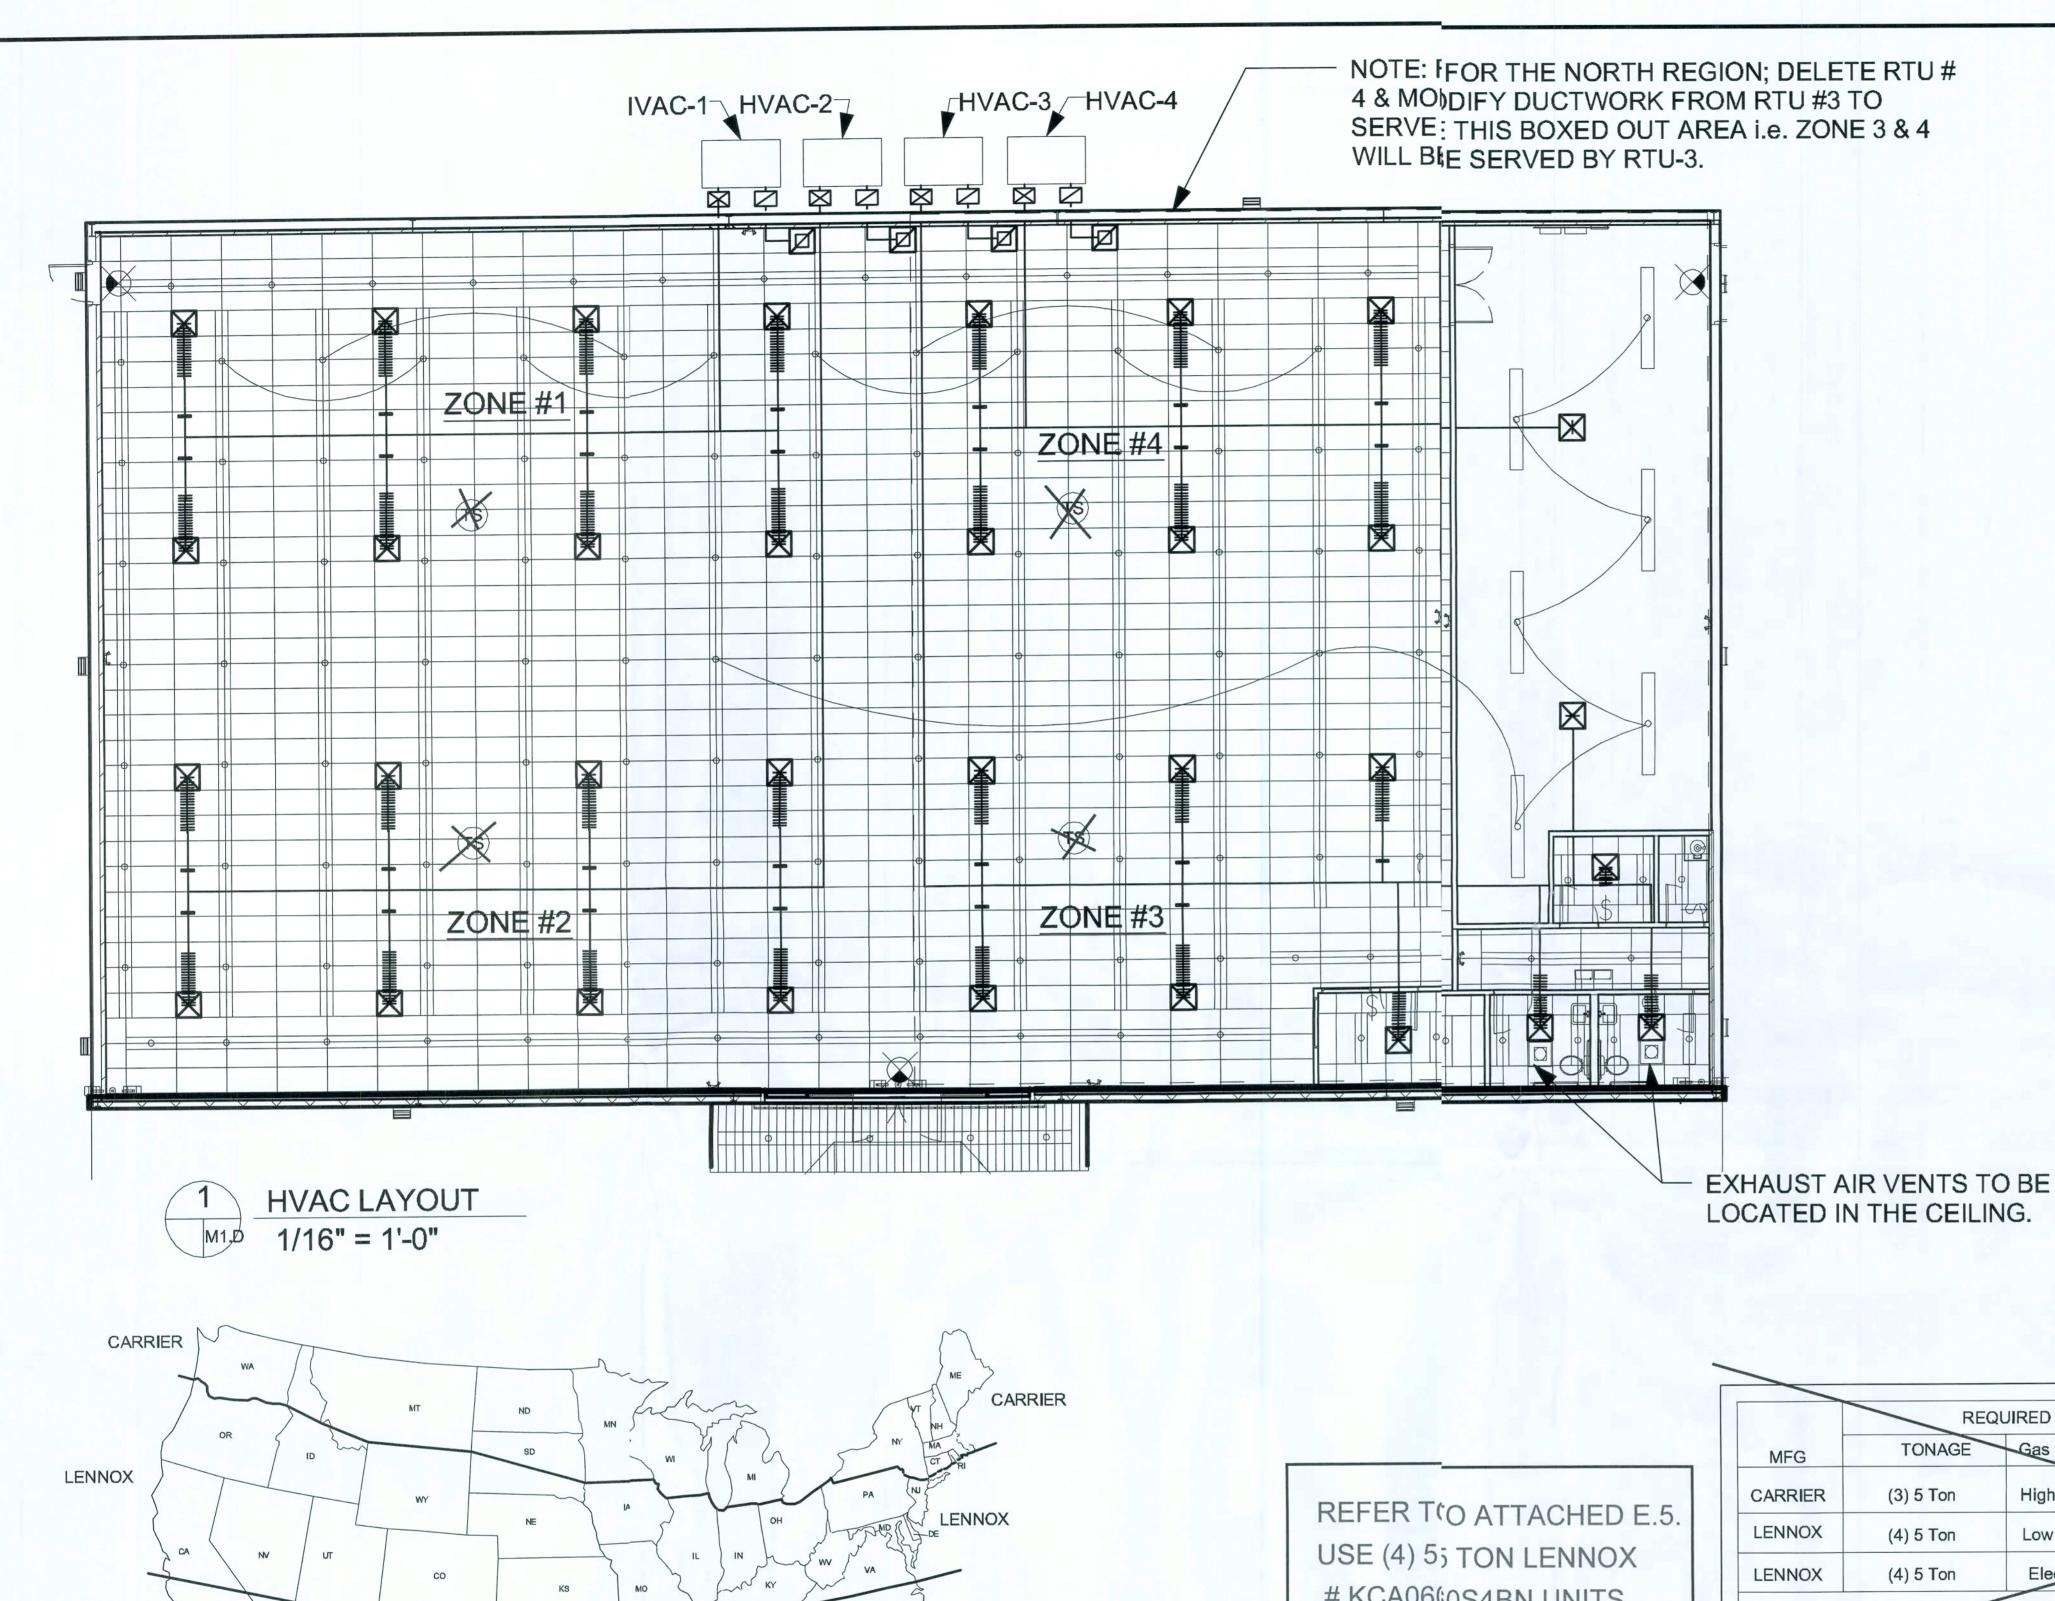
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ES1.D

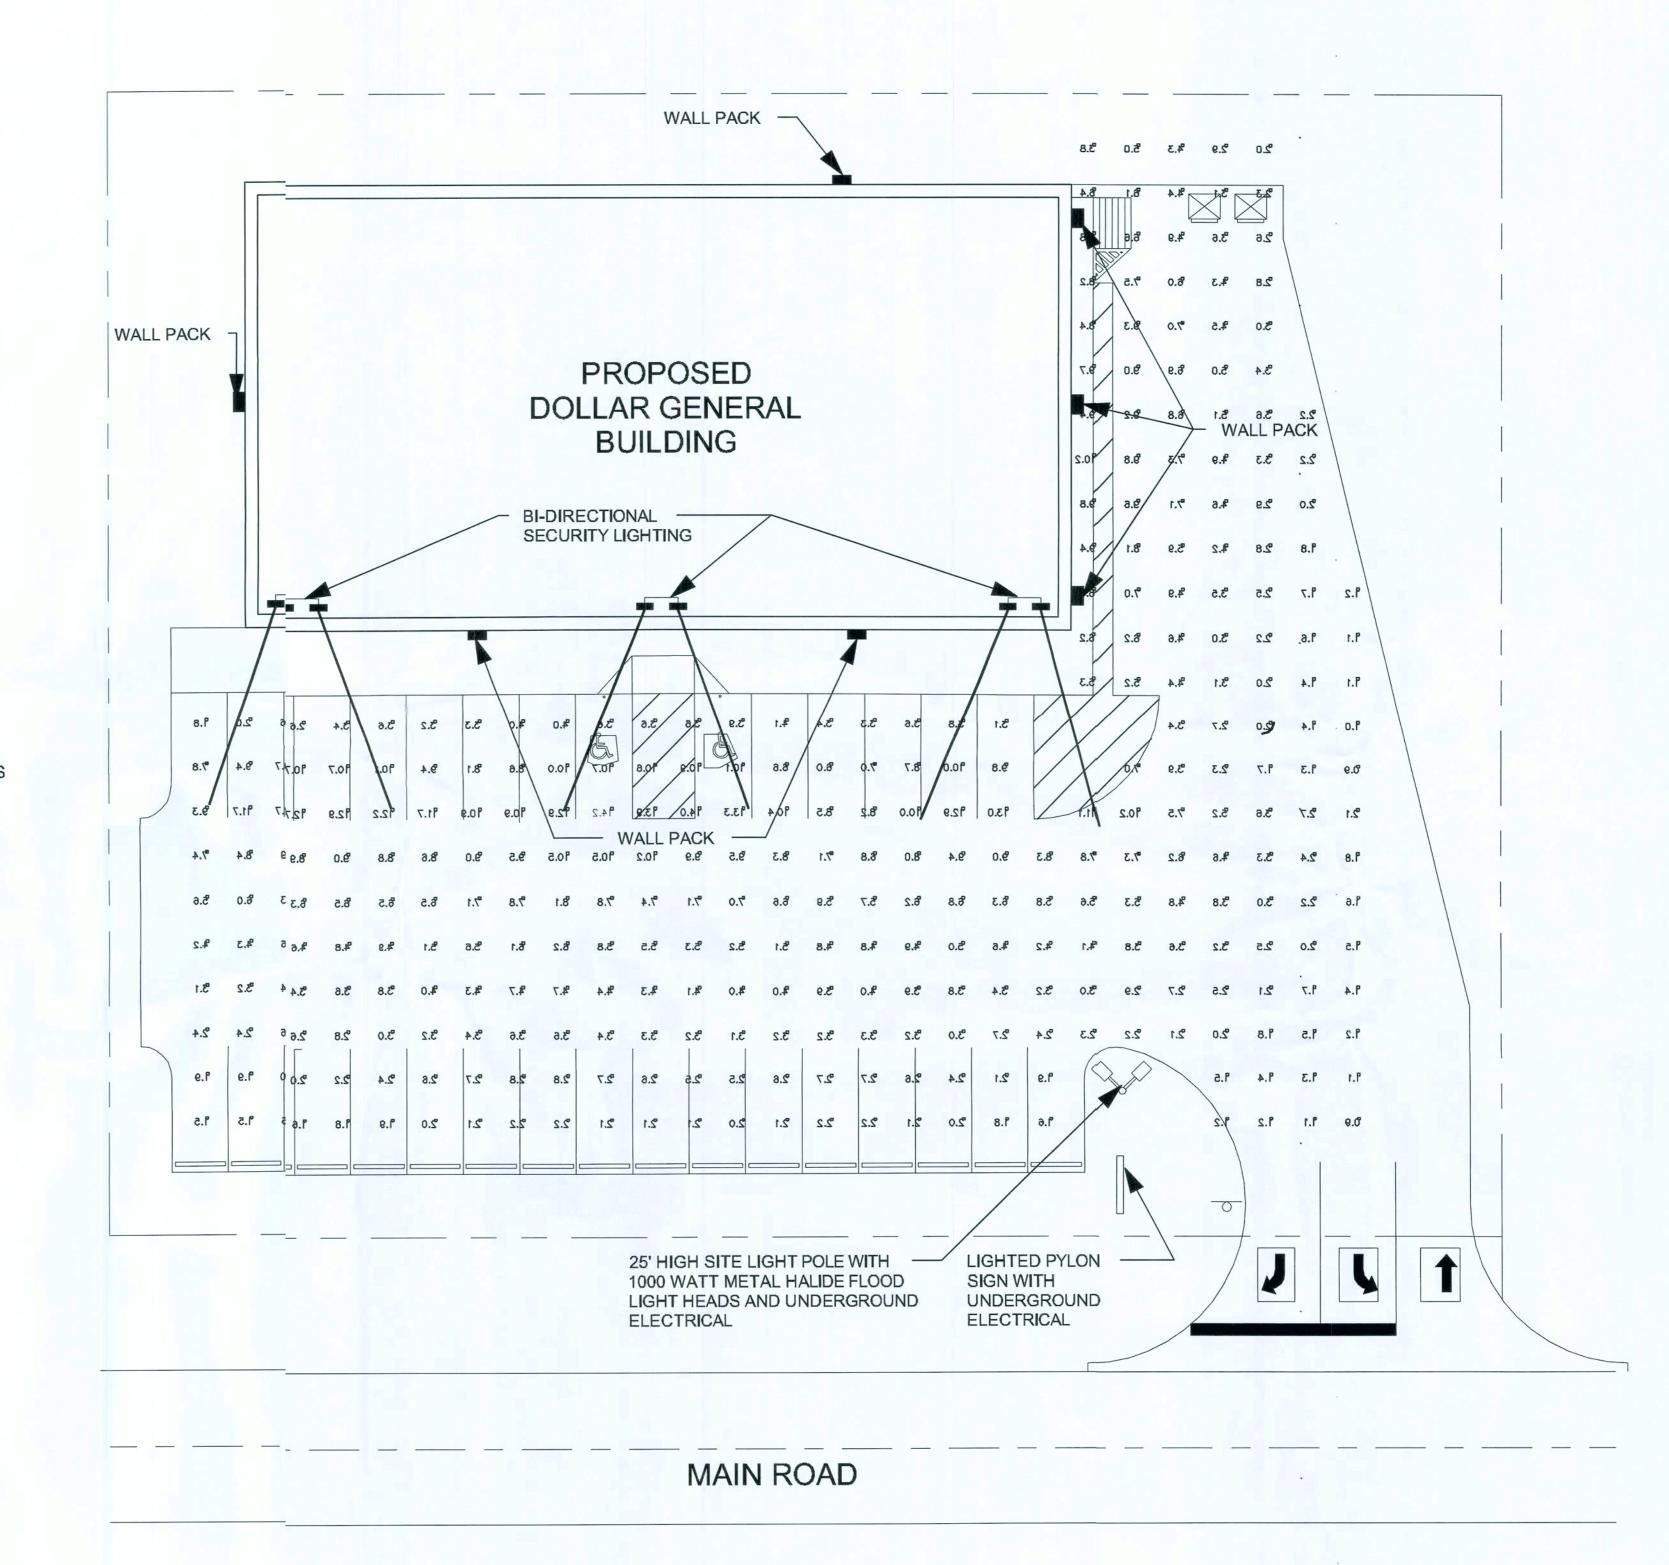ELECTRICAL SITE LIGHTING PLAN OPTION "D"



LENNOX

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LENNOX

ARE REQUIRED TO BE BURIED.

HVAC SPECIFICATIONS

1. REAR, SIDE, OR ROOF MOUNTED SYSTEM, WITH COMPLETE RIGID SQUARE DUCTWORK, CONFORMING TO ASHRAE SPECIFICATIONS IN SALES FLOOR, OFFICES, REST ROOM, AND STOCKROOM AREAS.

2. ALL DUCTWORK MUST BE ABOVE 10'-6" A.F.F.

3. FOR HVAC SENSOR LOCATIONS SEE EMS1.D SHEET

4. CARRIER AND/OR YORK PACKAGED H.V.A.C. SYSTEMS ARE REQUIRED.

5. PROVIDE INLINE EXHAUST FAN FOR RESTROOM AREAS, INTERLOCK W/ RESTROOM LIGHTS.

6. UNITS SHALL BE PLACED UPON ADEQUATE SIZED, ELEVATED CONCRETE PADS. SEE SHEET S1.D FOR DETAILS.

SYMBOL LEGEND:

EXHAUST FAN

SUPPLY AIR GRILL

RETURN AIR GRILL

TEMPERATURE SENSOR

NOTE!!! FIRE PROTECTION REQUIRED FOR ALL HVAC PENETRATIONS THROUGH FIRE WALL

KCA0660S4BN UNITS

MFG	TONAGE	Gas Input	MODEL NUMBER	Breaker Size
CARRIER	(3) 5 Ton	High Gas	48TCFA06A1A3A0A0A0A1-DG	
LENNOX	(4) 5 Ton	Low Gas	KGA060S4B-DG	70
LENNOX	(4) 5 Ton	Electric	KCA060S4B-DG	80

NOTE: ELEC. UNITS REQUIRE A SINGLE POINT KIT AND 10 KW HEAT STRIP. ALL UNITS REQUIRE MANUAL OR ECONOMIZER DAMPERS.

10877 WATSON ROAD ST. LOUIS, M0 63127

> 5/19/08 **EASE** ADDENDA) 855-4753 Store Design Department on Struction and Colorad (Colorad Colorad Colo CRITERIA AutoCAD-S PROTOTYPE 2008


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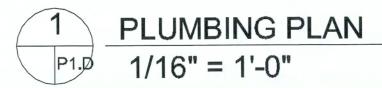
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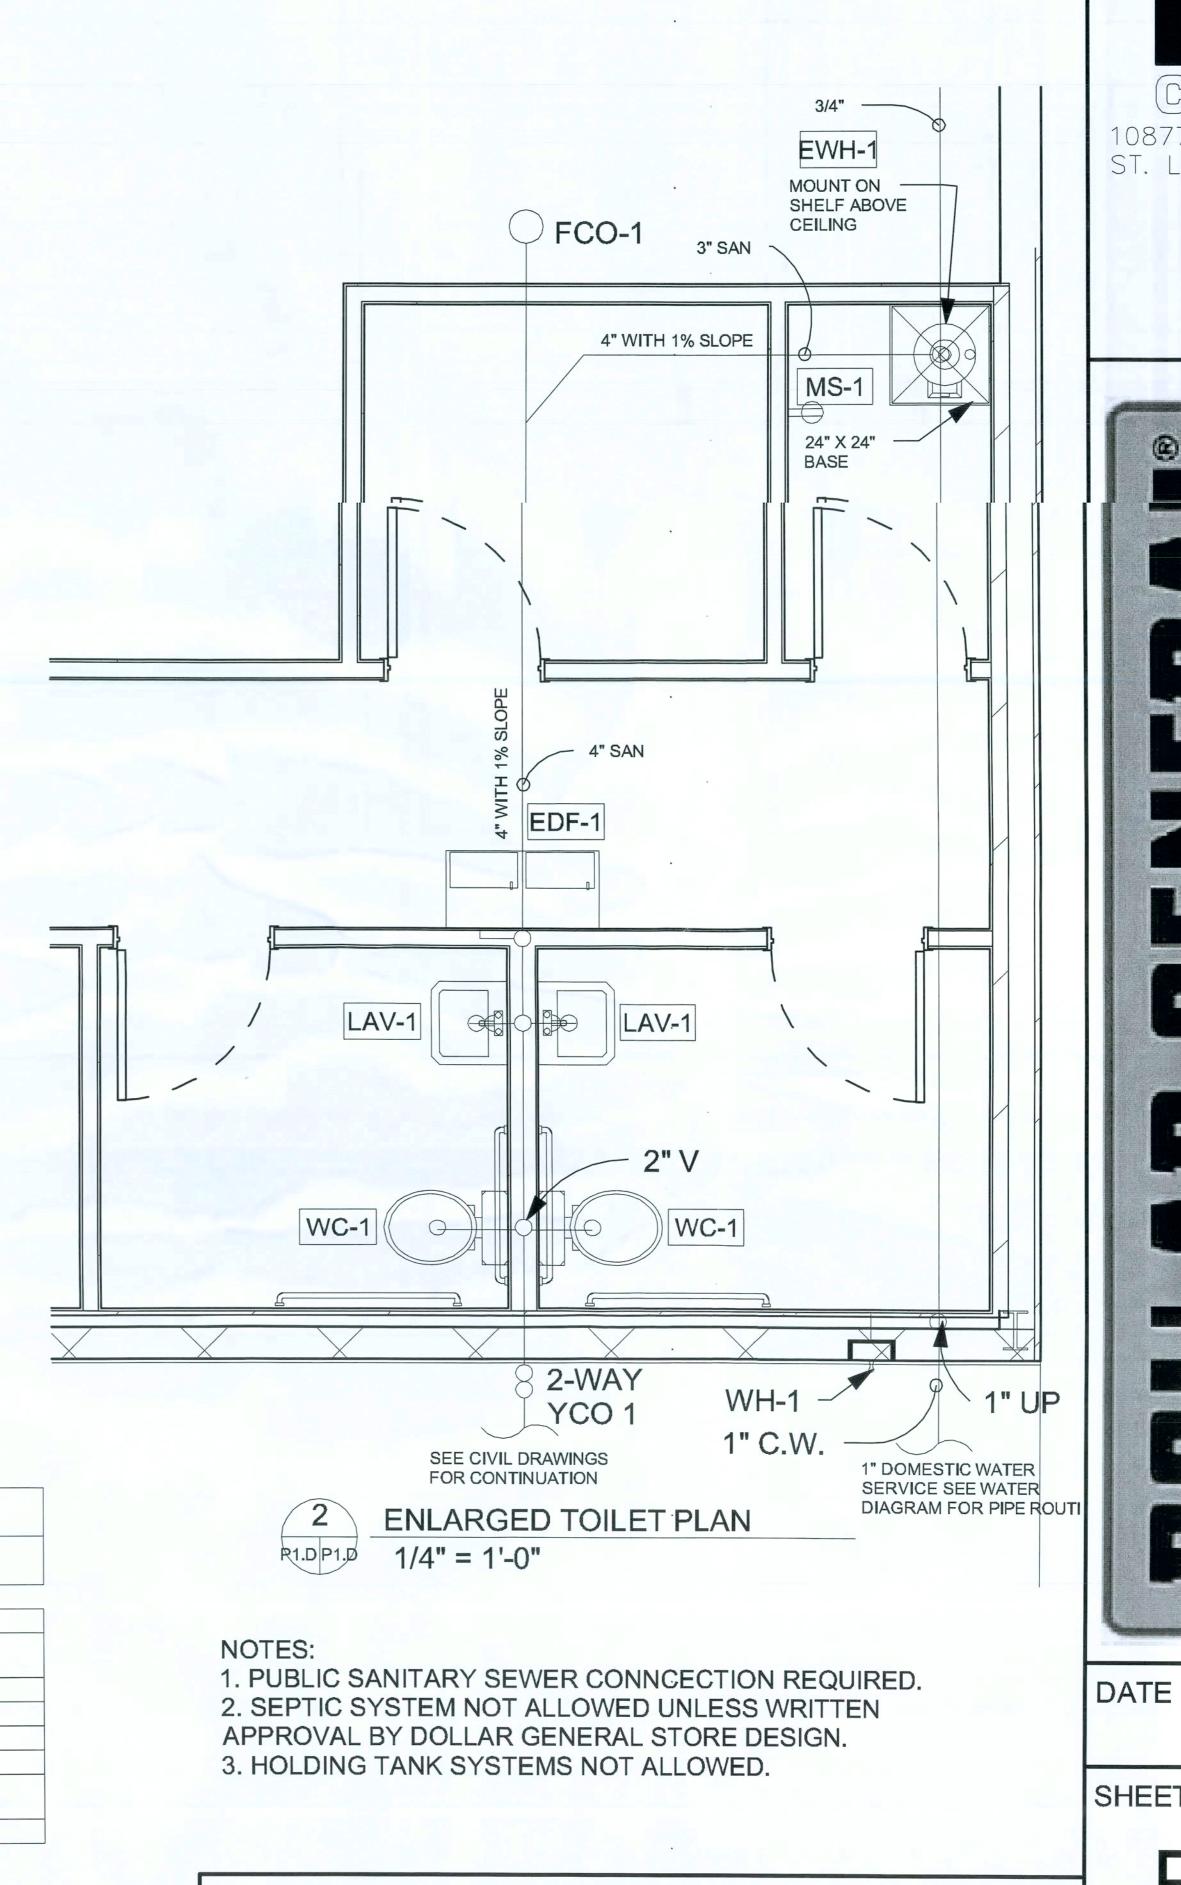
M1.D

HVAC LAYOUT & SCHEDULE OPTION "A"








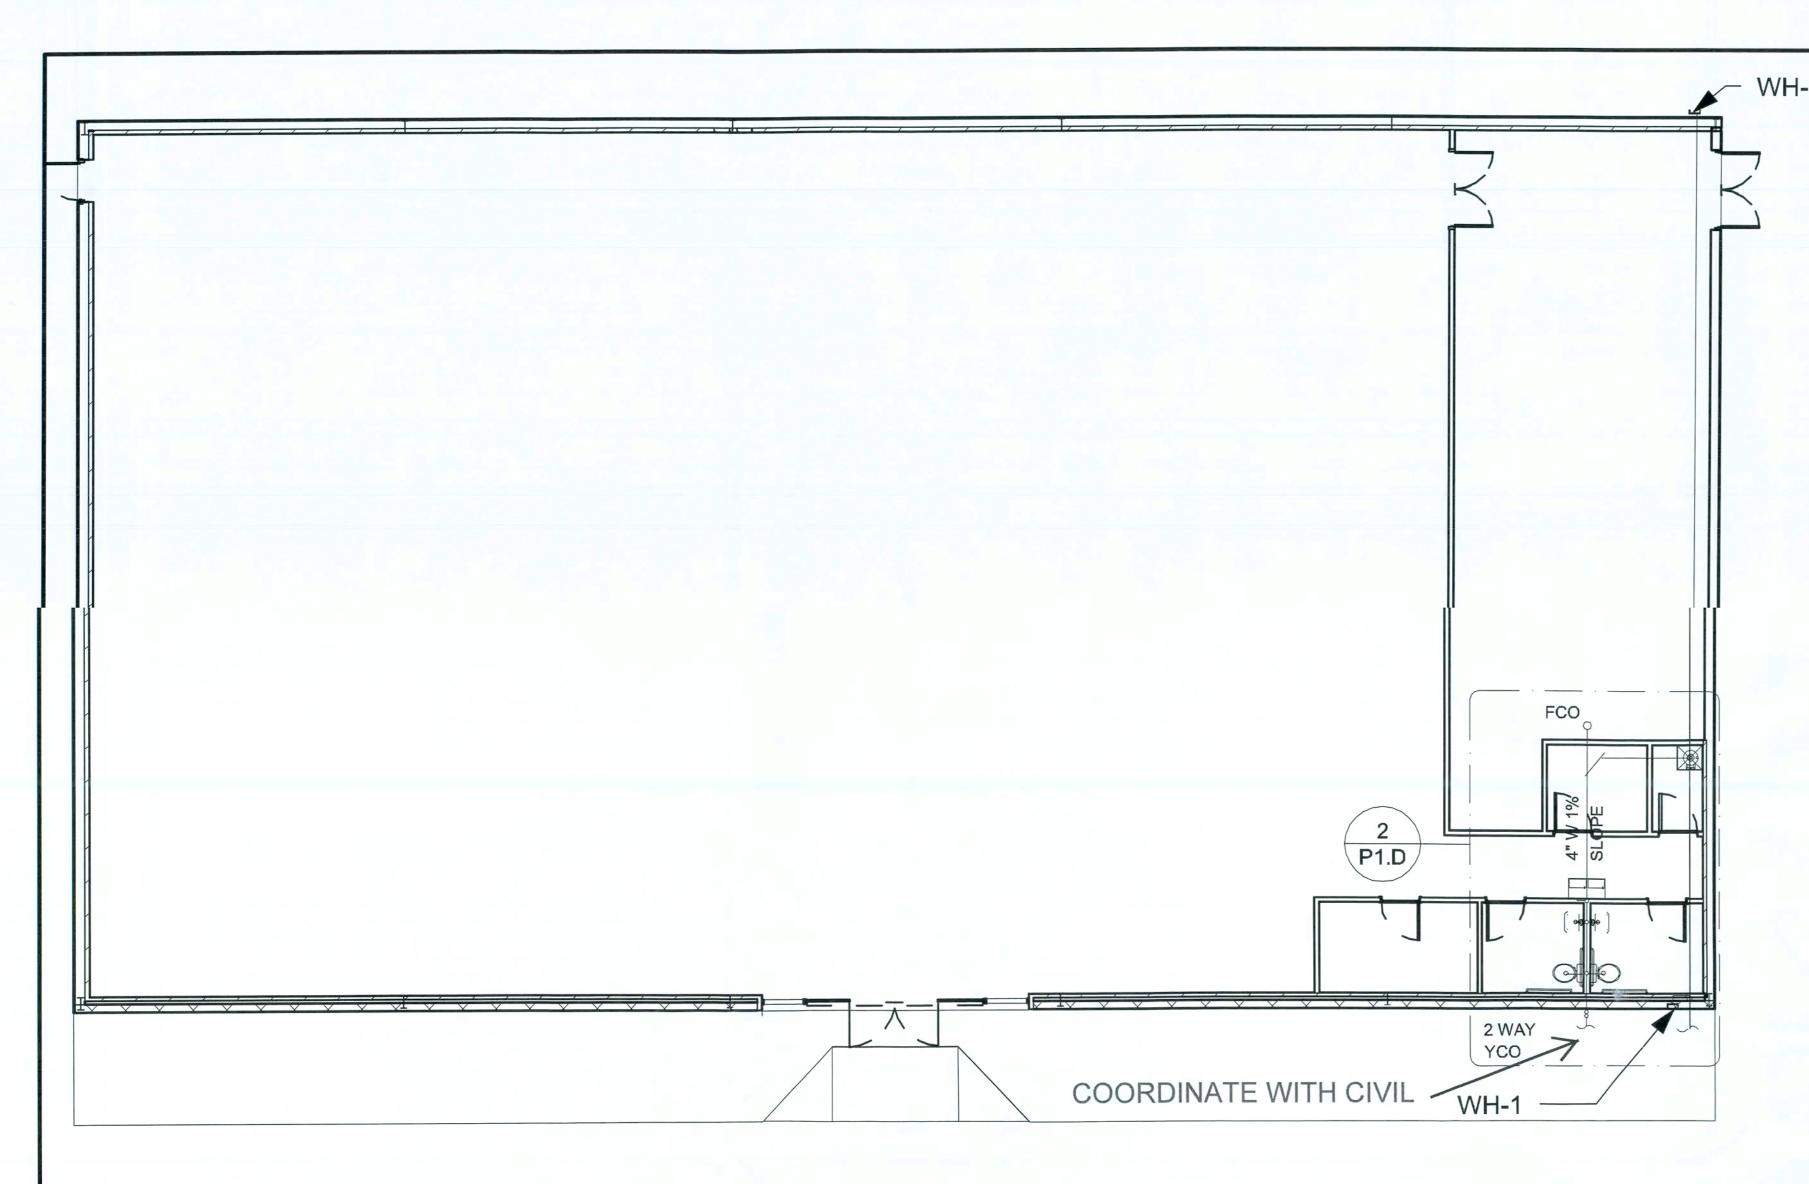

PLUMBING PLANS & SCHEDULE OPTION "D"


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SHEET NUMBER

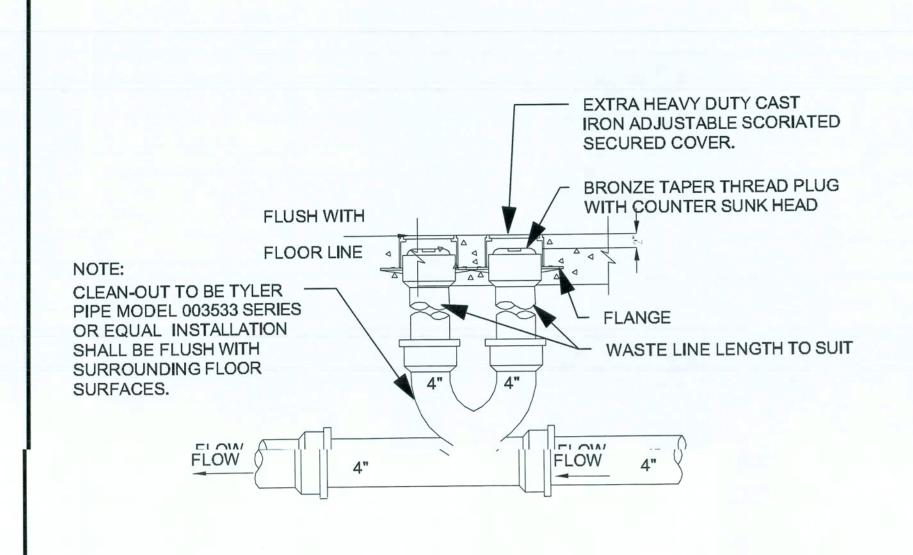

THIS DETAIL USED FOR 4" SANITARY LINE RUN BELOW FIXTURE RACKING. SEE PLANS.


2-WAY YARD CLEAN-OUT DETAIL 1/4" = 1'-0"

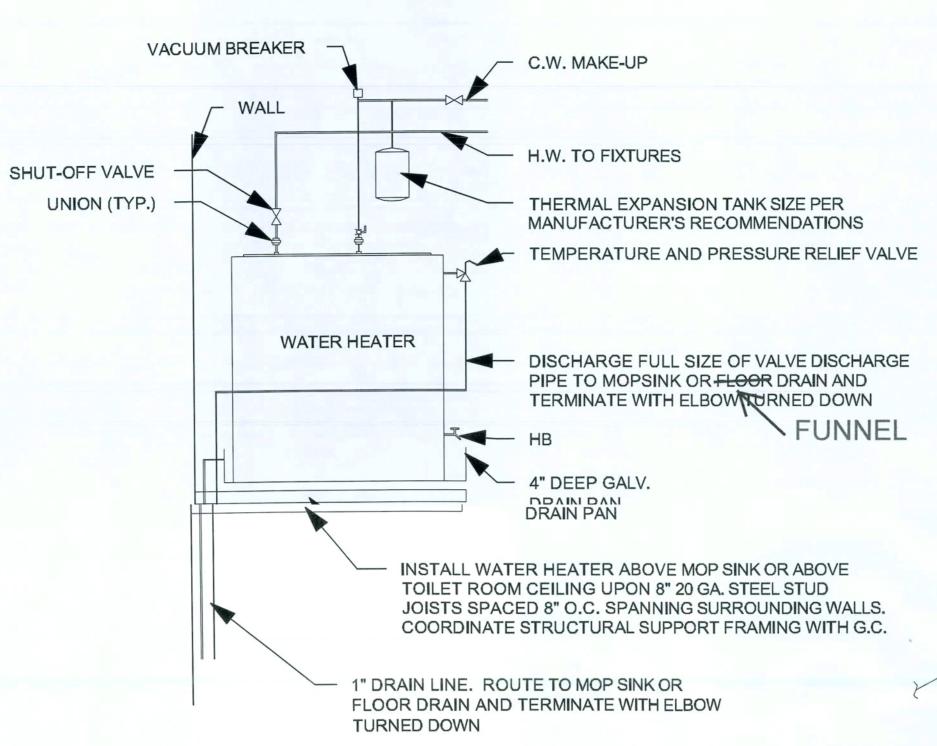

WATER HEATER "EWH-1" & "EWH-2" DETAIL

1/2" = 1'-0"

PROVIDE CLEANOUT WITH ADJUSTABLE CLEANOUT TOP WITH VARIATIONS SUITABLE FOR FLOOR COVERING (CARPET MARKER, RECESSED FOR TILE, SCORIATED FOR UNFINISHED FLOORS). CLEAN THE TOP OF EXPOSED FCO AFTER INSTALLATION.

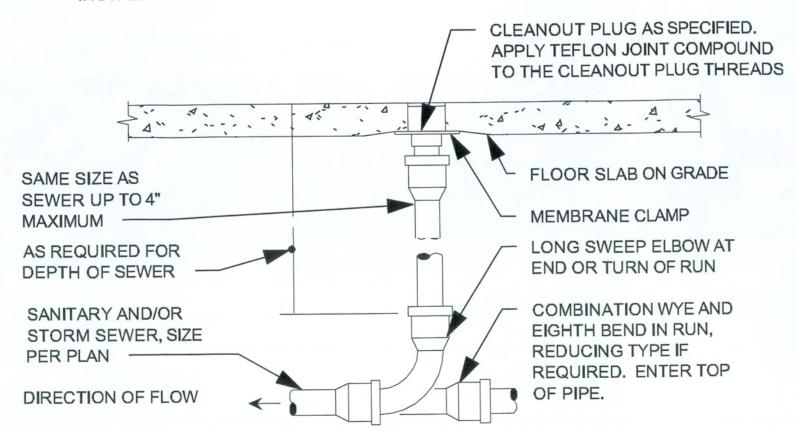


WHERE SHOWN ON PLANS AND RISERS. PROVIDE BACKFILL PER


IS 18" CLEAR AROUND, FOR ACCESSIBILITY. CONSULT LOCAL STATE OF THE REQUIREMENTS. Concept Construction
Date: 2/2/09

FLOOR CLEAN OUT DETAIL

1 1/2" = 1'-0"

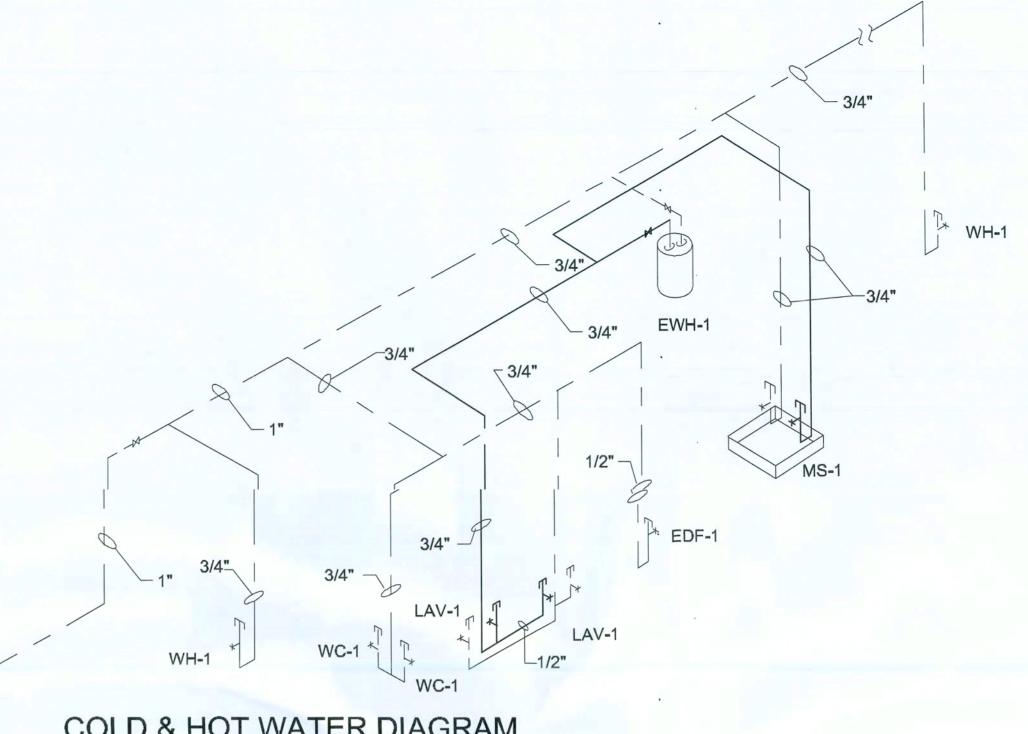

COLD & HOT WATER DIAGRAM SEE SHEET P1.D FOR PLUMBING DEVICE CODES

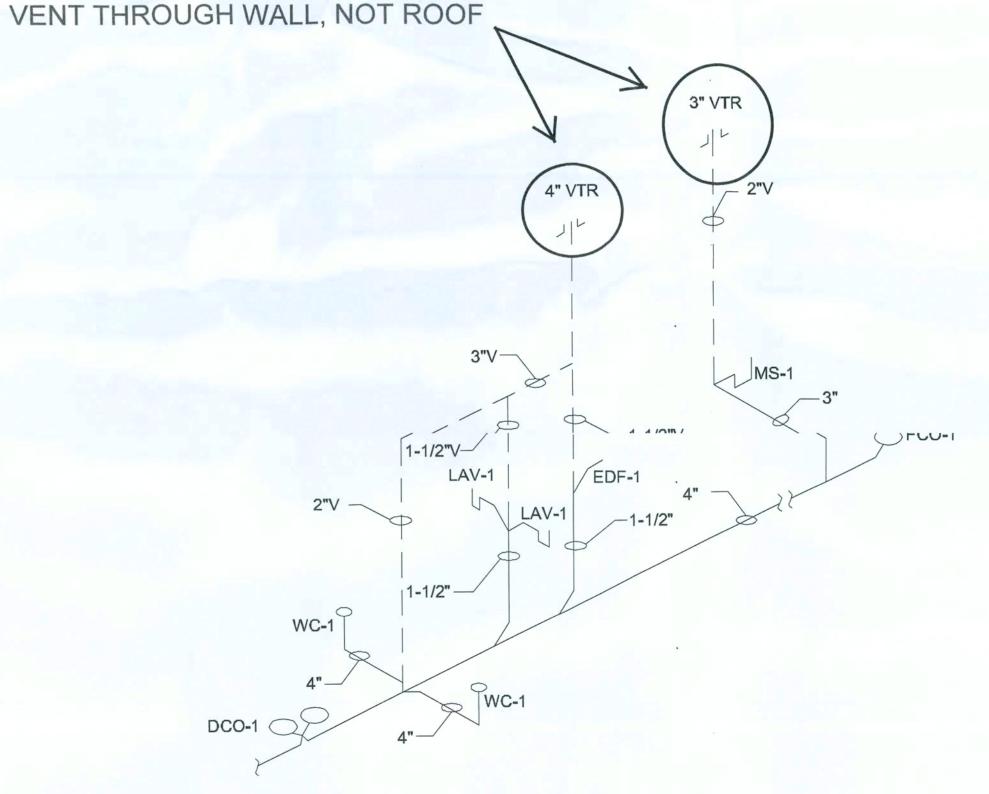

SANITARY & VENT DIAGRAM SEE SHEET P1.D FOR PLUMBING DEVICE CODES

PLUMBING DETAILS & RISER DIAGRAMS OPTION "D"

ST. LOUIS, MO 63127

DATE

05/19/08

SHEET NUMBER

P2.D

ANCHOR BOLT / FOUNDATION SIZIIG:

THE ANCHOR BOLT DIAMETERS AND DEVELOPED LENGTHS INDICIED IN THIS DRAWING WERE DETERMININED USING SHEAR FRICTION THEOR AS DESCRIBED IN AISC DESIGN GUIDE No.7, SECTION 9.2, ASSUMING AI ANCHOR BOLT MATERIAL OF ASTM A301 OR A36. THE COMBINED ORCES ACTING AT THE BASE OF THE STEEL FRAME RESULTING IN A VERTIAL REACTION ACTING UPON THE FOUNDATION WERE DEVELOPED AS PLLOWS:

T = Td + Tsf

WHERE

T = TOTAL TENSILE FORCE PER BOLT

Td = TENSILE FORCE PER BOLT DUE TO DIRECTLY APPLIED. LOD = PN Tof = TENSILE FORCE PER BOLT DUE TO SHEAR FRICTION = V / (X u)

P = P = TOTAL UPLIFT TO BE RESISTED BY ANCHOR BOLT GROP Y = Y = TOTAL SHEAR FORCE TO BE RESISTED BY ANCHOR BCT GROUP


n = n = NUMBER OF ANCHOR BOLTS

u = u = COEFFICIENT OF FRICTION (TAKEN AS Ø.7 FOR UNGROUTD BASE PLATES OR 0.9 FOR GROUTED BASE PLATES)

Foundation PLAN

SCALE: 1/8" = 1'-0"

REFER TO THE METAL BUILDING SHOP DRAWINGS FORALL DETAILS AND INFORMATION REGARDING ANCHOR BOIL PLACEMENT NUMBER, DIAMETER, ARRANGEMENT, ORIENTATIOS AND SOFORTH. METAL BUILDING MANUFACTURERS ENGINEERED SHOFDRAWINGS SHALL HAVE PRECEDENCE OVER THESE DRAWINGS.

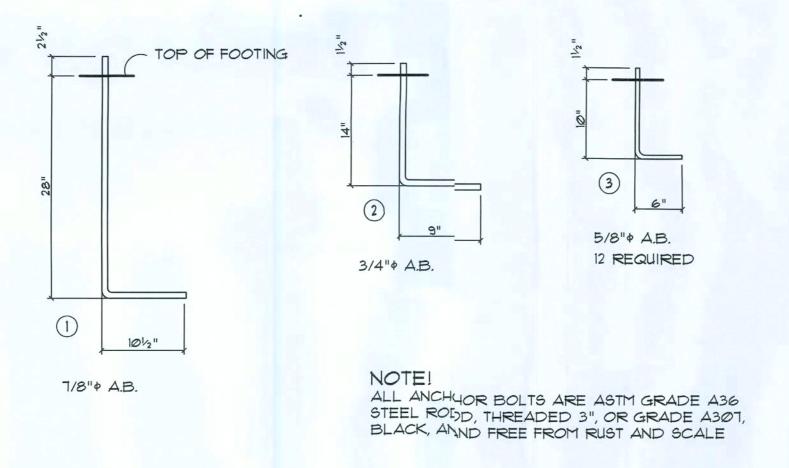

Anchor Bolt DETALLS

SCALE: 1" = 1'-0"

ALL DOOR/ENTRY OPENINGS INDICATED ARE NET; T SIZE AND REQUIRE 2 *3 ANCHOR BOLTS AT EACH SIDE OF THE OPENING REFER TO METAL BUILDING SHOP DRAWINGS FOR R DETAIL

GENERAL STRUCTURAL NOTES

GENERAL:

I. THE DRAWINGS ARE INTENDED TO SHOW THE GENERAL ARRANGEMENT DESIGN AND EXTENT OF THE WORK AND ARE PARTIALLY DIAGRAMMATIC. THEY ARE NOT INTENDED TO BE SCALED FOR ROUGH-IN MEASUREMENTS, OR TO SERVE AS SHOP DRAWINGS OR PORTIONS THEREOF.

. ALL DETAILS AND SECTIONS SHOWN ON THE DRAWINGS ARE INTENDED TO BE TYPICAL AND SHALL BE CONSTRUED TO APPLY TO ANY SIMILAR SITUATION ELSEWHERE ON THE PROJECT, EXCEPT WHERE A DIFFERENT DETAIL

3. PRIOR TO START OF CONSTRUCTION, THE CONTRACTOR AND ALL THE SUBCONTRACTORS SHALL VERIFY ALL GRADES, LINES, LEVELS, DIMENSIONS AND COORDINATE EXISTING CONDITIONS AT THE JOB SITE WITH THE PLANS AND SPECIFICATIONS. THEY SHALL REPORT ANY INCONSISTENCIES OR ERRORS IN THE ABOVE TO THE ARCHITECT/ENGINEER BEFORE COMMENCING WORK, THE CONTRACTOR AND HIS SUBCONTRACTORS SHALL LAY OUT THEIR WORK FROM ESTABLISHED REFERENCE POINTS AND BE RESPONSIBLE FOR ALL LINES, ELEVATIONS AND MEASUREMENTS IN CONNECTION WITH THEIR WORK.

4. IF ANY ERRORS OR OMISSIONS APPEAR IN THE DRAWINGS, GENERAL NOTES OR OTHER DOCUMENTS, THE CONTRACTOR SHALL NOTIFY THE ARCHITECT IN WRITING OF SUCH OMISSION OR ERROR PRIOR TO PROCEEDING WITH ANY WORK WHICH APPEARS IN QUESTION. IN THE EVENT OF THE CONTRACTOR'S FAILING TO GIVE SUCH AN ADVANCED NOTICE, HE SHALL BE HELD RESPONSIBLE FOR THE RESULTS OF ANY SUCH ERRORS OR OMISSIONS AND THE COST OF RECTIFYING THE SAME.

5. THE CONTRACTOR SHALL USE THE STRUCTURAL DRAWINGS AND SPECIFICATIONS TOGETHER WITH THE ARCHITECTURAL, MECHANICAL, ELECTRICAL AND OTHER TRADE DRAWINGS AND SHOP DRAWINGS, TO LOCATE DEPRESSED SLABS, SLOPES, DRAINS, OUTLETS, RECESSES, OPENINGS, BOLT SETTING, SLEEVES, DIMENSIONS, ETC. NOTIFY ARCHITECT/ENGINEER, IN WRITING, OF ANY POTENTIAL CONFLICTS BEFORE PROCEEDING WITH THE

SHOP DRAWINGS AND DELEGATED ENGINEERING:

ALL SHOP DRAWINGS SHALL BE SUBMITTED FOR ARCHITECT'S REVIEW ONLY AFTER THEY HAVE BEEN THOROUGHLY REVIEWED BY THE CONTRACTOR FOR CONSTRUCTION METHODS, DIMENSIONS AND OTHER TRADE REQUIREMENTS, AND STAMPED WITH THE CONTRACTOR'S APPROVAL STAMP. THE ARCHITECT ASSUMES NO RESPONSIBILITY FOR DIMENSIONS, QUANTITIES, ENGINEERING DESIGN BY DELEGATED ENGINEERS, ERRORS OR OMISSIONS AS A RESULT OF REVIEWING ANY SHOP DRAWINGS. ANY ERRORS OR OMISSIONS MUST BE MADE GOOD BY THE CONTRACTOR, IRRESPECTIVE OF RECEIPT, CHECKING OR REVIEW OF DRAWINGS BY THE ENGINEER AND EVEN THOUGH WORK IS DONE IN ACCORDANCE WITH SUCH DRAWINGS.

2. BEFORE STRUCTURAL INSPECTIONS CAN BE MADE ON A PORTION OF THE STRUCTURE, ALL RELATED SHOP DRAWINGS, DELEGATED ENGINEERING, PRODUCT APPROVAL, MANUFACTURER'S DATA AND OTHER RELATED INFORMATION, MUST BE REVIEWED AND ACCEPTED BY THE ARCHITECT-OF-RECORD AND APPROVED BY THE BUILDING DEPARTMENT.

3. SHOP DRAWINGS SHALL CONTAIN ALL INFORMATION SHOWN ON THE STRUCTURAL PLANS (RELATED TO THE DELEGATED DESIGN) INCLUDING ALL DESIGN LOADS, IN ADDITION TO THE INFORMATION REQUIRED BY THE DELEGATED ENGINEER'S DESIGN.

4. ARCHITECT WILL REVIEW ALL SUBMITTED SHOP DRAWINGS, PREPARED AND SIGNED AND SEALED BY THE CONTRACTOR'S DELEGATED ENGINEER, ONLY FOR GENERAL COMPLIANCE WITH THE DESIGN INTENT, REQUIRED LOADING AND COORDINATION WITH THE STRUCTURAL DESIGN.

5. CONTRACTOR SHALL SUBMIT TO THE ARCHITECT TWO SETS OF BLUE PRINTS OF THE STRUCTURAL SHOP DRAWINGS FOR ARCHITECT REVIEW. BEFORE STARTING FABRICATION. THE ARCHITECT WILL RETURN ONE MARKED UP AND STAMPED COPY TO THE CONTRACTOR. THE MARKED-UP COPY SHALL BE USED TO MAKE THE PRINTS REQUIRED FOR SHOP DRAWING DISTRIBUTION.

CONSTRUCTION MEANS AND METHODS:

. THE CONSTRUCTION MEANS, METHODS, TECHNIQUES, SEQUENCE OR PROCEDURES, SAFETY PRECAUTIONS, SHORES, RESHORES, LATERAL BRACING AND PROGRAMS IN CONNECTION WITH THE PROJECT, ARE THE SOLE RESPONSIBILITY OF THE CONTRACTOR. OUR SERVICES DO NOT GUARANTE! NOR ASSURE LIABILITY FOR THE JOB SAFETY, TEMPORARY SHORING AND BRACING AND THE PERFORMANCE OF THE CONTRACTOR.

2. THE CONTRACTOR IS RESPONSIBLE AND SHALL COMPLY WITH THE SAFETY REQUIREMENTS OF THE 2004 FLORIDA BUILDING CODE AND APPLICABLE LOCAL, STATE AND FEDERAL LAWS.

SAFETY, STRUCTURAL STABILITY AND FOR THE PROPER EXECUTION OF THE WORK. REMOVE WHEN WORK IS COMPLETED. 4. PROVIDE AND MAINTAIN GUARD LIGHTS AT ALL BARRICADES,

RAILINGS, OBSTRUCTIONS IN THE STREETS, ROADS OR SIDEWALKS AND ALL TRENCHES OR PITS ADJACENT TO PUBLIC WALKS OR ROADS. 5. AT ALL TIMES, PROVIDE PROTECTION AGAINST WEATHER (RAIN,

3. PROVIDE ALL SHORING, BRACING AND SHEETING AS REQUIRED FOR

WIND, STORMS OR THE SUN), SO AS TO MAINTAIN ALL WORK, MATERIALS. APPARATUS AND FIXTURES FREE FROM INJURY OR DAMAGE. 6. AT THE END OF THE DAYS WORK, COVER ALL WORK LIKELY TO BE DAMAGED. ANY WORK DAMAGED BY FAILURE TO PROVIDE PROTECTION SHALL

BE REMOVED AND REPLACED WITH NEW WORK AT THE CONTRACTOR'S

7. THE CONTRACTOR SHALL PAY FOR ALL DAMAGES TO ADJACENT STRUCTURES, SIDEWALKS AND TO STREETS OR OTHER PUBLIC PROPERTY OR

STRUCTURAL DESIGN CRITERIA:

I. THE DESIGN COMPLIES WITH THE REQUIREMENTS OF THE 2004 FLORIDA BUILDING CODE - SECTION 1609 AND OTHER REFERENCED CODES AND SPECIFICATIONS. ALL CODES AND SPECIFICATIONS SHALL BE LATEST EDITION AT TIME OF PERMIT.

2. WIND LOAD CRITERIA:

SUPERIMPOSED LIVE LOADS:

BASED ON ANSI/ASCE 7-97. BASIC WIND VELOCITY 110 MPH,

3 ROOF DESIGN LOADS: SUPERIMPOSED DEAD LOADS: . SUPERIMPOSED LIVE LOADS: . . . 4. FLOOR DESIGN LOADS: SUPERIMPOSED DEAD LOADS: 25 PSF

. 40 PSF RESIDENTIAL BALCONIES . 60 PSF 5. WIND NET UPLIFT: ARE AS INDICATED ON PLANS

I. FOUNDATIONS ARE DESIGNED TO BEAR ON WELL COMPACTED GRADE OR CLEAN FILL OF AN ALLOWABLE BEARING CAPACITY OF 1,000 PSF MINMUM. FOR REQUIRED SOIL BEARING CAPASITIES GREATER THAN 1,000 PSF, A CERTIFIED TESTING LABORATORY SHALL BE ENGAGED BY THE OWNER TO VERIFY THAT THE REQUIRED BEARING CAPACITY WAS OBTAINED. SAID SOIL CAPACITY SHALL BE CERTIFIED AND TESTED BY A FLORIDA REGISTERED FOUNDATION ENGINEER, PRIOR TO CASTING OF CONCRETE IN

2. NATURAL GRADE (OR FILL) BELOW FOOTINGS SHALL BE COMPACTED TO 98 % MODIFIED PROCTOR (ASTM D-1557).

FOUNDATIONS: (SPREAD FOOTINGS)

3. TOP OF WALL FOOTINGS TO BE AT THE SAME ELEVATION AS TOP OF COLUMN PAD FOOTINGS. STEP WALL FOOTING FROM HIGHER COLUMN FOOTING TO THE LOWER ONE (AS DETAILED ON THE PLANS).

4. BOTTOM OF ALL FOOTINGS TO BE A MINIMUM 1'-6" BELOW THE TOP OF CONCRETE SLAB ON GRADE (UNLESS OTHERWISE NOTED) OR MINIMUM 1'-0" BELOW FINISHED GRADE, WHICHEVER IS LOWER. IN THE EVENT THAT THE SLAB STEPS ON EACH SIDE OF THE FOOTING, THE FOOTING SHALL BE 1'-6" BELOW TOP OF THE LOWER SLAB.

5. REINFORCING IN THE CONTINUOUS WALL FOOTINGS (MONOLITHIC AND NON-MONOLITHIC) SHALL BE SPLICED 40 BAR DIAMETERS MINIMUM AND SHALL EXTEND CONTINUOUSLY THRU ALL FOOTING PADS.

6. ALL LONGITUDINAL REBARS IN THE CONTINUOUS WALL FOOTINGS, SHALL BE CONTINUED AT BENTS AND CORNERS BY BENDING THE REBARS 48 BAR DIAMETERS AROUND THE CORNERS OR ADDING MATCHING CORNER BARS, EXTENDING 48 BAR-DIAMETERS INTO FOOTING EACH SIDE OF CORNER OR BENT.

ALL FOOTINGS SHALL BE 12^{II} MINIMUM THICKNESS.

CONCRETE SLABS ON GRADE:

. ALL INTERIOR AND EXTERIOR SLABS AND WALKWAYS AS SHOWN ON THE STRUCTURAL OR ARCHITECTURAL PLANS, SHALL BE FOUR INCHES THICK MINIMUM REINFORCED WITH 6 X 6 - WI.4 X WI.4 WELDED WIRE FABRIC (UNLESS OTHERWISE NOTED).

2. ALL SLABS ON GRADE TO BE CONSTRUCTED IN ACCORDANCE WITH LATEST A.C.I - "GUIDE FOR CONCRETE FLOOR AND SLAB CONSTRUCTION" (A.C.I.

3. JOINTS SHALL BE PROVIDED IN ALL INTERIOR SLABS ON GRADE AT LOC. INDICATED ON THE PLANS DIVIDING THE SLAB INTO SQUARE PANELS NOT TO EXCEED 20 X 20 FT. IN SIZE. CAST SLAB IN LONG ALTERNATE STRIPS. PROVIDE A CONTRACTION JOINT BETWEEN EACH STRIP. SEE PLAN FOR SAW-CUT, CONTRACTION AND ISOLATION JOINT DETAILS.

4. PROVIDE SAW-CUT JOINTS AT ALL SIDEWALKS AT A MAXIMUM SPACING OF FIVE FEET ON CENTERS AND ISOLATION JOINTS AT 20 FEET O.C.

5. FILL MATERIAL SHALL BE PLACED IN LIFTS NOT EXCEEDING 12" AND COMPACTED TO 98 % MODIFIED PROCTOR (ASTM D-1557) WITHIN A DISTANCE OF 3 FEET BEYOND ALL FOOTING EDGES. TAKE AT LEAST ONE DENSITY TEST FOR EACH 1,600 SQ.FT. OF AREA AND 12" BELOW SURFACE. SEND RESULTS OF THE TEST TO OWNER, ARCHITECT AND ENGINEER.

CONCRETE AND REINFORCING:

CONCRETE DESIGN AND REINFORCEMENT IN ACCORDANCE WITH "BUILDING CODE REQUIREMENTS FOR REINFORCED CONCRETE" (A.C.I. 318 -LATEST EDITION) AND WITH "DETAILS AND DETAILING OF CONCRETE REINFORCEMENT - (A.C.I. 315 - LATEST EDITION).

2. ALL CONCRETE WORK IN ACCORDANCE WITH "SPECIFICATIONS FOR STRUCTURAL CONCRETE FOR BUILDING" (A.C.I. 301 - LATEST EDITION). PRODUCTION OF CONCRETE, DELIVERY, PLACING AND CURING TO BE IN ACCORDANCE WITH "HOT WEATHER CONCRETING" (A.C.I. 305R - LATEST

3. ALL CONCRETE TO BE REGULAR WEIGHT WITH A DESIGN STRENGTH OF 3,000 P.S.I. AT 28 DAYS. MAXIMUM SLUMP 5".

4. ALL REINFORCING TO BE NEW BILLET STEEL CONFORMING TO THE LATEST A.S.T.M. A-615 GRADE 60, FABRICATED IN ACCORDANCE WITH C.R.S.I. MANUAL OF STANDARD PRACTICE AND PLACED IN ACCORDANCE WITH A.C.I. 315 AND C.R.S.I. MANUAL OF STANDARD PRACTICE.

5. CONCRETE COVER UNLESS OTHERWISE DETAILED ON DRAWINGS: FOOTINGS:

SLABS ON GRADE:

6. BEAM REINFORCEMENT: LAPPED 36 BAR DIAMETER OR MINIMUM 18 INCHES. BOTTOM BARS SPLICED ONLY AT SUPPORTS, TOP BARS SPLICED ONLY AT MID-SPAN. ALL TOP BARS HOOKED AT NONCONTINUOUS EDGES (U.O.N.). ALL HOOKS TO BE STANDARD 90 DEGREE HOOKS AS REQUIRED

(TOP \$ SIDES) 2

CENTERED W/SLAB

7. ADDED REINFORCEMENT: PROVIDE ADDITIONAL CORNER BARS BENT 36 INCHES MINIMUM EACH WAY AT "L" AND "T" CORNERS IN OUTER FACES OF ALL BEAMS TO MATCH ALL HORIZONTAL BAR (TOP, BOTTOM AND INTERMEDIATE REBARS).

8. SEE PLAN FOR MINIMUM SIZE CONCRETE TIE BEAM REQUIREMENTS.


REFER TO THE METAL BUILDING SHOP

DRAWINGS PREPARED BY BUTLER METAL BUILDINGS, INC., FOR EXACT LOCATION OF ALL EMBEDDED ANCHOR BOLTS.

ADDED FILL SHALL BE APPLIED IN 12" LIFTS -EA. LIFT SHALL BE CONPACTED TO 98% DRY COMPACTION PER THE "MODIFIED PROCTOR" METHOD.

THE DESIGN WIND SPEED FOR THIS PROJECT IS 110 MPH PER 2004 FBC 1609 AND LOCAL JURISDICTION REQUIREMENTS

ALL ANCHOR BOLTS ARE ASTM GRADE A36 STEEL ROD, THREADED 3 1/2", BLACK AND FREE FROM RUST AND SCALE

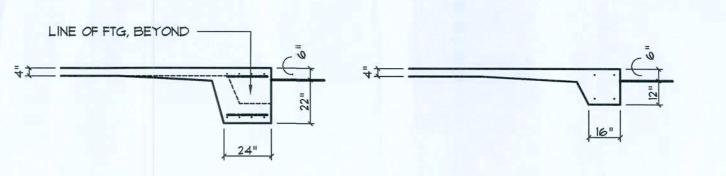

FOOTING @ MAIN FRAMES SCALE: 1/4" = 1'-0"

FOOTING @ SLAB EDGE

27 JAN 2009

REVISION:

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DATE: 24 DEC 2003 COMM

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SHEET: S.

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