

9/7/2012 12:42:20 AM

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08.07.12	PERMIT SET

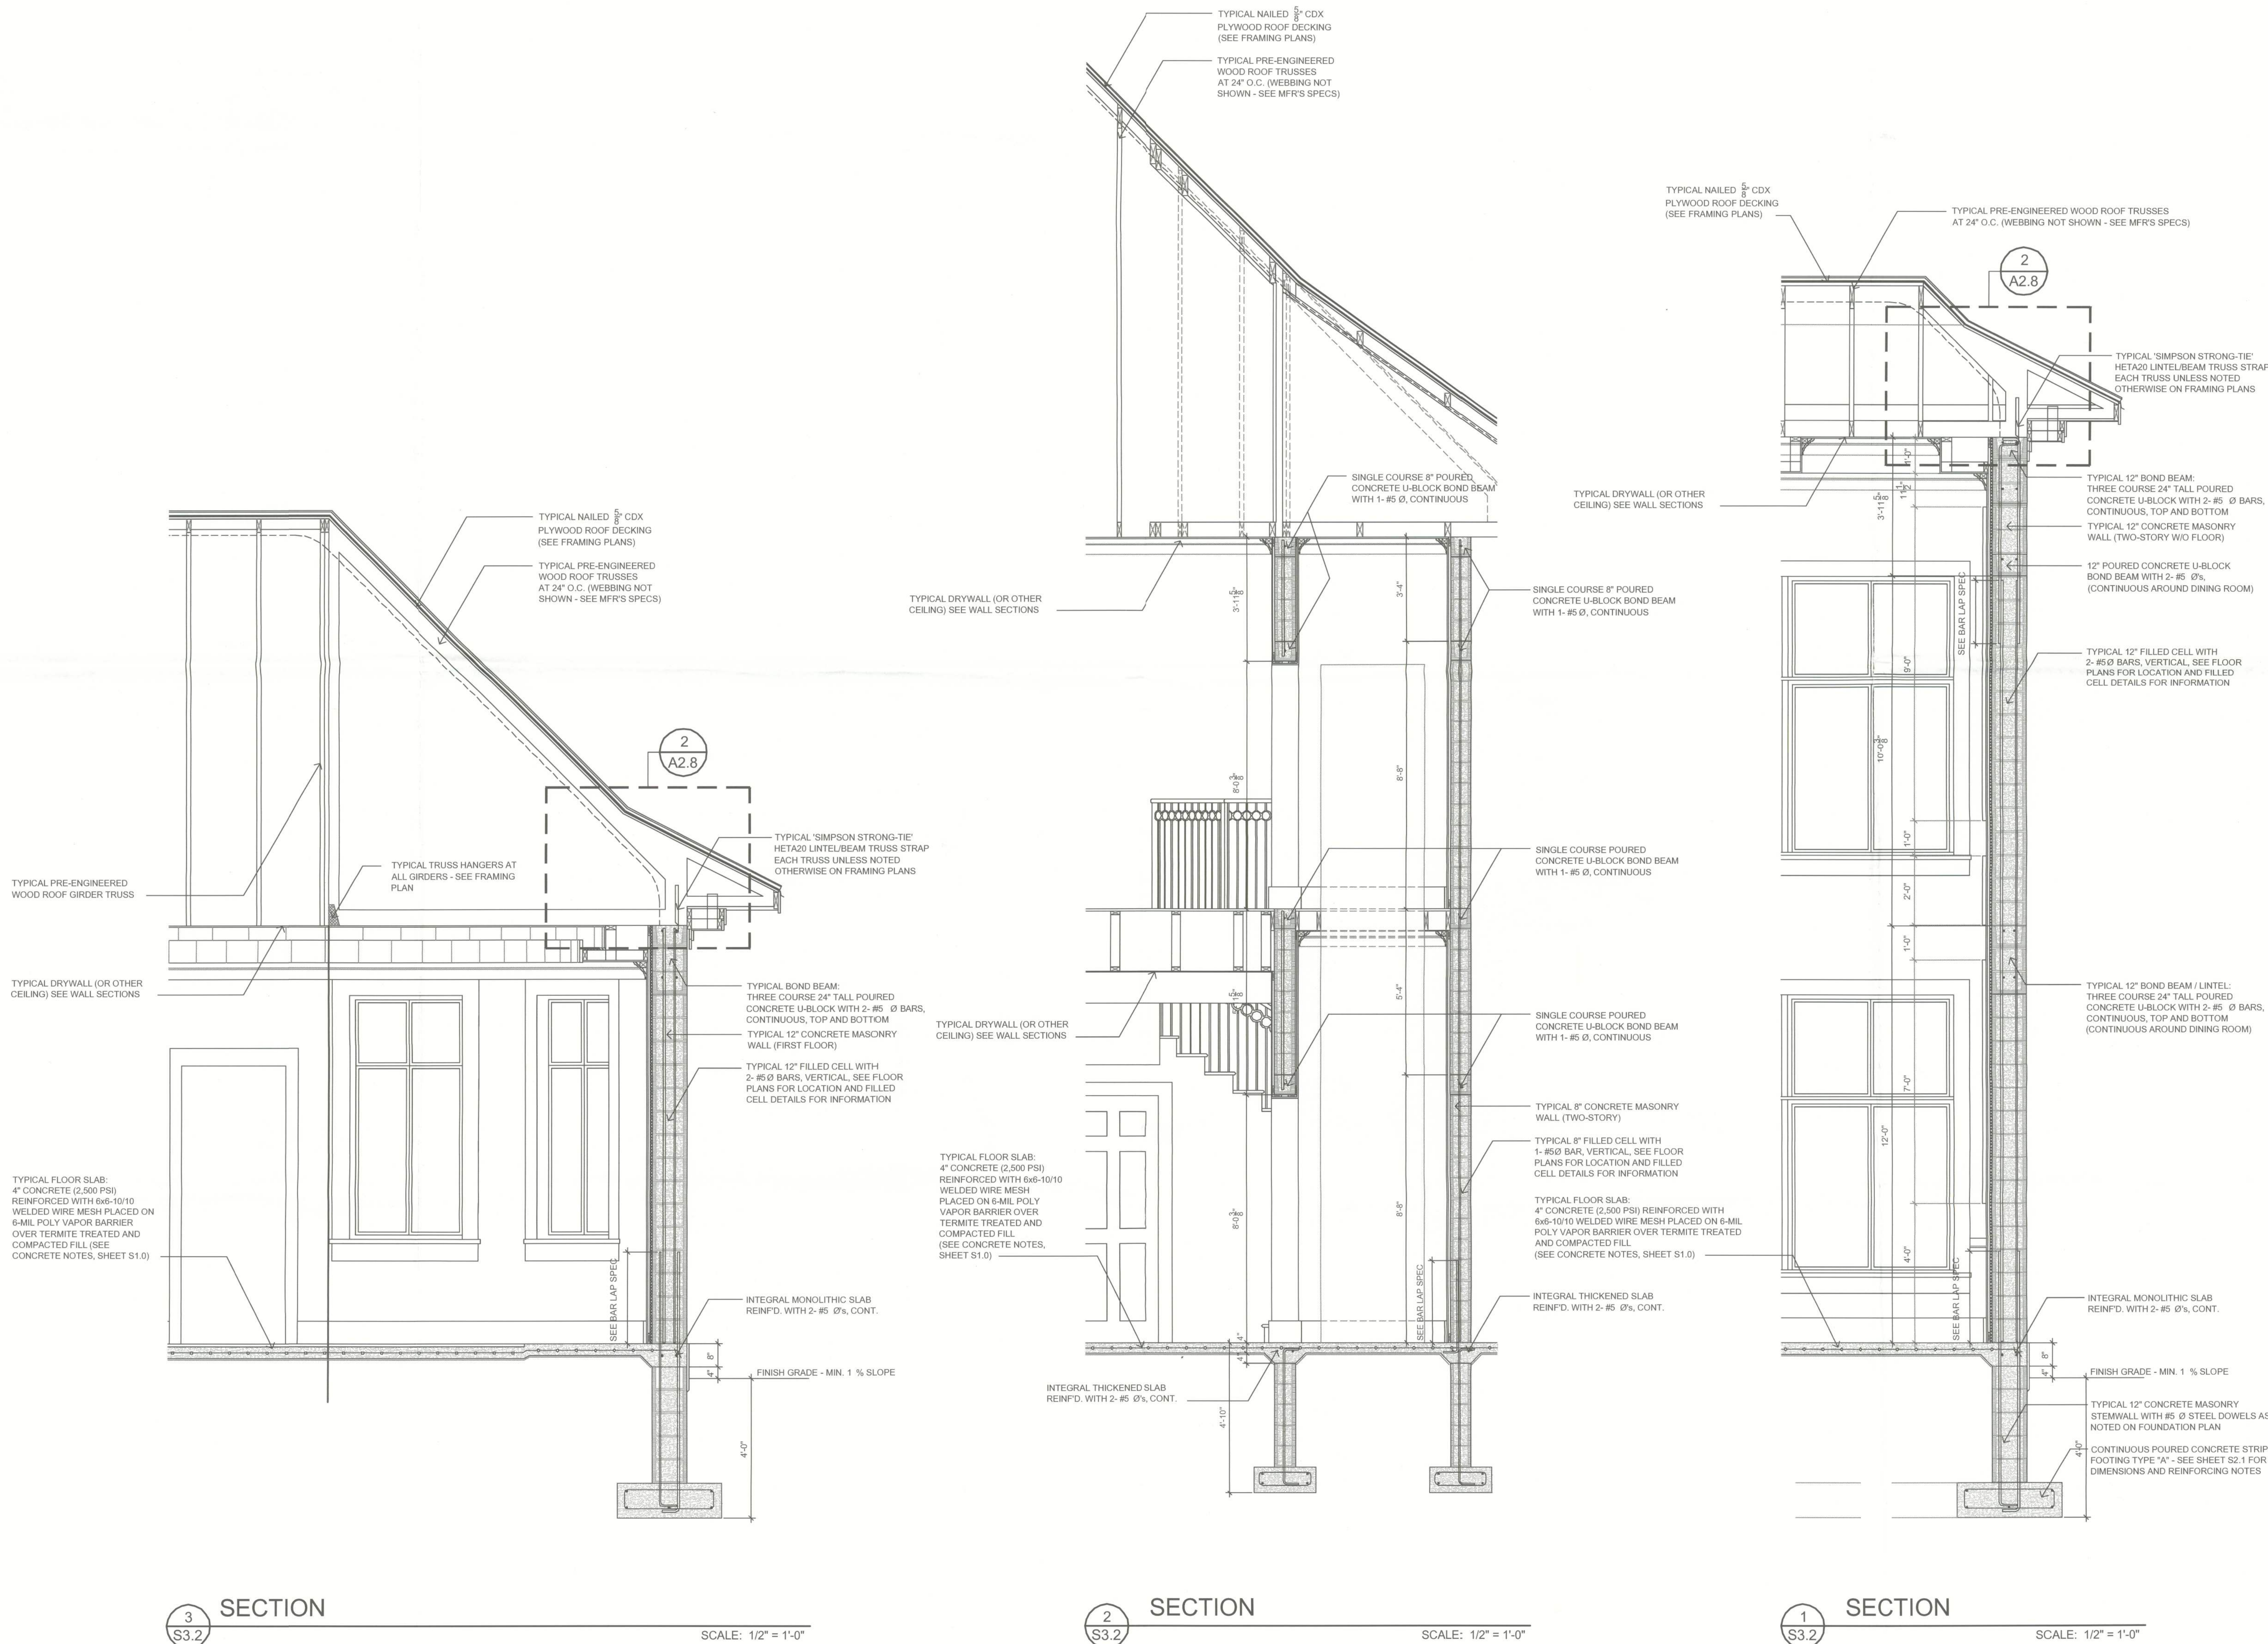
Ken Eilers P.E. # 18243

STRUCTURAL PLAN SERVICE, INC.
Post Office Box 940128
Maitland, FL 32754
Tel: (407) 945-6145
Fax: (407) 945-6141
Ken Eilers P.E. # 18243
LICENSED PROFESSIONAL ENGINEER

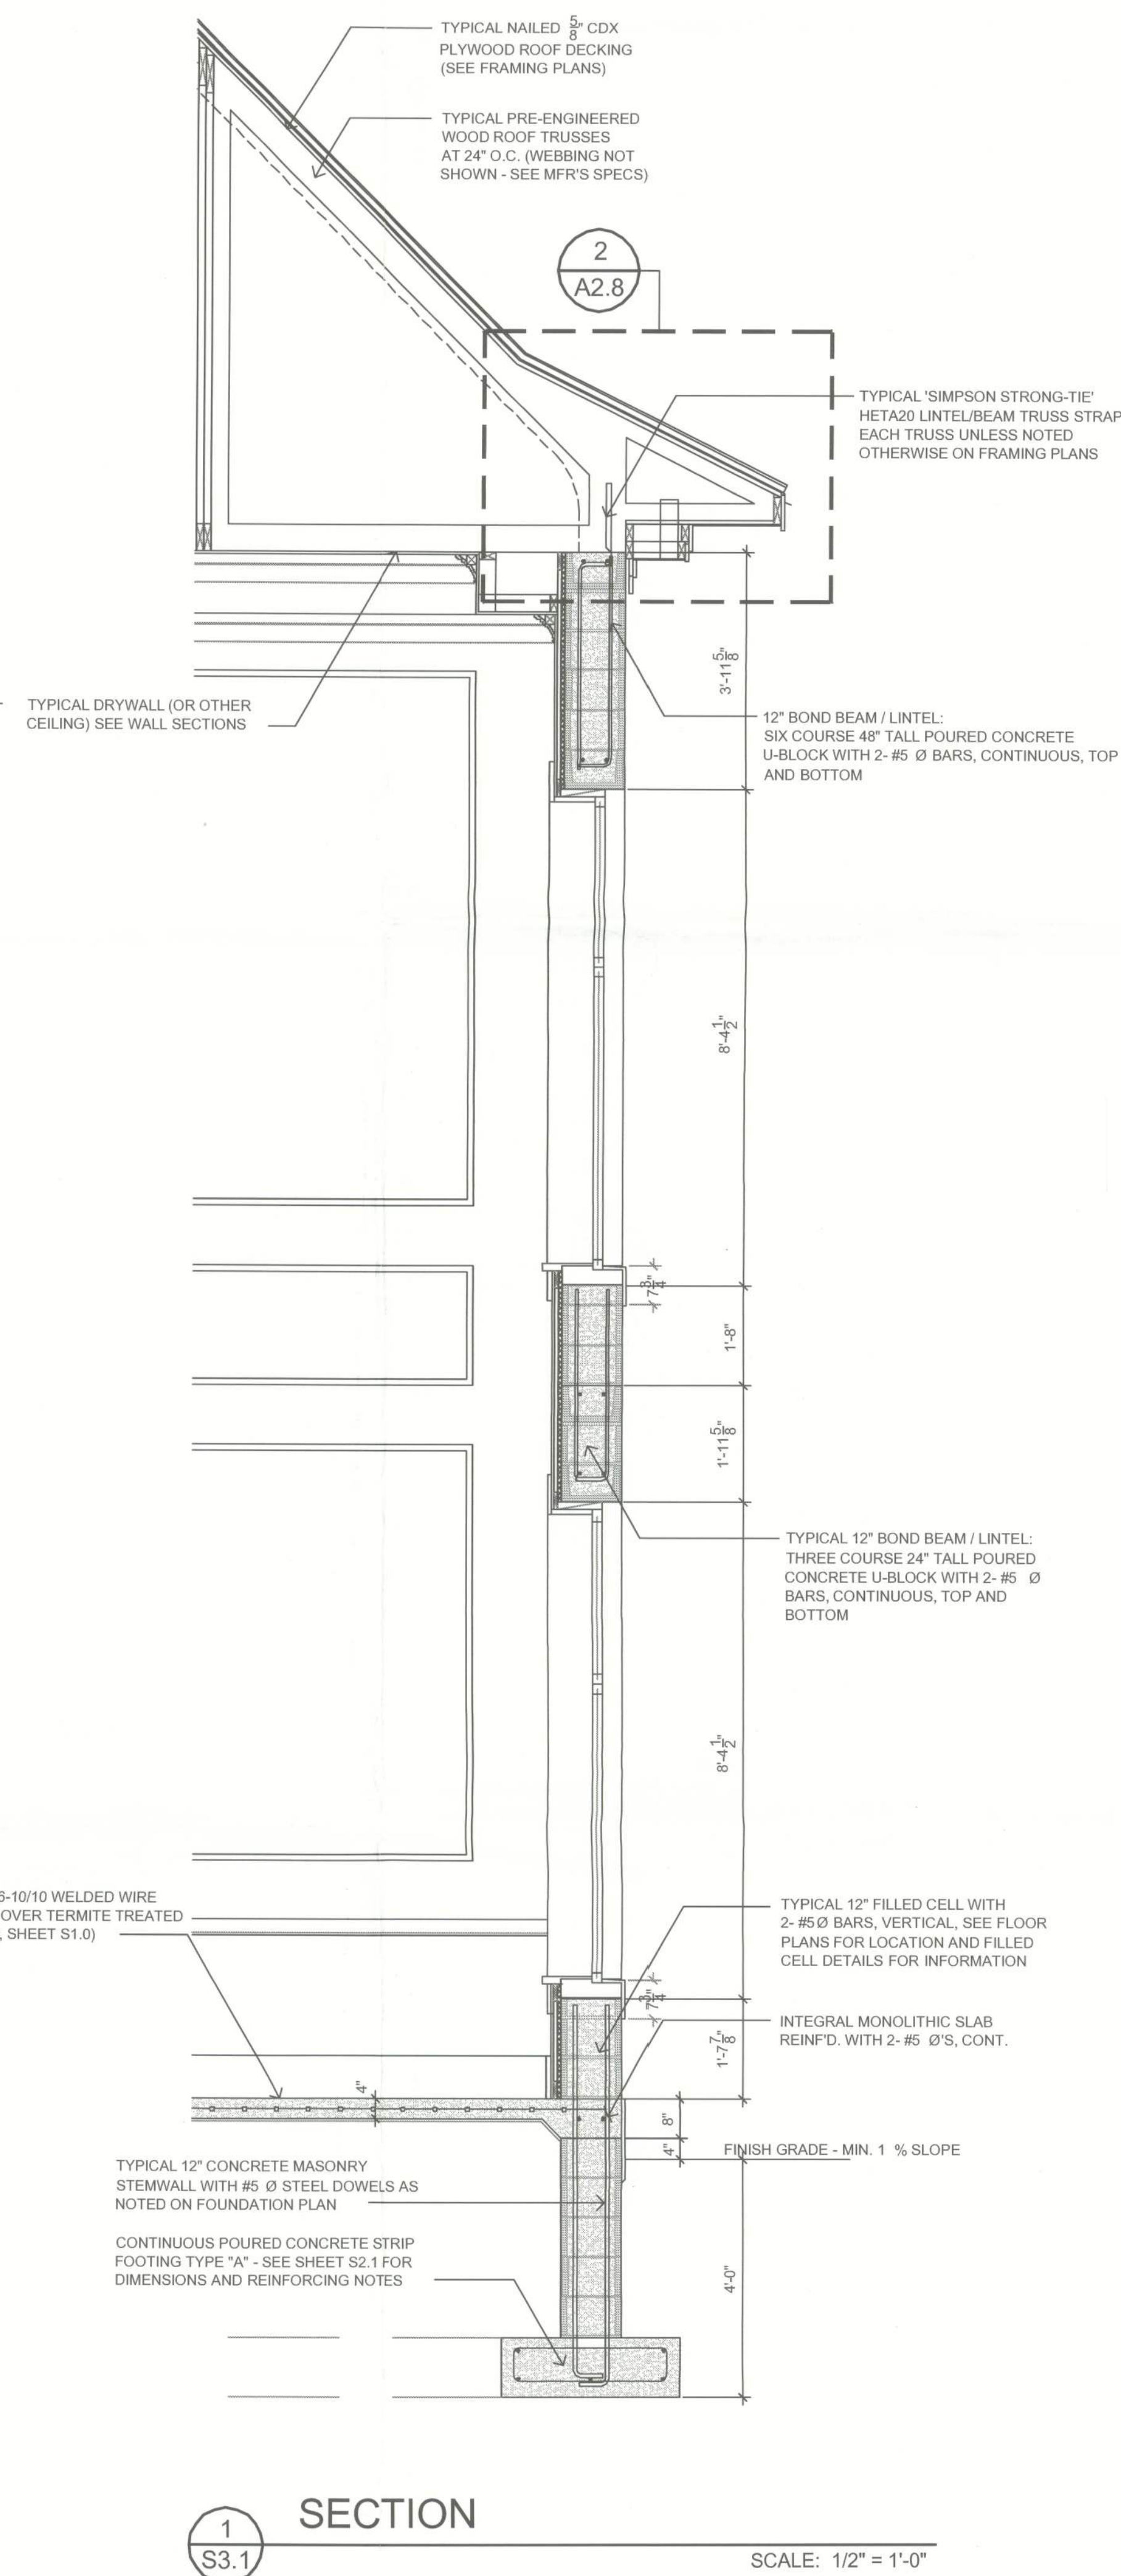
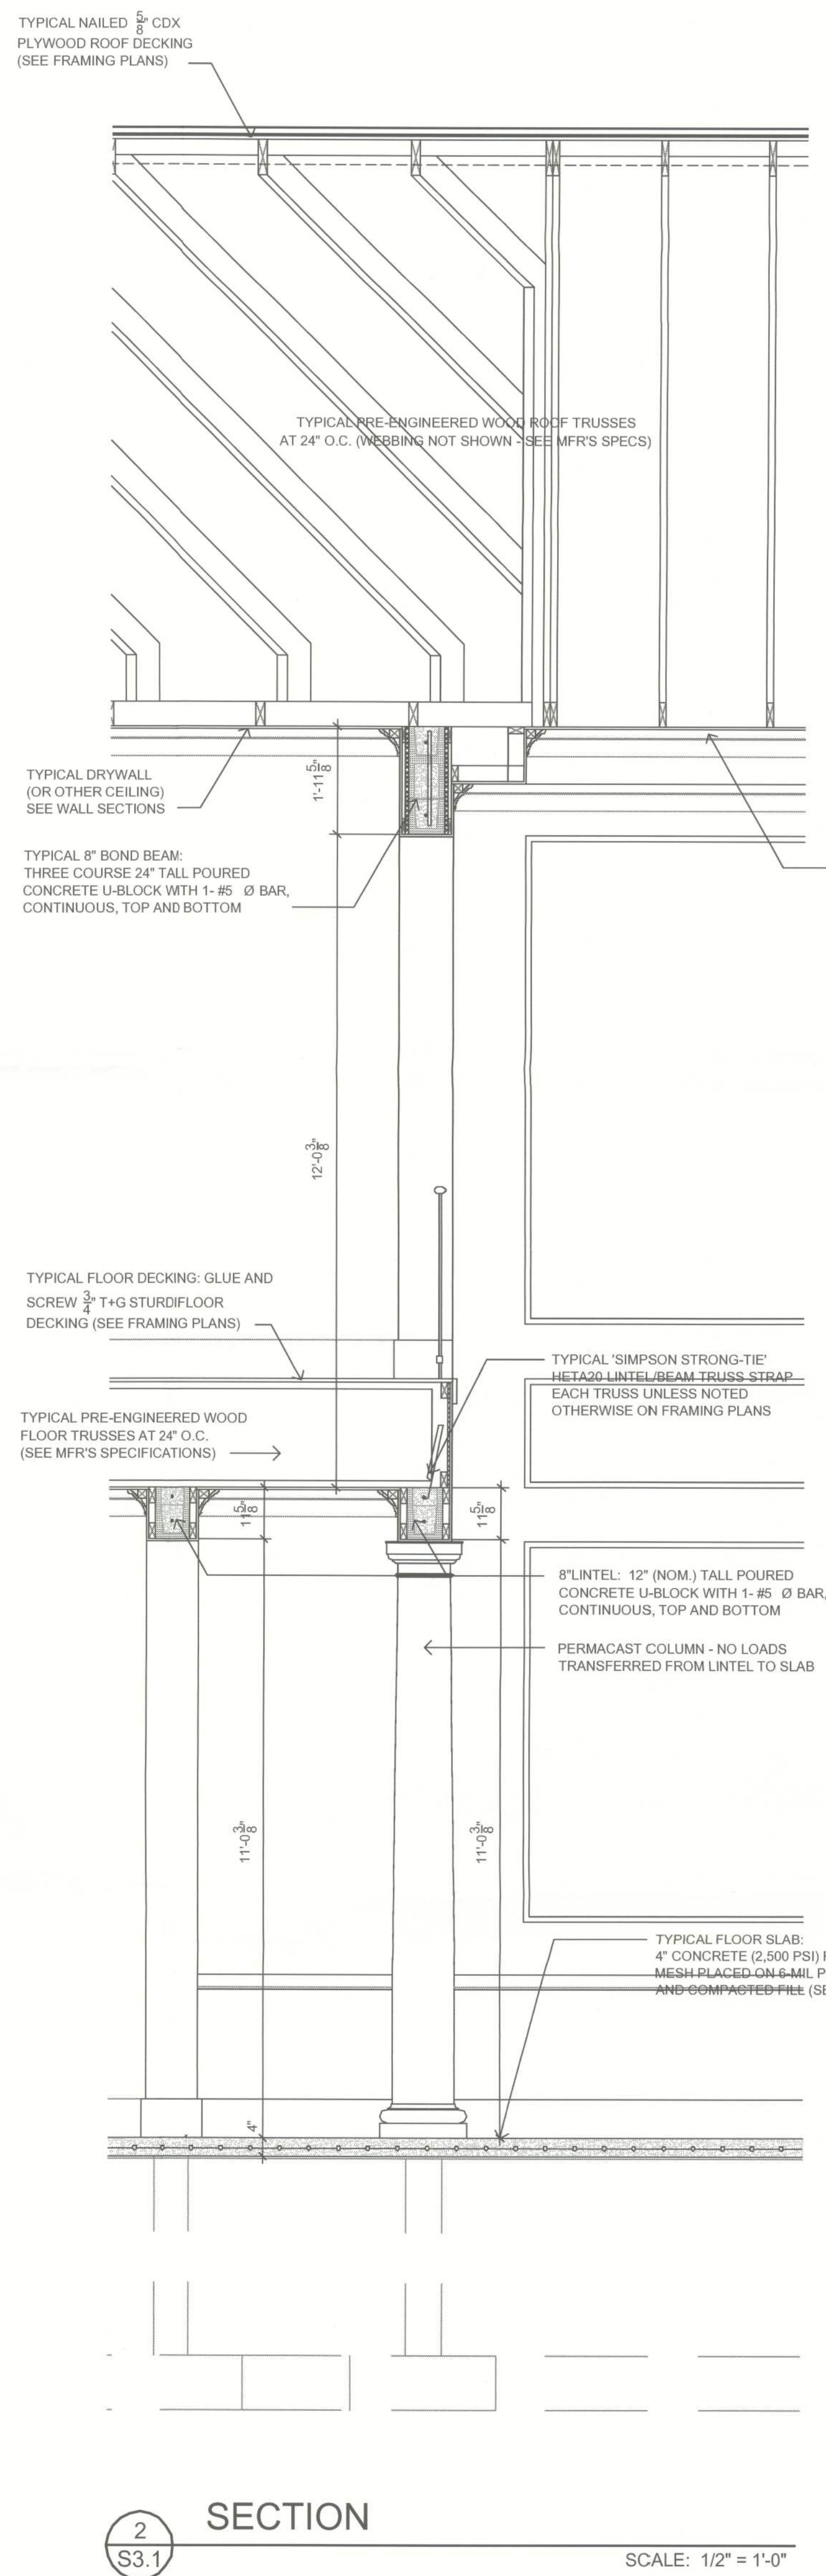
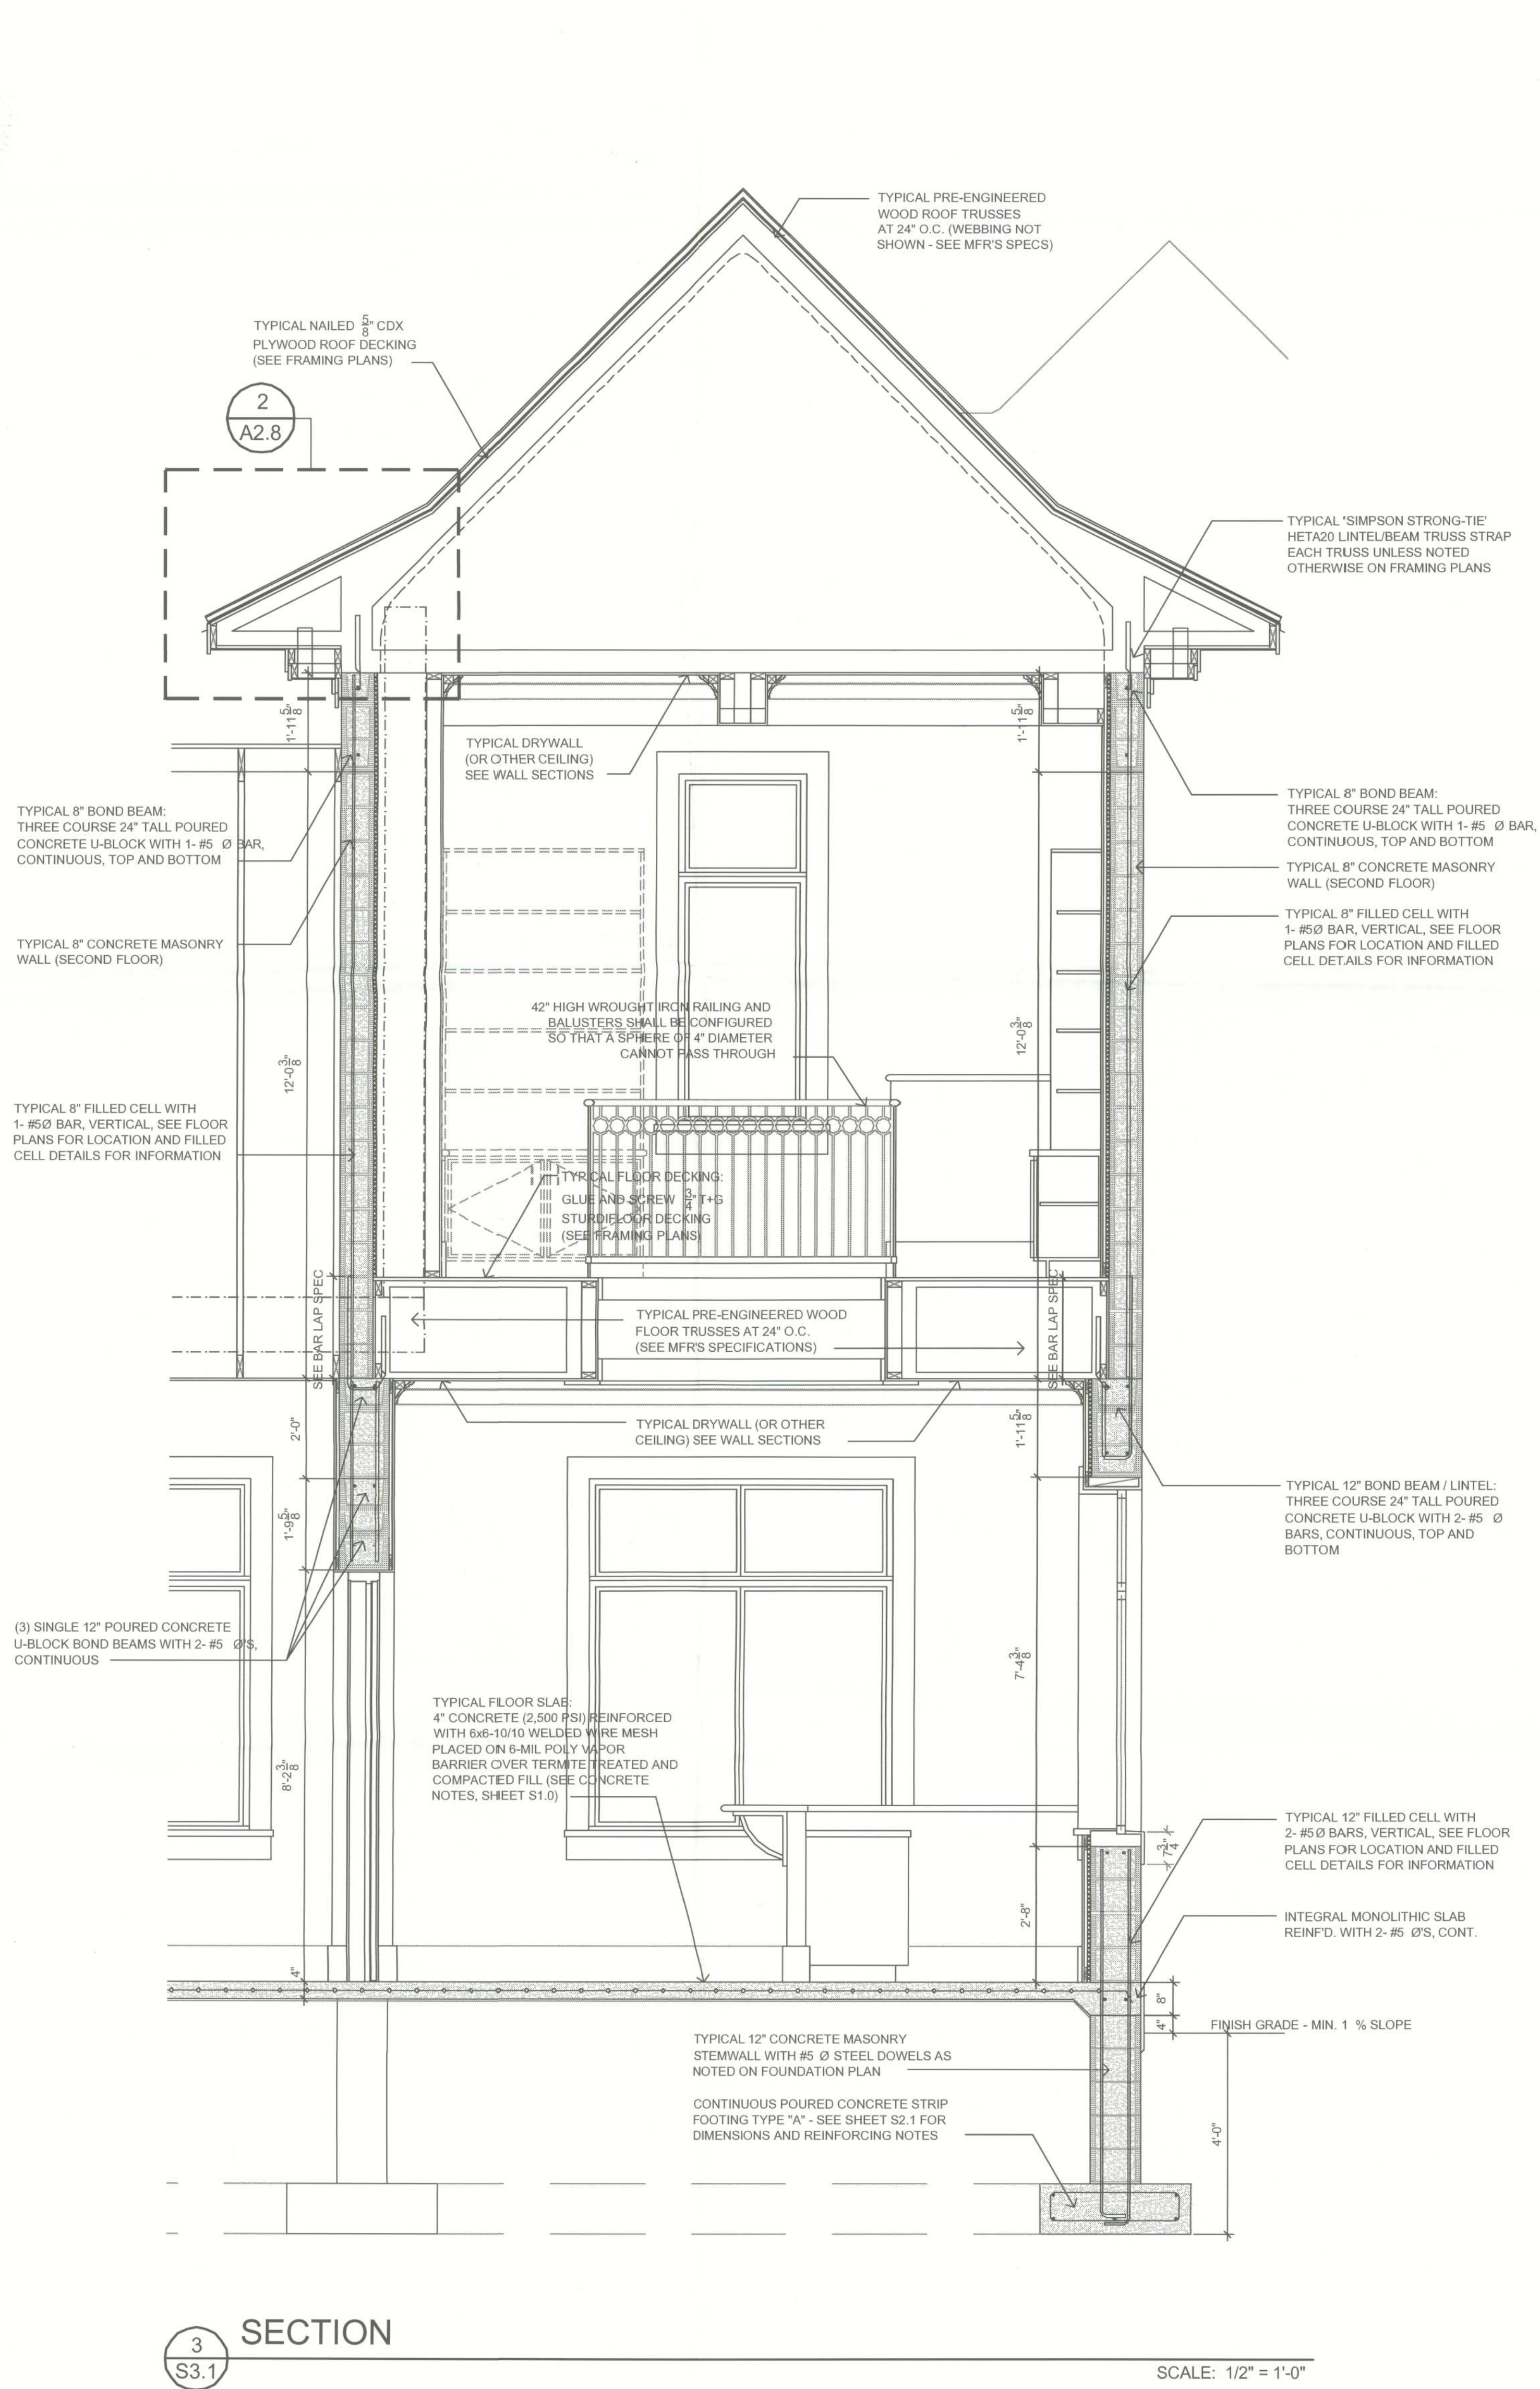
PLANS PREPARED BY AND UNDER THE
DIRECT SUPERVISION OF
STRUCTURAL PLAN SERVICE, INC.
AND KEN EILERS, P.E.
PETER WOODS, RESIDENTIAL DESIGNER
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PROPOSED RESIDENCE
DR. AND MRS. MINESH PATEL
LOT 1, HILLS OF WINDSOR, COLUMBIA COUNTY, FL
PARCEL NO. 30-3S-16-02411-101

SHEET NUMBER
S3.2
PROJECT NO. 120101



9/7/2012 12:35:27 AM



DATE	REMARK
08.07.12	PERMIT SET

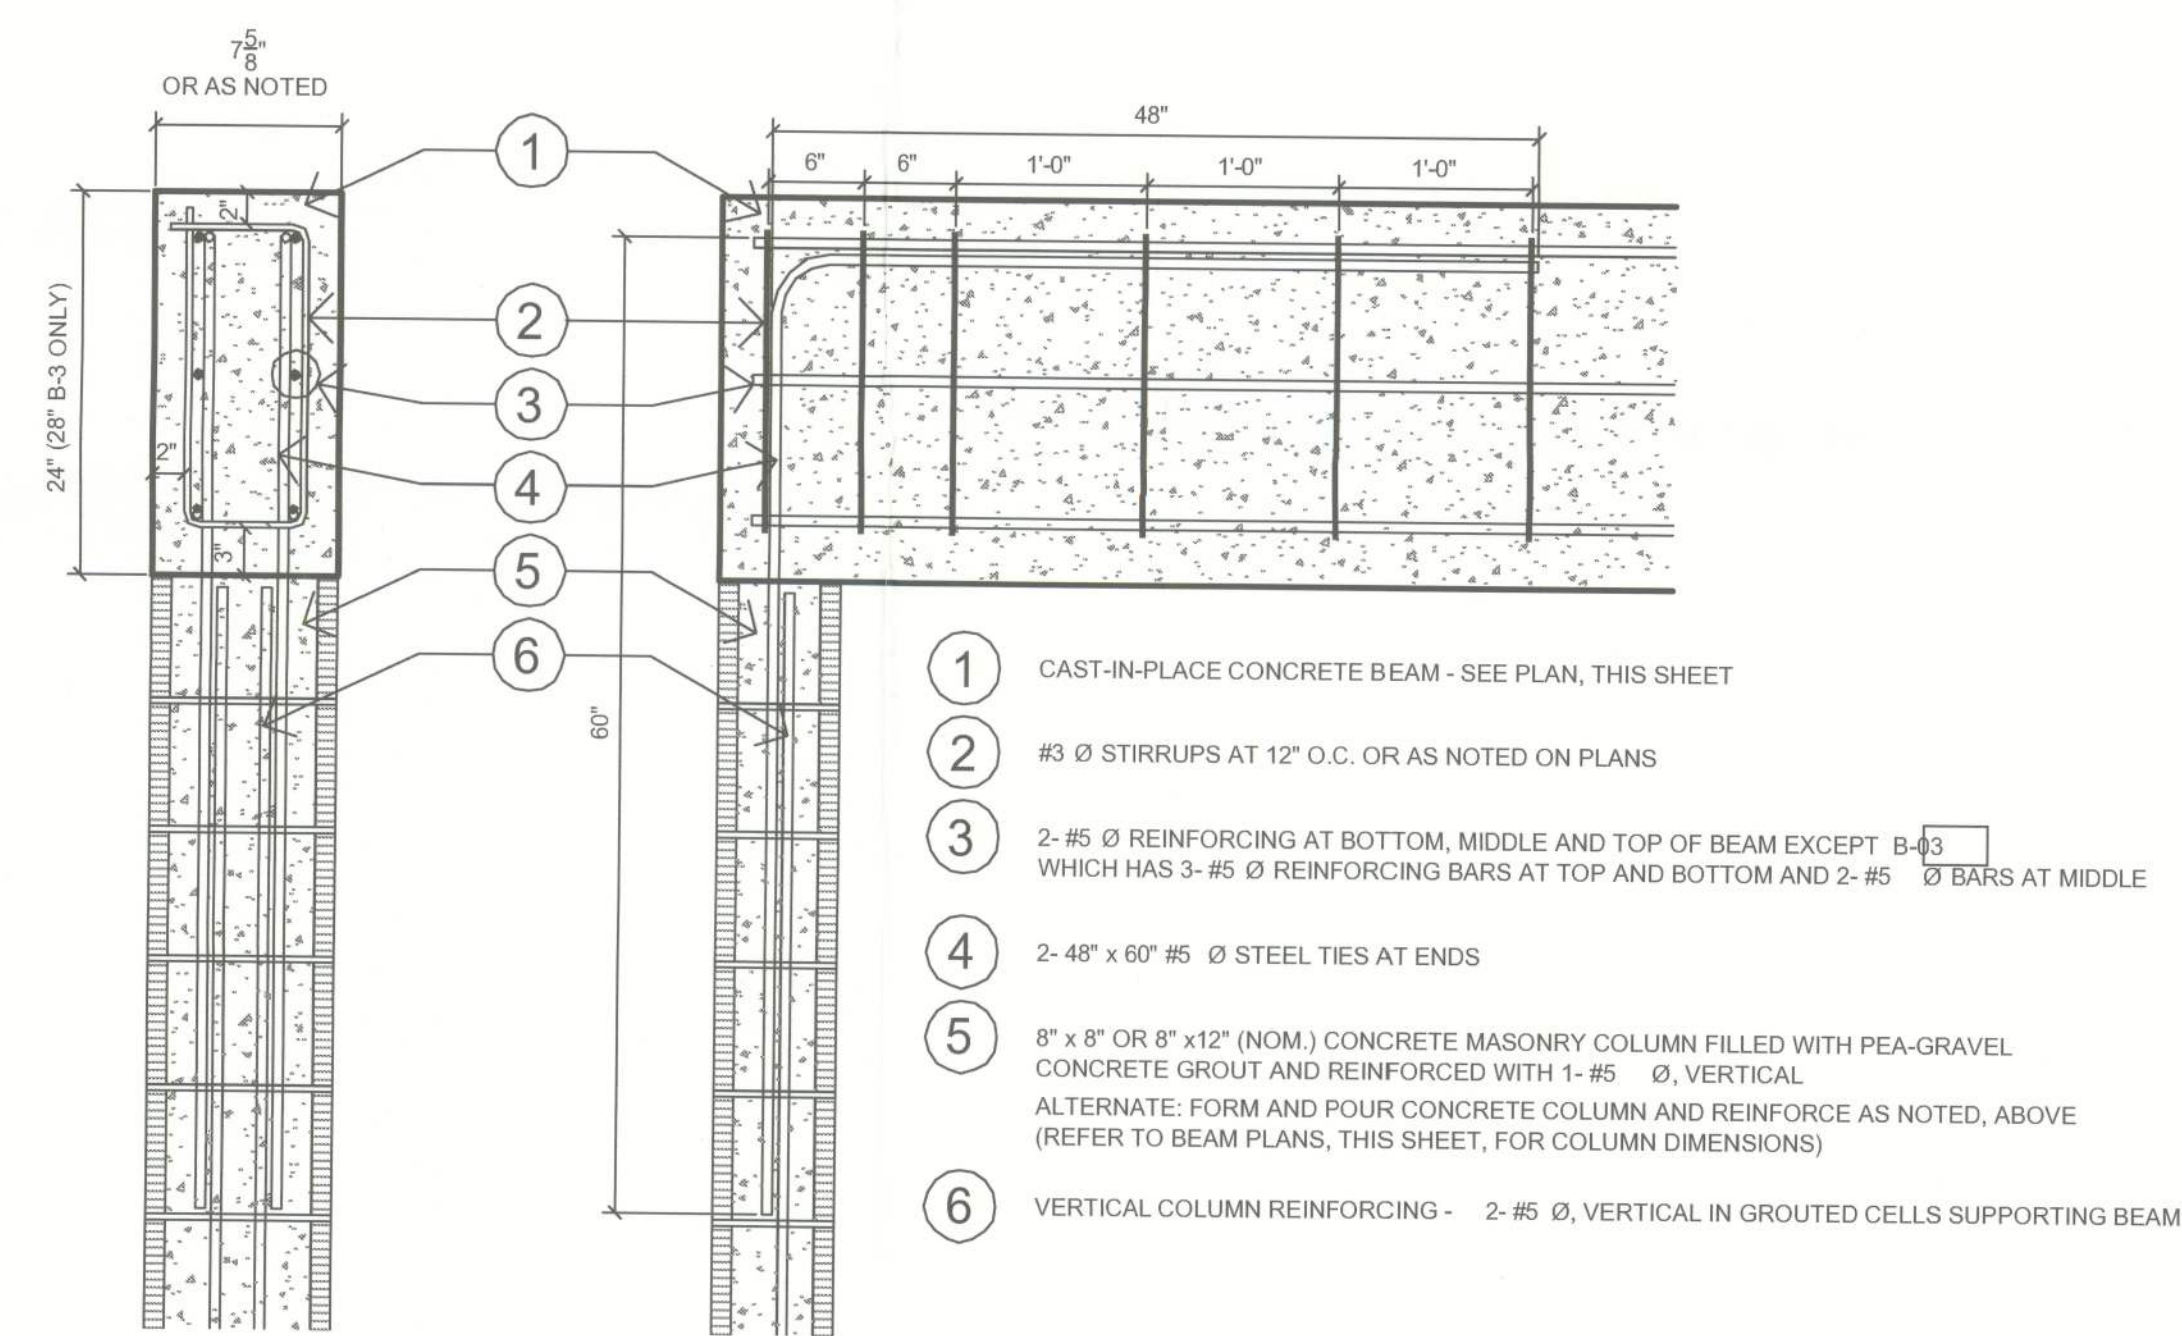
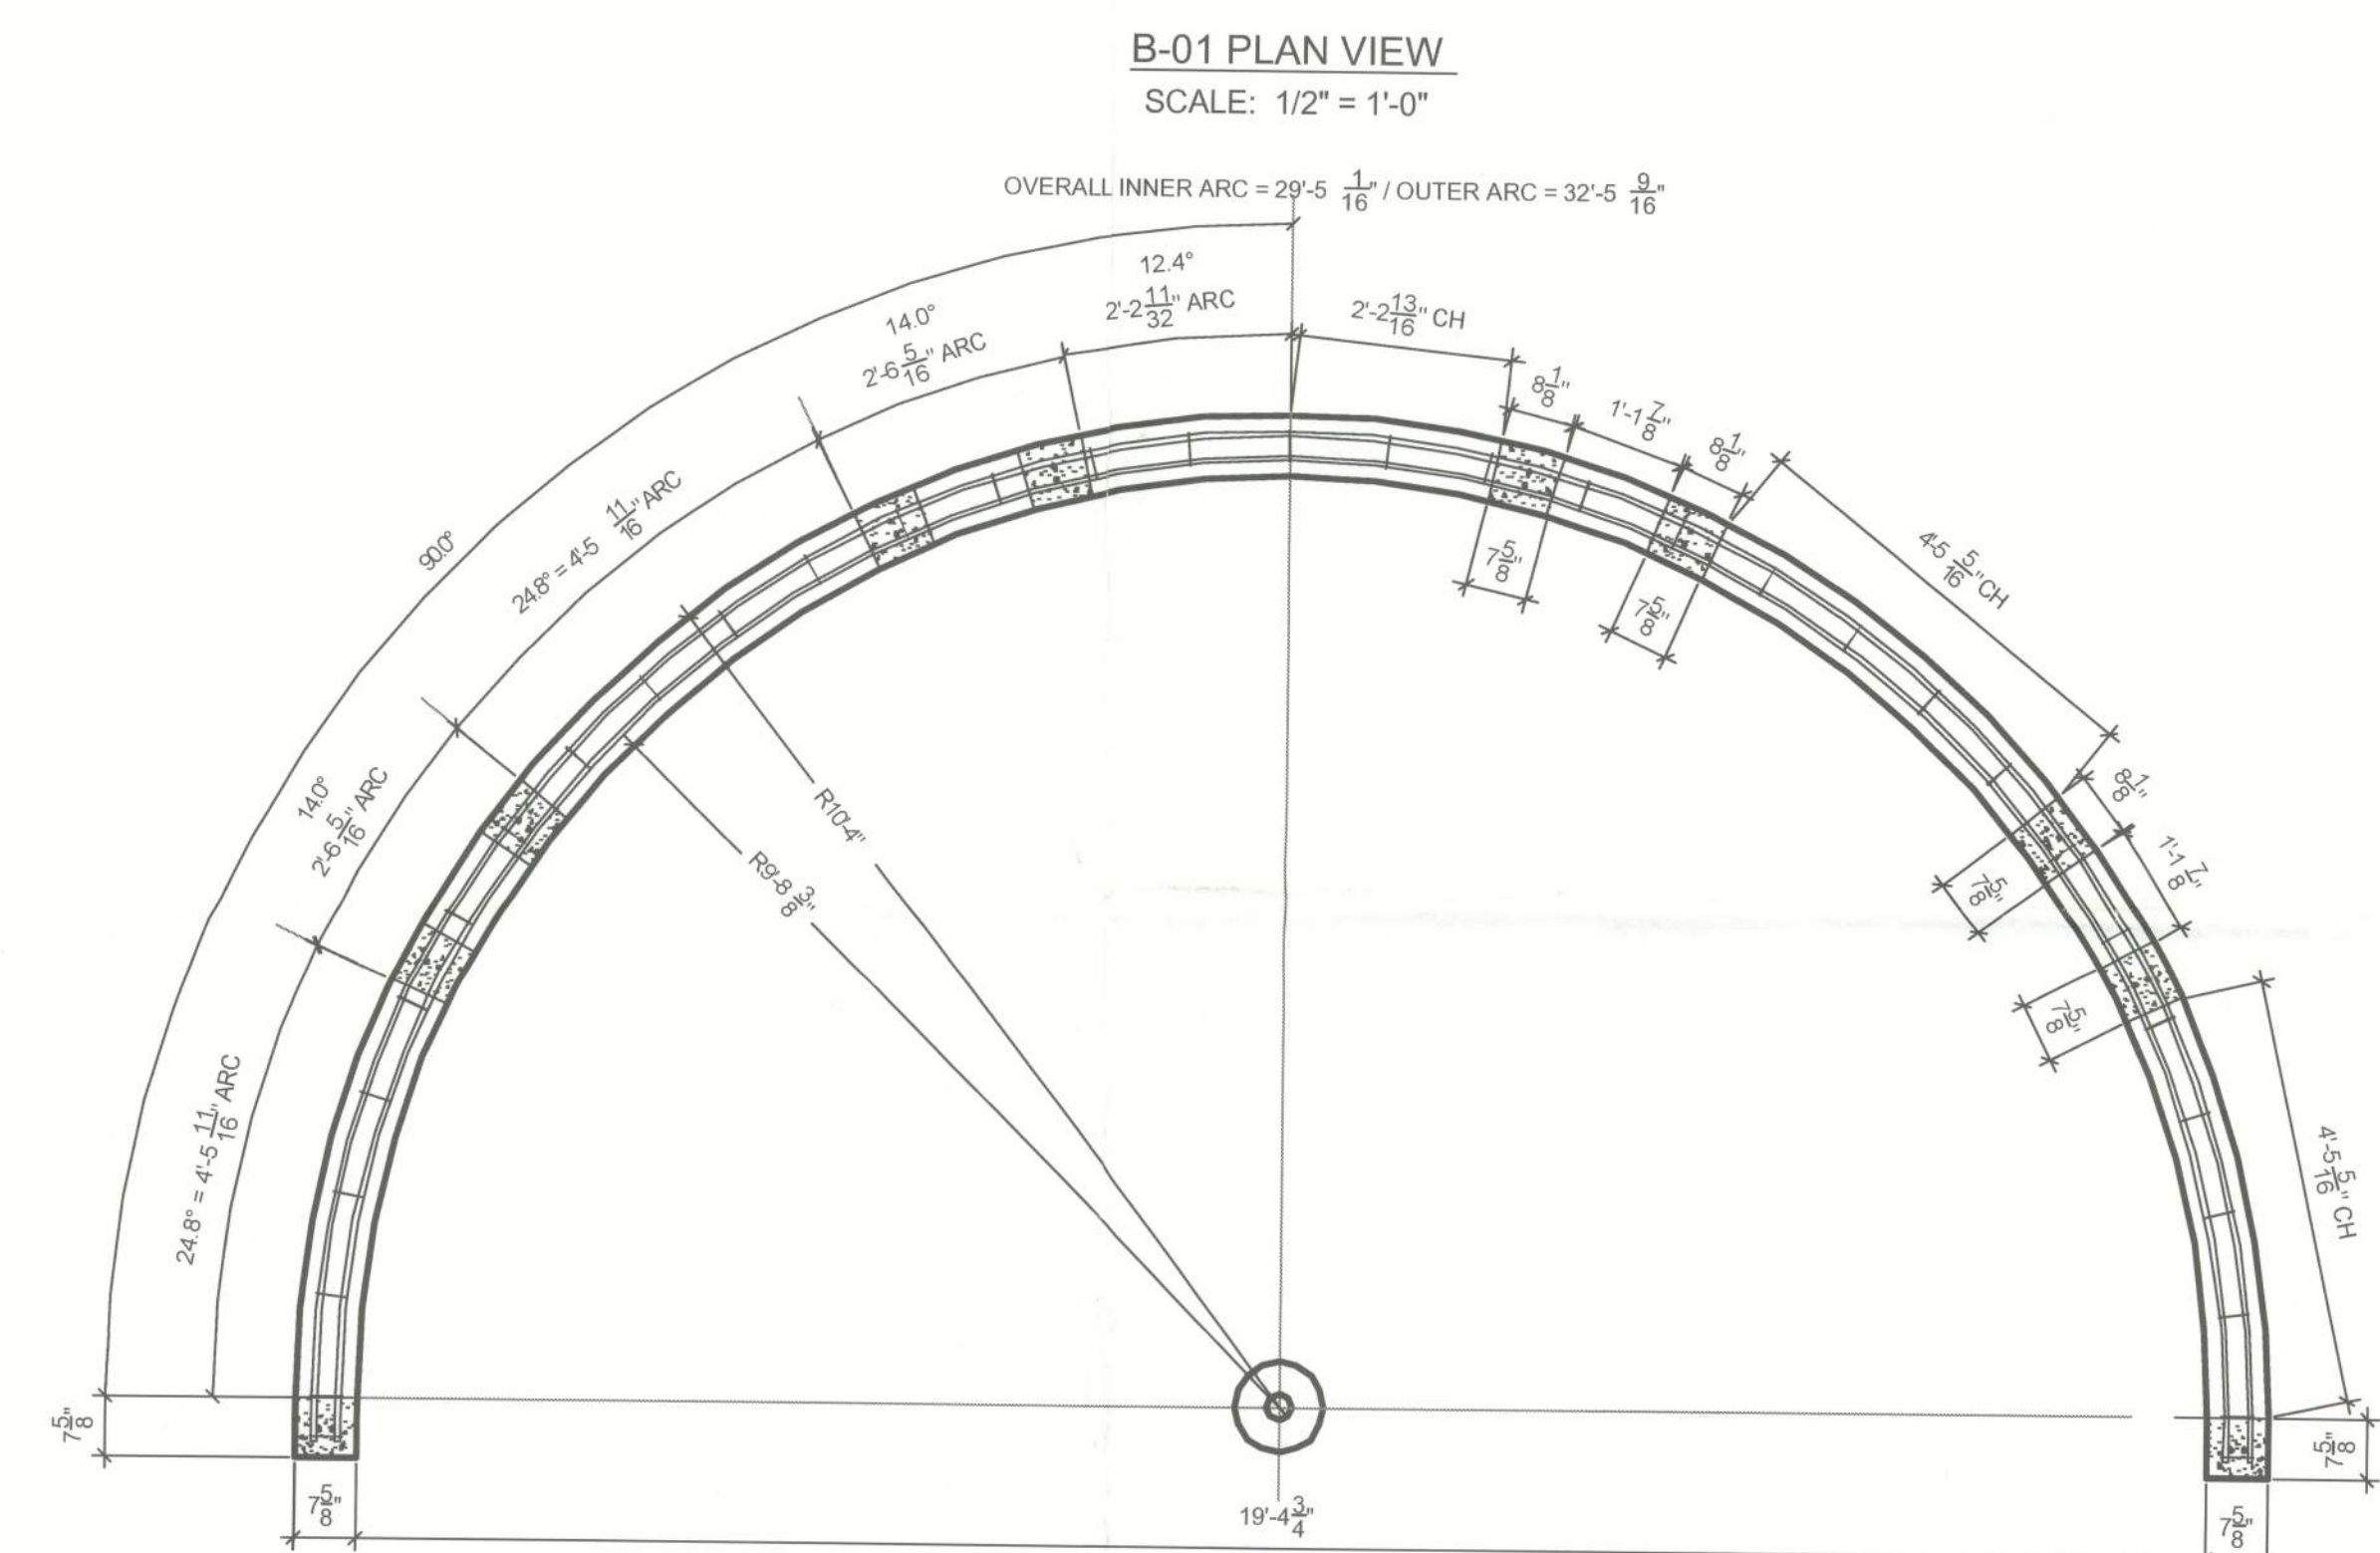
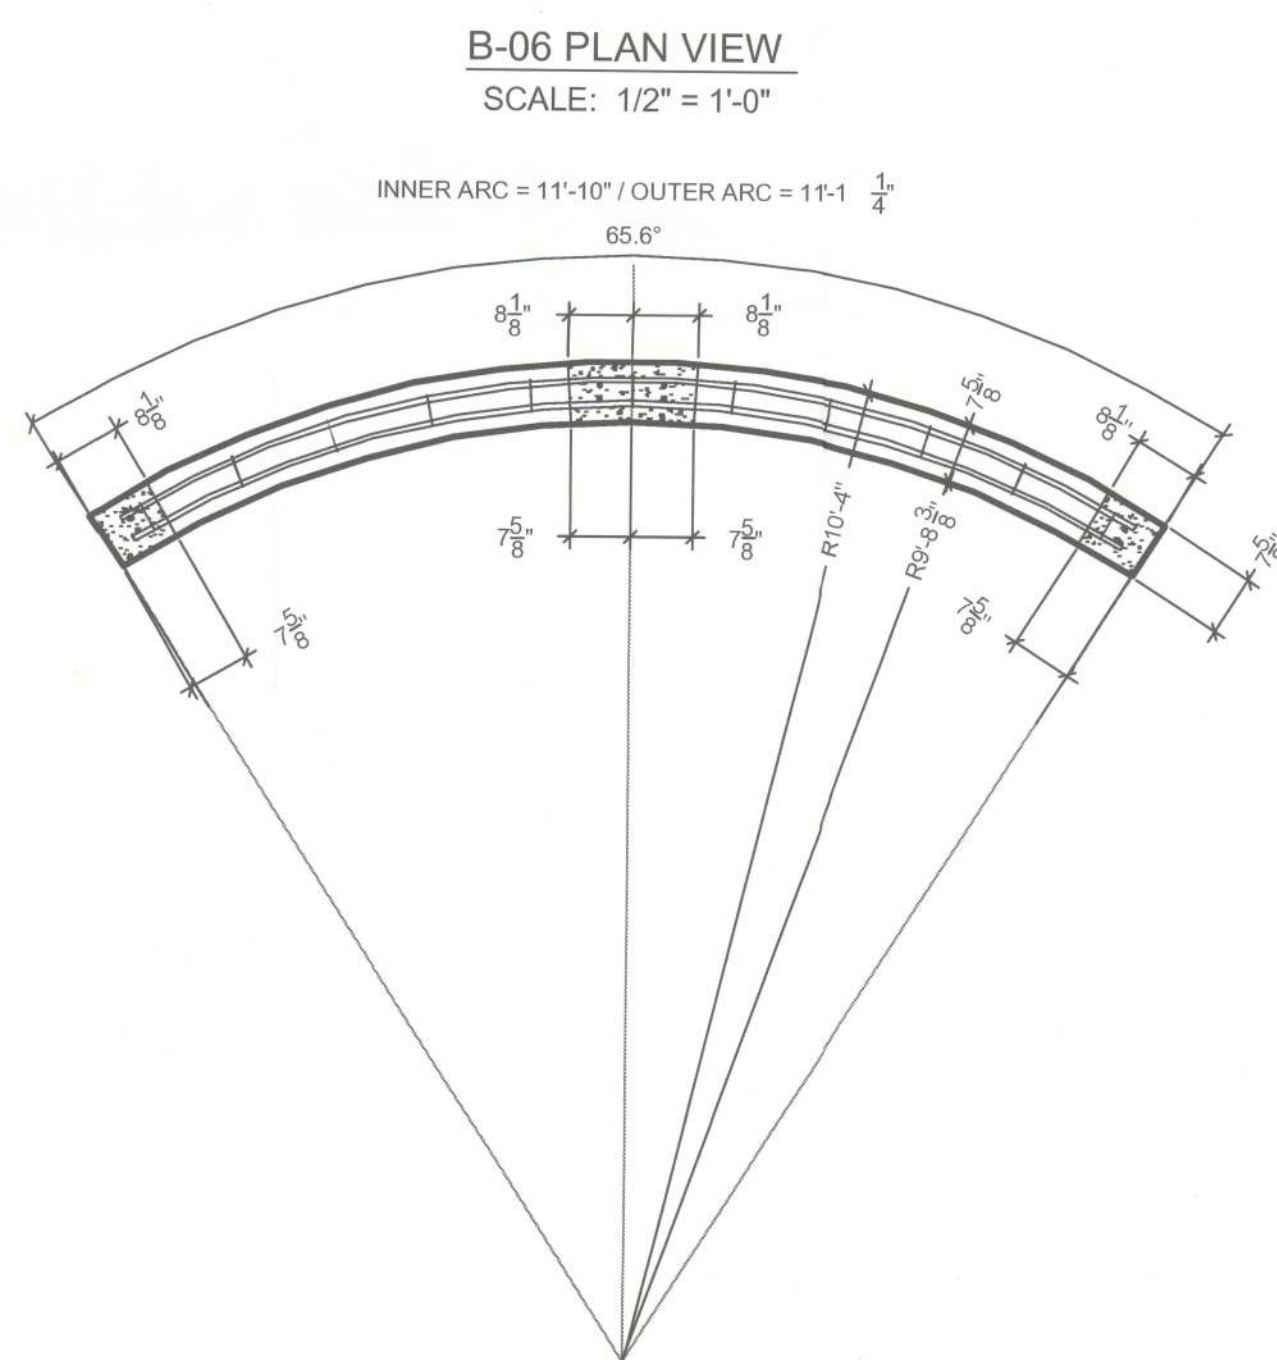
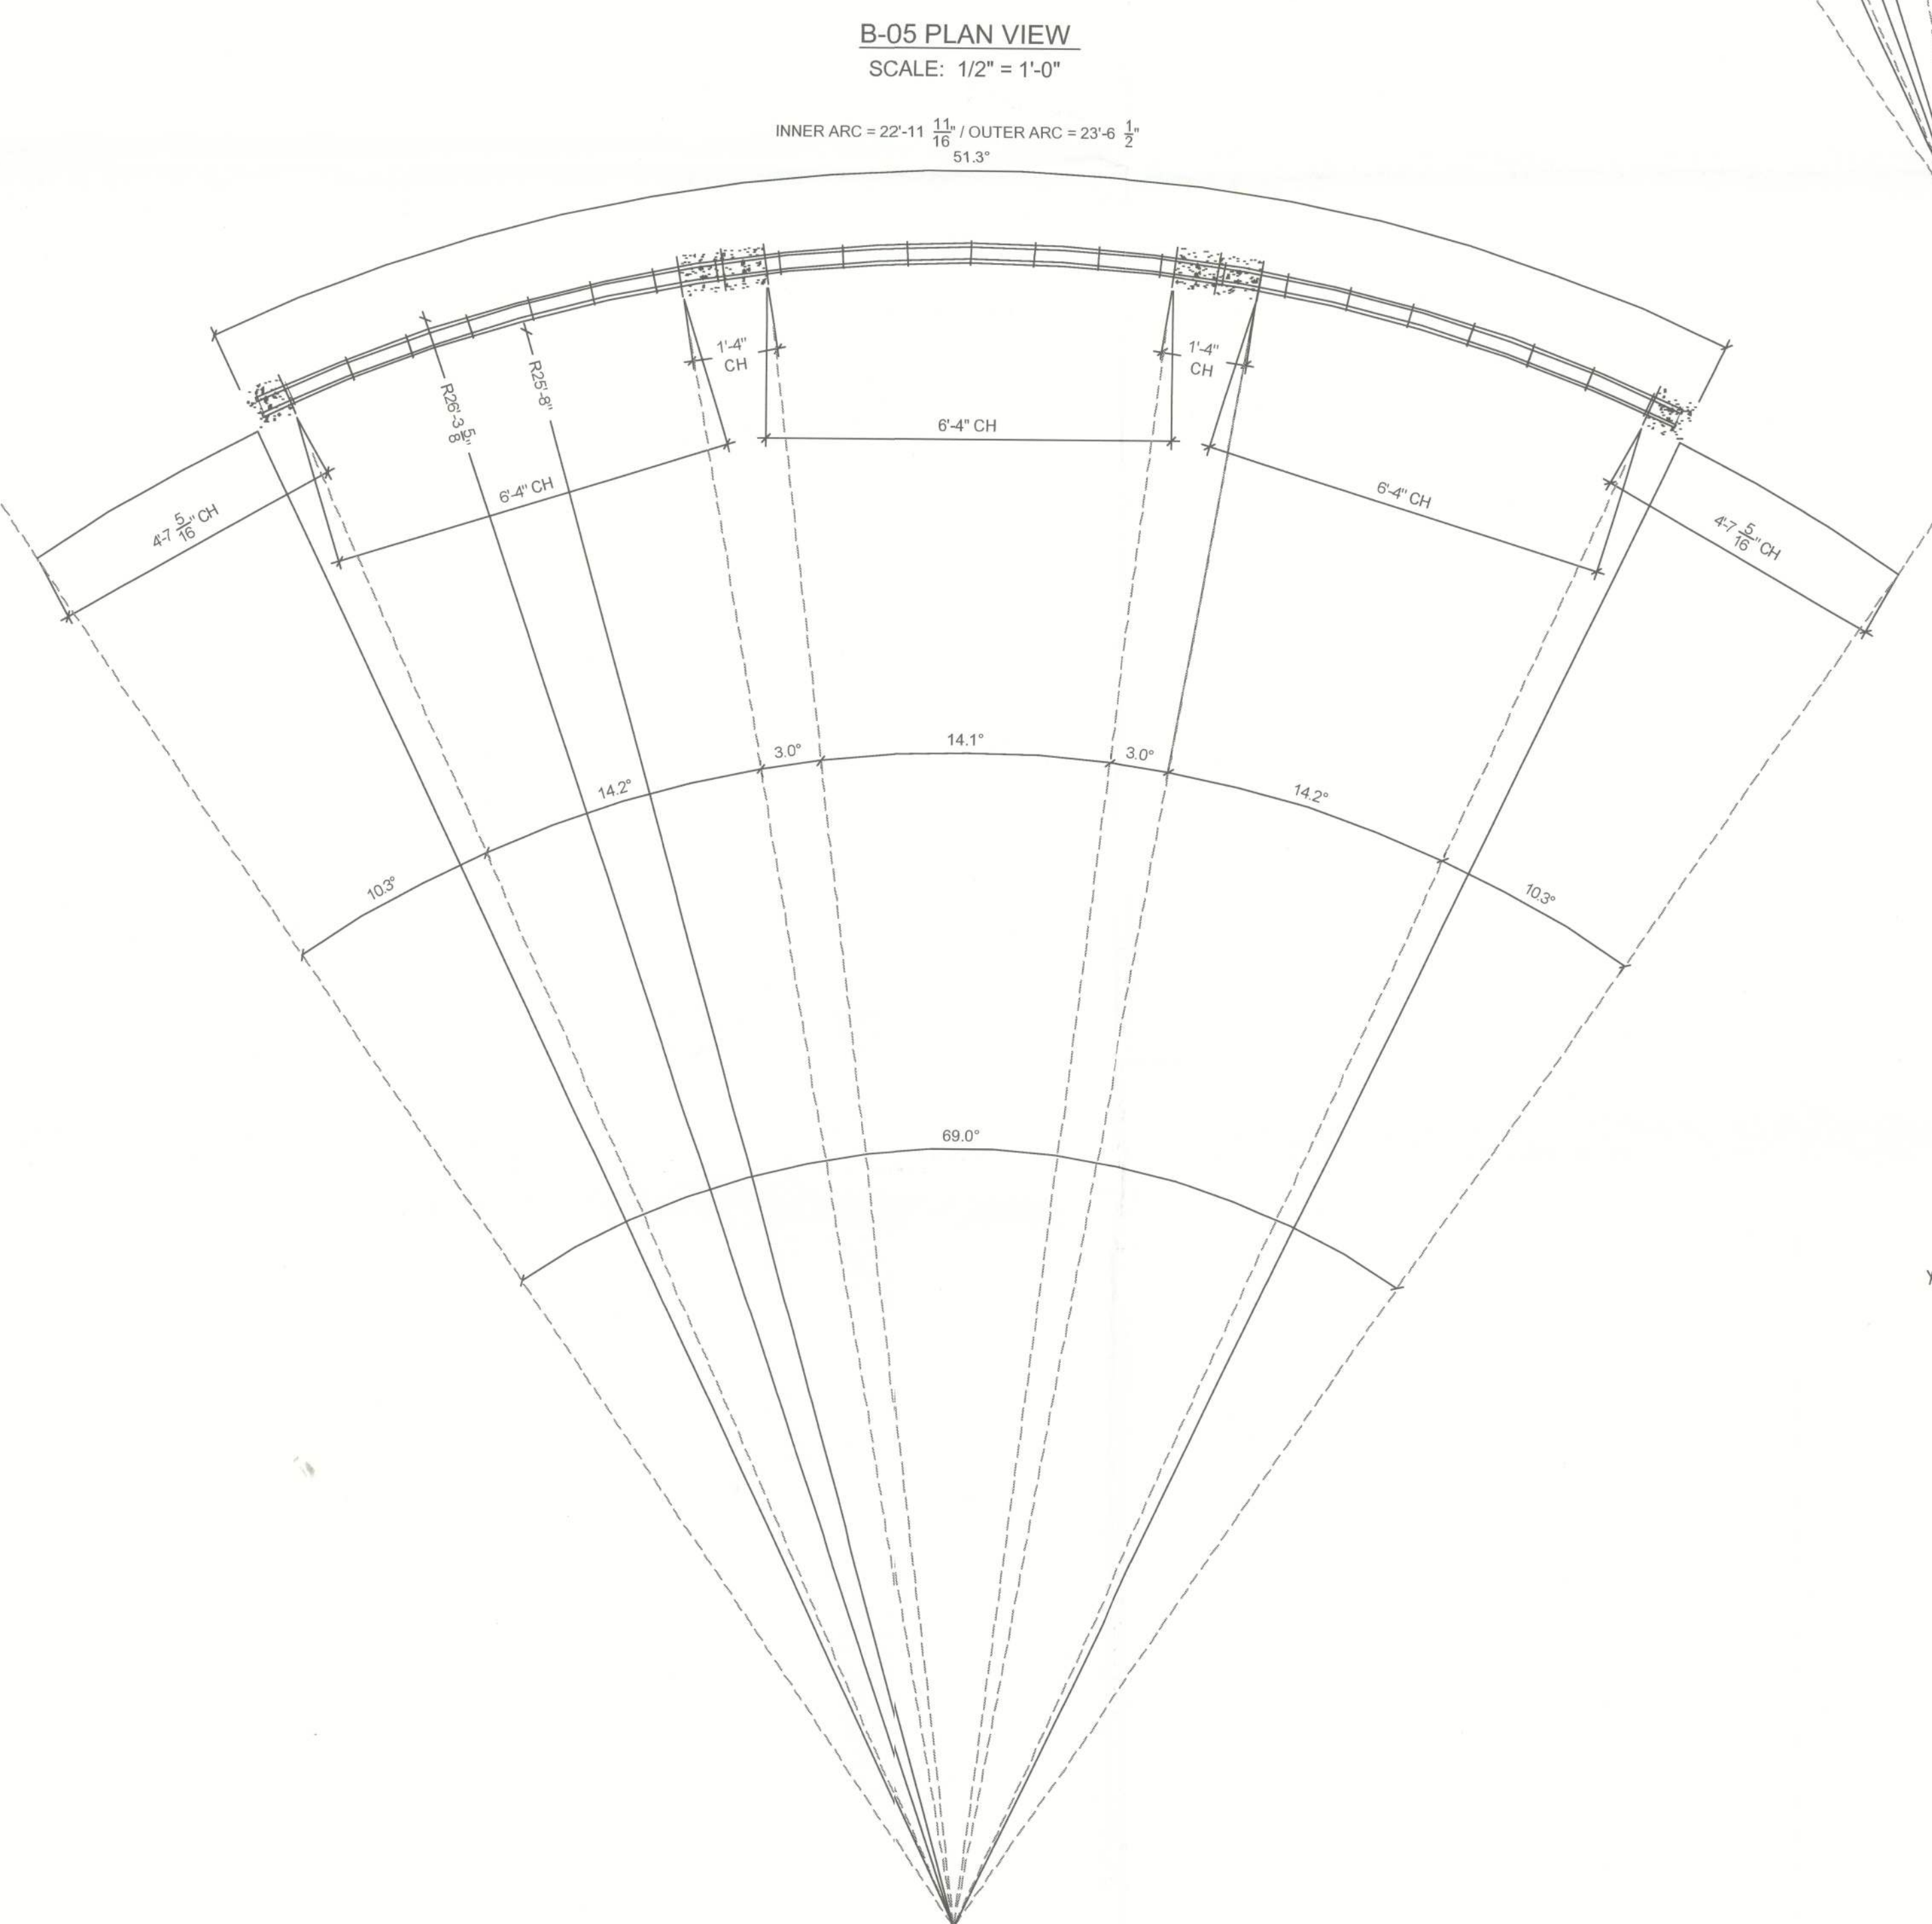
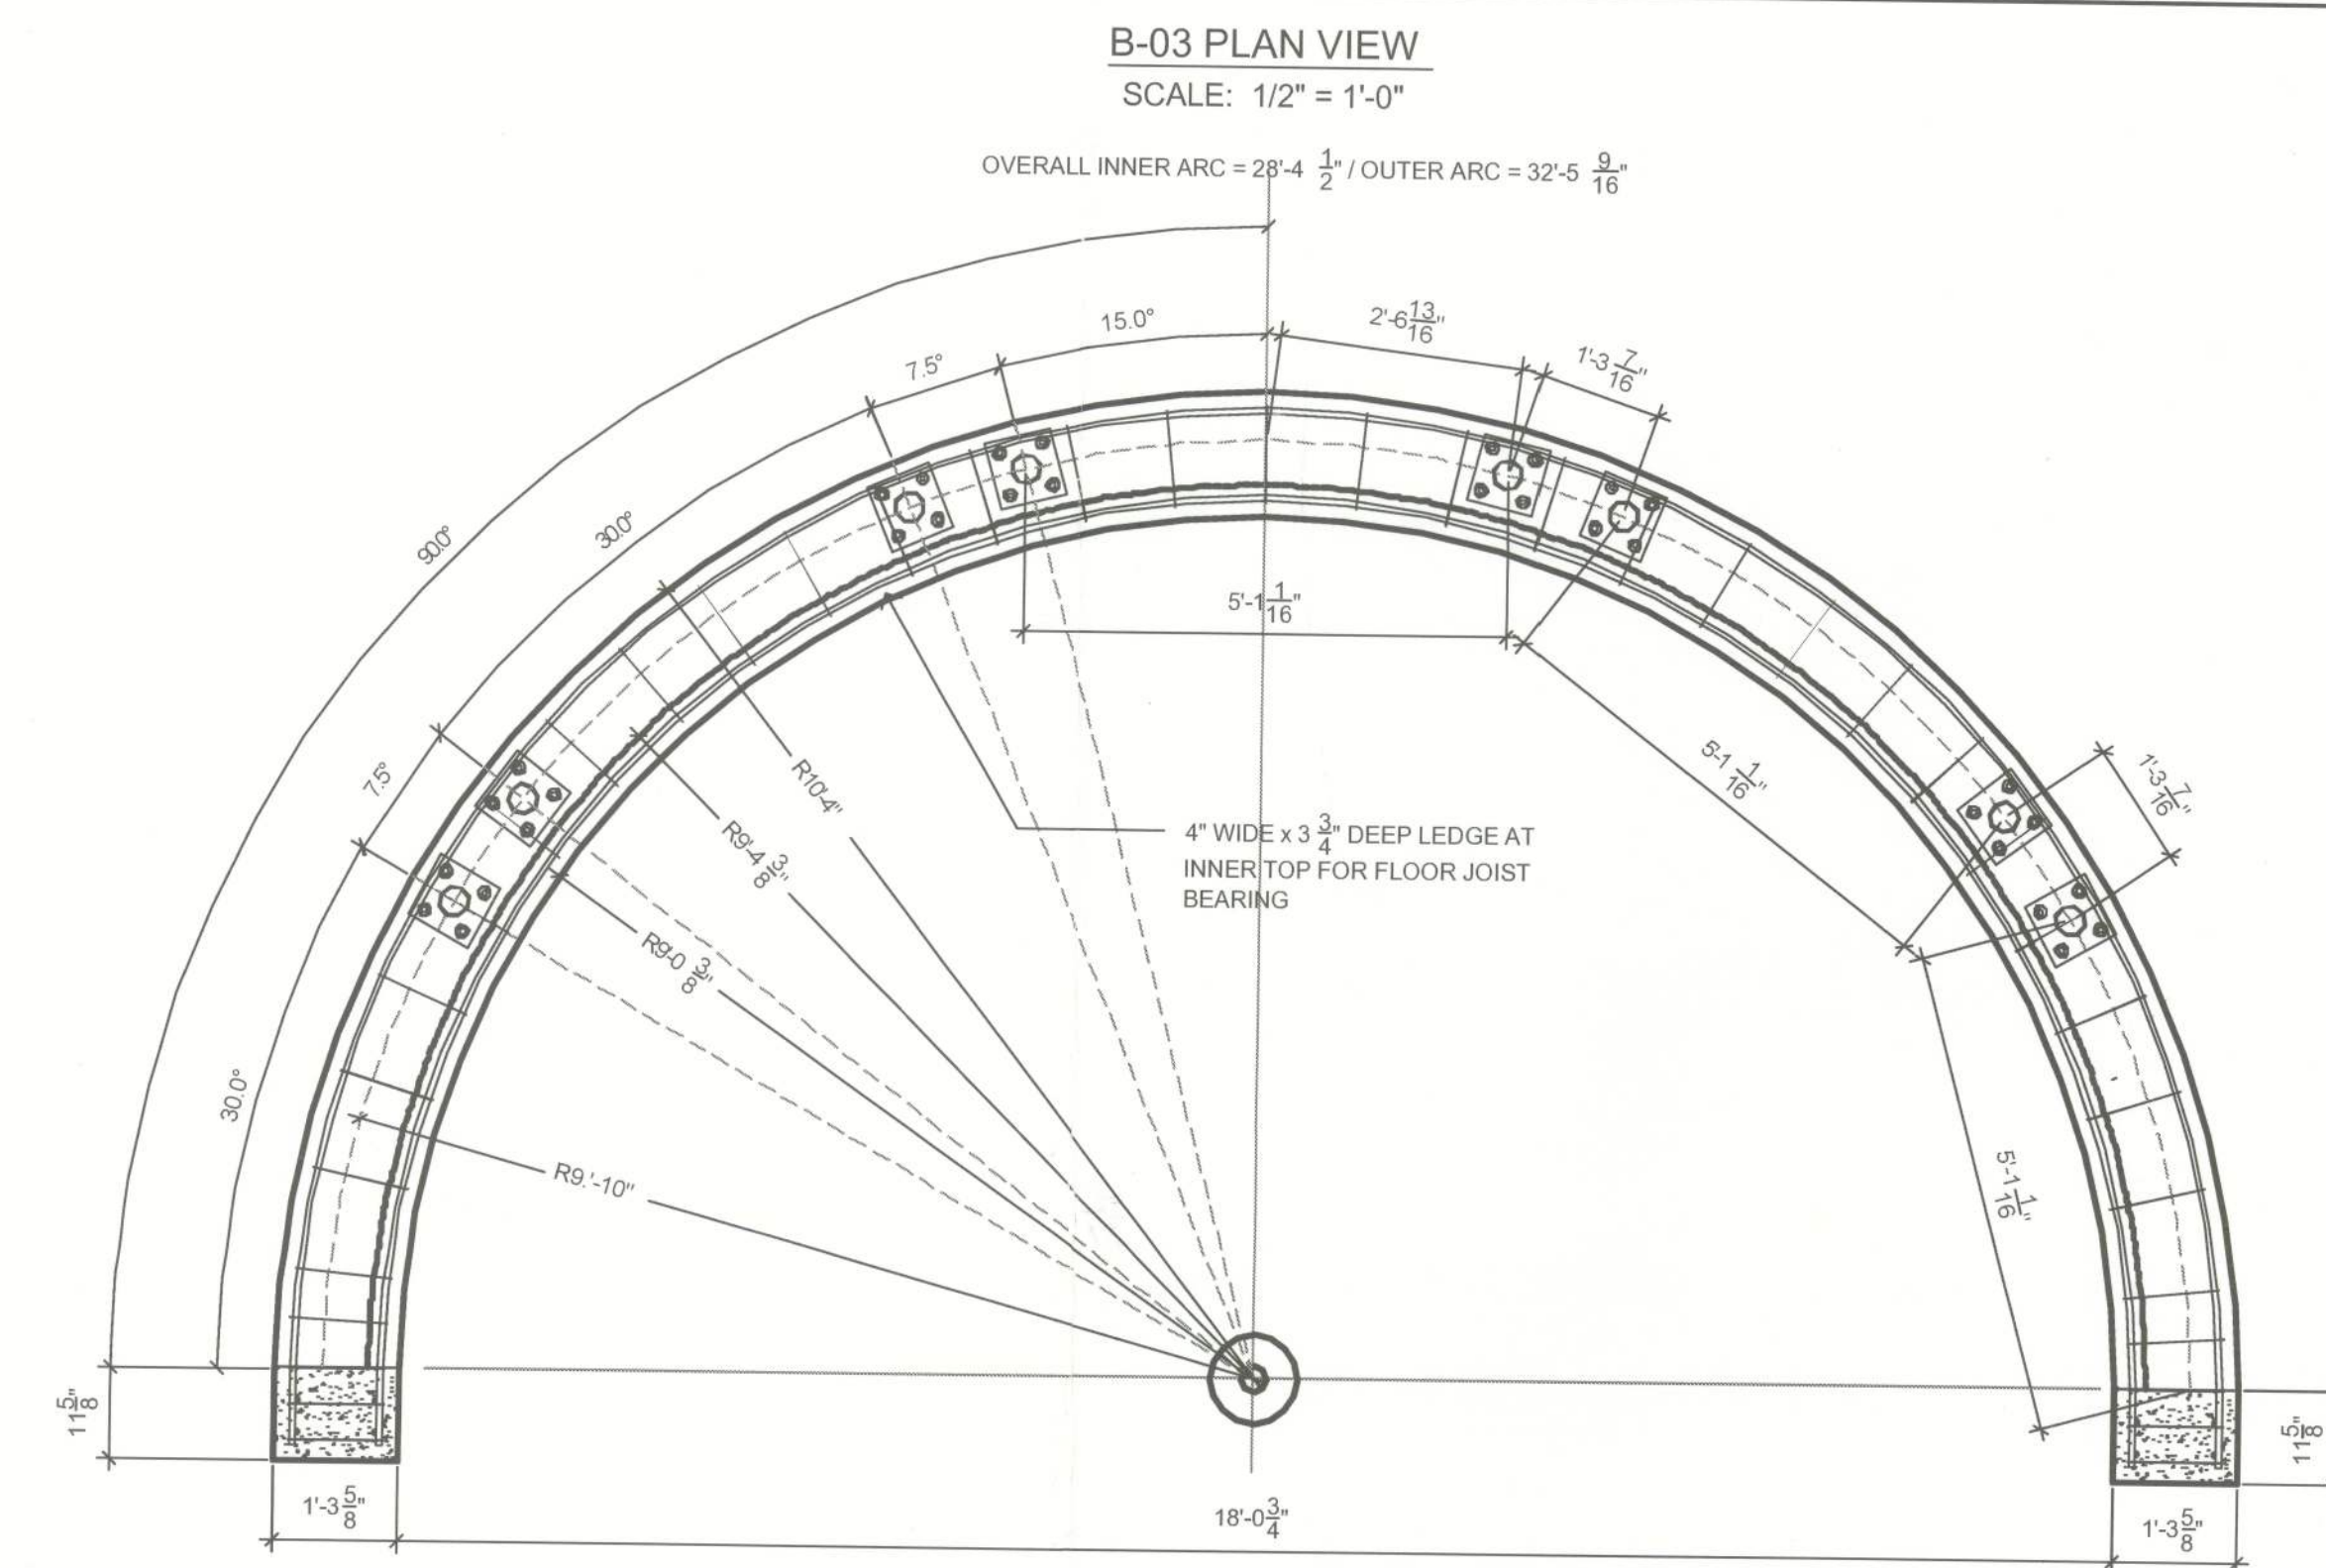
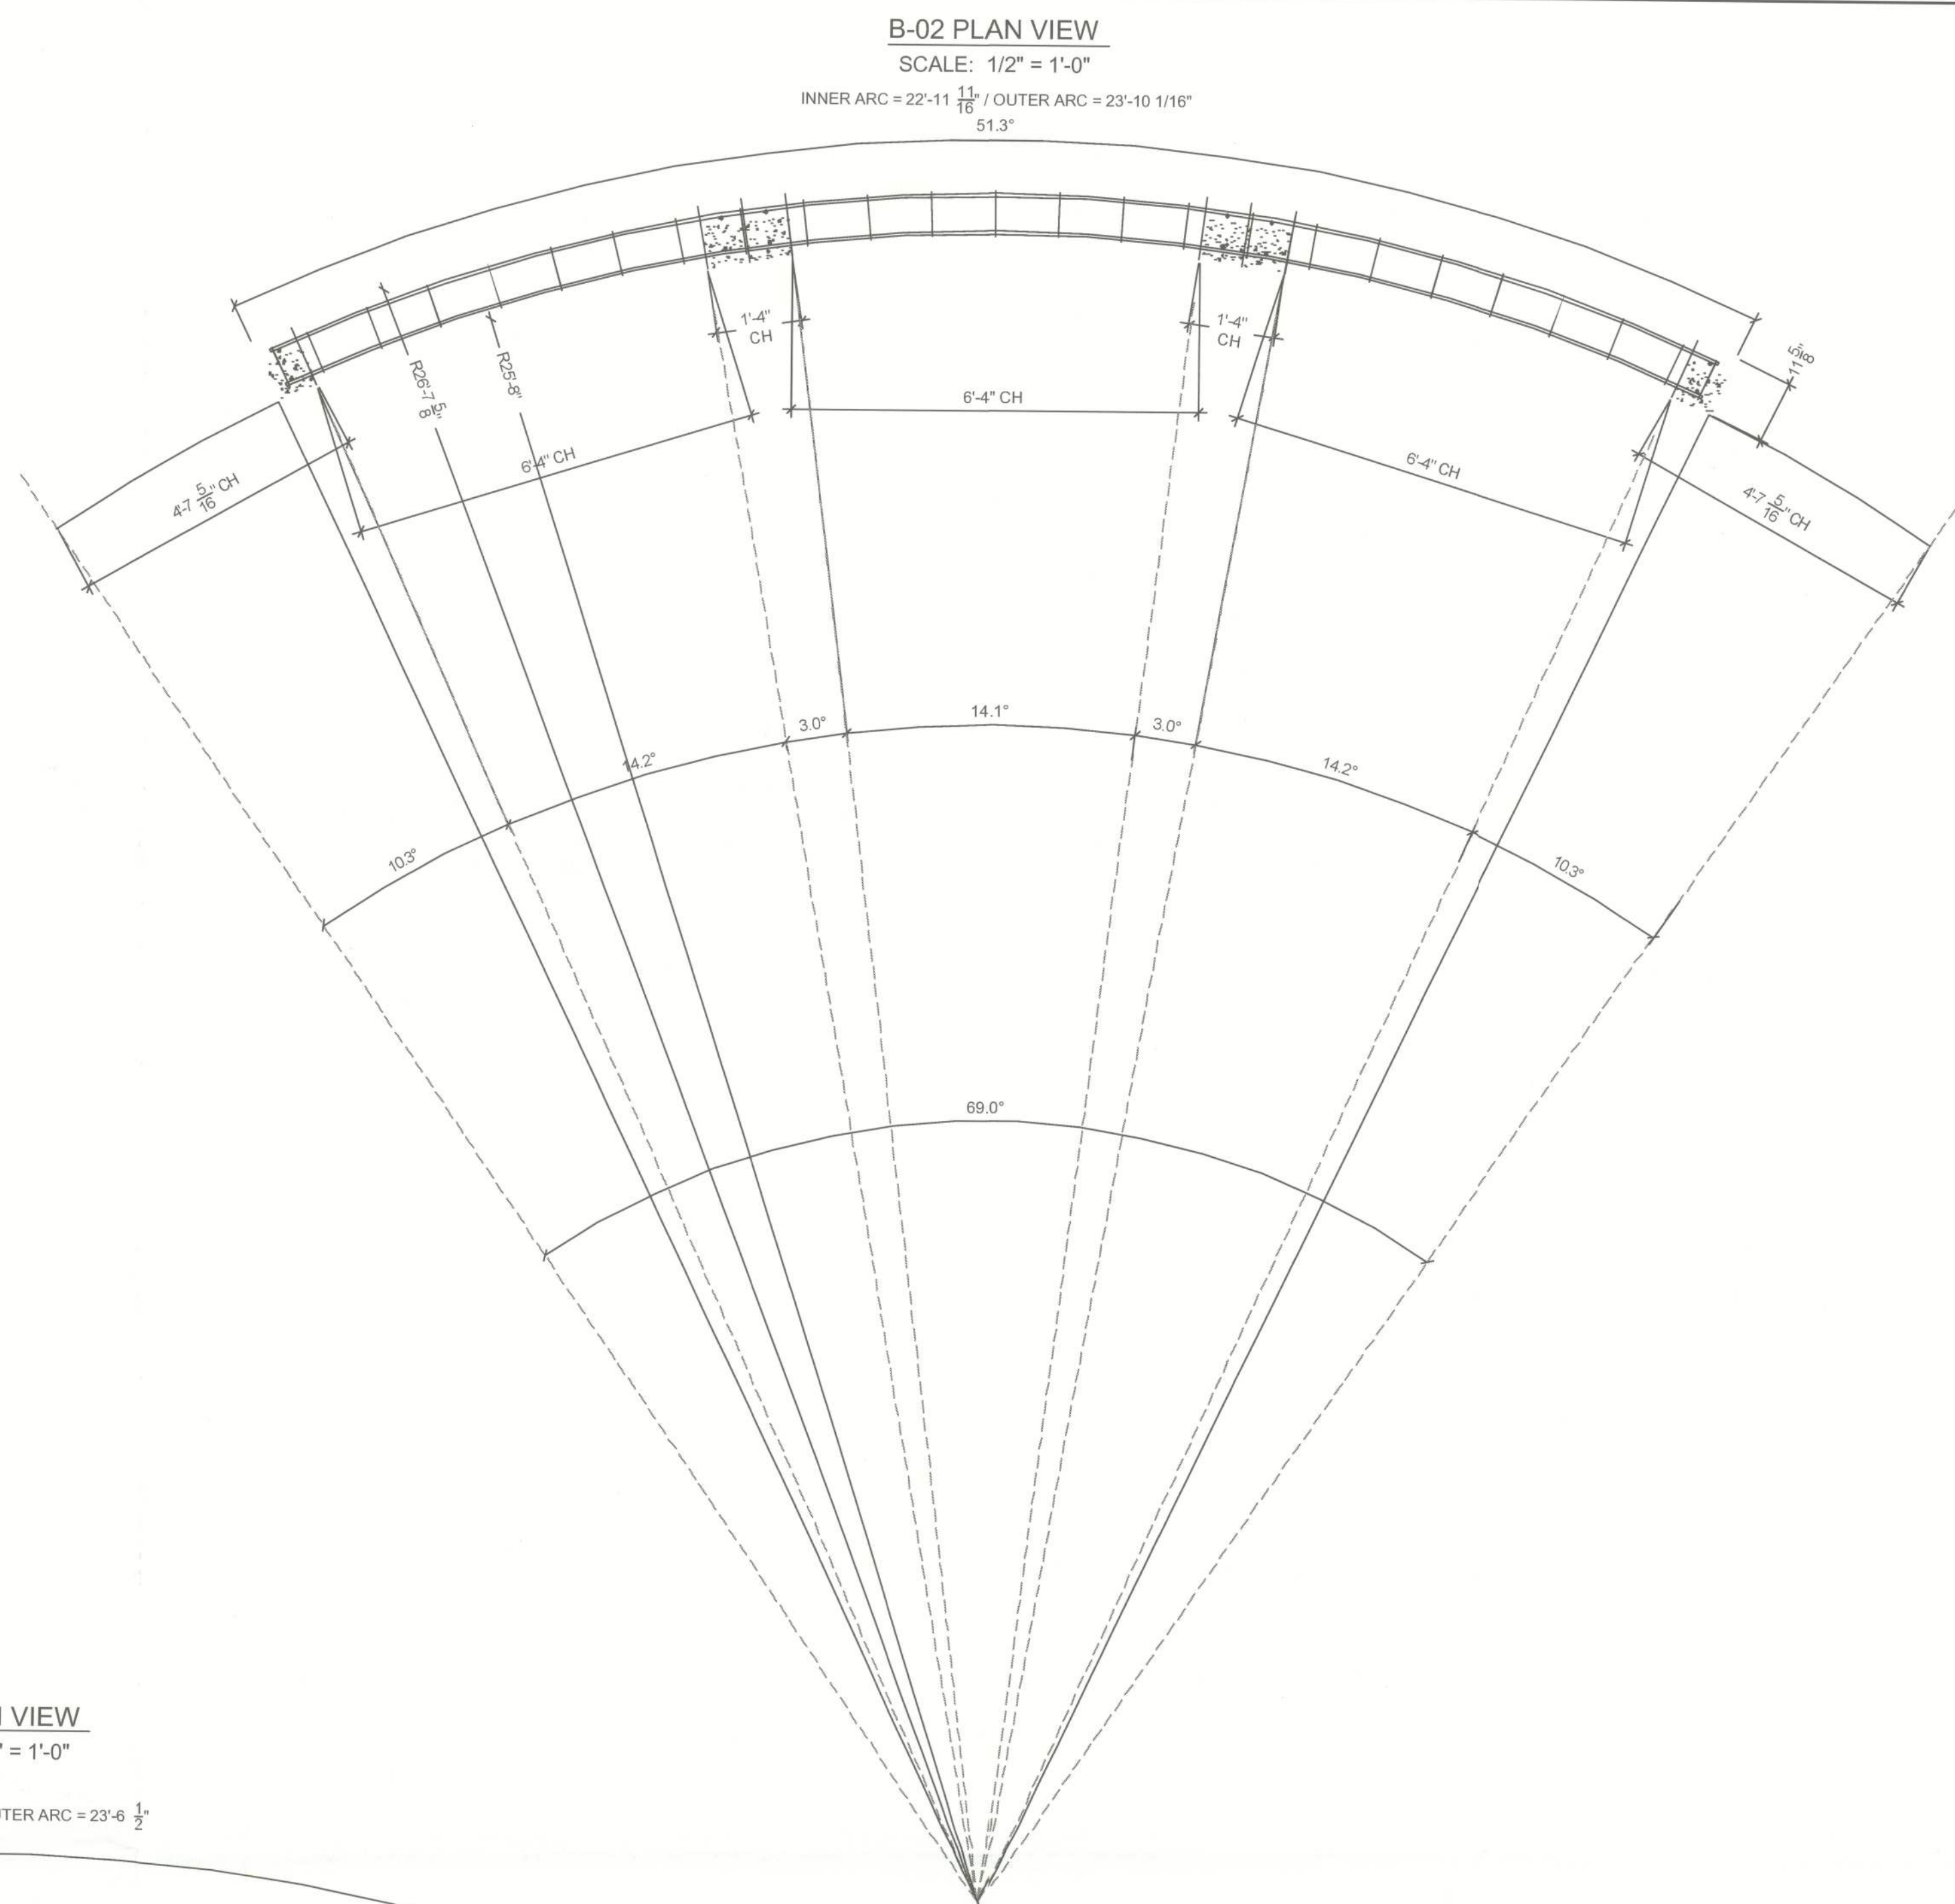
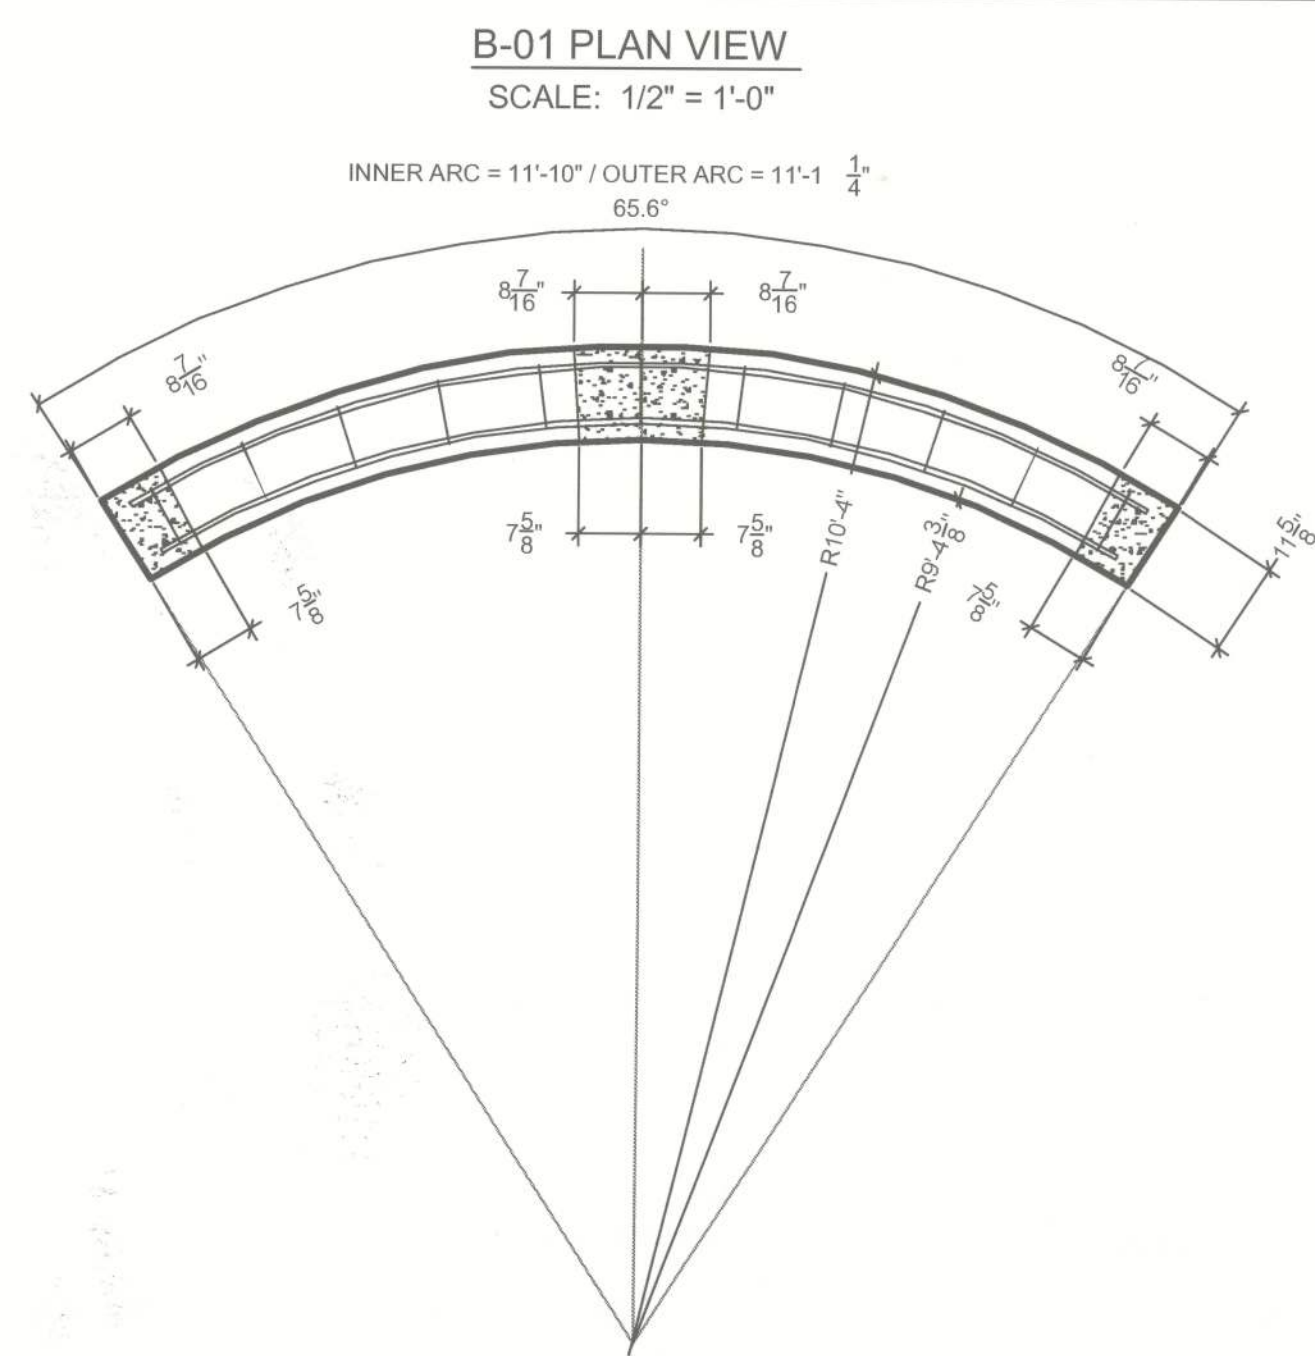
Ken Ehlers P.E. # 18243

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PROPOSED RESIDENCE
DR. AND MRS. MINESH PATEL
LOT 1, HILLS OF WINDSOR, COLUMBIA COUNTY, FL
PARCEL NO. 30-3S-16-02411-101

SHEET NUMBER
S3.1
PROJECT NO. 120101



DATE	REMARK
08.07.12	PERMIT SET

Ken Ehlers P.E. #18843

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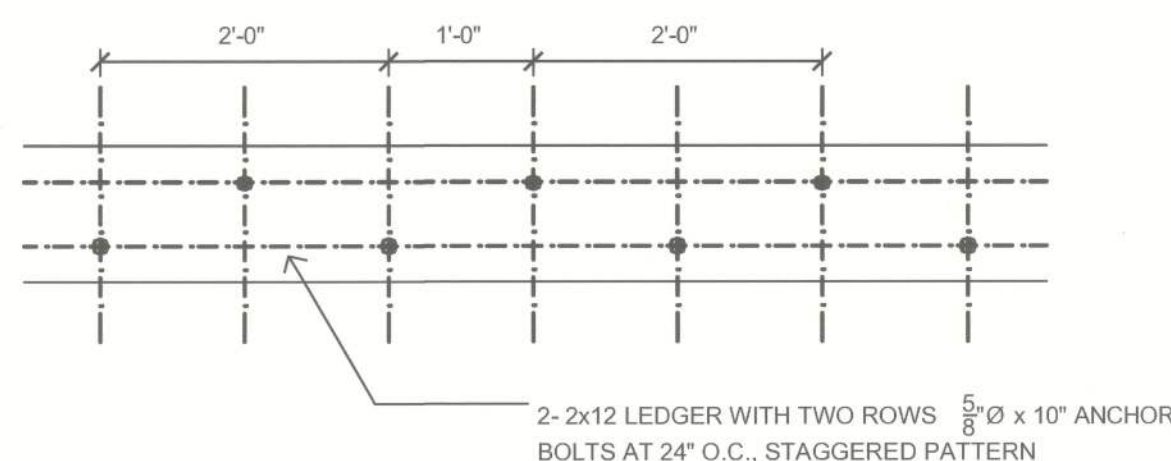
PROPOSED RESIDENCE
DR. AND MRS. MINESH PATEL
LOT 1, HILLS OF WINDSOR, COLUMBIA COUNTY, FL
PARCEL NO. 30-3S-16-02411-101

SHEET NUMBER

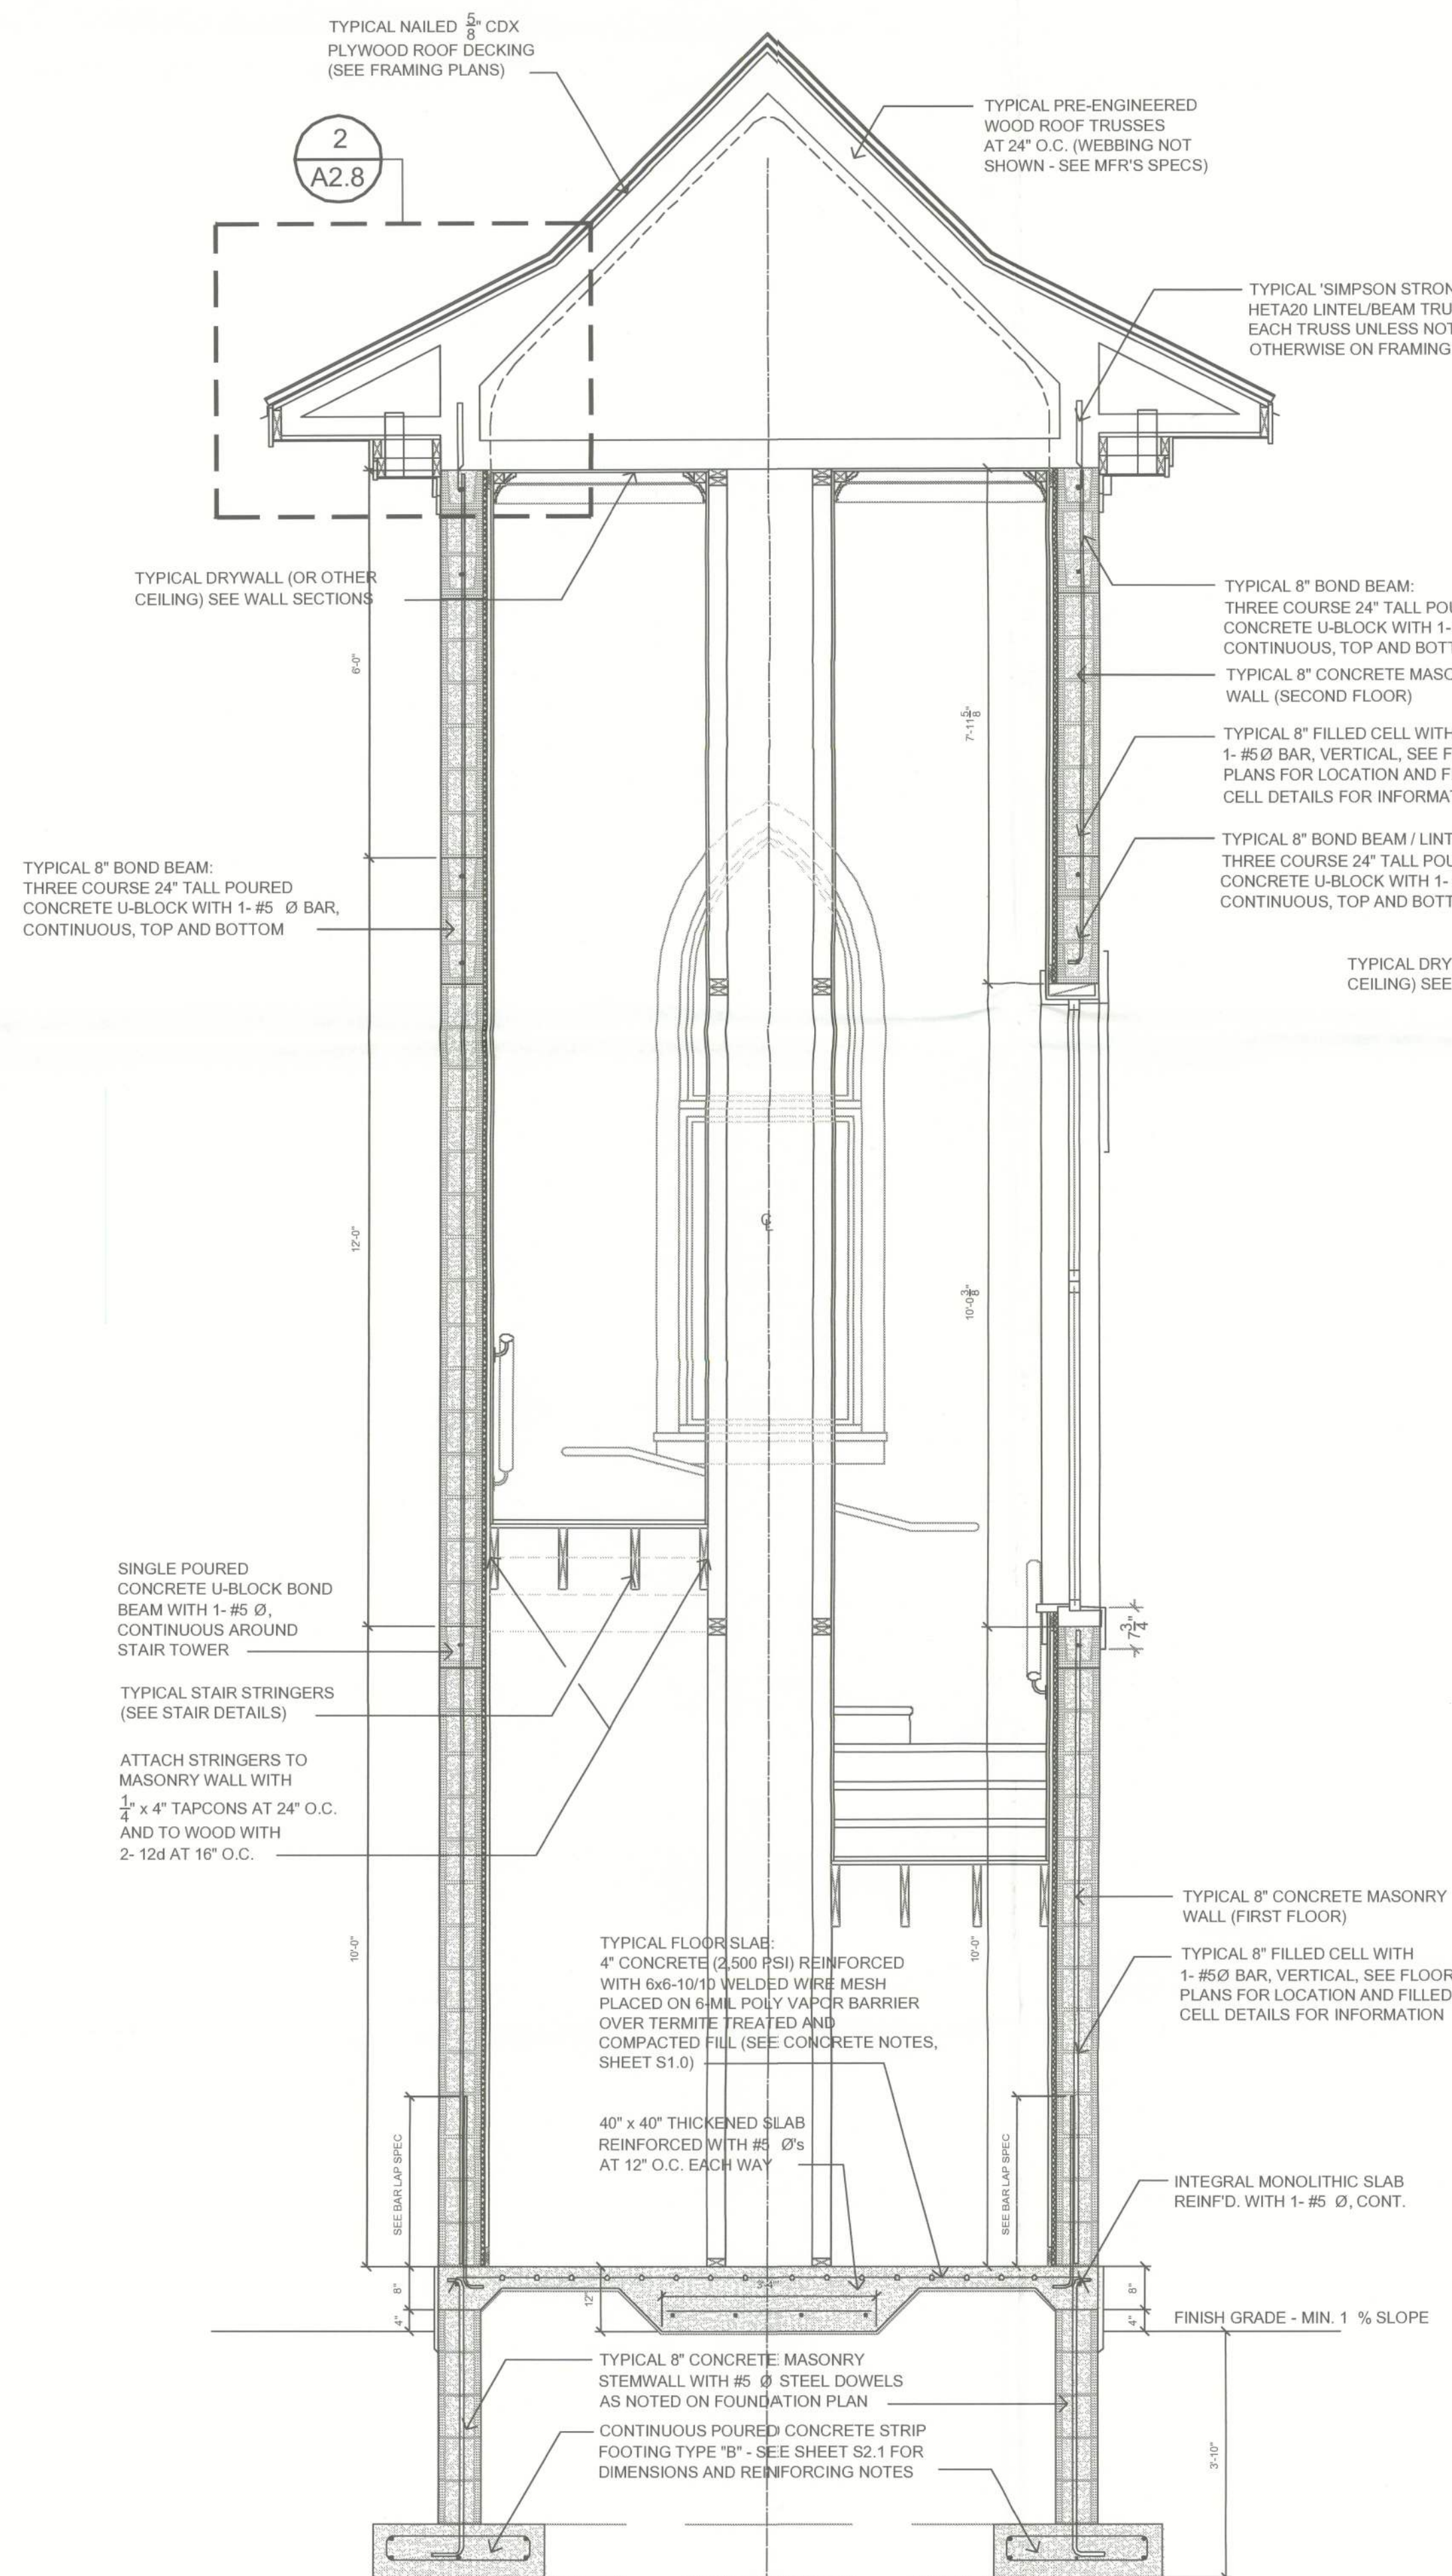
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PROJECT NO. 120101

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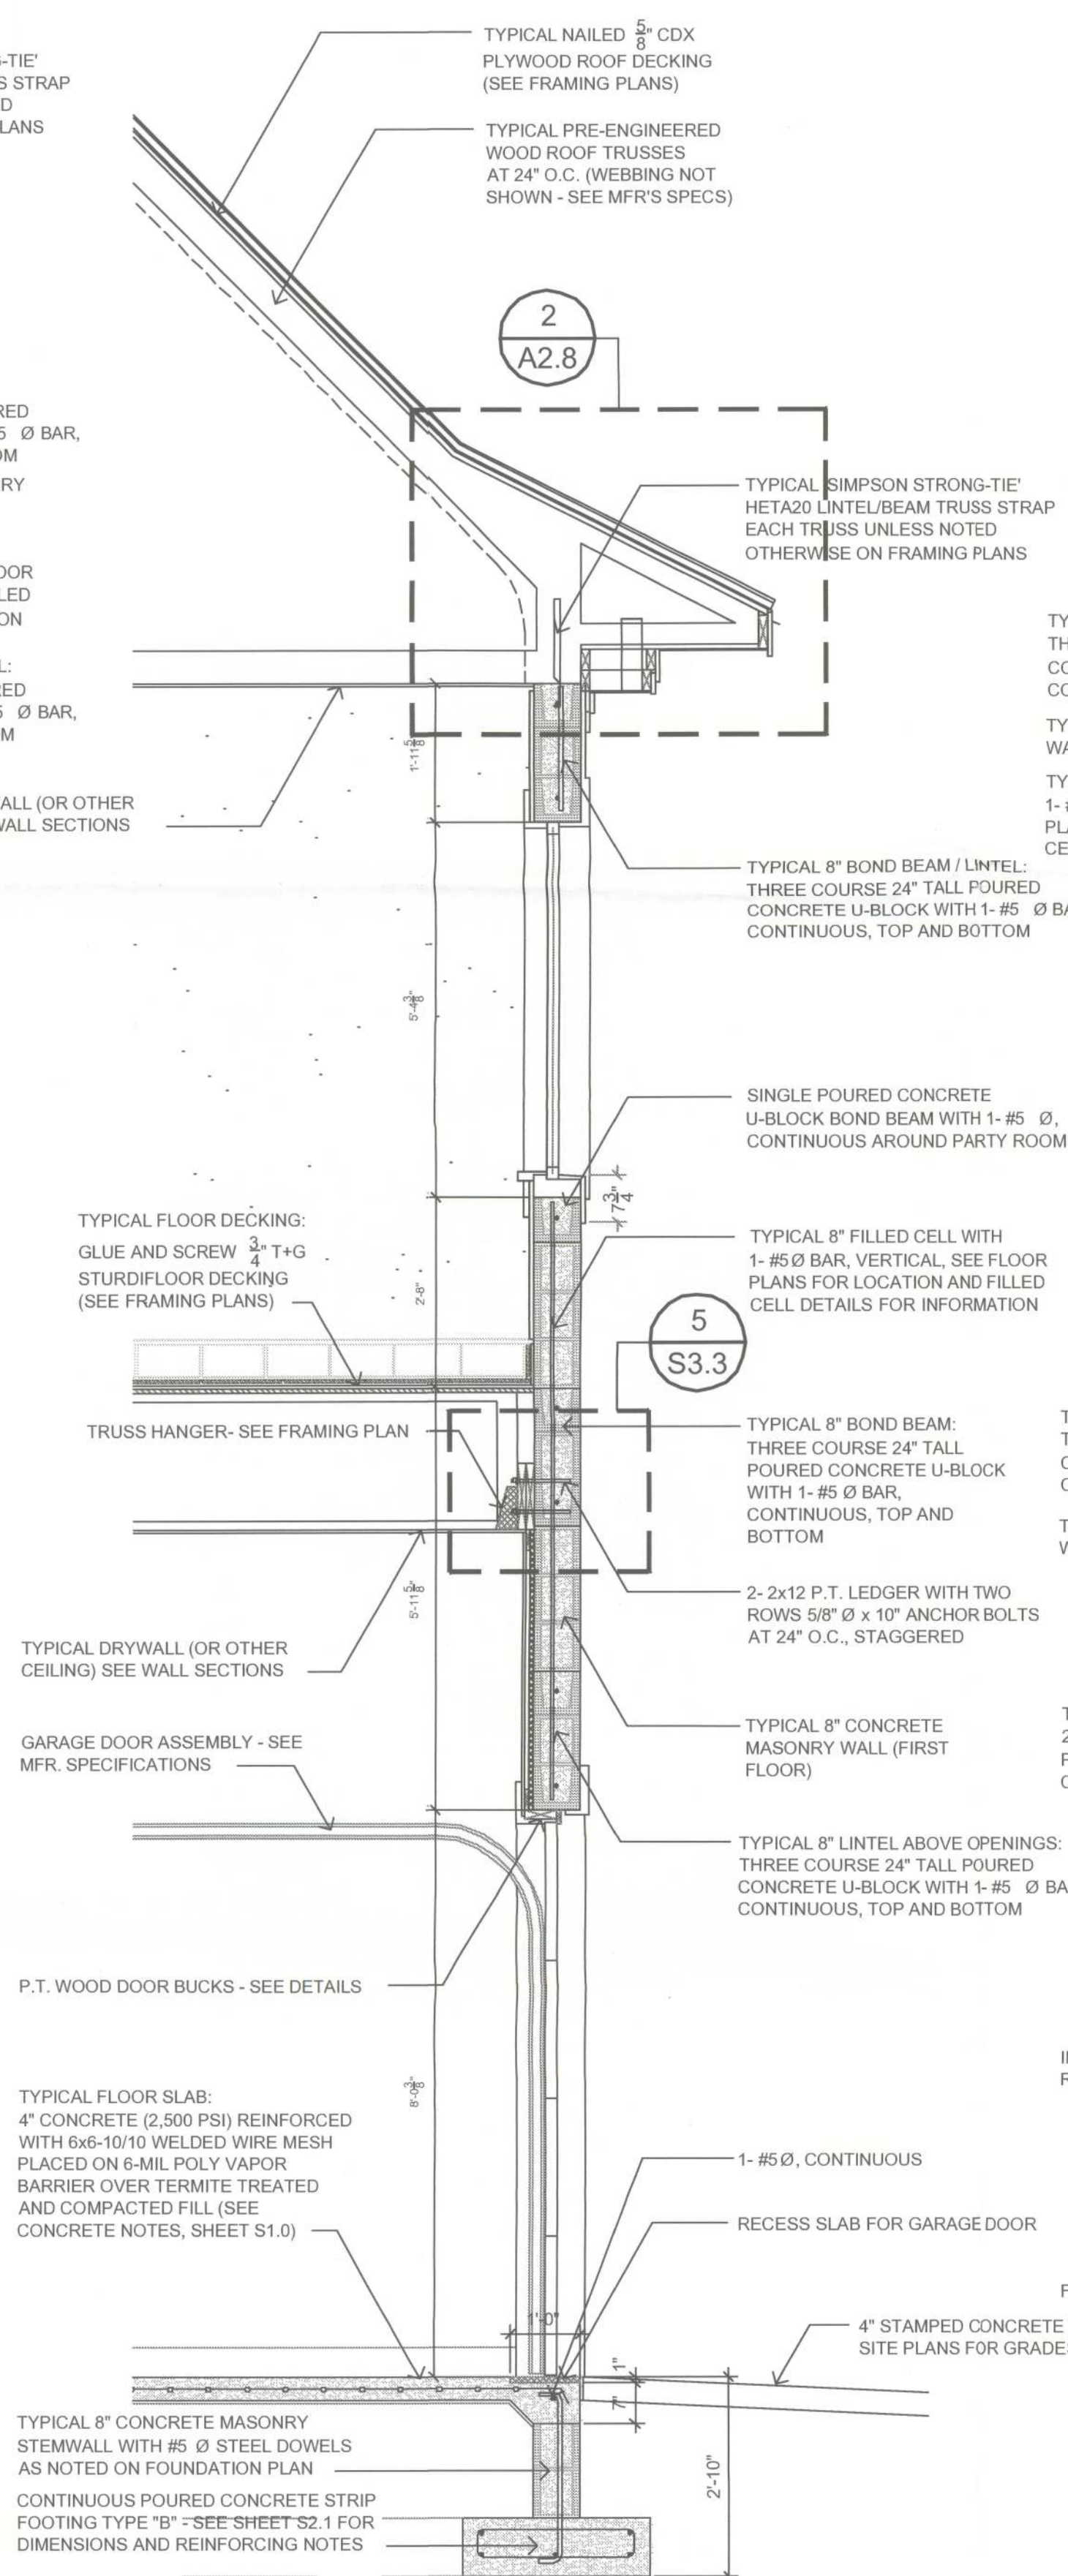


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SCALE: 3/4" = 1'-0"



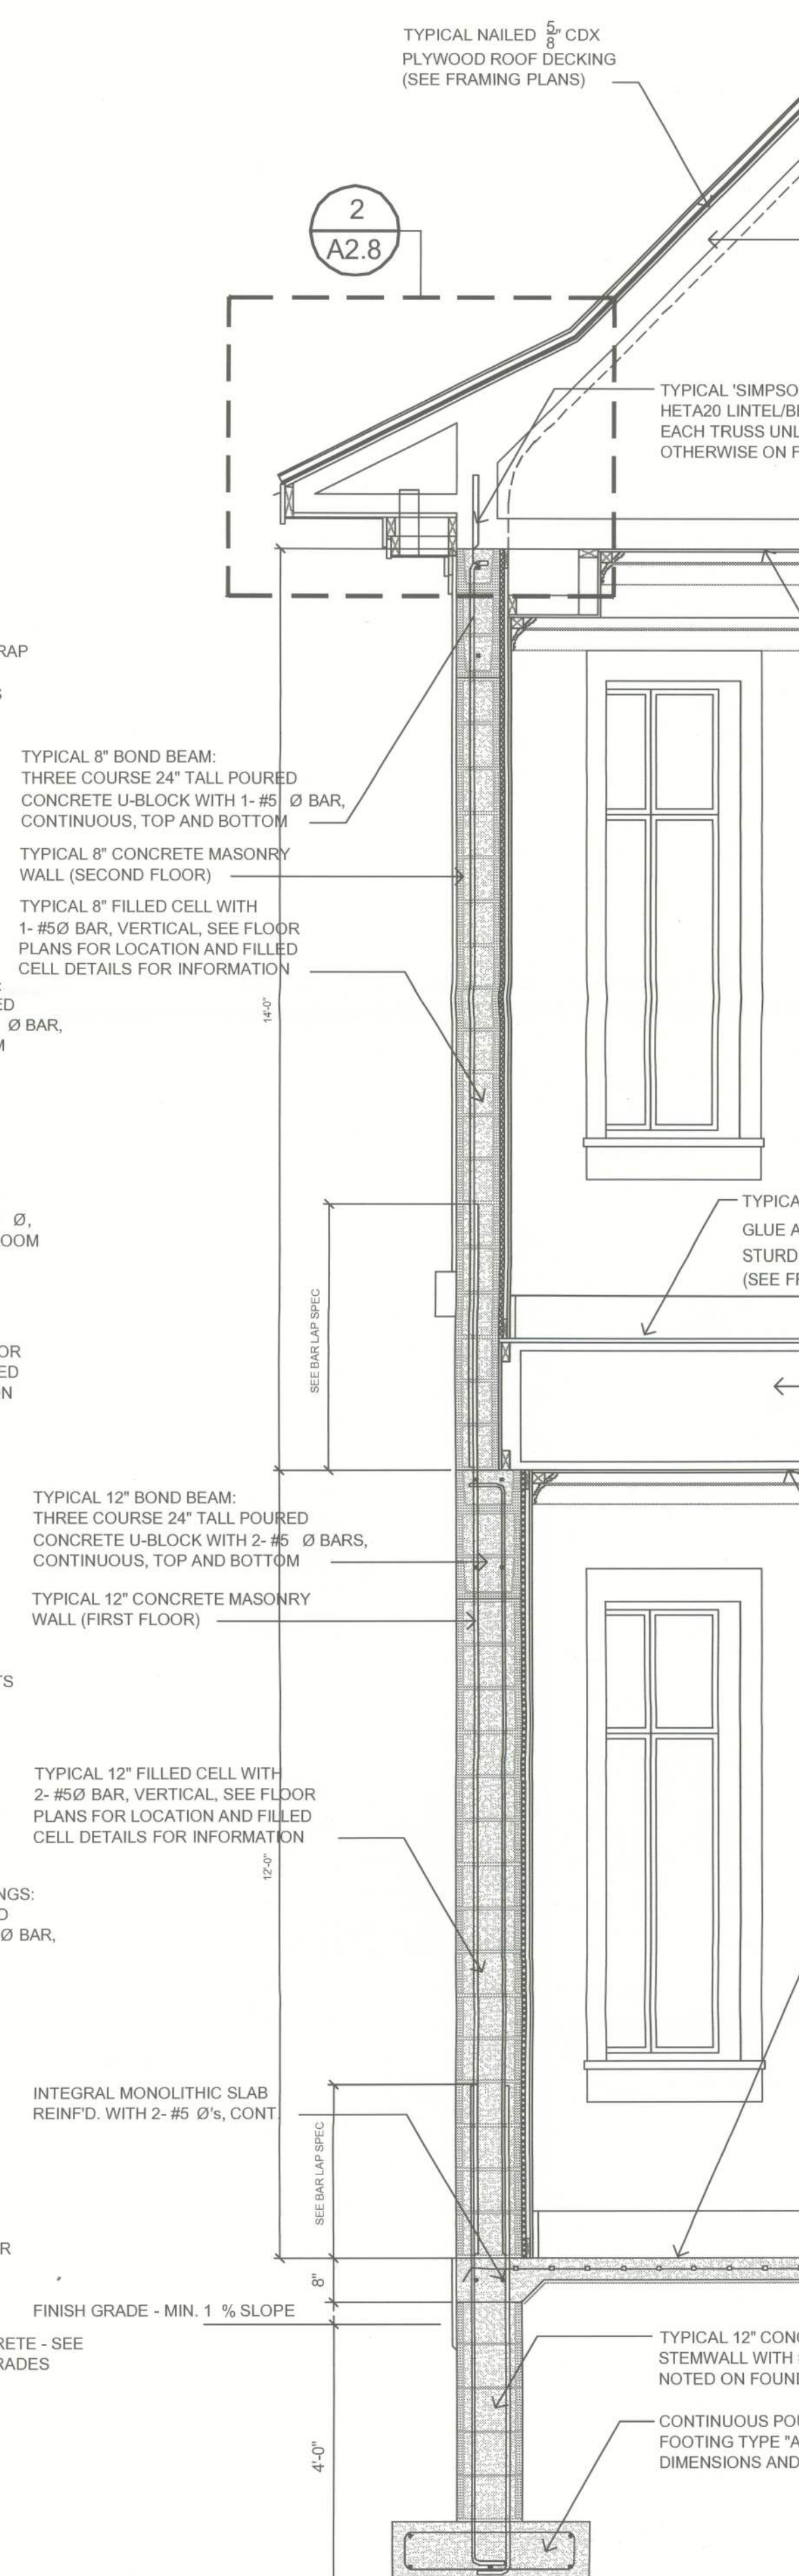
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S3.3

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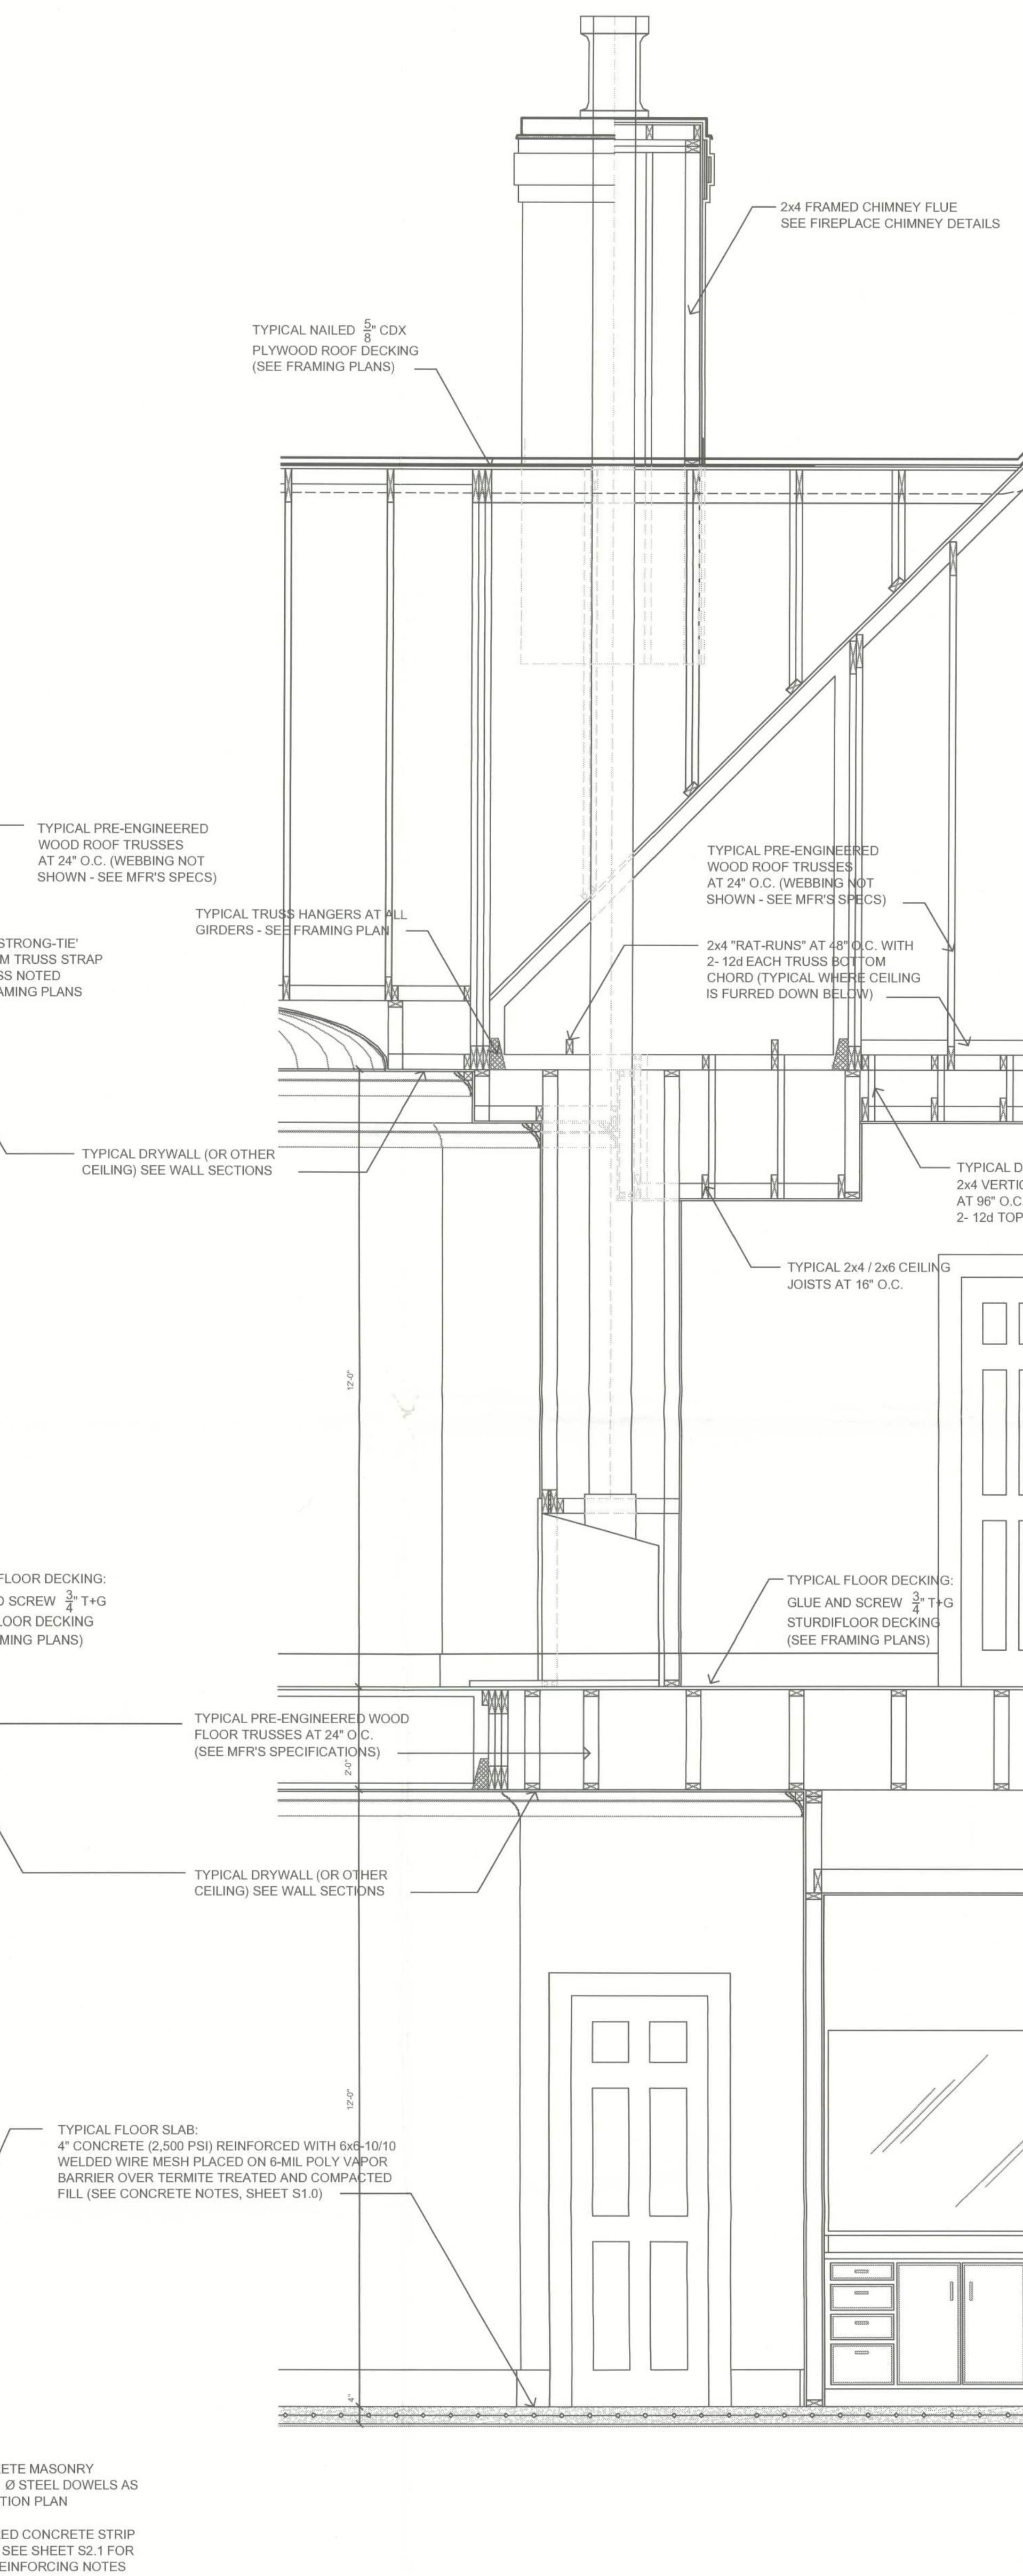
3 SECTION
S3.3

SCALE: 1/2" = 1'-0"



2 SECTION
S3.3

SCALE: 1/2" = 1'-0"



1 SECTION
S3.3

SCALE: 1/2" = 1'-0"

DATE	REMARK
09.07.12	PERMIT SET

Ken Eilers P.E. # 18243
9/11/12

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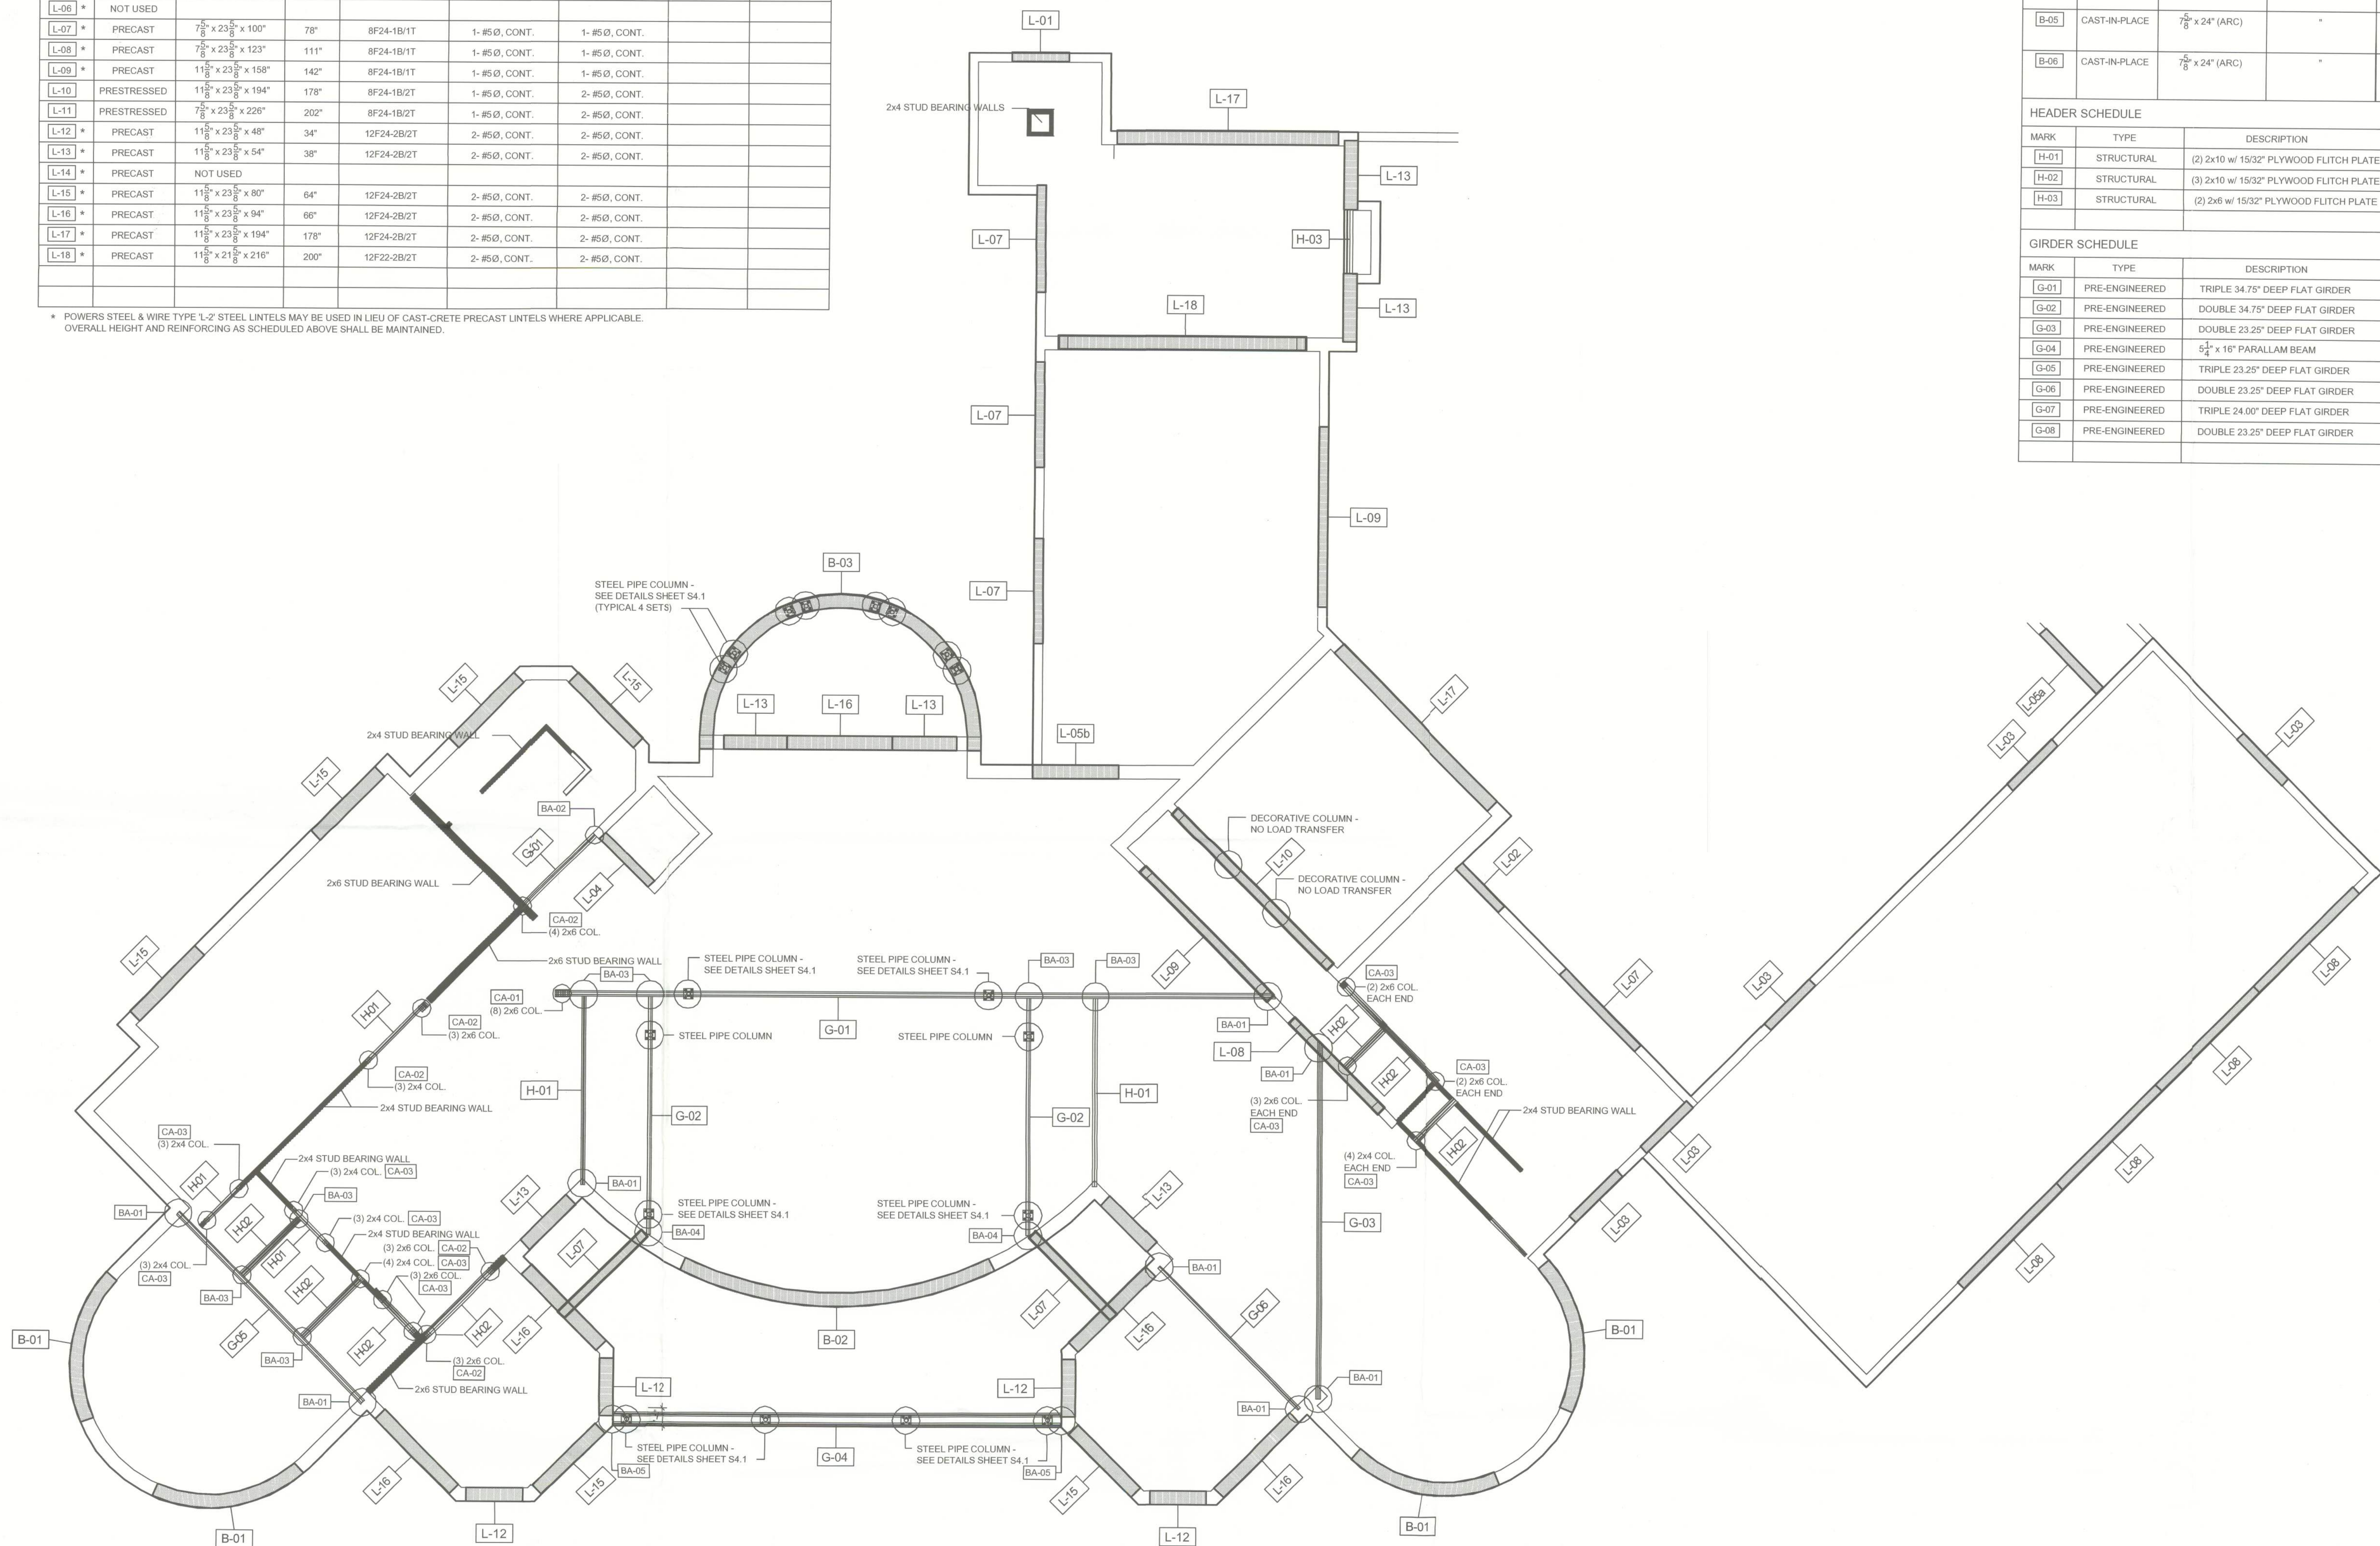
PLANS PREPARED BY AND UNDER THE
DIRECT SUPERVISION OF
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PROPOSED RESIDENCE
DR. AND MRS. MINESH PATEL
LOT 1, HILLS OF WINDSOR, COLUMBIA COUNTY, FL
PARCEL NO. 30-3S-16-02411-101

SHEET NUMBER
S3.3
PROJECT NO. 120101

LINTEL SCHEDULE								
MARK	TYPE	OVERALL DIMENSIONS	CLEAR SPAN	CAST CRETE DESIGNATION	BOTTOM REINFORCING	TOP REINFORCING	ALLOWED GRAVITY LOAD	ALLOWED UPLIFT LOAD
L-01 *	PRECAST	5'8" x 23'8" x 48"	34"	8F24-1B/1T	1- #5 @ . CONT.	1- #5 @ . CONT.		
L-02 *	PRECAST	7'8" x 23'8" x 54"	38"	8F24-1B/1T	1- #5 @ . CONT.	1- #5 @ . CONT.		
L-03 *	PRECAST	7'8" x 23'8" x 56"	44"	8F24-1B/1T	1- #5 @ . CONT.	1- #5 @ . CONT.		
L-04 *	PRECAST	7'8" x 23'8" x 60"	44"	8F24-1B/1T	1- #5 @ . CONT.	1- #5 @ . CONT.		
L-05a *	PRECAST	7'8" x 23'8" x 72"	54"	8F24-1B/1T	1- #5 @ . CONT.	1- #5 @ . CONT.		
L-05b *	PRECAST	11'8" x 23'8" x 72"	59"	8F24-1B/1T	1- #5 @ . CONT.	1- #5 @ . CONT.		
L-06 *	NOT USED							
L-07 *	PRECAST	7'8" x 23'8" x 100"	78"	8F24-1B/1T	1- #5 @ . CONT.	1- #5 @ . CONT.		
L-08 *	PRECAST	7'8" x 23'8" x 123"	111"	8F24-1B/1T	1- #5 @ . CONT.	1- #5 @ . CONT.		
L-09 *	PRECAST	11'8" x 23'8" x 158"	142"	8F24-1B/1T	1- #5 @ . CONT.	1- #5 @ . CONT.		
L-10	PRESTRESSED	11'8" x 23'8" x 194"	178"	8F24-1B/2T	1- #5 @ . CONT.	2- #5 @ . CONT.		
L-11	PRESTRESSED	7'8" x 23'8" x 226"	202"	8F24-1B/2T	1- #5 @ . CONT.	2- #5 @ . CONT.		
L-12 *	PRECAST	11'8" x 23'8" x 48"	34"	12F24-2B/2T	2- #5 @ . CONT.	2- #5 @ . CONT.		
L-13 *	PRECAST	11'8" x 23'8" x 54"	38"	12F24-2B/2T	2- #5 @ . CONT.	2- #5 @ . CONT.		
L-14 *	PRECAST	NOT USED						
L-15 *	PRECAST	11'8" x 23'8" x 80"	64"	12F24-2B/2T	2- #5 @ . CONT.	2- #5 @ . CONT.		
L-16 *	PRECAST	11'8" x 23'8" x 94"	66"	12F24-2B/2T	2- #5 @ . CONT.	2- #5 @ . CONT.		
L-17 *	PRECAST	11'8" x 23'8" x 194"	178"	12F24-2B/2T	2- #5 @ . CONT.	2- #5 @ . CONT.		
L-18 *	PRECAST	11'8" x 21'8" x 216"	200"	12F22-2B/2T	2- #5 @ . CONT.	2- #5 @ . CONT.		

* POWERS STEEL & WIRE TYPE 1-2" STEEL LINTELS MAY BE USED IN LIEU OF CAST-CRETE PRECAST LINTELS WHERE APPLICABLE. OVERALL HEIGHT AND REINFORCING AS SCHEDULED ABOVE SHALL BE MAINTAINED.



ALL TRUSS-TO-TRUSS CONNECTIONS DESIGNED AND PROVIDED BY TRUSS MANUFACTURER.

FIRST FLOOR LINTEL / BEAM PLAN

SCALE: 3/16" = 1'-0"

NOTE: POWERS STEEL & WIRE TYPE 1-2" STEEL LINTELS MAY BE USED IN LIEU OF CAST-CRETE PRECAST LINTELS AND CAST-IN-PLACE BEAMS WHERE APPLICABLE. OVERALL HEIGHT AND REINFORCING AS SCHEDULED ABOVE SHALL BE MAINTAINED.

BEAM SCHEDULE				
MARK	TYPE	DIMENSIONS	REINFORCING	REMARKS
B-01	CAST-IN-PLACE	11'8" x 24" (ARC)	SEE DETAILS SHEET S4.0	CURVED SECTION OPTIONAL MODIFIED POWERS STEEL LINTEL WITH MASONRY IS ACCEPTABLE ALTERNATIVE
B-02	CAST-IN-PLACE	11'8" x 24" (ARC)	"	CURVED SECTION OPTIONAL MODIFIED POWERS STEEL LINTEL WITH MASONRY IS ACCEPTABLE ALTERNATIVE
B-03	CAST-IN-PLACE	15'8" x 28" (ARC)	"	CURVED SECTION
B-04	CAST-IN-PLACE	7'8" x 24" (ARC)	"	CURVED SECTION OPTIONAL MODIFIED POWERS STEEL LINTEL WITH MASONRY IS ACCEPTABLE ALTERNATIVE
B-05	CAST-IN-PLACE	7'8" x 24" (ARC)	"	CURVED SECTION OPTIONAL MODIFIED POWERS STEEL LINTEL WITH MASONRY IS ACCEPTABLE ALTERNATIVE
B-06	CAST-IN-PLACE	7'8" x 24" (ARC)	"	CURVED SECTION OPTIONAL MODIFIED POWERS STEEL LINTEL WITH MASONRY IS ACCEPTABLE ALTERNATIVE

HEADER SCHEDULE			
MARK	TYPE	DESCRIPTION	REMARKS
H-01	STRUCTURAL	(2) 2x10 w/ 15/32" PLYWOOD FLITCH PLATE	
H-02	STRUCTURAL	(3) 2x10 w/ 15/32" PLYWOOD FLITCH PLATES	
H-03	STRUCTURAL	(2) 2x6 w/ 15/32" PLYWOOD FLITCH PLATE	

GIRDER SCHEDULE			
MARK	TYPE	DESCRIPTION	REMARKS
G-01	PRE-ENGINEERED	TRIPLE 34.75" DEEP FLAT GIRDER	
G-02	PRE-ENGINEERED	DOUBLE 34.75" DEEP FLAT GIRDER	
G-03	PRE-ENGINEERED	DOUBLE 23.25" DEEP FLAT GIRDER	
G-04	PRE-ENGINEERED	5/4" x 16" PARALLAM BEAM	
G-05	PRE-ENGINEERED	TRIPLE 23.25" DEEP FLAT GIRDER	
G-06	PRE-ENGINEERED	DOUBLE 23.25" DEEP FLAT GIRDER	
G-07	PRE-ENGINEERED	TRIPLE 24.00" DEEP FLAT GIRDER	
G-08	PRE-ENGINEERED	DOUBLE 23.25" DEEP FLAT GIRDER	

BEAM ANCHORAGE SCHEDULE			
MARK	MANUFACTURER	ANCHOR	REMARKS
BA-01	SIMPSON STRONG-TIE	HTT5	TAPCON TO WALL - NAIL TO BEAM
BA-02	SIMPSON STRONG-TIE	HUC412	TAPCON TO WALL - NAIL TO BEAM
BA-03	SIMPSON STRONG-TIE	HGUS412	NAIL TO BEAM
BA-04	SIMPSON STRONG-TIE	LS90	NAIL TO BEAM - TAPCON TO WALL WITH (8) - 1/4" x 2-3/4" TAPCONS
BA-05	SHOP FABRICATED	(4x4) 1/4" ANGLE IRON (12" LONG)	(2) - 1/2" x 6" EXPANSION BOLTS

COLUMN ANCHORAGE SCHEDULE				
MARK	MANUFACTURER	ANCHOR TOP	ANCHOR BOTTOM	REMARKS
CA-01	SIMPSON STRONG-TIE	(2) HTS20 STRAPS	HTT5	
CA-02	SIMPSON STRONG-TIE	(2) MTS16 STRAPS	LTT20B	
CA-03	SIMPSON STRONG-TIE	(1) LSTA STRAP	SP46 OR SSP CLIP	EACH STUD

DATE	REMARK
08/07/12	PERMIT SET

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PETER WOODS, RESIDENTIAL DESIGNER
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(504) 575-4984

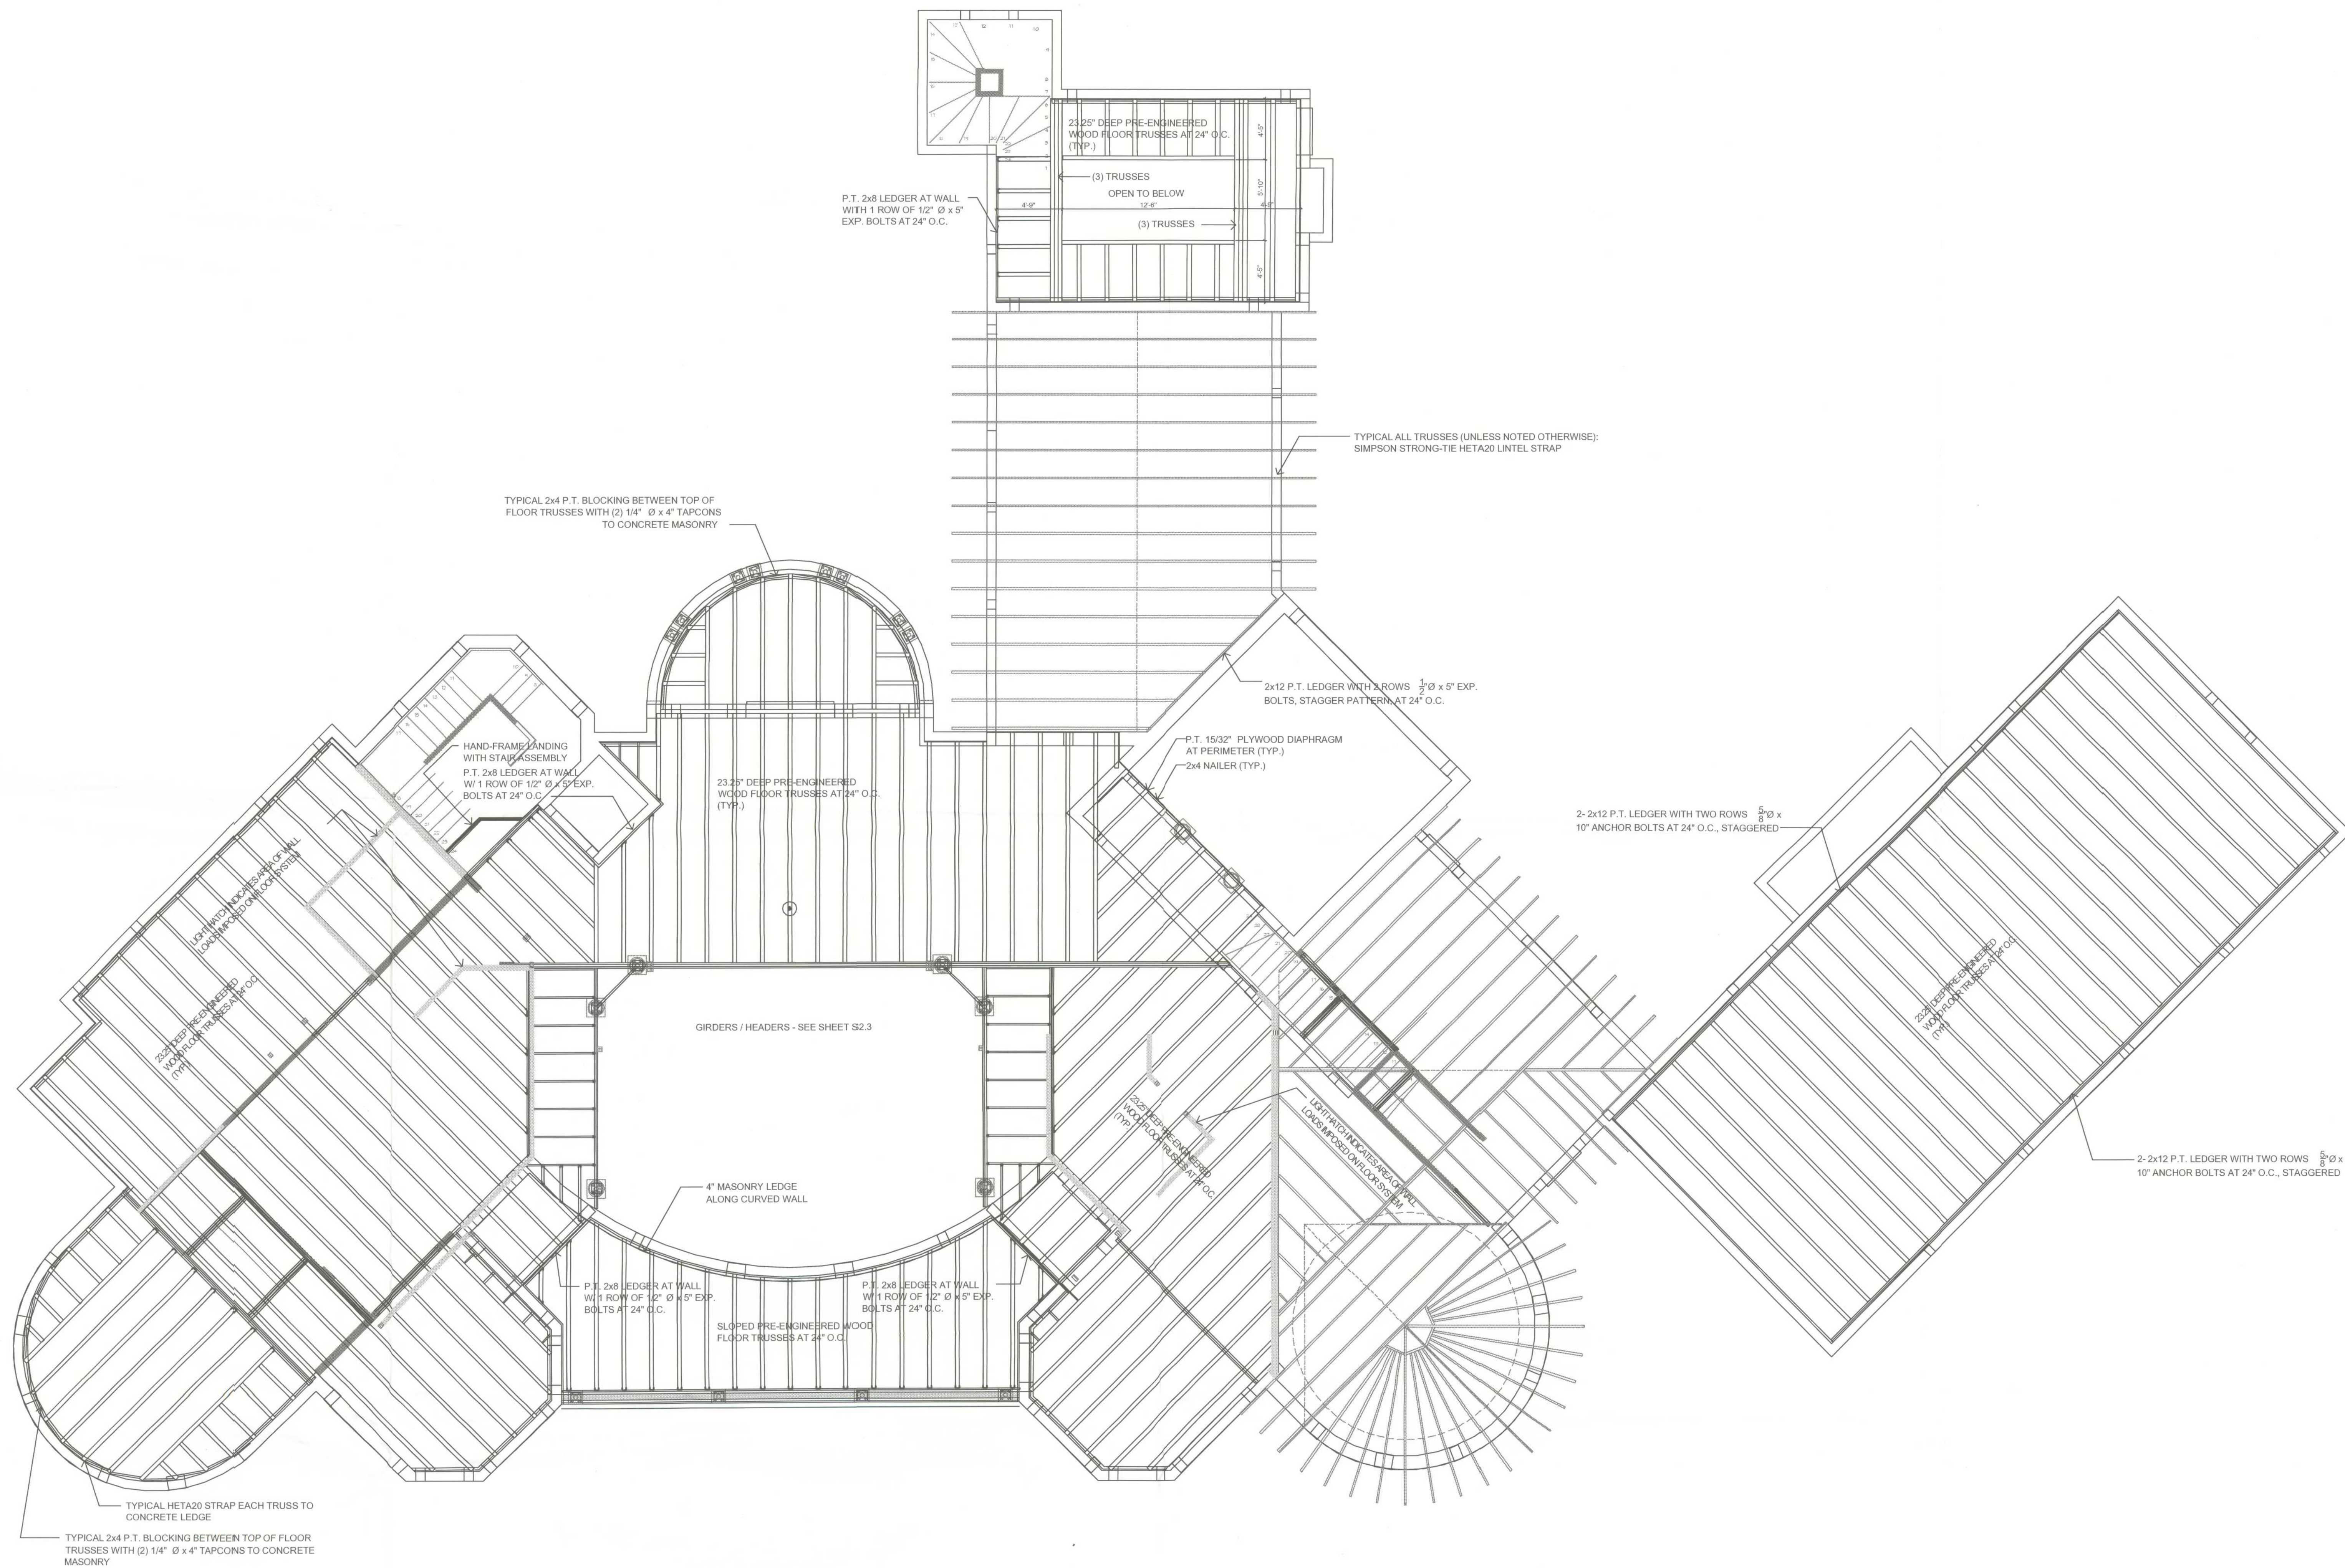
PROPOSED RESIDENCE
DR. AND MRS. MINESH PATEL
LOT 1, HILLS OF WINDSOR, COLUMBIA COUNTY, FL
PARCEL NO. 30-3S-16-02411-101

SHEET NUMBER

S2.3

PROJECT NO. 120101

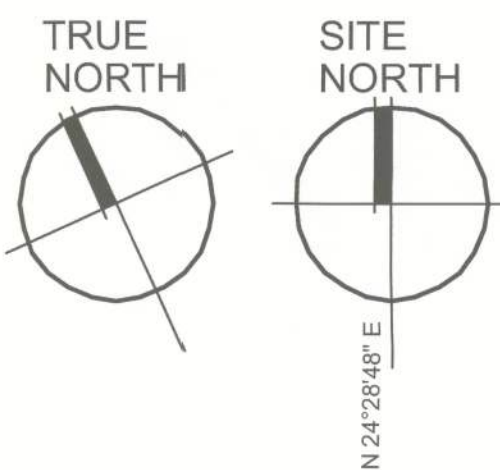
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VAPOR BARRIER BETWEEN WOOD TRUSSES AND DIRECT CONTACT TO CONCRETE OR CONCRETE MASONRY.

ALL TRUSS-TO-TRUSS CONNECTORS TO BE FURNISHED BY TRUSS MANUFACTURER.

TYPICAL TRUSS HANGERS PER TRUSS MANUFACTURER'S SPECS.



SECOND FLOOR FRAMING PLAN

LOWER ROOF FRAMING SHOWN FOR REFERENCE ONLY

SCALE: 3/16" = 1'-0"

DATE	REMARK
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Ken Ehlers P.E. # 18243

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PROPOSED RESIDENCE
DR. AND MRS. MINESH PATEL
LOT 1, HILLS OF WINDSOR, COLUMBIA COUNTY, FL
PARCEL NO. 30-3S-16-02411-101

SHEET NUMBER
S2.4
PROJECT NO. 120101

LINTEL SCHEDULE								
MARK	TYPE	OVERALL DIMENSIONS	CLEAR SPAN	CAST CRETE DESIGNATION	BOTTOM REINFORCING	TOP REINFORCING	ALLOWED GRAVITY LOAD	ALLOWED UPLIFT LOAD
L-01 *	PRECAST	7'8" x 23'8" x 48"	34"	8F24-1B/1T	1- #5 @ .CONT.	1- #5 @ .CONT.		
L-02 *	PRECAST	7'8" x 23'8" x 54"	38"	8F24-1B/1T	1- #5 @ .CONT.	1- #5 @ .CONT.		
L-03 *	PRECAST	7'8" x 23'8" x 56"	44"	8F24-1B/1T	1- #5 @ .CONT.	1- #5 @ .CONT.		
L-04 *	PRECAST	7'8" x 23'8" x 60"	44"	8F24-1B/1T	1- #5 @ .CONT.	1- #5 @ .CONT.		
L-05 *	PRECAST	7'8" x 23'8" x 72"	54"	8F24-1B/1T	1- #5 @ .CONT.	1- #5 @ .CONT.		
L-06 *	PRECAST	11'8" x 23'8" x 72"	59"	8F24-1B/1T	1- #5 @ .CONT.	1- #5 @ .CONT.		
L-07 *	NOT USED							
L-07 *	PRECAST	7'8" x 23'8" x 100"	78"	8F24-1B/1T	1- #5 @ .CONT.	1- #5 @ .CONT.		
L-08 *	PRECAST	7'8" x 23'8" x 123"	111"	8F24-1B/1T	1- #5 @ .CONT.	1- #5 @ .CONT.		
L-09 *	PRECAST	11'8" x 23'8" x 158"	142"	8F24-1B/1T	1- #5 @ .CONT.	1- #5 @ .CONT.		
L-10 *	PRESTRESSED	11'8" x 23'8" x 194"	178"	8F24-1B/2T	1- #5 @ .CONT.	2- #5 @ .CONT.		
L-11 *	PRESTRESSED	7'8" x 23'8" x 228"	202"	8F24-1B/2T	1- #5 @ .CONT.	2- #5 @ .CONT.		
L-12 *	PRECAST	11'8" x 23'8" x 48"	34"	12F24-2B/2T	2- #5 @ .CONT.	2- #5 @ .CONT.		
L-13 *	PRECAST	11'8" x 23'8" x 54"	38"	12F24-2B/2T	2- #5 @ .CONT.	2- #5 @ .CONT.		
L-14 *	PRECAST	NOT USED						
L-15 *	PRECAST	11'8" x 23'8" x 80"	64"	12F24-2B/2T	2- #5 @ .CONT.	2- #5 @ .CONT.		
L-16 *	PRECAST	11'8" x 23'8" x 94"	66"	12F24-2B/2T	2- #5 @ .CONT.	2- #5 @ .CONT.		
L-17 *	PRECAST	11'8" x 23'8" x 194"	178"	12F24-2B/2T	2- #5 @ .CONT.	2- #5 @ .CONT.		
L-18 *	PRECAST	11'8" x 21'8" x 216"	200"	12F22-2B/2T	2- #5 @ .CONT.	2- #5 @ .CONT.		

* POWERS STEEL & WIRE TYPE L-2" STEEL LINTELS MAY BE USED IN LIEU OF CAST-CRETE PRECAST LINTELS WHERE APPLICABLE. OVERALL HEIGHT AND REINFORCING AS SCHEDULED ABOVE SHALL BE MAINTAINED.

BEAM SCHEDULE				
MARK	TYPE	DIMENSIONS	REINFORCING	REMARKS
B-01	CAST-IN-PLACE	11'8" x 24" (ARC)	SEE DETAILS SHEET S4.0	CURVED SECTION OPTIONAL MODIFIED POWERS STEEL LINTEL WITH MASONRY IS ACCEPTABLE ALTERNATIVE
B-02	CAST-IN-PLACE	11'8" x 24" (ARC)	*	CURVED SECTION OPTIONAL MODIFIED POWERS STEEL LINTEL WITH MASONRY IS ACCEPTABLE ALTERNATIVE
B-03	CAST-IN-PLACE	15'8" x 28" (ARC)	*	CURVED SECTION
B-04	CAST-IN-PLACE	7'8" x 24" (ARC)	*	CURVED SECTION OPTIONAL MODIFIED POWERS STEEL LINTEL WITH MASONRY IS ACCEPTABLE ALTERNATIVE
B-05	CAST-IN-PLACE	5'8" x 24" (ARC)	*	CURVED SECTION OPTIONAL MODIFIED POWERS STEEL LINTEL WITH MASONRY IS ACCEPTABLE ALTERNATIVE
B-06	CAST-IN-PLACE	7'8" x 24" (ARC)	*	CURVED SECTION OPTIONAL MODIFIED POWERS STEEL LINTEL WITH MASONRY IS ACCEPTABLE ALTERNATIVE

HEADER SCHEDULE			
MARK	TYPE	DESCRIPTION	REMARKS
H-01	STRUCTURAL	(2) 2x10 w/ 15/32" PLYWOOD FLITCH PLATE	
H-02	STRUCTURAL	(3) 2x10 w/ 15/32" PLYWOOD FLITCH PLATES	
H-03	STRUCTURAL	(2) 2x6 w/ 15/32" PLYWOOD FLITCH PLATE	

GIRDER SCHEDULE			
MARK	TYPE	DESCRIPTION	REMARKS
G-01	PRE-ENGINEERED	TRIPLE 34.75" DEEP FLAT GIRDER	
G-02	PRE-ENGINEERED	DOUBLE 34.75" DEEP FLAT GIRDER	
G-03	PRE-ENGINEERED	DOUBLE 23.25" DEEP FLAT GIRDER	
G-04	PRE-ENGINEERED	5 1/2" x 16" PARALLAM BEAM	
G-05	PRE-ENGINEERED	TRIPLE 23.25" DEEP FLAT GIRDER	
G-06	PRE-ENGINEERED	DOUBLE 23.25" DEEP FLAT GIRDER	
G-07	PRE-ENGINEERED	TRIPLE 24.00" DEEP FLAT GIRDER	
G-08	PRE-ENGINEERED	DOUBLE 23.25" DEEP FLAT GIRDER	

DATE	REMARK
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Ken Eilers P.E. # 18243

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LICENSED PROFESSIONAL ENGINEER

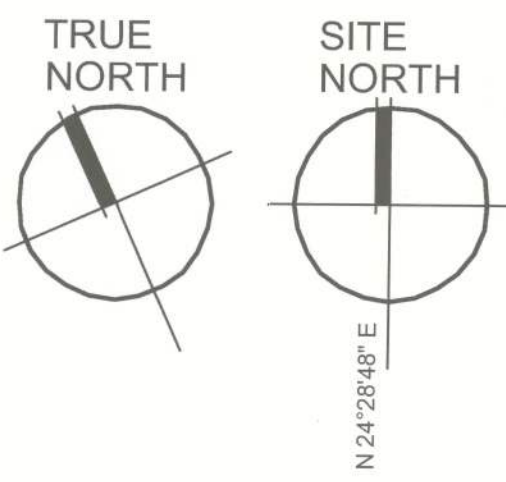
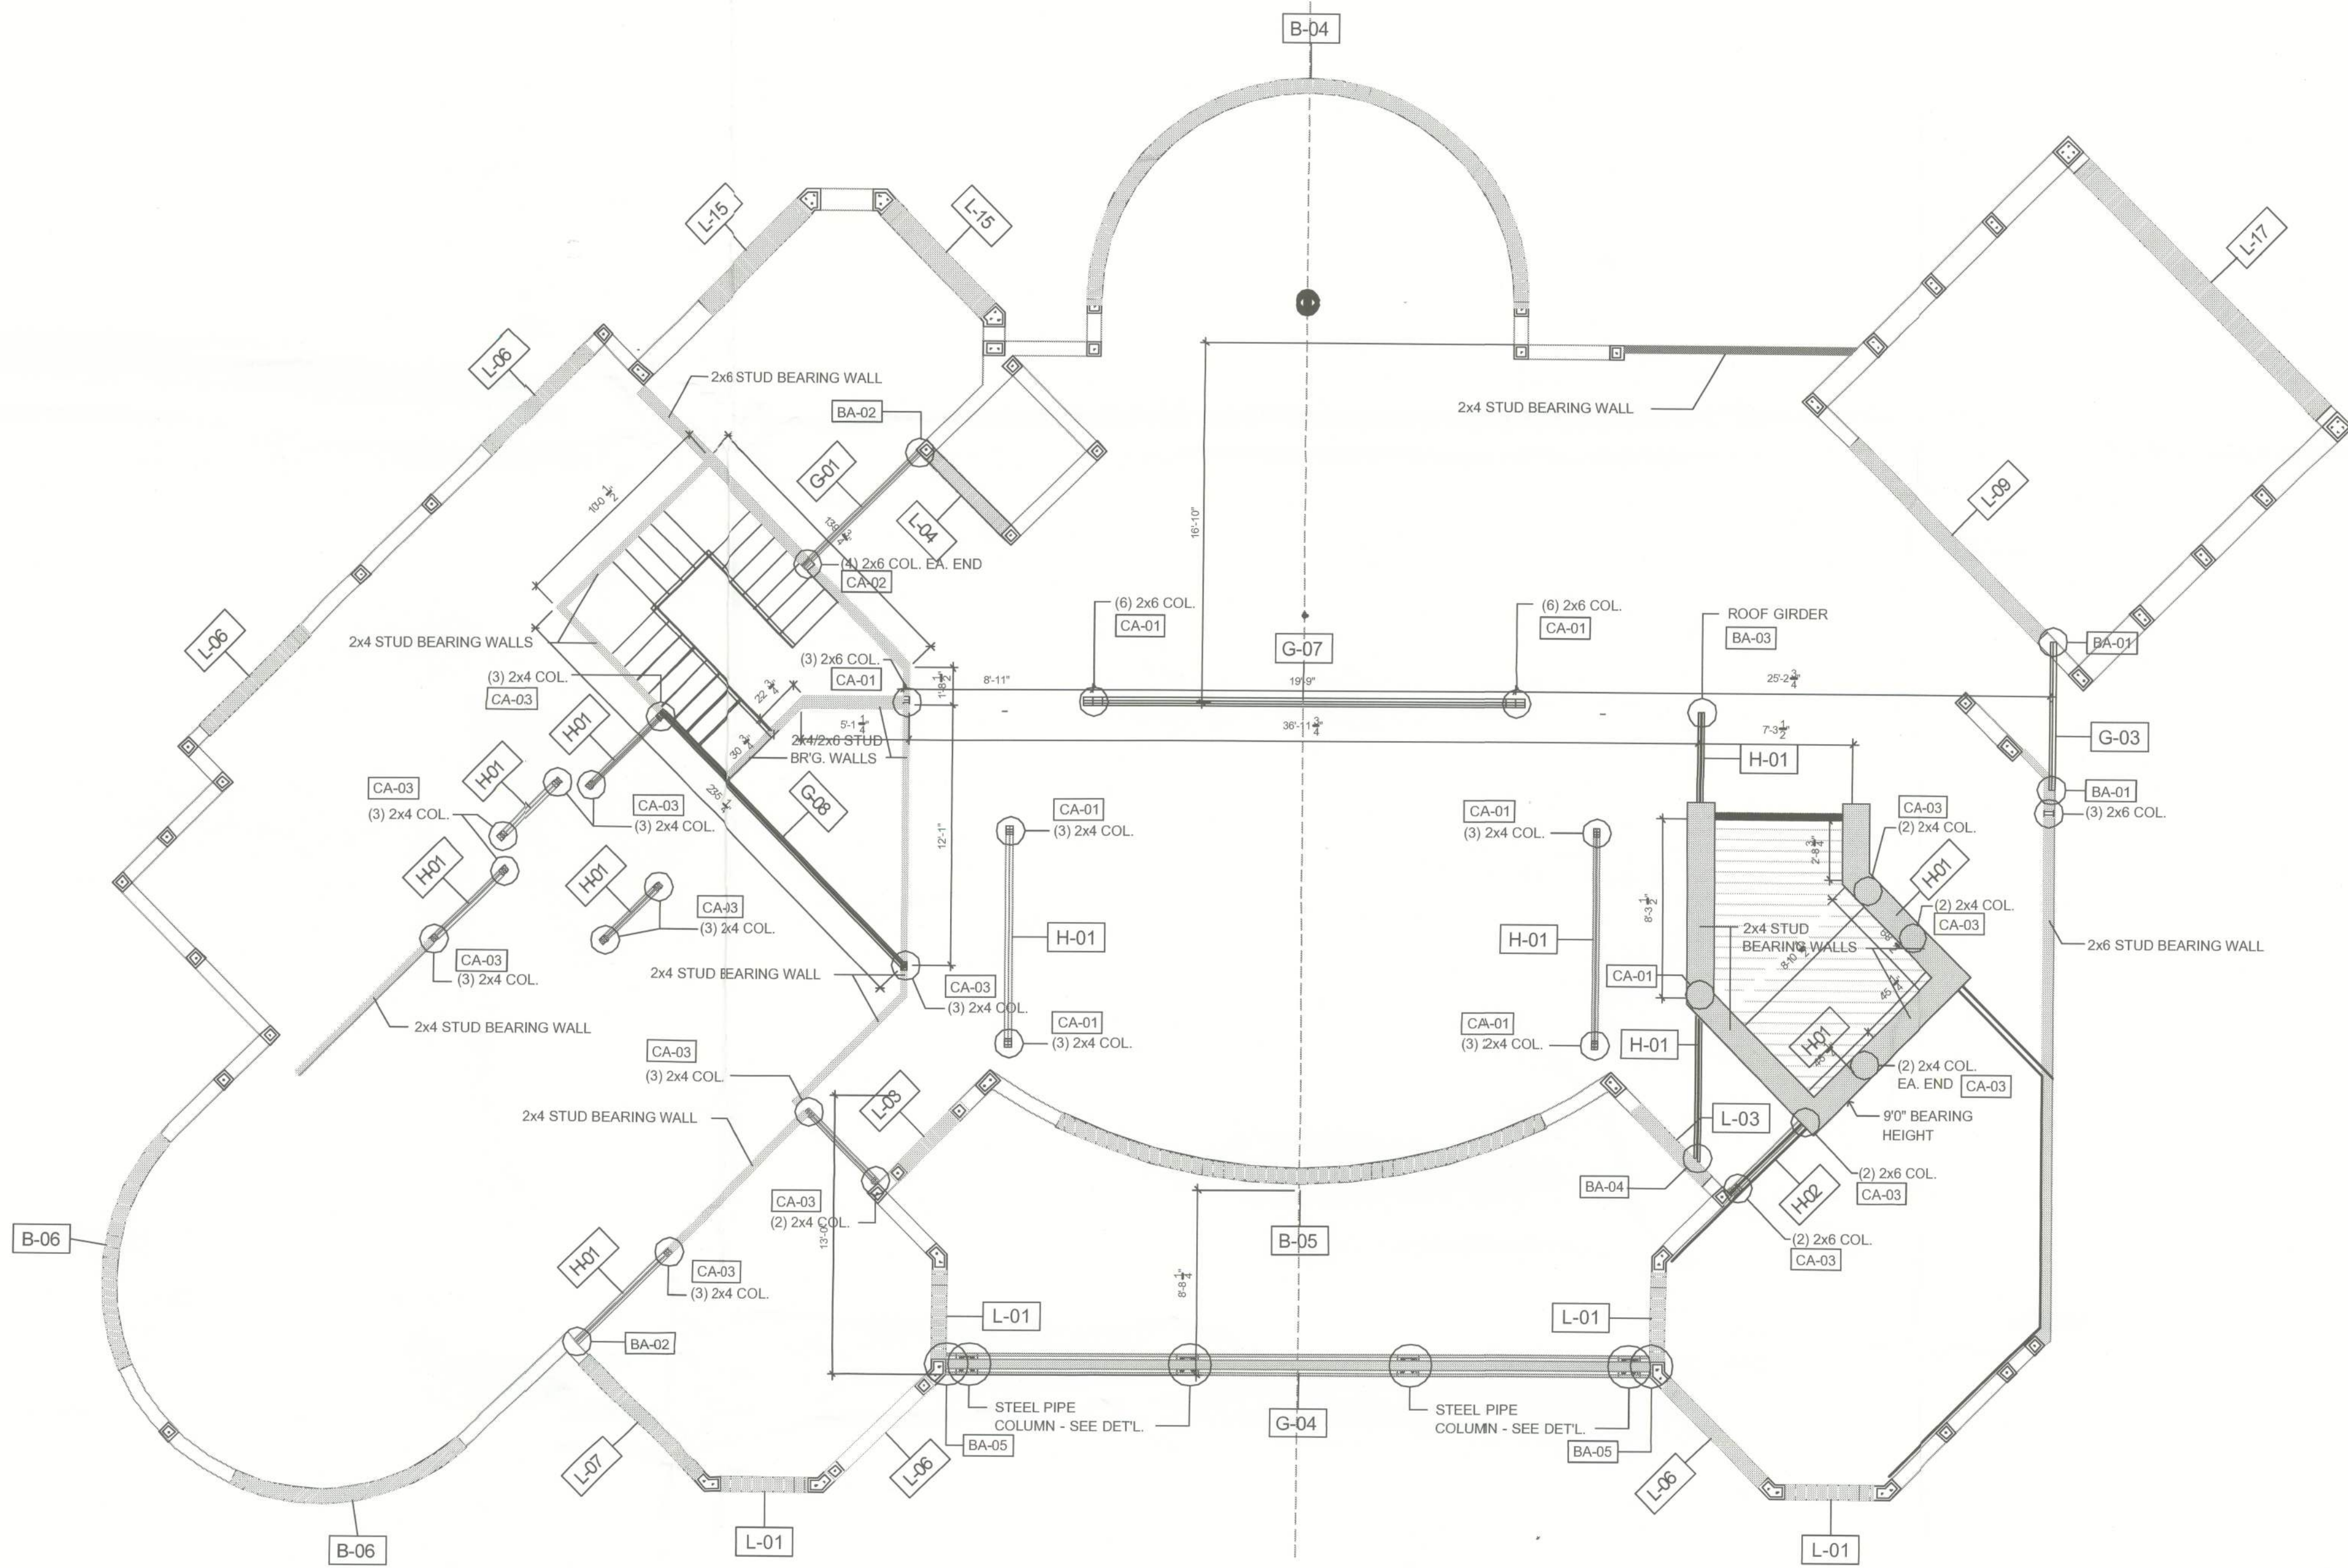
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DIRECT SUPERVISION OF
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AND YONIS B. EILERS, P.E.
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PROPOSED RESIDENCE
DR. AND MRS. MINESH PATEL
LOT 1, HILLS OF WINDSOR, COLUMBIA COUNTY, FL
PARCEL NO. 30-3S-16-02411-101

SHEET NUMBER

S2.5

PROJECT NO. 120101



ALL TRUSS-TO-TRUSS CONNECTIONS DESIGNED
AND PROVIDED BY TRUSS MANUFACTURER.

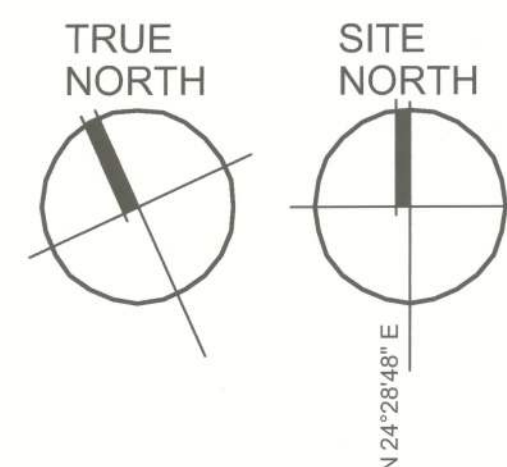
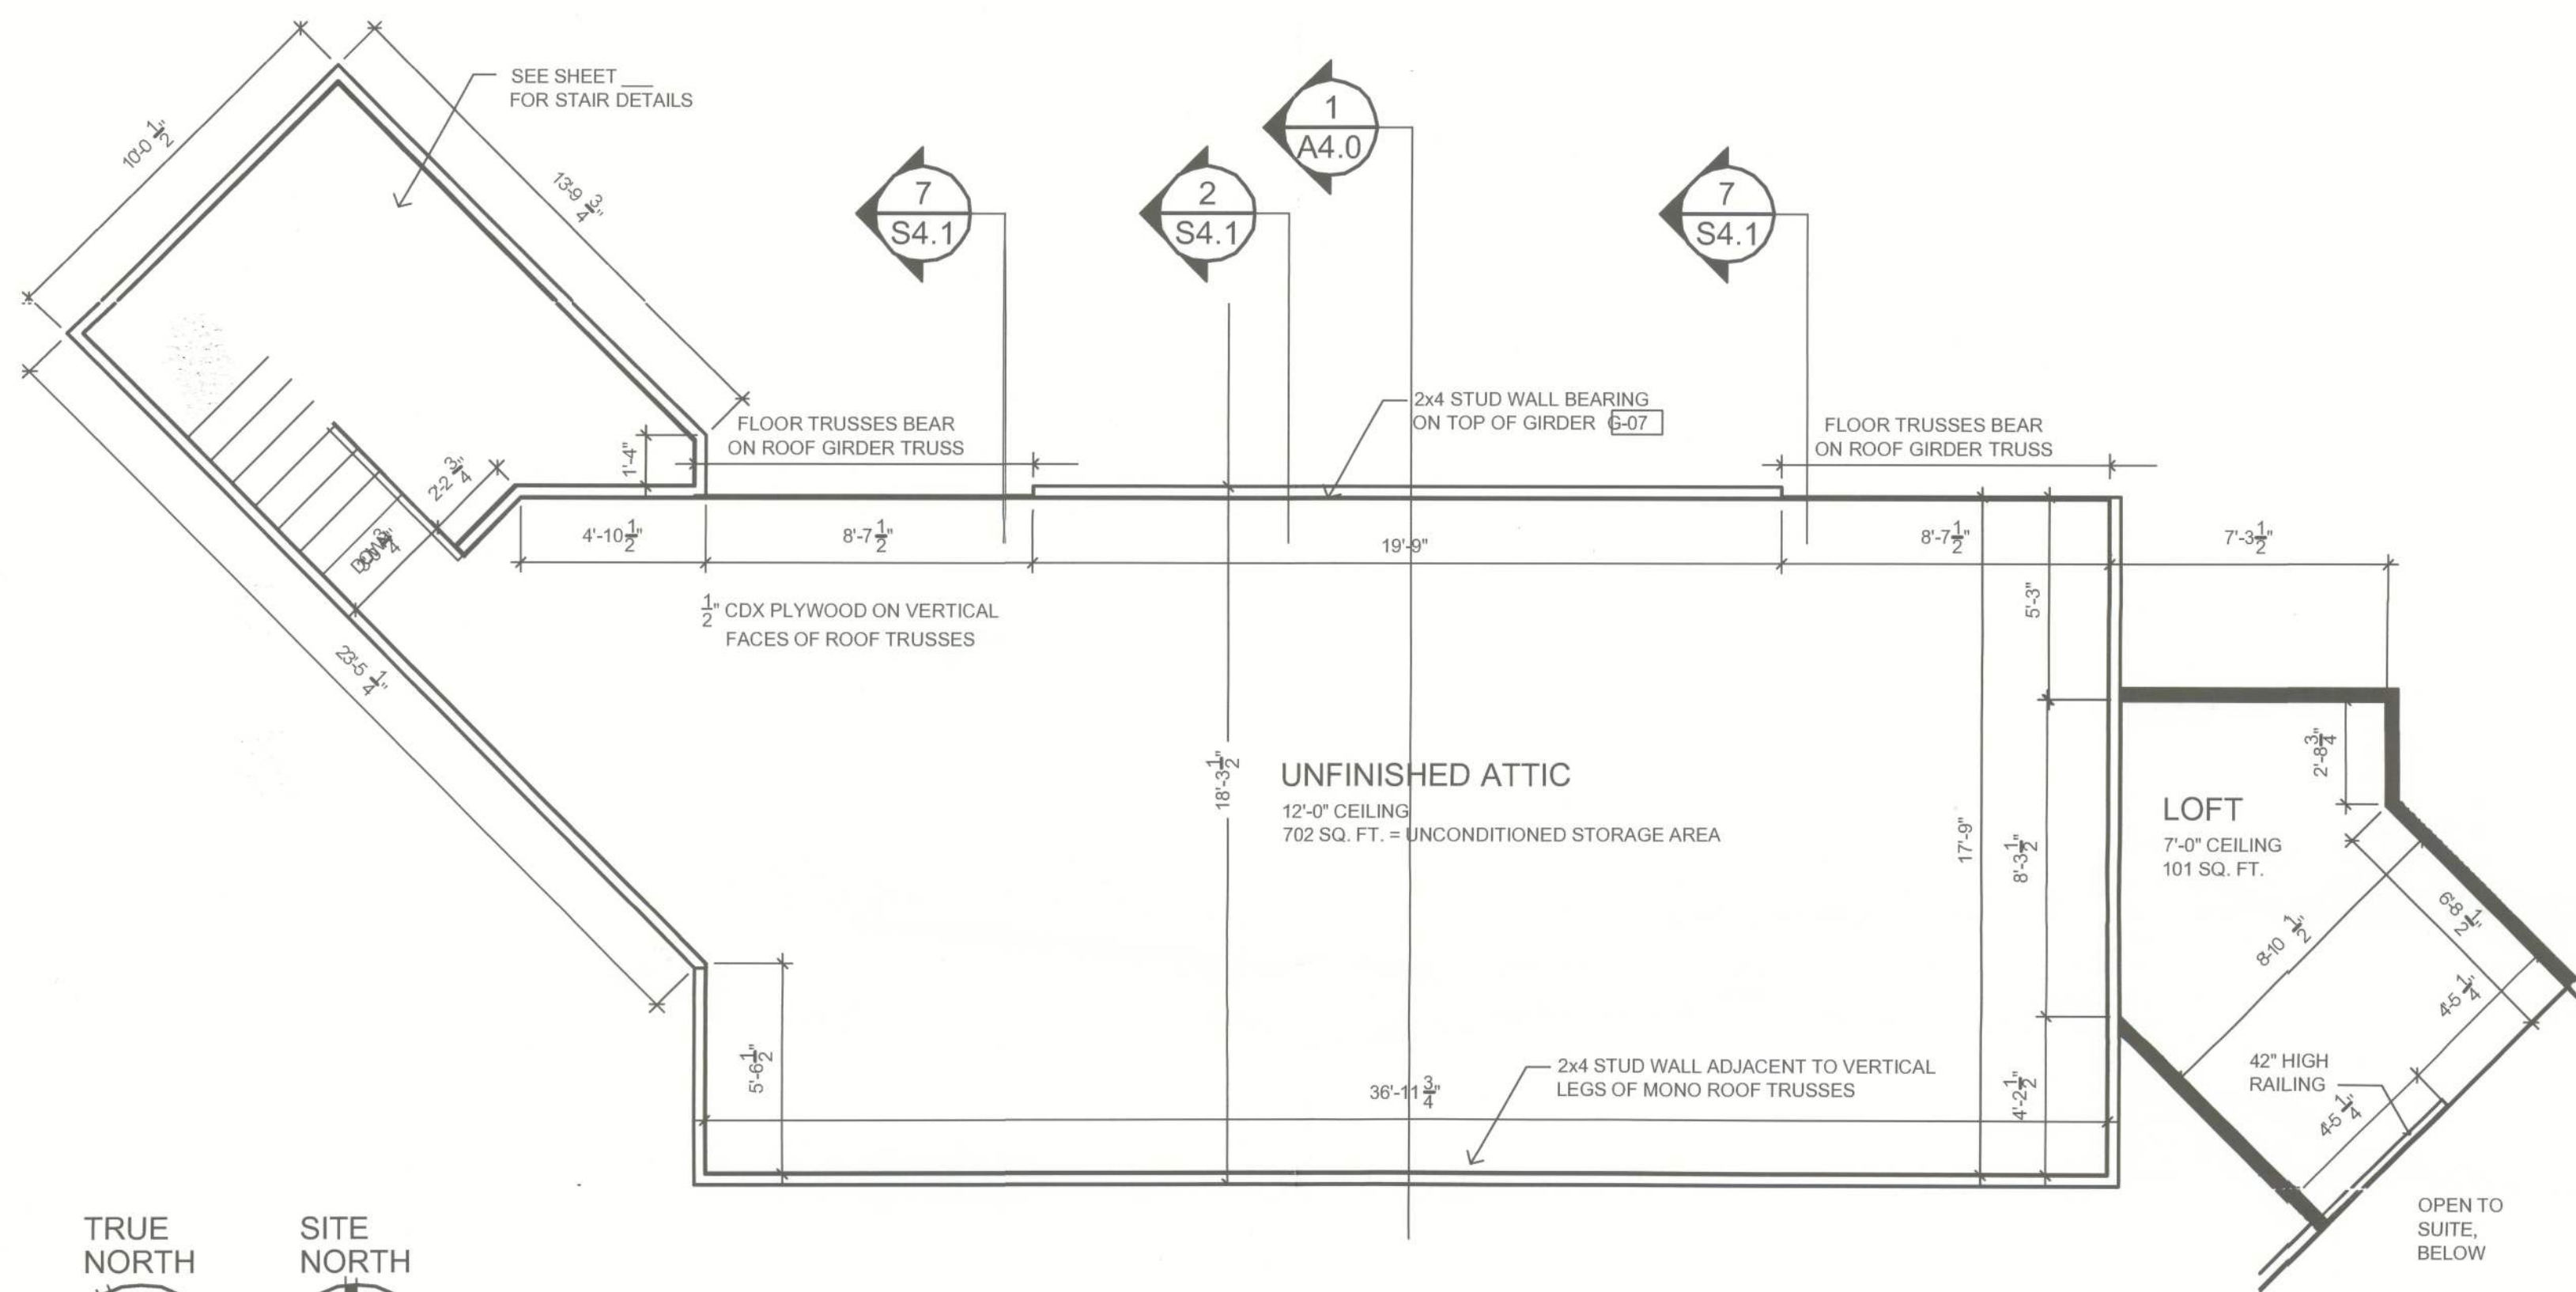
SECOND FLOOR LINTEL/BEAM PLAN

NOTE:
POWERS STEEL & WIRE TYPE L-2" STEEL LINTELS MAY BE USED IN LIEU OF CAST-CRETE PRECAST LINTELS WHERE APPLICABLE. OVERALL HEIGHT AND REINFORCING AS
SCHEDULED ABOVE SHALL BE MAINTAINED.

SCALE: 3/16" = 1'-0"

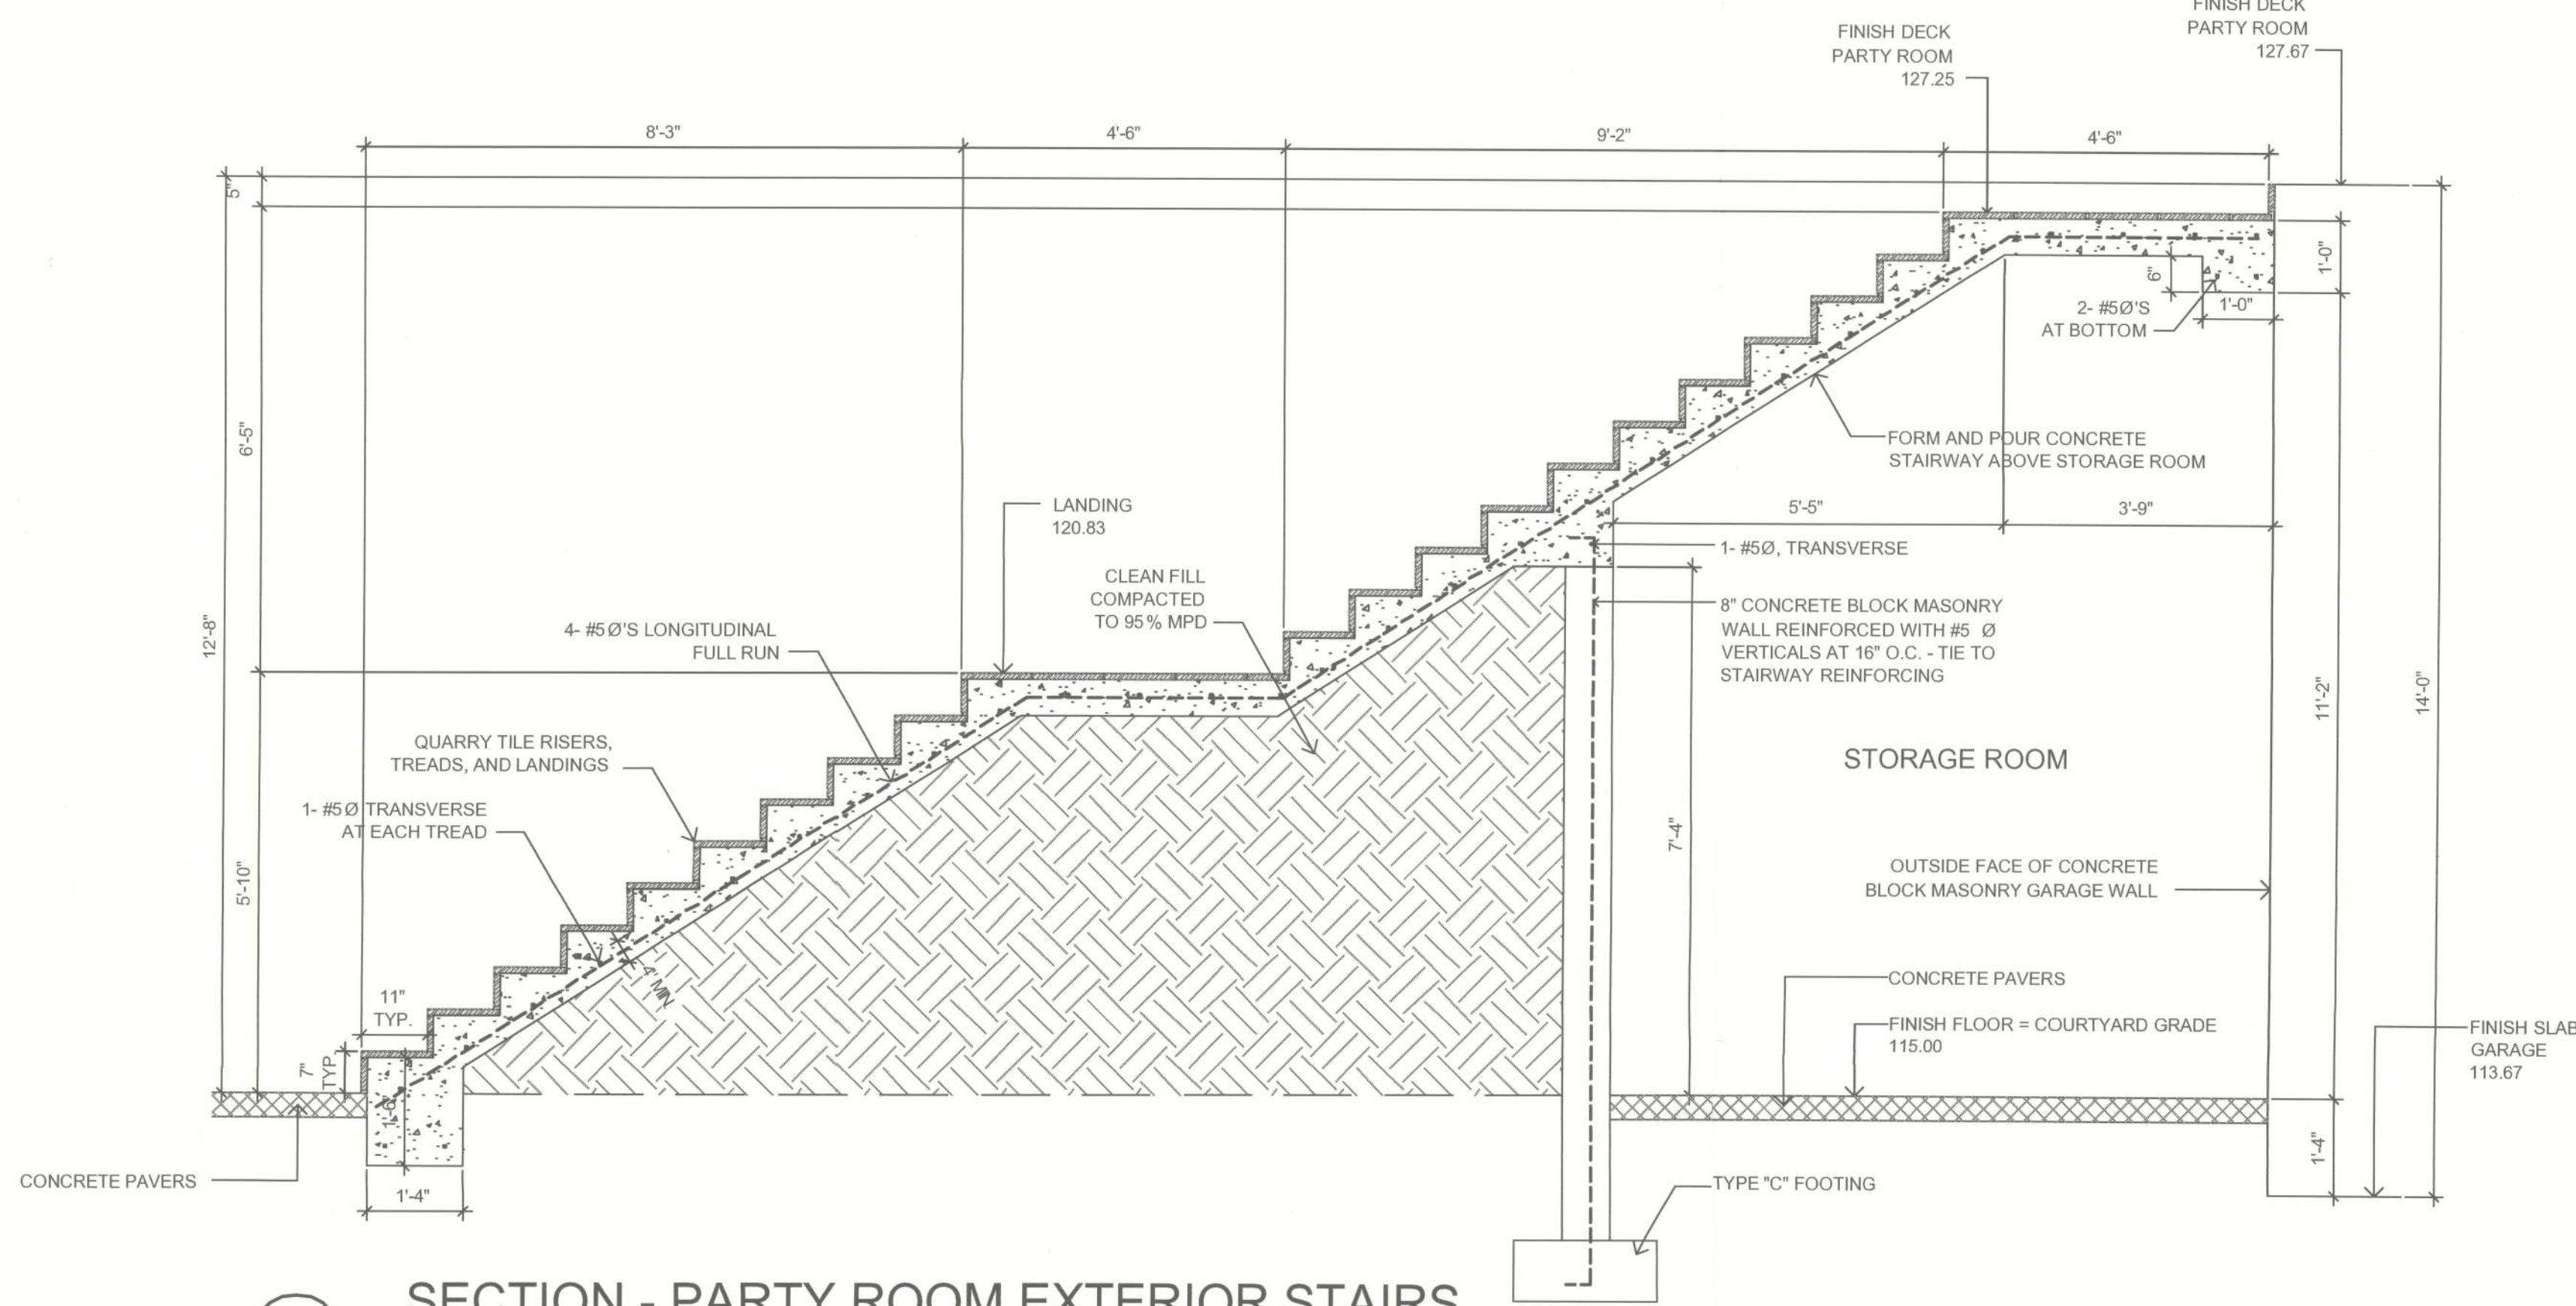
COLUMN ANCHORAGE SCHEDULE				
MARK	MANUFACTURER	ANCHOR TOP	ANCHOR BOTTOM	REMARKS
CA-01	SIMPSON STRONG-TIE	(2) HTS20 STRAPS	HTT5	
CA-02	SIMPSON STRONG-TIE	(2) MTS16 STRAPS	LTT20B	
CA-03	SIMPSON STRONG-TIE	(1) LSTA STRAP	SP46 OR SSP CLIP	EACH STUD

BEAM ANCHORAGE SCHEDULE			
MARK	MANUFACTURER	ANCHOR	REMARKS
BA-01	SIMPSON STRONG-TIE	HTT5	TAPCON TO WALL - NAIL TO BEAM
BA-02	SIMPSON STRONG-TIE	HUC412	TAPCON TO WALL - NAIL TO BEAM
BA-03	SIMPSON STRONG-TIE	HGUS412	NAIL TO BEAM
BA-04	SIMPSON STRONG-TIE	LS90	NAIL TO BEAM - TAPCON TO WALL WITH (8) - 1/4" x 2-3/4" TAPCONS
BA-05	SHOP FABRICATED	(4x4) 1/4" ANGLE IRON (12" LONG)	(2) - 1/2" x 6" EXPANSION BOLTS



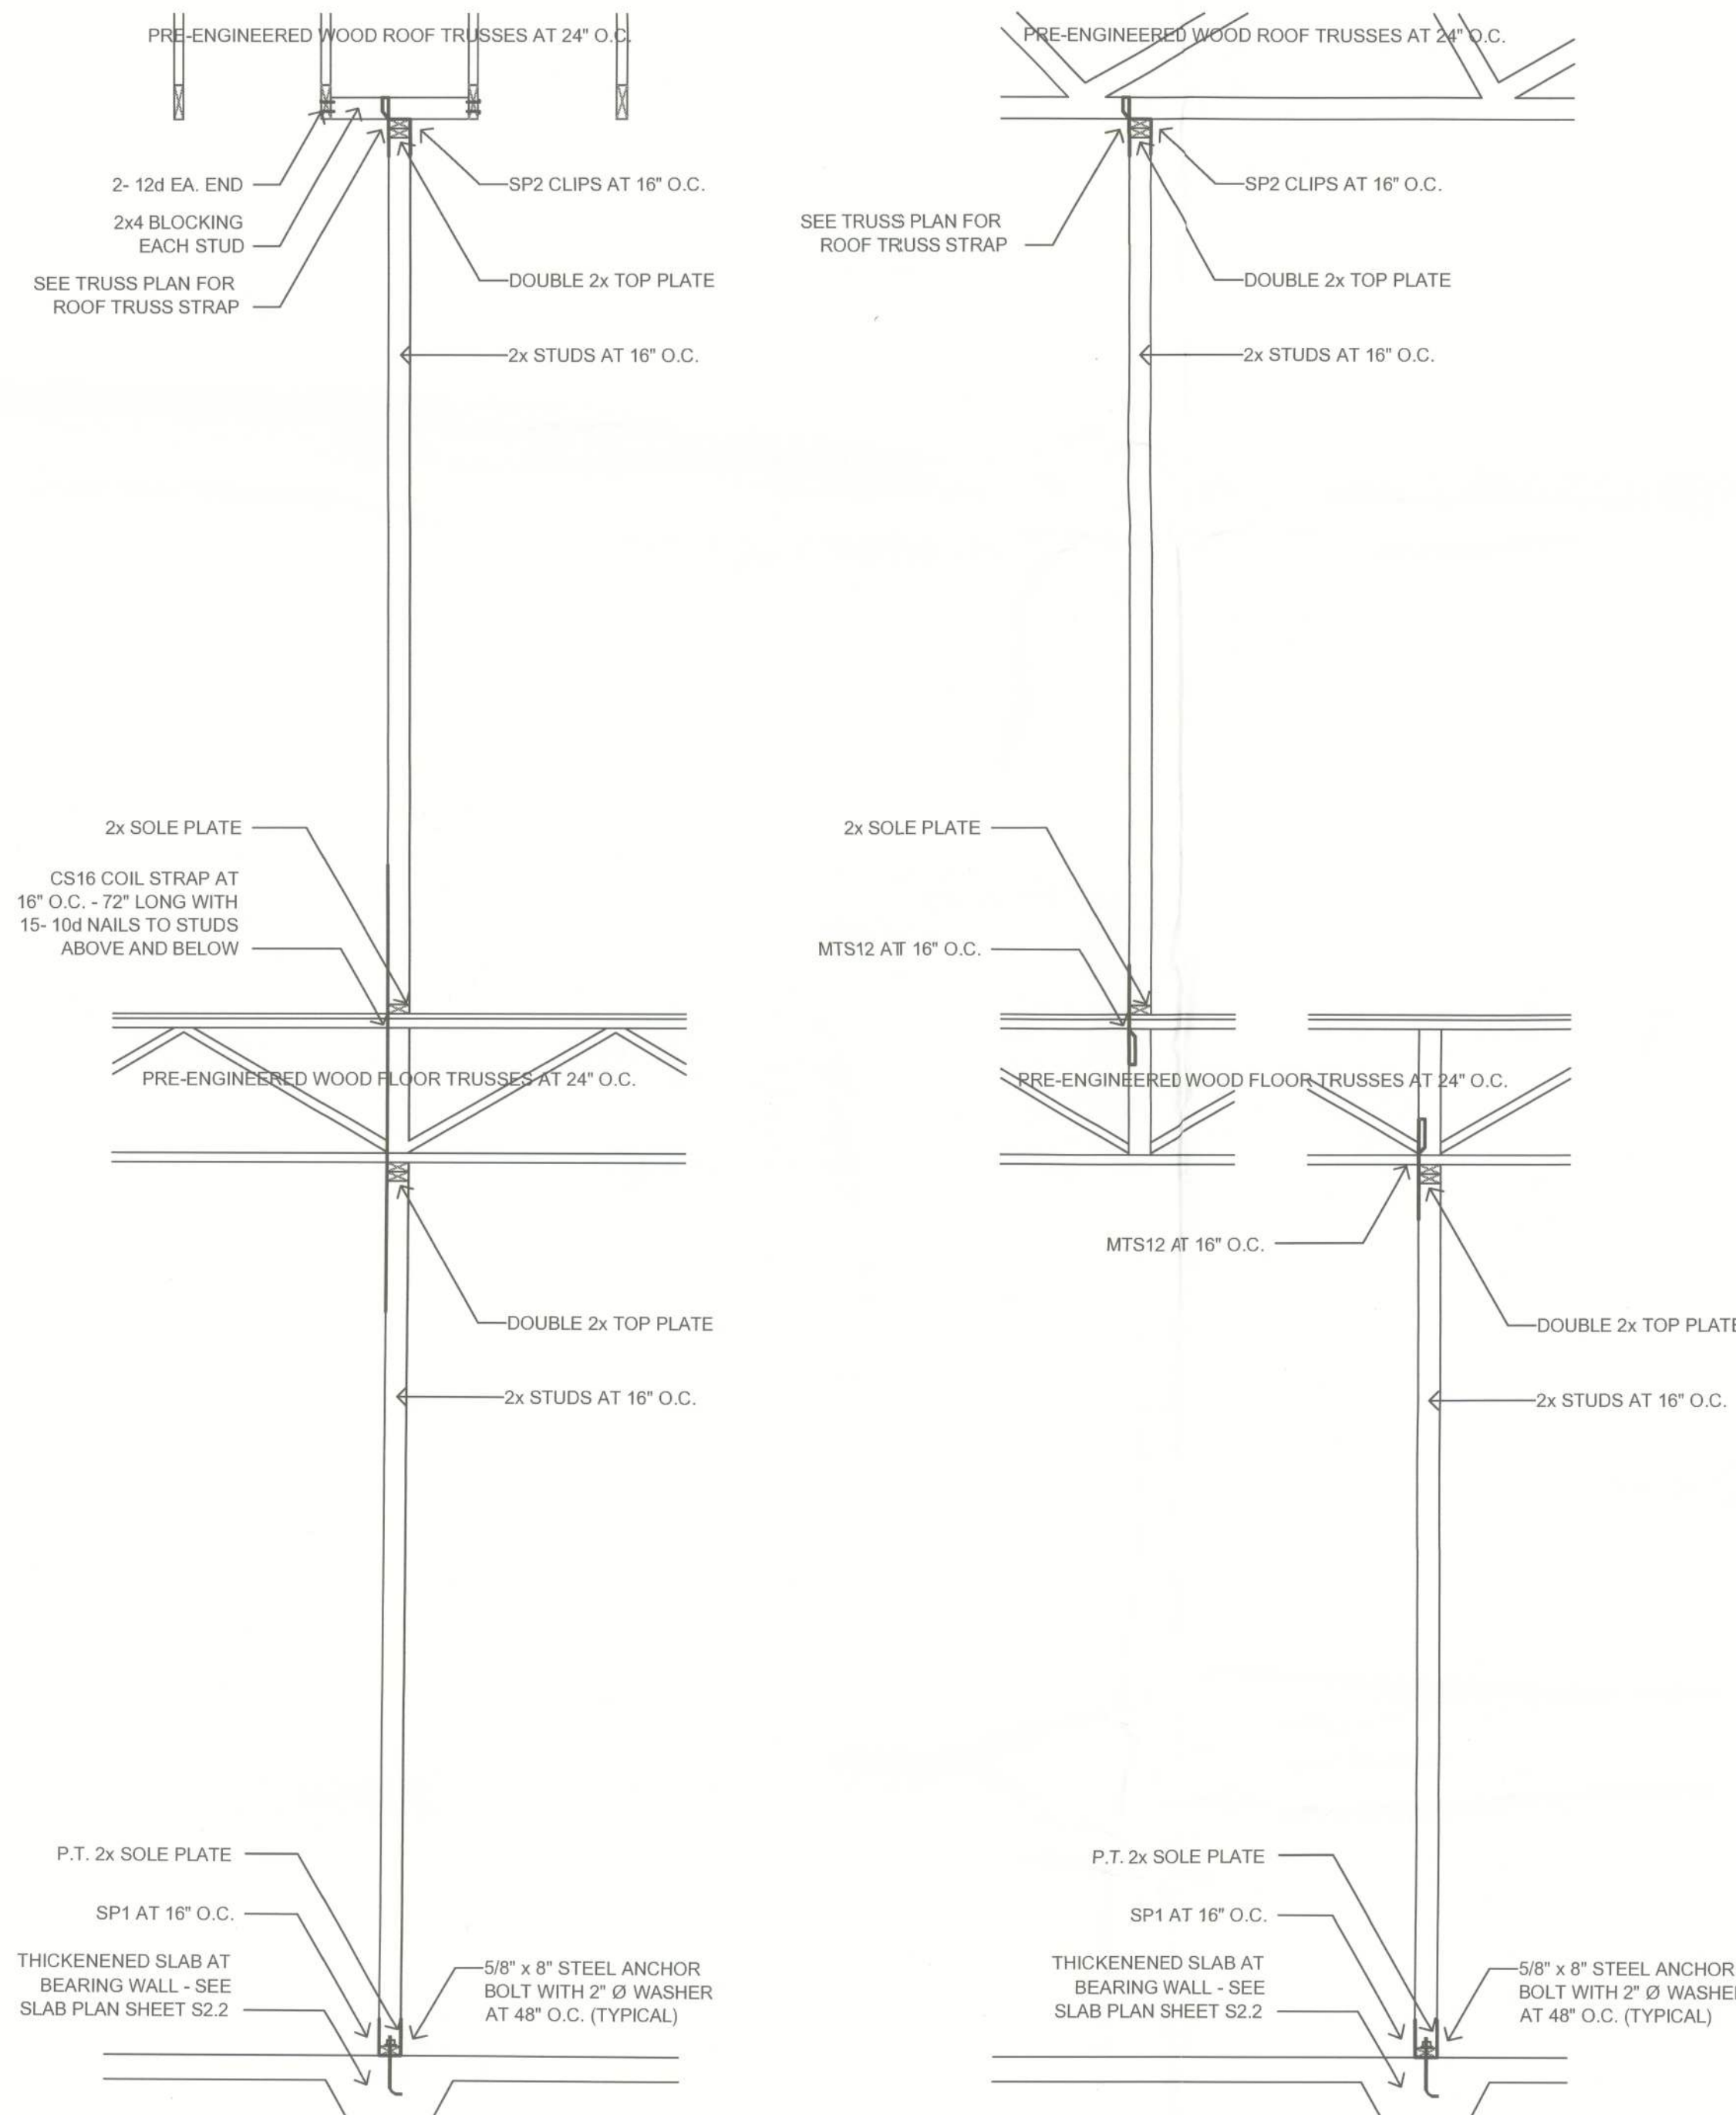
ATTIC FLOOR PLAN

SCALE: 1/4" = 1'-0"



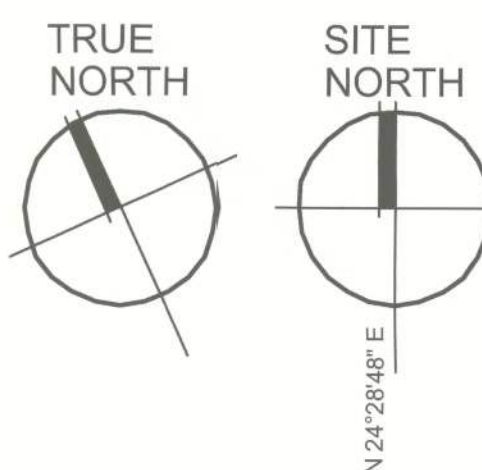
SECTION - PARTY ROOM EXTERIOR STAIRS

SCALE: 1/2" = 1'-0"



TYPICAL INTERIOR BEARING WALLS

SCALE: 1/2" = 1'-0"



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ATTIC FLOOR FRAMING PLAN

SCALE: 1/4" = 1'-0"

DATE	REMARK
08.07.12	PERMIT SET

Ken Eilers
9/11/12
Ken Eilers P.E.# 18243

STRUCTURAL PLAN SERVICE, INC.
CMAA #27132
Post Office Box 840128
Melbourne, FL 32984-0128
Fax (407) 266-9141
Ken Eilers P.E.# 18243
LICENSED PROFESSIONAL ENGINEER

PLANS PREPARED BY AND UNDER THE DIRECT SUPERVISION OF
STRUCTURAL PLAN SERVICE, INC.
AND KEN EILERS, P.E.
PETER WOODS, RESIDENTIAL DESIGNER
1824 PECAN RD., OCOA, FL 34472
peter.woods@woodenguru.com
(352) 575-4964

PROPOSED RESIDENCE
DR. AND MRS. MINESH PATEL
LOT 1, HILLS OF WINDSOR, COLUMBIA COUNTY, FL
PARCEL NO. 30-3S-16-02411-101

SHEET NUMBER
S2.6
PROJECT NO. 120101

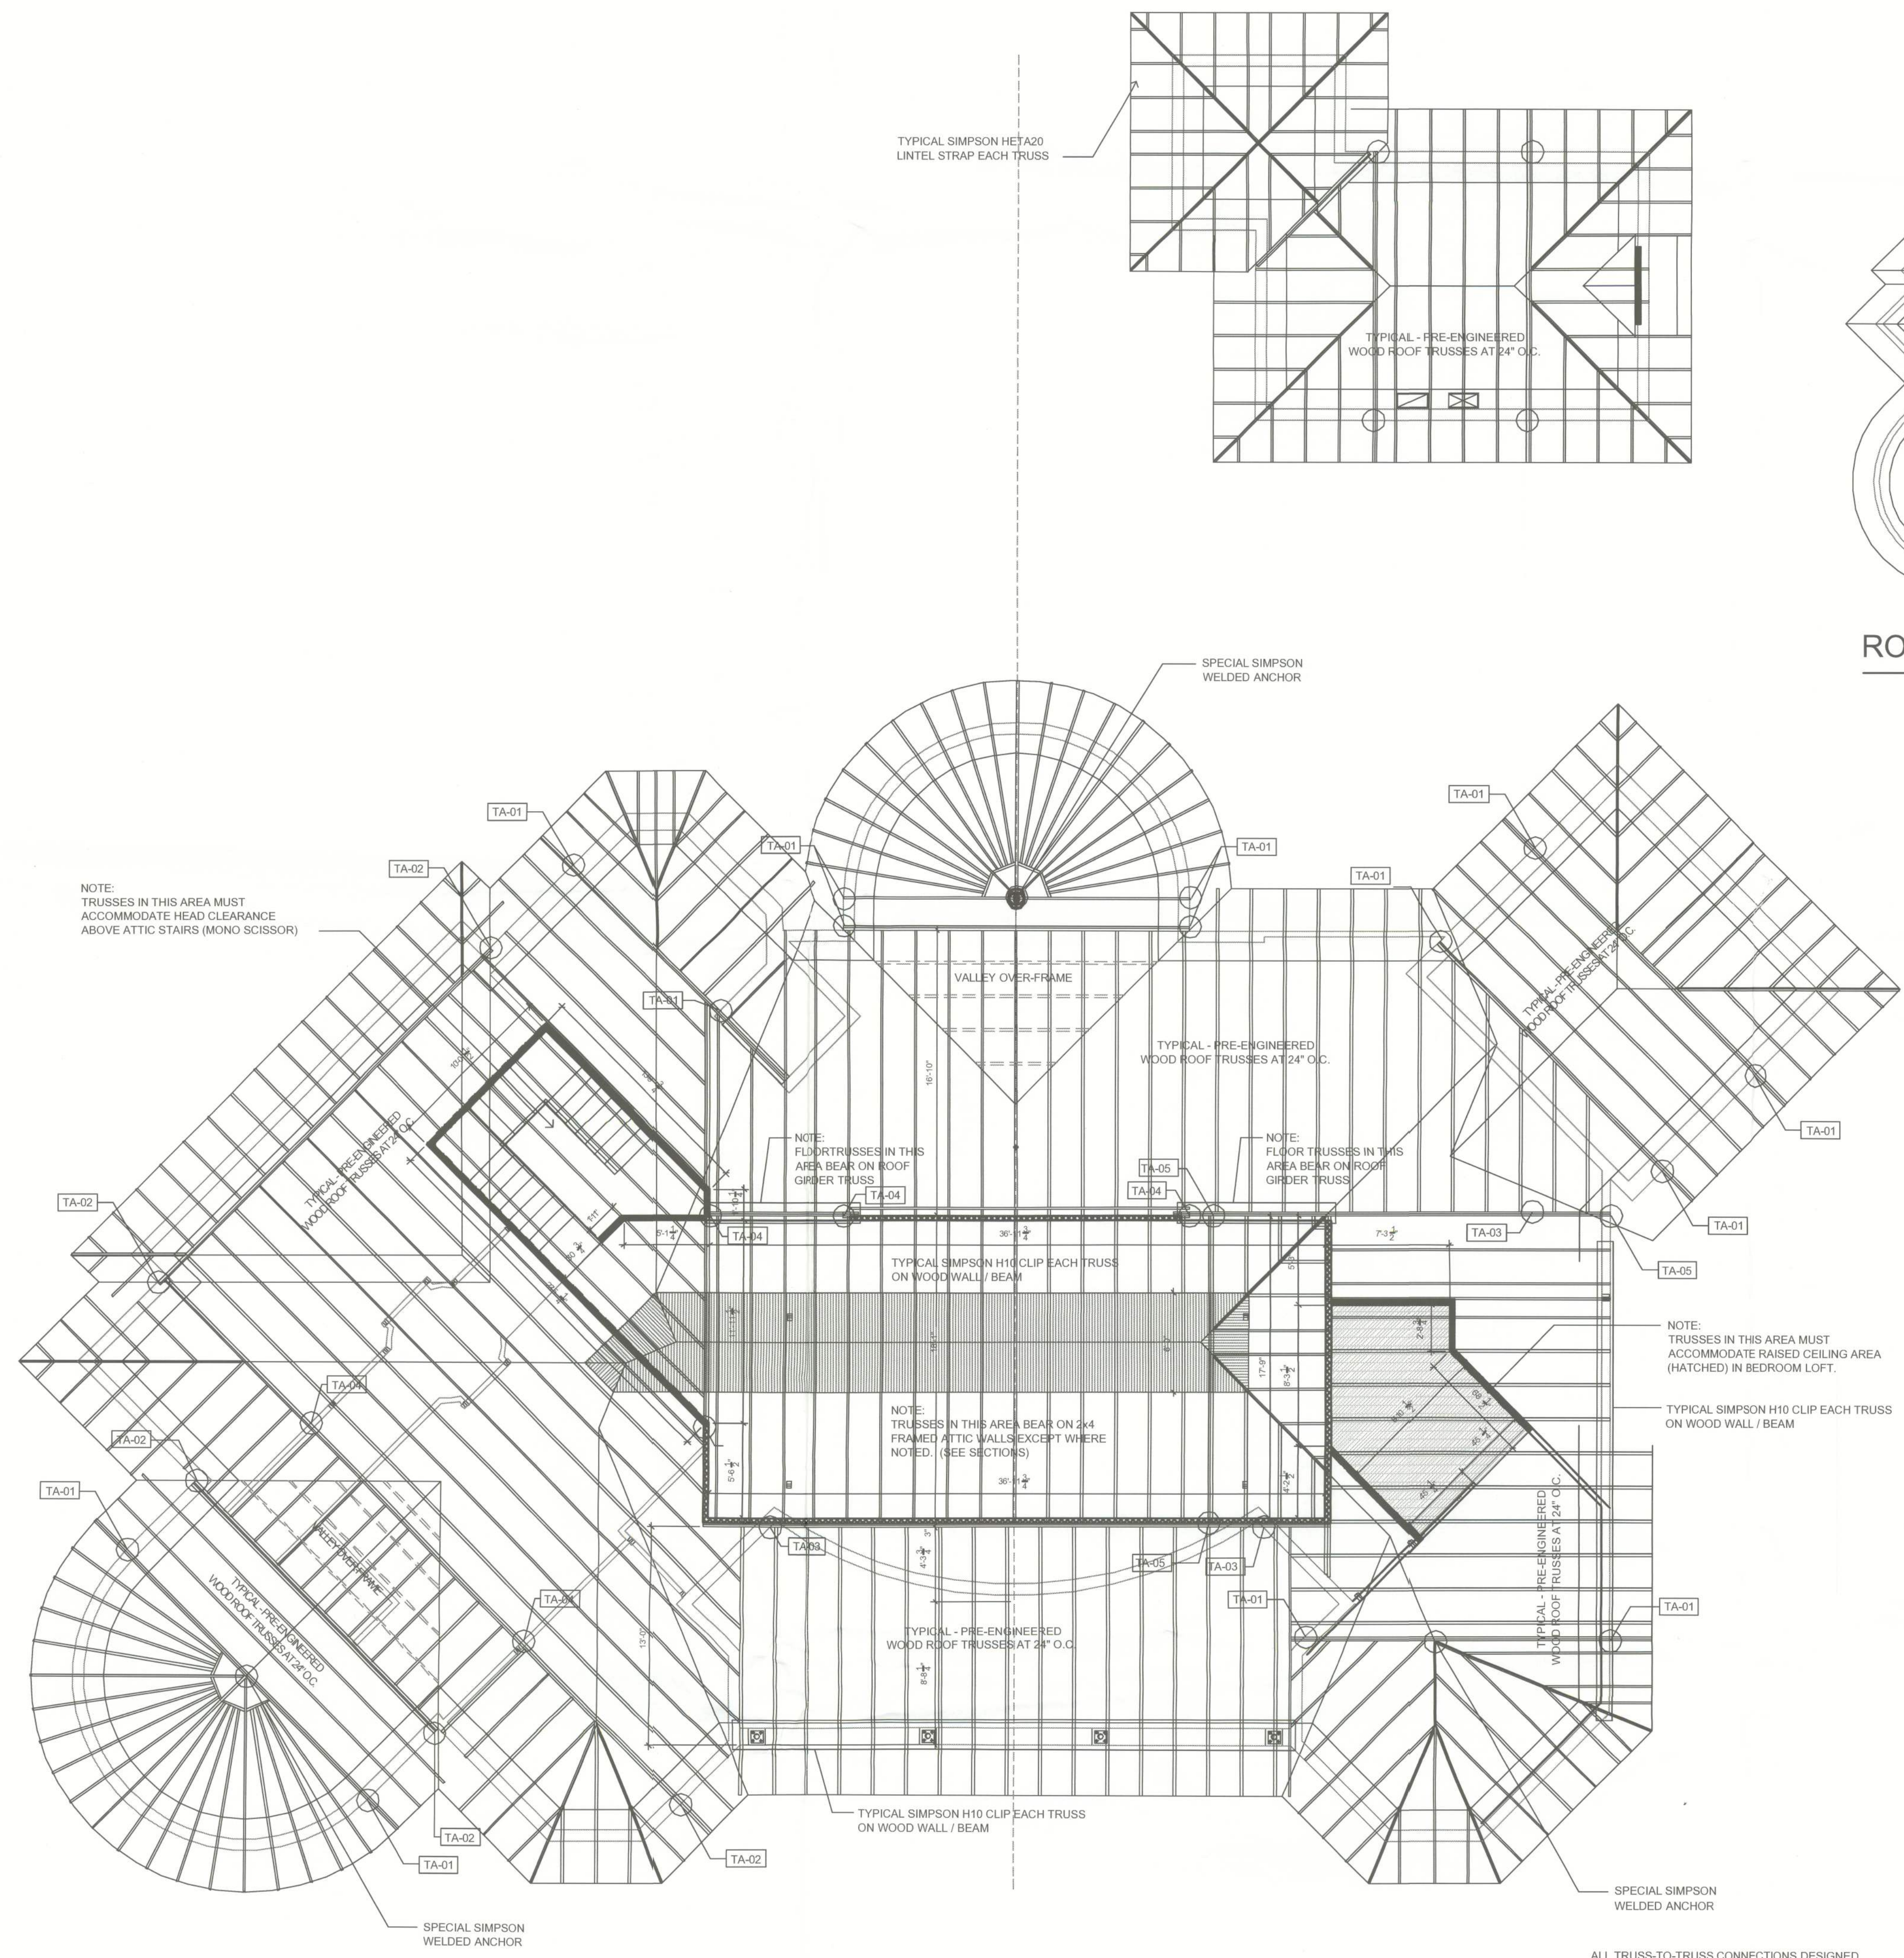
Ken Ehlers P.E.# 18243

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COA 427152
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Metairie, LA 70004
Phone (504) 885-8141
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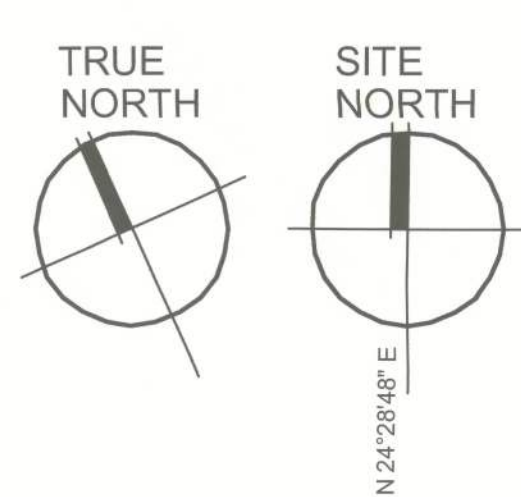
**PLANS PREPARED BY AND UNDER THE
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(352) 575-4984

NOT TO SCALE



SCALE: 3/16" = 1'-0"



4-22-00
9/14/12

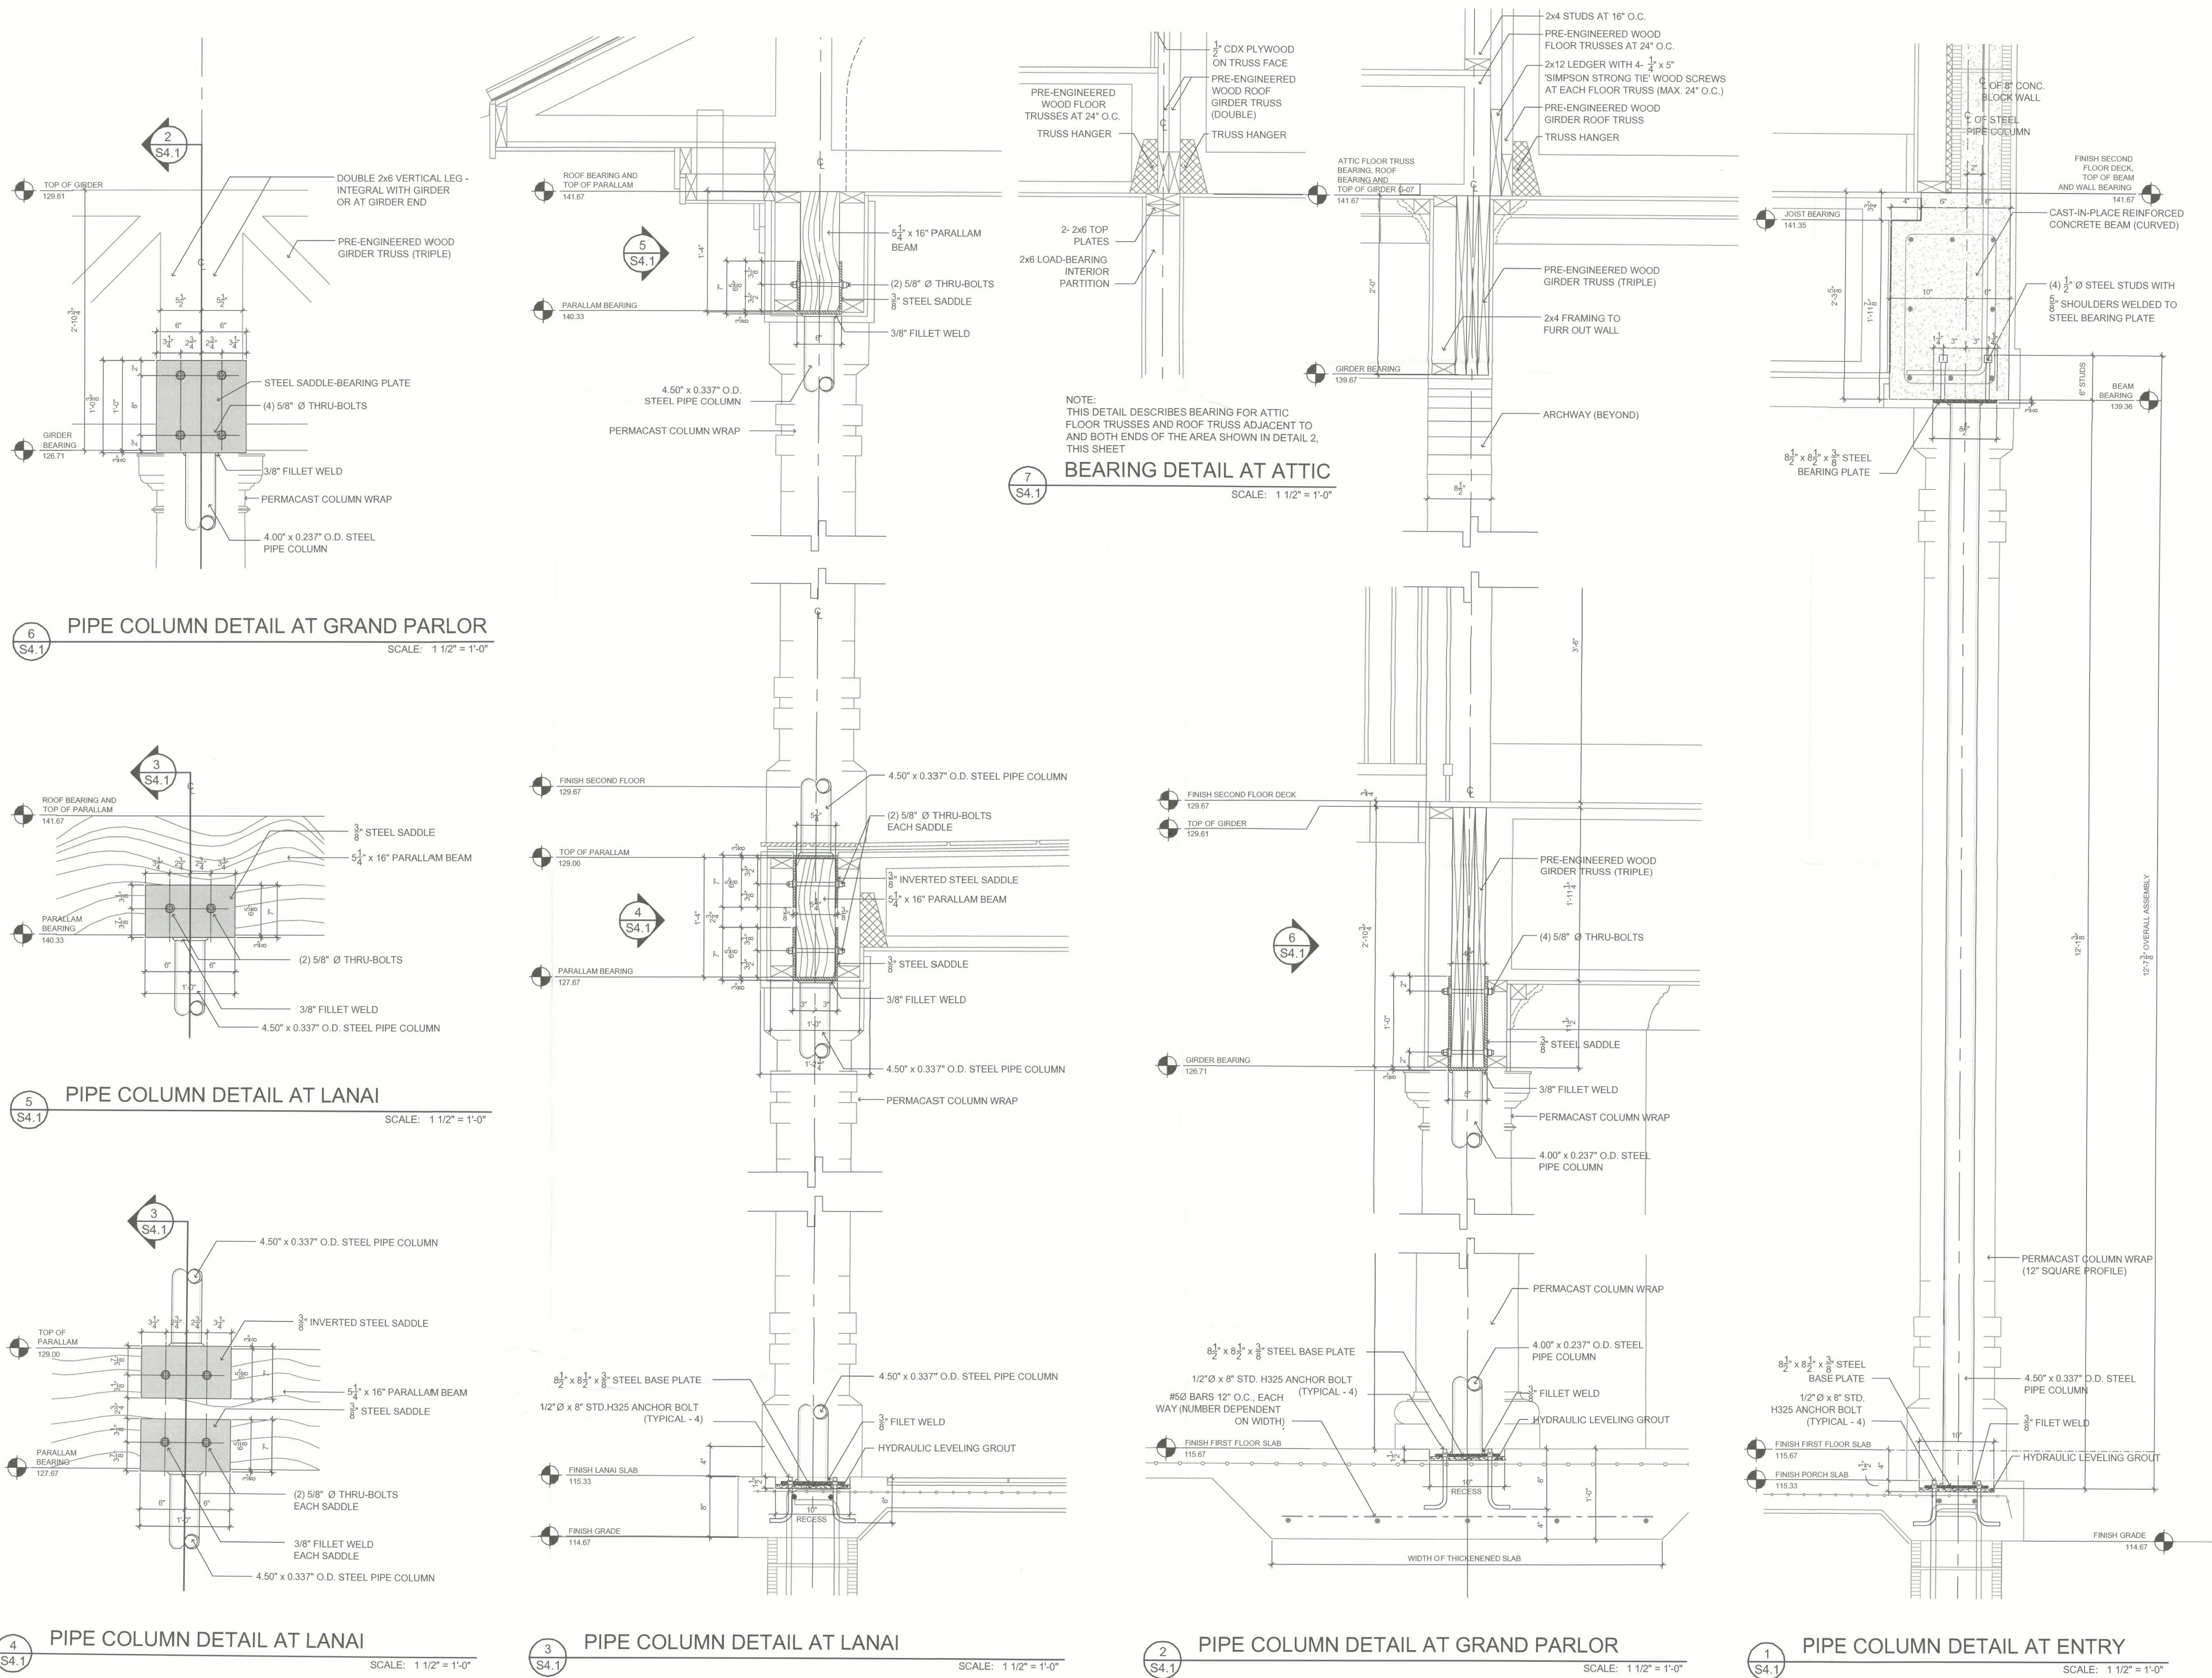
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PROJECT NO. 120101





9/5/2012 10:43:54 AM