

SOFTPXN ARCHITECTURAL DESIGN SOFTWARE

SECTION

WALL

ANNA REEK RUN PLANTATIO

© WM DEJGN & A550CIATES, NC. 426 SW COMMERCE DR. STE 130 LAKE CITY, R. 32025 (386) 758-8406 will@willmyers.net



JOB NUNBER 20190710

SHEET NUMBER A.1

SOFTPION

© WN DESIGN &
ASSOCIATES, INC.
426 SW COMMERCE DR. STE 130
LAKE CITY, FL 32025
(383) 758-8406
wil@willmyers.net




JOB NUMBER 20190710

SHEET NUMBER

A.2

uc-mp\_

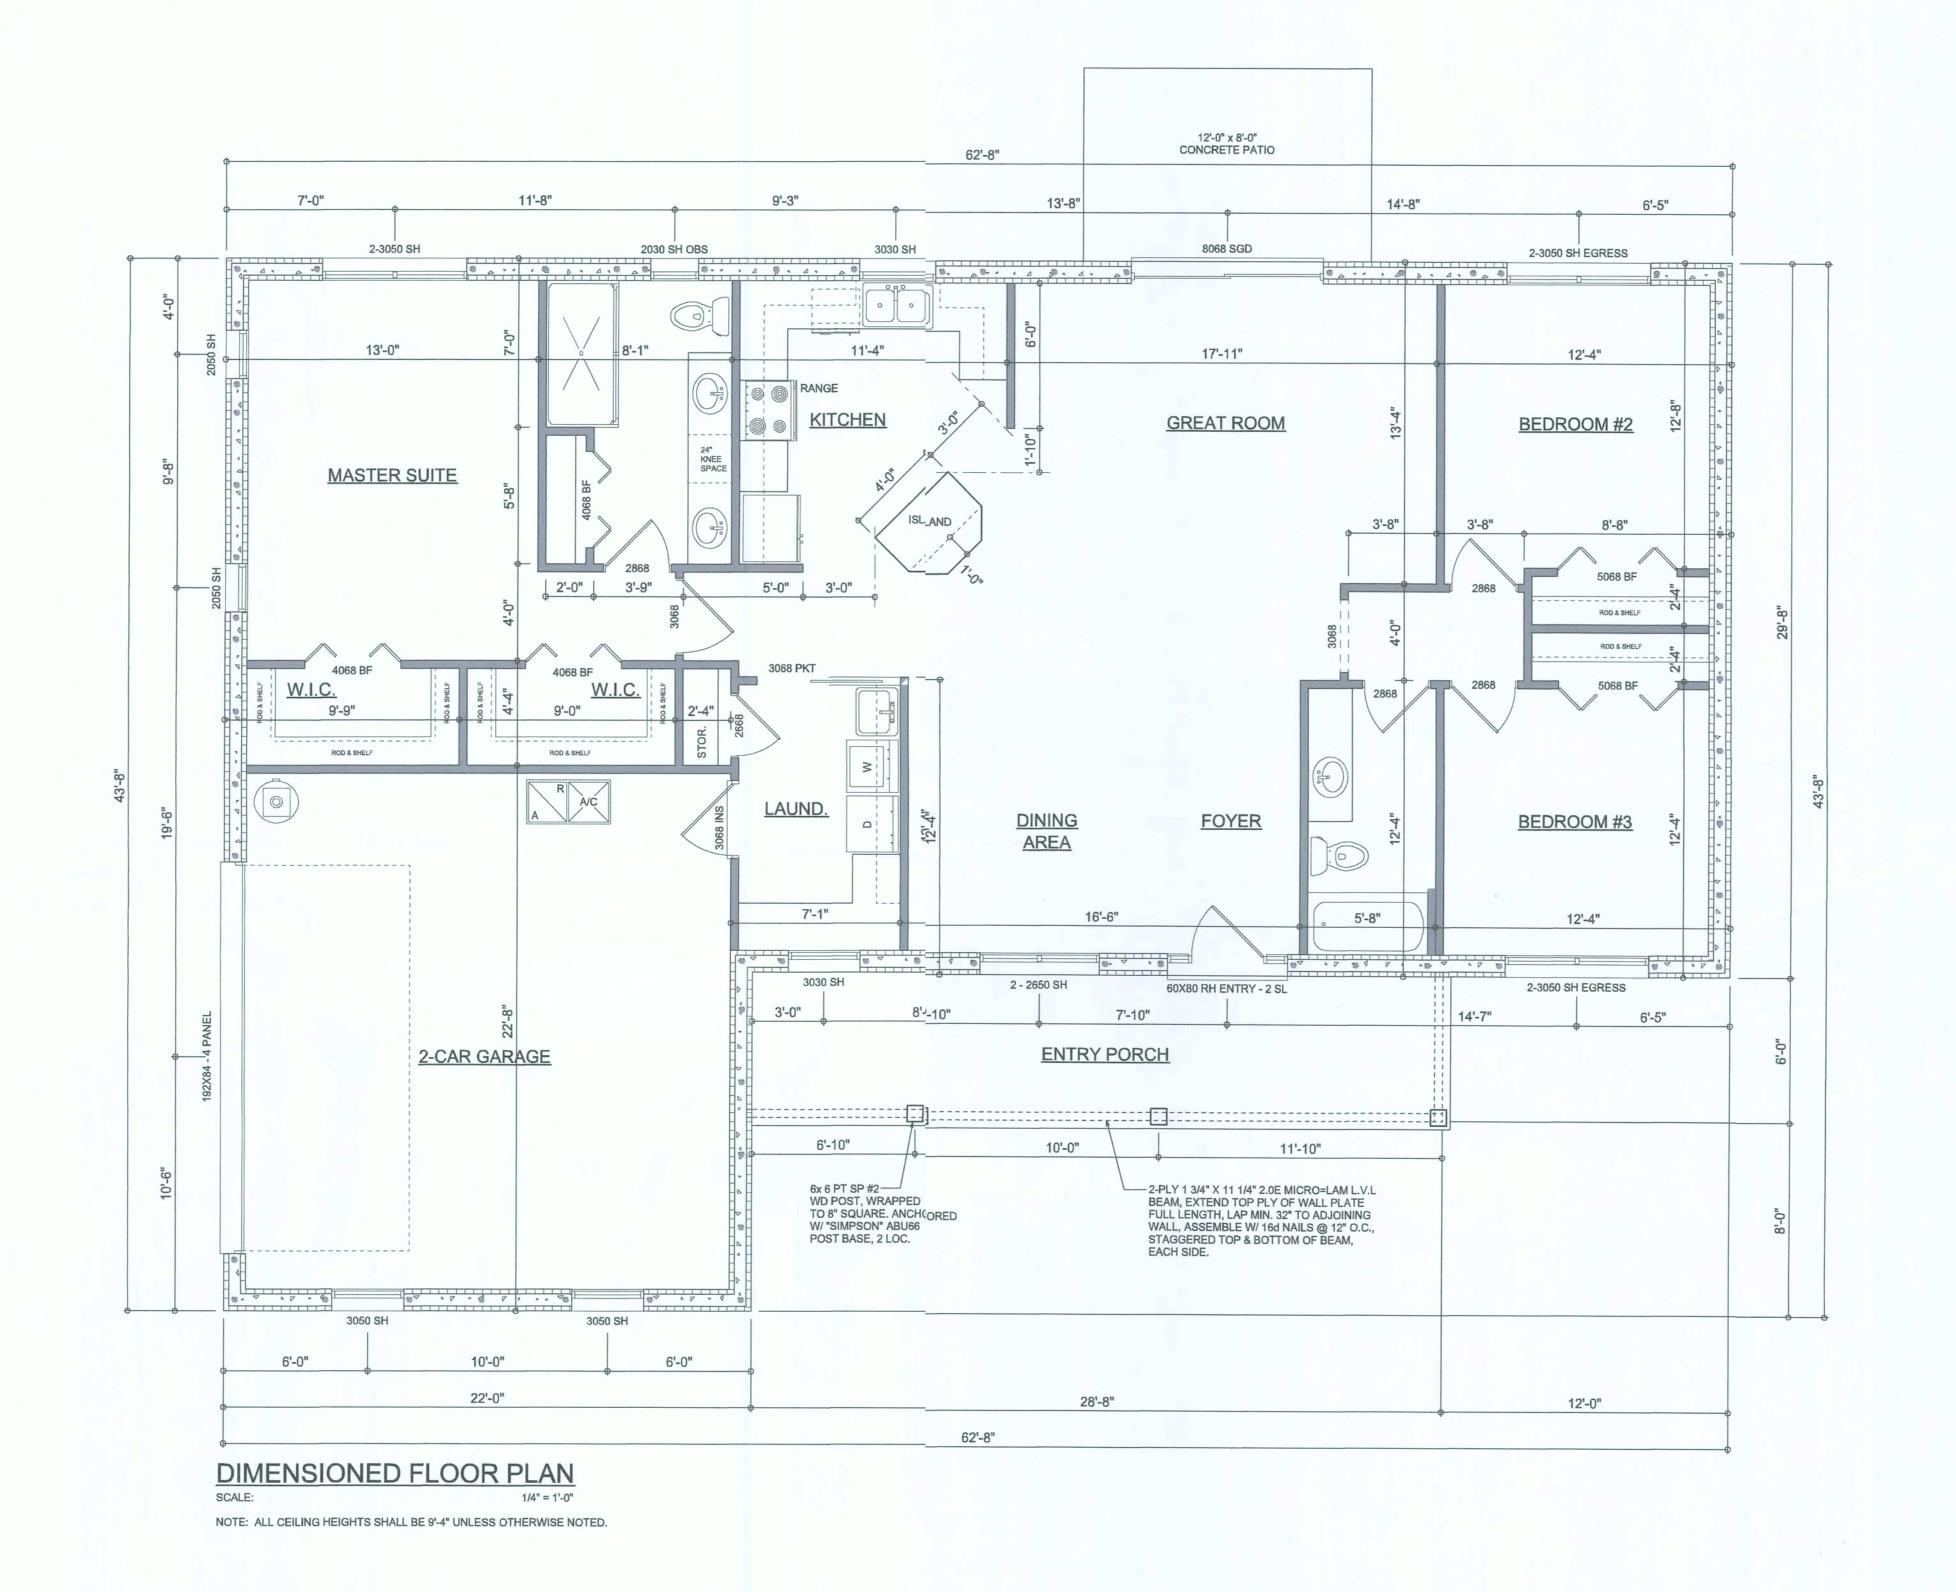

AREA SUMMARY

LIVING AREA 1,683 S.F.
GARAGE AREA 484 S.F.
ENTRY PORCH AREA 172 S.F.

TOTAL AREA 2,339 S.F.


	ELECTRICAL LEGEND
	CEILING FAN (PRE-WIRE FOR LIGHT KIT)
QP	DOUBLE SECURITY LIGHT
0	RECESSED CAN LIGHT
⊕	BATH EXHAUST FAN
- <b></b>	LIGHT FIXTURE
ф	DUPLEX OUTLET (AFCI & TAMPER RESISTANT)
	220v OUTLET
Фан	GFI DUPLEX OUTLET (PER NEC 406.8)
† †	TELEVISION JACK
PH	TELEPHONE JACK
•	SMOKE / CARBON MONOXIDE DETECTOR (see note below)
\$	WALL SWITCH
\$3	3 WAY WALL SWITCH
₩P/GFI	WATER PROOF GFI OUTLET
48" FLOUR.	2 OR 4 TUB FLUORESCENT FIXTURE

NOTE: ALL INTERIOR RECEPTACLES SHALL BE AFCI (ARC FAULT CIRCUIT INTERRUPT) PER NEC 210.12 & TAMPER RESISTANT PER NEC 406.11

ALL SMOKE DETECTORS BE A COMBO SMOKE & CARBON MONOXIDE DETECTOR AND SHALL HAVE BATTERY BACKUP POWER AND ALL WIRED TOGETHER SO IF ANY ONE UNIT IS ACTUATED THEY ALL ACTIVATE.

THE ELECTRICAL SERVICE OVERCURRENT PROTECTION DEVICE SHALL BE INSTALLED ON THE EXTERIOR OF STRUCTURES TO SERVE AS A DISCONNECT MEANS. CONDUCTORS USED FROM THE EXTERIOR DISCONNECTING MEANS TO A PANEL OR SUB PANEL SHALL HAVE FOUR-WIRE CONDUCTORS, OF WHICH ONE CONDUCTOR SHALL BE USED AS AN EQUIPMENT GROUND.

IT IS THE LICENSED ELECTRICAL CONTRACTORS RESPONSIBILITY TO INSURE THAT ALL WORK PERFORMED AND EQUIPMENT INSTALLED MEETS OR EXCEEDS THE NFPA70 2014 NATIONAL ELECTRIC CODE AND ALL OTHER LOCAL CODES AND ORDINANCES.

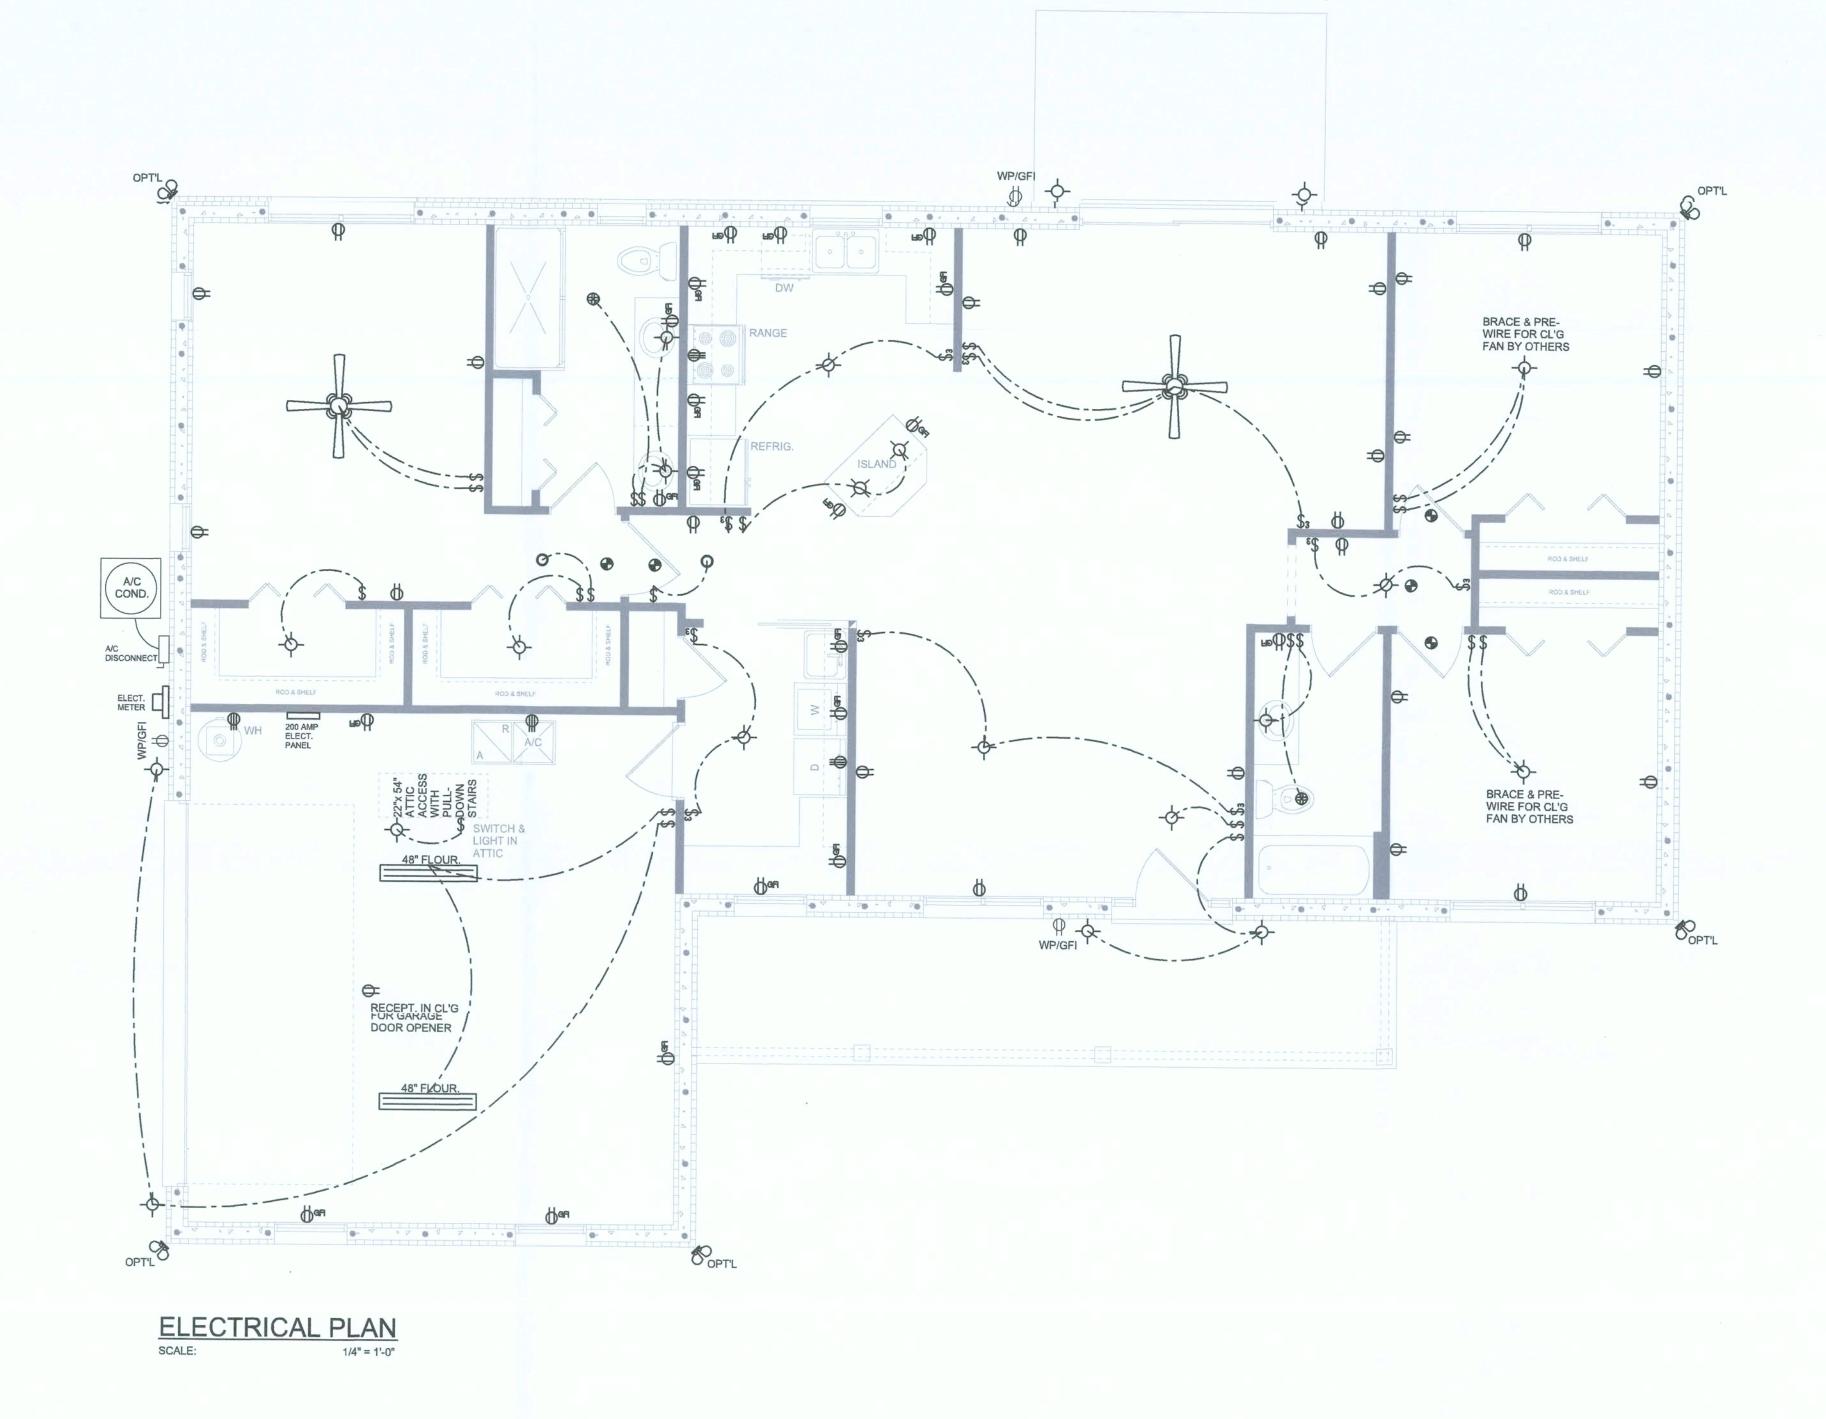

November 13, 2019


SOFTPAN

November 13, 2019

ELECTRICAL PLAN
CALE: 1/4" = 1'0"

PETER & ANNA LEV
PROJECT ADDRESS: LOT 3, CREIK RUN PLANTATION, LAKE CITY, FLORIDA 3202


© VM DESIGN &
ASSOCIATES, INC.
426 SW COMMERCE DR. STE 130
LAKE CITY, FL 32025
(386) 758-8406
will@willmyers.net

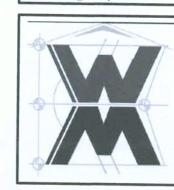

JOB NUMBER 20190710

SHEET NUMBER

MC-AZ

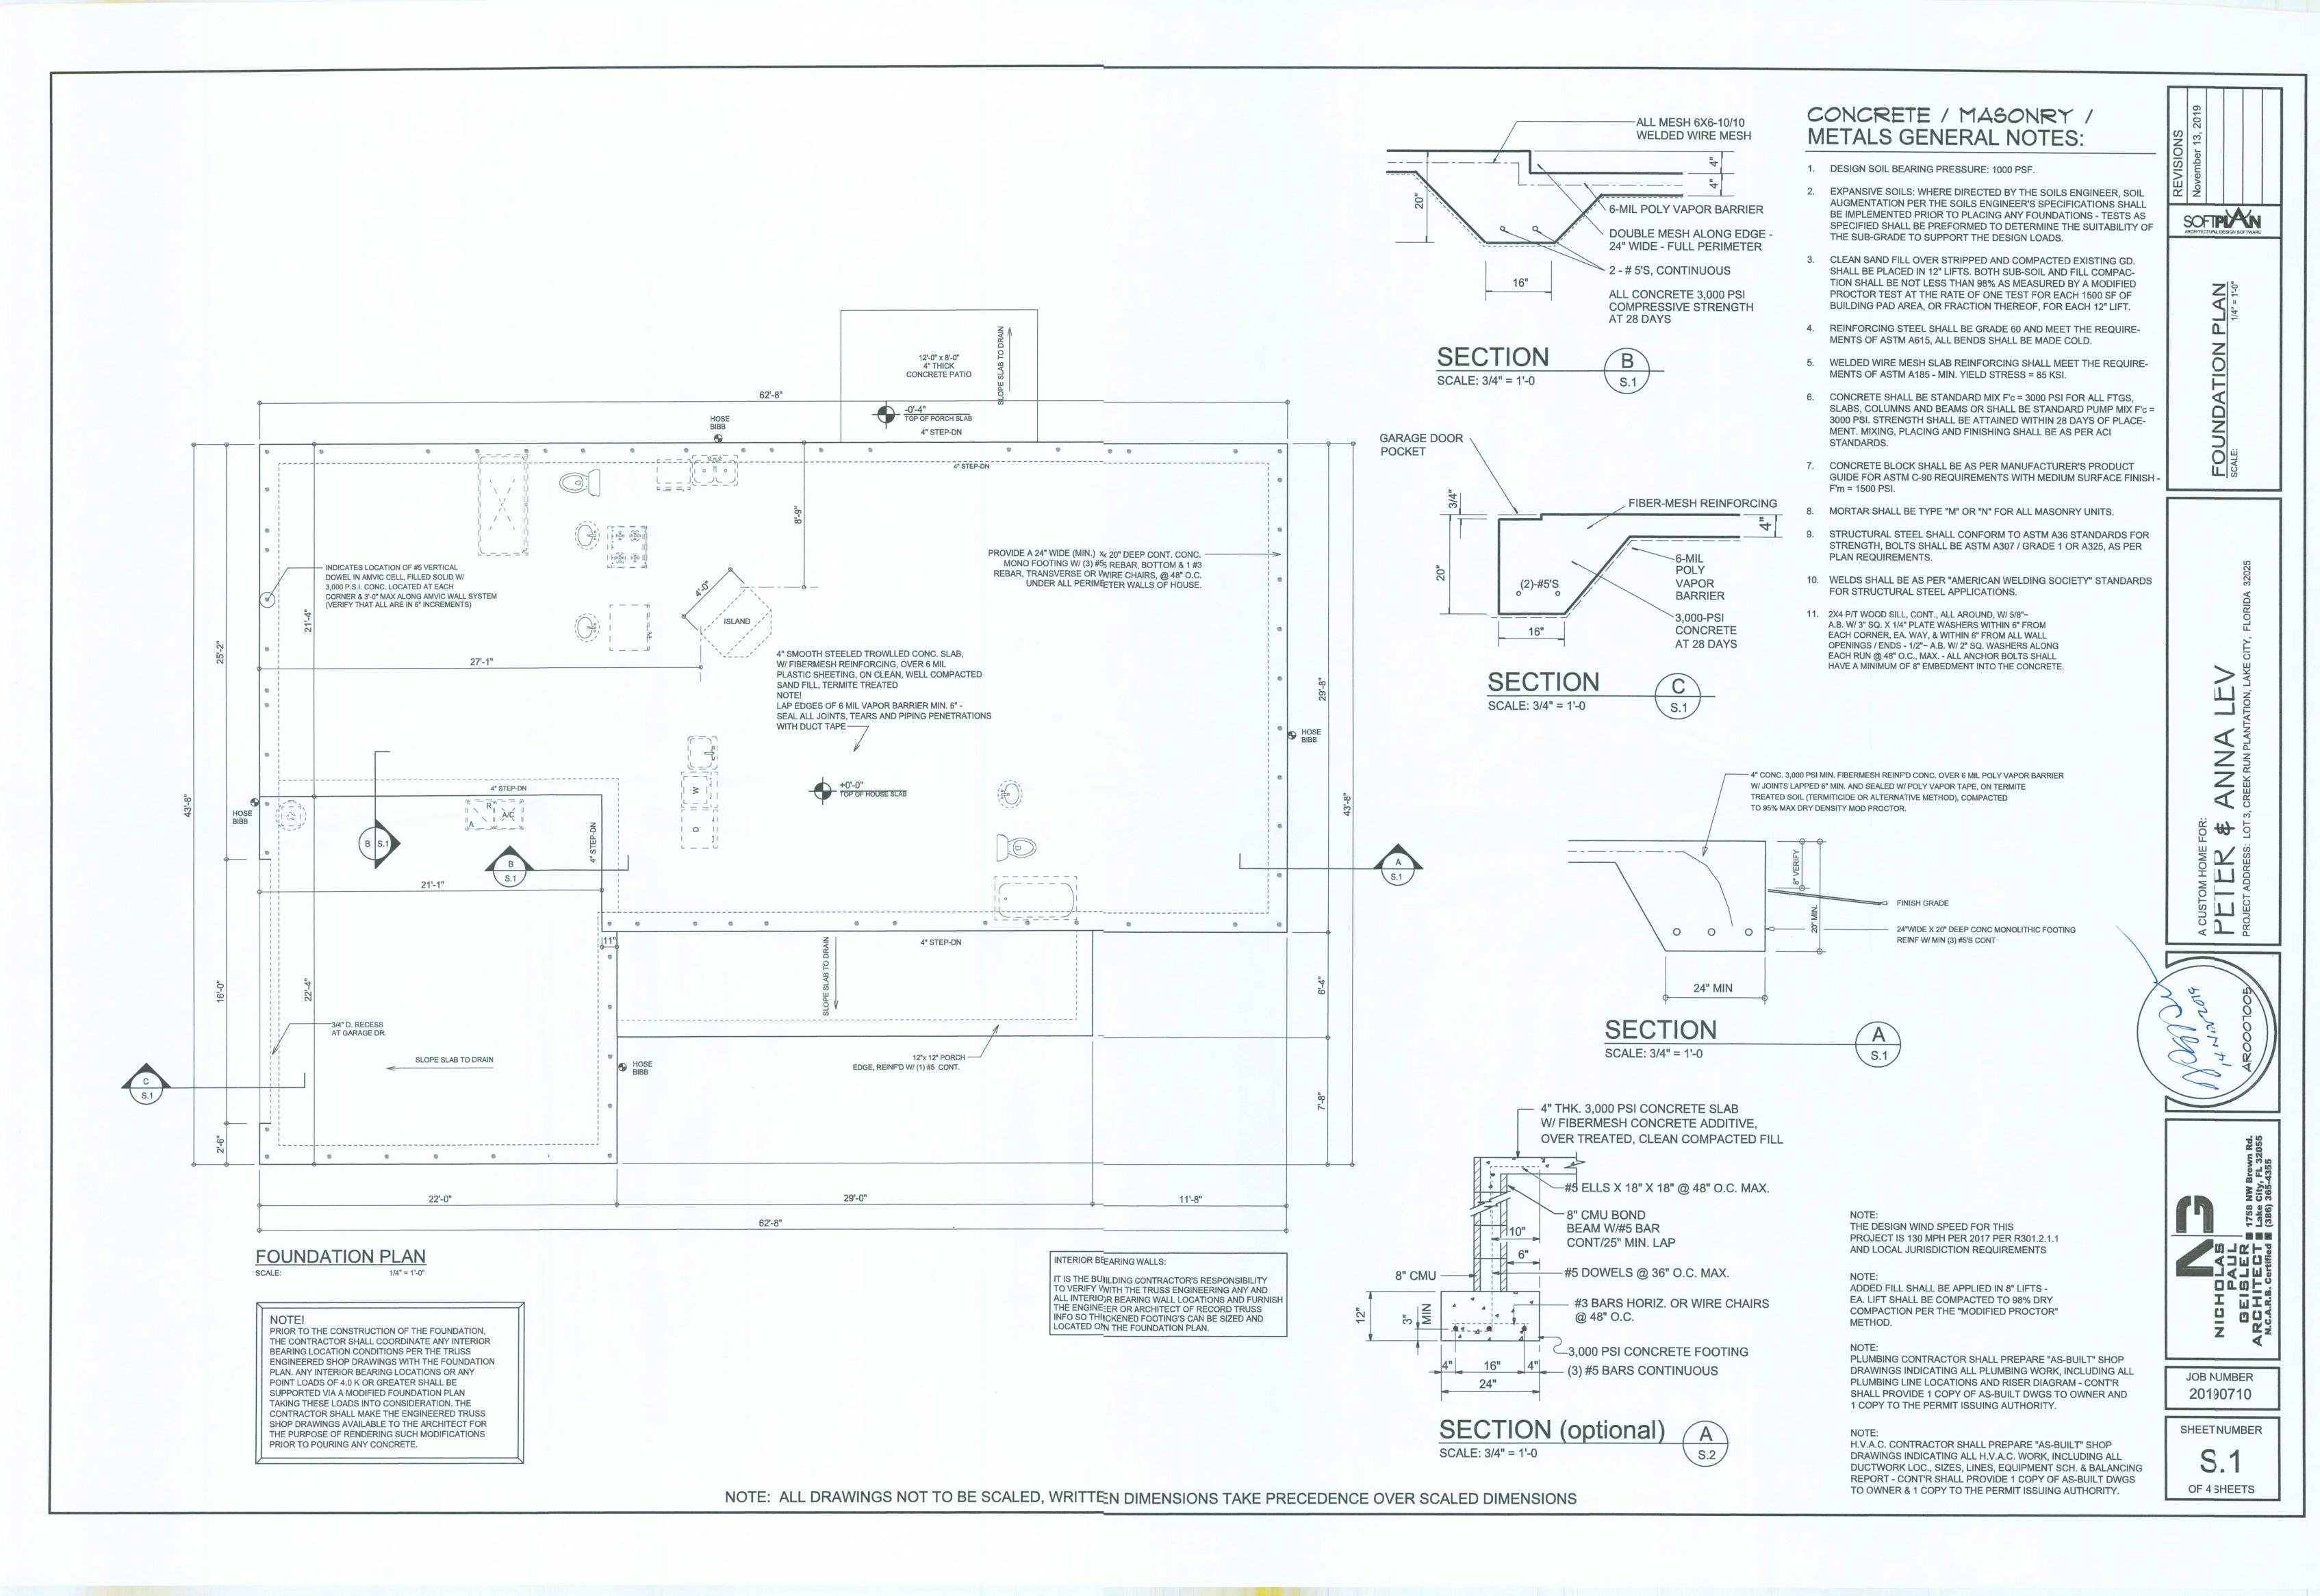

CORDANCE WITH SCHEDULE ON THIS SHEET.

SEE EXTERIOR ELEVATIONS AND FLOOR

- PLANS TO VERIFY PLATE AND HEEL HEIGHTS
- MOVE ALL VENTS AND OTHER ROOF PENETRATIONS TO REAR

SHEATH ROOF W/ 5/8" CDX PLYWOOD PLACED W/ LONG DIMENSION PERPENDICULAR TO THE ROOF TRUSSES, SECURE TO FRAMING W/ 8d NAILS - AS PER DETAIL ON SHEET 5.4

THE DESIGN WIND SPEED FOR THIS PROJECT IS 130 MPH PER 2017 PER R301.2.1.1 AND LOCAL JURISDICTION REQUIREMENTS

AS TOP PLATES, NOTED ABOVE

ALL PENETRATIONS OF THE TOP PLATE OF ALL LOAD BEARING WALLS SHALL BE SEALED WITH FIRE RETARDANT CAULKING,

INCLUDING WIRING, PLUMBING OR OTHER SUCH PENETRATIONS

WALLS OVER 8'-0" TALL SHALL HAVE CONTINUOUS BLOCKING

TO LIMIT CAVITY HEIGHT TO 8'-O". PENETRATIONS THROUGH

SUCH BLOCKING SHALL BE TREATED IN THE SAME MANNER

### WOOD STRUCTURAL NOTES

- I. TEMPORARY BRACING OF THE STRUCTURE DURING ERECTION, REQUIRED FOR SAFE AND STABLE CONSTRICTION, SHALL BE THE SOLE RESPON-SIBILITY OF THE CONTRACTOR SO ENGAGED, TEMPORARY & PERMANENT BRACING OF ROOF TRUSSES SHALL BE AS PER THE STANDARD GUIDE-LINES OF THE "TRUSS PLATE INSTTUTE".
- 2. ALL TRUSSES SHALL BE DESIGNED BY A LICENSED PROFESSIONAL ENGINEER & SHALL BE SIGNED AND SEALED BY SAME, TRUSS DESIGN SHALL INCLUDE PLACEMENT PLANS, TRUSS DETAILS, TRUSS TO TRUSS CONNECTIONS & THE STANDARD SPECIFICATIONS & RECOMMENDATIONS OF INSTALLATION OF THE "TRUSSPLATE INSTITUTE".
- 3. WOOD STUDS IN EXTERIOR WALLS & INTERIOR BEARING WALLS SHALL BE NOT LESS THAN Nr.2 HEM-FIR OR BETTER.
- 4. CONNECTORS FOR WOOD FRAMILG SHALL BE GALYANIZED METAL OR BLACK METAL AS MANUFACTURED OR AS CALLED FOR IN THE PLANS AND BE OF A DESIGN SUITABLE FOR THE LOADS AND USE INTENDED. REFER TO THE JOINT REINFORCEMENT SCHEDULE FOR PRINCIPLE CON-NECTIONS.

# WALLEY FLASHING METAL PER FBC R903.2.1 - 26 GA METAL ROOFING SHEATHING -UNDERLAYMENT -EAYE DRIP -

Roofing/Flashing DETS.

YALLEY FLASHING

SHOP DWG COORDINATION: THE TRUSS ANCHOR STRAPS AS INDICATED IN THE CONSTRUCTION DOCUMENTS ARE SUGGESTED STRAPS AND THAT THE TRUSS ENGINEERED SHOP DRAWING LOADS TAKE PRECEDENCE OVER THAT INDICATED IN THE CONSTRUCTION DOCUMENTS. THE UPLIFT LOADS INDICATED FOR EACH TRUSS IN THE ENGINEERED TRUSS SHOP DRAWINGS MAY BE MATCHED TO STANDARD PRODUCT UPLIFT RATINGS FOR COMPARABLE UPLIFT CONNECTORS, AND THAT THE PRODUCTS THAT PROVIDE EQUAL OR GREATER UPLIFT RESISTANCE FOR THE LISTED LOADS MAY BE USED IN LIEU OF THOSE INDICATED IN THE CONSTRUCTION DOCUMENTS

THE CONTRACTOR SHALL COORDINATE THE TRUSS TO TRUSS ANCHOR REQUIREMENTS WITH THE TRUSS ENGINEERING SHOP DRAWINGS, SOME OF THE TRUSS TO TRUSS CONNECTIONS WILL REQUIRE ANCHOR STRAPS IN ADDITION TO TYPICAL NAILING. ANCHOR DEVICES SHALL BE REQUIRED FOR ALL JOINTS WITH AN UPLIFT OR GRAVITY LOAD OF 100 LBS OR GREATER.


TRUSSES BEARING ON INTERIOR PARTITIONS WHERE UPLIFT LOADS ARE PRESENT SHALL REQUIRE ANCHORS OF EQUAL OR GREATER LOAD CAPACITY THAN THAT INDICATED BY THE TRUSS SHOP DRAWINGS, THE UPLIFT ANCHOR SYSTEM SHALL BE CONTINUOUS TO THE FOUNDATION.

### PROJECT COORDINATION REQUIREMENTS

OR AS APPROVED BY THE BUILDING OFFICIAL.

#### NOTICE


THESE PLANS ARE DRAWN FOR AVERAGE SITE CONDITIONS AND COMPLIANCE WITH APPLICABLE CODES IN COLUMBIA COUNTY, FL AT THE TIME THEY ARE DRAWN. DUE TO VARYING STATE, LOCAL, AND NATIONAL CODES RULES AND REGULATIONS, N.P.GEISLER, ARCHITCT CANNOT WARRANT COMPLIANCE WITH ALL APPLICABLE STATE, LOCAL, AND NATIONAL CODES IN YOUR AREA OR WITH YOUR PARTICULAR SITE CONDITIONS, IT IS THE RESPONSIBILITY OF THE PURCHASER AND/OR BUILDER TO SEE THAT THE STRUCTURE IS BUILT IN STRICT COMPLIANCE WITH ALL GOVERNING MUNICIPAL CODES (CITY, COUNTY, STATE, AND FEDERAL). IF YOUR CITY OR STATE REQUIRES AN ENGINEER'S SEAL FOR THE SITE/CIVIL PORTIONS OF THE WORK,, YOU WILL NEED TO HAVE THAT DONE LOCALLY BY A QUALIFIED, LICENCED PROFESSIONAL ENGINEER.

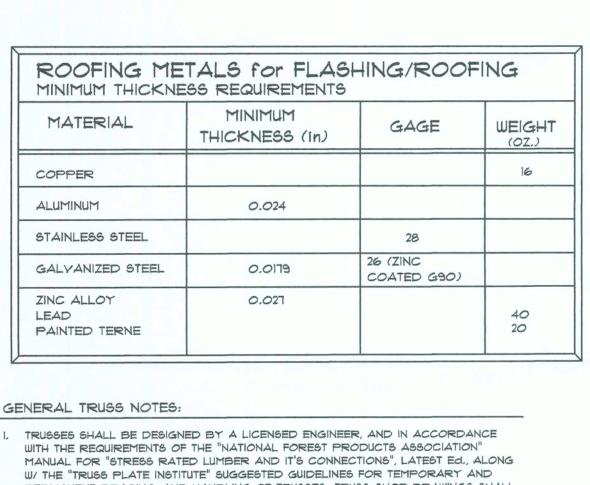

I, TRUSSES SHALL BE DESIGNED BY A LICENSED ENGINEER, AND IN ACCORDANCE PERMANENT BRACING, AND HANDLING OF TRUSSES. TRUSS SHOP DRAWINGS SHALL INCLUDE TRUSS DESIGN, PLACEMENT PLANS, DETS, & TRUSS TO TRUSS CONNECTIONS.

2. TRUSS SHOP DRAWINGS SHALL BE SIGNED & SEALED BY THE DESIGNING ENGINEER.

3. FOLLOWING DEVELOPMENT OF TRUSS SHOP DRAWINGS, ADJUSTMENTS TO THE ANCHOR REQUIRMENTS MAY BE REQUIRED DEPENDING ON THE ENGINEERED GRAVITY AND WIND UPLIFT REQUIREMENTS OF TRUSSES OR GIRDERS. THE CONTRACTOR SHALL MAKE AVAILABLE A COMPLETE SET OF TRUSS SHOP DRAWINGS TO THE ARCHITECT FOR THE PURPOSE OF REVIEW OF LOADS IMPOSED ON THE BALANCE OF THE STRUCTURE, ANY SUCH REQUIRED CHANGE SHALL BE INCORPORATED INTO THE CONSTRUCTION OF THIS

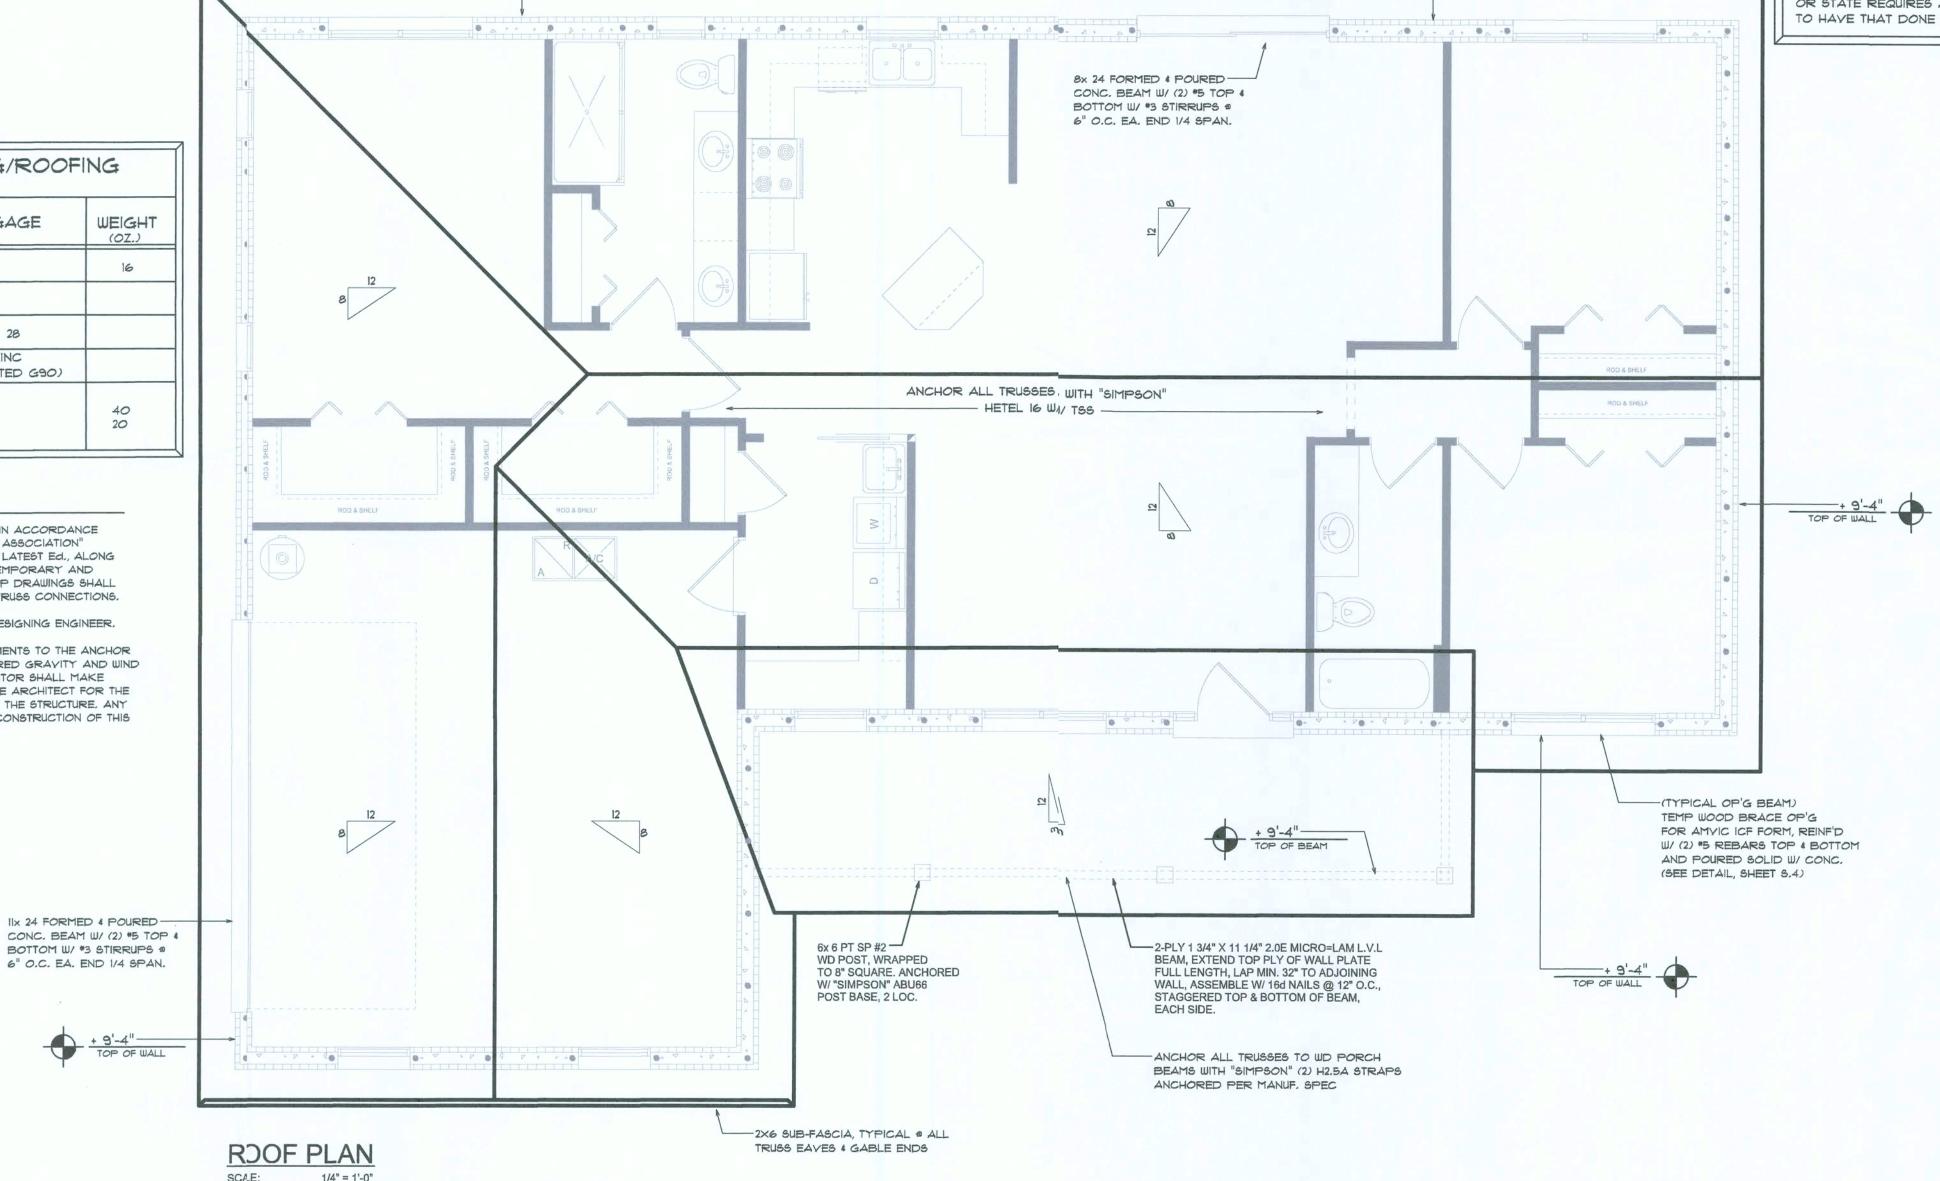

OF YENT AREA OF INTAKE 410 SQ.IN. 1900 SF 24 LF 490 SQ.IN. 2200 SF 28 LF 570 SQ.IN. 2500 SF 32 LF 650 SQ.IN. 2800 SF 36 LF 730 SQ.IN. 3100 SF 40 LF 820 SQ.IN. 3600 SF 44 LF 900 SQ.IN.

- CONT. RIDGE VENT AS PER "GAF" "COBRA RIGID RIDGE YENT II" W/ SHINGLE COVERING SHINGLE ROOFING AS PER SCHEDULE ON PLANS - SEE ROOFING NOTES 5/8" TYPE 'X' T & G PLYWOOD SHEATHING AS PER NAILING SCHEDULE ON PLANS FRAMING AS PER ROOF FRAMING PLAN (TRUSSES OR LUMBER)

MIAMI/DADE PRODUCT APPROYAL REPORT: \*98-0713.05

Ridge Vent DETAIL



Roof Framing PLAN

NOTE: ALL CEILING HEIGHTS SHALL BE 9'-4" UNLESS OTHERWISE NOTED.

SCALE: 3/16" = 1'-0"

IIX 24 FORMED 4 POURED -

BOTTOM W/ \*3 STIRRUPS @


6" O.C. EA. END 1/4 SPAN.

NOTE: ALL DRAWINGS NOT TO BE SCALED, WRITTEN DIMENSIONS TAKE PRECEDENCE OVER SCALED DIMENSIONS

SOFPIAN

PLAN 3/16" = 1'-0"

Z Z <del>-111</del>

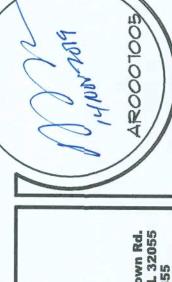

Do

JOB NUMBER 20190710

SHEET NUMBER

OF 4SHEETS

STRUCTURAL DESIGN CRITERIA:

Porch footings: 12"x 12" Cont. W/ (1) #5 Bars Cont.

. THE DESIGN COMPLIES WITH THE REQUIREMENTS OF THE 2017 FLORIDA BUILDING CODE PER R301.2.1.1 AND OTHER REFERENCED CODES AND SPECIFICATIONS. ALL CODES AND SPECIFICATIONS SHALL BE LATEST EDITION AT TIME OF PERMIT.

VASD = 101 MPH

House walls: 24" x 20" Cont. W/ (3) #5 Bars Cont. on wire chairs or (1) #3 Transverse @ 24" O.C.

2. WIND LOAD CRITERIA: RISK CATAGORY: 2, EXPOSURE: "C"

BASED ON ANSI/ASCE 7-10. 2017 FBC 1609-A WIND YELOCITY: Y ULT = 130 MPH

3. ROOF DESIGN LOADS: SUPERIMPOSED DEAD LOADS: . . . . . . 20 PSF SUPERIMPOSED LIVE LOADS: . . . . . . 20 PSF

4. FLOOR DESIGN LOADS: SUPERIMPOSED DEAD LOADS: . . . . . . . 25 PSF

SUPERIMPOSED LIVE LOADS: ..... 40 PSF RESIDENTIAL ..... 60 PSF BALCONIES

5. WIND NET UPLIFT: ARE AS INDICATED ON PLANS

### **TERMITE PROTECTION NOTES:**

### SOIL CHEMICAL BARRIER METHOD

1. A PERMANENT SIGN WHICH IDENTIFIES THE TERMITE TREATMENT PROVIDER AND NEED FOR REINSPECTION AND TREATMENT CONTRACT RENEWAL SHALL BE PROVIDED. THE SIGN SHALL BE POSTED NEAR THE WATER HEATER OR ELECTRIC PANEL. FBC 104.2.6

2. CONDENSATE AND ROOF DOWNSPOUTS SHALL DISCHARGE AT LEAST 1'-0" AWAY FROM BUILDING SIDE WALLS. FBC 1503.4.4

3. IRRIGATION/SPRINKLER SYSTEMS INCLUDING ALL RISERS AND SPRAY HEADS SHALL NOT BE INSTALLED WITHIN 1'-0" FROM BUILDING SIDE WALLS. FBC 1503.4.4

4. TO PROVIDE FOR INSPECTION FOR TERMITE INFESTATION, BETWEEN WALL COVERINGS AND FINAL EARTH GRADE SHALL NOT BE LESS THAN 6". EXCEPTION: PAINT AND DECORATIVE CEMENTIOUS FINISH LESS THAN 5/8" THICK ADHERED DIRECTLY TO THE FOUNDATION WALL. FBC 1403.1.6

5. INITIAL TREATMENT SHALL BE DONE AFTER ALL EXCAVATION AND BACKFILL IS COMPLETE. FBC 1816.1.1

6. SOIL DISTURBED AFTER THE INITIAL TREATMENT SHALL BE RETREATED INCLUDING SPACES BOXED OR FORMED. FBC 1816.1.2

7. BOXED AREAS IN CONCRETE FLOOR FOR SUBSEQUENT INSTALLATION OF TRAPS, ETC., SHALL BE MADE WITH PERMANENT METAL OR PLASTIC FORMS. PERMANENT FORMS MUST BE OF A SIZE AND DEPTH THAT WILL ELIMINATE THE DISTURBANCE OF SOIL AFTER THE INITIAL TREATMENT.

8. MINIMUM 6 MIL VAPOR RETARDER MUST BE INSTALLED TO PROTECT AGAINST RAINFALL DILUTION. IF RAINFALL OCCURS BEFORE VAPOR RET-ARDER PLACEMENT, RETREATMENT IS REQUIRED. FBC 1816.1.4

9. CONCRETE OVERPOUR AND MORTAR ALONG THE FOUNDATION PERIMETER MUST BE REMOVED BEFORE EXTERIOR SOIL TREATMENT. FBC 1816.1.5 10. SOIL TREATMENT MUST BE APPLIED UNDER ALL EXTERIOR CONCRETE

OR GRADE WITHIN 1'-0" OF THE STRUCTURE SIDEWALLS. FBC 1816.1.6 11. AN EXTERIOR VERTICAL CHEMICAL BARRIER MUST BE INSTALLED AFTER CONSTRUCTION IS COMPLETE INCLUDING LANDSCAPING AND IRRIGATION. ANY SOIL DISTURBED AFTER THE VERTICAL BARRIER IS APPLIED, SHALL

BE RETREATED. FBC 1816.1.6 12. ALL BUILDINGS ARE REQUIRED TO HAVE PER-CONSTRUCTION TREATMENT. FBC 1816.1.7

13. A CERTIFICATE OF COMPLIANCE MUST BE ISSUED TO THE BUILDING DEPART-MENT BY # LICENSED PEST CONTROL COMPANY BEFORE A CERTIFICATE OF OCCUPANCY WILL BE ISSUED. THE CERTIFICATE OF COMPLIANCE SHALL STATE: "THE BUILDING HAS RECEIVED A COMPLETE TREATMENT FOR THE PREVENTION OF SUBTERRANEAN TERMITES. THE TREATMENT IS IN ACCORDANCE WITH THE RULES AND LAWS OF THE FLORIDA DEPARTMENT OF AGRICULTURE AND CONS-UMER SERVICES". FBC 1816.1.7

14. AFTER ALL WORK IS COMPLETED, LOOSE WOOD AND FILL MUST BE REMOVED FROM BELOW AND WITHIN 1'-0" OF THE BUILDING. THIS INCLUDES ALL GRADE STAKES, TUB TRAP BOXES, FORMS, SHORING OR OTHER CELLULOSE CONTAINING MATERIAL, FBC 2303.1.3

15. NO WOOD, VEGETATION, STUMPS, CARDBOARD, TRASH, ETC., SHALL BE BURIED WITHIN 15'-0" OF ANY BUILDING OR PROPOSED BUILDING. FBC 2303.1.4

#### FRAMING ANCHOR SCHEDULE

CAP. APPLICATION MANUF'R/MODEL 1410# TRUSS TO WALL: "SIMPSON" HETEL 16 W/ TSS

1700# SIMPSON PC44/EPC44 PORCH BEAM TO POST (4x 4): 1700# PORCH BEAM TO POST (6x 6): SIMPSON PC66/EPC66 PORCH POST TO FND .: SIMPSON ABU44 or ABU 66 2200# 315#/24(0# MISC. JOINTS SIMPSON A34

ALL ANCHORS SHALL BE SECURED W/ NAILS AS PRESCRIBED BY THE MANUFACTURER FOR MAXIMUM JOINT STRENGTH, UNLESS NOTED OTHERWISE.

REFER TO THE INCLUDED STRUCTURAL DETAILS FOR ADDITIONAL ANCHORS/ JOINT REINFORCEMENT AND FASTENERS.


ALL UNLISTED JOINTS IN THE LOAD PATH SHALL BE REINFORCED WITH SIMPSON A34 FRAMING ANCHORS, TYPICAL T.O.

"SEMCO" PRODUCT APPROVAL:

MIAMI/DADE COUNTY REPORT #95-0818.15

"SIMPSON" PRODUCT APPROVALS:

MIAMI/DADE COUNTY REPORT #97-0107.05, #96-1126.11, #99-0623.04 SBCC1 NER-443, NER-393

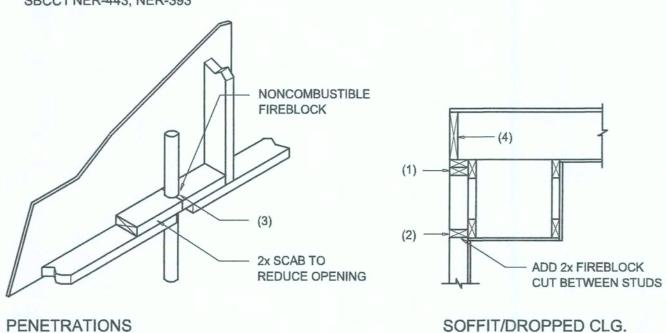

FIREBLOCKING NOTES:

FIREBLOCKING SHALL BE INSTALLED IN WOOD FRAME CONSTRUCTION IN THE FOLLOWING LOCATIONS:

1. IN CONCEALED SPACES OF STUD WALLS AND PARTITIONS INCLUDING FURRED SPACES AT CEILING AND FLOOR LEVELS.

2. AT ALL INTERCONNECTIONS BETWEEN CONCEALED VERTICAL AND HORIZONTAL SPACES SUCH AS OCCUR AT SOFFITS, DROP CEILINGS, COVE CEILINGS, ETC.

3. AT OPENINGS AROUND VENTS, PIPES, DUCTS, CHIMNEYS AND FIREPLACES AT

4. AT ALL INTERCONNECTIONS BETWEEN CONCEALED VERTICAL STUD WALL OR PARTITION SPACES AND CONCEALED SPACES CREATED BY AN ASSEMBLY OF FLOOR JOISTS, FIREBLOCKING SHALL BE PROVIDED FOR THE FULL DEPTH OF THE JOISTS AT THE ENDS AND OVER THE SUPPORTS.

## Fire Stopping DETAILS

SCALE: NONE



#### General Roofing NOTES:

UNDERLAYMENT:

UNLESS OTHERWISE NOTED, UNDERLAYMENT SHALL CONFORM W/ ASTM D 226, TYPE 1, OR ASTM D 4869, TYPE 1.

SELF-ADHERING POLYMER MODIFIED BITUMEN SHEET:

FASTENED SUFFICIENTLY TO STAY IN PLACE.

SELF ADHERING POLYMER MODIFIED BITUMEN SHALL COMPLY W/ ASTM D 1970.

UNDERLAYMENT APPLICATION:

FOR ROOF SLOPES FORM 2:12 TO 4:12, UNDERLAYMENT SHALL BE A MINIMUM OF TWO LAYERS APPLIED AS FOLLOWS: 1. STARTING AT THE EAVE, A 19 INCH STRIP OF UNDERLAYMENT SHALL BE APPLIED PARALLEL WITH THE EAVE AND FASTENED SUFFICIENTLY TO

STAY IN PLACE. 2. STARTING AT THE EAVE, 36 INCH WIDE STRIPS OF UNDERLAYMENT FELT SHALL BE APPLIED OVERLAPPING SUCCESSIVE SHEETS 19 INCHES AND

FOR ROOF SLOPED 4:12 AND GREATER, UNDERLAYMENT SHALL BE A MINIMUM OF ONE LAYER OF UNDERLAYMENT FELT APPLIED AS FOLLOWS: STARTING AT THE EAVE, UNDERLAYMENT SHALL BE APPLIED SHINGLE FASHION PARALLEL TO THE EAVE, LAPPED 2 INCHES, AND FASTENED SUFFICIENTLY TO STAY IN PLACE.

BASE AND CAP FLASHINGS:

BASE AND CAP FLASHING SHALL BE INSTALLED IN ACCORDANCE W/ MFGR'S INSTALLATION INSTRUCTIONS. BASE FLASHING SHALL BE OF EITHER CORROSION RESISTANT METAL OF MINIMUM NOMINAL THICKNESS 0.019 INCH OR MINERAL SURFACE ROLL ROOFING WEIGHING A MINIMUM OF 77 LBS PER 100 SQUARE FEET. CAP FLASHING SHALL BE CORROSION RESISTANT METAL OF MINIMUM NOMINAL THICKNESS OF 0.019 INCH.

VALLEY LININGS SHALL BE INSTALLED IN ACCORDANCE W/ MANUFACTURER'S INSTALLATION INSTRUCTIONS BEFORE APPLYING ASPHALT SHINGLES. VALLEY LININGS OF THE FOLLOWING TYPES SHALL BE PERMITTED.

1. FOR OPEN VALLEYS LINED WITH METAL, THE VALLEY LINING SHALL BE AT LEAST 16" WIDE AND OF ANY OF THE CORROSION RESISTANT METALS IN FBC TABLE 1507.3.9.2.

2. FOR OPEN VALLEYS, VALLEY LINING OF TWO PLIES OF MINERAL SURFACE

ROLL ROOFING SHALL BE PERMITTED. THE BOTTOM LAYER SHALL BE 18 INCHES AND THE TOP LAYER A MINIMUM OF 36 INCHES WIDE.

3. FOR CLOSED VALLEYS VALLEY LINING SHALL BE ONE OF THE FOLLOWING: 1. BOTH TYPES 1 AND 2 ABOVE, COMBINED. 2. ONE PLY OF SMOOTH ROLL ROOFING AT LEAST 36 INCHES WIDE AND

COMPLYING WITH ASTM D 224. 3. SPECIALTY UNDERLAYMENT AT LEAST 36 INCHES WIDE AND COMPLYING WITH ASTM D 1970.


BUILDING COMPONENTS & CLADDING LOADS MEAN BUILDING HEIGHT = 30.0', EXPOSURE "B" ROOF ANGLE T' TO 2T'

	ZONE	AREA	Vult 110 MPH	Vult 120 MPH	Vult 130 MPH	Yult 140 MPH
277	1 1 1	10 20 50	12.0 / -19.9 11.4 / -19.4 10.0 / -18.6	14.9 / -23.7 13.6 / -23.0 11.9 / -22.2	17.5 / -27.8 16.0 / -27.0 13.9 / -26.0	20.3 / -32.3 18.5 / -31.4 16.1 / -30.2
7	2 2 2	10 20 50	12.5 / -34.7 11.4 / -31.9 10.0 / -28.2	14.9 / -41.3 13.6 / -38.0 11.9 / -33.6	17.5 / -48.4 16.0 / -44.6 13.9 / -39.4	20.3 / -56.2 18.5 / -51.7 16.1 / -45.7
ROOF	3 3 3	10 20 50	12.5 / -51.3 11.4 /-47.9 10.0 / -43.5	14.9 / -61.0 13.6 / -57.1 11.9 / -51.8	17.5 / -71.6 16.0 / -67.0 13.9 / -60.8	20.3 / -83.1 18.5 / -17.7 16.1 / -10.5
WALL	4 4 4	10 20 50	21.8 / -23.6 20.8 / -22.6 19.5 / -21.3	25.9 / -34.7 24.7 / -26.9 23.2 / -25.4	30.4 / -33.0 29.0 / -31.6 27.2 / -29.8	35.3 / -38.2 33.7 / -36.7 31.6 / -34.6
AW	5 5 5	10 20 50	21.8 / -29.1 20.8 / -27.2 19.5 / -24.6	25.9 / -34.7 24.7 / -32.4 23.2 / -29.3	30.4 /-40.7 29.0 / -38.0 27.2 / -34.3	35.3 / -47.2 33.7 / -44.0 31.6 / -39.8


	EXPOSURE AT		
BLDG HEIGHT	EXPOSURE	EXPOSURE	EXPOSURE
15	1.00	1.21	1.47
20	1.00	1,29	1.55
25	1.00	1.35	1.61
30	1.00	1.40	1.66


1	BUILDING COMPONENTS & CLADDING LOADS  THEAN BUILDING HEIGHT = 30.0', EXPOSURE "B"  ROOF ANGLE 2T' TO 45"								
	ZONE	ARE4	Vult 110 MPH	Vult 120 MPH	Vult 130 MPH	Vult 140 MPH			
45°	1 1 1	10 20 50	19.9 / -21.8 19.4 / -20.7 18.6 / -19.2	23.7 / -25.9 23.0 / -24.6 22.2 / -22.8	27.8 / -30.4 27.0 / -28.9 26.0 / -26.8	32.3 / -35.3 31.4 / -33.5 30.2 / -31.1			
2T TO	2 2 2	10 20 50	19.9 / -25.5 19.4 / -24.3 18.6 / -22.9	23.7 / -30.3 23.0 / -29.0 22.2 / -27.2	27.8 / -35.6 27.0 / -34.0 26.0 / -32.0	32.3 / -41.2 31.4 / -39.4 30.2 / -37.1			
ROOF	3 3 3	10 20 50	19.9 / -25.5 19.4 / -24.3 18.6 / -22.9	23.7 / -30.3 23.0 / -29.0 22.2 / -27.2	27.8 / -35.6 27.0 / -34.0 26.0 / -32.0	32.3 / -41.2 31.4 / -39.4 30.2 / -37.1			
WALL	4 4 4	10 20 50	21.8 / -23.6 20.8 / -22.6 19.5 / -21.3	25.9 / -34.7 24.7 / -26.9 23.2 / -25.4	30.4 / -33.0 29.0 / -31.6 27.2 / -29.8	35.3 / -38.2 33.7 / -36.7 31.6 / -34.6			
M.W.	5 5 5	10 20 50	21.8 / -29.1 20.8 / -27.2 19.5 / -24.6	25.9 / -34.7 24.7 / -32.4 23.2 / -29.3	30.4 /-40.7 29.0 / -38.0 27.2 / -34.3	35.3 / -47.2 33.7 / -44.0 31.6 / -39.8			

BLDG HEIGHT	EXPOSURE "B"	EXPOSURE "C"	EXPOSURE "D"
15	1.00	1.21	1.47
20	1.00	1.29	1.55
25	1.00	1.35	1.61
30	1.00	1.40	1.66

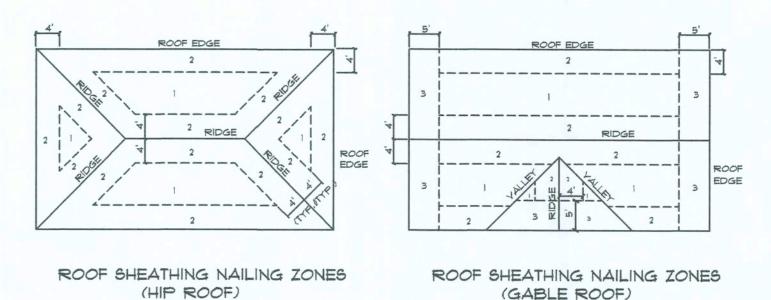



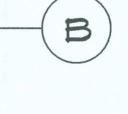

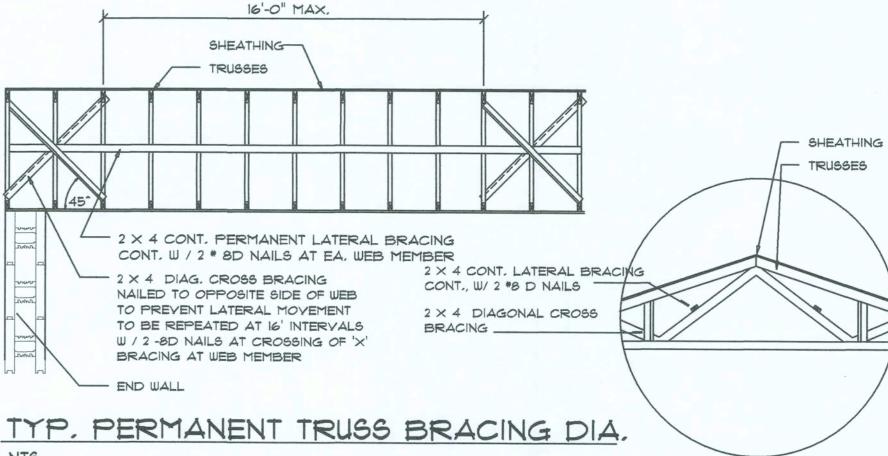


TYP, PERMANENT TRUSS BRACING DIA

NOTE: ALL WOOD TO BE NUMBER 2 GRADE SOUTHERN YELLOW PINE

Truss Bracing DETAILS

SCALE: AS NOTED



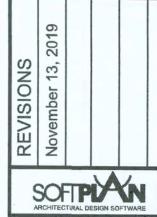



JOB NUMBER 20190710

SHEE NUMBER

OF 4SHEETS

NOTE: ALL DRAWINGS NOT TO BE SCALED, WRITTEN DIMENSIONS TAKE PRECEDENCE OVER SCALED DIMENSIONS

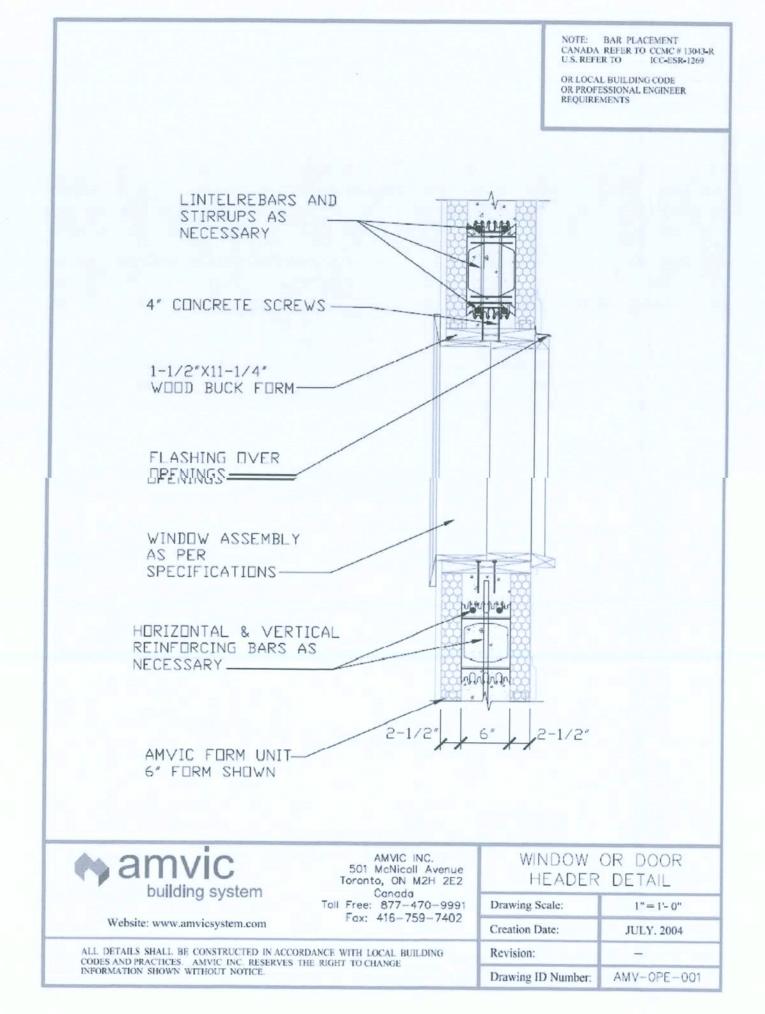

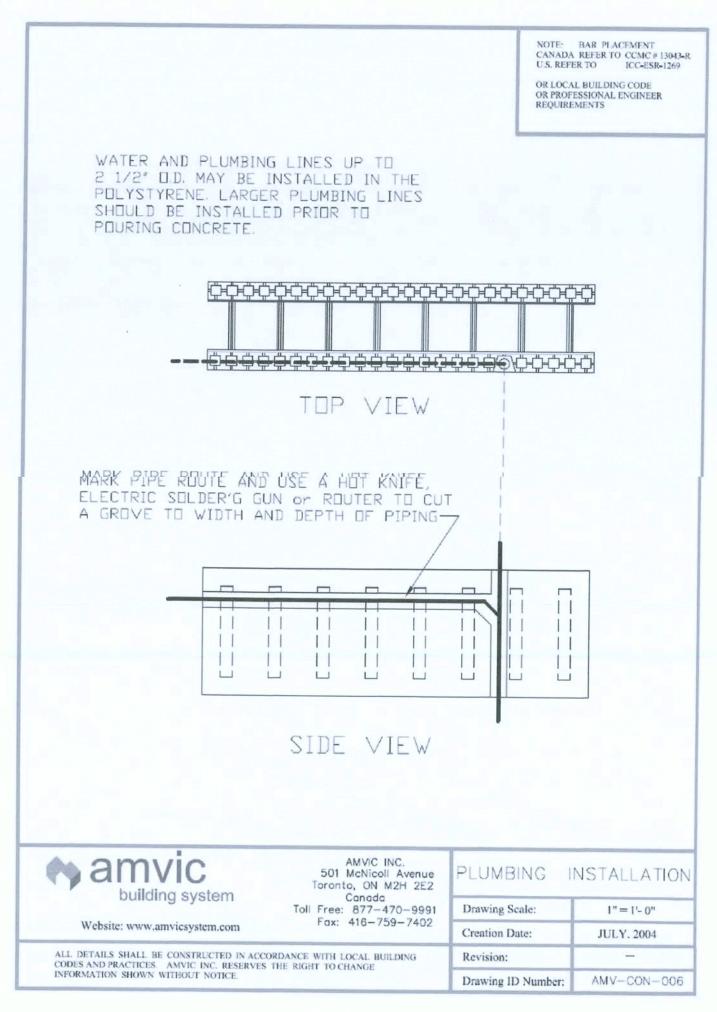

Fox: 416-759-7402

Creation Date:


Item Number:


JULY 2008


Drawing ID Number: AMV-FOR-012


Website: www.amvicsystem.com


ALL DETAILS SHALL BE CONSTRUCTED IN ACCORDANCE WITH LOCAL BUILDING CODES AND PRACTICES. AMVIC INC. RESERVES THE RIGHT TO CHANGE INFORMATION SHOWN WITHOUT NOTICE.

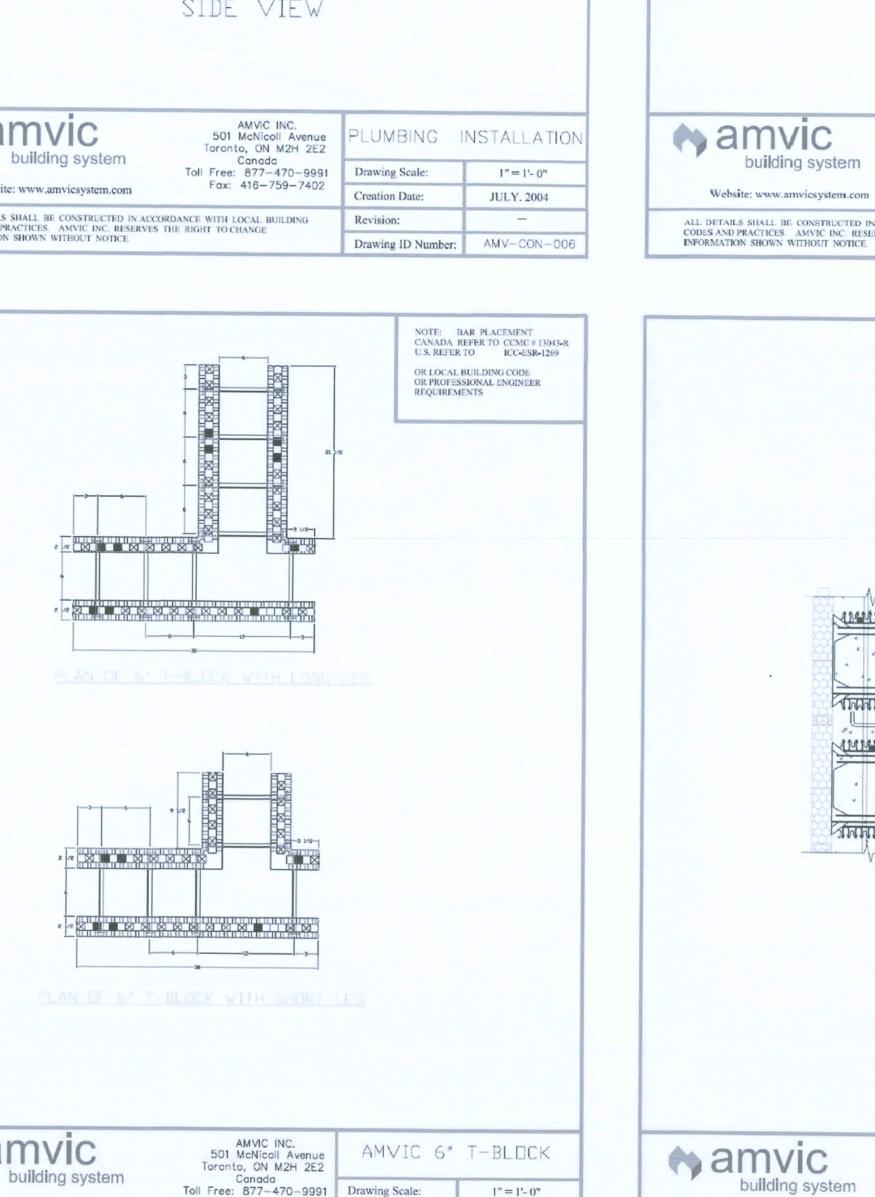


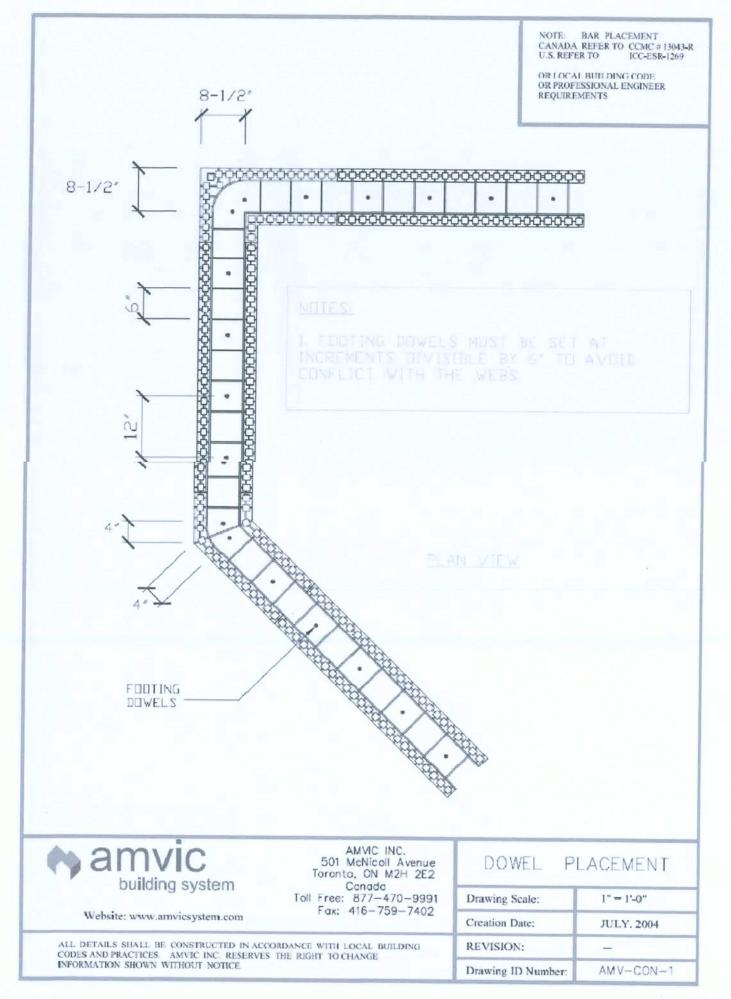


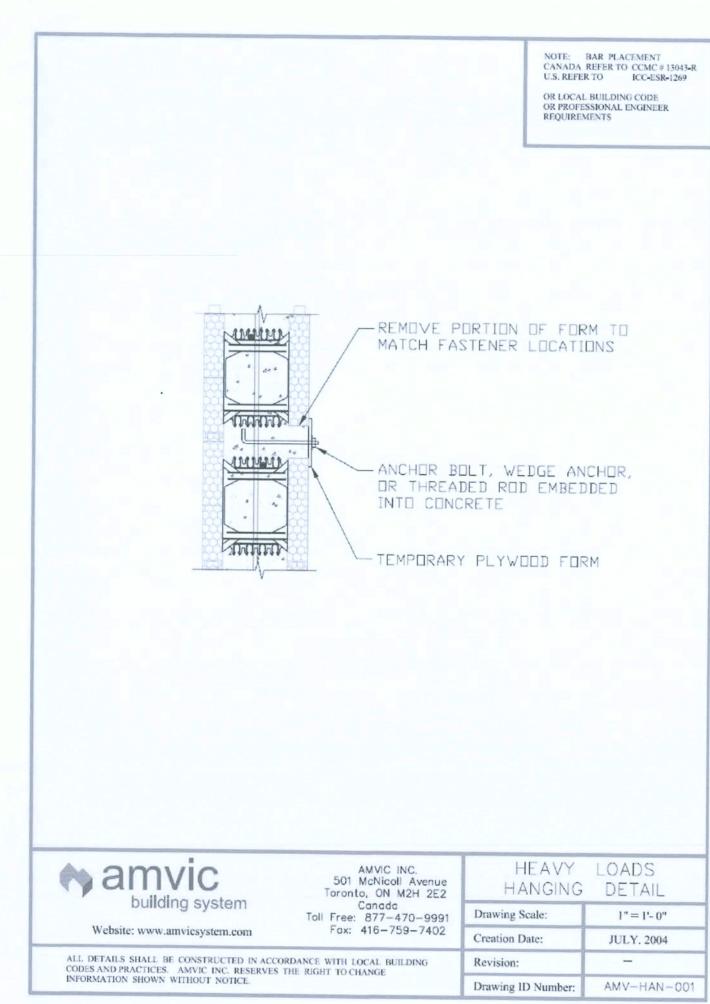

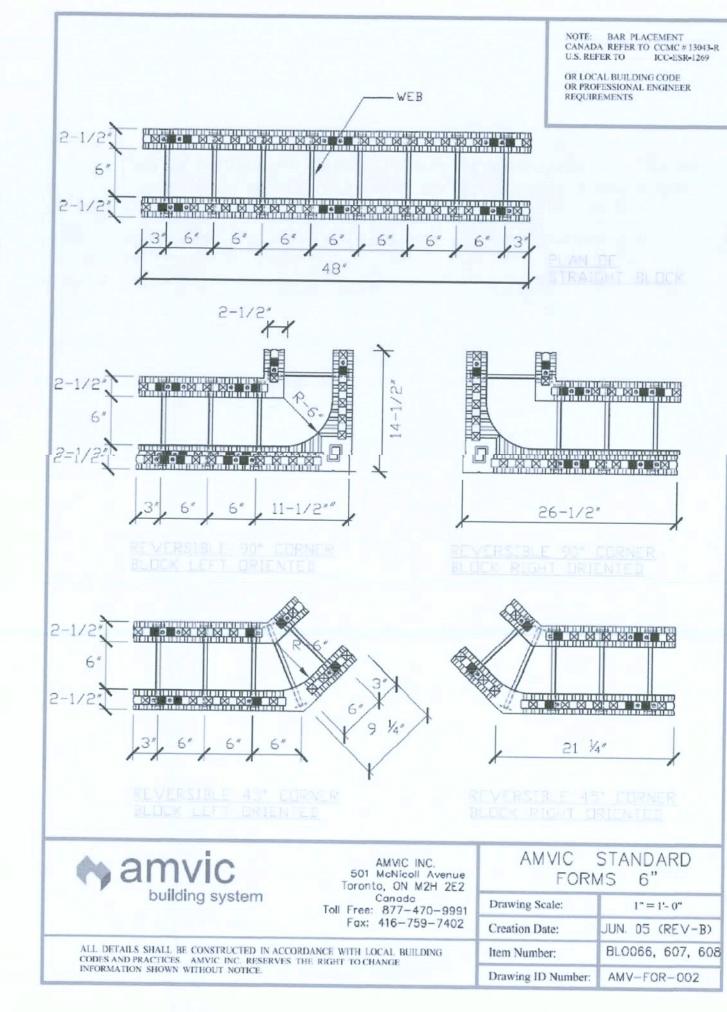

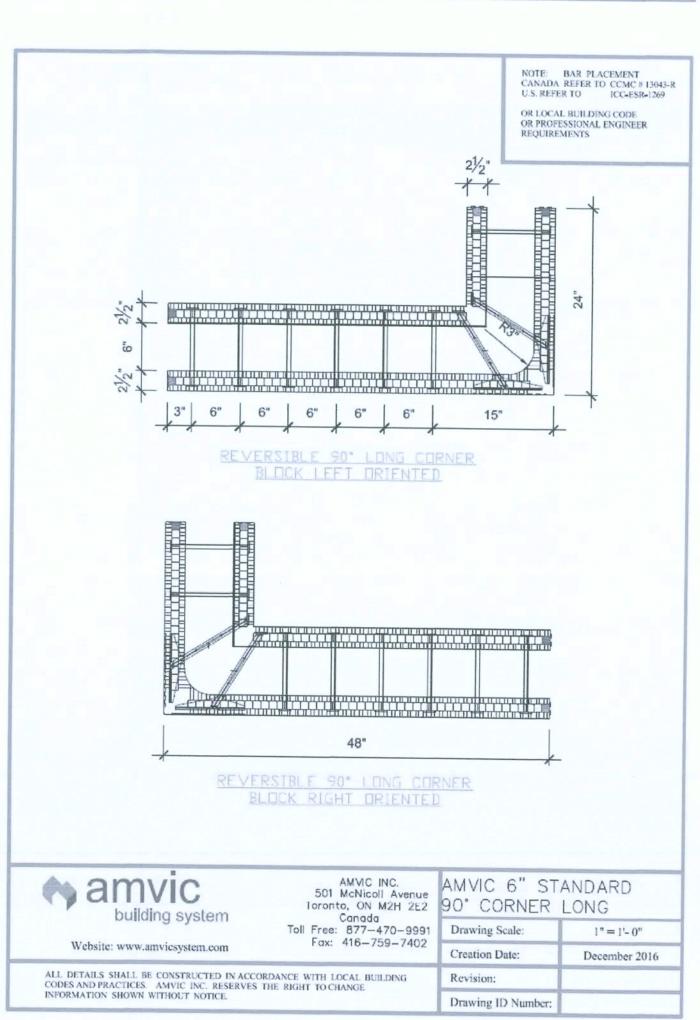

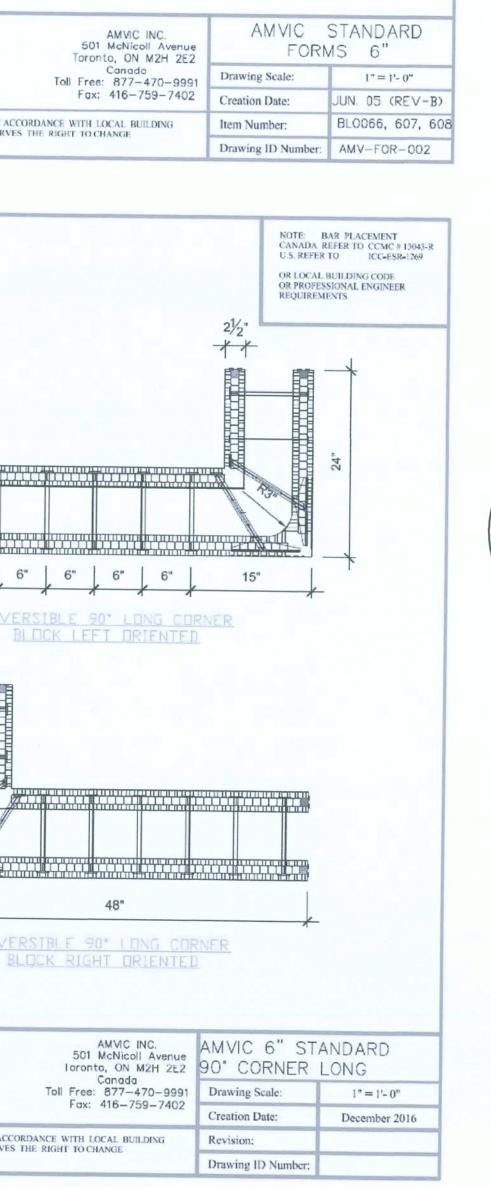

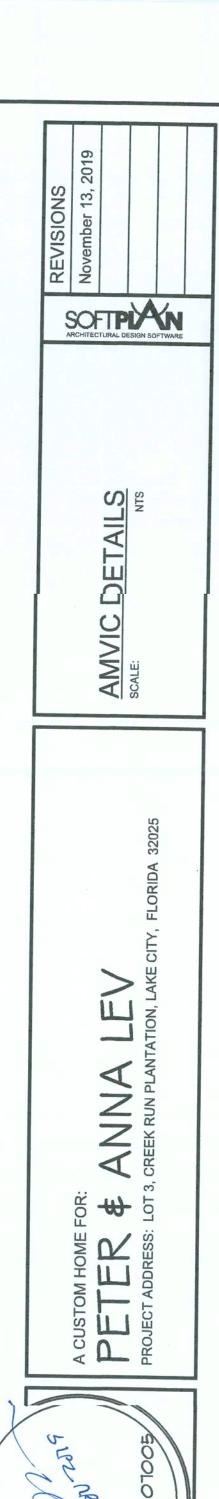




JOB NUMBER 20190710

SHEET NUMBER OF 4 SHEETS

NOTE: ALL DRAWINGS NOT TO BE SCALED, WRITTEN DIMENSIONS TAKE PRECEDENCE OVER SCALED DIMENSIONS

A BOUNDARY SURVEY IN SECTION 21, TOWNSHIP 4 SOUTH, RANGE 17 EAST, COLUMBIA COUNTY, FLORIDA.

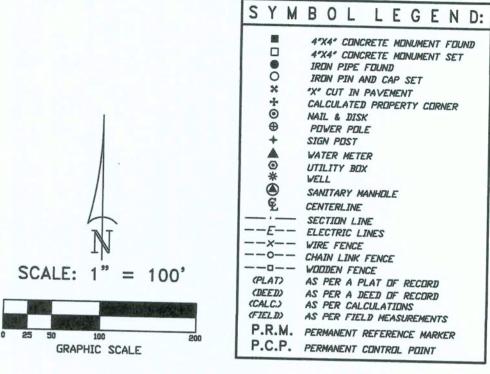

CURVE TABLE

NO. 1 PLAT 2 PLAT	RADIUS 500.00' 500.00' 530.00'	DELTA 14°10′25″ 14°10′06″ 14°30′37″	ARC 123.69' 123.64' 134.22'	TANGENT 62.16' 62.14' 67.47'	CHDRD 123.37' 123.33' 133.86'	CHORD BEARING S.54*46'04"W. S.54*47'37"W. S.55*00'55"W.
5 PLAT \$ PLAT	500.00′ 500.00′ 530.00′ 530.00′	24°22'44° 24°23'03° 24°02'45°	212.75° 212.79° 222.43°	108.01′ 108.03′ 112.88′	211.14' 211.19' 220.80'	S.73°46′02″W. S.74°04′12″W. S.74°13′29″W.

LOT 3 OF "CREEK RUIN PLANTATION" AS PER THE PLAT THEREOF RECORDED IN PLAT BOOK 9, PAGE(S) 55-56 OF TIME PUBLIC RECORDS OF COLUMBIA COUNTY, FLORIDA.

SURVEYOR'S NOTES

1. BOUNDARY BASED) ON MONUMENTATION FOUND IN ACCORDANCE WITH THE RETRACEMENT OF

THE DRIGINAL STURVEY FOR SAID PLAT OF RECORD.

2. BEARINGS ARE BRASED ON SAID PLAT OF RECORD AND THE CENTERLINE OF SE HOLLY TERRACE. 3. IT IS APPARENT THAT THIS PARCEL IS IN ZONE "X" AND IS DETERMINED TO BE OUTSIDE THE 500 YEAR FFLOOD PLAIN AS PER FLOOD RATE MAP, DATED 2 NOVEMBER, 2018 FIRM PANEL NUMBER 12023C0313D. HOWEVER, THE FLOOD INSURANCE RATE MAPS ARE SUBJECT

4. THE IMPROVEMENTS, IF ANY, INDICATED ON THIS SURVEY DRAWING ARE AS LOCATED ON DATE OF FIELD SURVEY AS SHOWN HEREON.

5. IF THEY EXIST, IND UNDERGROUND ENCROACHMENTS AND/OR UTILITIES WERE LOCATED FOR THIS SURVEY EXCEPT AS SHOWN HEREON.

6. THIS SURVEY WAS COMPLETED WITHOUT THE BENEFIT OF A TITLE COMMITMENT OR A TITLE

7. DIMENSIONS SHOWN HEREON ARE IN FEET AND DECIMAL PARTS THEREOF.

8. THIS SURVEY DOGES NOT REFLECT OR DETERMINE OWNERSHIP. 9. THE ADJACENT DIWNERSHIP INFORMATION AS SHOWN HEREON IS BASED ON THE COUNTY PROPERTY APPRIAISERS GIS SYSTEM, UNLESS OTHERWISE DENOTED.

LOT 5 LOT 2 RETENTION LOT 3 **IMPROVEMENTS** LOCATED (VACANT) 559.51' (PLAT) 559.49' (FIELD) .62' (FIELD) 4.70 Acres, ± (NET) 5.01 Acres, ± (GRDSS) 20' EASEMENT FOR INGRESS & EIRESS FOR RETENTION AREA FOR MAINTENANCE LOT 4 S.81°04′55″W. 45.25' (PLAT) PROPOSED-BUILDING S.86°15'43"W. 242.03' (PLAT) S.86°32'13"W. 242.35' (FIELD) PLATTED RIGHT-OF-WAY SE HOLLY TERRACE N.86°16'35"E. 242.07' (FIELD) (PAVED\PUBLIC) N.86°15'43"E. (PLAT)

NOTE: ALL PROPERTY CORNERS LOCATED WERE IDENTIFIED AS L.S. BRITT, P.L.S. 5757.

CERTIFIED TO: ANNA & PETER LEV

SURVEYOR'S CERTIFICATION

I HEREBY CERTIFY THAT THIS SURVEY WAS MADE UNDER MY RESPONSIBLE CHARGE AND MEETS THE MINIMUM TECHNICAL STANDARD: AS SET FORTH BY THE FLORIDA BOARD OF PROFESSIONAL SURVEYORS AND MAPPERS IN CHAPTER 5J-17, FIDRIDA ADMINISTRATIVE CODE, PURSUANT TO SECTION 472,027, FLORIDA STATUTES.

10/11/19 FIELD SURVEY DATE

L. SCOTT BRITT, P.S.M. CERTIFICATION # 5757

NOTE: UNLESS IT BEARS THEORIGINAL SIGNATURE AND THE ORIGINAL RAISED SEAL OF A FLORIDA LICENSED SURVEYOR AND MAPPER THIS DRAYING, SKETCH, PLAT OR MAP IS FOR INFORMATIONAL PURPOSES ONLY AND IS NOT VALID.

10/16/19

DRAWING DATE



# BRITT SURVEYING & MAPPING, LLC

LAIND SURVEYORS AND MAPPERS, L.B. # 8016 2086 SW MAIN BLVD, SUITE, 112 LAKE CITY, FLORIDA 32025

TELEPHONE: (386) 752-7163 FAX: (386) 752-5573

WORK ORDER # L-26102A

FIELD BOOK: SEE PAGE(S): FILE

www.brittsurvey.com