

**COMPLIANCE CODE** 



ATC SITE NAME: LAKE CITY ATC SITE NUMBER: 370667

PROJECT SUMMARY

VERIZON WIRELESS SITE NAME: LAKE CITY ATC VERIZON WIRELESS SITE NUMBER: 5000957580

**VERIZON WIRELESS FUZE PID: 17252856** 

SITE ADDRESS: 5348 NW US HWY 41

LAKE CITY, FL 32055-5550

PROJECT DESCRIPTION



**LOCATION MAP** 

SHEET INDEX

# VERIZON WIRELESS COLLOCATION PLAN

ALL WORK SHALL BE PERFORMED AND MATERIALS INSTALLED IN ACCORDANCE WITH THE CURRENT EDITIONS OF THE	SITE ADDRESS: 5348 NW US HWY 41	VERIZON WIRELESS IS PROPOSING THE FOLLOWING WORK TO BE COMPLETED ON AN EXISTING 340' GUYED TOWER:	SHEET NO:	DESCRIPTION:	REV:	DATE:	BY:
FOLLOWING CODES AS ADOPTED BY THE LOCAL GOVERNMENT AUTHORITIES. NOTHING IN THESE PLANS IS TO BE CONSTRUCT	LAVE CITY EL 2005 FEFO	TOWER WORK:	G-001	TITLE SHEET	0	12/10/24	KAG
TO PERMIT WORK NOT CONFORMING TO THESE CODES.	COUNTY: COLUMBIA	INSTALL (3) SECTOR FRAME MOUNT(S), (9) ANTENNA(S), (6) RRU(s),	G-002	GENERAL NOTES	0	12/10/24	KAG
1. 2023 FLORIDA BUILDING CODE, 8TH EDITION	REGISTERED COORDINATES:	(1) OVP(s), AND (2) 6x12 (1.43") HYBRID CABLE(S).		SITE SURVEY			
<ol> <li>ANSI/TIA-222-H</li> <li>8TH EDITION FLORIDA FIRE PREVENTION CODE</li> </ol>	LATITUDE: 30° 15' 14.80" N NAD 83	GROUND WORK:	C-001	OVERALL SITE PLAN	0	12/10/24	KAG
<ol> <li>2020 NATIONAL ELECTRICAL CODE (NFPA 70)</li> <li>CITY/COUNTY ORDINANCES</li> </ol>	LONGITUDE: 82° 40' 55.40" W GEOGRAPHIC COORDINATES:	INSTALL (2) CONCRETE PAD(S), (1) ICE BRIDGE(S), (1) EQUIPMENT CABINET(S), (1) 30KW GENERATOR(S), (1) OVP(s), (1) GPS ANTENNA(S),	C-101	EXISTING DETAILED SITE PLAN	0	12/10/24	KAG
DESIGN CRITERIA FOR TOWER STRUCTUAL ANALYSIS:	LATITUDE: 30.25421	(1) UTILITY METER(S), (1) DISCONNECT(S), (1) ATS/AC ILC(S), (1) FIBER JUNCTION BOX(ES), (1) LED WORK LAMP(S), (1) H-FRAME(S), AND	C-102	PROPOSED DETAILED SITE PLAN	0	12/10/24	KAG
JLTIMATE WIND SPEED: 118 MPH (3-SECOND GUST)	LONGITUDE: -82.6818	UNDERGROUND POWER AND TELCO IN JOINT TRENCH.	C-201	TOWER ELEVATION	0	12/10/24	KAG
SERVICE WIND SPEED: 60 MPH `	GROUND ELEVATION: 138' AMSL		C-201	TOWER ELEVATION	0	12/10/24	
RISK CATEGORY: II EXPOSURE CATEGORY: B	ZONING INFORMATION:		C-401	ANTENNA INFORMATION & SCHEDULE	0	12/10/24	KAG
TOPOGRAPHIC CATEGORY: 1	JURISDICTION: COLUMBIA COUNTY		C-501	CONSTRUCTION DETAILS	0	12/10/24	KAG
INFORMATION PROVIDED BY STRUCTURAL ANALYSIS BY AMERICAN TOWER CORPORATION, DATED SEPTEMBER 19, 2024	PARCEL ID: 023S1601936000		C-502	CONSTRUCTION DETAILS	0	12/10/24	KAG
AWILINGAN TOWER CONFORMION, DATED SEFTEMBER 19, 202	PROJECT TEAM		C-503	CONSTRUCTION DETAILS	0	12/10/24	KAG
	TOWER OWNER: APPLICANT:		C-504	CONSTRUCTION DETAILS	0	12/10/24	KAG
UTILITY COMPANIES	AMERICAN TOWER VERIZON WIRELESS 10 PRESIDENTIAL WAY WOBURN, MA 01801  ENGINEER: PROPERTY OWNER:		C-505	CONSTRUCTION DETAILS	0	12/10/24	KAG
POWER COMPANY: FLORIDA POWER & LIGHT		PROJECT NOTES	C-506	CONSTRUCTION DETAILS	0	12/10/24	KAG
PHONE: (800) 226-3545		THE FACILITY IS UNMANNED.	C-507	CONSTRUCTION DETAILS	0	12/10/24	KAG
TELEPHONE COMPANY: AT&T PHONE: (800) 331-0500	TEP OPCO, LLC SOUTHERN STONE	A TECHNICIAN WILL VISIT THE SITE APPROXIMATELY ONCE     A MONTH FOR ROUTINE INSPECTION AND MAINTENANCE.	E-101	GROUNDING PLAN & NOTES	0	12/10/24	KAG
	326 TRYON RD COMMUNICATIONS RALEIGH, NC 27603-3530 OF FLORIDA LLC	THE PROJECT WILL NOT RESULT IN ANY SIGNIFICANT LAND     DISTURBANCE OR EFFECT OF STORM WATER DRAINAGE.	E-102 ONE-LINE & PANEL SCHEDULE	ONE-LINE & PANEL SCHEDULE	0	12/10/24	KAG
	DAYTONA BEACH, FL 32117	4. NO SANITARY SEWER, POTABLE WATER OR TRASH	E-501	GROUNDING DETAILS	0	12/10/24	KAG
Always call 811 two full business days before you dig	PROJECT LOCATION DIRECTIONS	DISPOSAL IS REQUIRED.  5. HANDICAP ACCESS IS NOT REQUIRED.  6. THE PROJECT DEPICTED IN THESE PLANS QUALIFIES AS	E-502	GROUNDING DETAILS	0	12/10/24	KAG
~~~~~~~~~~~~~~~~~~~~~~~~~~~~~~~~~~~~~~		AN ELIGIBLE FACILITIES REQUEST ENTITLED TO	R-601 TO R-605	SUPPLEMENTAL			
	FROM I10 TAKE EXIT 301 AND GO NORTH ONTO NW US HIGHWA 41 AND GO NORTH SITE IS JUST UP THE ROAD ON THE LEFT	EXPEDITED REVIEW UNDER 47 U.S.C. § 1455(A) AS A MODIFICATION OF AN EXISTING WIRELESS TOWER THAT INVOLVES THE COLLOCATION, REMOVAL, AND/OR REPLACEMENT OF TRANSMISSION EQUIPMENT THAT IS					

NOT A SUBSTANTIAL CHANGE UNDER CFR § 1.61000 (B)(7).



RALEIGH, NC 27603-3530 OFFICE: (919) 661-6351 www.tepgroup.net FL COA#: 31011

ATC SITE NUMBER: 370667

ATC SITE NAME: LAKE CITY

VERIZON WIRELESS SITE NAME:

LAKE CITY ATC

SITE ADDRESS:

5348 NW US HWY 41 LAKE CITY, FL 32055-5550

REV.	DESCRIPTION	BY	DATE
$\mathbb{A}_{-}$	PRELIMINARY	PSG	10/09/24
<u></u>	100% CONSTRUCTION	<u>KAG</u>	12/10/24
$\triangle$ _			
$\triangle_{-}$			
$\wedge$			

DIGITAL/ELECTRONIC SEAL: THIS DOCUMENT HAS BEEN DIGITALLY SIGNED AND SEALED BY JOSHUA H. CARDEN, P.E. ON THE DATE ADJACENT TO THE SEAL.

PRINTED COPIES OF THIS DOCUMENT ARE NOT CONSIDERED SIGNED AND SEALED AND THE SIGNATURE MUST BE VERIFIED ON ANY ELECTRONIC COPIES.





DATE DRAWN:	12/10/24
ATC JOB NO:	14873543
CUSTOMER NAME:	LAKE CITY ATC
CUSTOMER ID:	5000957580

TITLE SHEET

SHEET NUMBER:

REVISION: G-001

#### GENERAL CONSTRUCTION NOTES:

- OWNER FURNISHED MATERIALS, VERIZON "THE COMPANY" WILL PROVIDE AND THE CONTRACTOR WILL INSTALL
- A. BTS EQUIPMENT FRAME (PLATFORM) AND ICEBRIDGE SHELTER (GROUND
  - BUILD/CO-LOCATE ONLY)

    B. AC/TELCO INTERFACE BOX (PPC)
  - C. ICE BRIDGE (CABLE TRAY WITH COVER) (GROUND BUILD/CO-LOCATE ONLY, GC TO FURNISH AND INSTALL FOR ROOFTOP INSTALLATION)
- D. TOWERS, MONOPOLES
- E. TOWER LIGHTING
- F. GENERATORS & LIQUID PROPANE TANK
- G. ANTENNA STANDARD BRACKETS. FRAMES AND PIPES FOR MOUNTING
- H. ANTENNAS (INSTALLED BY OTHERS)
- I. TRANSMISSION LINE
- J. TRANSMISSION LINE JUMPERS
- K. TRANSMISSION LINE CONNECTORS WITH WEATHERPROOFING KITS
- L. TRANSMISSION LINE GROUND KITS
- M. HANGERS
- N. HOISTING GRIPS
- O. BTS EQUIPMENT
- 2. THE CONTRACTOR IS RESPONSIBLE TO PROVIDE ALL OTHER MATERIALS FOR THE COMPLETE INSTALLATION OF THE SITE INCLUDING, BUT NOT LIMITED TO, SUCH MATERIALS AS FENCING, STRUCTURAL STEEL SUPPORTING SUB-FRAME FOR PLATFORM, ROOFING LABOR AND MATERIALS, GROUNDING RINGS, GROUNDING WIRES, COPPER-CLAD OR XIT CHEMICAL GROUND ROD(S), BUSS BARS, TRANSFORMERS AND DISCONNECT SWITCHES WHERE APPLICABLE, TEMPORARY ELECTRICAL POWER, CONDUIT, LANDSCAPING COMPOUND STONE, CRANES, CORE DRILLING, SLEEPERS AND RUBBER MATTING, REBAR, CONCRETE CAISSONS, PADS AND/OR AUGER MOUNTS, MISCELLANEOUS FASTENERS, CABLE TRAYS, NON-STANDARD ANTENNA FRAMES AND ALL OTHER MATERIAL AND LABOR REQUIRED TO COMPLETE THE JOB ACCORDING TO THE DRAWINGS AND SPECIFICATIONS. IT IS THE POSITION OF VERIZON TO APPLY FOR PERMITTING AND CONTRACTOR RESPONSIBLE FOR PICKUP AND PAYMENT OF REQUIRED PERMITS.
- ALL WORK SHALL CONFORM TO ALL CURRENT APPLICABLE FEDERAL, STATE, AND LOCAL CODES, INCLUDING ANSI/EIA/TIA-222, AND COMPLY WITH ATC CONSTRUCTION SPECIFICATIONS.
- CONTRACTOR SHALL CONTACT LOCAL 811 FOR IDENTIFICATION OF UNDERGROUND UTILITIES PRIOR TO START OF CONSTRUCTION.
- CONTRACTOR SHALL BE RESPONSIBLE FOR COORDINATING ALL REQUIRED INSPECTIONS.
- ALL DIMENSIONS TO, OF, AND ON EXISTING BUILDINGS, DRAINAGE STRUCTURES, AND SITE IMPROVEMENTS SHALL BE VERIFIED IN FIELD BY CONTRACTOR WITH ALL DISCREPANCIES REPORTED TO THE ENGINEER.
- 7. DO NOT CHANGE SIZE OR SPACING OF STRUCTURAL ELEMENTS.
- DETAILS SHOWN ARE TYPICAL; SIMILAR DETAILS APPLY TO SIMILAR CONDITIONS UNLESS OTHERWISE NOTED.
- THESE DRAWINGS DO NOT INCLUDE NECESSARY COMPONENTS FOR CONSTRUCTION SAFETY WHICH SHALL BE THE SOLE RESPONSIBILITY OF THE CONTRACTOR.
- CONTRACTOR SHALL BRACE STRUCTURES UNTIL ALL STRUCTURAL ELEMENTS NEEDED FOR STABILITY ARE INSTALLED. THESE ELEMENTS ARE AS FOLLOWS: LATERAL BRACING, ANCHOR BOLTS. FTC.
- 11. CONTRACTOR SHALL DETERMINE EXACT LOCATION OF EXISTING UTILITIES, GROUNDS DRAINS, DRAIN PIPES, VENTS, ETC. BEFORE COMMENCING WORK.
- 12. INCORRECTLY FABRICATED, DAMAGED, OR OTHERWISE MISFITTING OR NONCONFORMING MATERIALS OR CONDITIONS SHALL BE REPORTED TO THE VERIZON REP PRIOR TO REMEDIAL OR CORRECTIVE ACTION. ANY SUCH REMEDIAL ACTION SHALL REQUIRE WRITTEN APPROVAL BY THE VERIZON REP PRIOR TO PROCEEDING.
- 13. EACH CONTRACTOR SHALL COOPERATE WITH THE VERIZON REP, AND COORDINATE HIS WORK WITH THE WORK OF OTHERS.
- 14. CONTRACTOR SHALL REPAIR ANY DAMAGE CAUSED BY CONSTRUCTION OF THIS PROJECT TO MATCH EXISTING PRE-CONSTRUCTION CONDITIONS TO THE SATISFACTION OF THE VERIZON. CONSTRUCTION MANAGER
- 15. ALL CABLE/CONDUIT ENTRY/EXIT PORTS SHALL BE WEATHERPROOFED DURING INSTALLATION LISING A SILICONE SEALANT
- WHERE EXISTING CONDITIONS DO NOT MATCH THOSE SHOWN IN THIS PLAN SET, CONTRACTOR SHALL NOTIFY THE VERIZON REP AND ENGINEER OF RECORD IMMEDIATELY.
- 17. CONTRACTOR SHALL ENSURE ALL SUBCONTRACTORS ARE PROVIDED WITH A COMPLETE AND CURRENT SET OF DRAWINGS AND SPECIFICATIONS FOR THIS PROJECT.
- 18. CONTRACTOR SHALL REMOVE ALL RUBBISH AND DEBRIS FROM THE SITE AT THE END OF EACH DAY.
- CONTRACTOR SHALL COORDINATE WORK SCHEDULE WITH AMERICAN TOWER CORPORATION (ATC) AND TAKE PRECAUTIONS TO MINIMIZE IMPACT AND DISRUPTION OF OTHER OCCUPANTS OF THE FACILITY.
- CONTRACTOR SHALL FURNISH VERIZON AND AMERICAN TOWER CORPORATION (ATC)
  WITH A PDF MARKED UP AS-BUILT SET OF DRAWINGS UPON COMPLETION OF WORK.
- PRIOR TO SUBMISSION OF BID, CONTRACTOR SHALL COORDINATE WITH VERIZON REP TO DETERMINE WHAT, IF ANY, ITEMS WILL BE PROVIDED. ALL ITEMS NOT PROVIDED SHALL BE PROVIDED AND INSTALLED BY THE CONTRACTOR. CONTRACTOR WILL INSTALL ALL ITEMS PROVIDED.

- 22. PRIOR TO SUBMISSION OF BID, CONTRACTOR SHALL COORDINATE WITH VERIZON REP TO DETERMINE IF ANY PERMITS WILL BE OBTAINED BY CONTRACTOR. ALL REQUIRED PERMITS NOT OBTAINED BY VERIZON MUST BE OBTAINED, AND PAID FOR, BY THE CONTRACTOR.
- $23.\,\,$  Contractor shall install all site signage in accordance with verizon specifications and requirements.
- 24. CONTRACTOR SHALL SUBMIT ALL SHOP DRAWINGS TO VERIZON FOR REVIEW AND APPROVAL PRIOR TO FABRICATION.
- 25. ALL EQUIPMENT SHALL BE INSTALLED ACCORDING TO MANUFACTURER'S SPECIFICATIONS AND LOCATED ACCORDING TO VERIZON SPECIFICATIONS, AND AS SHOWN IN
- 26. THE CONTRACTOR SHALL SUPERVISE AND DIRECT THE PROJECT DESCRIBED HEREIN. THE CONTRACTOR SHALL BE SOLELY RESPONSIBLE FOR ALL THE CONSTRUCTION MEANS, METHODS, TECHNIQUES, SEQUENCES AND PROCEDURES AND FOR COORDINATING ALL PORTIONS OF THE WORK UNDER THE CONTRACT.
- 27. CONTRACTOR SHALL NOTIFY VERIZON REP A MINIMUM OF 48 HOURS IN ADVANCE OF POURING CONCRETE OR BACKFILLING ANY UNDERGROUND UTILITIES, FOUNDATIONS OR SEALING ANY WALL, FLOOR OR ROOF PENETRATIONS FOR ENGINEERING REVIEW AND
- 28. CONTRACTOR SHALL BE RESPONSIBLE FOR SITE SAFETY INCLUDING COMPLIANCE WITH ALL APPLICABLE OSHA STANDARDS AND RECOMMENDATIONS AND SHALL PROVIDE ALL RECESSARY SAFETY DEVICES INCLUDING PPE AND PPM AND CONSTRUCTION DEVICES SUCH AS WELDING AND FIRE PREVENTION, TEMPORARY SHORING, SCAFFOLDING, TRENCH BOYDE'S LODING BADDEIDS ETC.
- 29. THE CONTRACTOR SHALL PROTECT AT HIS OWN EXPENSE, ALL EXISTING FACILITIES AND SUCH OF HIS NEW WORK LIABLE TO INJURY DURING THE CONSTRUCTION PERIOD. ANY DAMAGE CAUSED BY NEGLECT ON THE PART OF THIS CONTRACTOR OR HIS REPRESENTATIVES, OR BY THE ELEMENTS DUE TO NEGLECT ON THE PART OF THIS CONTRACTOR OR HIS REPRESENTATIVES, EITHER TO THE EXISTING WORK, OR TO HIS WORK OR THE WORK OF ANY OTHER CONTRACTOR, SHALL BE REPAIRED AT HIS EXPENSE TO THE OWNERS SATISFACTION
- 30. ALL WORK SHALL BE INSTALLED IN A FIRST CLASS, NEAT AND WORKMANLIKE MANNER BY MECHANICS SKILLED IN THE TRADE INVOLVED. THE QUALITY OF WORKMANSHIP SHALL BE SUBJECT TO THE APPROVAL OF THE VERIZON REP. ANY WORK FOUND BY THE VERIZON REP TO BE OF INFERIOR QUALITY AND/OR WORKMANSHIP SHALL BE REPLACED AND/OR REWORKED AT CONTRACTOR EXPENSE UNTIL APPROVAL IS OBTAINED.
- 31. IN ORDER TO ESTABLISH STANDARDS OF QUALITY AND PERFORMANCE, ALL TYPES OF MATERIALS LISTED HEREINAFTER BY MANUFACTURER'S NAMES AND/OR MANUFACTURER'S CATAL OR NUMBER SHALL BE PROVIDED BY THESE MANUFACTURER'S AS SPECIFIED
- 32. VERIZON FURNISHED EQUIPMENT SHALL BE PICKED-UP AT THE VERIZON WAREHOUSE, NO LATER THAN 48HR AFTER BEING NOTIFIED INSURED, STORED, UNCRATE, PROTECTED AND INSTALLED BY THE CONTRACTOR WITH ALL APPURTENANCES REQUIRED TO PLACE THE EQUIPMENT IN OPERATION, READY FOR USE. THE CONTRACTOR SHALL BE RESPONSIBLE FOR THE FOILING MILEMENT AFTER DICKING IT LIP.
- 33. VERIZON OR HIS ARCHITECT/ENGINEER RESERVES THE RIGHT TO REJECT ANY EQUIPMENT OR MATERIALS WHICH, IN HIS OWN OPINION ARE NOT IN COMPLIANCE WITH THE CONTRACT DOCUMENTS, EITHER BEFORE OR AFTER INSTALLATION AND THE EQUIPMENT SHALL BE REPLACED WITH EQUIPMENT CONFORMING TO THE REQUIREMENTS OF THE CONTRACT DOCUMENTS BY THE CONTRACT AT NO COST TO VERIZON OR THEIR ARCHITECT/ENGINEER

#### STRUCTURAL STEEL NOTES:

- 1. STRUCTURAL STEEL SHALL CONFORM TO THE LATEST EDITION OF THE AISC "SPECIFICATION FOR THE DESIGN, FABRICATION AND ERECTION OF STRUCTURAL STEEL FOR BILLI DINGS."
- 2. STRUCTURAL STEEL ROLLED SHAPES, PLATES AND BARS SHALL CONFORM TO THE FOLLOWING ASTM DESIGNATIONS:
- A. ASTM A-572, GRADE 50 ALL W SHAPES, UNLESS NOTED OR A992 OTHERWISE
- B. ASTM A-36 ALL OTHER ROLLED SHAPES, PLATES AND BARS UNLESS NOTED OTHERWISE.
- C. ASTM A-500, GRADE B HSS SECTION (SQUARE, RECTANGULAR, AND ROUND)
- D. ASTM A-325, TYPE SC OR N ALL BOLTS FOR CONNECTING STRUCTURAL MEMBERS
- ASTM F-1554 07 ALL ANCHOR BOLTS, UNLESS NOTED OTHERWISE
- 3. ALL EXPOSED STRUCTURAL STEEL MEMBERS SHALL BE HOT-DIPPED GALVANIZED AFTER FABRICATION PER ASTM A123. EXPOSED STEEL HARDWARE AND ANCHOR BOLTS SHALL BE GALVANIZED PER ASTM A153 OR 8695.
- 4. ALL FIELD CUT SURFACES, FIELD DRILLED HOLES AND GROUND SURFACES WHERE EXISTING PAINT OR GALVANIZATION REMOVAL WAS REQUIRED SHALL BE REPAIRED WITH (2) BRUSHED COATS OF ZRC GALVILITE COLD GALVANIZING COMPOUND PER ASTM A780 AND MANUFACTURER'S RECOMMENDATIONS.
- 5. DO NOT DRILL HOLES THROUGH STRUCTURAL STEEL MEMBERS EXCEPT AS SHOWN AND DETAILED ON STRUCTURAL DRAWINGS.
- CONNECTIONS:
- A. ALL WELDING TO BE PERFORMED BY AWS CERTIFIED WELDERS AND CONDUCTED IN ACCORDANCE WITH THE LATEST EDITION OF THE AWS WELDING CODE D1.1.
- B. ALL WELDS SHALL BE INSPECTED VISUALLY. 25% OF WELDS SHALL BE INSPECTED WITH DYE PENETRANT OR MAGNETIC PARTICLE TO MEET THE ACCEPTANCE CRITERIA OF AWS D1.1.

REPAIR ALL WELDS AS NECESSARY.

- C. INSPECTION SHALL BE PERFORMED BY AN AWS CERTIFIED WELD INSPECTOR.
- D. IT IS THE CONTRACTORS RESPONSIBILITY TO PROVIDE BURNING/WELDING PERMITS AS REQUIRED BY LOCAL GOVERNING AUTHORITY AND IF REQUIRED SHALL HAVE FIRE DEPARTMENT DETAIL FOR ANY WELDING ACTIVITY.
- E. ALL ELECTRODES TO BE LOW HYDROGEN, MATCHING FILLER METAL, PER AWS D1.1, UNLESS NOTED OTHERWISE.
- MINIMUM WELD SIZE TO BE 0.1875 INCH FILLET WELDS, UNLESS NOTED OTHERWISE.
- G. PRIOR TO FIELD WELDING GALVANIZING MATERIAL, CONTRACTOR SHALL GRIND OFF GALVANIZING %\* BEYOND ALL FIELD WELD SURFACES. AFTER WELD AND WELD INSPECTION IS COMPLETE, REPAIR ALL GROUND AND WELDED SURFACES WITH ZRC GALVILITE COLD GALVANIZING COMPOUND PER ASTM A780 AND MANUFACTURERS RECOMMENDATIONS.
- H. THE CONTRACTOR SHALL PROVIDE ADEQUATE SHORING AND/OR BRACING WHERE REQUIRED DURING CONSTRUCTION UNTIL ALL CONNECTIONS ARE COMPLETE.
- I. ANY FIELD CHANGES OR SUBSTITUTIONS SHALL HAVE PRIOR APPROVAL FROM THE ENGINEER, AND VERIZON PROJECT MANAGER IN WRITING

# SPECIAL CONSTRUCTION ANTENNA INSTALLATION NOTES:

- . WORK INCLUDED:
- A. ANTENNA AND COAXIAL CABLES ARE FURNISHED BY VERIZON UNDER A SEPARATE CONTRACT. THE CONTRACTOR SHALL ASSIST ANTENNA INSTALLATION CONTRACTOR IN TERMS OF COORDINATION AND SITE ACCESS. ERECTION SUBCONTRACTOR SHALL BE RESPONSIBLE FOR THE PROTECTION OF PERSONNEL
- B. INSTALL ANTENNAS AS INDICATED ON DRAWINGS AND VERIZON SPECIFICATIONS.
- C. INSTALL GALVANIZED STEEL ANTENNA MOUNTS AS INDICATED ON DRAWINGS
- D. INSTALL FURNISHED GALVANIZED STEEL OR ALUMINUM WAVEGUIDE AND PROVIDE PRINTOUT OF THAT TEST.
- E. CONTRACTOR SHALL PROVIDE FOUR (4) SETS OF SWEEP TESTS USING ANRITZU-PACKARD 8713B RF SCALAR NETWORK ANALYZER. SUBMIT FREQUENCY DOMAIN REFLECTOMETER(FDR) TESTS RESULTS TO THE PROJECT MANAGER. SWEEP TESTS SHALL BE AS PER ATTACHED RFS "MINIMUM FIELD TESTING RECOMMENDED FOR ANTENNA AND HELIAX COAXIAL CABLE SYSTEMS" DATED 10/5/93. TESTING SHALL BE PERFORMED BY AN INDEPENDENT TESTING SERVICE AND BE BOUND AND SUBMITTED WITHIN ONE WEEK OF WORK COMPLETION.
- F. INSTALL COAXIAL CABLES AND TERMINATING BETWEEN ANTENNAS AND EQUIPMENT PER MANUFACTURER'S RECOMMENDATIONS. WEATHERPROOF ALL CONNECTIONS BETWEEN THE ANTENNA AND EQUIPMENT PER MANUFACTURER'S REQUIREMENTS. TERMINATE ALL COAXIAL CABLE THREE (3) FEET IN EXCESS OF ENTRY PORT LOCATION UNLESS OTHERWISE STATED.
- G. ANTENNA AND COAXIAL CABLE GROUNDING:
- 2. ALL EXTERIOR #6 GREEN GROUND WIRE "DAISY CHAIN" CONNECTIONS ARE TO BE WEATHER SEALED WITH RFS CONNECTORS/SPLICE WEATHERPROOFING KIT #221213 OR FOLIAL.
- 3. ALL COAXIAL CABLE GROUNDING KITS ARE TO BE INSTALLED ON STRAIGHT RUNS OF COAXIAL CABLE (NOT WITHIN BENDS).

#### CONCRETE AND REINFORCING STEEL NOTES:

- 1. DESIGN AND CONSTRUCTION OF ALL CONCRETE ELEMENTS SHALL CONFORM TO THE LATEST EDITIONS OF ALL APPLICABLE CODES INCLUDING: ACI 301 "SPECIFICATIONS FOR STRUCTURAL CONCRETE FOR BUILDINGS", ACI 117 "SPECIFICATIONS FOR TOLERANCES FOR CONCRETE CONSTRUCTION AND MATERIALS", AND ACI 318 "BUILDING CODE REQUIREMENTS FOR REINFORCED CONCRETE."
- 2. MIX DESIGN SHALL BE APPROVED BY VERIZON REP PRIOR TO PLACING CONCRETE.
- 3. CONCRETE SHALL BE NORMAL WEIGHT, 6 % AIR ENTRAINED (+/- 1.5%) WITH A SLUMP RANGE OF 3-6" AND HAVE A MINIMUM 28-DAY COMPRESSIVE STRENGTH OF 4500 PSI UNLESS OTHERWISE NOTED.
- 4. THE FOLLOWING MATERIALS SHALL BE USED:

WELDED WIRE FABRIC:

-AIR-ENTERING AGENT:

PORTLAND CEMENT: ASTM C150, TYPE 2
REINFORCEMENT: ASTM A185, PLAIN STEEL WELDED WIRE FABRIC

ASTM A185

ASTM C 260/C 260M

REINFORCEMENT BARS: ASTM A615, GRADE 60, DEFORMED NORMAL WEIGHT AGGREGATE: ASTM C 33
WATER: ASTM C 94/C 94M

ADMIXTURES:
-WATER-REDUCING AGENT: ASTM C 494/C 494M, TYPE A

-SUPERPLASTICIZER: ASTM C494, TYPE F OR TYPE G
-RETARDING: ASTM C 494/C 494M, TYPE B

5. MINIMUM CONCRETE COVER FOR REINFORCING STEEL SHALL BE NO LESS THAN 3'

- 6. A 3/4" CHAMFER SHALL BE PROVIDED AT ALL EXPOSED EDGES OF CONCRETE IN ACCORDANCE WITH ACI 301 SECTION 4.2.4, UNLESS NOTED OTHERWISE.
  - 7. INSTALLATION OF CONCRETE EXPANSION/WEDGE ANCHOR SHALL BE PER MANUFACTURER'S WRITTEN RECOMMENDED PROCEDURE. THE ANCHOR BOLT, DOWEL, OR ROD SHALL CONFORM TO MANUFACTURER'S RECOMMENDATION FOR EMBEDMENT DEPTH OR AS SHOWN ON THE DRAWINGS. NO REBAR SHALL BE CUT WITHOUT PRIOR APPROVAL FROM AN ATC ENGINEER WHEN DRILLING HOLES IN CONCRETE.
- ADMIXTURES SHALL CONFORM TO THE APPROPRIATE ASTM STANDARD AS REFERENCED IN "METHOD 1" OF ACI 301.
- . DO NOT WELD OR TACK WELD REINFORCING STEEL.
- ALL DOWELS, ANCHOR BOLTS, EMBEDDED STEEL, ELECTRICAL CONDUITS, PIPE SLEEVES, GROUNDS AND ALL OTHER EMBEDDED ITEMS AND FORMED DETAILS SHALL BE IN PLACE BEFORE START OF CONCRETE PLACEMENT.
- REINFORCEMENT SHALL BE COLD BENT WHENEVER BENDING IS REQUIRED.
- 12. DO NOT PLACE CONCRETE IN WATER, ICE, OR ON FROZEN GROUND.
- FOR COLD-WEATHER (ACI 306) AND HOT-WEATHER (ACI 301M) CONCRETE PLACEMENT, CONFORM TO APPLICABLE ACI CODES AND RECOMMENDATIONS. IN EITHER CASE, MATERIALS CONTAINING CHLORIDE, CALCIUM, SALTS, ETC. SHALL NOT BE USED. PROTECT FRESH CONCRETE FROM WEATHER FOR 7 DAYS. MINIMUM.
- 14. ALL CONCRETE SHALL HAVE A "SMOOTH FORM FINISH."
- 15. SPLICING OF REINFORCEMENT IS PERMITTED ONLY AT LOCATIONS SHOWN IN THE CONTRACT DRAWINGS OR AS ACCEPTED BY THE ENGINEER. UNLESS OTHERWISE SHOWN OR NOTED REINFORCING STEEL SHALL BE SPLICED TO DEVELOP ITS FULL TENSILE CAPACITY (CLASS A) IN ACCORDANCE WITH ACI 318.
- 16. DETAILING OF REINFORCING STEEL SHALL CONFORM TO "ACI MANUAL OF STANDARD PRACTICE FOR DETAILING REINFORCED CONCRETE STRUCTURES" (ACI 315).
- ALL SLAB CONSTRUCTION SHALL BE CAST MONOLITHICALLY WITHOUT HORIZONTAL CONSTRUCTION JOINTS, UNLESS SHOWN IN THE CONTRACT DRAWINGS.
- 18. LOCATION OF ALL CONSTRUCTION JOINTS ARE SUBJECT TO THE REQUIREMENTS OF THE CONTRACT DOCUMENTS, CONFORMANCE WITH ACI 318, AND ACCEPTANCE OF THE ENGINEER. DRAWINGS SHOWING LOCATION OF DETAILS OF THE PROPOSED CONSTRUCTION JOINTS SHALL BE SUBMITTED WITH REINFORCING STEEL PLACEMENT DRAWINGS.
- SPLICES OF WWF, AT ALL SPLICED EDGES, SHALL BE SUCH THAT THE OVERLAP MEASURED BETWEEN OUTERMOST CROSS WIRES OF EACH FABRIC SHEET IS NOT LESS THAN THE SPACING OF THE CROSS WIRE PLUS 2 INCHES, NOR LESS THAN 6°.
- 20. BAR SUPPORTS SHALL BE ALL-GALVANIZED METAL WITH PLASTIC TIPS.
- 21. ALL REINFORCEMENT SHALL BE SECURELY TIED IN PLACE TO PREVENT DISPLACEMENT BY CONSTRUCTION TRAFFIC OR CONCRETE. TIE WIRE SHALL BE OF SUFFICIENT STRENGTH FOR INTENDED PURPOSE, BUT NOT LESS THAN NO. 18 GAUGE.
- 22. SLAB ON GROUND: COMPACT STRUCTURAL FILL TO 95% DENSITY AND THEN PLACE 6" GRAVEL BENEATH SLAB

#### **ELECTRICAL NOTES:**

- ELECTRICAL WORK SHALL BE PERFORMED BY ELECTRICAL CONTRACTOR SHALL ENSURE THAT ALL WORK COMPLIES WITH ALL APPLICABLE LOCAL AND STATE CODES AND NATIONAL ELECTRICAL CODE.
- 2. ALL SUGGESTED ELECTRICAL ELEMENTS (SUCH AS BREAKER SIZES, WIRE SIZES, CONDUITS SIZES) ARE FOR ZONING PURPOSES ONLY. IT IS THE RESPONSIBILITY TO OF THE ELECTRICAL CONTRACTOR TO CONFIRM COMPLIANCE WITH LOCAL ELECTRICAL CODES AND PASS ALL APPLICABLE AND NECESSARY INSPECTIONS. IN SOME EVENTS, IT MAY BE NECESSARY TO PERFORM AN ELECTRICAL LOAD STUDY TO VERIFY THE CAPACITY OF THE EXISTING SERVICE. THIS IS NOT THE RESPONSIBILITY OF ATC. IT IS THE RESPONSIBILITY OF THE ELECTRICAL CONTRACTOR.
- CONTRACTOR SHALL FIELD LOCATE ALL BELOW GRADE GROUNDING CABLES AND UTILITY LINES PRIOR TO CONSTRUCTION. CONTRACTOR IS RESPONSIBLE FOR RELOCATION OF ALL UTILITIES AND GROUNDING LINES THAT MAY BECOME DISTURBED OR CONFLICTING IN THE COLURSE OF CONSTRUCTION

ALL DISCREPANCIES FROM WHAT IS SHOWN ON THESE CONSTRUCTION DRAWINGS SHALL BE COMMUNICATED TO ATC ENGINEERING IMMEDIATELY FOR CORRECTION OR RE-DESIGN. FAILURE TO COMMUNICATE DIRECTLY WITH ATC ENGINEERING OR ANY CHANGES FROM THE DESIGN CONDUCTED WITHOUT PRIOR APPROVAL FROM ATC ENGINEERING SHALL BE THE SOLE RESPONSIBILITY OF THE GENERAL CONTRACTOR.



TEP OPCO LLC 326 TRYON ROAD RALEIGH, NC 27603-3530 OFFICE: (919) 661-6351 www.tepgroup.net FL COA#: 31011

EP IS A FAMILY OF COMPANIES LICENSED TO PROVIDE DIFFERENT SERVICES IN IFFERENT JURISDICTIONS. DEPENDING ON THE JURISDICTION, PROFESSIONAL GINEERING AND LAND SURVEYING SERVICES ARE PROVIDED BY TEP OPCO C., A DELAWARE LIMITED LIABILITY COMPANY, TEP ENGINEERING, L.C., A NORTH AROLLINA PROFESSIONAL LIMITED LIABILITY COMPANY, OR MEH HENGINEERING, C., A NEW YORK PROFESSIONAL LIMITED LIABILITY COMPANY, GENERAL ONTRACTOR SERVICES ARE PROVIDED BY TEP OPCO LLC, A DELAWARE MITED LIABILITY COMPANY. WE ACQUIRE THE REQUISITE LICENSES IN EACH TATE. ADDITIONAL INFORMATION CAN BE OBTAINED FROM THE COMPANY.

ATC SITE NUMBER: 370667

ATC SITE NAME:


LAKE CITY

VERIZON WIRELESS SITE NAME: LAKE CITY ATC

SITE ADDRESS: 5348 NW US HWY 41 LAKE CITY, FL 32055-5550

DIGITAL/ELECTRONIC SEAL:
THIS DOCUMENT HAS BEEN DIGITALLY SIGNED
AND SEALED BY JOSHUA H. CARDEN, P.E. ON
THE DATE ADJACENT TO THE SEAL.

PRINTED COPIES OF THIS DOCUMENT ARE NOT CONSIDERED SIGNED AND SEALED AND THE SIGNATURE MUST BE VERIFIED ON ANY ELECTRONIC COPIES.

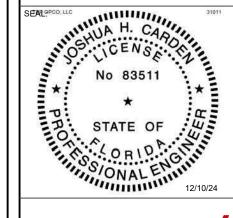



 DATE DRAWN:
 12/10/24

 ATC JOB NO:
 14873543

 CUSTOMER NAME:
 LAKE CITY ATC


 CUSTOMER ID:
 5000957580


GENERAL NOTES

SHEET NUMBER:

G-002

0

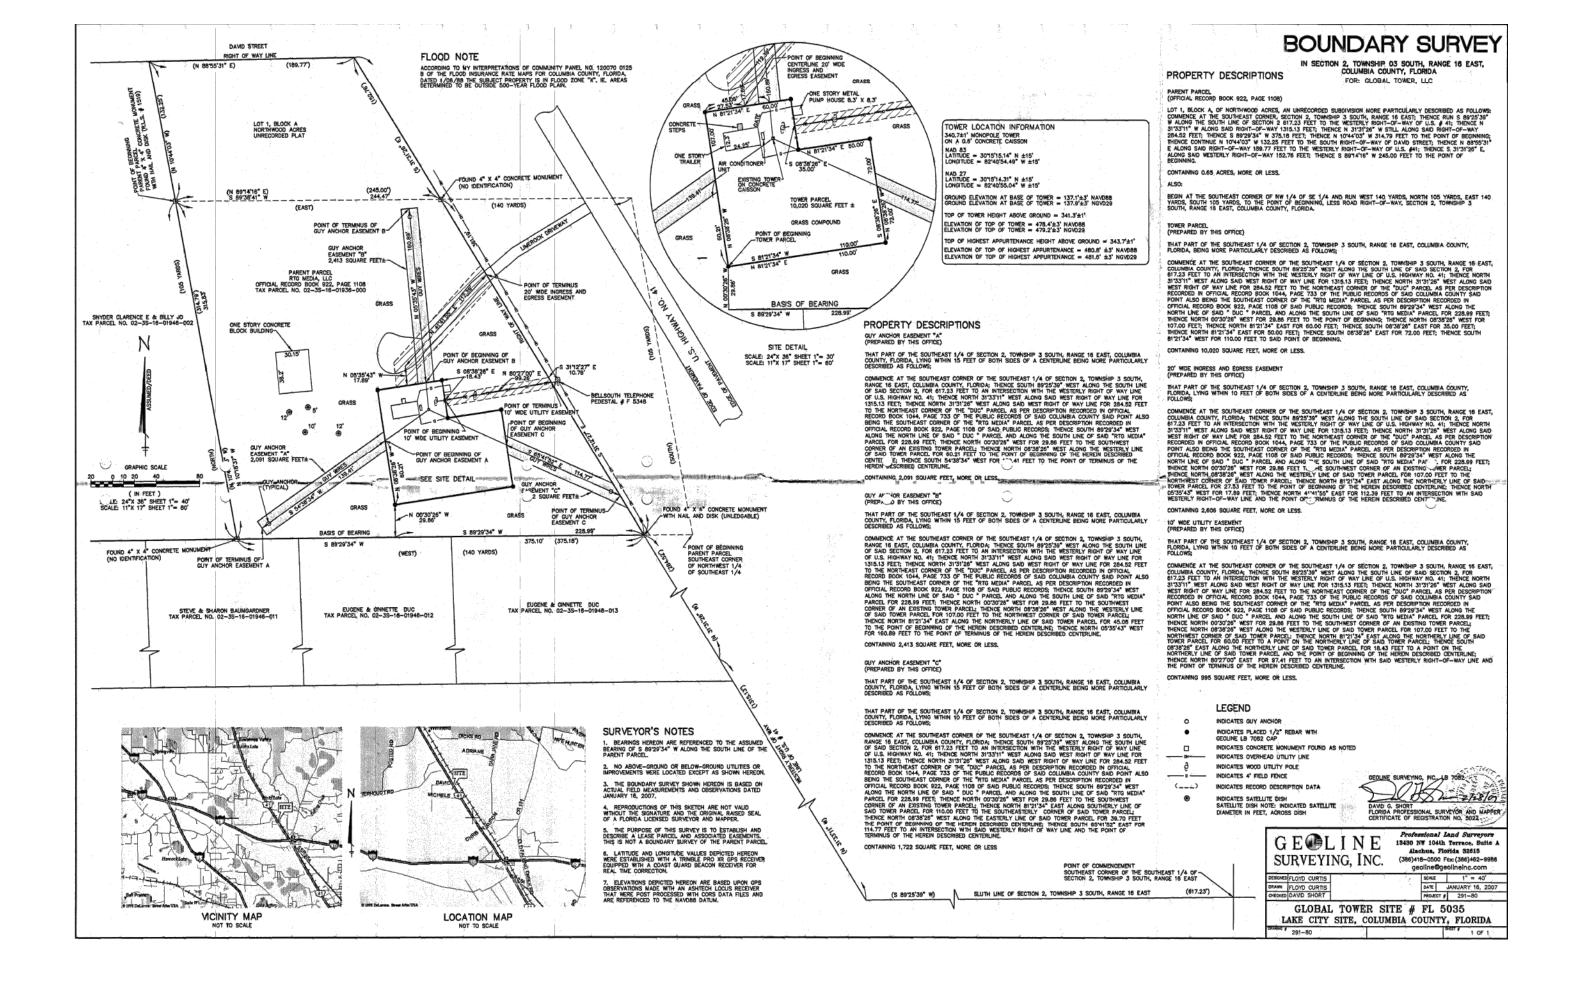

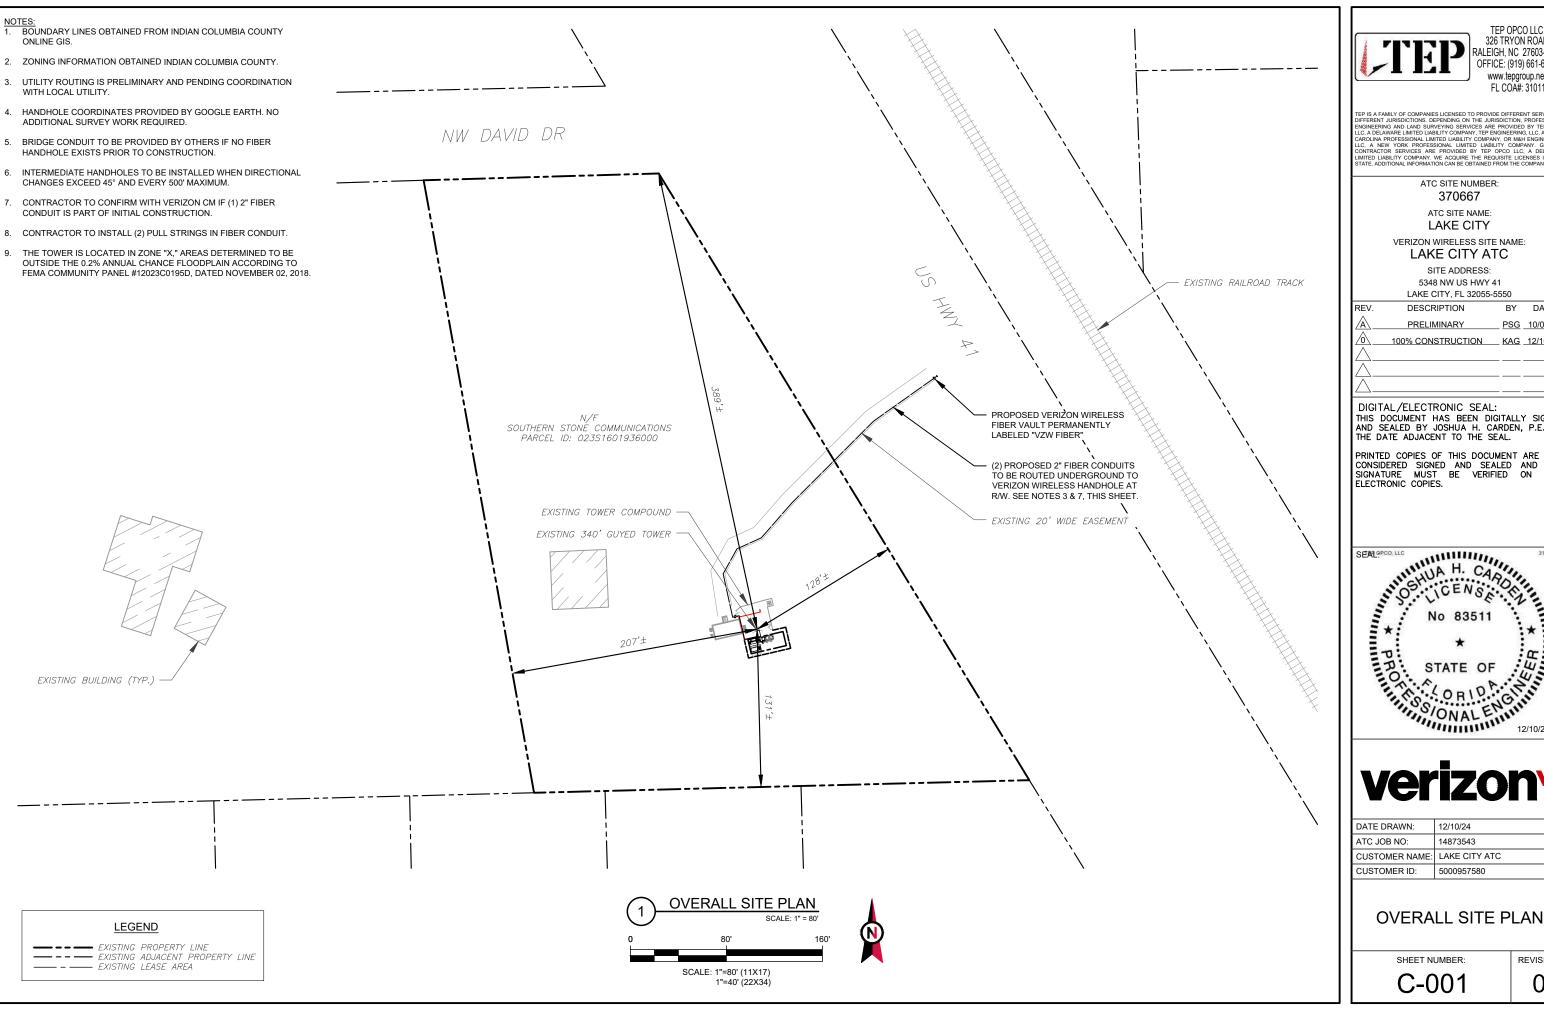



RALEIGH, NC 27603-3530 OFFICE: (919) 661-6351 www.tepgroup.net FL COA#: 31011

TEP IS A FAMILY OF COMPANIES LICENSED TO PROVIDE DIFFERENT SERVICES IN DIFFERENT JURISDICTIONS. DEPENDING ON THE JURISDICTION, PROFESSIONA ENGINEERING AND LAND SURVEYING SERVICES ARE PROVIDED BY TEP OPC. LIC., A DELAWARE LIMITED LUBLITY COMPANY, TEP ENGINEERING, LLC., A NORTI CAROLINA PROFESSIONAL. LIMITED LUBLITY COMPANY, OR MAIN ENGINEERING LIC., A NEW YORK PROFESSIONAL LIMITED LUBLITY COMPANY, GENERA CONTRACTOR SERVICES AND PROVIDED BY TEP OPTOC LIC., A DELAWARD CONTRACTOR SERVICES AND PROVIDED BY TEP OPTOC LIC., A DELAWARD STATE ADDITIONAL INFORMATION CAN BE OBTAINED FROM THE COMPANY.

370667

ATC SITE NAME:

VERIZON WIRELESS SITE NAME:

LAKE CITY ATC

5348 NW US HWY 41

REV.	DESCRIPTION	BY	DATE
$\triangle$ _	PRELIMINARY	PSG	10/09/24
<u>^</u>	100% CONSTRUCTION	KAG	12/10/24
$\wedge$			
$\overline{\wedge}$			
$\overline{\wedge}$			

THIS DOCUMENT HAS BEEN DIGITALLY SIGNED AND SEALED BY JOSHUA H. CARDEN, P.E. ON THE DATE ADJACENT TO THE SEAL.

PRINTED COPIES OF THIS DOCUMENT ARE NOT CONSIDERED SIGNED AND SEALED AND THE SIGNATURE MUST BE VERIFIED ON ANY





DATE DRAWN:	12/10/24
ATC JOB NO:	14873543
CUSTOMER NAME:	LAKE CITY ATC
CUSTOMER ID:	5000957580

**OVERALL SITE PLAN** 

REVISION:

#### SITE PLAN NOTE:

THIS SITE PLAN REPRESENTS THE BEST PRESENT KNOWLEDGE AVAILABLE TO THE ENGINEER AT THE TIME OF THIS DESIGN. THE CONTRACTOR SHALL VISIT THE SITE PRIOR TO CONSTRUCTION AND VERIFY ALL EXISTING CONDITIONS RELATED TO THE SCOPE OF WORK FOR THIS PROJECT.

LEGEND

BOLLARD

DISCONNECT

ELECTRICAL FIBER

**GENERATOR** 

ICE BRIDGE

METER

PULL BOX

POWER POLE TELCO

TRANSFORMER CHAINLINK FENCE

KENTROX BOX

GROUNDING TEST WELL

GENERATOR RECEPTACLE

CELL SITE CABINET

HAND HOLE, VAULT

LIGHTING CONTROL

AUTOMATIC TRANSFER SWITCH

8

B CSC

D

GEN

G HH. V

ΙB

LC


М


РΒ

PP

TRN

ATS

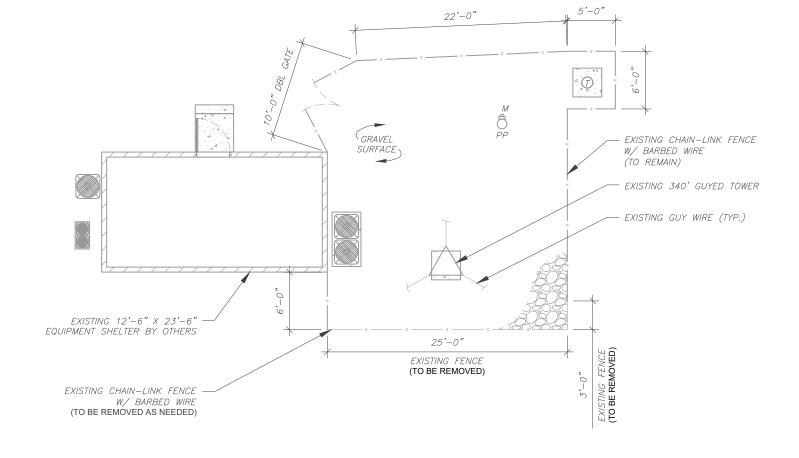

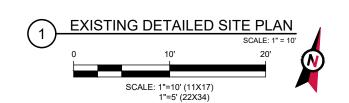



1EP OPCO LLC 326 TRYON ROAD RALEIGH, NC 27603-3530 OFFICE: (919) 661-6351 www.tepgroup.net FL COA#: 31011

TEP IS A FAMILY OF COMPANIES LICENSED TO PROVIDE DIFFERENT SERVICES IN DIFFERENT JURISDICTIONS. DEPENDING ON THE JURISDICTION, PROFESSIONAL ENGINEERING, AND LAND SURVEYING SERVICES ARE PROVIDED BY TEP OPCO LLC, A DELAWARE LIMITED LIABILITY COMPANY, TEP ENGINEERING, LLC, A NORTH OCAROLINA PROFESSIONAL LIMITED LIABILITY COMPANY GENERAL LLC, A NEW YORK PROFESSIONAL LIMITED LIABILITY COMPANY, GENERAL CONTRACTOR SERVICES ARE PROVIDED BY TEP OPCO LIC, A DELAWARE LIMITED LIABILITY, COMPANY, ME ACQUIRE THE RECUSINE LECENSES IN EACH STATE, ADDITIONAL INFORMATION CAN BE OSTAINED FROM THE COMPANY.

ATC SITE NUMBER: 370667

ATC SITE NAME:

LAKE CITY

VERIZON WIRELESS SITE NAME: LAKE CITY ATC

SITE ADDRESS: 5348 NW US HWY 41

5348 NW US HWY 41 LAKE CITY, FL 32055-5550

DIGITAL/ELECTRONIC SEAL:
THIS DOCUMENT HAS BEEN DIGITALLY SIGNED
AND SEALED BY JOSHUA H. CARDEN, P.E. ON
THE DATE ADJACENT TO THE SEAL.

PRINTED COPIES OF THIS DOCUMENT ARE NOT CONSIDERED SIGNED AND SEALED AND THE SIGNATURE MUST BE VERIFIED ON ANY ELECTRONIC COPIES.





	DATE DRAWN:	12/10/24
	ATC JOB NO:	14873543
١	CUSTOMER NAME:	LAKE CITY ATC
	CUSTOMER ID:	5000957580

EXISTING DETAILED SITE PLAN

SHEET NUMBER:

C-101


#### SITE PLAN NOTES:

- 1. THIS SITE PLAN REPRESENTS THE BEST PRESENT KNOWLEDGE AVAILABLE TO THE ENGINEER AT THE TIME OF THIS DESIGN. THE CONTRACTOR SHALL VISIT THE SITE PRIOR TO CONSTRUCTION AND VERIFY ALL EXISTING CONDITIONS RELATED TO THE SCOPE OF WORK FOR THIS PROJECT.
- 2. ICE BRIDGE, CABLE LADDER, COAX PORT, AND COAX CABLE ARE SHOWN FOR REFERENCE ONLY. CONTRACTOR SHALL CONFIRM THE EXACT LOCATION OF ALL PROPOSED AND EXISTING EQUIPMENT AND STRUCTURES DEPICTED ON THIS PLAN. BEFORE UTILIZING EXISTING CABLE SUPPORTS, COAX PORTS, INSTALLING NEW PORTS OR ANY OTHER EQUIPMENT, CONTRACTOR SHALL VERIFY ALL ASPECTS OF THE COMPONENTS MEET THE ATC SPECIFICATIONS.
- 3. IT IS THE RESPONSIBILITY OF THE CONTRACTOR TO COORDINATE WITH THE VERIZON REPRESENTATIVE AND LOCAL UTILITY COMPANY FOR THE INSTALLATION OF CONDUITS, CONDUCTORS, BREAKERS, DISCONNECTS, OR ANY OTHER EQUIPMENT REQUIRED FOR ELECTRICAL SERVICE. ALL ELECTRICAL WORK SHALL BE PERFORMED IN ACCORDANCE WITH LATEST EDITION OF THE STATE AND NATIONAL CODES, ORDINANCES AND REGULATIONS APPLICABLE TO THIS PROJECT.
- CONTRACTOR TO CONFIRM WITH VERIZON CM IF
   (1) 2" FIBER CONDUIT IS PART OF INITIAL
   CONSTRUCTION.
- 5. CONTRACTOR TO INSTALL (2) PULL STRINGS IN FIBER CONDUIT.

#### **LEGEND** 8 GROUNDING TEST WELL ATS AUTOMATIC TRANSFER SWITCH BOLLARD CSC CELL SITE CABINET D DISCONNECT ELECTRICAL GEN GENERATOR GENERATOR RECEPTACLE HH, V HAND HOLE, VAULT ΙB ICE BRIDGE KENTROX BOX LC LIGHTING CONTROL Μ METER РΒ PULL BOX PP POWER POLE TELCO TRN TRANSFORMER CHAINLINK FENCE

#### PROPOSED CABLE NOTES:

- ESTIMATED LENGTH OF PROPOSED CABLE IS 235'. ESTIMATED LENGTH OF CABLE WAS PROVIDED BY CUSTOMER OR CALCULATED BY ADDING THE RAD CENTER AND THE DISTANCE FROM THE SHELTER ENTRY PLATE TO THE TOWER (ALONG THE ICE BRIDGE) AND A SAFETY FACTOR MEASUREMENT OF 15% (OF THE TWO PREVIOUS VALUES), CDS DEFER TO GREATEST CABLE LENGTH.
- 2. ROUTE PROPOSED CABLES ALONG SAME PATH AS EXISTING CABLES AND IN ACCORDANCE WITH STRUCTURAL ANALYSIS. WHERE POSSIBLE UTILIZE EXISTING CABLE SUPPORT STRUCTURES AS PROVIDED FOR CARRIER TO ADEQUATELY SECURE CABLES, USING EITHER APPROPRIATELY SIZED STAINLESS STEEL SNAP-INS OR MOUNTING HARDWARE AND BRACKETS AS SPECIFIED BY CABLE MANUFACTURER. OTHERWISE, ATTACH CABLES TO HORIZONTAL OR DIAGONAL TOWER MEMBERS USING PROPOSED STAINLESS STEEL ADAPTERS (DO NOT ATTACH TO TOWER LEG).

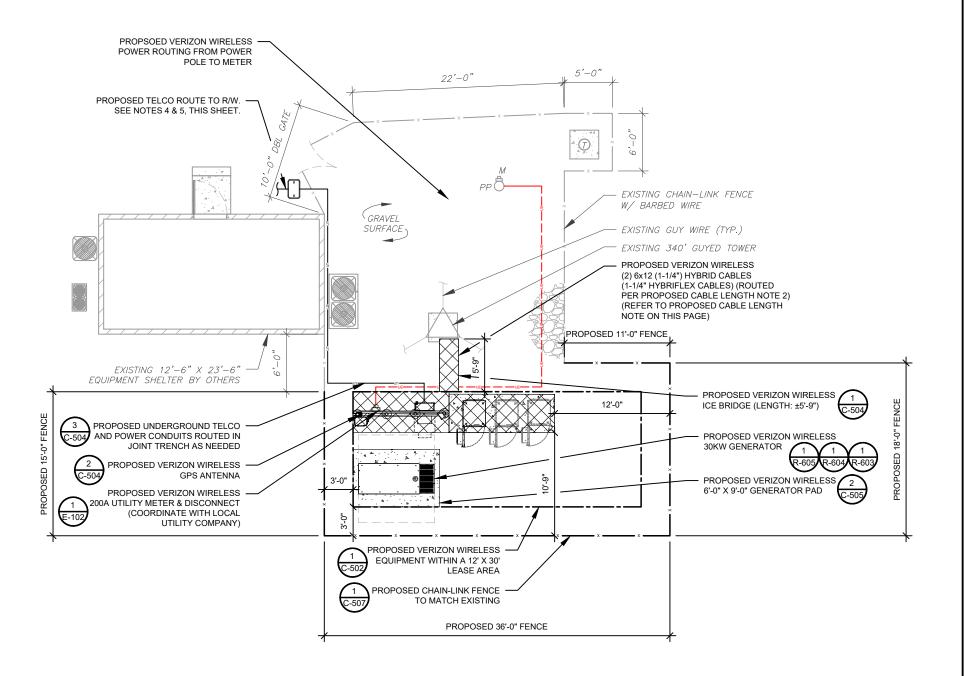





326 TRYON ROAD RALEIGH, NC 27603-3530 OFFICE: (919) 661-6351 www.tepgroup.net FL COA#: 31011

TEP IS A FAMILY OF COMPANIES LICENSED TO PROVIDE DIFFERENT SERVICES IN DIFFERENT JURISDICTIONS. DEPENDING ON THE JURISDICTION, PROFESSIONAL RESINIERERING AND LAND SURVEYING SERVICES ARE PROVIDED BY TEP OPCO LLC, A DELAWARE LIMITED LIABILITY COMPANY, TEP ENGINEERING, LLC, A NORTH OF ACROLINA PROFESSIONAL LIMITED LIABILITY COMPANY OR REPREAL LIMITED LIABILITY COMPANY. GENERAL COMPANY OF THE PROFESSIONAL LIMITED LIABILITY COMPANY GENERAL STATE. ADDITIONAL INFORMATION CAN BE OBTAINED FROM THE COMPANY.

ATC SITE NUMBER: 370667

ATC SITE NAME:

LAKE CITY


VERIZON WIRELESS SITE NAME: LAKE CITY ATC

SITE ADDRESS: 5348 NW US HWY 41

5348 NW US HWY 41 LAKE CITY, FL 32055-5550

DIGITAL/ELECTRONIC SEAL:
THIS DOCUMENT HAS BEEN DIGITALLY SIGNED
AND SEALED BY JOSHUA H. CARDEN, P.E. ON
THE DATE ADJACENT TO THE SEAL.

PRINTED COPIES OF THIS DOCUMENT ARE NOT CONSIDERED SIGNED AND SEALED AND THE SIGNATURE MUST BE VERIFIED ON ANY ELECTRONIC COPIES.

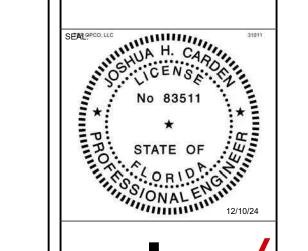




DATE DRAWN:	12/10/24
ATC JOB NO:	14873543
CUSTOMER NAME:	LAKE CITY ATC
CUSTOMER ID:	5000957580

PROPOSED DETAILED EQUIPMENT PLAN

SHEET NUMBER:

C-102

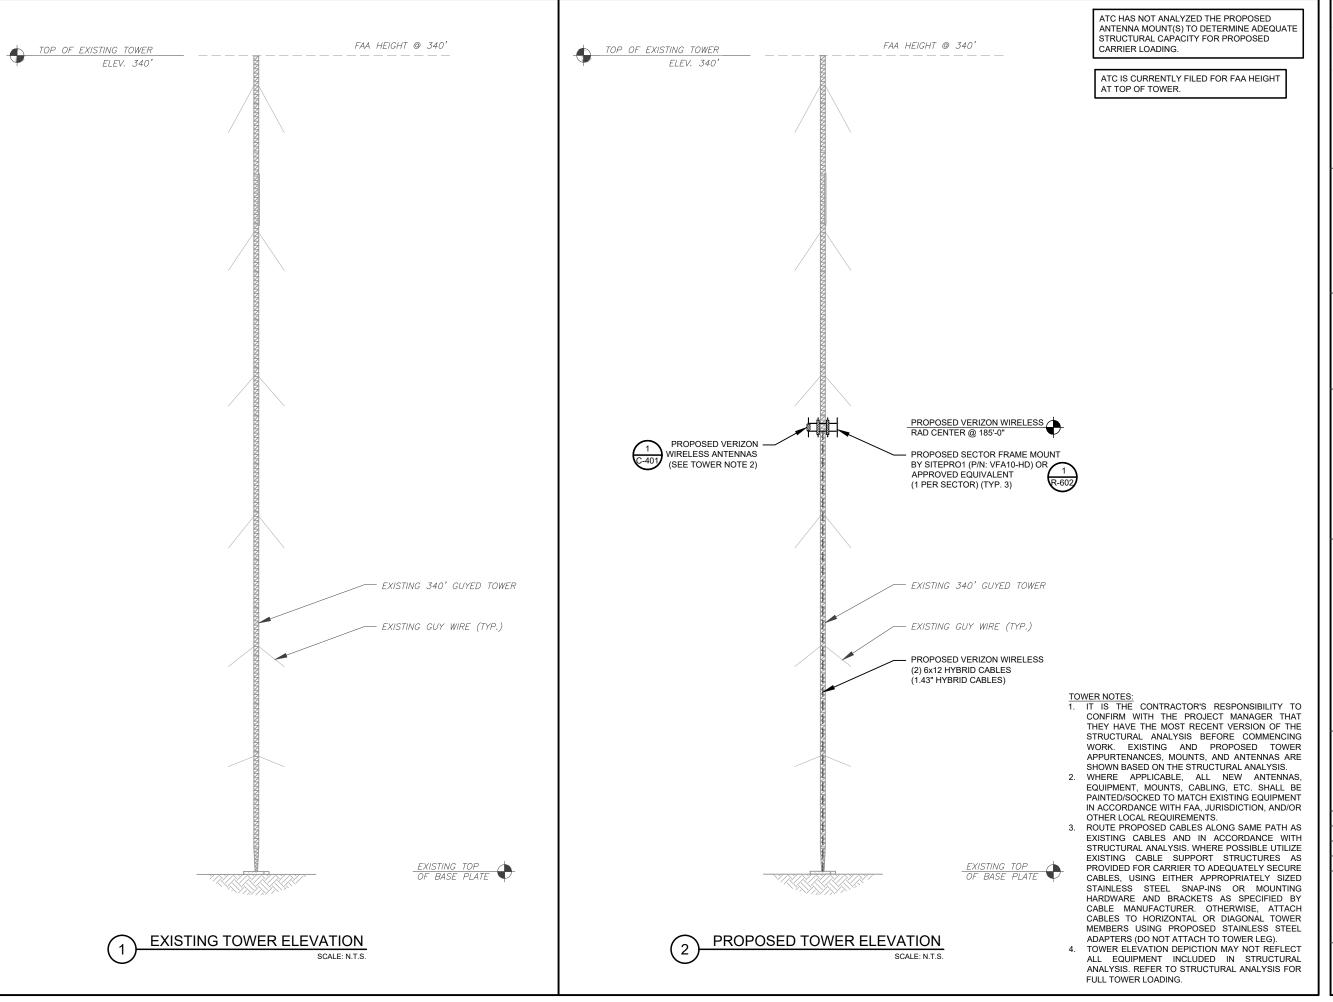



TEP OPCO LLC 326 TRYON ROAD RALEIGH, NC 27603-3530 OFFICE: (919) 661-6351 www.tepgroup.net FL COA#: 31011

TEP IS A FAMILY OF COMPANIES LICENSED TO PROVIDE DIFFERENT SERVICES IN DIFFERENT JURISDICTIONS. DEPENDING ON THE JURISDICTION, PROFESSIONAL. REGISSIERS AND LAND SURVEVING SERVICES ARE PROVIDED BY TEP OPCO. LLC, A DELAWARE LIMITED LABILITY COMPANY, TEP ENGINEERING, LLC, A NORTH ORACINIAN PROFESSIONAL LIMITED LIABILITY COMPANY, OR MAIL HONDINEERING, LLC, A NEW YORK PROFESSIONAL LIMITED LIABILITY COMPANY, GENERAL CONTRACTOR SERVICES AND PROVIDED BY TEP OPCO. LIC, A DELAWARE LIMITED LIBILITY COMPANY WE ACCOUNTED THE DISTRICT OF THE DEPONDED BY EACH STATE ADDITIONAL INFORMATION CAN BE OBTAINED FROM THE COMPANY.

ATC SITE NUMBER: 370667

ATC SITE NAME:

LAKE CITY

VERIZON WIRELESS SITE NAME: LAKE CITY ATC

SITE ADDRESS:

5348 NW US HWY 41 LAKE CITY, FL 32055-5550


REV. DESCRIPTION BY DATE

A PRELIMINARY PSG 10/09/24

O 100% CONSTRUCTION KAG 12/10/24

DIGITAL/ELECTRONIC SEAL:
THIS DOCUMENT HAS BEEN DIGITALLY SIGNED
AND SEALED BY JOSHUA H. CARDEN, P.E. ON
THE DATE ADJACENT TO THE SEAL.

PRINTED COPIES OF THIS DOCUMENT ARE NOT CONSIDERED SIGNED AND SEALED AND THE SIGNATURE MUST BE VERIFIED ON ANY ELECTRONIC COPIES.

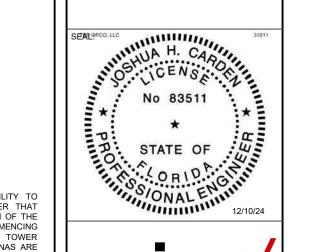



ı		
l	DATE DRAWN:	12/10/24
l	ATC JOB NO:	14873543
l	CUSTOMER NAME:	LAKE CITY ATC
l	CUSTOMER ID:	5000957580


**TOWER ELEVATION** 

SHEET NUMBER:

C-201

REVISION:


ATC HAS NOT ANALYZED THE PROPOSED ANTENNA MOUNT(S) TO DETERMINE ADEQUATE STRUCTURAL CAPACITY FOR PROPOSED CARRIER LOADING.

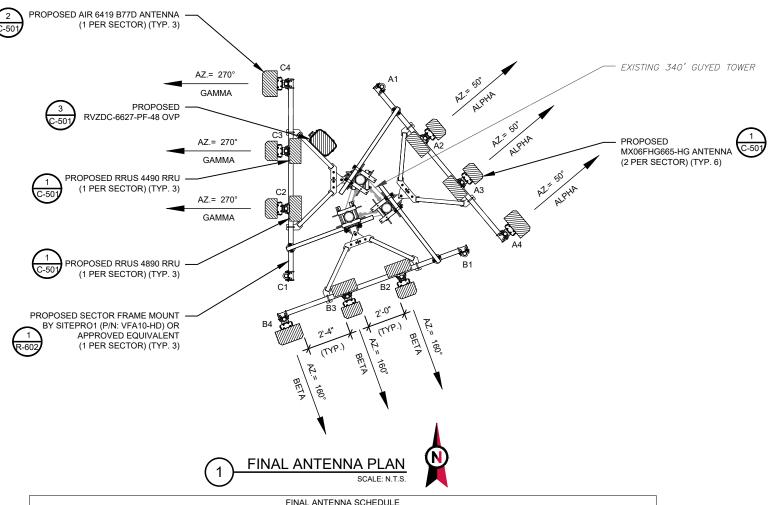

	FINAL ANTENNA SCHEDULE									
LO	LOCATION ANTENNA SUMMARY					NON ANTENNA SUMMARY				
SECTOR	RAD	AZ	POS	ANTENNA	BAND	MECH/ELEC D-TILT	STATUS	ADDITIONAL TOWER MOUNTED EQUIPMENT	STATUS	
			A1	-	-	*	-	-	-	
ALPHA	4051	185' 50°	50°	A2	MX06FHG665-HG	LTE 700/5G 850/LTE 850/ LTE 1900/LTE AWS/LTE AWS3	*	ADD	(1) RRUS 4890	ADD
ALPHA	100			50	50	А3	MX06FHG665-HG	LTE 700/5G 850/LTE 850/ LTE 1900/LTE AWS/LTE AWS3	*	ADD
			A4	AIR 6419 B77D	5G L-SUB6	*	ADD	-	-	
	185'		B1	-	-	*	-	-	-	
ВЕТА		160°	B2	MX06FHG665-HG	LTE 700/5G 850/LTE 850/ LTE 1900/LTE AWS/LTE AWS3	*	ADD	(1) RRUS 4890	ADD	
		160	ВЗ	MX06FHG665-HG	LTE 700/5G 850/LTE 850/ LTE 1900/LTE AWS/LTE AWS3	*	ADD	(1) RRUS 4490	ADD	
			B4	AIR 6419 B77D	5G L-SUB6	*	ADD	-	-	
			C1	-	-	*	-	-	-	
GAMMA	185'	0700	C2	MX06FHG665-HG	LTE 700/5G 850/LTE 850/ LTE 1900/LTE AWS/LTE AWS3	*	ADD	(1) RRUS 4890	ADD	
	100	270°	СЗ	MX06FHG665-HG	LTE 700/5G 850/LTE 850/ LTE 1900/LTE AWS/LTE AWS3	*	ADD	(1) RRUS 4490	ADD	
			C4	AIR 6419 B77D	5G L-SUB6	*	ADD	-	-	

1. CONFIRM WITH VERIZON WIRELESS REP FOR APPLICABLE UPDATES/REVISIONS AND MOST RECENT RFDS FOR NSN CONFIGURATION (CONFIG). GC TO CAP ALL UNUSED PORTS.

CABLE LENGTHS FOR JUMPERS FIBER DISTRIBUTION/OVP TO RRU: 15'

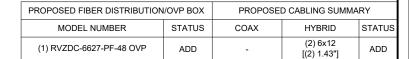



326 TRYON ROAD RALEIGH, NC 27603-3530 OFFICE: (919) 661-6351 www.tepgroup.net FL COA#: 31011

EP IS A FAMILY OF COMPANIES LICENSED TO PROVIDE DIFFERENT SERVICES IFFERENT JURISDICTIONS. DEPENDING ON THE JURISDICTION, PROFESSIONA MOINEERING AND LAND SURVEYING SERVICES ARE PROVIDED BY TEP OFC. C., A DELAWARE LIMITED LIABILITY COMPANY, TEP ENGINEERING, LLC, A NORT AROLLINA PROFESSIONAL LIMITED LIABILITY COMPANY, OR MARINE LIMITED LIABILITY COMPANY. GENERAL ONTRACTOR SERVICES ARE PROVIDED BY TEP OFFCO. LIC., A DELAWARE MITTED LIABILITY COMPANY. SENERAL ONTRACTOR SERVICES ARE PROVIDED BY TEP OFFCO. LIC., A DELAWARE MITTED LIABILITY OF THE MARINE PROVIDED BY THE PORT OF THE COMPANY. SENERAL OFFI THE THE PROFILES IN EACTION AND THE COMPANY.

ATC SITE NUMBER: 370667

ATC SITE NAME: LAKE CITY

VERIZON WIRELESS SITE NAME: LAKE CITY ATC


SITE ADDRESS:

5348 NW US HWY 41 LAKE CITY, FL 32055-5550

REV.	DESCRIPTION	BY	DATE
<u> </u>	PRELIMINARY	PSG	10/09/24
<u> </u>	100% CONSTRUCTION	KAG	12/10/24
$\wedge$			
$\overline{\wedge}$			
$\overline{\wedge}$			

DIGITAL/ELECTRONIC SEAL: THIS DOCUMENT HAS BEEN DIGITALLY SIGNED AND SEALED BY JOSHUA H. CARDEN, P.E. ON THE DATE ADJACENT TO THE SEAL.

PRINTED COPIES OF THIS DOCUMENT ARE NOT CONSIDERED SIGNED AND SEALED AND THE SIGNATURE MUST BE VERIFIED ON ANY ELECTRONIC COPIES.

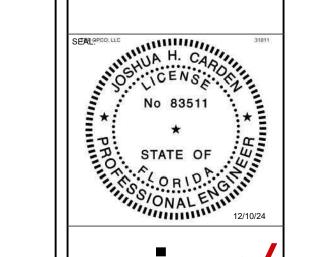



DATE DRAWN:	12/10/24
ATC JOB NO:	14873543
CUSTOMER NAME:	LAKE CITY ATC
CUSTOMER ID:	5000957580

# ANTENNA INFORMATION & SCHEDULE

SHEET NUMBER:

C-401


REVISION:

0

ANTENNA SCHEDULE

<sup>2.</sup> CONFIRM SPACING OF PROPOSED EQUIP DOES NOT CAUSE TOWER CONFLICTS NOR IMPEDE TOWER CLIMBING PEGS.


<sup>\* -</sup> SEE RFDS FOR VALUES

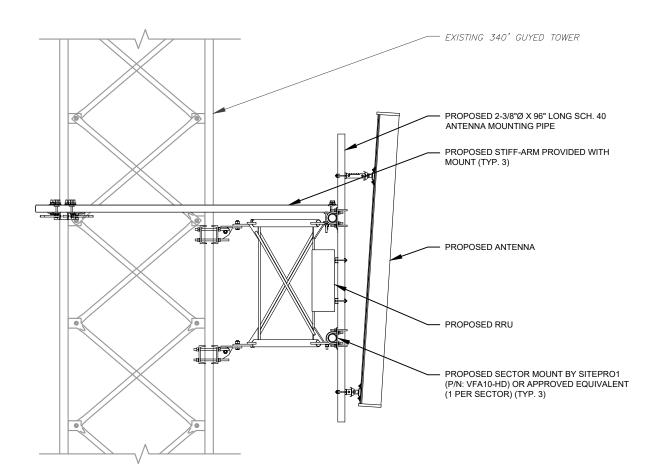


EXISTING 340' GUYED TOWER PROPOSED 2-3/8"Ø X 96" LONG SCH. 40 ANTENNA MOUNTING PIPE PROPOSED STIFF-ARM PROVIDED WITH MOUNT (TYP. 3) PROPOSED 5G ANTENNA PROPOSED SECTOR MOUNT BY SITEPRO1 (P/N: VFA10-HD) OR APPROVED EQUIVALENT (1 PER SECTOR) (TYP. 3)


PROPOSED ANTENNA MOUNTING DETAIL

PROPOSED 5G ANTENNA MOUNTING DETAIL

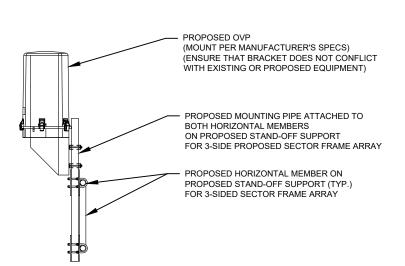

PROPOSED OVP MOUNTING DETAIL

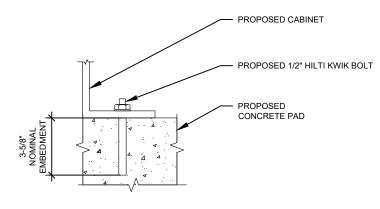

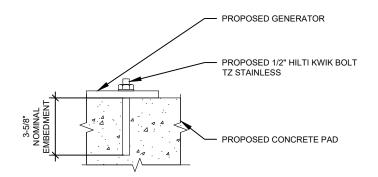

NOTE:

INSTALL HILTI KWIK BOLT ANCHORS STRICTLY PER INSTALLATION INSTRUCTIONS INCLUDED WITH PRODUCT OR FOUND ONLINE AT WWW.US.HILTI.COM. PROPER INSTALLATION IS CRITICAL FOR FULL PERFORMANCE.

SCALE: N.T.S.

NOTE:

INSTALL HILTI KWIK BOLT ANCHORS STRICTLY PER INSTALLATION INSTRUCTIONS INCLUDED WITH PRODUCT OR FOUND ONLINE AT WWW.US.HILTI.COM. PROPER INSTALLATION IS CRITICAL FOR FULL PERFORMANCE.

CABINET ATTACHMENT DETAIL

GENERATOR ATTACHMENT DETAIL SCALE: NOT TO SCALE



TEP OPCO LLC 326 TRYON ROAD RALEIGH, NC 27603-3530 OFFICE: (919) 661-6351 www.tepgroup.net FL COA#: 31011

TEP IS A FAMILY OF COMPANIES LICENSED TO PROVIDE DIFFERENT SERVICES. DIFFERENT JURISDICTIONS. DEPENDING ON THE JURISDICTION, PROFESSIONA NEGINEERING, AND LAND SURVEYING SERVICES ARE PROVIDED BY TEP OPC. L.C., A DELAWARE LIMITED LIABILITY COMPANY, TEP ENGINEERING, L.C., A NORT SARCILIAN PROFESSIONAL. LIMITED LIABILITY COMPANY, OR MAH ENGINEERIN L.C., A NEW YORK PROFESSIONAL. LIMITED LIABILITY COMPANY. OR SENER! CONTRACTOR SERVICES ARE PROVIDED BY TEP OTFOC LICE, A DELAWARE TATE. ADDITIONAL INFORMATION CAN BE OBTAINED FROM THE COMPANY.

ATC SITE NUMBER: 370667

ATC SITE NAME:

LAKE CITY VERIZON WIRELESS SITE NAME:

LAKE CITY ATC

SITE ADDRESS: 5348 NW US HWY 41 LAKE CITY, FL 32055-5550

DESCRIPTION BY DATE **PRELIMINARY** PSG 10/09/24 100% CONSTRUCTION KAG 12/10/24

DIGITAL/ELECTRONIC SEAL: THIS DOCUMENT HAS BEEN DIGITALLY SIGNED AND SEALED BY JOSHUA H. CARDEN, P.E. ON THE DATE ADJACENT TO THE SEAL.

PRINTED COPIES OF THIS DOCUMENT ARE NOT CONSIDERED SIGNED AND SEALED AND THE SIGNATURE MUST BE VERIFIED ON ANY ELECTRONIC COPIES.






DATE DRAWN:	12/10/24
ATC JOB NO:	14873543
CUSTOMER NAME:	LAKE CITY ATC
CUSTOMER ID:	5000957580

CONSTRUCTION **DETAILS** 

SHEET NUMBER:

C-501

0

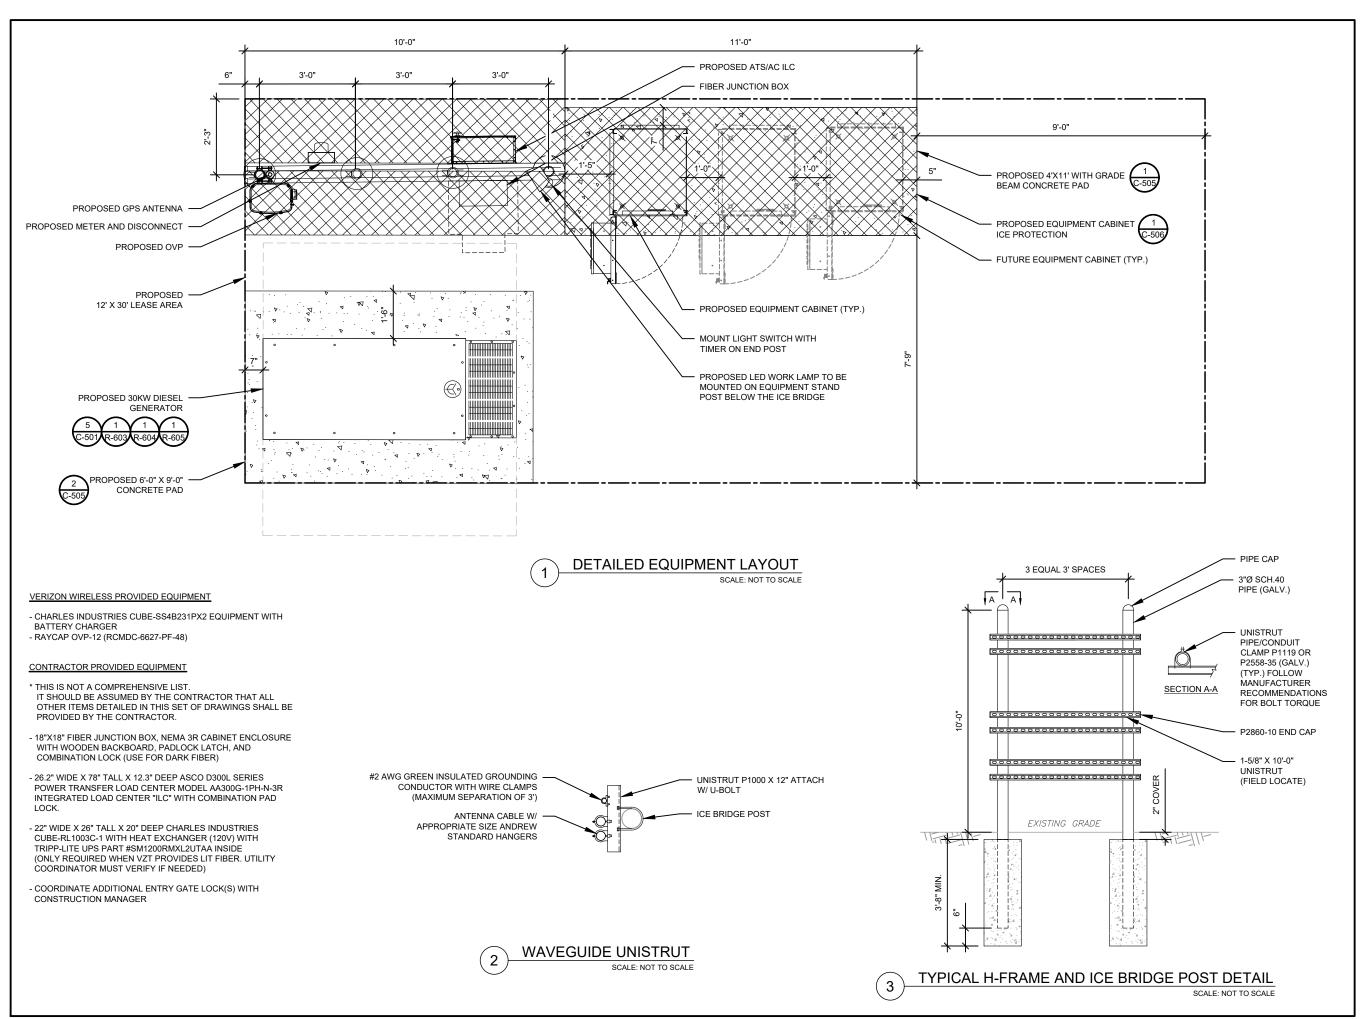

326 TRYON ROAD RALEIGH, NC 27603-3530 OFFICE: (919) 661-6351 www.tepgroup.net FL COA#: 31011

TEP IS A FAMILY OF COMPANIES LICENSED TO PROVIDE DIFFERENT SERVICES DIFFERENT JURISDICTIONS. DEPENDING ON THE JURISDICTION, PROFESSIONA ENGINEERING AND LAND SURVEYING SERVICES ARE PROVIDED BY TEP OPC. LLC, A DELAWARE LIMITED LUBILITY COMPANY, TEP ENGINEERING, LLC, A NORT CARCILIAN PROFESSIONAL. LIMITED LUBILITY COMPANY OR MAHE HORIMEERIN LLC, A NEW YORK PROFESSIONAL LIMITED LUBILITY COMPANY. GENER/CONTRACTOR SERVICES AND FROVIDED BY TEP OPCO. LLC, A DELAWARD CONTRACTOR SERVICES AND FROVIDED BY TEP OPCO. LLC, A DELAWARD STATE ADDITIONAL INFORMATION CAN BE OBTAINED FROM THE COMPANY.

ATC SITE NUMBER: 370667

ATC SITE NAME: LAKE CITY

VERIZON WIRELESS SITE NAME:

LAKE CITY ATC

SITE ADDRESS: 5348 NW US HWY 41 LAKE CITY, FL 32055-5550

DESCRIPTION **PRELIMINARY** PSG 10/09/24 100% CONSTRUCTION KAG 12/10/24

DIGITAL/ELECTRONIC SEAL: THIS DOCUMENT HAS BEEN DIGITALLY SIGNED AND SEALED BY JOSHUA H. CARDEN, P.E. ON THE DATE ADJACENT TO THE SEAL.

PRINTED COPIES OF THIS DOCUMENT ARE NOT CONSIDERED SIGNED AND SEALED AND THE SIGNATURE MUST BE VERIFIED ON ANY ELECTRONIC COPIES.






DATE DRAWN:	12/10/24
ATC JOB NO:	14873543
CUSTOMER NAME:	LAKE CITY ATC
CUSTOMER ID:	5000957580

CONSTRUCTION **DETAILS** 

SHEET NUMBER:

REVISION: C-502

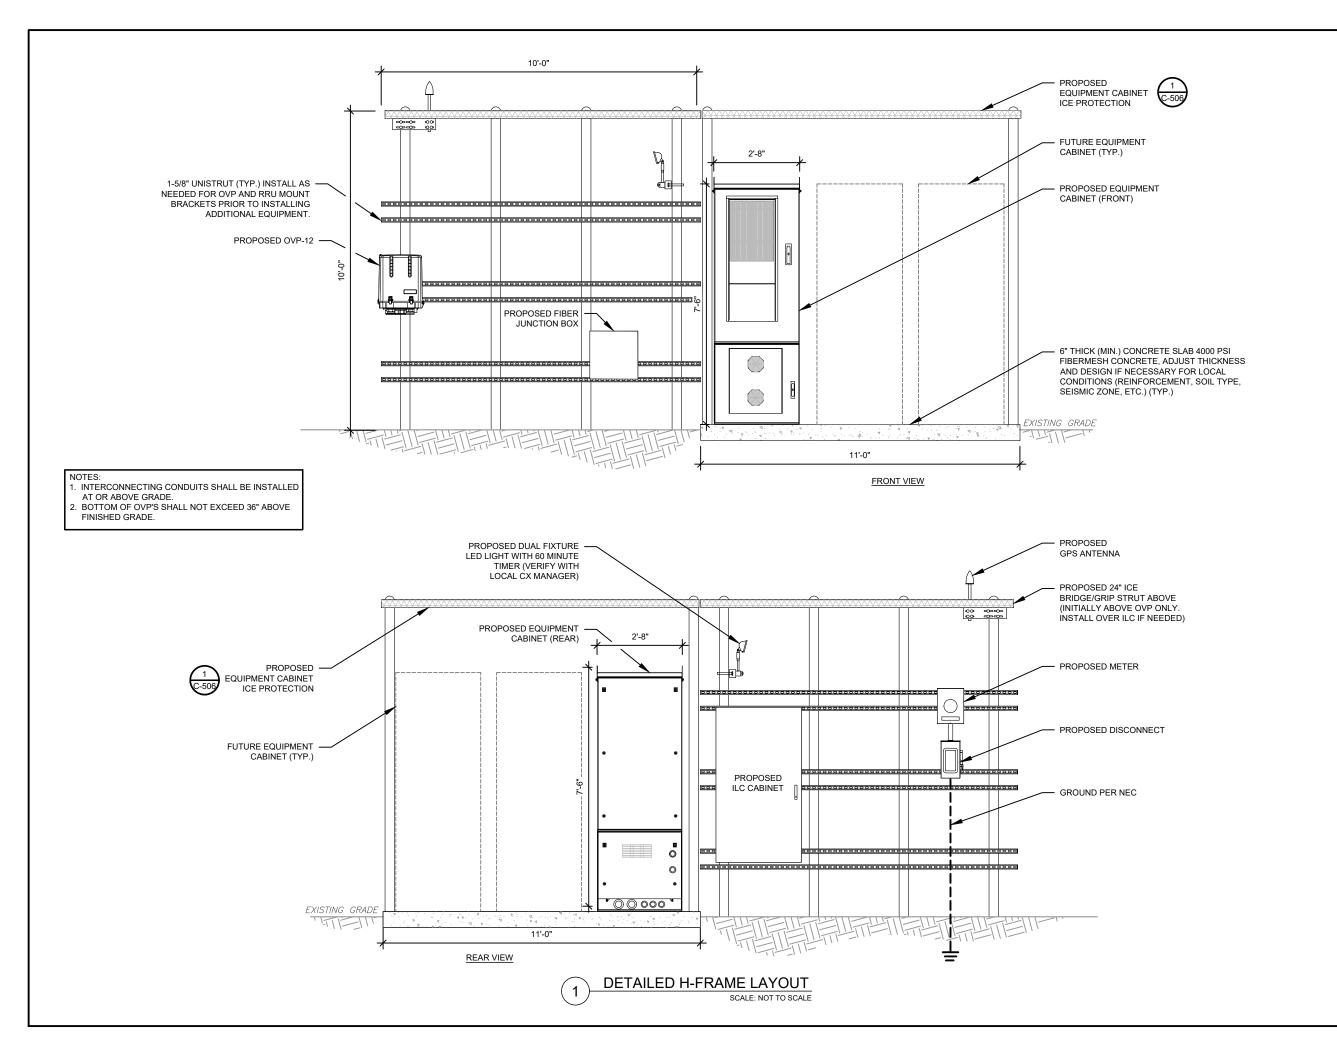



TEP OPCO LLC
326 TRYON ROAD
RALEIGH, NC 27603-3530
OFFICE: (919) 661-6351
www.tepgroup.net
FL COA#: 31011

DATE

TEP IS A FAMILY OF COMPANIES LICENSED TO PROVIDE DIFFERENT SERVICES IN DIFFERENT JURISDICTIONS. DEPENDING ON THE JURISDICTION, PROFESSIONAL REGINEERING AND LAND SURVEYING SERVICES ARE PROVIDED BY TEP OPCOLLC, A DELAWARE LIMITED LIABILITY COMPANY, TEP ENGINEERING, LLC, A NORTH ACACILIAN PROFESSIONAL LIMITED LIABILITY COMPANY, OR MAIR HENDINEERING, LLC, A NEW YORK, PROFESSIONAL LIMITED LIABILITY COMPANY, GENERAL CONTRACTOR SERVICES AND FROVIDED BY TEP OPCOLLIC. A DELAWARE LIMITED LIABILITY COMPANY, HE ACQUIRE THE REQUISITE LICENSES IN EACH STATE JOHN OF THE OPPOSITE LICENSES IN EACH STATE JOHN OF THE OMPANY.

ATC SITE NUMBER: 370667

ATC SITE NAME:

LAKE CITY

VERIZON WIRELESS SITE NAME: LAKE CITY ATC

SITE ADDRESS:

5348 NW US HWY 41

LAKE CITY, FL 32055-5550 DESCRIPTION BY

DIGITAL/ELECTRONIC SEAL:
THIS DOCUMENT HAS BEEN DIGITALLY SIGNED
AND SEALED BY JOSHUA H. CARDEN, P.E. ON
THE DATE ADJACENT TO THE SEAL.

PRINTED COPIES OF THIS DOCUMENT ARE NOT CONSIDERED SIGNED AND SEALED AND THE SIGNATURE MUST BE VERIFIED ON ANY ELECTRONIC COPIES.





	DATE DRAWN:	12/10/24			
	ATC JOB NO:	14873543			
	CUSTOMER NAME:	LAKE CITY ATC			
	CUSTOMER ID:	5000957580			


CONSTRUCTION DETAILS

SHEET NUMBER:

C-503

#### **CONSTRUCTION NOTE:**


1. INSTALL ICE BRIDGE TO ALLOW 7 FEET CLEARANCE ABOVE GRADE TO LOWEST APPURTENANCE

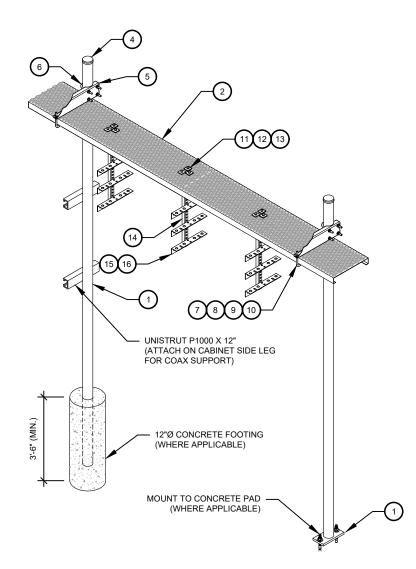

WB-K210-B WAVEGUIDE BRIDGE KIT - BILL OF MATERIALS (INCLUDED WITH KIT UNLESS NOTED OTHERWISE)							
ITEM	PART NUMBER	DESCRIPTION	ITEM	PART NUMBER	DESCRIPTION		
1	MF126.01 MF-130	10'-4" COLUMN & BASE SHOE* 13'-4" PIPE COLUMN	9	GWL-04	1/2" GALV LOCK WASHER		
2	WB-CY210	SAFETY GRATING 24" X 10'	10	GN-04	1/2" GALV HEX NUT		
3	WBK110BHK	HARDWARE KIT (ITEMS 4-16)	11	GB-03205	3/8" X 2" GALV BOLT KIT		
4	PC-034	PIPE CAP 3-1/2"	12	MT-387	SQUARE WASHER, 1-1/2" X 1-1/2" W/ 7/16" HOLE		
5	WBLB243.08	24" WAVEGUIDE BRIDGE SUPPORT BRACKET	13	GWF-03	3/8" GALV FLAT WASHER		
6	GUB-4356	1/2" X 3-5/8" X 6" GALV U-BOLT	14	WBT243.01	VERTICAL TRAPEZE SECTION		
7	WB-JB-6	1/2" J-BOLT	15	GB-03105	3/8" X 1" GALV BOLT KIT		
8	GWF-04	1/2" GALV FLAT WASHER	16	WBT243.02	HORIZONTAL TRAPEZE SECTION		
CONTRACTOR SHALL USE PARTS MANUFACTURED BY COMMSCOPE OR APPROVED EQUIVALENT.							


\*BASE SHOE NOT INCLUDED IN WB-K210-B KIT, ORDER COLUMN SEPARATELY OR KIT WB-K210-S.



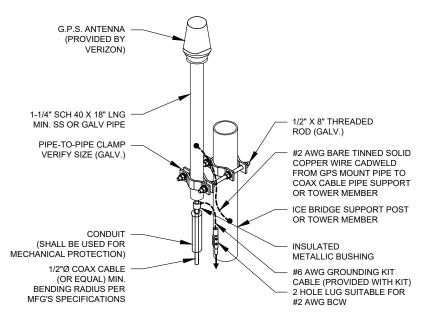

- GPS SHALL BE PLACED WITH CLEAR SIGHT LINE TO THE SOUTHERN SKY.
- CONTRACTOR TO SUPPLY COAX FOR GPS UNIT.



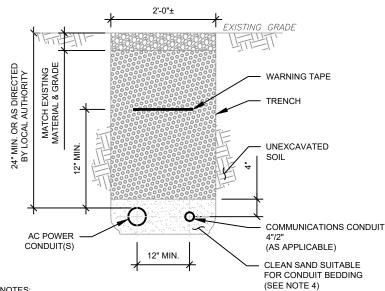

- IF FREE OF ORGANIC OR OTHER DELETERIOUS MATERIAL, EXCAVATED MATERIAL MAY BE USED FOR BACKFILL. IF NOT, PROVIDE CLEAN, COMPACTIBLE MATERIAL. COMPACT IN 8" LIFTS. REMOVE ANY LARGE ROCKS PRIOR TO BACKFILLING. CONTRACTOR
- TO VERIFY LOCATION OF EXISTING U/G UTILITIES PRIOR TO DIGGING.
- IF CURRENT AS-BUILT DRAWINGS ARE NOT AVAILABLE CONTRACTOR SHALL HAND DIG
- USE COMMUNICATIONS ONLY TRENCH FOR COMMUNICATIONS CONDUIT UNLESS TRAVELING UNDER PATH OF VEHICLE TRAVEL, THEN CONDUIT MUST BE 24" MIN. BELOW
- CONFIRM SPACING AND DEPTH WITH NEC OR LOCAL CODE REQUIREMENTS

POWER/TELCO CONDUIT TRENCH DETAILS



326 TRYON ROAD RALEIGH, NC 27603-3530 OFFICE: (919) 661-6351 www.tepgroup.net FL COA#: 31011

TEP IS A FAMILY OF COMPANIES LICENSED TO PROVIDE DIFFERENT SERVICES DIFFERENT JURISDICTIONS. DEPENDING ON THE JURISDICTION, PROFESSIONA NEGINEERING AND LAND SURVEYING SERVICES ARE PROVIDED BY TEP OPC. LC, A DELAWARE LIMITED LIABILITY COMPANY, TEP ENGINEERING, LLC, A NORT SARQLIMA PROFESSIONAL. LIMITED LIABILITY COMPANY, OR MAE HENGINEERIN LC, A NEW YORK PROFESSIONAL. LIMITED LIABILITY COMPANY OR GENERAL CONTRACTOR SERVICES ARE PROVIDED BY TEP OPCOL LIC, A DELAWARE LIMITED LIABILITY COMPANY. WE ACQUIRE THE REQUISITE LICENSES IN EACT STATE. ADDITIONAL INFORMATION CAN BE OBTAINED FROM THE COMPANY.

ATC SITE NUMBER: 370667

ATC SITE NAME:

LAKE CITY


VERIZON WIRELESS SITE NAME: LAKE CITY ATC

> SITE ADDRESS: 5348 NW US HWY 41 LAKE CITY, FL 32055-5550

PRELIMINARY PSG 10/09/24 100% CONSTRUCTION KAG 12/10/24

DIGITAL/ELECTRONIC SEAL: THIS DOCUMENT HAS BEEN DIGITALLY SIGNED AND SEALED BY JOSHUA H. CARDEN, P.E. ON THE DATE ADJACENT TO THE SEAL.

PRINTED COPIES OF THIS DOCUMENT ARE NOT CONSIDERED SIGNED AND SEALED AND THE SIGNATURE MUST BE VERIFIED ON ANY ELECTRONIC COPIES.

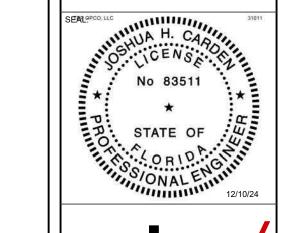





ı					
l	DATE DRAWN:	12/10/24			
l	ATC JOB NO:	14873543			
l	CUSTOMER NAME:	LAKE CITY ATC			
ı	CUSTOMER ID:	5000957580			

CONSTRUCTION **DETAILS** 

SHEET NUMBER:


C-504

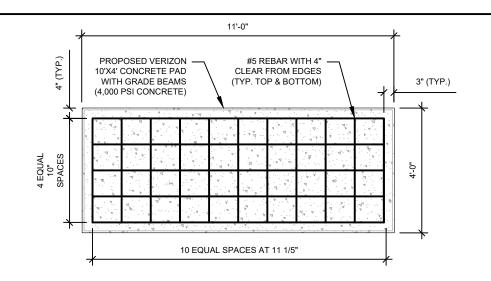

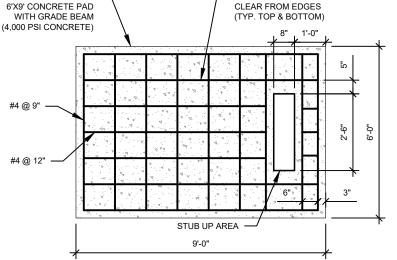

#5 REBAR WITH 4"

PROPOSED VERIZON

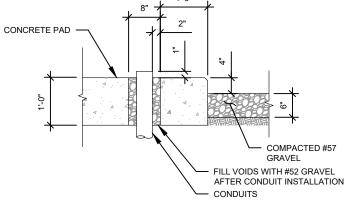


GENERATOR CONDUIT STUB UP DETAIL



#### PAD NOTES:

- PADS SHALL BE PRE-CAST MATCHING THIS DESIGN WHERE ALLOWED BY LOCAL JURISDICTION.
- REFER TO CONCRETE & REINFORCED STEEL NOTES ON SHEET G-002 & ATC SPEC 033000 FOR CAST-IN-PLACE PADS.



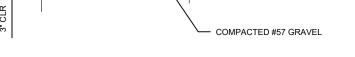

#4 AT 12" O.C. EACH WAY FOR

THIS DESIGN ASSUMES A 1500


PSF SOIL BEARING PRESSURE

3

GENERATOR PAD. (TYP. TOP & BOTTOM) (4,000 PSI CONCRETE)

CONCRETE GENERATOR PAD DESIGN




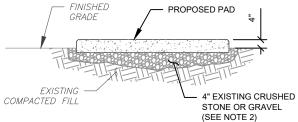


#### PAD NOTES:

- SUBGRADE AND FILL SHALL CONSIST OF CLEAN SOIL. DELETRIOUS MATERIAL AND ORGANICS SHALL BE REMOVED.
- 2. MECHANICALLY COMPACT FOOTPRINT OF PAD PLUS 2' PERIMETER.
- USE GALVANIZED HILTI EXPANSION ANCHORS OR, APPROVED EQUAL, FOR EQUIPMENT ANCHORAGE.
- FOR SIZE AND LOCATION OF ANCHORS AND OTHER REQUIREMENT, SEE EQUIPMENT VENDOR DRAWINGS.



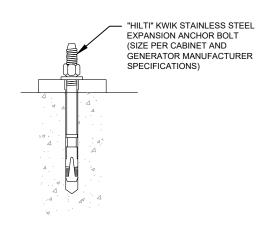

**EXPANSION ANCHOR DETAIL** 

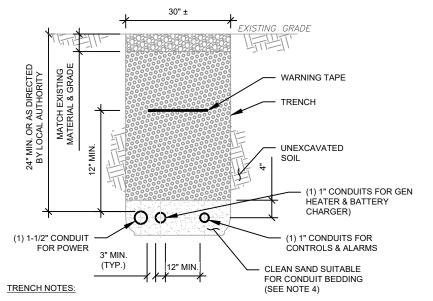

- IF FREE OF ORGANIC OR OTHER DELETERIOUS MATERIAL, EXCAVATED MATERIAL MAY BE USED FOR BACKFILL. IF NOT, PROVIDE CLEAN, COMPACTIBLE MATERIAL.
- COMPACT IN 8" LIFTS. REMOVE ANY LARGE ROCKS PRIOR TO BACKFILLING CONTRACTOR TO VERIFY LOCATION OF EXISTING U/G UTILITIES PRIOR TO DIGGING.
- IF CURRENT AS-BUILT DRAWINGS ARE NOT AVAILABLE CONTRACTOR SHALL HAND DIG U/G TRENCHING
- USE COMMUNICATIONS ONLY TRENCH FOR COMMUNICATIONS CONDUIT UNLESS TRAVELING UNDER PATH OF VEHICLE TRAVEL, THEN CONDUIT MUST BE 24" MIN.
- CONFIRM SPACING AND DEPTH WITH NEC OR LOCAL CODE REQUIREMENTS

6

GENERATOR CONDUIT TRENCH DETAILS



EP IS A FAMILY OF COMPANIES LICENSED TO PROVIDE DIFFERENT SERVICES FFERENT JURISDICTIONS. DEPENDING ON THE JURISDICTION, PROFESSIONA VIGINEERING AND LAND SURVEYING SERVICES ARE PROVIDED BY TEP OFC. C. A DELAWARE LIMITED LIABILITY COMPANY, TEP ENGINEERING, LLC. A NORT AROLINA PROFESSIONAL LIMITED LIABILITY COMPANY, OR MARINE PROFESSIONAL LIMITED LIABILITY COMPANY. GENERO NOTRACTOR SERVICES ARE PROVIDED BY TEP OFCO LLC, A DELAWARE MITTED LIABILITY COMPANY. WE ACCURE THE REQUISE LICENSES IN EACT ATTER ADDITIONAL INFORMATION CAN BE OBTAINED FROM THE COMPANY.

ATC SITE NUMBER: 370667

ATC SITE NAME:

LAKE CITY

VERIZON WIRELESS SITE NAME: LAKE CITY ATC


SITE ADDRESS:

5348 NW US HWY 41 LAKE CITY, FL 32055-5550

	REV.	DESCRIPTION	BY	DATE
	$\mathbb{A}_{-}$	PRELIMINARY	PSG	10/09/24
	<u> </u>	100% CONSTRUCTION	KAG	12/10/24
	$\wedge$			
l	$\overline{\wedge}$			
	$\overline{\wedge}$			

DIGITAL/ELECTRONIC SEAL: THIS DOCUMENT HAS BEEN DIGITALLY SIGNED AND SEALED BY JOSHUA H. CARDEN, P.E. ON THE DATE ADJACENT TO THE SEAL.

PRINTED COPIES OF THIS DOCUMENT ARE NOT CONSIDERED SIGNED AND SEALED AND THE SIGNATURE MUST BE VERIFIED ON ANY ELECTRONIC COPIES.

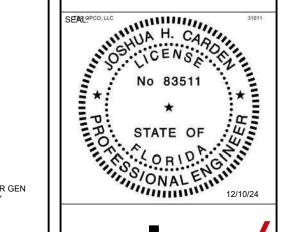




DATE DRAWN:	12/10/24
ATC JOB NO:	14873543
CUSTOMER NAME:	LAKE CITY ATC
CUSTOMER ID:	5000957580

CONSTRUCTION **DETAILS** 

SHEET NUMBER:

C-505

0

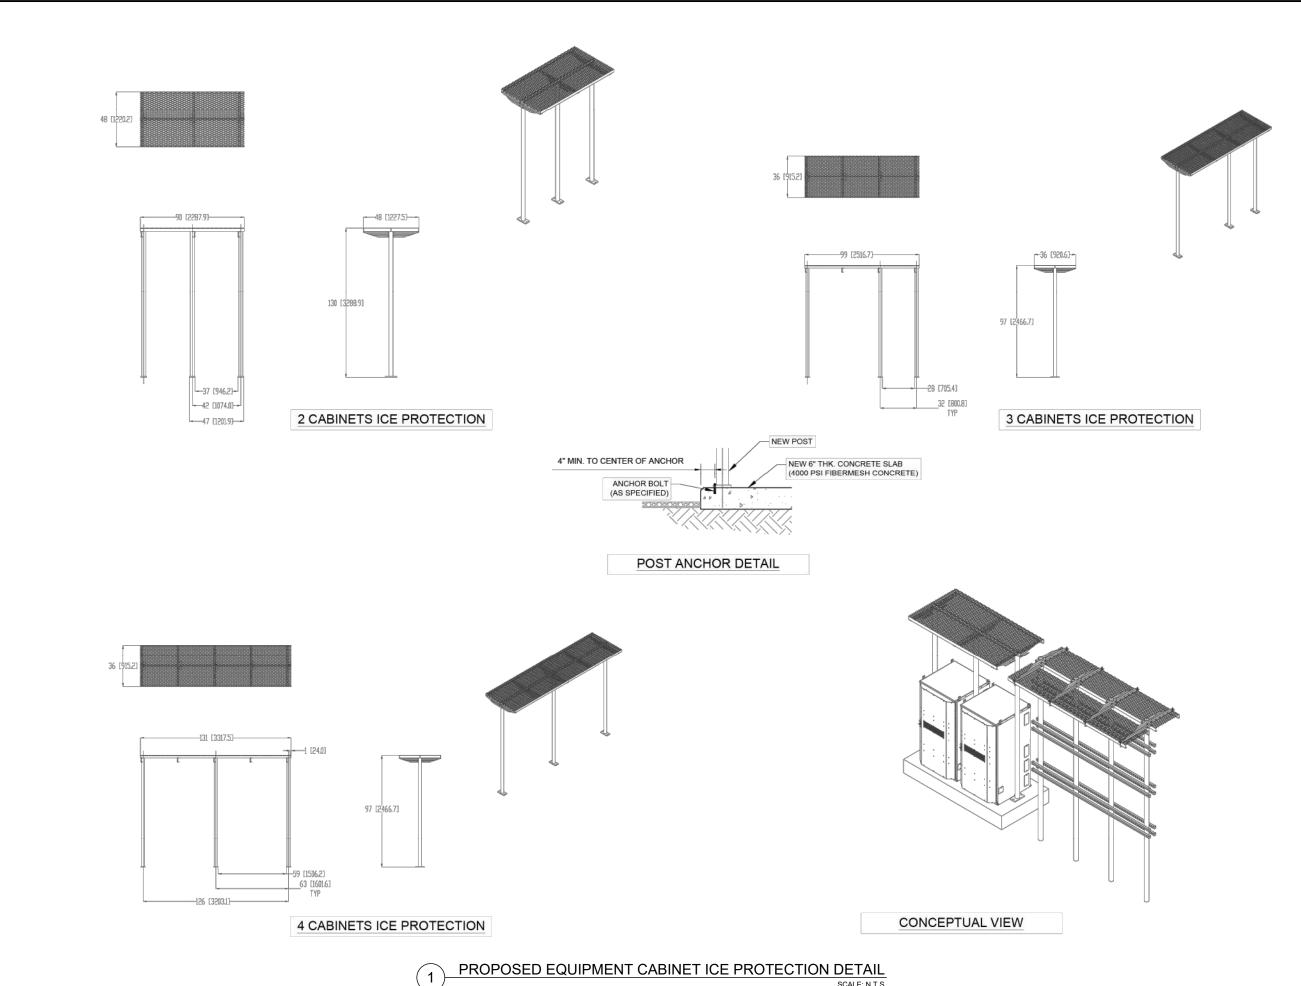



TEP OPCO LLC 326 TRYON ROAD RALEIGH, NC 27603-3530 OFFICE: (919) 661-6351 www.tepgroup.net FL COA#: 31011

EP IS A FAMILY OF COMPANIES LICENSED TO PROVIDE DIFFERENT SERVICES IFFERENT JURISDICTIONS. DEPENDING ON THE JURISDICTION, PROFESSIONA MOINEERING AND LAND SURVEYING SERVICES ARE PROVIDED BY TEP OFC. C., A DELAWARE LIMITED LIABILITY COMPANY, TEP ENGINEERING, LLC, A NORT AROLLINA PROFESSIONAL LIMITED LIABILITY COMPANY, OR MARINE LIMITED LIABILITY COMPANY. GENERAL ONTRACTOR SERVICES ARE PROVIDED BY TEP OFFCO. LIC., A DELAWARE MITTED LIABILITY COMPANY. SENERAL ONTRACTOR SERVICES ARE PROVIDED BY TEP OFFCO. LIC., A DELAWARE MITTED LIABILITY OF THE MARINE PROVIDED BY THE PORT OF THE COMPANY. SENERAL OFFI THE THE PROFILES IN EACTION AND THE COMPANY.

ATC SITE NUMBER: 370667

ATC SITE NAME:

LAKE CITY

VERIZON WIRELESS SITE NAME: LAKE CITY ATC


SITE ADDRESS:

5348 NW US HWY 41 LAKE CITY, FL 32055-5550

DESCRIPTION PRELIMINARY 100% CONSTRUCTION KAG 12/10/24

DIGITAL/ELECTRONIC SEAL: THIS DOCUMENT HAS BEEN DIGITALLY SIGNED AND SEALED BY JOSHUA H. CARDEN, P.E. ON THE DATE ADJACENT TO THE SEAL.

PRINTED COPIES OF THIS DOCUMENT ARE NOT CONSIDERED SIGNED AND SEALED AND THE SIGNATURE MUST BE VERIFIED ON ANY ELECTRONIC COPIES.

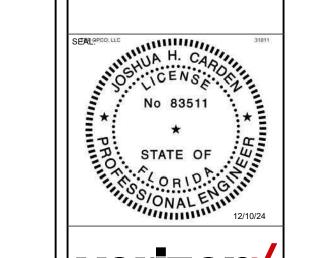



	DATE DRAWN:	12/10/24
	ATC JOB NO:	14873543
ı	CUSTOMER NAME:	LAKE CITY ATC
	CUSTOMER ID:	5000957580


CONSTRUCTION **DETAILS** 

SHEET NUMBER:

REVISION

0

C-506

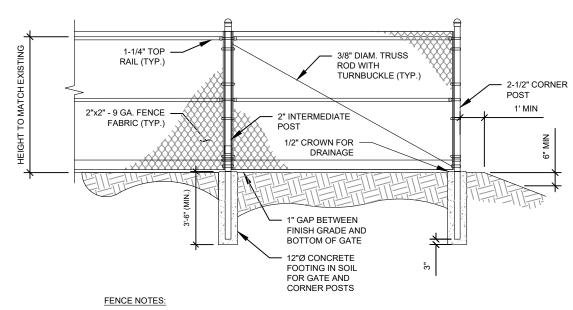


1. POSTS NOT TO EXCEED A MAXIMUM SEPRATION OF 10 FEET.

AMERICAN TOWER CONSTRUCTION SPECIFICATION:

1. DIVISION 32 EXTERIOR IMPROVEMENTS SECTION 0323113 FOR CHAIN LINK FENCE AND GATES



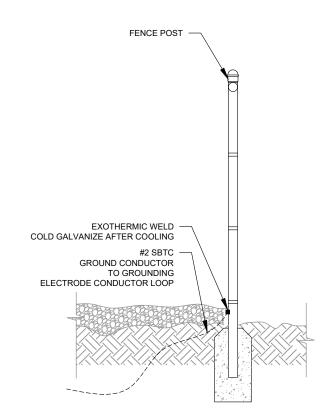

FENCE GROUNDING DETAIL



TEP OPCO LLC 326 TRYON ROAD RALEIGH, NC 27603-3530 OFFICE: (919) 661-6351 www.tepgroup.net FL COA#: 31011

TEP IS A FAMILY OF COMPANIES LICENSED TO PROVIDE DIFFERENT SERVICES IN DIFFERENT JURISDICTIONS. DEPENDING ON THE JURISDICTION, PROFESSIONA ENGINEERING AND LAND SURVEYING SERVICES ARE PROVIDED BY TEP OPC. LIC., A DELAWARE LIMITED LUBLITY COMPANY, TEP ENGINEERING, LLC., A NORTI CAROLINA PROFESSIONAL. LIMITED LUBLITY COMPANY, OR MAIN ENGINEERING LIC., A NEW YORK PROFESSIONAL LIMITED LUBLITY COMPANY, GENERA CONTRACTOR SERVICES AND PROVIDED BY TEP OPTOC LIC., A DELAWARD CONTRACTOR SERVICES AND PROVIDED BY TEP OPTOC LIC., A DELAWARD STATE ADDITIONAL INFORMATION CAN BE OBTAINED FROM THE COMPANY.

ATC SITE NUMBER: 370667

ATC SITE NAME:

LAKE CITY

VERIZON WIRELESS SITE NAME: LAKE CITY ATC

SITE ADDRESS:

5348 NW US HWY 41 LAKE CITY, FL 32055-5550

DESCRIPTION BY DATE PRELIMINARY PSG 10/09/24 <u>100% CONSTRUCTION</u> <u>KAG</u> <u>12/10/24</u>

DIGITAL/ELECTRONIC SEAL: THIS DOCUMENT HAS BEEN DIGITALLY SIGNED AND SEALED BY JOSHUA H. CARDEN, P.E. ON THE DATE ADJACENT TO THE SEAL.

PRINTED COPIES OF THIS DOCUMENT ARE NOT CONSIDERED SIGNED AND SEALED AND THE SIGNATURE MUST BE VERIFIED ON ANY ELECTRONIC COPIES.





	DATE DRAWN:	12/10/24
	ATC JOB NO:	14873543
1	CUSTOMER NAME:	LAKE CITY ATC
	CUSTOMER ID:	5000957580

CONSTRUCTION DETAILS


SHEET NUMBER:

C-507


# CONDUIT KEYED NOTES: FIBER CONDUITS ig( 1 ig) $oxed{(2)}$ 2" SCH. 40 PVC CONDUIT WITH MULE TAPE FROM TELCO BOX TO THE EQUIPMENT CABINET (2) (1) 1-1/2" LFMC FOR FIBER & ALARM FROM EQUIPMENT CABINET TO OVP (2) 1" CONDUIT EACH W/ (6) #8 AWG + (2) #10 GND FROM THE ILC TO THE EQUIPMENT CABINET FOR (4) 30 AMP 2-POLE CIRCUITS. (4) (1) 2" LFMC WITH (12) #6 (6 PAIRS) & (6) # 6 G FROM EQUIPMENT CABINET TO OVP. (5) (1) 3/4" CONDUIT WITH (2) #12 & (1) #10 G FROM ILC TO GFI RECEPTACLE/LIGHT. (1) 1-1/2" CONDUIT WITH PULLSTRING FOR FUTURE RECTIFIER CIRCUITS FROM EQUIPMENT

- $\left(\begin{array}{c}7\end{array}\right)$  (1) 2" CONDUIT WITH (3) #3/0 & (1) #4 GND FROM THE ILC TO THE GENERATOR.
- (1) 1" CONDUIT WITH (4) #12 & (2) #10 GND FROM ILC TO GENERATOR. (GEN HEATER & BATTERY CHARGER)
- 9 ALARM/MISCELLANEOUS COINDUITS
  (1) 1" CONDUIT FROM ILC TO EQUIPMENT CABINET FOR ILC ALARMS.
- $\left(10
  ight)$  (1) 1" CONDUIT FROM ILC TO GENERATOR FOR GEN CONTROLS & ALARMS.

BELOW GRADE CONDUIT SHALL BE SCHEDULE 80 PVC. ABOVE GRADE CONDUIT SHALL BE GALVANIZED RIGID CONDUIT. BELOW GRADE PVC CONDUIT SHALL TRANSITION TO GRC PRIOR TO RISING ABOVE GRADE. ALL BENDS SHALL HAVE MINIMUM 24" RADIUS. ALL FITTINGS SHALL BE SUITABLE FOR USE WITH THREADED RIGID CONDUIT. VERIFY CONDUIT TYPE WITH LOCAL CONSTRUCTION MANAGER AND ADJUST AS NECESSARY. ALL CONDUIT SHALL MEET NEC, STATE, AND LOCAL CODE REQUIREMENTS AS REQUIRED.

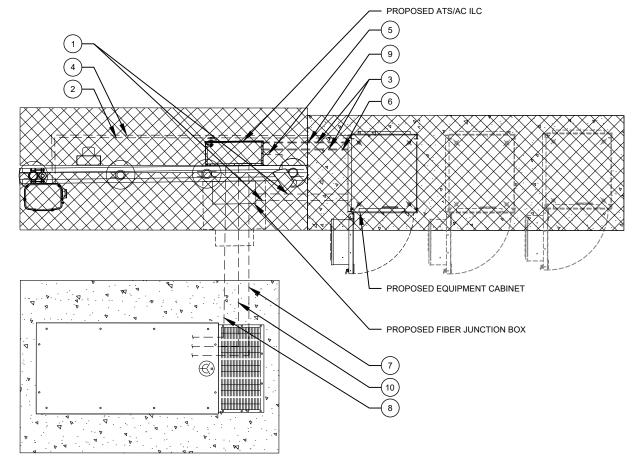

**DETAILED CONDUIT LAYOUT** 

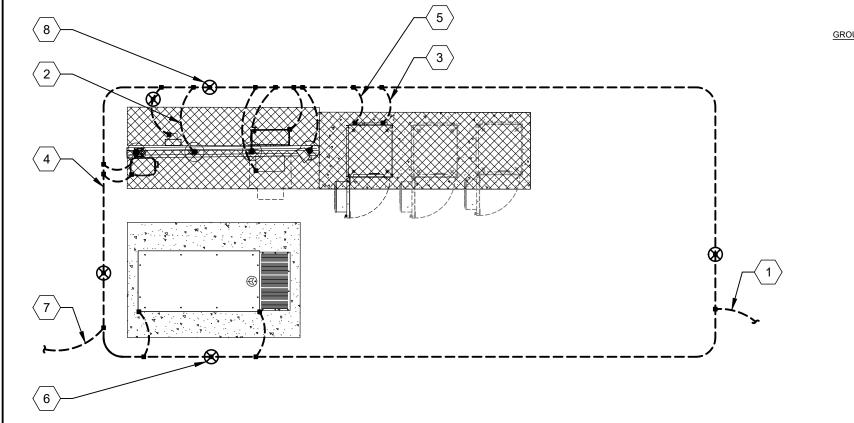

SCALE: NOT TO SCALE

**DETAILED GROUNDING LAYOUT** 

#### GROUNDING KEYED NOTES:

1 BOND TO TOWER GROUND RING

#2 AWG BOND FROM VERTICAL H-FRAME AND ICE BRIDGE POST TO EXTERNAL GROUND RING (TYP. EVERY POST).

 $\begin{pmatrix} 3 \end{pmatrix}$  EQUIPMENT BOND TO GROUND RING (TYP.).

4 > #2 GROUND RING

GROUNDING ELECTRODE CONDUCTOR PER NEC

6 GROUNDING ELECTRODE (TYP.)

7 BOND TO COMPOUND GROUND RING

8 GROUNDING ELECTRODE WITH TEST WELL



RALEIGH, NC 27603-3530 OFFICE: (919) 661-6351 www.tepgroup.net FL COA#: 31011

ATC SITE NUMBER: 370667

ATC SITE NAME: LAKE CITY

VERIZON WIRELESS SITE NAME: LAKE CITY ATC

SITE ADDRESS:

5348 NW US HWY 41

LAKE CITY, FL 32055-5550 100% CONSTRUCTION KAG 12/10/24

DIGITAL/ELECTRONIC SEAL: THIS DOCUMENT HAS BEEN DIGITALLY SIGNED AND SEALED BY JOSHUA H. CARDEN, P.E. ON THE DATE ADJACENT TO THE SEAL.

PRINTED COPIES OF THIS DOCUMENT ARE NOT CONSIDERED SIGNED AND SEALED AND THE SIGNATURE MUST BE VERIFIED ON ANY ELECTRONIC COPIES.





	DATE DRAWN:	12/10/24			
	ATC JOB NO:	14873543			
	CUSTOMER NAME:	LAKE CITY ATC			
	CUSTOMER ID:	5000957580			

**GROUNDING PLAN** AND NOTES

E-101

			PANEL	1.47	145	IYHE		SHIING & APPL		-	SYSII		_	120/240V, 3VV,	30 CK	LOCATION:	VZVV LE	EASE AREA	
			DESIGNATION:	VZ	<u>w</u>	MOUN		SURFACE				BREAKER (M	· —	MLO		-			
						BNCLC	DSURE	N⊟MA 3R			MAIN	BUS RATING	: <u> </u>	200A		PANEL NOTES:	ASCO D	300L SERIES	
										-	MIN. A	C. RATING	i:	<b>6</b> 5K		_			
			CONNECTED					DER OR BRAIN	CH CIRC	<u>ur                                    </u>	_			OR BRANCH					NECTED
			LOAD (kVA)	J BF	RIEF DESCRIPTION		В	REAKER	POLE	1R		* "   P		BRE	AKER	BRIEF	DESCRIPTION	LOAI	D (kVA)
			A B				AMPS	POLES	NO.	H 2 . 5		H 2 1 - N	NO.	POLES	AMPS			A	В
			2.88		RECTIFIER		30	2	1				2				SPACE	0.00	
			2.88		NEO II IE C		00		3				4				SPACE		0.00
			2.88	]	RECTIFIER		30	2	5				6				SPACE	0.00	
		_	2.88						7				8				SPACE		0.00
			2.88	4	RECTIFIER		30	2	9				10				SPACE	0.00	
			2.88						11				12				SPACE		0.00
			2.88	4	RECTIFIER		30	2	13				14				SPACE	0.00	
		-	2.88		ELBEARET (LIALE				15				16				SPACE		0.00
			0.68		FI RECEPT / LIGHT		20	1	17				18				SPACE	0.00	1000
			1.92		N BLOCK HEATER		20	7	19	<u> </u>	1		20				SPACE	0.00	0.00
		,	1.92	H BA	TTERY CHARGER		20	1	21				22				SPACE	0.00	0.00
		-	0.00		SPACE SPACE				23 25				24 26				SPACE SPACE	0.00	0.00
FIELD VERIFY FEEDER —		-	0.00		SPACE				27	<u> </u>			28 28				SPACE SPACE	0.00	0.00
SIZE IS RATED 200A,	TO UTILITY POL	F	0.00		SPACE				29				30				SPACE SPACE	0.00	0.00
0V, 1PH, 3W ELECTRIC SERVICE	\ \ \ \ \ \ \ \ \ \ \ \ \ \ \ \ \ \ \			<u> </u>	SFAGE				29	<b>.</b>	+-						SPACE		
52.11.62	<b>V</b>		14. <b>1 1</b> 3.4	J						A 14.1	13.4	27.6		ONNECTED L	M D ALATA S			0.0	0.0
	M									14.1	13.4		_	ONNECTED LO DEMAND LOAD		000	ATING FACTOR (	(000/)	
3-#3/0 AWG CU, 1-#6 AWG CU G 2"C  VERIZON WIRELESS ILC CABINET WITH 2P/200A UTILITY BREAKER AND OPTIONAL 2P/200A CAM LOCK BREAKER MECHANICALLY INTERLOCKED WITH WALKING BEAM TRANSFER SWITCH AND 30 BRANCH LOAD CENTER		2-#12 AV #10 GNE 3/4" CON	GFCI WG NDUIT H12 AWG, 2-#10 GN CONDUIT (FOR GE	] JD,	ALARMS		30KW 120/24C GENERATOR BREAKER. GE NEMA 3R ENC WITH 1500W  NOTE: THE C CONJUNCTIC WITH A SOLI SEPERATEL' SUCH, DO N	1. 2 //IRELESS EL GENERATOR	. MAXIMUI ED EED EER. D IN DT A EM. AS UTRAL	I LENGTH	H OF RUN		ER CIRC IDUIT FO ER *	DR  JIT VZW FIE ED ** (OR JUN COMMC	(1) 2" CONDUIT (FOR DARK FIE EBH AS NEEDE  BER HANDHOLE ICTION BOX ON IN USE UTILITY IN COMPOUND  (1) 2" CONDUIT (FOR EBH IF N	BER OR TERMINATIO (18"X18" FIBER BOX FOR DARK CHARLES CA NEEDED FO	GRADE I FRAME I LFMC ALL LFMC	MC STRAIGHT RI (CLAMP TO EQL POSTS), TRANS T EACH FOR EQ T CONNECTION:	JIPMENT ITION TO 2" UIPMENT S PRIMARY CABINET
	(INSTALL (2) 1" CO FOR FUTURE RECONDUIT ABOVE EQUIPMENT FRA	ONDUIT WITH CTIFIER CIRCU GROUND. SE	PULL STRING UITS) ROUTE		6-#6 AWG GND (1) 2" LFMC										,	,	E LINE DIAGRA	AM	
ELECTRICAL SINGLE	LINE DIAGRA	AM													NOTES:			_	
	= =	<del></del>														ONAL 2" CONDUIT FOR	DARK FIRER (2 TOTA	I ) IE REOLIIRED	RY

- 1. ALL EQUIPMENT SHALL BE NEMA 3R RATED.
- 2. ALL EQUIPMENT SHALL BE GROUNDED IN ACCORDANCE WITH TIA-222-G AND VERIZON WIRELESS
- 3. CONDUCTOR SIZES AND DISTANCES HAVE BEEN SIZED FOR 3% MAX VOLTAGE DROP. (TOTAL SYSTEM VOLTAGE DROP ON BOTH FEEDERS AND BRANCH CIRCUITS TO THE FARTHEST DEMAND SHALL NOT EXCEED 5%)
- 4. WIRE SIZING AND MAXIMUM DISTANCE FROM GENERATOR TO ILC ASSUMES POWER FACTOR OF 0.9.

  5. BELOW GRADE PVC CONDUIT SHALL TRANSITION TO RMC PRIOR TO RISING ABOVE GRADE, ALL BENDS SHALL HAVE A MINIMUM 24" RADIUS. ALL FITTINGS SHALL BE SUITABLE FOR USE WITH THREADED RIGID CONDUIT. VERIFY CONDUIT TYPE WITH LOCAL CONSTRUCTION MANAGER AND ADJUST IF NECESSARY, ALL CONDUIT SHALL MEET NEC, STATE, AND LOCAL CODE REQUIREMENTS AS REQUIRED.



326 TRYON ROAD RALEIGH, NC 27603-3530 OFFICE: (919) 661-6351 www.tepgroup.net FL COA#: 31011

TEP IS A FAMILY OF COMPANIES LICENSED TO PROVIDE DIFFERENT SERVICES IN DIFFERENT JURISDICTIONS. DEPENDING ON THE JURISDICTION, PROFESSIONA ENGINEERING AND LAND SURVEYING SERVICES ARE PROVIDED BY TEP OPC. LIC., A DELAWARE LIMITED LUBLITY COMPANY, TEP ENGINEERING, LLC., A NORTI CAROLINA PROFESSIONAL. LIMITED LUBLITY COMPANY, OR MAIN ENGINEERING LIC., A NEW YORK PROFESSIONAL LIMITED LUBLITY COMPANY, GENERA CONTRACTOR SERVICES AND PROVIDED BY TEP OPTOC LIC., A DELAWARD CONTRACTOR SERVICES AND PROVIDED BY TEP OPTOC LIC., A DELAWARD STATE ADDITIONAL INFORMATION CAN BE OBTAINED FROM THE COMPANY.

ATC SITE NUMBER: 370667

ATC SITE NAME: LAKE CITY

VERIZON WIRELESS SITE NAME: LAKE CITY ATC

> SITE ADDRESS: 5348 NW US HWY 41 LAKE CITY, FL 32055-5550

DESCRIPTION PRELIMINARY PSG 10/09/24 100% CONSTRUCTION KAG 12/10/24

DIGITAL/ELECTRONIC SEAL: THIS DOCUMENT HAS BEEN DIGITALLY SIGNED AND SEALED BY JOSHUA H. CARDEN, P.E. ON THE DATE ADJACENT TO THE SEAL.

PRINTED COPIES OF THIS DOCUMENT ARE NOT CONSIDERED SIGNED AND SEALED AND THE SIGNATURE MUST BE VERIFIED ON ANY ELECTRONIC COPIES.



DATE DRAWN:	12/10/24
ATC JOB NO:	14873543
CUSTOMER NAME:	LAKE CITY ATC
CUSTOMER ID:	5000957580
	·

**ONE-LINE & PANEL** SCHEDULE

SHEET NUMBER:

LOCAL MARKET FACILITIES. VERIFY PRIOR TO CONSTRUCTION. (ADD 2 PULL STRINGS


\*\* VERIFY EBH REQUIREMENTS WITH TELCO PROVIDER PRIOR TO CONSTRUCTION.

TO EACH CONDUIT)

(ADD 2 PULL STRINGS TO EACH CONDUIT)

E-102

0

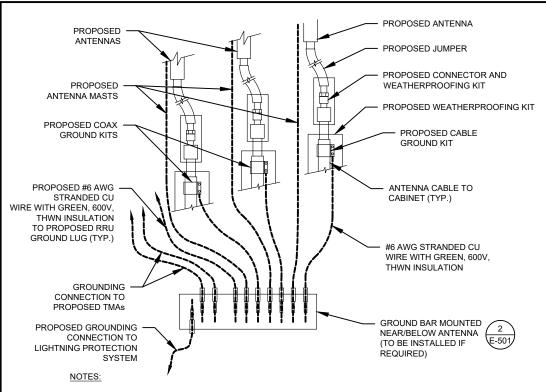

- THIS DETAIL IS INTENDED TO SHOW THE GENERAL GROUNDING REQUIREMENTS. SLIGHT ADJUSTMENTS MAY BE REQUIRED BASED ON EXISTING SITE CONDITIONS. THE CONTRACTOR SHALL MAKE FIELD ADJUSTMENTS AS NEEDED AND INFORM THE CONSTRUCTION MANAGER OF ANY CONFLICTS.
- SITE GROUNDING SHALL COMPLY WITH VERIZON GROUNDING STANDARDS, LATEST EDITION, AND COMPLY WITH VERIZON GROUNDING CHECKLIST, LATEST VERSION. WHEN NATIONAL AND LOCAL GROUNDING CODES ARE MORE STRINGENT THEY SHALL GOVERN.
- <u>GROUND KIT NOTES:</u>

  1. DO NOT INSTALL CABLE GROUND KIT AT A BEND AND ALWAYS DIRECT GROUND WIRE DOWN TO GROUND BAR.
- 2. CONTRACTOR SHALL PROVIDE WEATHERPROOFING KIT (ANDREW PART NUMBER 221213) AND INSTALL/TAPE PER MANUFACTURER'S SPECIFICATIONS

CABLE GROUND KIT CONNECTION DETAIL

ANTENNA CABLE 2 1/2"Ø MAX

GROUNDING KIT PER CABLE

TO GROUND BAR

(ANDREW OR APPROVED EQUAL)

MANUFACTURER'S RECOMMENDATIONS

#6 AWG STRANDED COPPER GROUND

WIRE (GROUNDED TO GROUND BAR)

3/8" X 1-1/4" SS BOLT

(EACH SIDE)

0

**GROUND BAR NOTES:** 

0

0

**TOWER GROUND BAR DETAIL** 

GROUND BAR KITS COME WITH ALL HARDWARE, NUTS, BOLTS,

2. GROUND BAR TO BE BONDED DIRECTLY TO TOWER

WASHERS, ETC. EXCEPT THE STRUCTURAL MOUNTING MEMBER(S).

3/8" SS LOCK WASHER

0

1/4" X 4" X 6" GROUND BAR

(LOWER TOWER GROUND

WITH #2 AWG BCW

BAR ONLY)

TWO-HOLE LUG, TO BE USED

(ERICO P/N: EGBA14406CC OR EQUAL)

(EACH SIDE)

0

00000


00000

00000

# TYPICAL ANTENNA GROUNDING DIAGRAM





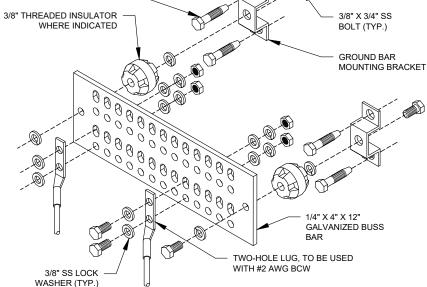

#### **GROUND BAR NOTES**

- GROUND KITS COME WITH ALL HARDWARE, NUTS, BOLTS, WASHERS, ETC. EXCEPT THE STRUCTURAL MOUNTING MEMBER(S).
- 2. GROUND BAR SHALL BE BOLTED TO STRUCTURAL MEMBER OR ANCHORED TO CONCRETE SLAB W/ HILTI KWIK BOLT III.

SEPARATION DIMENSION TO BE VERIFIED WITH LOCAL UTILITY COMPANY


TO ANTENNA


 $\bigcirc$ 

2. COORDINATE UTILITY, LOCATE BEFORE DIGGING.

TO EQUIPMENT

- CONDUIT TRENCHING DEPTHS AT 36" OR 6" BELOW FROST LINE, WHICHEVER IS GREATER.
- ALL RING AND RADIAL DEPTHS AT 30" OR 6" BELOW FROST LINE, WHICHEVER IS GREATER.

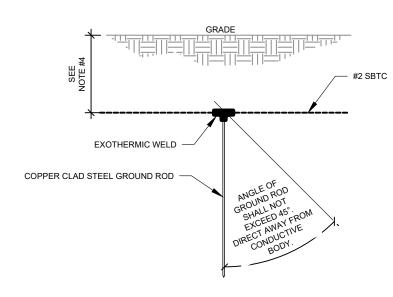

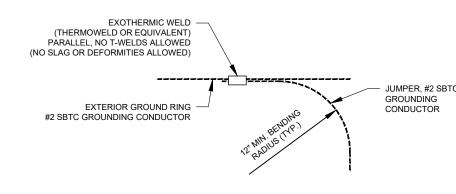

**GROUND ROD DETAIL** 

TIE CONNECTION DETAIL SCALE: NOT TO SCALE



EP IS A FAMILY OF COMPANIES LICENSED TO PROVIDE DIFFERENT SERVICES FFERENT JURISDICTIONS. DEPENDING ON THE JURISDICTION, PROFESSION. WORKERING AND LAND SURVEYING SERVICES ARE PROVIDED BY TEP OFC. C. A DELAWARE LIMITED LIABILITY COMPANY, TEP ENGINEERING, LLC, A NOR ARQUINA PROFESSIONAL LIMITED LIABILITY COMPANY, OR MAR HENGINEERING. A NEW YORK PROFESSIONAL LIMITED LIABILITY COMPANY. GENEROUTHER OF SERVICES ARE PROVIDED BY TEP OTFOC LICE, A DELAWARE TED LIABILITY COMPANY. WE ACQUIRE THE REQUISITE LICENSES IN EA TE. ADDITIONAL INFORMATION CAN BE OBTAINED FROM THE COMPANY.

TEP OPCO LLC

326 TRYON ROAD

RALEIGH, NC 27603-3530

OFFICE: (919) 661-6351

www.tepgroup.net

FL COA#: 31011

ATC SITE NUMBER: 370667

ATC SITE NAME: LAKE CITY

VERIZON WIRELESS SITE NAME: LAKE CITY ATC

> SITE ADDRESS: 5348 NW US HWY 41

LAKE CITY, FL 32055-5550 **PRELIMINARY** PSG 10/09/24 100% CONSTRUCTION KAG 12/10/24

DIGITAL/ELECTRONIC SEAL: THIS DOCUMENT HAS BEEN DIGITALLY SIGNED AND SEALED BY JOSHUA H. CARDEN, P.E. ON THE DATE ADJACENT TO THE SEAL.

PRINTED COPIES OF THIS DOCUMENT ARE NOT CONSIDERED SIGNED AND SEALED AND THE SIGNATURE MOUST BE VERIFIED ON ANY ELECTRONIC COPIES.





DATE DRAWN: 12/10/24 14873543 ATC JOB NO: CUSTOMER NAME: LAKE CITY ATC CUSTOMER ID: 5000957580

**GROUNDING DETAILS** 

SHEET NUMBER

E-501


0

REVISION




MAIN GROUND BAR DETAIL

SCALE: NOT TO SCALE

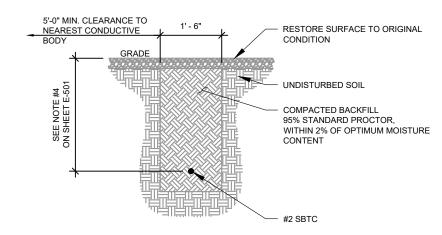

(1) GROUND CONNECTION TRENCH DETAIL (STD.)

SCALE: NOT TO SCALE

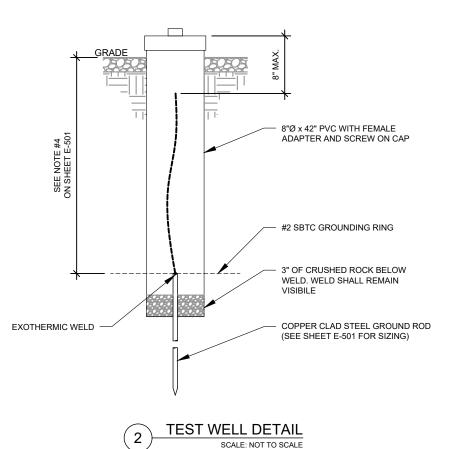

TEP

TEP OPCO LLC 326 TRYON ROAD RALEIGH, NC 27603-3530 OFFICE: (919) 661-6351 www.tepgroup.net FL COA#: 31011

TEP IS A FAMILY OF COMPANIES LICENSED TO PROVIDE DIFFERENT SERVICES IN DIFFERENT JURISDICTIONS. DEPENDING ON THE JURISDICTION, PROFESSIONAL ENGINEERING AND LAND SURVEYING SERVICES ARE PROVIDED BY TEP OPCO LLC, A DELAWARE LIMITED LIABILITY COMPANY, TEP ENGINEERING, LLC, A NORTH CAROLINA PROFESSIONAL LIMITED LIABILITY COMPANY OR MAIL HOSINEERING, LLC, A NEW YORK PROFESSIONAL LIMITED LIABILITY COMPANY, GENERAL CONTRACTOR SERVICES ARE PROVIDED BY TEP OPCOL LIC, A DELAWARE LIMITED LIABILITY COMPANY. MICHORISM SERVICES AND SERVICES ARE PROVIDED BY TEP OPCOL LIC, A DELAWARE LIMITED LIABILITY COMPANY. MICHORISM SERVICES AND SERVICES ARE PROVIDED BY THE OPCOLUMENT LICENSES IN SCAN-TIME AND SERVICES AND SERV

ATC SITE NUMBER: 370667

ATC SITE NAME: LAKE CITY

VERIZON WIRELESS SITE NAME: LAKE CITY ATC

SITE ADDRESS:

5348 NW US HWY 41 LAKE CITY, FL 32055-5550

DIGITAL/ELECTRONIC SEAL:
THIS DOCUMENT HAS BEEN DIGITALLY SIGNED
AND SEALED BY JOSHUA H. CARDEN, P.E. ON
THE DATE ADJACENT TO THE SEAL.

PRINTED COPIES OF THIS DOCUMENT ARE NOT CONSIDERED SIGNED AND SEALED AND THE SIGNATURE MUST BE VERIFIED ON ANY ELECTRONIC COPIES.






	DATE DRAWN:	12/10/24
	ATC JOB NO:	14873543
	CUSTOMER NAME:	LAKE CITY ATC
	CUSTOMER ID:	5000957580

**GROUNDING DETAILS** 

SHEET NUMBER:

REVISION


E-502

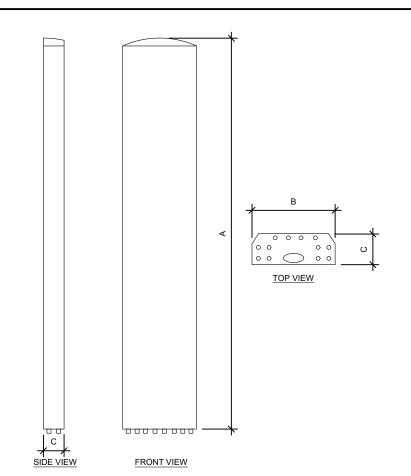


ANTENNA SPECIFICATIONS				
ANTENNA MODEL	А	В	С	WEIGHT (LBS)
AIR 6419 B77D	31.2"	16.1"	9.1"	63.1
MX06FHG865-HG	72.0"	12.2"	7.5"	41.0



TOP VIEW

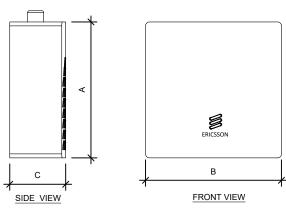

RRU SPECIFICATIONS				
RRU MODEL	A	В	С	WEIGHT (LBS)
RRUS 4490	20.6"	15.7"	7.0"	68.4
RRUS 4890	20.6"	15.7"	7.2"	69.5

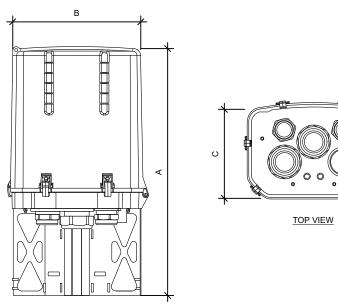

## FRONT VIEW

OVP :	SPECIFICAT	IONS		
RAYCAP MODEL	А	В	С	WEIGHT (LBS)
RVZDC-6627-PF-48	28.9"	15.7"	10.3"	32.0




SUPPLEMENTAL

SHEET NUMBER:

R-601

-

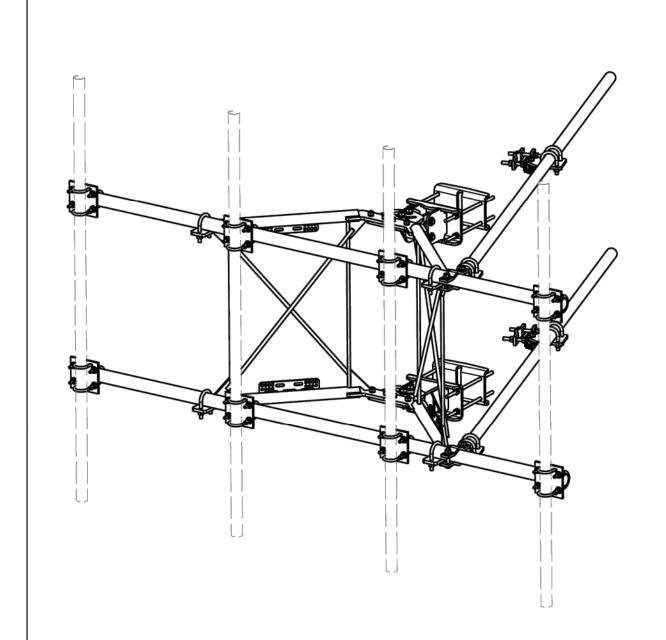

			PARTS LIST			
ITEM	QTY	PART NO.	PART DESCRIPTION	LENGTH	UNIT WT.	NET WT.
1	2	X-VFAW	SUPPORT ARM		71.41	142.81
2	1	X-HDCAMTBW	CLAMP WELDMENT FOR BCAM-HD		33.86	33.86
3	1	X-MHTPHD	MULTI-HOLE TAPER PLATE WELDMENT		36.24	36.24
4	2	X-VFAPL4	VFA-HD PIVOT PLATE	12 in	15.88	31.77
5	2	X-LCBP4	BENT BACKING PLATE	13 in	19.00	38.01
6	1	X-HDCAMSS	ANGLE ADJUSTMENT WELDMENT FOR BCAM-HD		16.39	16.39
7	4	X-SPTB	SLIDING PIPE TIE BACK PLATE	5 1/2 in	5.87	23.49
8	1	X-HDCAMSP	POSITIONING PLATE WELDMENT FOR BCAM-HD		2.58	2.58
9	4	X-TBCA	TIE BACK CLIP ANGLE		2.01	8.02
10	8	SCX2	CROSSOVER PLATE	7 in	4.80	38.37
11	4	MCP	CLAMP HALF 1/2" THICK, 11-5/8" LONG	12 1/16 in	3.59	14.37
12	8	DCP	1/2" THICK, 5-3/4" CNTER TO CENTER CLAMP HALF	8 1/8 in	2.36	18.90
13	2	P2126	2-3/8" X 126" (2" SCH. 40) GALVANIZED PIPE	126 in	40.75	81.50
14	2	P30126	2-7/8" O.D. X 126" SCH. 40 PIPE	126 in	64.63	129.25
15	4	A34212	3/4" x 2-1/2" UNC HEX BOLT (A325)	2 1/2 in	0.48	1.92
16	4	G34FW	3/4" HDG USS FLATWASHER		0.06	0.24
17	4	G34LW	3/4" HDG LOCKWASHER		0.04	0.17
18	4	G34NUT	3/4" HDG HEAVY 2H HEX NUT		0.21	0.85
19	8	G58R-18	5/8" x 18" THREADED ROD (HDG.)	18 in	0.40	3.19
20	4	G58R-12	5/8" x 12" THREADED ROD (HDG.)		1.05	4.18
21	4	G58R-8	5/8" x 8" THREADED ROD (HDG.)		0.70	2.79
22	4	X-UB5300	5/8" X 3" X 5-1/4" X 2-1/2" U-BOLT (HDG.)		1.15	4.60
23	8	X-UB5258	5/8" X 2-5/8" X 4-1/2" X 2" U-BOLT (HDG.)		1.00	8.00
24	2	G5807	5/8" x 7" HDG HEX BOLT GR5 FULL THREAD	7 in	0.70	1.41
25	1	G5806	5/8" x 6" HDG HEX BOLT GR5 FULL THREAD	6 in	0.62	0.62
26	8	G5804	5/8" x 4" HDG HEX BOLT GR5		0.44	3.55
27	4	G5802	5/8" x 2" HDG HEX BOLT GR5		0.27	1.08
28	8	A582114	5/8" x 2-1/4" HDG A325 HEX BOLT	2 1/4 in	0.31	2.50
29	25	G58FW	5/8" HDG USS FLATWASHER	1/8 in	0.07	1.76
30	66	G58LW	5/8" HDG LOCKWASHER		0.03	1.72
31	71	G58NUT	5/8" HDG HEAVY 2H HEX NUT		0.13	9.22
32	32	X-UB1300	1/2" X 3" X 5" X 2" GALV U-BOLT		0.74	23.64
33	16	X-UB1212	1/2" X 2" X 3" X 1-1/4" U-BOLT (HDG.)		0.60	9.56
34	64	G12FW	1/2" HDG USS FLATWASHER	3/32 in	0.03	2.18
35	64	G12LW	1/2" HDG LOCKWASHER	1/8 in	0.01	0.89
36	64	G12NUT	1/2" HDG HEAVY 2H HEX NUT		0.07	4.58
				•	TOTAL WT. #	713.44

					SAWED, SHEARE DRILLED AND GA
D	UPDATED BCAM VERSION 1 TO BCAM VERSION 2		CEK	6/29/2018	LASER CUT EDG
С	UPDATED PIN LEG CONNECTION TO BCAM CONNECTION		CEK	12/14/2017	BENDS ARE ± 1/2
В	CHANGED TIE-BACK BACK CONNECTION		CEK	7/28/2017	ALL OTHER MAG
Α	CHANGED TIE-BACK FRONT CONNECTION		CEK	2/2/2017	
REV	DESCRIPTION OF REVISIONS	CPD	BY	DATE	PROPRIETARY NOTE: THE DATA AND TECHNIQU

REVISION HISTORY

TOLERANCE NOTES

S ON DIMENSIONS, UNLESS OTHERWISE NOTED ARE:
ARED AND GAS CUT EDGES (± 0.030")
GAS CUT HOLES (± 0.030") - NO CONING OF HOLES
DGES AND HOLES (± 0.010") - NO CONING OF HOLES
1/2 DEGREE
ACHINING (± 0.030")

SEMBLY (± 0.060")

10' 6" HEAVY DUTY V-FRAME ASSEMBLY WITH TWO STIFF ARMS A valmont 🕶 cowww

New York, NY Atlanta, GA Los Angeles, CA Plymouth, IN Salem, OR Dallas, TX

DRAWN BY ENG. APPROVAL VFA10-HD CEK 1/25/2017 DRAWING USAGE CHECKED BY 81 02 CUSTOMER BMC 12/14/2017 VFA10-HD

**SUPPLEMENTAL** 

SHEET NUMBER:

REVISION:

R-602

PROPOSED SECTOR FRAME MOUNT DETAIL

DESCRIPTION

 $\frac{\text{NOTE:}}{\text{AT THE REQUEST OF THE CUSTOMER WITHOUT EDIT.}} \\$ 

INDUSTRIAL DIESEL GENERATOR SET

GENERAC INDUSTRIAL

Prime Power Rating\* 27 kW, 34 kVA, 60 Hz





\*EPA Certified Prime ratings are not available in the US or its Territories



Image used for illustration purposes only

## Codes and Standards

Not all codes and standards apply to all configurations. Contact factory for details.





UL142

UL2200, UL6200, UL1236, UL489,







BS5514 and DIN 6271

CSA C22.2, ULC S601



SAE J1349



NFPA 37, 70, 99, 110 NEC700, 701, 702, 708



ISO 3046, 7637, 8528, 9001



NEMA ICS10, MG1, 250, ICS6, AB1



ANSI C62.41

# Powering Ahead

For over 60 years, Generac has provided innovative design and superior manufacturing.

Generac ensures superior quality by designing and manufacturing most of its generator components, including alternators, enclosures and base tanks, control systems and communications software.

Generac gensets utilize a wide variety of options, configurations and arrangements, allowing us to meet the standby power needs of practically every application.

Generac searched globally to ensure the most reliable engines power our generators. We choose only engines that have already been proven in heavy-duty industrial applications under adverse conditions.

Generac is committed to ensuring our customers' service support continues after their generator purchase.

# SD030 | 2.2L | 30 kW

INDUSTRIAL DIESEL GENERATOR SET

EPA Certified Stationary Emergency

#### STANDARD FEATURES

#### **ENGINE SYSTEM**

- Oil Drain Extension
- Air Cleaner
- · Level 1 Fan and Belt Guards (Open Set Only)
- Stainless Steel Flexible Exhaust Connection
- · Factory Filled Oil and Coolant
- · Radiator Duct Adapter (Open Set Only)
- · Critical Silencer (Enclosed Unit Only) · Engine Coolant Heater

#### **FUEL SYSTEM**

- · Fuel Lockoff Solenoid
- Primary Fuel Filter

#### **COOLING SYSTEM**

- · Closed Coolant Recovery System
- UV/Ozone Resistant Hoses
- · Factory-Installed Radiator
- · Radiator Drain Extension
- 50/50 Ethylene Glycol Antifreeze

# ELECTRICAL SYSTEM

- · Battery Charging Alternator
- Battery Cables
- Battery Tray
- · Rubber-Booted Engine Electrical Connections
- Solenoid Activated Starter Motor

#### ALTERNATOR SYSTEM

- UL2200 GENprotect TM
- Class H Insulation Material 2/3 Pitch
- Skewed Stator
- Brushless Excitation
- Sealed Bearing
- · Rotor Dynamically Spin Balanced
- · Amortisseur Winding (3-Phase Only) · Full Load Capacity Alternator
- Protective Thermal Switch

#### GENERATOR SET

- Internal Genset Vibration Isolation
- · Separation of Circuits High/Low Voltage
- . Separation of Circuits Multiple Breakers
- Wrapped Exhaust Piping
- Standard Factory Testing
- . 2 Year Limited Warranty (Standby Rated Units)
- . 1 Year Limited Warranty (Prime Rated Units)
- Silencer Mounted in the Discharge Hood (Enclosed Unit Only)

## **ENCLOSURE (If Selected)**

· Rust-Proof Fasteners with Nylon Washers to Protect Finish

GENERAC | INDUSTRIAL

- High Performance Sound-Absorbing Material (Sound Attenuation Enclosures)
- Gasketed Doors
- Upward Facing Discharge Hoods (Radiator and Exhaust)
- · Stainless Steel Lift Off Door Hinges
- Stainless Steel Lockable Handles
- RhinoCoat™ Textured Polyester Powder Coat Paint

#### FUEL TANKS (If Selected)

- UL 142/ULC S601
- Double Wall
- Normal and Emergency Vents
- Sloped Top
- Sloped Bottom
- · Factory Pressure Tested
- Rupture Basin Alarm
- Fuel Level
- · Check Valve In Supply and Return Lines
- RhinoCoat™- Textured Polyester Powder Coat Paint
- Stainless Steel Hardware

#### CONTROL SYSTEM



#### Digital H Control Panel- Dual 4x20 Display

#### **Program Functions**

- · Programmable Crank Limiter
- · 7-Day Programmable Exerciser
- · Special Applications Programmable Logic Controller RS-232/485 Communications
- · All Phase Sensing Digital Voltage Regulator 2-Wire Start Capability
- Date/Time Fault History (Event Log)
- Isochronous Governor Control
- Waterproof/Sealed Connectors · Audible Alarms and Shutdowns
- Not in Auto (Flashing Light)

- Auto/Off/Manual Switch
- E-Stop (Red Mushroom-Type)
- . NFPA110 Level I and II (Programmable)
- · Customizable Alarms, Warnings, and Events Modbus<sup>®</sup> Protocol
- · Predictive Maintenance Algorithm
- Sealed Boards
- · Password Parameter Adjustment Protection
- · Single Point Ground
- 16 Channel Remote Trending
- · 0.2 msec High Speed Remote Trending Alarm Information Automatically Annunciated on the Display

#### **Full System Status Display**

- · Power Output (kW)
- Power Factor
- · kW Hours, Total, and Last Run Real/Reactive/Apparent Power
- All Phase AC Voltage
- · All Phase Currents
- Oil Pressure
- · Coolant Temperature
- Coolant Level Engine Speed Battery Voltage
- Frequency

## Alarms and Warnings

- Oil Pressure Coolant Temperature
- · Coolant Level
- · Engine Overspeed Battery Voltage
- · Alarms and Warnings Time and Date Stamped
- · Snap Shots of Key Operation Parameters During Alarms and Warnings
- Alarms and Warnings Spelled Out (No Alarm Codes)

**SUPPLEMENTAL** 

SHEET NUMBER:

R-603

REVISION:

PROPOSED 30KW GENERATOR DETAIL

# GENERAC INDUSTRIAL

#### CONFIGURABLE OPTIONS

#### ENGINE SYSTEM

- Oil Heater
- Critical Silencer (Open Set Only)
- Radiator Stone Guard
- O Level 1 Fan and Belt Guards (Enclosed Units Only)

#### FUEL SYSTEM

O NPT Flexible Fuel Line

#### **ELECTRICAL SYSTEM**

- O 10A UL Listed Battery Charger
- Battery Warmer

# ALTERNATOR SYSTEM

- Alternator Upsizing
- O Anti-Condensation Heater
- Tropical Coating O Permanent Magnet Excitation

# GENERATOR SET

- Extended Factory Testing
- O 8 Position I oad Center
- O Pad Vibration Isolation

#### **ENGINEERED OPTIONS**

#### ENGINE SYSTEM

- O Coolant Heater Isolation Ball Valves
- O Fluid Containment Pan

#### CONTROL SYSTEM

- O Spare Inputs (x4) / Outputs (x4)
- O Battery Disconnect Switch

## CIRCUIT BREAKER OPTIONS

- O Main Line Circuit Breaker
- O 2nd Main Line Circuit Breaker
- O Shunt Trip and Auxiliary Contact
- O Electronic Trip Breakers

#### **ENCLOSURE**

- O Weather Protected Enclosure
- O Level 1 Sound Attenuation
- O Level 2 Sound Attenuation O Level 2 Sound Attenuation with Motorized Dampers
- O Steel Enclosure
- O Aluminum Enclosure
- O Up to 200 MPH Wind Load Rating (Contact Factory for Availability)
- O AC/DC Enclosure Lighting Kit
- O Door Open Alarm Switch
- Enclosure Heater
- O Damper Alarm Contacts

### WARRANTY (Standby Gensets Only)

- O 2 Year Extended Limited Warranty
- O 5 Year Limited Warranty
- O 5 Year Extended Limited Warranty O 7 Year Extended Limited Warranty
- O 10 Year Extended Limited Warranty

ALTERNATOR SYSTEM

#### CONTROL SYSTEM

- O NFPA 110 Compliant 21-Light Remote Annunciator
- O Remote Relay Assembly (8 or 16)
- O Oil Temperature Indication and Alarm
- O Remote E-Stop (Break Glass-Type, Surface Mount)
- O Remote E-Stop (Red Mushroom-Type, Surface Mount)
- Remote E-Stop (Red Mushroom-Type, Flush Mount)
- O 100 dB Alarm Hom
- O Ground Fault Annunciation
- O 120V GFCI and 240V Outlets
- Remote Communication Modem
- O 10A Engine Run Relay

#### FUEL TANKS (Size On Last Page)

- O 8 in (203.2 mm) Fill Extension
- O 13 in (330.2 mm) Fill Extension
- O 19 in (482.6 mm) Fill Extension
- O Overfill Protection Valve
- O 5 Gallon Spill Box Return Hose O 5 Gallon Spill Box
- O Tank Risers
- Fuel Level Switch and Alarm
- O 12' Vent System

#### O Fire Rated Stainless Steel Fuel Hose

#### FUEL TANKS

- O 3rd Breaker System
- **GENERATOR SET**
- Special Testing

- O UL2085 Tank
- O Stainless Steel Tanks
- O Special Fuel Tanks
- Vent Extensions

## SD030 | 2.2L | 30 kW

#### INDUSTRIAL DIESEL GENERATOR SET

EPA Certified Stationary Emergency

# APPLICATION AND ENGINEERING DATA

## **ENGINE SPECIFICATIONS**

0	-	 -	ı.	

Make	Perkins
EPA Emissions Compliance	Stationary Emergency
EPA Emissions Reference	See Emission Data Sheet
Cylinder #	4
Туре	In-Line
Displacement - in <sup>3</sup> (L)	135 (2.22)
Bore - in (mm)	3.3 (84)
Stroke - in (mm)	3.9 (100)
Compression Ratio	23.3:1
Intake Air Method	Turbocharged
Cylinder Head	Cast Iron
Piston Type	Aluminum
Crankshaft Tyne	Formed Steel

#### Engine Governing

	Governor	Electronic Isochronous
Ī	Frequency Regulation (Steady State)	±0.5%

## Lubrication System

Oil Pump Type	Gear
Oil Filter Type	Full-Flow
Crankcase Capacity - qt (L)	11.2 (10.6)

#### Cooling System

Cooling System Type	Closed Recovery
Water Pump Type	Pre-Lubed, Self Sealing
Fan Type	Pusher
Fan Speed - RPM	1,980
Fan Diameter - in (mm)	18 (457)

GENERAC | INDUSTRIAL

#### Fuel System

Fuel Type	Ultra Low Sulfur Diesel Fuel #2
Fuel Specifications	ASTM
Fuel Filtering (Microns)	5
Fuel Inject Pump	Distribution Injection Pump
Fuel Pump Type	Engine Driven Gear
Injector Type	Mechanical
Fuel Supply Line - in (mm)	0.31 (7.9) ID
Fuel Return Line - in (mm)	0.2 (4.8) ID

#### Engine Electrical System

System Voltage	12 VDC
Battery Charger Alternator	Standard
Battery Size	See Battery Index 0161970SBY
Battery Voltage	12 VDC
Ground Polarity	Negative

#### ALTERNATOR SPECIFICATIONS

Standard Model	K0035124Y21
Pales	4
Field Type	Revolving
Insulation Class - Rotor	Н
Insulation Class - Stator	Н
Total Harmonic Distortion	<5% (3-Phase Only)
Telephone Interference Factor (TIF)	< 50

Standard Excitation	Synchronous Brushless
learings	Single Sealed
Coupling	Direct via Flexible Disc
oad Capacity - Standby	100%
rototype Short Circuit Test	Yes
oltage Regulator Type	Digital
lumber of Sensed Phases	All
legulation Accuracy (Steady State)	±0.25%

NOTE: THIS SHEET WAS CREATED BY OTHERS AND PROVIDED AT THE REQUEST OF THE CUSTOMER WITHOUT EDIT.

SUPPLEMENTAL

SHEET NUMBER:

R-604

REVISION:

PROPOSED 30KW GENERATOR DETAIL



EPA Certified Stationary Emergency

#### **OPERATING DATA**

#### POWER RATINGS

		Standby
Single-Phase 120/240 VAC @1.0pf	30 kW	Amps: 125
Three-Phase 120/208 VAC @0.8pf	30 kW	Amps: 104
Three-Phase 120/240 VAC @0.8pf	30 kW	Amps: 90
Three-Phase 277/480 VAC @0.8pf	30 kW	Amps: 45
Three-Phase 346/600 VAC @0.8pf	30 kW	Amps: 36

#### MOTOR STARTING CAPABILITIES (skVA)

SKVA vs. Voltage Dip					
120/240 VAC 1Ø	30%	277/480 VAC 3Ø	30%	208/240 VAC 3Ø	30%
A0035044N21	20	K0035124Y21	61	K0035124Y21	46
A0040044N21	24	K0040124Y21	76	K0040124Y21	58
A0050044N21	31	K0050124Y21	98	K0050124Y21	75

#### **FUEL CONSUMPTION RATES\***

	Diesel - gph (Lph)		
Fuel Pump Lift- ft (m)	Percent Load	Standby	
3 (1)	25%	1.0 (3.7)	
	50%	1.4 (5.2)	
Total Fuel Pump Flow (Combustion + Return) - gph (Lph)	75%	2.0 (7.5)	
16.6 (63)	100%	2.8 (10.5)	
	* Fuel supply installation m consumption rates at 100		

#### COOLING

		Standby
Coolant Flow	gpm (Lpm)	14.9 (56.2)
Coolant System Capacity	gal (L)	2.5 (9.5)
Heat Rejection to Coolant	BTU/hr (kW)	128,638 (136)
Inlet Air	cfm (m³/hr)	2,800 (4,757)
Maximum Operating Ambient Temperature	°F (°C)	122 (50)
Maximum Operating Ambient Temperature (Before Derate)	See Bulletin	No. 0199280SSD
Maximum Additional Radiator Backpressure	in H <sub>2</sub> O (kPa)	0.5 (0.12)

#### COMBUSTION AIR REQUIREMENTS

	,
Flow at Rated Power - cfm (m <sup>3</sup> /min) 88 (2.5)	

IGINE	EXHAUST

		Standby	
Rated Engine Speed	RPM	1,800	Exhaust Flow (Rated Output)
Horsepower at Rated kW**	hp	49	Max. Allowable Backpressure (Post Turbocharg
Piston Speed	ft/min (m/min)	1,181 (360)	Exhaust Temperature (Rated Output)
BMEP	psi (kPa)	159 (1,096)	

<sup>\*\*</sup> Refer to "Ernissions Data Sheet" for maximum bHP for EPA and SCAQMD permitting purposes.

Deration - Operational characteristics consider maximum ambient conditions. Derate factors may apply under atypical site conditions.

Please contact a Generac Power Systems Industrial Dealer for additional details. All performance ratings in accordance with ISO3046, BS5514, ISO8528, and DIN6271 standards. Standby - See Bulletin 0187500SSB


Prime - See Bulletin 0187510SSB

# SD030 | 2.2L | 30 kW

INDUSTRIAL DIESEL GENERATOR SET

EPA Certified Stationary Emergency

#### **DIMENSIONS AND WEIGHTS\***

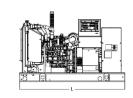



# OPEN SET


OI LIN OLI					
Run Time - Hours	Usable Capacity - Gal (L)	LxWxH-in (mm)	Weight - Ibs (kg)		
No Tank	-	76.0 (1,930) x 37.4 (950) x 44.8 (1,138)	1,456 - 1,641 (661 - 745)		
19	54 (204)	76.0 (1,930) x 37.4 (950) x 57.8 (1,468)	1,936 - 2,121 (879 - 963)		
47	132 (500)	76.0 (1,930) x 37.4 (950) x 69.8 (1,773)	2,166 - 2,351 (983 - 1,067)		
67	190 (719)	76.0 (1,930) x 37.4 (950) x 79.3 (2,014)	2,380 - 2,565 (1,081 - 1,165)		
75	211 (799)	76.0 (1,930) x 37.4 (950) x 81.8 (2,078)	2,375 - 2,560 (1,078 - 1,162)		
107	300 (1,136)	92.9 (2,360) x 37.4 (950) x 85.3 (2,167)	2,438 - 2,623 (1,106 - 1,190)		
107	300 (1,136)	92.9 (2,360) x 37.4 (950) x 85.3 (2,167)	2,438 - 2,623 (1,106 - 1,19		

GENERAC | INDUSTRIAL




# WEATHER PROTECTED ENCLOSURE

Run Time	Usable Capacity	LxWxH-in (mm)		- lbs (kg) sure Only
- Hours	- Gal (L)		Steel	Aluminum
No Tank	-	94.8 (2,409) x 38.0 (965) x 49.5 (1,258)		
19	54 (204)	94.8 (2,409) x 38.0 (965) x 62.5 (1,588)	_	
47	132 (500)	106.0 (2,692) x 38.0 (965) x 84.0 (2,134)	372	241
67	190 (719)	94.8 (2,409) x 38.0 (965) x 84.0 (2,134)	(169)	(109)
75	211 (799)	76.0 (1,930) x 38.0 (965) x 86.5 (2,198)	_	
107	300 (1,136)	92.9 (2,360) x 38.0 (965) x 90.0 (2,287)		

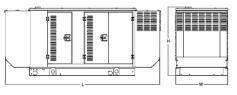

### LEVEL 1 SOUND ATTENUATED ENCLOSURE

Run Time	Usable Capacity	L x W x H - in (mm)		t - lbs (kg) sure Only
- 110015	- Gal (L)		Steel	Aluminum
No Tank	-	112.5 (2,857) x 38.0 (965) x 49.5 (1,258)		
19	54 (204)	112.5 (2,857) x 38.0 (965) x 62.5 (1,588)		
47	132 (500)	112.5 (2,857) x 38.0 (965) x 74.5 (1,893)	505	338
67	190 (719)	112.5 (2,857) x 38.0 (965) x 84.0 (2,134)	(229)	(153)
75	211 (799)	112.5 (2,857) x 38.0 (965) x 86.5 (2,198)		
107	300 (1,136)	112.5 (2,857) x 38.0 (965) x 90.0 (2,287)		

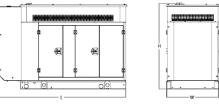

## **LEVEL 2 SOUND ATTENUATED ENCLOSURE**

	Run Time - Hours	Usable Capacity - Gal (L)	L x W x H - in (mm)	Weight - Ibs (kg) Enclosure Only	
				Steel	Aluminum
	No Tank	-	94.8 (2,409) x 38.0 (965) x 49.5 (1,258)		341 (155)
	19	54 (204)	94.8 (2,409) x 38.0 (965) x 62.5 (1,588)	510 (231)	
	47	132 (500)	94.8 (2,409) x 38.0 (965) x 74.5 (1,893)		
	67	190 (719)	106.0 (2,692) x 38.0 (965) x 84.0 (2,134)		
	75	211 (799)	94.8 (2,409) x 38.0 (965) x 86.5 (2,198)		
	107	300 (1,136)	94.8 (2,409) x 38.0 (965) x 90.0 (2,287)		

<sup>\*</sup> All measurements are approximate and for estimation purposes only. Specification characteristics may change without notice. Please contact a Generac Power Systems industrial Dealer for detailed installation drawings.

Generac Power Systems, Inc. | P.O. Box 8 | Waukesha, WI 53189 P: (262) 544-4811 @2020 Generac Power Systems, Inc. All rights reserved. All specifications are subject to change without notice. Part No. 10000024842 Rev. C 10/19/2020

 $\frac{\text{NOTE:}}{\text{AT THE REQUEST OF THE CUSTOMER WITHOUT EDIT.}} \\$ 

**SUPPLEMENTAL** 

SHEET NUMBER:

R-605

REVISION:

PROPOSED 30KW GENERATOR DETAIL

Standby

296.6 (8.4) 1.5 (5.1)

892 (478)

cfm (m3/min)

inHg (kPa) °F (°C)