



REVISIONS	

SOFTPLAN  
ARCHITECTURAL DESIGN SOFTWARE

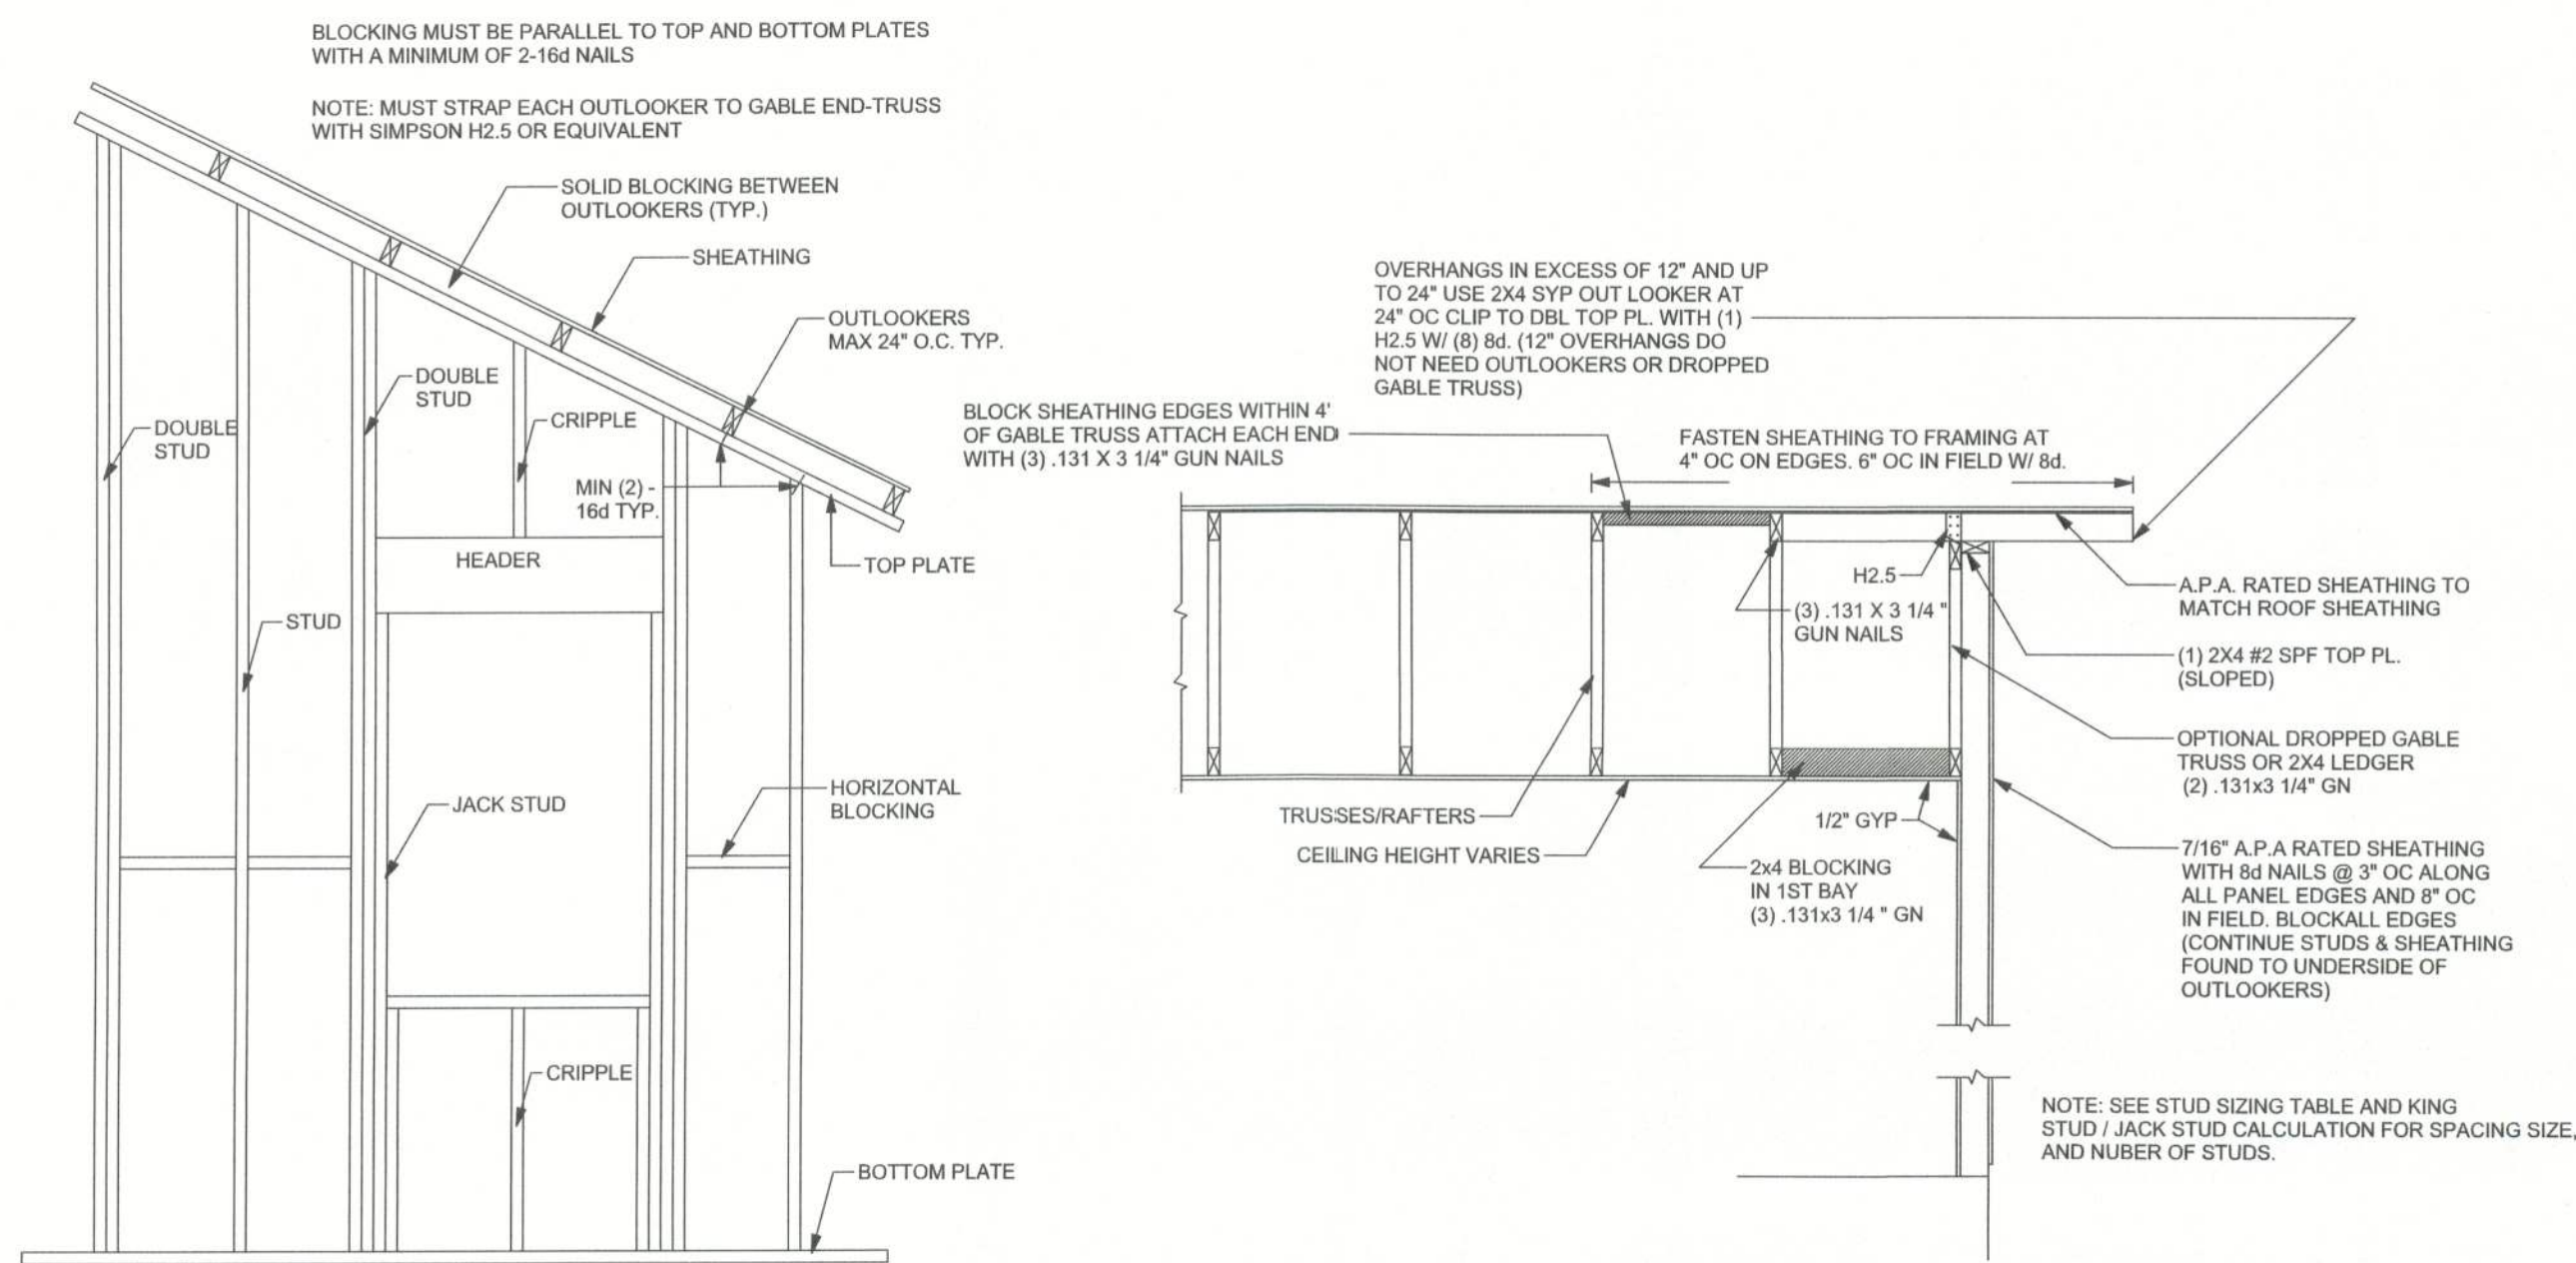

**GABLE END WALL BALLOON FRAMING DETAIL**  
SCALE: 1/2" = 1'-0"

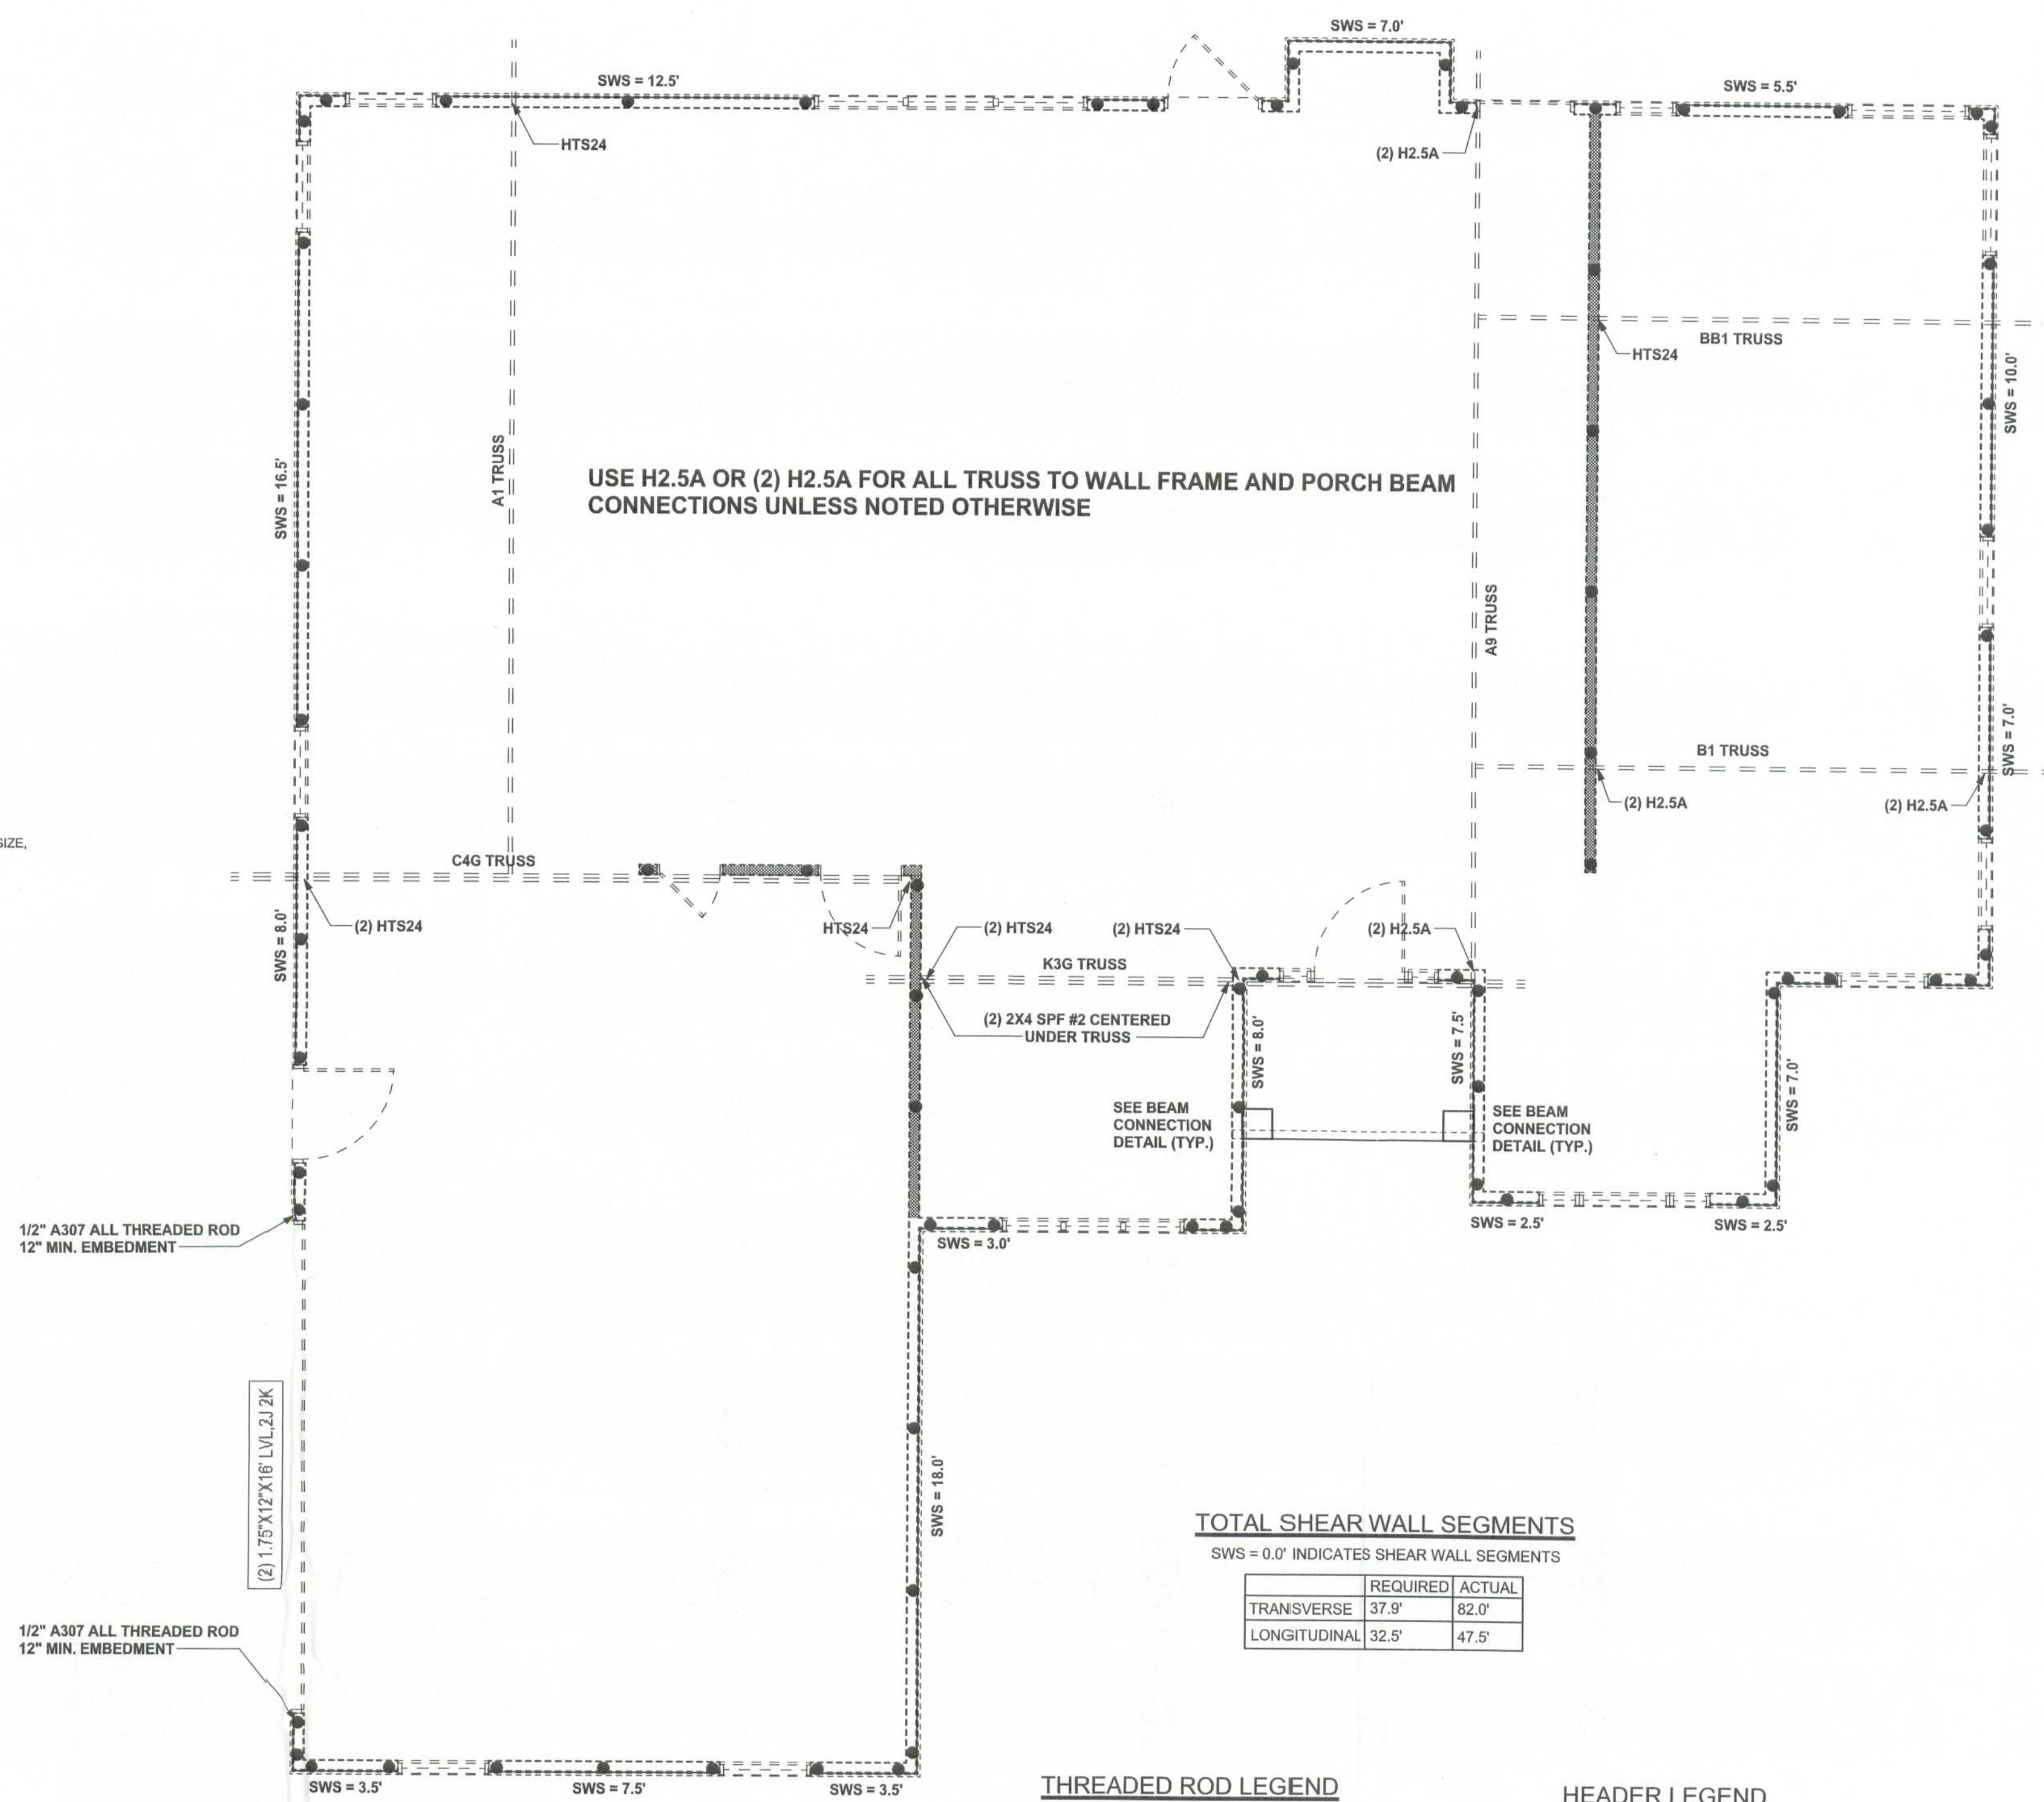

**TOTAL SHEAR WALL SEGMENTS**  
SWS = 0.0' INDICATES SHEAR WALL SEGMENTS

	REQUIRED	ACTUAL
TRANSVERSE	37.9'	82.0'
LONGITUDINAL	32.5'	47.5'

**THREADED ROD LEGEND**

- INDICATES LOCATION OF: 1ST FLOOR 1/2" A307 ALL THREADED ROD
- INDICATES LOCATION OF: 2ND FLOOR 1/2" A307 ALL THREADED ROD

**HEADER LEGEND**

- (2) 2X12X0', 1J 1K
- HEADER/BEAM CALL-OUT (U.N.O.)
- NUMBER OF KING STUDS (FULL LENGTH)
- NUMBER OF JACK STUDS (UNDER HEADER)
- SPAN OF HEADER
- SIZE OF HEADER MATERIAL
- NUMBER OF PLIES IN HEADER

**STRUCTURAL PLAN**  
SCALE: 1/4" = 1'-0"

**STRUCTURAL PLAN NOTES**

- SN-1 ALL LOAD BEARING FRAME WALL & PORCH HEADERS SHALL BE A MINIMUM OF (2) 2X12 SYP#2 (U.N.O.)
- SN-2 ALL LOAD BEARING FRAME WALL HEADERS SHALL HAVE (1) JACK STUD & (1) KING STUD EACH SIDE (U.N.O.)
- SN-3 DIMENSIONS ON STRUCTURAL SHEETS ARE NOT EXACT. REFER TO ARCHITECTURAL FLOOR PLAN FOR ACTUAL DIMENSIONS
- SN-4 PERMANENT TRUSS BRACING IS TO BE INSTALLED AT LOCATIONS AS SHOWN ON THE SEALED TRUSS DRAWINGS. LATERAL BRACING IS TO BE RESTRAINED PER BCSI-03, BCSI-B1, BCSI-B2, & BCSI-B3. BCSI-B1, BCSI-B2, & BCSI-B3 ARE FURNISHED BY THE TRUSS SUPPLIER, WITH THE SEALED TRUSS PACKAGE

**WALL LEGEND**

SWS = 0.0'	1ST FLOOR EXTERIOR WALL
SWS = 0.0'	2ND FLOOR EXTERIOR
IBW	1ST FLOOR INTERIOR BEARING WALLS SEE DETAILS ON SHEET S-1
IBW	2ND FLOOR INTERIOR BEARING WALLS SEE DETAILS ON SHEET S-1

CONNECTIONS, WALL, & HEADER DESIGN IS BASED ON REACTIONS & UPLIFTS FROM TRUSS ENGINEERING FURNISHED BY BUILDER, ANDERSON TRUSS CO. (JOB #5-426)

WINDLOAD ENGINEER: Mark Disosway,  
PE No.53915, POB 868, Lake City, FL  
32056, 386-754-5419

DIMENSIONS:  
Stated dimensions supersede scaled dimensions. Refer all questions to Mark Disosway, P.E. for resolution. Do not proceed without clarification.

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CERTIFICATION: I hereby certify that I have examined this plan, and that the applicable portions of the plan, relating to wind engineering comply with section 1609, Florida building code 2004, to the best of my knowledge.

LIMITATION: This design is valid for one building, at specified location.

MARK DISOSWAY  
P.E. 53915

*Mark Disosway*  
12 OCT 05  
SEAL

**SPARKS CONSTRUCTION**

**SPEC HOUSE**  
Lot 41 Turkey Run S/D

ADDRESS:  
Lot 41 Turkey Run S/D  
Columbia County, Florida

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windloadengineer@bellsouth.net

PRINTED DATE:  
October 17, 2005

DRAWN BY:  
Ben Sparks

CHECKED BY:

FINALS DATE:  
17 / OCT / 05

JOB NUMBER:  
509142

DRAWING NUMBER  
**S-3**  
OF 6 SHEETS